

Report to the Hearing Officer

DATE ISSUED: March 6, 2024 REPORT NO. HO-24-005

HEARING DATE: March 20, 2024

SUBJECT: 7443 Eads Avenue, Process Three Decision

PROJECT NUMBER: 1070073

OWNER/APPLICANT: William Mueller and Tina Wright, Owner / Marengo Morton Architects,

Applicant

SUMMARY

<u>Issue</u>: Should the Hearing Officer approve demolishing an existing garage and constructing a new 3,327 square-foot single dwelling unit with an 800 square foot accessory dwelling unit adding 436 square-feet to an existing 1,556-square-foot dwelling unit, and creating two condominium units at 7443 Eads Avenue within the La Jolla Community Planning area?

Proposed Actions: Approve Coastal Development Permit No. 3185169 and Map Waiver No. 3231921.

<u>Fiscal Considerations</u>: All costs associated with this action are recovered through a deposit account funded by the applicant.

Housing Impact Statement: The project proposes demolishing an existing garage and constructing a new single dwelling unit with accessory dwelling unit an addition to an existing dwelling unit and creating two residential condominium units. Relocation assistance is not required since the project site has one occupant, the existing property owner/applicant. The project is subject to the City's Inclusionary Housing Regulations (San Diego Municipal Code Chapter 14, Article 2, Division 13) and Condominium Conversion Regulations (Chapter 14, Article 4, Division 5), and is conditioned to require payment of an inclusionary affordable housing in-lieu fee.

<u>Community Planning Group Recommendation</u>: On May 4, 2023, the La Jolla Community Planning Association voted 13-0-1 to approve the project (Attachment 6).

<u>Environmental Review</u>: This project was determined to be categorically exempt from the California Environmental Quality Act (CEQA) pursuant to Section 15303 (New Construction). The environmental determination for the project was made on November 6, 2023, and the opportunity to appeal the determination ended on November 21, 2023 (Attachment 9). There were no appeals of the environmental determination.

BACKGROUND

The project site is developed with a 1,556 square-foot single dwelling unit at 7443 Eads Avenue. The 0.16-acre site is located approximately half a mile east from the Pacific Ocean within an urbanized area within the La Jolla community. There is no public view or coastal access from the project site, as identified in the La Jolla Community Plan (Community Plan). The project site is in the RM-1-1 Zone, Coastal Overlay Zone (Non-Appealable Area 2), Coastal Height Limit Overlay Zone, Parking Impact Overlay Zone (Coastal Impact), Transit Area Overlay Zone, and Transit Priority Area (Attachments 1-3).

The existing structure is more than 45 years old, requiring staff to evaluate the proposal for historic significance per San Diego Municipal Code (SDMC) Section 143.0212. Staff determined that the property does not meet the local designation criteria as an individually significant resource under any adopted Historical Resources Board Criteria.

Pursuant to SDMC Section 126.0704(a)(3), a Process Two Coastal Development Permit is required for an addition to an existing structure that increases the intensification of use. Pursuant to SDMC Section 125.0122, a Process Three Tentative Map Waiver is required for the creation of the proposed two residential condominium units. The discretionary actions have been consolidated under this application and processed concurrently, pursuant to the Consolidation of Processing regulations contained in SDMC Section 112.0103. Therefore, the decision to approve, conditionally approve, or deny the project will be made by the Hearing Officer and is appealable to the Planning Commission.

DISCUSSION

The project (Attachment 11 – Project Plans) includes demolishing an existing garage and constructing a new 3,327-square-foot dwelling unit with 800-square-foot accessory dwelling unit, adding 436-square-feet to an existing 1,556-square-foot dwelling unit, and create two condominium units. The project was designed to comply with the development regulations of the underlying RM-1-1 Zone, including building height (29 feet 4 inches) that does not exceed the 30-foot height limit, density, setbacks, and floor area ratio (.75) that is equal to the maximum (.75) allowed. No deviations or variances are required. The Map Waiver for the project was also reviewed and determined to be in compliance with the SDMC and Subdivision Map Act.

The Community Plan designates the site as low medium residential (9-15 dwelling units per acre), and the creation of two dwelling units (condominiums) with an accessory dwelling unit is consistent with the prescribed density of 9-15 dwelling units per acre. The project is consistent with the Community Plan goal of incorporating a variety of architectural styles, colors, and building materials for single-dwelling development and providing a dwelling unit that is similar in bulk and scale to the existing homes within the neighborhood. The project is also consistent with the Community Plan goal of promoting the development of a variety of housing types and styles in La Jolla.

The project site does not contain sensitive vegetation or biological resources, nor is the site within or adjacent to the City's Multiple Species Conservation Plan/Multiple Habitat Planning Area. No archaeological sites are located within the project site. Staff has also reviewed and accepted a

preliminary drainage study prepared for the site that concluded that the project complies with the City's drainage regulations and standards.

Additionally, the project permit contains specific requirements to ensure compliance with the regulations of the Land Development Code, including those adopted to protect public health, safety, and welfare. Permit requirements include the following:

- Removing and replacing the existing full-width alley pavement with the current City standard public improvement;
- Installing appropriate private back flow prevention devices;
- Constructing all public water and sewer facilities, per the City's Water and Sewer Facility design guidelines and regulations; and
- Maintenance of all landscaping improvements.

Staff has reviewed the proposal, including all the issues identified through the review process, and has determined that all project issues have been addressed. The project conforms with the Community Plan and the adopted City Council policies and regulations of the Land Development Code. Therefore, draft findings and conditions to support project approval are presented to the Hearing Officer for consideration.

ALTERNATIVES

- 1. Approve Coastal Development Permit No. 3185169 and Map Waiver No. 3231921, with modifications.
- 2. Deny Coastal Development Permit No. 3185169 and Map Waiver No. 3231921, if the findings required to approve the project cannot be affirmed.


Respectfully submitted,

Blaks Sonuga

Blake Sonuga, Development Project Manager

Attachments:

- 1. Project Location Map
- 2. Community Plan Land Use Map
- 3. Aerial Photograph
- 4. Draft Permit Resolution with Findings
- 5. Draft Permit with Conditions
- 6. Draft Map Waiver Resolution
- 7. Draft Map Waiver Conditions
- 8. Community Planning Group Recommendation
- 9. Notice of Right to Appeal (NORA)
- 10. Ownership Disclosure Statement
- 11. Project Plans

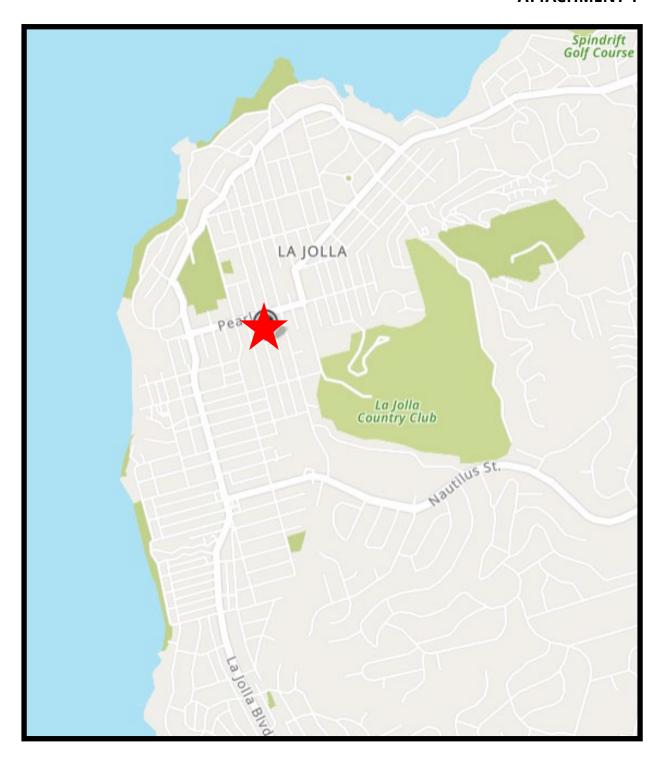




Project Location

7443 Eads Avenue La Jolla Project No. PRJ-1070073



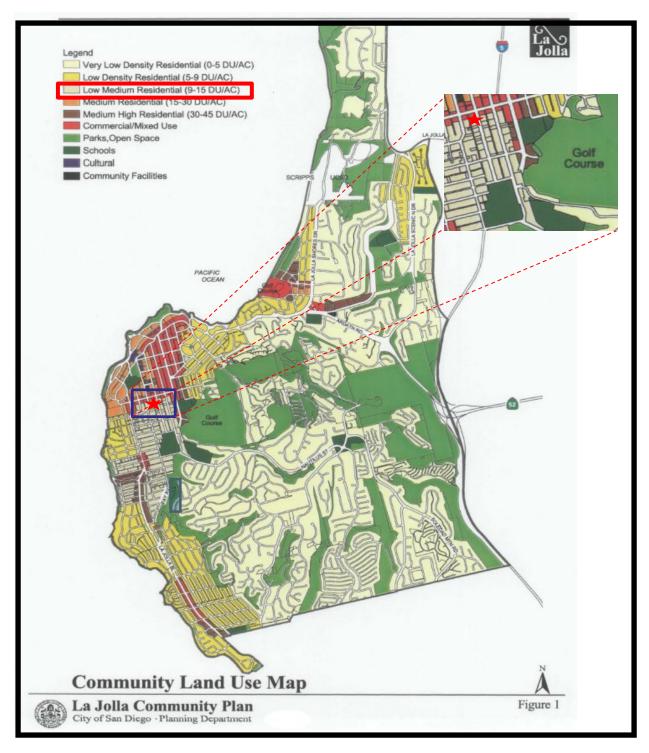




Land Use Plan

7443 Eads Avenue La Jolla Project No. PRJ-1070073



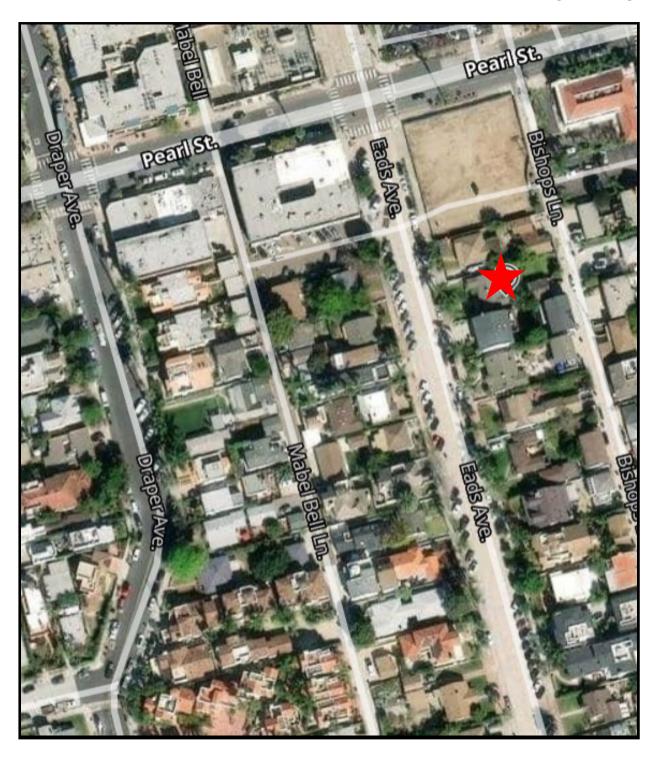



Aerial Photo

7443 Eads Avenue La Jolla Project No. PRJ-1070073



HEARING OFFICER RESOLUTION NO. COASTAL DEVELOPMENT PERMIT NO. 3185169 **7443 EADS AVENUE - PROJECT NO. 1070073**

WHEREAS, WILLIAM MUELLER AND TINA WRIGHT, Owner/Permittee, filed an application with the City of San Diego for a permit to demolish an existing garage and construct a new 3,327-square-foot dwelling unit with 800-square-foot accessory dwelling unit, add 436 square feet to an existing 1,556-square-foot dwelling unit, and create two condominium units (as described in and by reference to the approved Exhibits "A" and corresponding conditions of approval for the associated Coastal Development Permit No. 3185169), on portions of a 0.16-acre site.

WHEREAS, the project site is located at 7443 Eads Avenue in the RM-1-1 Zone, Coastal Overlay Zone (Non-Appealable Area 2), Coastal Height Limit Overlay Zone, Parking Impact Overlay Zone (Coastal Impact), Transit Area Overlay Zone, and Transit Priority Area within the La Jolla Community Planning Area;

WHEREAS, the project site is legally described as Lots 9 and 10 in Block 6 of La Jolla Park in the City of San Diego, County of San Diego, State of California, according to Map Thereof No. 352, filed in the office of the County Recorder of San Diego County March 22, 1887.

WHEREAS, on November 6, 2023, the City of San Diego, as Lead Agency, through the Development Services Department, made and issued an Environmental Determination that the project is exempt from the California Environmental Quality Act (CEQA) (Public Resources Code Section 21000 et seq.) under CEQA Guideline Section 15303 (New Construction); and there was no appeal of the Environmental Determination filed within the time period provided by San Diego Municipal Code Section 112.0520.

WHEREAS, on March 20, 2024, the Hearing Officer of the City of San Diego considered

Coastal Development Permit No. 3185169 pursuant to the Land Development Code of the City of

San Diego; NOW, THEREFORE,

BE IT RESOLVED by the Hearing Officer of the City of San Diego that it adopts the following findings with respect to Coastal Development Permit No. 3185169:

A. <u>COASTAL DEVELOPMENT PERMIT [San Diego Municipal Code Section (SDMC) Section</u> 126.0708]

- 1. Findings for all Coastal Development Permits:
 - a. The proposed coastal development will not encroach upon any existing physical accessway that is legally used by the public or any proposed public accessway identified in a Local Coastal Program land use plan; and the proposed coastal development will enhance and protect public views to and along the ocean and other scenic coastal areas as specified in the Local Coastal Program land use plan.

The project site is located approximately half a mile east of the Pacific Ocean within an urbanized area within the La Jolla community. There is no public view or coastal access from the project site, as identified in the Community Plan. The project complies with the community goals regarding public view preservation and enhancement since the project was designed to comply with the development regulations of the underlying RM-1-1 Zone, including building height (29 feet 4 inches) that is below the 30-foot height limit, density, setbacks, and floor area ratio (.75) that is equal to the maximum (.75) allowed. No deviations or variances are required. Therefore, the project will not encroach upon any existing physical accessway that is legally used by the public or any proposed public accessway identified in a Local Coastal Program land use plan; and the proposed project will enhance and protect public views to and along the ocean and other scenic coastal areas as specified in the Local Coastal Program Land Use Plan.

b. The proposed coastal development will not adversely affect environmentally sensitive lands.

The project site is developed and does not contain sensitive vegetation or biological resources, nor is the site is within or adjacent to the City's Multiple Species Conservation Plan/Multiple Habitat Planning Area. No archaeological sites are located within the project site. Staff has also reviewed and accepted a preliminary drainage study prepared for the site that concluded that the project complies with the City's drainage regulations and standards. The project was determined to be exempt from the California Environmental Quality Act (CEQA) pursuant to CEQA Guidelines Section 153303 (New Construction). Therefore, the proposed coastal development will not adversely affect environmentally sensitive lands.

c. The proposed coastal development is in conformity with the certified Local Coastal Program land use plan and complies with all regulations of the certified Implementation Program.

The existing structure is more than 45 years old, requiring City staff to evaluate the proposal for historic significance. Staff determined that the property does not meet the local designation criteria as an individually significant resource under any adopted Historical Resources Board Criteria. The project was designed to comply with the development regulations of the underlying RM-1-1 Zone, including building height (29 feet 4 inches) that is below the 30-foot height limit, density, setbacks, and floor area ratio (.75) that is equal to the maximum (.75) allowed. No deviations or variances are required.

The Community Plan designates the site as low medium residential (9-15 dwelling units per acre), and the creation of two dwelling units (condominiums) and one accessory dwelling unit is consistent with the prescribed density. The project is consistent with the Community Plan goal of incorporating a variety of architectural styles, colors and building materials for single-family development and providing a dwelling unit that is similar in bulk and scale to the existing homes within the neighborhood. The project is also consistent with the Community Plan goal of promoting the development of a variety of housing types and styles in La Jolla. The project site is located approximately half a mile east of the Pacific Ocean and there is no public view or coastal access from the project site, as identified in the Community Plan. Therefore, the proposed project is in conformity with the certified Local Coastal Program land use plan and complies with all regulations of the certified Implementation Program.

d. For every Coastal Development Permit issued for any coastal development between the nearest public road and the sea or the shoreline of any body of water located within the Coastal Overlay Zone the coastal development is in conformity with the public access and public recreation policies of Chapter 3 of the California Coastal Act.

The project site is not located between the nearest public road and the sea or the shoreline of any body of water. The project will be redeveloped entirely within private property and will not adversely impact public access or any public recreation opportunities. Therefore, the project conforms with the public access and public recreation policies of Chapter 3 of the California Coastal Act.

The above findings are supported by the minutes, maps, and exhibits, all of which are incorporated herein by this reference.

BE IT FURTHER RESOLVED that, based on the findings hereinbefore adopted by the Hearing Officer, Coastal Development Permit No. 3185169 is hereby GRANTED by the Hearing Officer to the

ATTACHMENT 4

referenced Owner/Permittee, in the form, exhibits, terms, and conditions as set forth in Coastal Development Permit No. 3185169, a copy of which is attached hereto and made a part hereof.

Blake Sonuga Development Project Manager Development Services

Adopted on March 20, 2024

IO#: 24009401

RECORDING REQUESTED BY

CITY OF SAN DIEGO DEVELOPMENT SERVICES PERMIT INTAKE, MAIL STATION 501

WHEN RECORDED MAIL TO CITY CLERK MAIL STATION 2A

INTERNAL ORDER NUMBER: 24009401

SPACE ABOVE THIS LINE FOR RECORDER'S USE

COASTAL DEVELOPMENT PERMIT NO. 3185169 7443 EADS AVENUE - PROJECT NO. 1070073 HEARING OFFICER

This Coastal Development Permit No. 3185169 is granted by the Hearing Officer of the City of San Diego to WILLIAM MUELLER AND TINA WRIGHT, Owner/Permittee, pursuant to San Diego Municipal Code [SDMC] sections 126.0702. The 0.16-acre site is located at 7443 Eads Avenue in the RM-1-1 Zone, Coastal Overlay Zone (Non-Appealable Area 2), Coastal Height Limit Overlay Zone, Parking Impact Overlay Zone (Coastal Impact), Transit Area Overlay Zone, and Transit Priority Area. The project site is legally described as Lots 9 and 10 in Block 6 of La Jolla Park, in the City of San Diego, County of San Diego, State of California, according to Map Thereof No. 352, filed in the office of the County Recorder of San Diego County March 22, 1887.

Subject to the terms and conditions set forth in this Permit, permission is granted to Owner/Permittee to demolish an existing garage and construct a new three story, single dwelling unit with accessory dwelling unit, adding an accessory dwelling unit to an existing single dwelling unit described as identified by size, dimension, quantity, type, and location on the approved exhibits [Exhibit "A"] dated March 20, 2024, on file in the Development Services Department.

The project shall include:

- a. Demolishing an existing garage, constructing a new 3,327-square-foot dwelling unit with 800-square-foot accessory dwelling unit, and a 436-square-foot addition to an existing 1,556-square-foot dwelling unit.
- b. Public and private accessory improvements determined by the Development Services Department to be consistent with the land use and development standards for this site in accordance with the adopted community plan, the California Environmental Quality Act [CEQA], and the CEQA Guidelines, the City Engineer's requirements, zoning regulations, conditions of this Permit, and any other applicable regulations of the SDMC.

STANDARD REQUIREMENTS:

- 1. This permit must be utilized within thirty-six (36) months after the date on which all rights of appeal have expired. If this permit is not utilized in accordance with Chapter 12, Article 6, Division 1 of the SDMC within the 36-month period, this permit shall be void unless an Extension of Time has been granted. Any such Extension of Time must meet all SDMC requirements and applicable guidelines in effect at the time the appropriate decision-maker considers the extension. This permit must be utilized by April 4, 2027.
- 2. While this Permit is in effect, the subject property shall be used only for the purposes and under the terms and conditions set forth in this Permit unless otherwise authorized by the appropriate City decision-maker.
- 3. This Permit is a covenant running with the subject property, and all of the requirements and conditions of this Permit and related documents shall be binding upon the Owner/Permittee and any successor(s) in interest.
- 4. The continued use of this Permit shall be subject to the regulations of this and any other applicable governmental agency.
- 5. Issuance of this Permit by the City of San Diego does not authorize the Owner/Permittee for this Permit to violate any Federal, State or City laws, ordinances, regulations or policies including, but not limited to, the Endangered Species Act of 1973 [ESA] and any amendments thereto (16 U.S.C. § 1531 et seq.).
- 6. The Owner/Permittee shall secure all necessary building permits. The Owner/Permittee is informed that to secure these permits, substantial building modifications and site improvements may be required to comply with applicable building, fire, mechanical, and plumbing codes, and State and Federal disability access laws.
- 7. Construction plans shall be in substantial conformity to Exhibit "A." Changes, modifications, or alterations to the construction plans are prohibited unless appropriate application(s) or amendment(s) to this Permit have been granted.
- 8. All of the conditions contained in this Permit have been considered and were determined necessary to make the findings required for approval of this Permit. The Permit holder is required to comply with each and every condition in order to maintain the entitlements that are granted by this Permit.
- 9. If any condition of this Permit, on a legal challenge by the Owner/Permittee of this Permit, is found or held by a court of competent jurisdiction to be invalid, unenforceable, or unreasonable, this Permit shall be void. However, in such an event, the Owner/Permittee shall have the right, by paying applicable processing fees, to bring a request for a new permit without the "invalid" conditions(s) back to the discretionary body which approved the Permit for a determination by that body as to whether all of the findings necessary for the issuance of the proposed permit can still be made in the absence of the "invalid" condition(s). Such hearing shall be a hearing de novo, and the

discretionary body shall have the absolute right to approve, disapprove, or modify the proposed permit and the condition(s) contained therein.

The Owner/Permittee shall defend, indemnify, and hold harmless the City, its agents, officers, and employees from any and all claims, actions, proceedings, damages, judgments, or costs, including attorney's fees, against the City or its agents, officers, or employees, relating to the issuance of this permit including, but not limited to, any action to attack, set aside, void, challenge, or annul this development approval and any environmental document or decision. The City will promptly notify Owner/Permittee of any claim, action, or proceeding and, if the City should fail to cooperate fully in the defense, the Owner/Permittee shall not thereafter be responsible to defend, indemnify, and hold harmless the City or its agents, officers, and employees. The City may elect to conduct its own defense, participate in its own defense, or obtain independent legal counsel in defense of any claim related to this indemnification. In the event of such election, Owner/Permittee shall pay all of the costs related thereto, including without limitation reasonable attorney's fees and costs. In the event of a disagreement between the City and Owner/Permittee regarding litigation issues, the City shall have the authority to control the litigation and make litigation-related decisions, including, but not limited to, settlement or other disposition of the matter. However, the Owner/Permittee shall not be required to pay or perform any settlement unless such settlement is approved by Owner/Permittee.

CLIMATE ACTION PLAN REQUIREMENTS:

11. Prior to the issuance of any construction permit, all CAP strategies shall be noted within the first 3 sheets of the construction plans under the heading "Climate Action Plan Requirements." The Climate Action Plan strategies, as identified in Exhibit "A," shall be enforced and implemented to the satisfaction of the Development Services Department.

ENGINEERING REQUIREMENTS:

- 12. Coastal Development Permit No. 3185169 shall comply with the conditions of the Tentative Map Waiver No. 3231921, satisfactory to the City Engineer.
- 13. Prior to the issuance of any construction permits, Owner/Permittee shall assure by permit and bond the removal and replacement of the existing full-width alley pavement with a current City Standard along the project frontage, satisfactory to the City Engineer.

TRANSPORTATION REQUIREMENTS

14. All on-site parking stalls and aisle widths shall be in compliance with requirements of the City's Land Development Code and shall not be converted and/or utilized for any other purpose, unless otherwise authorized in writing authorized by the appropriate City decision maker in accordance with the SDMC.

LANDSCAPE REQUIREMENTS:

- 15. Prior to issuance of any construction permit for grading, the Owner/Permittee shall submit complete construction documents for the revegetation and hydro-seeding of all disturbed land in accordance with the City of San Diego Landscape Standards, Storm Water Design Manual, and to the satisfaction of the Development Services Department. All plans shall be in substantial conformance to this permit (including Environmental conditions) and Exhibit "A," on file in the Development Services Department.
- 16. Prior to issuance of any construction permit for public improvements, the Owner/Permittee shall submit to the Development Services Department for approval complete landscape construction documents for public right-of-way improvements. Improvement plans shall show, label, and dimension a 40-square-foot area around each tree which is unencumbered by utilities. Driveways, utilities, drains, water and sewer laterals shall be designed to not prohibit the placement of street trees.
- 17. Prior to issuance of any construction permits, the Owner/Permittee shall submit to the Development Services Department for approval complete landscape and irrigation construction documents, which are consistent with the Landscape Standards. The construction documents shall be in substantial conformance with Exhibit "A," Landscape Development Plan on file in the Development Services Department. Construction plans shall provide a 40-square-foot area around each tree that is unencumbered by hardscape and utilities unless otherwise approved per SDMC Section 142.0403(b)(6).
- 18. The Owner/Permittee shall be responsible for the maintenance of all landscape improvements shown on the approved plans, including in the public right-of-way unless long-term maintenance of said landscaping will be the responsibility of another entity approved by the Development Services Department. All required landscape shall be maintained consistent with the Landscape Standards in a disease, weed, and litter free condition at all times. Severe pruning or "topping" of trees is not permitted.
- 19. If any required landscape (including existing or new plantings, hardscape, landscape features, etc.) as shown on the approved construction documents is damaged or removed, the Owner/Permittee shall repair and/or replace in kind and in an equivalent size per the approved documents to the satisfaction of the Development Services Department within 30 days of damage or final Onspection.

PLANNING/DESIGN REQUIREMENTS:

20. A topographical survey conforming to the provisions of the SDMC may be required if it is determined, during construction, that there may be a conflict between the building(s) under construction and a condition of this Permit or a regulation of the underlying zone. The cost of any such survey shall be borne by the Owner/Permittee.

AFFORDABLE HOUSING PERMIT REQUIREMENTS:

21. Prior to issuance of the Parcel Map, the Owner/Permittee shall demonstrate compliance with the provisions of the San Diego Municipal Code, including the Condominium Conversion Regulations of Chapter 14, Article 4, Division 5; the Inclusionary Affordable Housing Regulations of Chapter 14, Article 2, Division 13; and the Inclusionary Housing Procedures Manual by payment of the applicable Inclusionary Affordable Housing In-Lieu Fee.

WATER & SEWER DEVELOPMENT REQUIREMENTS:

- 22. All proposed private water and sewer facilities located within a single lot shall be designed to meet the requirements of the California Plumbing Code and will be reviewed as part of the building permit plan check.
- 23. Prior to the issuance of any construction permits, the Owner/Permittee shall assure by permit and bond the design and construction of new water and sewer services outside of any driveway or drive aisle, including the abandonment of any existing unused water and sewer services within the public right-of-way adjacent to the project site, in a manner satisfactory to the Public Utilities Department and the City Engineer.
- 24. Prior to the issuance of any construction permits, the Owner/Permittee shall apply for a plumbing permit for the installation of appropriate private back flow prevention devices (BFPDs) on each water service (domestic, fire and irrigation), in a manner satisfactory to the Public Utilities Department and the City Engineer.
- 25. The Owner/Permittee shall design and construct all proposed public water and sewer facilities in accordance with established criteria in the current edition of the City's Water and Sewer Facility Design Guidelines and City regulations, standards and practices.
- 26. No trees or shrubs exceeding three feet in height at maturity shall be installed within ten feet of any sewer facilities and five feet of any water facilities.

INFORMATION ONLY:

- The issuance of this discretionary permit alone does not allow the immediate commencement or continued operation of the proposed use on site. Any operation allowed by this discretionary permit may only begin or recommence after all conditions listed on this permit are fully completed and all required ministerial permits have been issued and received final inspection.
- Any party on whom fees, dedications, reservations, or other exactions have been imposed as conditions of approval of this Permit, may protest the imposition within ninety days of the approval of this development permit by filing a written protest with the City Clerk pursuant to California Government Code-section 66020.

• This development may be subject to impact fees at the time of construction permit issuance.

APPROVED by the Hearing Officer of the City of San Diego on March 20, 2024 and by______.



ATTACHMENT 5

Coastal Development Permit No. 3185169 Date of Approval: March 20, 2024

 Blake Sonuga		
Development Project Manager		

AUTHENTICATED BY THE CITY OF SAN DIEGO DEVELOPMENT SERVICES DEPARTMENT

NOTE: Notary acknowledgment must be attached per Civil Code section 1189 et seq.

The undersigned Owner/Permittee, by execution hereof, agrees to each and every condition of this Permit and promises to perform each and every obligation of Owner/Permittee hereunder.

Owner/Permittee
By William Mueller
Owner/Permittee
By Tina Wright

NOTE: Notary acknowledgments must be attached per Civil Code section 1189 et seq.

HEARING OFFICER RESOLUTION NO. TENTATIVE MAP WAIVER NO. 3231921 **7443 EADS AVENUE - PROJECT NO. 1070073**

WHEREAS, WILLIAM MUELLER AND TINA WRIGHT, Subdivider, and San Diego Land Surveying & Engineering, Inc., Surveyor, submitted an application with the City of San Diego for Map Waiver No. 3231921 to waive the requirement for a Tentative Map to create two residential condominium units. The project site is located at 7443 Eads Avenue in the RM-1-1 Zone within the La Jolla Community Planning area. The property is legally described as Lots 9 and 10 in Block 6 of La Jolla Park, in the City of San Diego, County of San Diego, State of California, according to Map Thereof No. 352, filed in the office of the County Recorder of San Diego County March 22, 1887; and

WHEREAS, the Map proposes the subdivision of a 0.61-acre site into one parcel and conversion into two residential condominium units; and

WHEREAS, on November 6, 2023, the City of San Diego, as Lead Agency, through the Development Services Department made and issued an Environmental Determination that the project is exempt from the California Environmental Quality Act (CEQA) (Public Resources Code section 21000 *et. seq.*) under CEQA Guidelines Section 15303 (New Construction); and there was no appeal of the Environmental Determination filed within the time period provided by San Diego Municipal Code section 112.0520; and

WHEREAS, a preliminary soils and geological reconnaissance report are waived by the City Engineer pursuant to Subdivision Map Act section 66491(a) and San Diego Municipal Code sections 144.0220(a) and 144.0220(b); and

WHEREAS, the subdivision is a condominium project as defined in California Civil Code section 4125 and filed pursuant to the Subdivision Map Act. The total number of condominium units is two; and

WHEREAS, on March 20, the Hearing Officer of the City of San Diego considered Map Waiver No. 3231921, and pursuant to sections 125.0122 and 125.0444 of the San Diego Municipal Code and Subdivision Map Act section 66428, received for its consideration written and oral presentations, evidence having been submitted, and testimony having been heard from all interested parties at the public hearing, and the Hearing Officer having fully considered the matter and being fully advised concerning the same; NOW THEREFORE,

BE IT RESOLVED by the Hearing Officer of the City of San Diego that it adopts the following findings with respect to Map Waiver No. 3231921:

1. The proposed subdivision and its design or improvement are consistent with the policies, goals, and objectives of the applicable land use plan.

The Community Plan designates the site as low medium residential (9-15 dwelling units per acre), and the creation of two dwelling units (condominiums) with one accessory dwelling unit is consistent with the prescribed density. The project is consistent with the Community Plan goal of incorporating a variety of architectural styles, colors and building materials for single-family development and providing a dwelling unit that is similar in bulk and scale to the existing homes within the neighborhood. The project is also consistent with the Community Plan goal of promoting the development of a variety of housing types and styles in La Jolla. The project site is located approximately half a mile east of the Pacific Ocean and there is no public view or coastal access from the project site, as identified in the Community Plan. Therefore, the proposed subdivision and its design or improvement are consistent with the policies, goals, and objectives of the applicable land use plan.

2. The proposed subdivision complies with the applicable zoning and development regulations of the Land Development Code including any allowable deviations pursuant to the Land Development Code.

The existing structure is more than 45 years old, requiring City staff to evaluate the proposal for historic significance. Staff determined that the property does not meet the local designation criteria as an individually significant resource under any adopted Historical Resources Board Criteria. The project was designed to comply with the development regulations of the underlying RM-1-1 Zone, including building height (29 feet 4 inches) that is below the 30-foot height limit, density, setbacks, and floor area ratio (.75) that is equal to the maximum (.75) allowed. No deviations or variances are required. Therefore, the proposed subdivision complies with the applicable zoning and development regulations of the Land Development Code including any allowable deviations pursuant to the Land Development Code.

3. The site is physically suitable for the type and density of development.

The project was designed to comply with the development regulations of the underlying RM-1-1 Zone, including building height (29 feet 4 inches) that is below the 30-foot height limit, density, setbacks, and floor area ratio (.75) that is equal to the maximum (.75) allowed. No deviations or variances are required.

The Community Plan designates the site as low medium residential (9-15 dwelling units per acre), and the creation of two dwelling units (condominiums) with one accessory dwelling unit is consistent with the prescribed density. The project site is developed and does not contain sensitive vegetation or biological resources, nor is the site within or adjacent to the City's Multiple Species Conservation Plan/Multiple Habitat Planning Area. No archaeological sites are located within the project site. Staff has also reviewed and accepted a preliminary drainage study prepared for the site that concluded that the project complies with the City's drainage regulations and standards. Therefore, the site is physically suitable for the type and density of development.

4. The design of the subdivision or the proposed improvements are not likely to cause substantial environmental damage or substantially and avoidably injure fish or wildlife or their habitat.

The project site is located approximately half a mile east from the Pacific Ocean within an urbanized area within the La Jolla community. The project site is developed and does not contain sensitive vegetation or biological resources, nor is the site within or adjacent to the City's Multiple Species Conservation Plan/Multiple Habitat Planning Area. Additionally, the project was determined to be exempt from the California Environmental Quality Act (CEQA) pursuant to CEQA Guidelines Section 15303 (New Construction). Therefore, the design of the subdivision or the proposed improvements will not cause substantial environmental damage or substantially and avoidably injure fish or wildlife or their habitat.

5. The design of the subdivision or the type of improvements will not be detrimental to the public health, safety, and welfare.

The project site is developed and does not contain sensitive vegetation or biological resources, nor is the site within or adjacent to the City's Multiple Species Conservation Plan/Multiple Habitat Planning Area. The project permit also contains specific requirements to ensure compliance with the regulations of the Land Development Code, including those adopted to protect public health, safety and welfare. Permit requirements include the following:

- Removing and replacing the existing full-width alley pavement with the current City standard improvement;
- Installing appropriate private back flow prevention devices;
- Constructing all public water and sewer facilities, per the City's Water and Sewer Facility design guidelines and regulations; and

Maintenance of all landscaping improvements.

Additionally, the Map Waiver for the project was reviewed and determined to be in compliance with the SDMC and Subdivision Map Act. Therefore, the design of the subdivision or the type of improvements will not be detrimental to the public health, safety, and welfare.

6. The design of the subdivision or the type of improvements will not conflict with easements acquired by the public at large for access through or use of property within the proposed subdivision.

The project site does not contain any easements acquired by the public at large for access or use of property within the subdivision. Therefore, the design of the subdivision or the type of improvements will not conflict with easements acquired by the public at large for access through or use of property within the proposed subdivision.

7. The design of the proposed subdivision provides, to the extent feasible, for future passive or natural heating and cooling opportunities.

The new single dwelling unit will have a halo roof to provide shade at the upper level. The installation of mini splits and controlled air stations will provide for energy efficiency. Additionally, the project will incorporate sustainable materials for floor assembly systems and insulation to control building temperatures, and building ceilings are lower which will limit energy use. Therefore, the design of the proposed subdivision provides, to the extent feasible, for future passive or natural heating and cooling opportunities.

8. The decision maker has considered the effects of the proposed subdivision on the housing needs of the region and that those needs are balanced against the needs for public services and the available fiscal and environmental resources.

The project promotes the Community Plan goal of creating home ownership opportunities and a range of housing types in La Jolla. The creation of two residential condominiums with one accessory dwelling unit does not adversely impact public resources. The project also requires payment of an inclusionary affordable housing in-lieu fee. The decision maker has reviewed the administrative record, including the project plans, environmental documentation and public testimony to determine the effects of the proposed subdivision on the housing needs of the region, and determined that the proposed subdivision for the creation of two residential condominiums is consistent with the housing needs in the La Jolla community. Therefore, the decision maker has considered the effects of the proposed subdivision on the housing needs of the region and that those needs are balanced against the needs for public services and the available fiscal and environmental resources.

9. The notices required by San Diego Municipal Code section 125.0431 have been given in the manner required.

The project site only has one occupant, the existing property owner/applicant. Therefore, there is no requirement to issue notices as required per SDMC Section 125.0431.

10. The project was not financed by funds obtained from a governmental agency to provide for elderly, disabled, or low income housing.

The project was not financed by funds obtained from a governmental agency to provide for elderly, disabled, or low-income housing. The project requires payment of an inclusionary affordable housing in-lieu fee.

11. For any project that was developed to provide housing for the elderly, disabled or to provide low income housing, provisions have been made to perpetuate the use for which the project was developed.

The project does not provide housing for the elderly, disabled or low-income housing.

That said Findings are supported by the minutes, maps, and exhibits, all of which are herein incorporated by reference.

BE IT FURTHER RESOLVED, that based on the Findings hereinbefore adopted by the Hearing Officer, Map Waiver No. 3231921 is hereby granted to Subdivider subject to the attached conditions which are made a part of this resolution by this reference

Blake Sonuga
Development Project Manager
Development Services Department

ATTACHMENT: Map Waiver Conditions

Internal Order No. 24009401

HEARING OFFICER RESOLUTION NO. CONDITIONS FOR MAP WAIVER NO. 3231921 5443 EADS AVENUE - PROJECT NO. 1070073 ADOPTED ON MARCH 30, 2024

GENERAL

- 1. This Map Waiver will expire on April 4, 2027.
- 2. Compliance with all of the following conditions shall be completed and/or assured, to the satisfaction of the City Engineer, prior to the recordation of the Final Map unless otherwise noted.
- 3. Prior to the Map Waiver expiration date, a Parcel Map to consolidate the existing lots into one lot shall be recorded in the Office of the San Diego County Recorder.
- 4. The Parcel Map shall conform to the provisions of the Coastal Development Permit No. 3185169.
- 5. The Subdivider shall defend, indemnify, and hold the City (including its agents, officers, and employees [together, "Indemnified Parties"]) harmless from any claim, action, or proceeding, against the City and/or any Indemnified Parties to attack, set aside, void, or annul City's approval of this project, which action is brought within the time period provided for in Government Code section 66499.37. City shall promptly notify Subdivider of any claim, action, or proceeding and shall cooperate fully in the defense. If City fails to promptly notify the Subdivider of any claim, action, or proceeding, or if the City fails to cooperate fully in the defense, Subdivider shall not thereafter be responsible to defend, indemnify, or hold City and/or any Indemnified Parties harmless. City may participate in the defense of any claim, action, or proceeding if City bears its own attorney's fees and costs, City defends the action in good faith, and Subdivider is not be required to pay or perform any settlement unless such settlement is approved by the Subdivider.

ENGINEERING

- 6. Tentative Map Waiver No. 3231921 shall comply with the conditions of Coastal Development Permit No. 3185169, satisfactory to the City Engineer.
- 7. The Subdivider shall comply with the "General Conditions for Tentative Subdivision Maps," filed in the Office of the City Clerk under Document No. 767688 on May 7, 1980. Only those exceptions to the General Conditions which are shown on the Map Waiver and covered in these special conditions will be authorized. All public improvements and incidental facilities shall be designed in accordance with criteria established in the Street Design Manual, filed with the City Clerk as Document No. RR-297376.

MAPPING

- 8. Prior to the expiration of the Tentative Map Waiver, a Parcel Map to consolidate and subdivide the 0.16-acre property into two (2) residential condominium units shall be recorded in the San Diego County Recorder's Office.
- 9. Prior to the recordation of the Parcel Map, taxes must be paid or bonded for this property pursuant to section 66492 of the Subdivision Map Act. A current original tax certificate, recorded in the office of the San Diego County Recorder, must be provided to satisfy this condition. Please note if tax bond is required as indicated in the tax certificate, please make sure that it is paid or posted, and submit evidence (e.g., filed bond letter or receipt from Clerk of the Board) indicating the required tax bond amount has been paid or bonded.
- 10. The Parcel Map shall be based on field survey and all lot corners must be marked with durable survey monuments pursuant to Section 144.0311(d) of the City of San Diego Land Development Codes and Subdivision Map Act Section 66495. All survey monuments shall be set prior to the recordation of the Parcel Map, unless the setting of monuments is deemed impractical due to the proposed improvements and/or grading associated with the project, in which case, delayed monumentation may be applied on the Parcel Map in accordance with Section 144.0130 of the City of San Diego Land Development Codes.
- 11. All subdivision maps in the City of San Diego are required to be tied to the California Coordinate System of 1983 (CCS83), Zone 6 pursuant to section 8801 through 8819 of the California Public Resources Code. The Parcel Map shall:
 - a. Use the California Coordinate System for its "Basis of Bearings" and express all measured and calculated bearing values in terms of said system. The angle of grid divergence from a true meridian (theta or mapping angle) and the north point of said map shall appear on each sheet thereof. Establishment of said Basis of Bearings may be by use of existing Horizontal Control stations or astronomic observations.
 - b. Show two measured ties from the boundary of the map to existing Horizontal Control stations having California Coordinate values of First Order accuracy. These tie lines to the existing control shall be shown in relation to the California Coordinate System (i.e., grid bearings and grid distances). All other distances shown on the map are to be shown as ground distances. A combined factor for conversion of grid-to-ground shall be shown on the map.

INFORMATION:

- The approval of this Map Waiver by the Hearing Officer of the City of San Diego does not authorize the Subdivider to violate any Federal, State, or City laws, ordinances, regulations, or policies including but not limited to, the Federal Endangered Species Act of 1973 and any amendments thereto (16 U.S.C. § 1531 et seq.).
- If the Subdivider makes any request for new water and sewer facilities (including services, fire hydrants, and laterals), the Subdivider shall design and construct such facilities in accordance with established criteria in the most current editions of the City of San Diego

ATTACHMENT 7

water and sewer design guides and City regulations, standards and practices pertaining thereto. Off-site improvements may be required to provide adequate and acceptable levels of service and will be determined at final engineering.

- Subsequent applications related to this Map Waiver will be subject to fees and charges based on the rate and calculation method in effect at the time of payment.
- Any party on whom fees, dedications, reservations, or other exactions have been imposed as conditions of approval of the Map Waiver, may protest the imposition within 90 days of the approval of this Map Waiver by filing a written protest with the San Diego City Clerk pursuant to Government Code Sections 66020 and/or 66021.
- Where in the course of development of private property, public facilities are damaged or removed, the Subdivider shall at no cost to the City, obtain the required permits for work in the public right-of-way, and repair or replace the public facility to the satisfaction of the City Engineer (San Diego Municipal Code § 142.0607).

Internal Order No. 24009401

Page 3

City of San Diego · Information Bulletin 620

August 2018



City of San Diego

Community Planning

SDy	Developmer 1222 First Av San Diego, C	e., MS-302	Commit	lee i	Form
Project Name: 7443 Eads Ave			Project Numbe 1070073	r:	
Community: La J	olla				
·	log into Op	enDSD at <u>https:</u>	nation (project ma .//aca.accela.com e Project Numbe	/SANDIE	
	e with Conditi	ons Listed Belov nding Recomme	v endations Listed E	Below	Date of Vote: May 04, 2023
# of Members Yes # of Members No 0 # of Members No 0		# of Me	lembers Abstain 1		
Conditions or Reco	mmendations	į			
☐ No Action (Please specify, e.g	., Need further inf	ormation, Split vote	, Lack of quorum, etc.	.)	
NAME: Suzanne B	aracchini				
TITLE: LJCPA Trus	stee/Secretary	,		DATE:	May 04, 2023
	Attach additio	nal pages if nece	essary (maximum 3	3 attachr	ments).

Visit our web site at www.sandiego.gov/development-services. Upon request, this information is available in alternative formats for persons with disabilities. DS-5620 (08-18) ONLINE FORM



THE CITY OF SAN DIEGO

Date of Notice November 6, 2023

NOTICE OF RIGHT TO APPEAL ENVIRONMENTAL DETERMINATION

DEVELOPMENT SERVICES DEPARTMENT

SAP No. 24009401

PROJECT NAME/NUMBER: 7443 Eads Avenue /1070073

COMMUNITY PLAN AREA: La Jolla

COUNCIL DISTRICTS: 1

LOCATION: The project is located at 7443 Eads Avenue. La Jolla, CA 92037

PROJECT DESCRIPTION: COASTAL DEVELOPMENT PERMIT (CDP) and Tentative Map Waiver for the demolition of an existing detached garage and construction of a new 3,327- square-foot (SF) dwelling unit; construction of an 800 SF Accessory Dwelling Unit (ADU); and construction of a 256 SF Junior ADU to be attached to an existing residence. The Tentative Map Waiver is for subdivision of the 6969.6 sq Ft property to allow the creation of two condominium units. The project is located at 7443 Eads Avenue on a 0.16-acre site within the RM-1-1 zone, Coastal (Non-Appealable) Overlay Zone, and Coastal Height Limit Overlay Zone of the La Jolla Community Plan area. The project complies with all height and bulk regulations and is located on a site that can be served by public utilities.

ENTITY CONSIDERING PROJECT APPROVAL: City of San Diego, Hearing Officer

ENVIRONMENTAL DETERMINATION: Section 15303 (New Construction)

ENTITY MAKING ENVIRONMENTAL DETERMINATION: City of San Diego, Development Services Department

STATEMENT SUPPORTING REASON FOR ENVIRONMENTAL DETERMINATION: The City of San Diego conducted an environmental review and determined that the project would qualify to be exempt from CEQA pursuant to CEQA Section 15303 (New Construction). Section 15303 applies to projects that consist of the construction of a limited number of new small facilities or structures, including the construction of up to three single family units. Since the project is constructing one single family residence, on a previously developed site it was determined that the CEQA exemption was appropriate and the exceptions listed in CEQA Section 15300.2 would not apply.

ATTACHMENT 9

DEVELOPMENT PROJECT MANAGER:

Blake Sonuga

MAILING ADDRESS:

1222 First Avenue, MS 501, San Diego, CA 92101-4153

PHONE NUMBER/EMAIL:

(619) 687-5928 MSonuga@sandiego.gov


On November 6, 2023 the City of San Diego made the above-referenced environmental determination pursuant to the California Environmental Quality Act (CEQA). This determination is appealable to the City Council. If you have any questions about this determination, contact the City Development Project Manager listed above.

Applications to appeal CEQA determinations made by staff (including the City Manager) to the City Council must be filed in the office of the City Clerk within 10 business days from the date of the posting of this Notice so the final day to file an appeal is November 21, 2023. Appeals to the City Clerk must be filed by email or in-person as follows:

- 1) Appeals filed via E-mail: The Environmental Determination Appeal Application Form <u>DS-3031</u>can be obtained at https://www.sandiego.gov/sites/default/files/legacy/development-services/pdf/industry/forms/ds3031. Send the completed appeal form (including grounds for appeal and supporting documentation in pdf format) by email to https://exandiego.gov by 5:00p.m. on the last day of the appeal period; your email appeal will be acknowledged within 24 business hours. You must separately mail the appeal fee by check payable to the City Treasurer to: City Clerk/Appeal, MS 2A, 202 C Street, San Diego, CA 92101. The appeal filing fee must be United States Postal Service (USPS) postmarked) before or on the final date of the appeal. Please include the project number on the memo line of the check.
- 2) Appeals filed in person: Environmental Determination Appeal Application Form <u>DS-3031</u> can be obtained at https://www.sandiego.gov/sites/default/files/legacy/development-services/pdf/industry/forms/ds3031.pdf. Bring the fully completed appeal application <u>DS-3031</u> (including grounds for appeal and supporting documentation) to the City Administration Building—Public Information Counter (Open 8:00am to 5:00pm Monday through Friday excluding City-approved holidays), 1st Floor Lobby, located at 202 C Street, San Diego, CA 92101, by 5:00pm on the last day of the appeal period. The completed appeal form shall include the required appeal fee, with a check payable to: City Treasurer.

The appeal application can also be obtained from the City Clerk, 202 'C' Street, Second Floor, San Diego, CA 92101.

This information will be made available in alternative formats upon request.

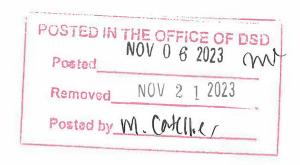



City of San Diego Development Services 1222 First Ave., MS 302 San Diego, CA 92101 (619) 446-5000

Ownership Disclosure Statement

FORM


DS-318

October 2017

Approval Type: Check approprie	ate how for time of	annoval(e) reque	cted: D Neighborhoo	d Use Permit	X Coastal Develope	ment Permit
☐ Neighborhood Development ☐ Tentative Map ☐ Vesting Ten	Permit Site Dev	velopment Perm	it 🗅 Planned Develop	ment Permit	Conditional Use	Permit 🗆 Variance
Project Title: 7443 EF	105 AVE L	A JOUA	CA	Project N	o. For City Use Onl	iv:
Project Address: 1443	EADS AVE	IA JOU	A CA			
rioject mauress.	,					
Specify Form of Ownership/Le	egal Status (nleas	se check):				
☐ Corporation ☐ Limited Liabil			Corporat	te Identificatio	n No	
Partnership Individual			N.			
By signing the Ownership Disclawith the City of San Diego on owner(s), applicant(s), and othe individual, firm, co-partnership with a financial interest in the individuals owning more than officers. (A separate page may ANY person serving as an offi A signature is required of at lenotifying the Project Manager ownership are to be given to the accurate and current ownership.	the subject proper financially intered, joint venture, assapplication. If the 10% of the shares, be attached if neceer or director of any changes in the project Manage	erty with the inte ested persons of sociation, social of applicant include. If a publicly-ow sessary.) If any p f the nonprofit of operty owners. I ownership durier at least thirty of	ent to record an encu- the above referenced club, fraternal organizates a corporation or pured corporation, inclu- erson is a nonprofit or organization or as tru- Attach additional pag- ing the time the applicates prior to any publication or as tru-	imbrance againg property. A cation, corpora cartnership, in ude the name rganization or ustee or beninges if needed. Cation is being ic hearing on	inst the property. financially interested ation, estate, trust, iclude the names, ties, titles, and addressed arust, list the name eficiary of the non Note: The application of the processed or concept the processed or concept financially processed or concept finan	Please list below the ed party includes any receiver or syndicate itles, addresses of all sses of the corporate nes and addresses of profit organization. It is responsible for sidered. Changes in
Property Owner						
Name of Individual: Ting H	Wright	Willram	K. Mueller	_ 🔏 Owner	☐ Tenant/Lessee	☐ Successor Agency
Street Address: 7443 E	ads Are					
City: La Jolla					State: CA	Zip: 92037
Phone No.: 619-846 - Z	302	Cax No.	()	Email: 46	Mian Robert	Zip: 92037 Muche 1 @910
Signature	1	6 U		Date: 8	2.30.ZD	22
Additional pages Attached:	☐ Yes	∆ (No	(//			
Applicant			<u> </u>			
Name of Individual: CLAUDE	- ANTHONY	MARENGO	, AGENT	_ Owner		Successor Agency
Street Address: MARENGO	MORTON AK	ECHITECTS,	7724 GIRAR	D, 2NO	FLOUR	
City: LA JOLLA					State: CA	Zip: 92037
Phone No.: 619 417/111	1	Fax No.:	_	Email: CA	MARENGOOM	
Signature 1 40	Ca 1/2			Date: 8/	30/22	
Additional pages Attached	□ Yes	SCNo			,	
Other Financially Interested Polyame of Individual:				□ Owner	☐ Tenant/Lessee	☐ Successor Agency
						_ 552255501 / (6516)
Street Address:					5 1-1	71
City:						Zip:
Phone No.:		Fax No.:				
Signature:				Date:		
Additional pages Attached:	Yes	□ No				

EADS DEVELOPMENT

7443 EADS AVENUE, LA JOLLA, CA 92037

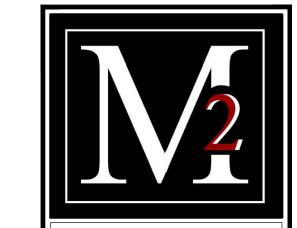

Marengo Morton **Architects**

7724 Girard Ave.

Second Floor La Jolla, CA 92037 Tel. (858) 459-3769 Fax. (858) 459-3768 Michael Morton AIA Claude Anthony Marengo Desa



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PROJECT DATA

350-611-0300

BLK 6*LOTS 9 & 10*

SPC and the 2019 CEC.

ADU #1:

Lot Area

Max. F.A.R. [.

Total Area

Landscape Provided:

Existing F.A.R.
Proposed F.A.R.
Existing Impervious Area:
(E) & Proposed Impervious Area:

Zone | Transit Priority Area

Geo Hazard Category 52, Slopes 25% Or Grater

7443 Eads Avenue, La Jolla Ca, 92037

Associated Amendments In SDMC.

California Residential Code (CRC), 2019 Edition &

California BLDG. Code (CBC) Based On 2019 IBC. National Electrical Code (NEC), 2019 Edition National Mechanical Code (CMC), 2019 Edition California Plumbing Code (CPC), 2019 Edition

Coastal Overlay Zone (N-APP-2) | Coastal Height Limit Overlay Zone Parking Impact Overlay Zone (coastal Impact) | Transit Area Overlay

Allowed Proposed Difference

29'-4 ½" --

2,142 S.f. (30%)

7,140 S.f.

5,355 S.f.

5,061 S.f.

1,906 S.f. (0.26)

2,199.6 S.f. (30.8%)

Proposed Total 1,556 S.F. 436 S.F. 1,992 S.F.

> 1,329 S.F. 1,329 S.F. 842 S.F. 842 S.F. 1,156 S.F. 1,156 S.F. 36 S.F. 36 S.F.

150 S.F. 150 S.F.

5,355 S.F.

141.0302(c)(2)(D)

800 S.F.

5,355 S.f. (0.75) + ADU #1 (Per 141.0302(c)(2)(E

| 15 Ft/20 Ft | 15 FT/20 FT | --5 Ft / 8 Ft | 5 FT/8 FT | --

San Diego County Municipal Code (SDC), Project shall

comply with Title 24 and 2019 CBC, 2019 CMC and 2019 01/26/2022 PROJECT START

FEASIBILITY PHASE PROJECT NO. 2021-46

REVIEWED BY CAM


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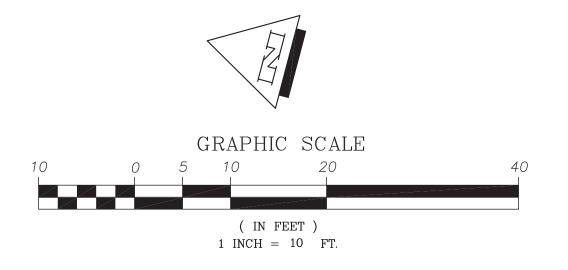
DATE 02/08/2024

Marengo Morton Architects, Inc. is providing, by agreement with certain parties, materials stored electronically. The parties recognize that data, plans, specifications, reports, documents, or other information recorded on or transmitted as electronic media (including but not necessarily limited to "CAD documents") are subject to undetectable alteration, either intentional or unintentional, due to, among other causes, transmission, conversion, media degradation, software error, or human alteration. Accordingly, all such documents are provided to the parties for informational purposes only and not as an end product nor as a record document. Any reliance thereon is deemed to be unreasonable and unenforceable. The signed and stamped hard copies with the wet signature of the Architect of Record are the Architect's Instruments of Service and are the only true contract documents of record.

TITLE SHEET

		CCORE OF WORK	DE
SHEET INDEX	PROJECT TEAM	SCOPE OF WORK	PR
GENERAL: TS1 Title Sheet GN1 Specifications GN2 Specifications GN3 Specifications GN4 Green Notes Survey Map Waiver L01 Landscape Plan ARCHITECTURAL: A011 Proposed Site Plan A012 Drainage Plan A020 Existing/Demo Floor Plan (Main House) A021 Existing/Demo Floor Plan (Garage) A022 Proposed Floor Plan (Main House) A023 Proposed Floor Plan (Back House) A024 Proposed Second Floor Plan (Back House) A025 Proposed Third Floor Plan (Back House) A041 Proposed Roof Plan (Back House) A050 Proposed Elevation (Front House) A051 Proposed Elevation (Front House) A052 Proposed Elevation (Front House) A053 Proposed Elevation (Front House) A053 Proposed Elevation (Front House)	OWNER'S Tina Marie Wright & William Robert Mueller 7443 Eads La Jolla, CA 92037 ARCHITECT Marengo Morton Architects 7724 Girard Avenue, Second Floor La Jolla, CA 92037 Telephone: (858) 459-3769 Fax: (858) 459-3768 Contact: Claude Anthony Marengo CAMarengo@m2a.io Cell: (619) 417-1111 SURVEY San Diego Land Surveying & Engineering, Inc. 7028 Convoy Court San Diego, CA 92111-1017 Telephone: (858) 565-8362 Fax: (858) 565-4354 Contact: Robert Bateman RBateman@sdlse.com Cell: (858) 244-0420	PROJECT SCOPE Propose to demolish existing garage at rear of property and construct a new dwelling Unit #2 of 3,327 sq ft, an ADU#1 of 800 sq ft and an addition to the main house of 436 sq ft, process a map waiver and become condos for 2 units with an ADU located at 7443 Eads Av.	Project Information Project Address: Assessors Parcel Number: Legal Description: Year Built Building Code: Occupancy Type: R3 Number Of Dwellings: 1 Construction Type: VA Number Of Stories: 1 Lot Area: 7,140 S.f. Zoning Information RM-1-1 Zone: R2 Overlay Zones: Coastal O Parking In Zone Tra Geo Hazard Zone: Geo Hazard Setbacks
A054 Proposed Elevation (Back House)		VICINITY MAP	Front (street Frontage): Interior Side:
A055 Proposed Elevation (Back House) A056 Proposed Elevation (Back House) A057 Proposed Elevation (Back House) A061 Section (Back House) A062 Section (Back House) A063 Section (Streets Cross Sections)		Eads Development 7443 Eads Ave. La Jolla, CA 92037	Interior Side: Rear: Building Height Limitations: Max. Floor Area Ratio (F.A.R.): Parking Spaces: Building Areas: Existing House First Floor: Unit #2 First Floor: Unit #2 Second Floor: Unit #2 Third Floor: Cabana for Unit #2: Total Area ADU #1 Egress/Ingress:



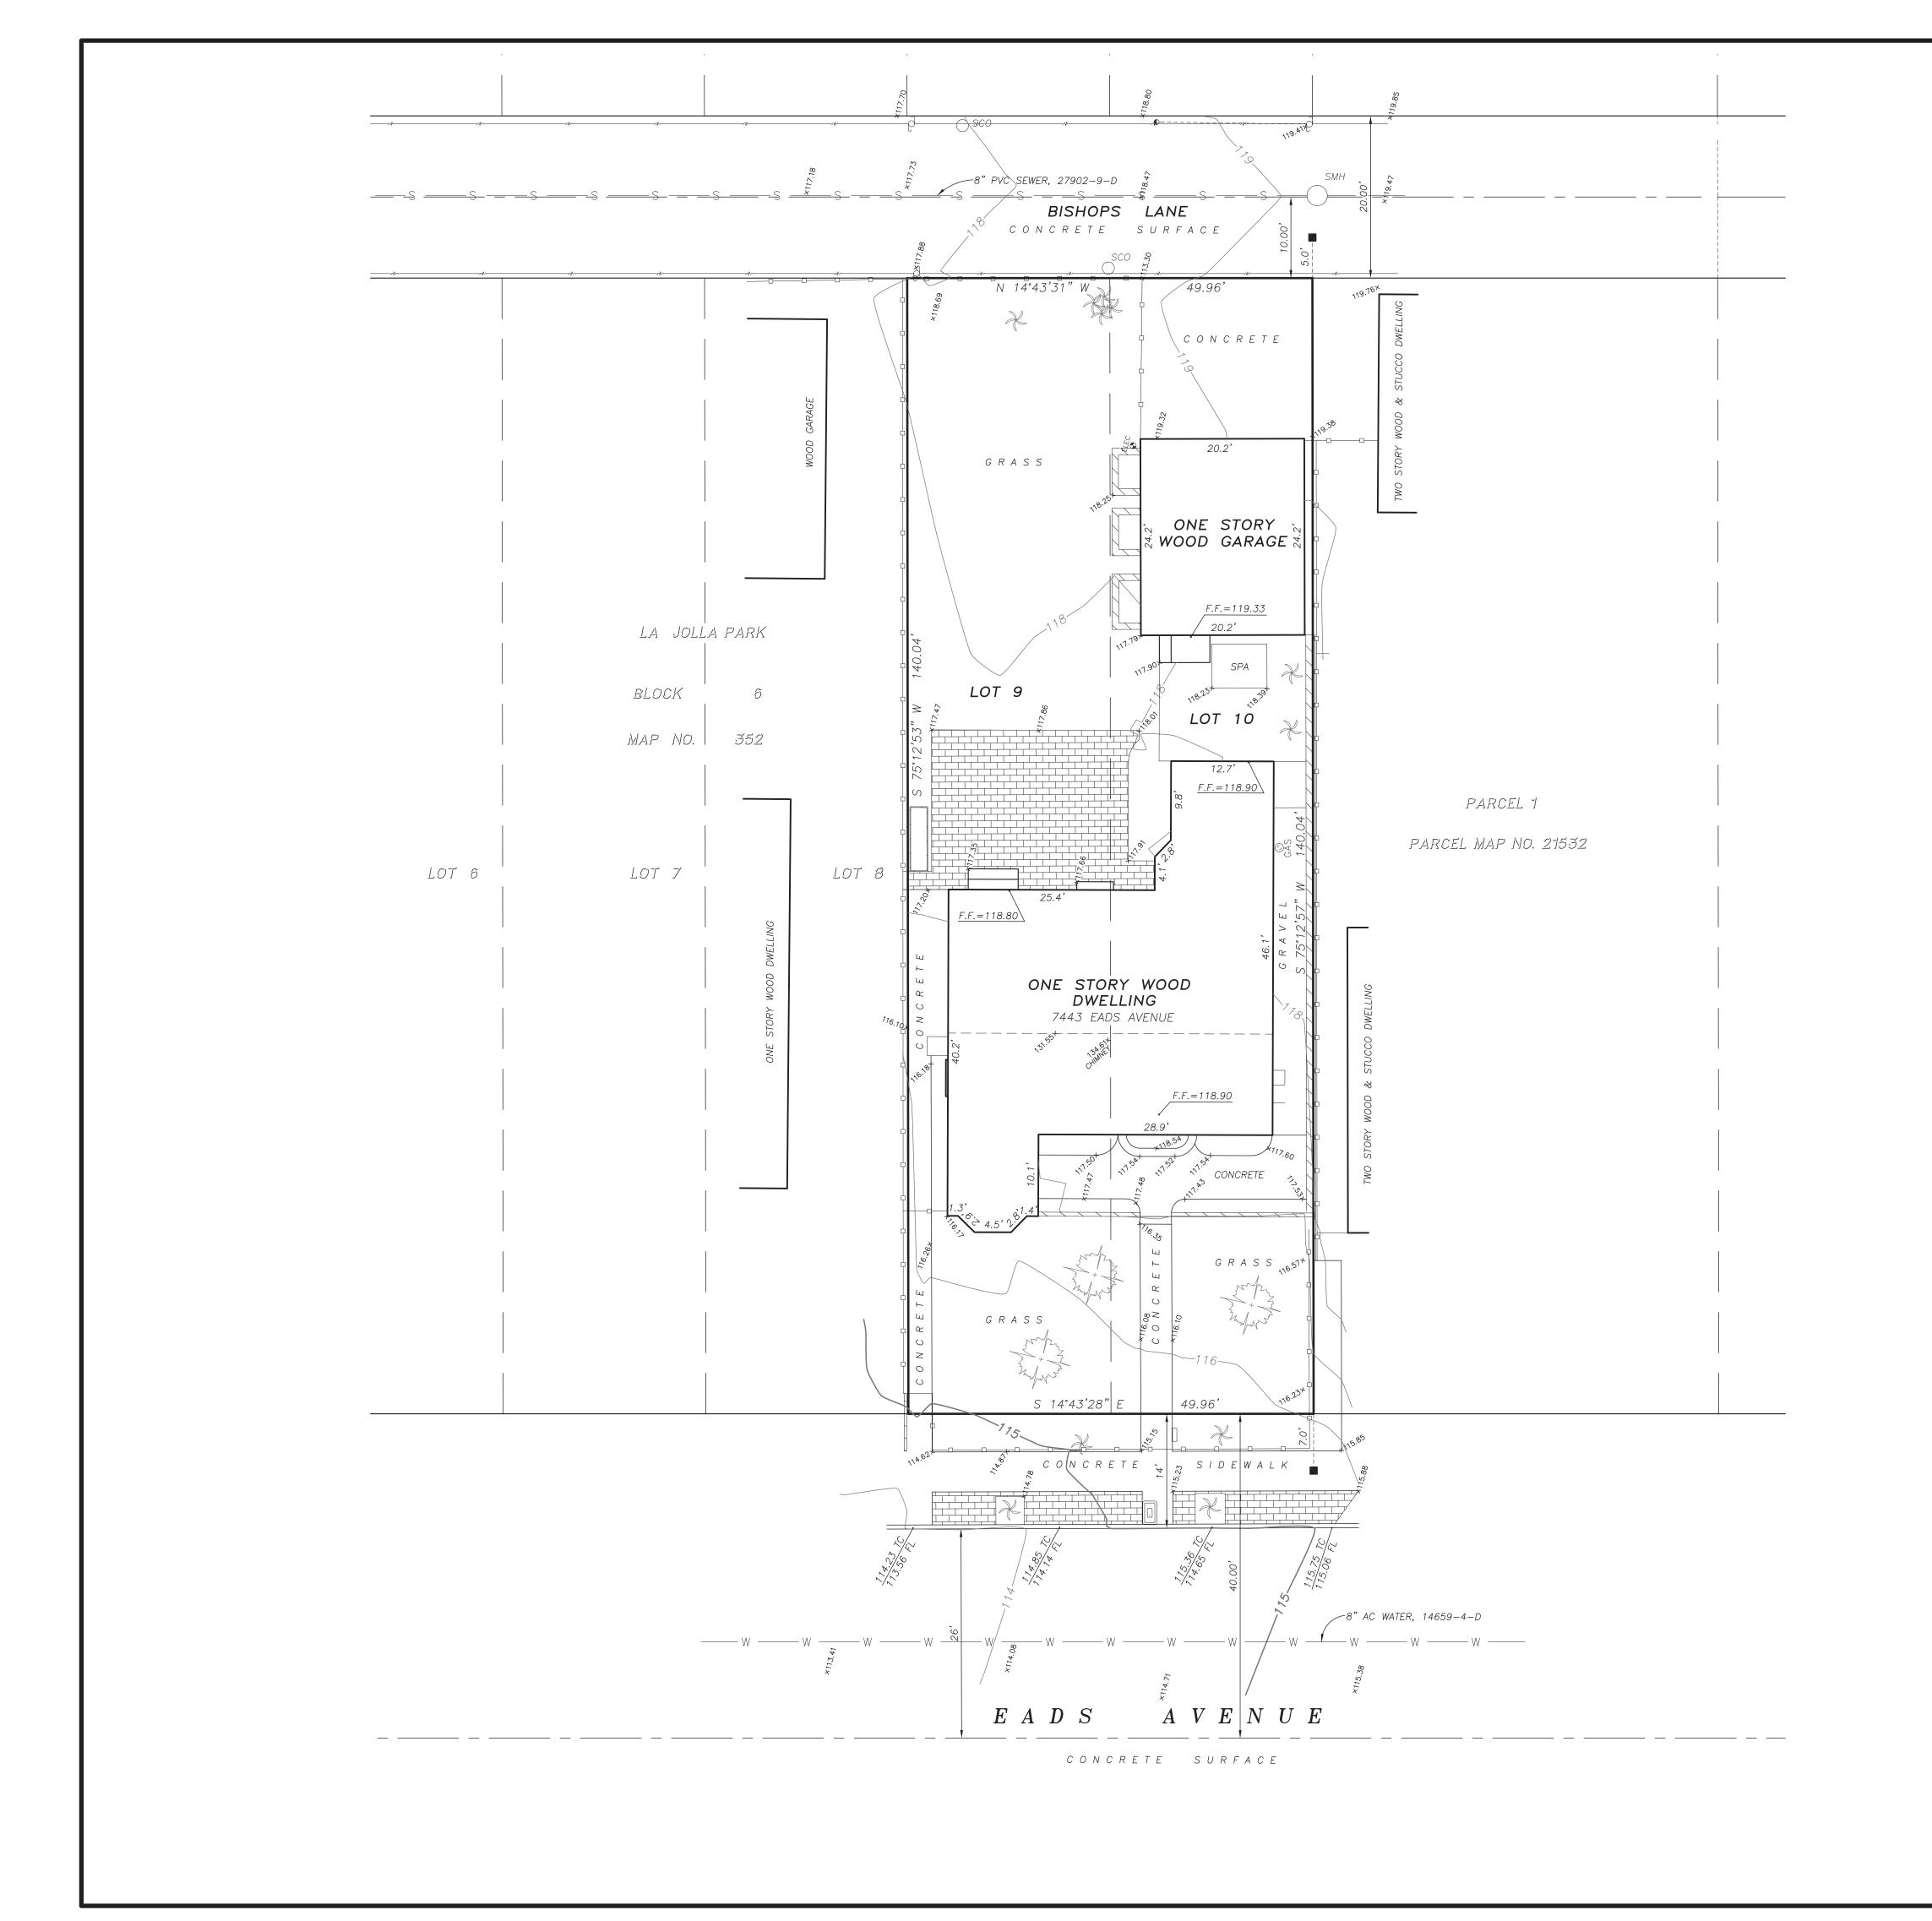

LEGEND:

- INDICATES FOUND LEAD & DISC, L.S. 7046
- INDICATES WATER METER
- INDICATES POWER POLE
- INDICATES GUY/ANCHOR POLE
- INDICATES SEWER CLEAN OUT
- INDICATES SEWER MANHOLE
- INDICATES FINISH FLOOR INDICATES TOP OF CURB
- INDICATES FLOW LINE
- ------ INDICATES PROPERTY LINE
- ------ INDICATES OVERHEAD POWERLINE
- INDICATES WALL
- ------ W ------ INDICATES WATER LINE
- -----S ----- INDICATES SEWER LINE

LEGAL DESCRIPTION:

LOTS 9 AND 10 IN BLOCK 6 OF LA JOLLA PARK, IN THE CITY OF SAN DIEGO, COUNTY OF SAN DIEGO, STATE OF CALIFORNIA, ACCORDING TO MAP THEREOF NO. 352, FILED IN THE OFFICE OF THE COUNTY RECORDER OF SAN DIEGO COUNTY, MARCH 22, 1887.

BASIS OF ELEVATION:

NORTHEAST BRASS PLUG FAY AVENUE AND PEARL STREET ELEVATION = 113.882 M.S.L.



Rabert J. Saterna ROBERT J. BATEMAN, P.L.S. 7046


TOPOGRAPHY SURVEY


For the exclusive use of: WILLIAM MUELLER 7443 EADS AVENUE LA JOLLA, CALIFORNIA 92037

San Diego Land Surveying & Engineering, Inc. 7028 Convoy Court, San Diego, CA 92111-1017 Phone: (858) 565-8362 Fax: (858) 565-4354

Date: 3/11/2022 Revised: Revised:

CC. 0/ 11/2022	ite vibea.	ite visea.
ale: 1"=10'	Drawn by: R.J.B	Sheet 1 of 1 Sheet
awing: Eads Ave 74.	35 Торо	A.P.N. 350-611-03

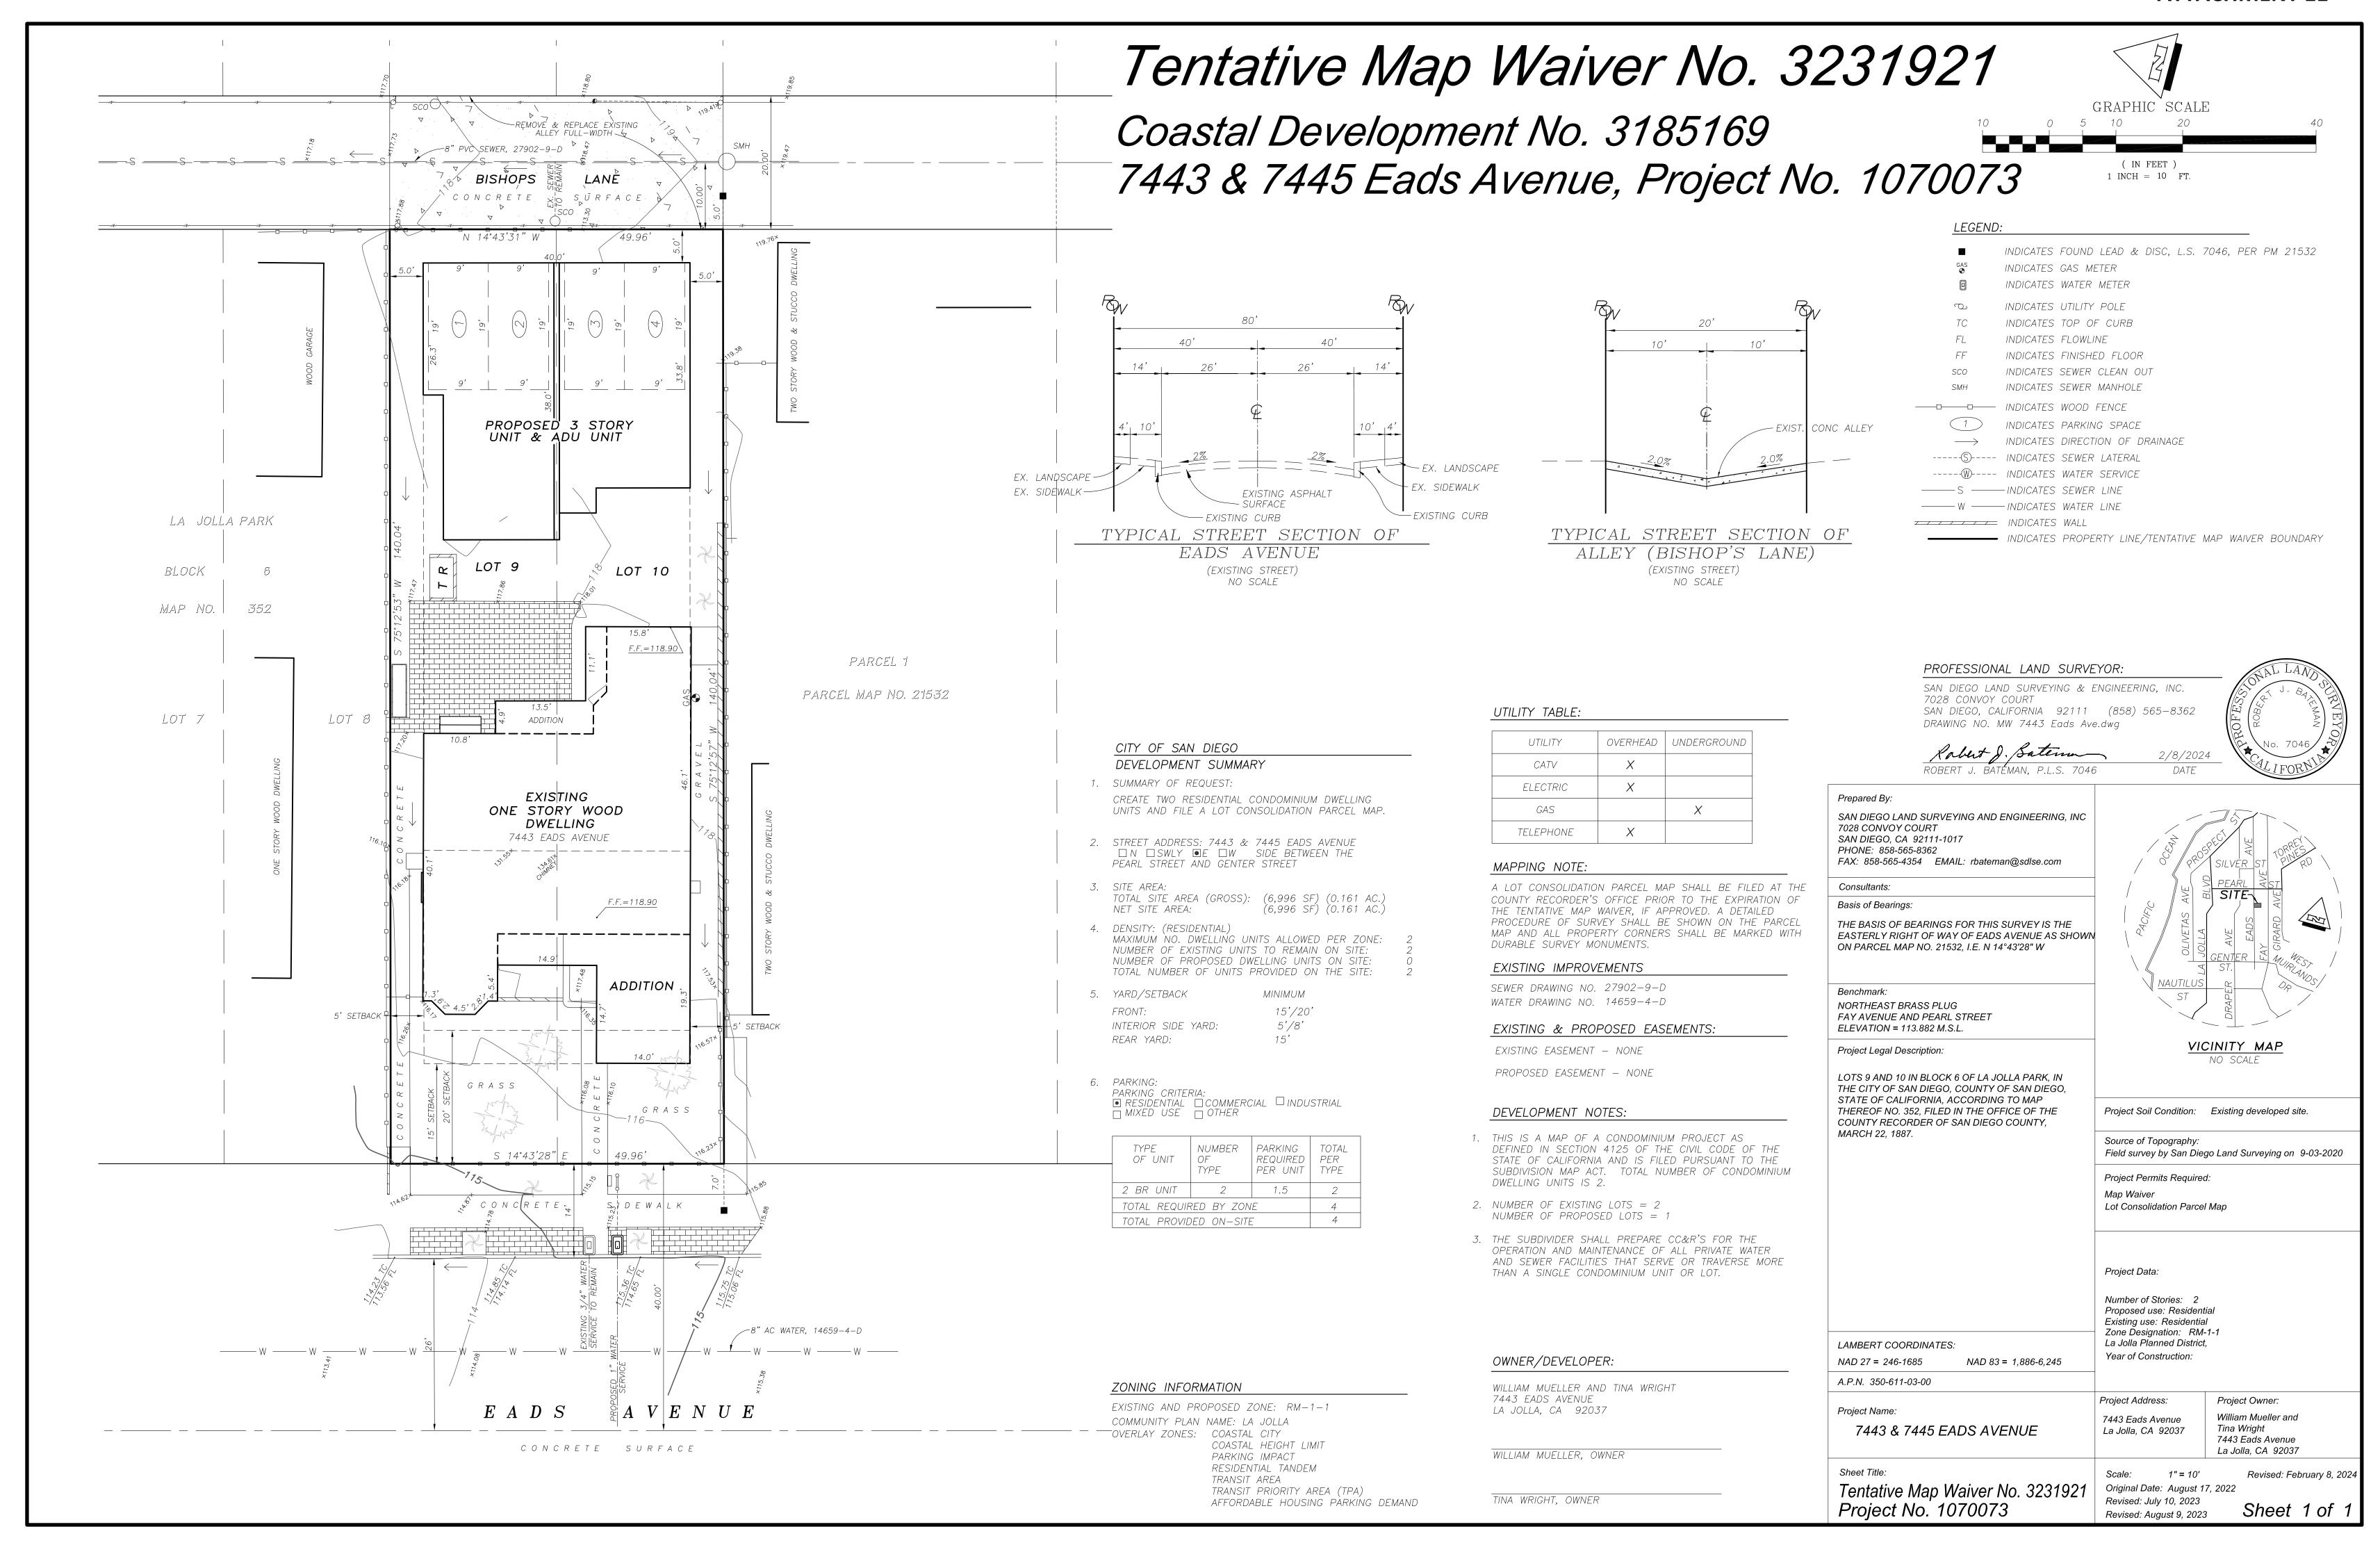

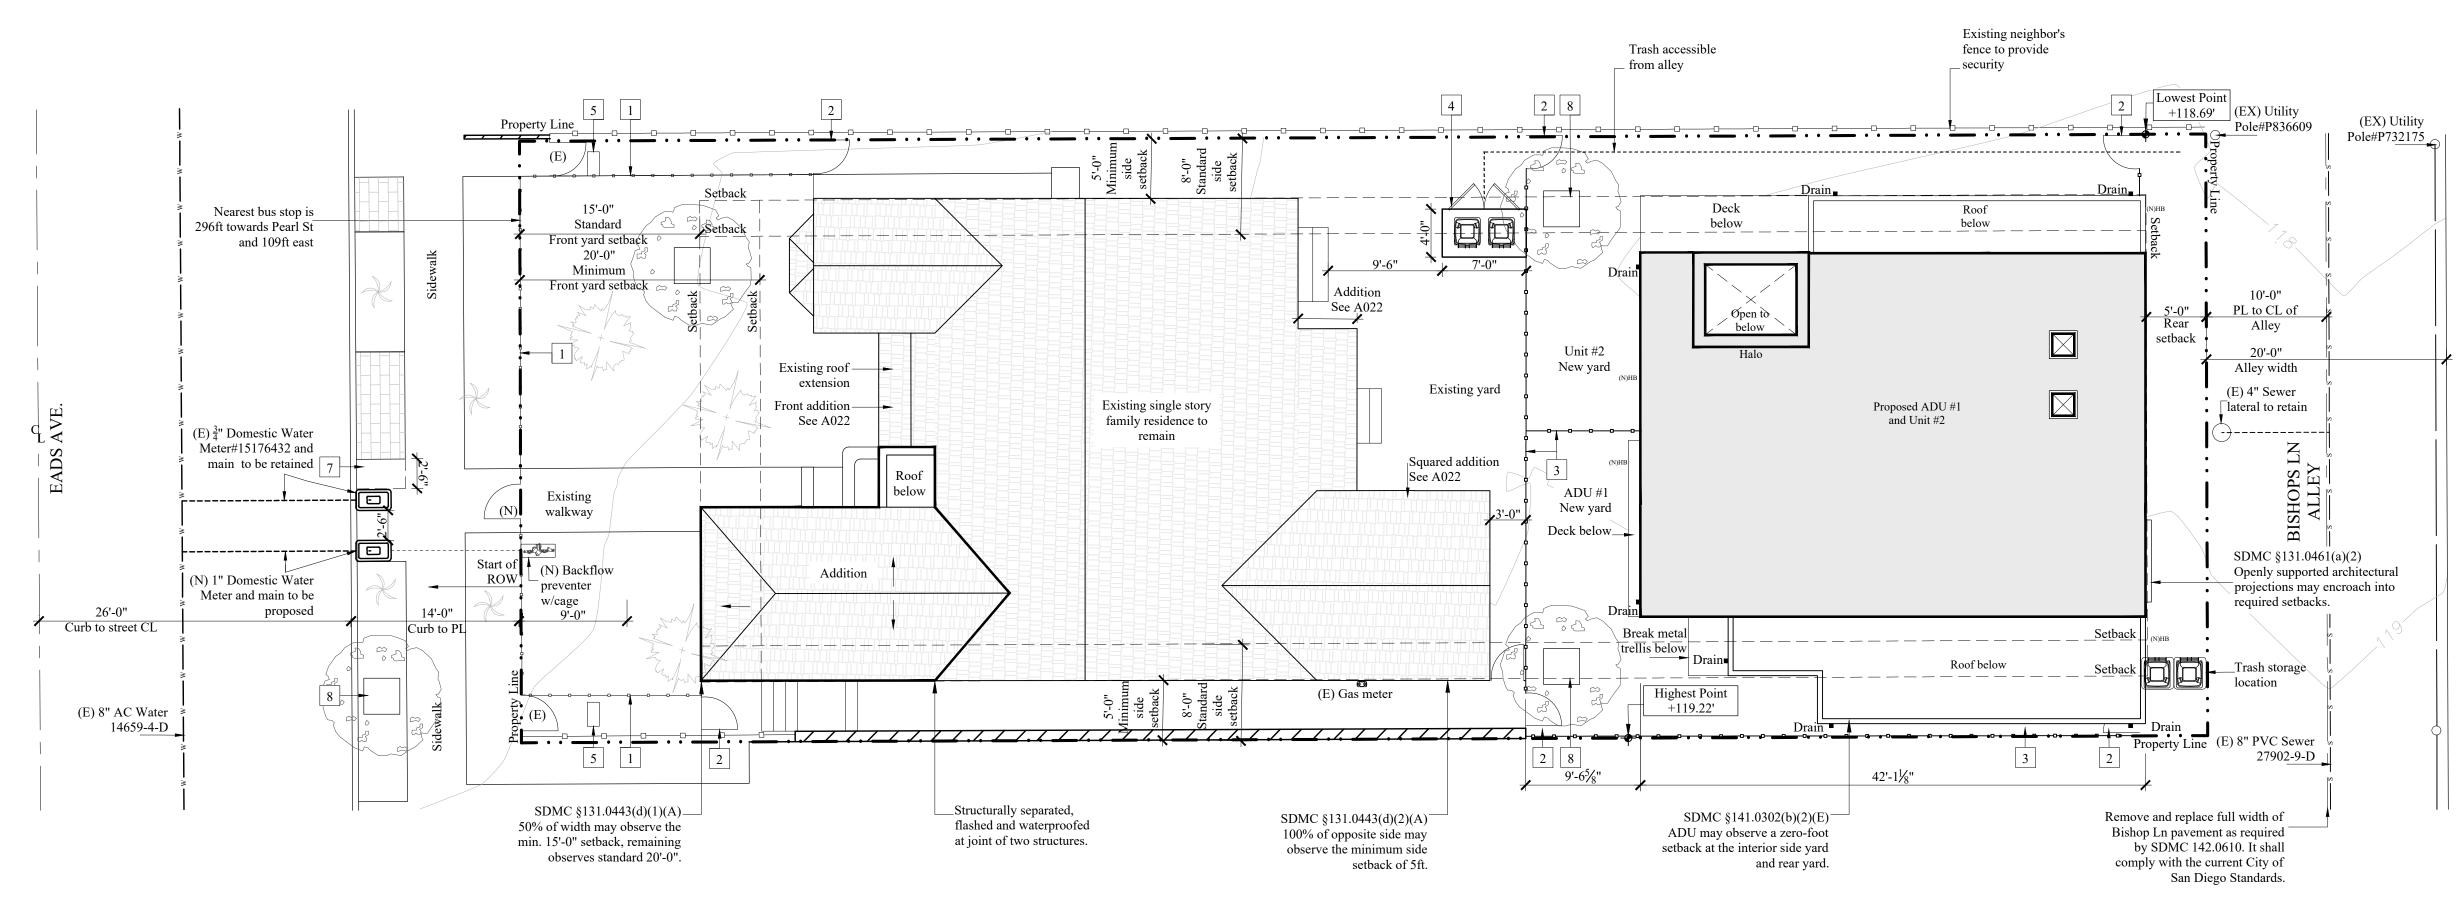

PROPOSED SITE PLAN



ATTACHMENT 11

Marengo Morton Architects

7724 Girard Ave.
Second Floor
La Jolla, CA 92037
Tel. (858) 459-3769
Fax. (858) 459-3768
Michael Morton AIA

ENE MORE

RENEWAL

04/30/2025

Claude Anthony Marengo Desa

All design, ideas and arrangements as indicated on these drawings are the legal property of Marengo Morton Architects, Incorporated and the specific project for which they were prepared as indicated on the project title block. Reproduction, publication or re-use by any method, in whole or part, without the express written consent of Marengo Morton Architects. Incorporated is prohibited. There shall be no changes, substitutions, modifications or

deviations from these drawings or accompanying specifications without the consent of Marengo Morton Architects, Incorporated. Visual, physical, or electronic contact or use of these drawings and attached specifications shall constitute the acceptance of all these restrictions.

ADS DEVELOPMENT
7443 Eads Avenue
La Jolla CA, 92037

REVISIONS
01/26/2022 PROJECT START

 \triangle

FEASIBILITY PHASE

PROJECT NO. 2021-46

DRAWN BY AP

REVIEWED BY CAM

DATE 02/08/2024

SHEET TITLE PROPOSED

Marengo Morton Architects, Inc. is providing, by agreement with certain parties, materials stored electronically. The parties recognize that data, plans, specifications, reports, documents, other information recorded on or transmitted as electronic medi (including but not necessarily limited to "CAD documents") are subject to undetectable alteration, either intentional or unintentional, due to, among other causes, transmission, conversion, media degradation, software error, or human alteration. Accordingly, all such documents are provided to the parties for informational purposes only and not as an end product nor as a record document. Any reliance thereon is deemed to be unreasonable and unenforceable. The signed and stamped hard copies with the wet signature of the Architect of Record are the Architect's Instruments of Service and are the only true contract documents of record.

A011

SITE PLAN

TOTAL DISTURBANCE AREA

GENERAL SITE NOTES

existing utilizes to the tenant space are proposed.

complete scope of work.

utilities, and indicate utility type.

subcontractors.

the architect's office.

city-approved locations.

installed level and plumb.

1. No existing/proposed easements.

1 (N) 3ft. Picket wood fence

2 (N) 6ft. Solid wood gate

(N) 6ft. Solid wood fence

screening enclosure.

(N) Linear drainage

Height:

KEY NOTES

A. The site plan is for general site reference only. Refer to other construction documents for

walls are involved. Minor alterations to existing electrical, water, phone and other

This is an interior tennant improvement plan only, only new or relocation of non-bearing

Before commencing any site foundation or slab cutting or excavation the contractor shall verify locations of all site utilities, dimensions and conditions. These include but are not

limited to property lines, setback location to all new or existing walls, easements (if any),

existing site utilities, including water, sewer, gas and electrical lines and any other new or

existing site items which could affect in any way the construction of the building. Flag or otherwise mark all locations of site property lines, easements (if any) underground

All conditions or dimensions on these plans shall be verified in the field by the general

contractor with actual site conditions. Written dimensions shall take precedence over

The contractor or sub-contractor shall notify the architect if any conflicts or discrepancy occurs between this information on this plan and actual field conditions. Do not proceed with work in conflict with these drawing until written or verbal instructions are issued by

Protect and mark all existing building structure including walls, beams, columns, area

scope of the tenant improvement, and mark perimeter of construction zone.

cable or other data links with are connected to the building.

SITE PLAN NOTES

2. Bus transit distance of 409ft heading north/east via Eads Ave. and Pearl St.

(N) Trash area to comply with the following SDMC sections:

minimum storage area of 24 sq ft. We're proposing 28 sq ft.

(N) Catch basin that will discharge to existing landscape

Brick to be removed and replaced with concrete

New Magnolia grandiflora 'Little Gem'

Common name: Little Gem Magnolia

Container size: 36"x36"

 $\S142.0810(b)(3) = \text{Trash enclosure is accessible from the alley.}$

§142.0810(c) = Structure shall be screened with a minimum 6ft-high solid

 $\S142.0810(d) = A \text{ sign should be placed on the exterior of each trash enclosure.}$

§142.0820 = Trash enclosures follow Table 142-08B (2-6 dwelling units need a

separation walls, and other items that are part of the existing structure and not part of the

Coordinate with other tenants the temporary shut-off of any site utilities, including but not

limited to electrical service, gas service, water service, sewer service, telephone service,

Locate refuse bin at approved on-site location. contractor shall dispose of all site refuse at

Verify the level and plumb of existing floors, walls, ceilings and other items, which will not be changed, so that any attached structure, walls, ceiling or other components can be

No trees or shrubs whose height will be 3' at maturity shall be installed within 5' of any publicly maintained water facilities or within 10' of any publicly maintained sewer

Provide building address numbers, visible and legible from street or road fronting the

scaled dimensions and shall be verified on the job site. On-site verification of all dimensions and conditions shall be the sole responsibility of the general contractor and

New building footprint	1, 782 S.F.
New hardscape/concrete areas	280 S.F.
New landscape areas	106.3 S.F.
Removal of existing building footprint	0 S.F.
Removal of existing concrete	526.8 S.F.
Removal of existing landscape areas	0 S.F.
TOTAL DISTURBANCE AREA	2,695.1 S.F.


NEW/REPLACED IMPERVIOUS AREA

a) Existing impervious area (Ex. bldg. footprint & Ex. hardscape areas)	
	3,723 S.F.
b) New impervious area (Bldg. footprint, parking lot, walkways, hardscape	
areas, etc.)	1,338.2 S.F.
Total existing & new impervious area:	5,061.2 S.F.

EARTHWORK QUANTITIES

Cut quantities:	4,845 CYD
Fill quantities:	0 CYD
Import/export:	4,845 CYD
Max cut depth:	3 FT
Max fill depth:	0 FT

NOTE Disturbance area shall include: New building(s) footprint(s), new hardscape/concrete areas, new landscape areas, removal of existing building(s) footprint(s), concrete, landscape areas, grading, etc.

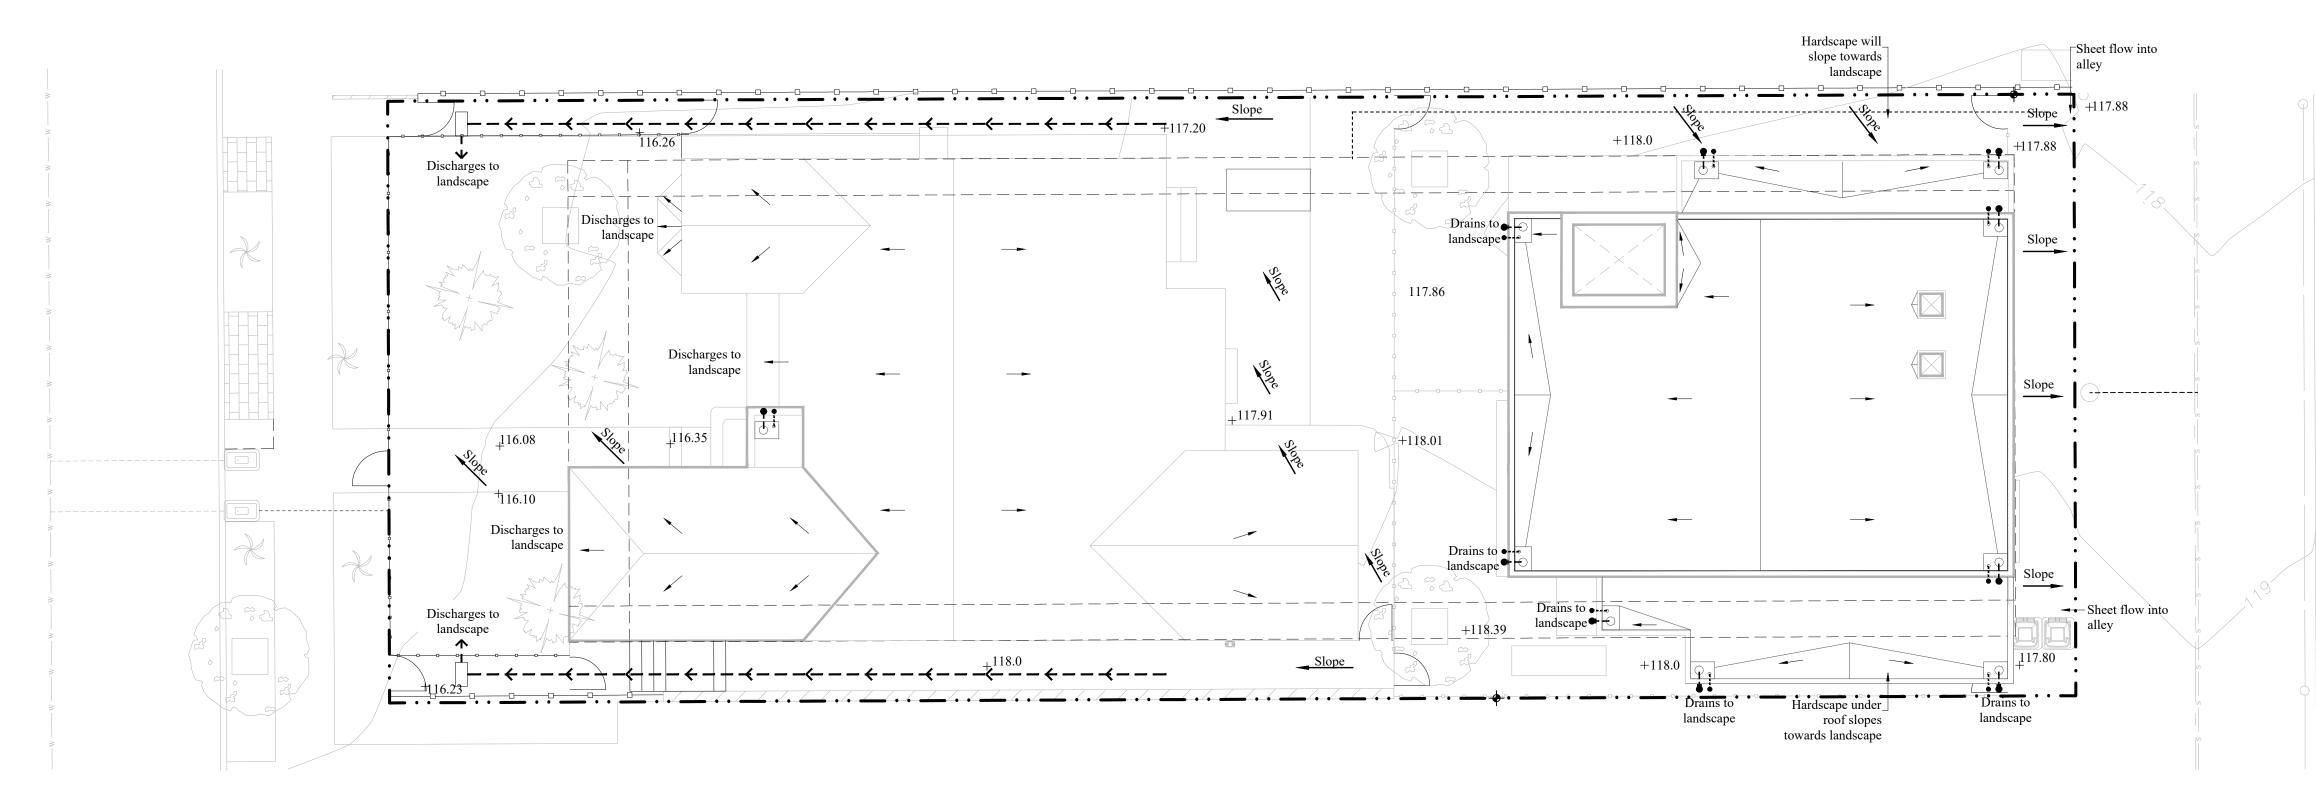

DRAINAGE PLAN

GENERAL SITE NOTES

A. The site plan is for general site reference only. Refer to other construction documents for complete scope of work.

B. Before commencing any site foundation or slab cutting or excavation the contractor shall verify locations of all site utilities, dimensions and conditions. These include but are not limited to property lines, setback location to all new or existing walls, easements (if any), existing site utilities, including water, sewer, gas and electrical lines and any other new or existing site items which could affect in any way the construction of the building. Flag or otherwise mark all locations of site property lines, easements (if any) underground utilities, and indicate utility type.

C. All conditions or dimensions on these plans shall be verified in the field by the general contractor with actual site conditions. Written dimensions shall take precedence over scaled dimensions and shall be verified on the job site. On-site verification of all dimensions and conditions shall be the sole responsibility of the general contractor and

D. The contractor or sub-contractor shall notify the architect if any conflicts or discrepancy occurs between this information on this plan and actual field conditions. Do not proceed with work in conflict with these drawing until written or verbal instructions are issued by the architect office.

E. Locate refuse bin at approved on-site location. Contractor shall dispose of all site refuse at city-approved locations.

F. All grades shown / proposed are existing.

G. No trees or shrubs whose height will be 3'-0" at maturity shall be installed within 5'-0" of any publicly maintained water facilities or within 10'-0" of any publicly maintained sewer

H. No existing or proposed transit stops at site.

I. Provide building address number, visible and legible from the street or road fronting the property per fhps policy P-00-6 (UFC 901.4.4). J. This project will not discharge any increase in storm water run-off onto the existing

coastal bluff areas. K. At the storm water discharge locations, suitable energy dissipaters are to be installed to

reduce the discharge to non-erodible velocities. L. Multiple storm water discharge locations will be used to mimic the existing drainage

M. No additional run-off is proposed for the discharge locations
N. No obstruction including solid walls in the visibility area shall exceed 3 feet in height. plant material, other than trees, within the public right-of-way that is located within visibility areas shall not exceed 24 inches in height, measured from the top of the adjacent

O. Prior to the issuance of any construction permit, the owner/permittee shall enter into a maintenance agreement for the ongoing permanent bmp maintenance, satisfactory to the

P. Prior to the issuance of any construction permit, the owner/permittee shall incorporate any construction best management practices necessary to comply with chapter 14, article 2, division 1 (grading regulations) of the San Diego Municipal Code, into the construction plans or specifications.

Q. Prior to the issuance of any construction permit the owner/permittee shall submit a water pollution control plan (WPCP). the WPCP shall be prepared in accordance with the guidelines in part 2 construction bmp standards chapter 4 of the city's storm water

R. Per SDMC Section 143.0143(c) only native or other drought-tolerant plant species shall be used in landscaped areas in order to minimize irrigation requirements and to reduce


potential slide hazards due to over-watering of the coastal bluffs. S. New site drainage system to connect to existing sidewalk underdrain for discharge to

public conveyance Proposed drainage sheet flowing into neighboring properties cannot exceed existing Q100

U. All stormwater runoff from proposed and/or replaced impervious areas shall be routed to pervious surfaces or landscaping prior to reaching the public drain system.

SITE PLAN LEGEND

Slope Water flow direction (grade) Downspout Discharge flow Catch basin that will discharge to existing landscape

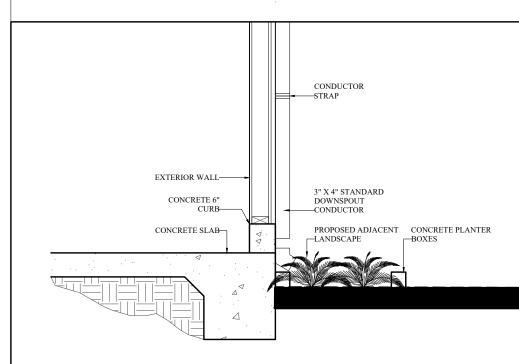

DOWNSPOUT IN LANDSCAPE

SCALE 1" = 1'-0"

ATTACHMENT 11

Marengo Morton Architects

7724 Girard Ave. Second Floor La Jolla, CA 92037 Tel. (858) 459-3769 Fax. (858) 459-3768 Michael Morton AIA



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01/26/2022 PROJECT START

FEASIBILITY PHASE

PROJECT NO. 2021-46

REVIEWED BY CAM

DRAWN BY AP

DATE 02/08/2024


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only true contract documents of record.

SHEET TITLE DRAINAGE

A012

ATTACHMENT 11

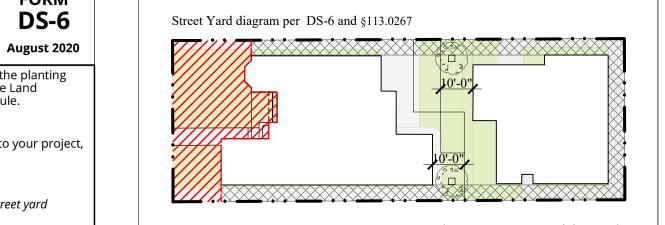

satisfactorily treated or replaced per the conditions of the permit. Tree root barriers: A minimum root zone of 40 sf in area shall be provided for all trees.

LANDSCAPE NOTES

and all other landscape related City and Regional Standards.

The minimum dimension of this area shall be 5 feet, per LDC 142.0403 (b)(5). 4. Tree grates around street trees shall be a minimum of 40 s.f. with a minimum 5' inside

. All landscape and irrigation shall conform to the standards of City-Wide Landscape

Maintenance: All required landscape areas shall be maintained by the owner. Landscape

and irrigation areas in the public right-of-way shall be maintained by the owner. The

maintained in a healthy growing condition. Diseased or dead plant material shall be

All pruning shall comply with the standards of the American National Standards Institute (ANSI) for tree care operations and the International Society of Arboriculture (ISA) for

Mulch: All required planting areas and all exposed soil areas without vegetation shall be covered with mulch to a minimum depth of 3", excluding slopes requiring revegetation per

Minimum tree separation distance: Traffic signals (stop sign) Underground utility lines 5 ft Above ground utility structures 10 ft 10 ft Driveway (entries) Street intersections 25 ft Sewer lines 10 ft

tree pruning. Topping of trees is not permitted.

8. Prior to issuance of any building permits, a complete set of landscaping and irrigation plans shall be submitted to the city manager for approval. The landscaping and irrigation plans shall be in conformance with the requirements of the La Jolla Planned District Ordinance, the La Jolla Community Plan and the landscape guidelines of the land development manual.

9. All required landscaped areas shall be permanently irrigated and maintained in accordance with the landscape guidelines of the land development manual.

0. Irrigation: An automatic, electronically controlled irrigation system shall be provided as

required by LDC 142.0403(c) for proper irrigation, development, and maintenance of the vegetation in a healthy-disease-resistant condition. The design of the system shall provide adequate support for the vegetation selected.

12. All graded, disturbed or eroded areas that will not be permanently paved or covered by structures shall be permanently re-vegetated and irrigated as shown in table 142.04f and in accordance with the standards in the land development manual.


13. All required landscape as shown on these plans shall be maintained by the owner in a disease, weed and litter free condition at all times consistent with CDP no. 1314394, the La Jolla Shores PDO, the Community Plan, and the city-wide landscape standards.

14. All existing plant material to be removed.

LANDSCAPE REQUIREMENTS

One hundred percent of all required yards except interior yards and rear yards shall be landscaped with a minimum of at least 50 percent and shall be any combination of trees, shrubs and ground cover; except that the use of trees to meet this requirement shall be optional. All proposed landscaping in the required yard areas for Courts, Places, or Walks shall be maintained at a height of three feet or lower (including raised planters) to preserve public views. All landscaping shall be drought-tolerant and native or non-invasive plant species. The remaining 50 percent may include, but is not restricted to, fountains, reflecting pools, art objects, decorative walkways, screens, walls, fences, benches, and decks not exceeding 3 feet in height.

PLANT LEGEND

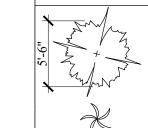


(3x) Existing shrubs - Plumeria Species - Diameter: 5'-6" (more than 24" spread: 15 points per plant)

Existing palm trees (not counted towards points as

they're placed in ROW (outside of the property)) (8x) Existing shrubs (12"-24" spread: 4 points per plant)

(14x) New 5-gallon shrubs (2 points per plant)

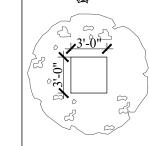

New Magnolia Grandiflora 'Little Gem' Common name: Little Gem Magnolia Height: Spread: Container size: 36"x36" (50 points per plant)

LANDSCAPE LEGEND

Description Landscape area

Hardscape area

KEY NOTES

New (4x) Magnolia Grandiflora (Refer to plant legend) (Site tree satisfies both CAP and ADU regulations)

Trash area. Please refer to sheet L01, keynote 4 for compliance

Gate 75% open

Existing walkway

5 Existing shrubs to remain | Plumeria Species | Diameter: 5'-6"

6 Existing 3/4" water meter to remain

Existing neighbor's 6ft wood fence

8 New 6ft wood fence

9 Existing gate

10

New 1" Water meter


Existing shrubs

New (x14) 5-gallon shrubs

Regulations and the City of San Diego Land Development Manual Landscape Standards landscape areas shall be maintained free of debris and litter and all plant material shall be Marengo

Morton **Architects**

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01/26/2022 PROJECT START

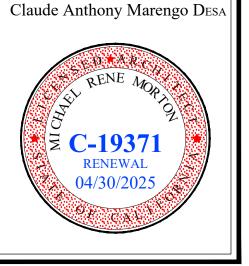FEASIBILITY PHASE

PROJECT NO. 2021-46

REVIEWED BY CAM

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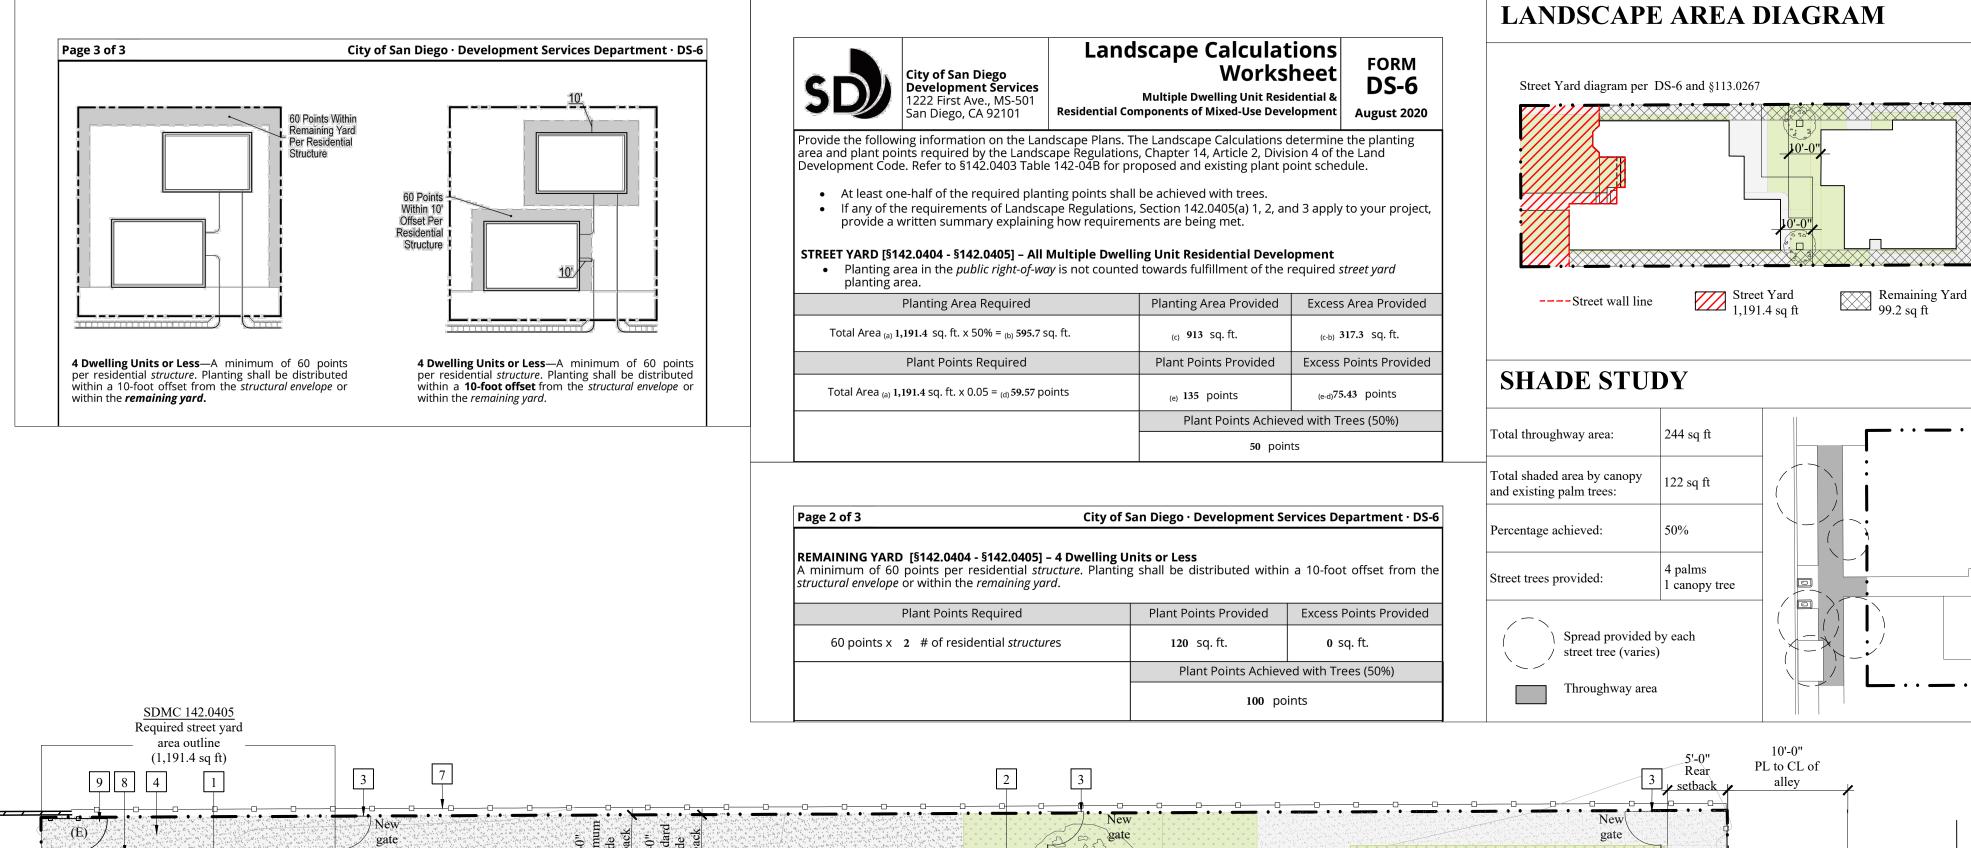
DATE 02/08/2024


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only true contract documents of record

SHEET TITLE PROPOSED LANDSCAPE PLAN






PROPOSED LANDSCAPE PLAN

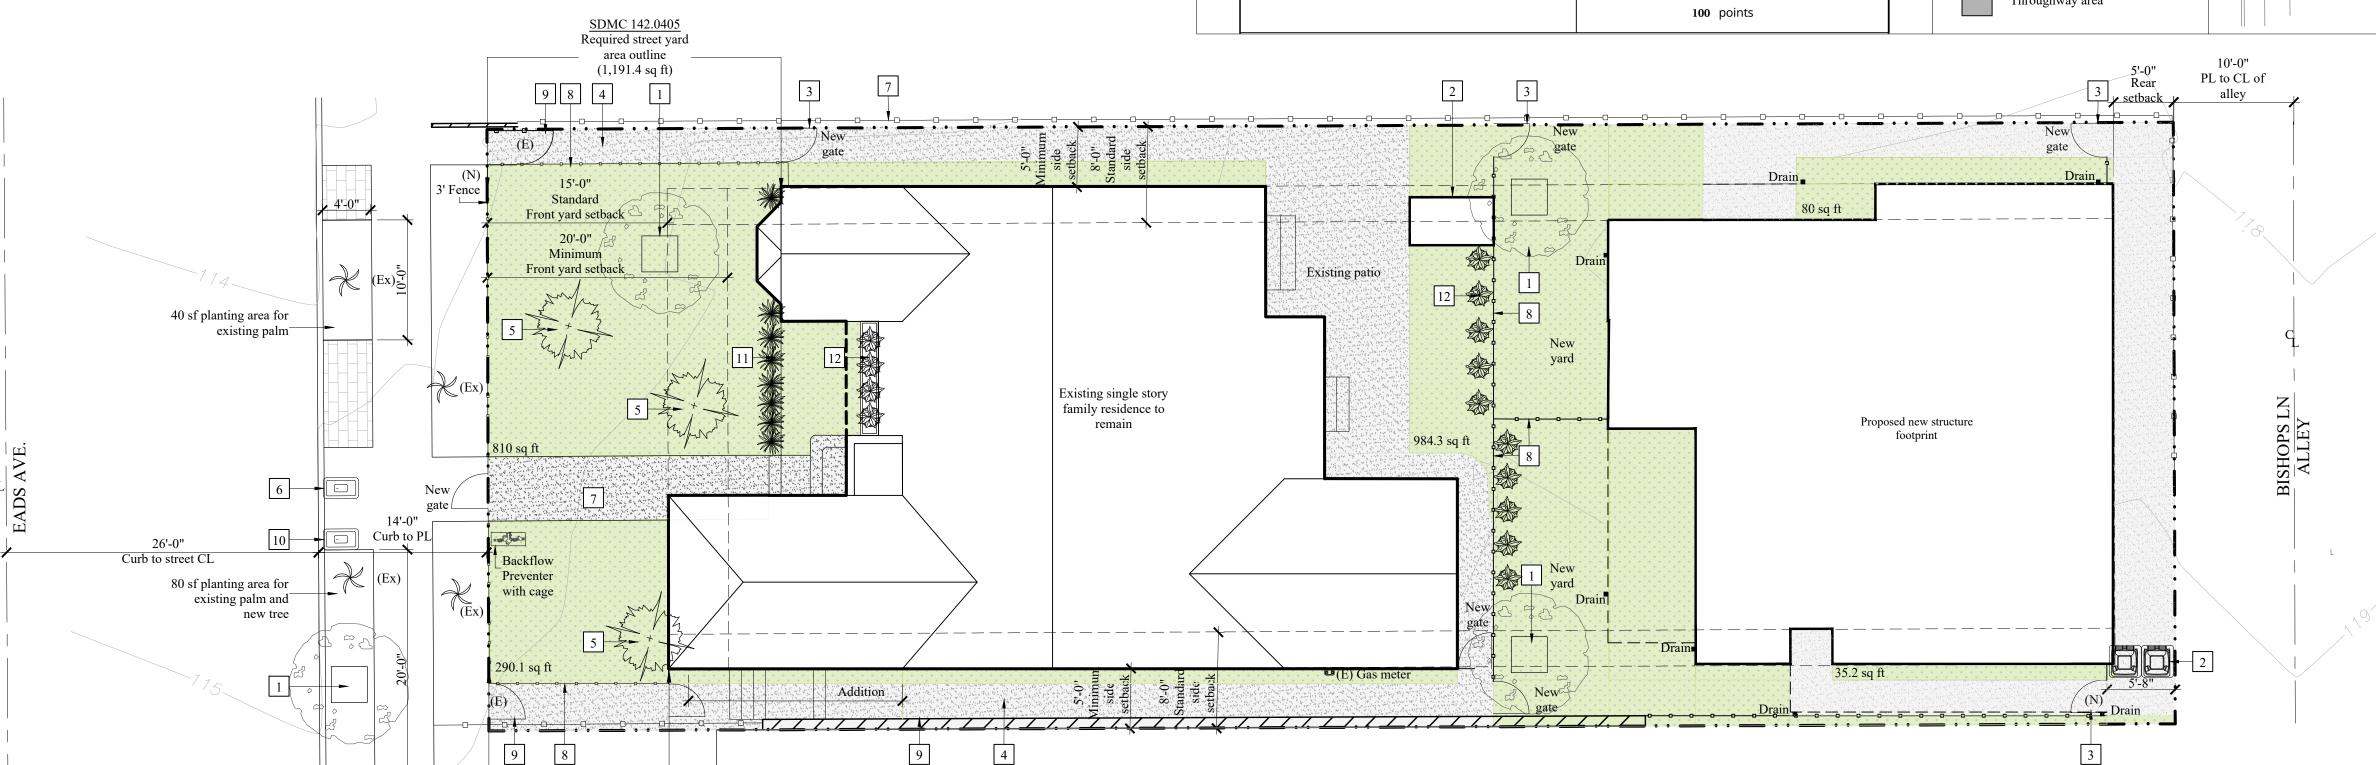SDMC 142.0405

Required street yard


area outline (1,191.4 sq ft)

4'-0"

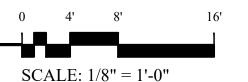



Project Name	Eads Condos					
Project Address	7443 Eads Ave					
	La Jolla, CA 92037					
Existing Residence Perimeter Lengths						
Direction Existing Wall Faces	Existing Length		Length Remaining		Length Removed	
A- North	56.39	LF	20.99	LF	35.40	LF
B- South	46.25	LF	46.25	LF	0.00	LF
C- East	55.02	LF	23.57	LF	31.45	LF
D- West	40.91	LF	40.91	LF	0.00	LF
Total Exist. Basement Level Perimeter Lengt	198.57	LF	131.72	LF	66.85	LI
	99.285		32.44	4 LF	above 50%	
Existing Perimeter Wall Remaining	131.72	LF				
Total Existing Building Perimeter Length	198.57	LF				
66%	Percentage of Exis	ting	Perimeter Wall Whic	h Rei	nains	
50%	of existing wall must	rema	ain to qualify for coastal	exem	ption	
Cumulative Perimeter Wall Remaining	131.72	LF				
Total Cumulative Building Perimeter	287.37	LF				
46%	Percentage of Cun	ulat	ive Perimeter Wall W	hich .	Remains	
50%	of existing wall must	rema	ain to qualify for costal e	xemp	tion	
-4.16%	-11.97	LF	above 50% min perin	1eter	wall length to rema	in

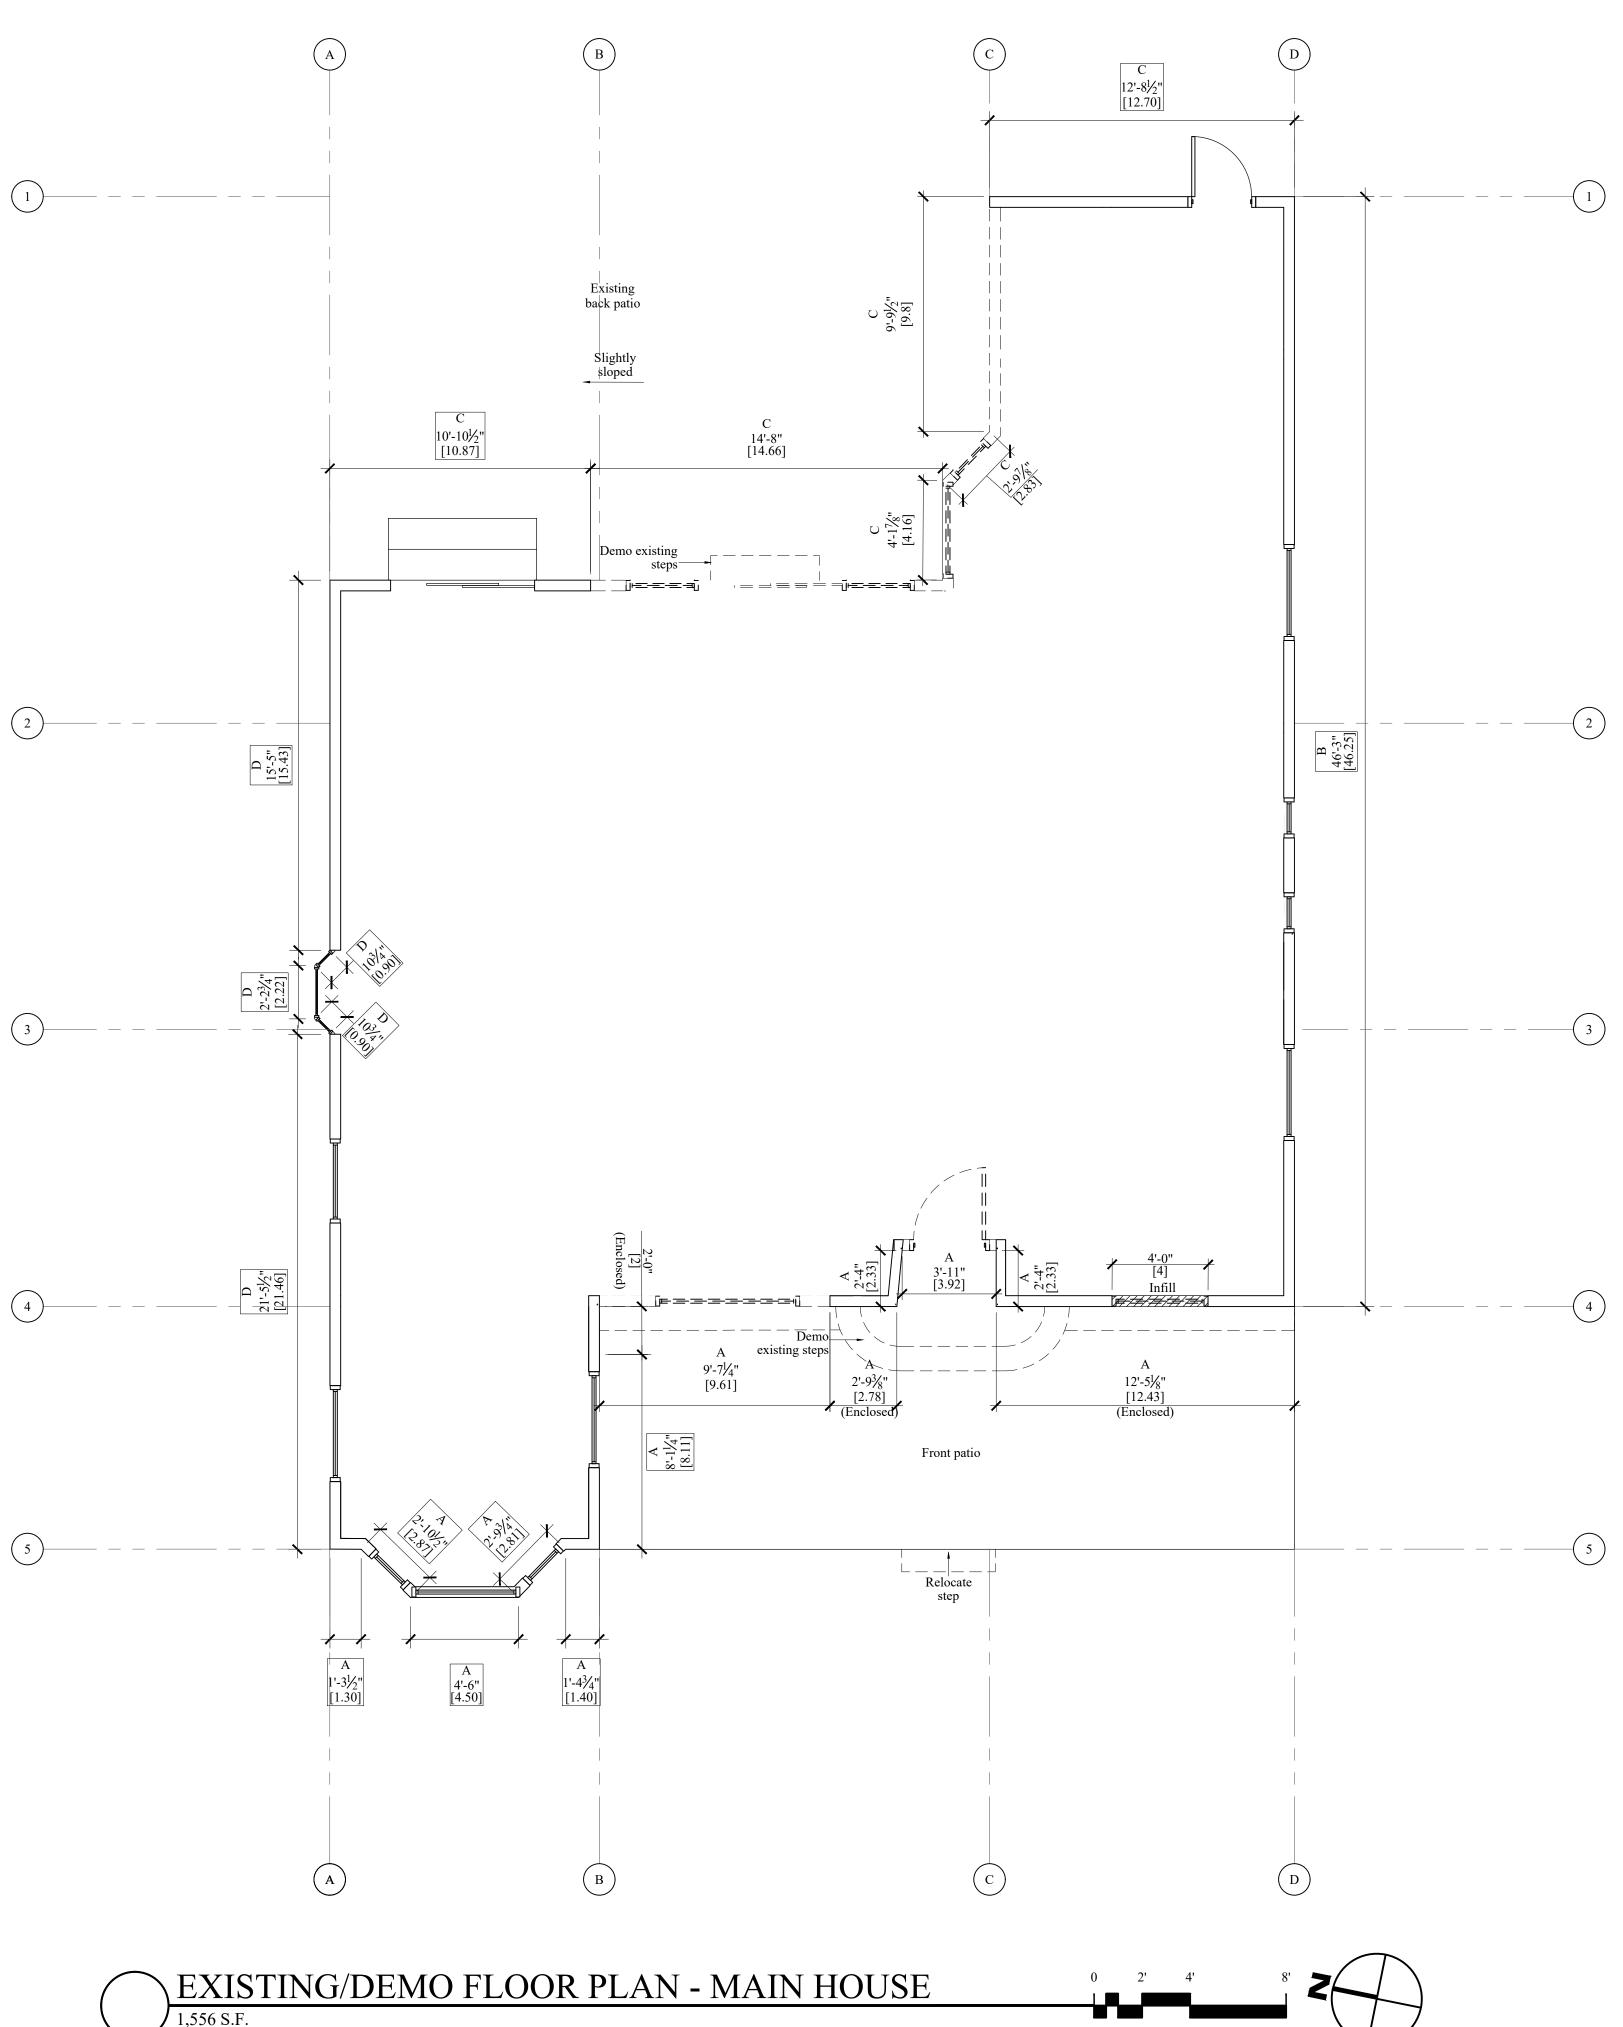

SCALE: 1/4" = 1'-0"

ATTACHMENT 11

DEMOLITION NOTES

- 1. Architect shall be notified immediately when any discrepancy with architectural or structural drawings are found at the project site. All drawings may have to be modified upon removal of existing construction. Do not proceed with work in question until the architect issues directions.
- 2. Contractor shall verify layout of existing structure, property boundaries, location of site utilities underground and overhead, and field conditions as shown on the plans prior to
- demolition.
 3. Before start of demolition contractor shall verify with the owner any item to be saved (s), covered, or stored, verify storage locations with owner before demolition commences.
 4. Any outdoor structures or landscaping marked to be saved, shall be protected, fenced
- and/or covered to avoid damage.5. All demolition material shall be transported off site and properly disposed at city-approved locations by the contractor.
- 6. Contractor to verify dumpster location with architect before demolition commences.
 7. Contractor shall also refer to floor plans and other construction plans for new work to be
- incorporated into the project and to proceed with demolition accordingly.

 8. Carefully remove structure as shown on plan. Remove all materials carefully to avoid damage to adjacent surfaces.
- 9. Contractor shall notify architect if any of the exposed wood show evidence of active water leaks, termites or dry rot.
- 10. Prepare existing window framing openings (to remain) to receive new window units.
- See new floor plan and elevations for new window size.

 11. When demolition is complete, the structure and site shall be broom clean and ready to receive new work.
- receive new work.

 12. Remove all existing landscape and tree roots with in 3 feet of the outline of new structure. If the removal of tree roots produces potentially unstable trees, the contractor shall
- immediately contact a tree specialist to make a recommendation.
 13. Demolition of openings in roof and exterior walls shall be covered each night with plastic tarps and secured to prevent water and dust from entering the building.
 14. Existing floors shall be covered during construction. openings shall be taped and sealed to walls at edges of construction zone to minimize dust. Temporary wall shall be built and
- sealed as if needed or shown on plans.

 15. Should any portion of the structure being removed produce unstable of unsafe conditions the contractor shall provide shoring and bracing.
- 16. Existing FAU & water heater shall be turned off and salvaged units removed and stored for re-use. Existing natural gas service shall be turned off and lines temporarily capped at residence.
- 17. Electrical service shall be turned off at residence and provisions for temporary power made during construction.

 18. Please be advised this is a remodel project, conseeled conditions of all types shall be
- 18. Please be advised this is a remodel project. concealed conditions of all types shall be taken into account and/or verified prior to completion of final project bid.
 19. Contractor shall verify in the field the condition of all foundations, stem walls, sill
- attachments, pier-footing conditions and attachment to framing. deficiencies, cracks or other structural issues in foundations or footings or lack thereof shall be brought to the attention of the architect and structural engineer.
- 20. Existing framing and floor surfaces may be out of plumb and not level. They shall be inspected and made plumb and leveled upon notification to the architect and a written approval has been documented. Wood framing adjacent to soil may be encountered and modifications and/or protection measures shall be taken.
- 21. Elevation changes between door openings and adjacent grade shall be verified in the field and if discrepancies exist between field conditions and plans exist, notify the architect to make modifications and/or other corrective measures.
- 22. If soils report or survey not included with this set of documents, the architect will not be held responsible for any changes, modifications, ordered reports or survey or other additional issues caused by lack of information from those documents.

Coastal Projects Additional Notes

- A. This is a coastal project. No exterior walls shall be demolished other than those
- specified on the demolition sheet without prior written instruction from architect.B. It is the general contractors sole responsibility that all existing wall shown to remain shall be protected and maintained at all times during the project construction.

DEMOLITION NOTES FOR COASTAL EXEMPTION

- A. At least 50% of the existing exterior walls (from the foundation to the top plate) of the principal habitable floor must be left standing and in place throughout construction and incorporated into the completed structure without modifications.
- B. The wall must continue to be used as exterior walls in the completed project (may not be used as interior walls or used in a "double wall" configuration with any new wall)
 C. Any door or window located within a segment of the wall which is counted toward the
- C. Any door or window located within a segment of the wall which is counted toward the length of an existing exterior wall to be left standing (at least 50%) cannot have their location or size modified.
 D. The surface of the wall can be modified or removed down to the studs but with both the
- top and bottom plates in place. Removal of the stud walls, even on a temporary basis does not meet exemption criteria (for coastal exemption) and is not to be done.

 E. Walls, which are designated to remain, cannot be replaced, heightened or relocated for
- any reason, including reasons of structural integrity (dry rot, termites).

 F. Reinforcement in the form of sistering members (studs and plates) is permitted as long as they do not interrupt the assembly of top plate studs and sill. New member is to be notched to sister and incorporate. Not existing lumber.
- G. Penetration through top plate is permitted only the width of the actual cut will be included in the calculation (e.g. only actual width of a 2x4 or a 4x4 going through the top plate will deduct that amount). Need to be approved by architect to be sure after all cuts are made that we still comply.
- H. Cripple walls are permitted (placing a new bottom plate on an existing top plate together with new studs and a new top plate for the purposes of increasing floor to ceiling height).
 I. Foundation replacement is acceptable only if existing walls can be properly supported <u>in</u>
- J. A window may be replaced or may be reduced in area or dimension or may be covered over (filled in) provided that the existing studs and headers are retained in their original
- position.

 K. Reinforcement in the form of furring is permitted for single wall construction only if it is done in such a manner that the wall is not extended outward. All furring is to the
- is done in such a manner that the wall is not extended outward. All furring is to the interior & verified by the architect.


 L. There shall be no significant alteration of land forms including removal or placement of vegetation, on a beach, wetland or sand dune, or within 100 feet of the edge of a coastal

bluff without first obtaining approval from the governing authority having jurisdiction

over the project.

M. If a sill is required to be 3x material where a 2x4 wall exists, a site meeting should take place with architect and engineer to block 3x on top of existing sill in between existing studs strapped and/or clipped in place.

DEMOLITION LEGEND

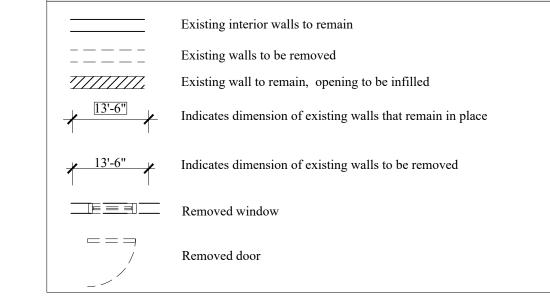



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Claude Anthony Marengo Desa



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7443 Eads Avenue La Jolla CA, 92037

REVISIONS 01/26/2022 PROJECT START

7

PHASE FEASIBILITY PHASE

PROJECT NO. 2021-46

REVIEWED BY CAM


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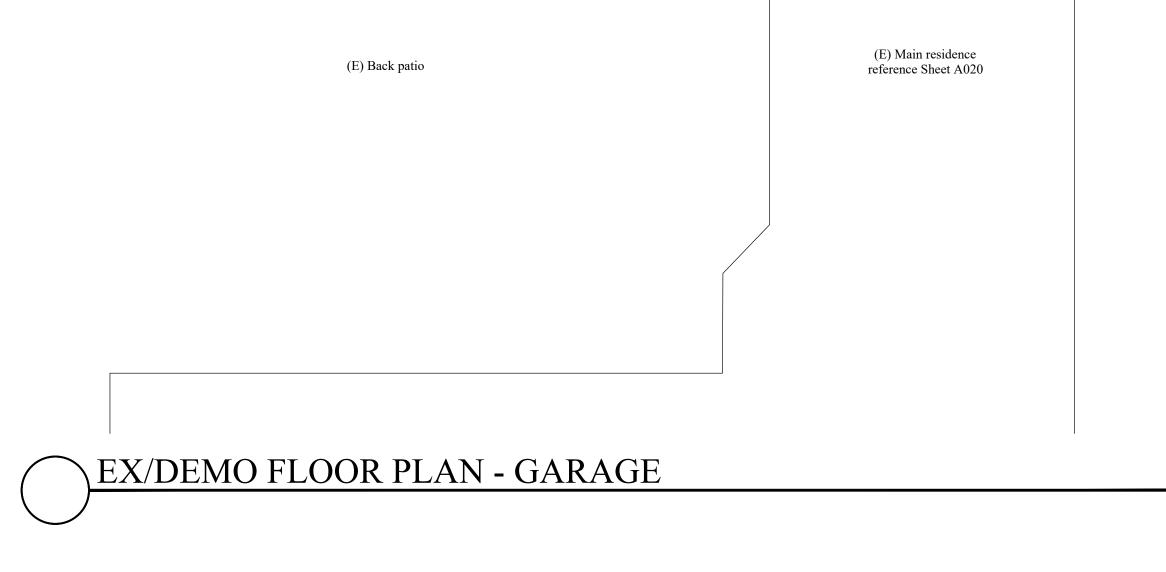
DATE 02/08/2024


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SHEET TITLE EXISTING/DEMO
FLOOR PLAN - MAIN HOUSE

Garage Floor Perime	ter Calcul	lati	on works	nee	et	
Project Name	Eads Condos					
Project Address	7443 Eads Ave					
	La Jolla, CA 92037	7				
Existing Residence Perimeter Lengths						
Direction Existing Wall Faces	Existing Length		Length Remaining		Length Remove	ed
A- East	20.20	LF	0.00	LF	20.20	LF
B- South	24.20	LF	0.00	LF	24.20	LF
C- West	20.20	LF	0.00	LF	20.20	LF
D- North	24.20	LF	0.00	LF	24.20	LF
Total Exist. First Floor Perimeter Length	88.80	LF	0.00	LF	88.80	LF
	44.4		-44.	40 LF	above 50%	
Existing Perimeter Wall Remaining	0.00	LF				
Total Existing Building Perimeter Length	88.80	LF				
0	% Percentage of Ext	sting	Perimeter Wall Whi	ch Rei	nains	
50	% of existing wall mus	st rema	ain to qualify for coasta	al exem	otion	
Cumulative Perimeter Wall Remaining	131.72	LF				
Total Cumulative Building Perimeter	287.37	LF				
469	% Percentage of Cu	mulat	ive Perimeter Wall V	Which .	Remains	
50	% of existing wall mus	st rema	ain to qualify for costal	exemp	tion	
-4.169	% -11.9	7 <i>LF</i>	above 50% min peri	meter	wall length to ren	nain





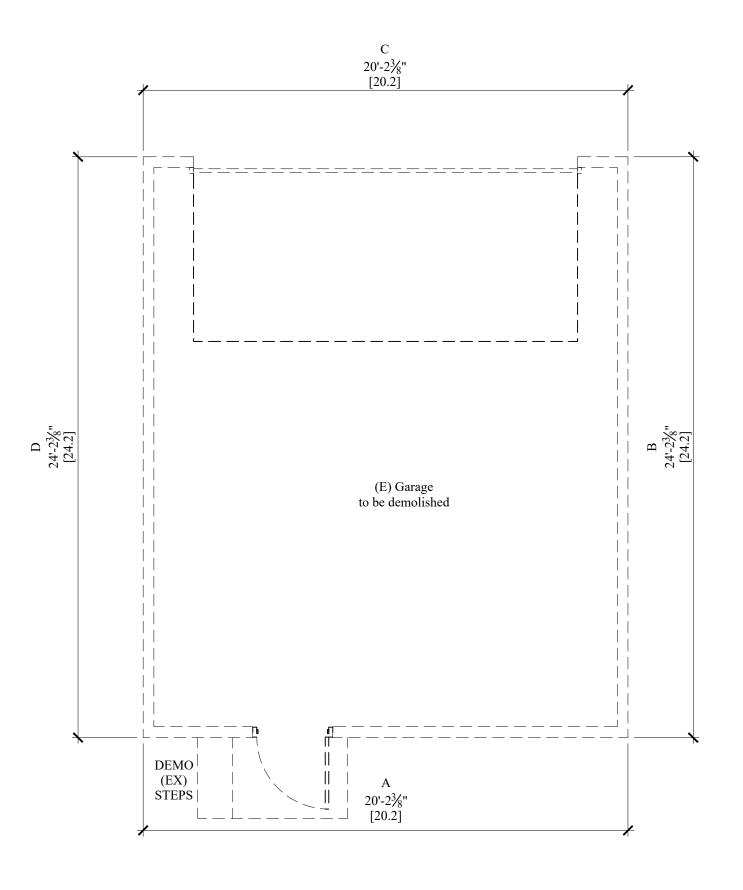

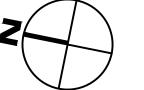DEMOLITION NOTES

- 1. Architect shall be notified immediately when any discrepancy with architectural or structural drawings are found at the project site. All drawings may have to be modified upon removal of existing construction. Do not proceed with work in question until the architect issues directions.
- 2. Contractor shall verify layout of existing structure, property boundaries, location of site utilities underground and overhead, and field conditions as shown on the plans prior to demolition.
- demolition.
 3. Before start of demolition contractor shall verify with the owner any item to be saved (s), covered, or stored, verify storage locations with owner before demolition commences.
 4. Any outdoor structures or landscaping marked to be saved, shall be protected, fenced
- and/or covered to avoid damage.5. All demolition material shall be transported off site and properly disposed at city-approved locations by the contractor.
- locations by the contractor.

 6. Contractor to verify dumpster location with architect before demolition commences.
- 7. Contractor shall also refer to floor plans and other construction plans for new work to be incorporated into the project and to proceed with demolition accordingly.8. Carefully remove structure as shown on plan. Remove all materials carefully to avoid
- damage to adjacent surfaces.

 9. Contractor shall notify architect if any of the exposed wood show evidence of active water
- leaks, termites or dry rot.
- 10. Prepare existing window framing openings (to remain) to receive new window units.

 See new floor plan and elevations for new window size.

 When demolition is complete the structure and site shall be broom clean and ready to
- 11. When demolition is complete, the structure and site shall be broom clean and ready to receive new work.12. Permove all existing landscape and tree roots with in 3 feet of the outline of new structure.
- 12. Remove all existing landscape and tree roots with in 3 feet of the outline of new structure. If the removal of tree roots produces potentially unstable trees, the contractor shall immediately contact a tree specialist to make a recommendation.
- Demolition of openings in roof and exterior walls shall be covered each night with plastic tarps and secured to prevent water and dust from entering the building.
 Existing floors shall be covered during construction. openings shall be taped and sealed to walls at edges of construction zone to minimize dust. Temporary wall shall be built and
- sealed as if needed or shown on plans.

 15. Should any portion of the structure being removed produce unstable of unsafe
- conditions the contractor shall provide shoring and bracing.

 16. Existing FAU & water heater shall be turned off and salvaged units removed and stored for re-use. Existing natural gas service shall be turned off and lines temporarily capped at residence.
- 17. Electrical service shall be turned off at residence and provisions for temporary power made during construction.
- made during construction.

 18. Please be advised this is a remodel project, concealed conditions of all types shall be taken into account and/or verified prior to completion of final project bid.
- 19. Contractor shall verify in the field the condition of all foundations, stem walls, sill attachments, pier-footing conditions and attachment to framing. deficiencies, cracks or other structural issues in foundations or footings or lack thereof shall be brought to the attention of the architect and structural engineer.
- 20. Existing framing and floor surfaces may be out of plumb and not level. They shall be inspected and made plumb and leveled upon notification to the architect and a written approval has been documented. Wood framing adjacent to soil may be encountered and
- modifications and/or protection measures shall be taken.

 21. Elevation changes between door openings and adjacent grade shall be verified in the field and if discrepancies exist between field conditions and plans exist, notify the architect
- to make modifications and/or other corrective measures.

 22. If soils report or survey not included with this set of documents, the architect will not be held responsible for any changes, modifications, ordered reports or survey or other additional issues caused by lack of information from those documents.

Coastal Projects Additional Notes

- A. This is a coastal project. No exterior walls shall be demolished other than those
- specified on the demolition sheet without prior written instruction from architect.
 B. It is the general contractors sole responsibility that all existing wall shown to remain shall be protected and maintained at all times during the project construction.

DEMOLITION NOTES FOR COASTAL EXEMPTION


- A. At least 50% of the existing exterior walls (from the foundation to the top plate) of the principal habitable floor must be left standing and in place throughout construction and
- incorporated into the completed structure without modifications.
 B. The wall must continue to be used as exterior walls in the completed project (may not be used as interior walls or used in a "double wall" configuration with any new wall)
 C. Any door or window located within a segment of the wall which is counted toward the
- length of an existing exterior wall to be left standing (at least 50%) cannot have their location or size modified.

 D. The surface of the wall can be modified or removed down to the studs but with both the
- top and bottom plates in place. Removal of the stud walls, **even on a temporary basis does not meet exemption criteria (for coastal exemption) and is not to be done.**E. Walls, which are designated to remain, <u>cannot be replaced</u>, <u>heightened</u> or <u>relocated</u> for
- any reason, including reasons of structural integrity (dry rot, termites).

 F. Reinforcement in the form of sistering members (studs and plates) is permitted as long as they do not interrupt the assembly of top plate studs and sill. New member is to be
- notched to sister and incorporate. Not existing lumber.

 G. Penetration through top plate is permitted only the width of the actual cut will be included in the calculation (e.g. only actual width of a 2x4 or a 4x4 going through the top plate will deduct that amount). Need to be approved by architect to be sure after all cuts
- are made that we still comply.
 H. Cripple walls are permitted (placing a new bottom plate on an existing top plate together with new studs and a new top plate for the purposes of increasing floor to ceiling height).
 I. Foundation replacement is acceptable only if existing walls can be properly supported in their pre-existing position during replacement or repair.
- J. A window may be replaced or may be reduced in area or dimension or may be covered over (filled in) provided that the existing studs and headers are retained in their original position.
- K. Reinforcement in the form of furring is permitted for single wall construction only if it is done in such a manner that the wall is not extended outward. All furring is to the interior & verified by the architect.
- L. There shall be no significant alteration of land forms including removal or placement of vegetation, on a beach, wetland or sand dune, or within 100 feet of the edge of a coastal bluff without first obtaining approval from the governing authority having jurisdiction over the project.
- M. If a sill is required to be 3x material where a 2x4 wall exists, a site meeting should take place with architect and engineer to block 3x on top of existing sill in between existing studs strapped and/or clipped in place.

DEMOLITION LEGEND

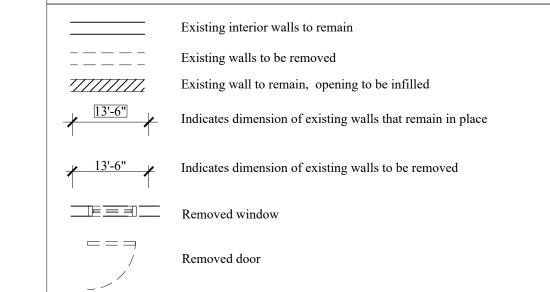



Marengo Morton Architects

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Michael Morton AIA



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7443 Eads Avenue

REVISIONS
01/26/2022 PROJECT START

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FEASIBILITY PHASE

PROJECT NO. 2021-46

REVIEWED BY CAM

DRAWN BY AP

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DATE 02/08/2024

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PLAN - GARAGE

SHEET TITLE EXISTING / DEMO

AU21

FLOOR PLAN NOTES

R-19 batt insulation at all new 2x6 exterior walls and raised floor areas R-13 batt insulation at all accessible interior walls for sound control.

area and on each story and basements. detector shall have an alarm audible in all sleeping areas of the unit. section 310.9.1.2. unit shall be permanently wired and

H. All abs and pvc piping and fittings shall be enclosed within walls and floors covered with type x gypsum board or similar assemblies that provide the same level of fire protection.

Whole building ventilation: indoor air quality exhaust fan with ventilation rate of 120

J. Ducts in the garage and ducts penetrating the walls or ceilings separating the dwelling from the garage shall be constructed of minimum no.26 gauge sheet steel or other

non-absorbent surface that extends to a height not less than 6 ft above flr. crc r307.2 L. Water meters for combined domestic water & fire sprinkler systems shall not be installed

until the fire sprinkler system has been submitted and approved by the bldg official

N. Outdoor shower drains and sinks are not permitted to connect to the public sewer system unless equipped with an approved cover. hot and water connections allowed.

O. During construction, at least one extinguisher shall be provided on each floor level at each stairway, in all storage and construction sheds, in locations where flammable or

P. Buildings undergoing construction, alteration or demolition shall conform to cfc chapter 33. welding, cutting and other hot work shall be in conformance with cfc chapter 35. Address identification shall be provided for all new and existing buildings in a location

that is plainly visible and legible from the street or road fronting the property. where

classifications in cbc table 803.11 and shall meet the flame propagation performance criteria of the california code of regulations, title 19, division 1. decorative materials shall be properly treated by a product or process approved by the state fire marshal with

All luminaries shall be high efficacy and shall have a manual on/off in addition to a

An electronically signed and registered installation certificate(s) (CF2R) posted by the installing contractor shall be submitted to the field inspector during construction at the

An electronically signed and registered certificate(s) of field verification and diagnostic

testing (CF3R) shall be posted at the building signed and registered certificate(s) of field verification and diagnostic testing (CF3R) shall be posted at the building site by a certified hers rater. A registered CF3R will have a unique 25-digit registration number

located at the bottom of each page. The first 20 digits of the number will match the registration number of the associated CF2R. Certificate of occupancy will not be issued

building site. A registered CF2R will have a unique 21-digit registration number

number will match the registration number of the associated cflr. Certificate of occupancy will not be issued until forms CF2R is reviewed and approved.

followed by four zeros located at the bottom of each page. The first 12 digits of the

R. Wall, floor and ceiling finishes and materials shall not exceed the interior finish

access is by way of a private road and the building address can not be viewed from the

public way, an approved signed or means shall be used to identify the structure. premises

combustible liquids are stored or used, and where other special hazards are present per cfc

K. Shower compartment & bathtubs w/ installed showerheads shall be finished w/ a

F. Attic/underfloor installation must comply with sections 904, 908, and 909 of the

G. Provide 5 air changes per hour for bathroom and laundry room ventilation.

the work in question.

B. Refer to site plan for site and utility info.

california mechanical code (cmc)

section 3315.1

vacancy sensor or dimmer.

untilef3r is reviewed and approved.

Existing exterior & interior wall.

2x4 New interior wall - Gypsum each side.

Proposed structure dimension

For additional project information see additional sheets.

dimensions to center line of stud.

Exterior wall dimensions to face of stud/fdtn. wall. Interior wall

2x6 New exterior wall - Gypsum inteiror and stucco exterior

adjacent wall unless otherwise noted.

SCALE: 1/4'' = 1'-0''

New door, installed 4" traditional jamb allowances from

R-30 batt insulation at ceiling & roof areas. R-4.5 insulation wrap on all new hot water piping. R-4.5 insulation wrap on all new supply ducts.

equipped with battery backup. c.b.c. sec. 310.9.1.3.


protection of membrane penetrations is not required.

approved material and shall have no opening into the garage.

M. All plumbing fixtures and fittings will be water conserving

identification shall conform to cbc section 501.2.

appropriate documentation provided to the city of san diego.

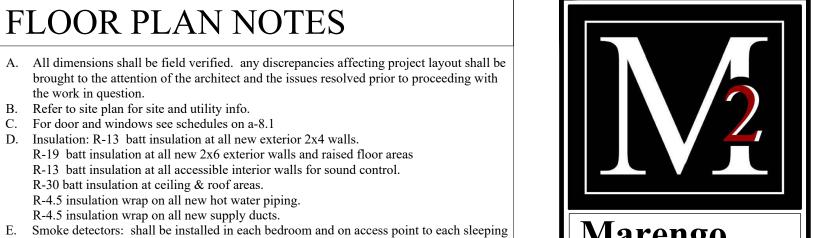

Marengo Morton **Architects**

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FEASIBILITY PHASE PROJECT NO. 2021-46


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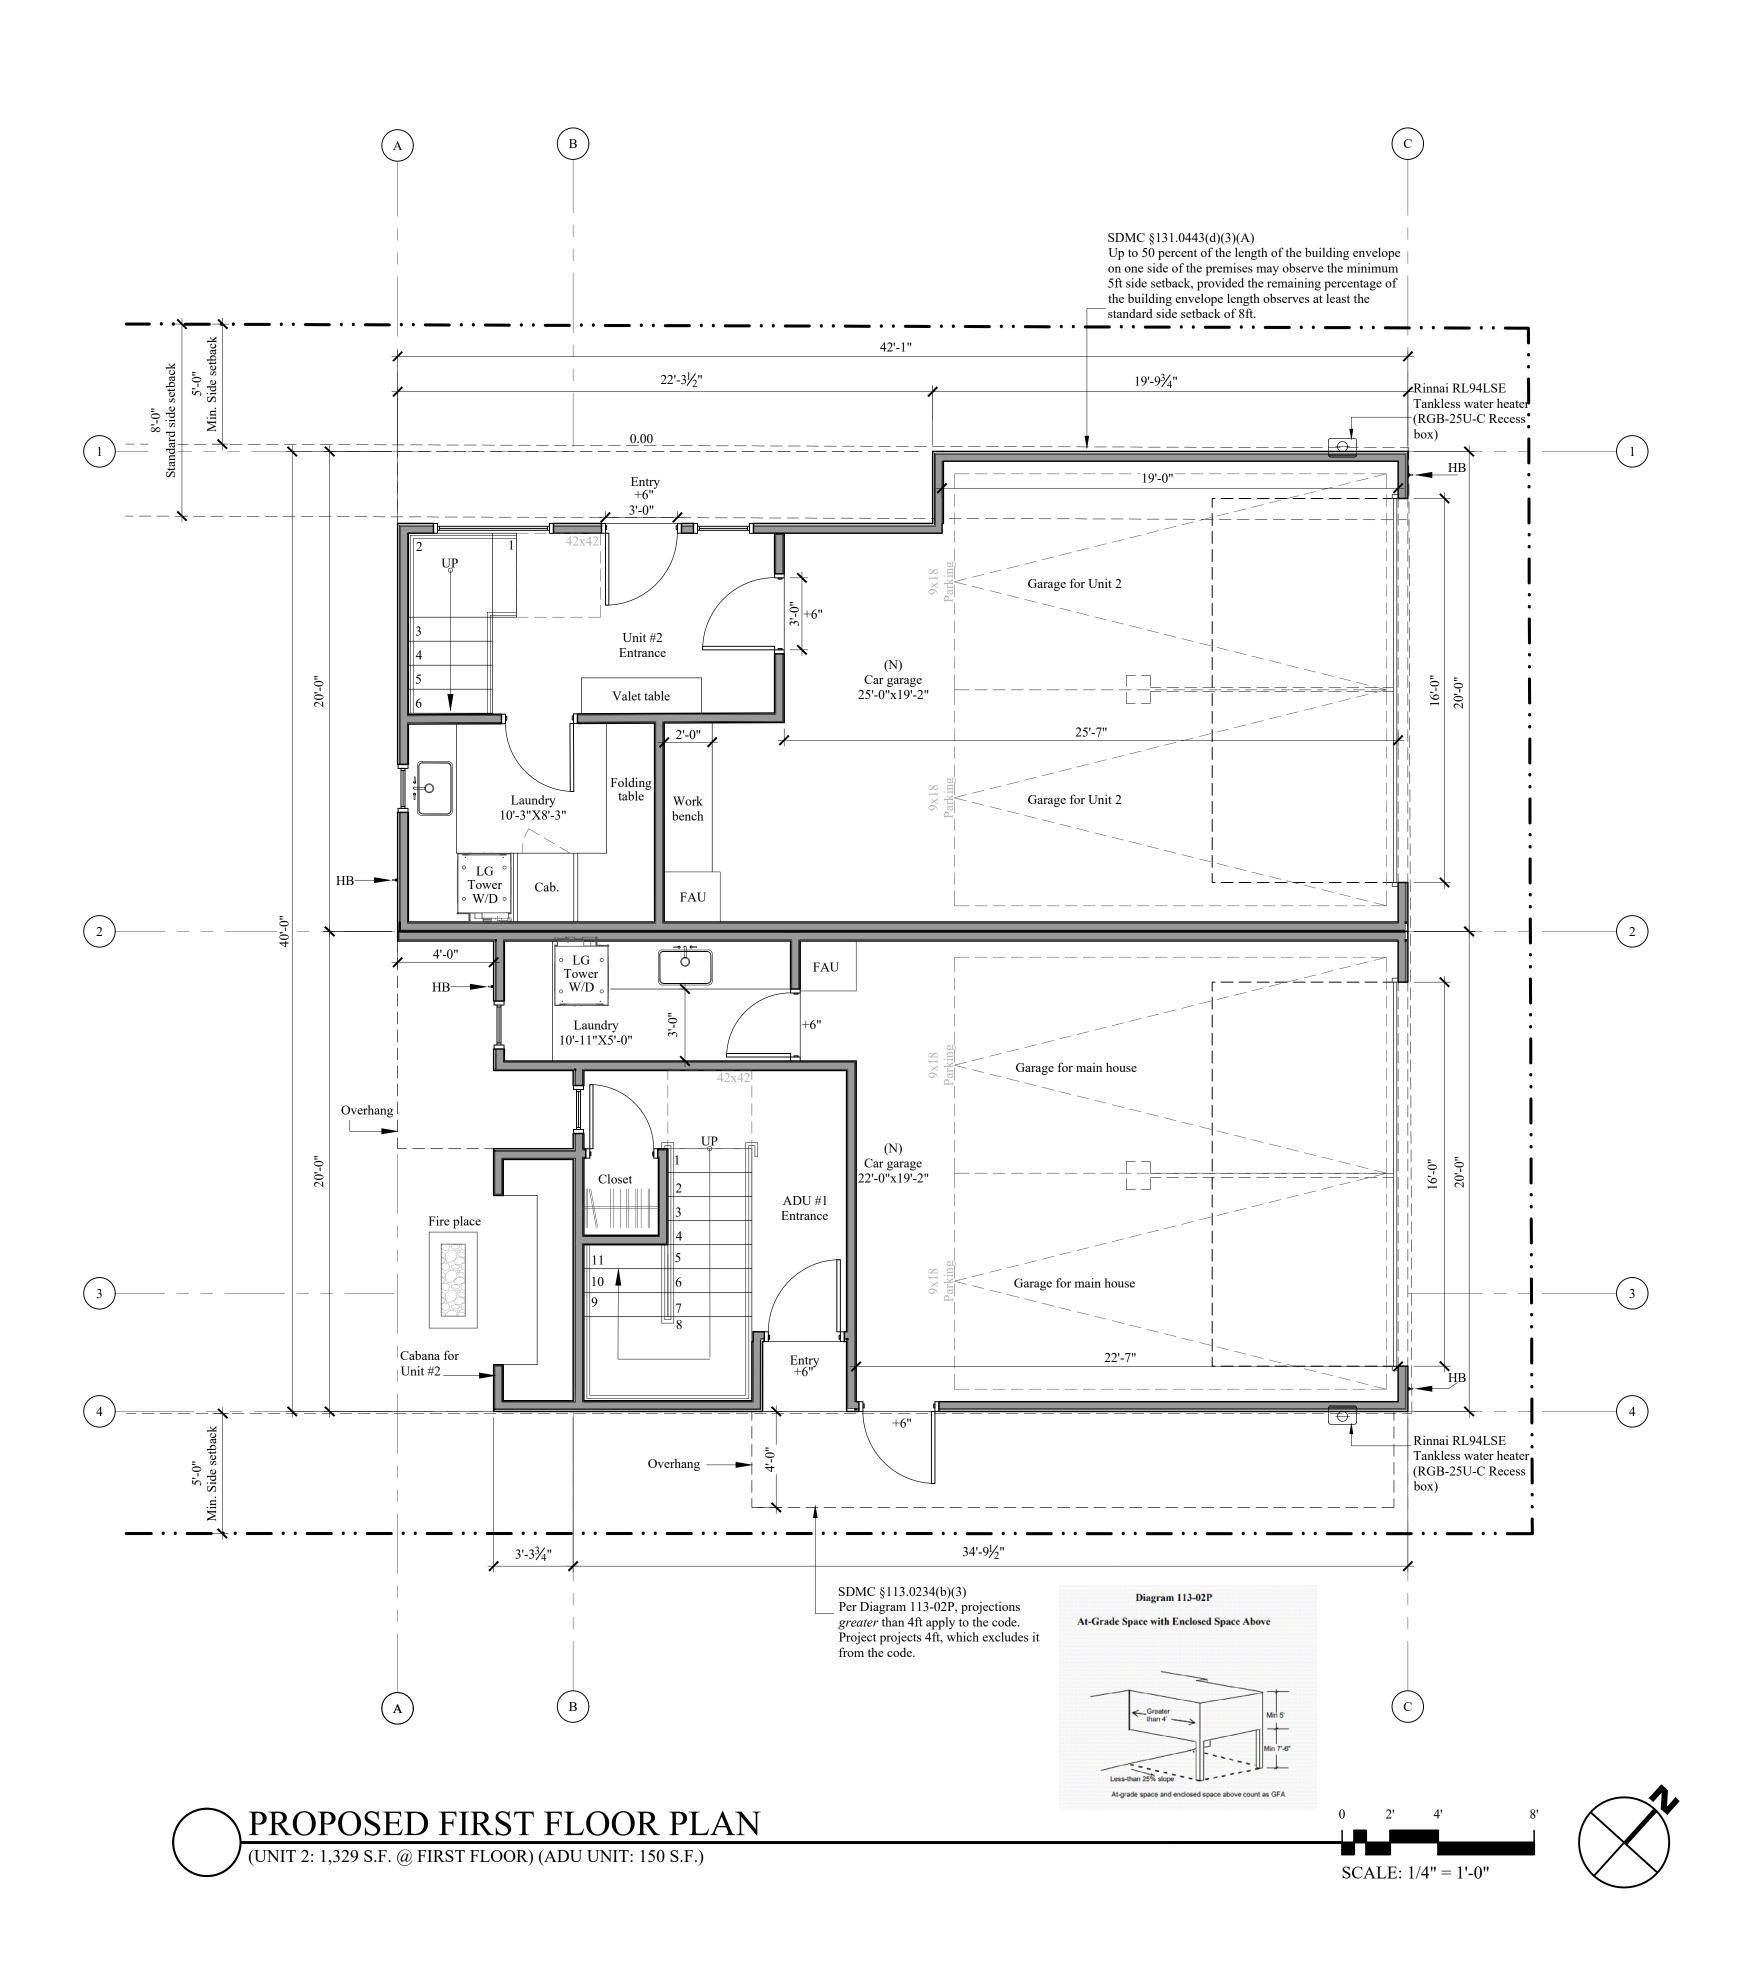
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SHEET TITLE PROPOSED FLOOR PLAN





FLOOR PLAN NOTES

- A. All dimensions shall be field verified. any discrepancies affecting project layout shall be brought to the attention of the architect and the issues resolved prior to proceeding with the work in question.
- B. Refer to site plan for site and utility info.
- C. For door and windows see schedules on a-8.1 D. Insulation: R-13 batt insulation at all new exterior 2x4 walls. R-19 batt insulation at all new 2x6 exterior walls and raised floor areas R-13 batt insulation at all accessible interior walls for sound control. R-30 batt insulation at ceiling & roof areas. R-4.5 insulation wrap on all new hot water piping.

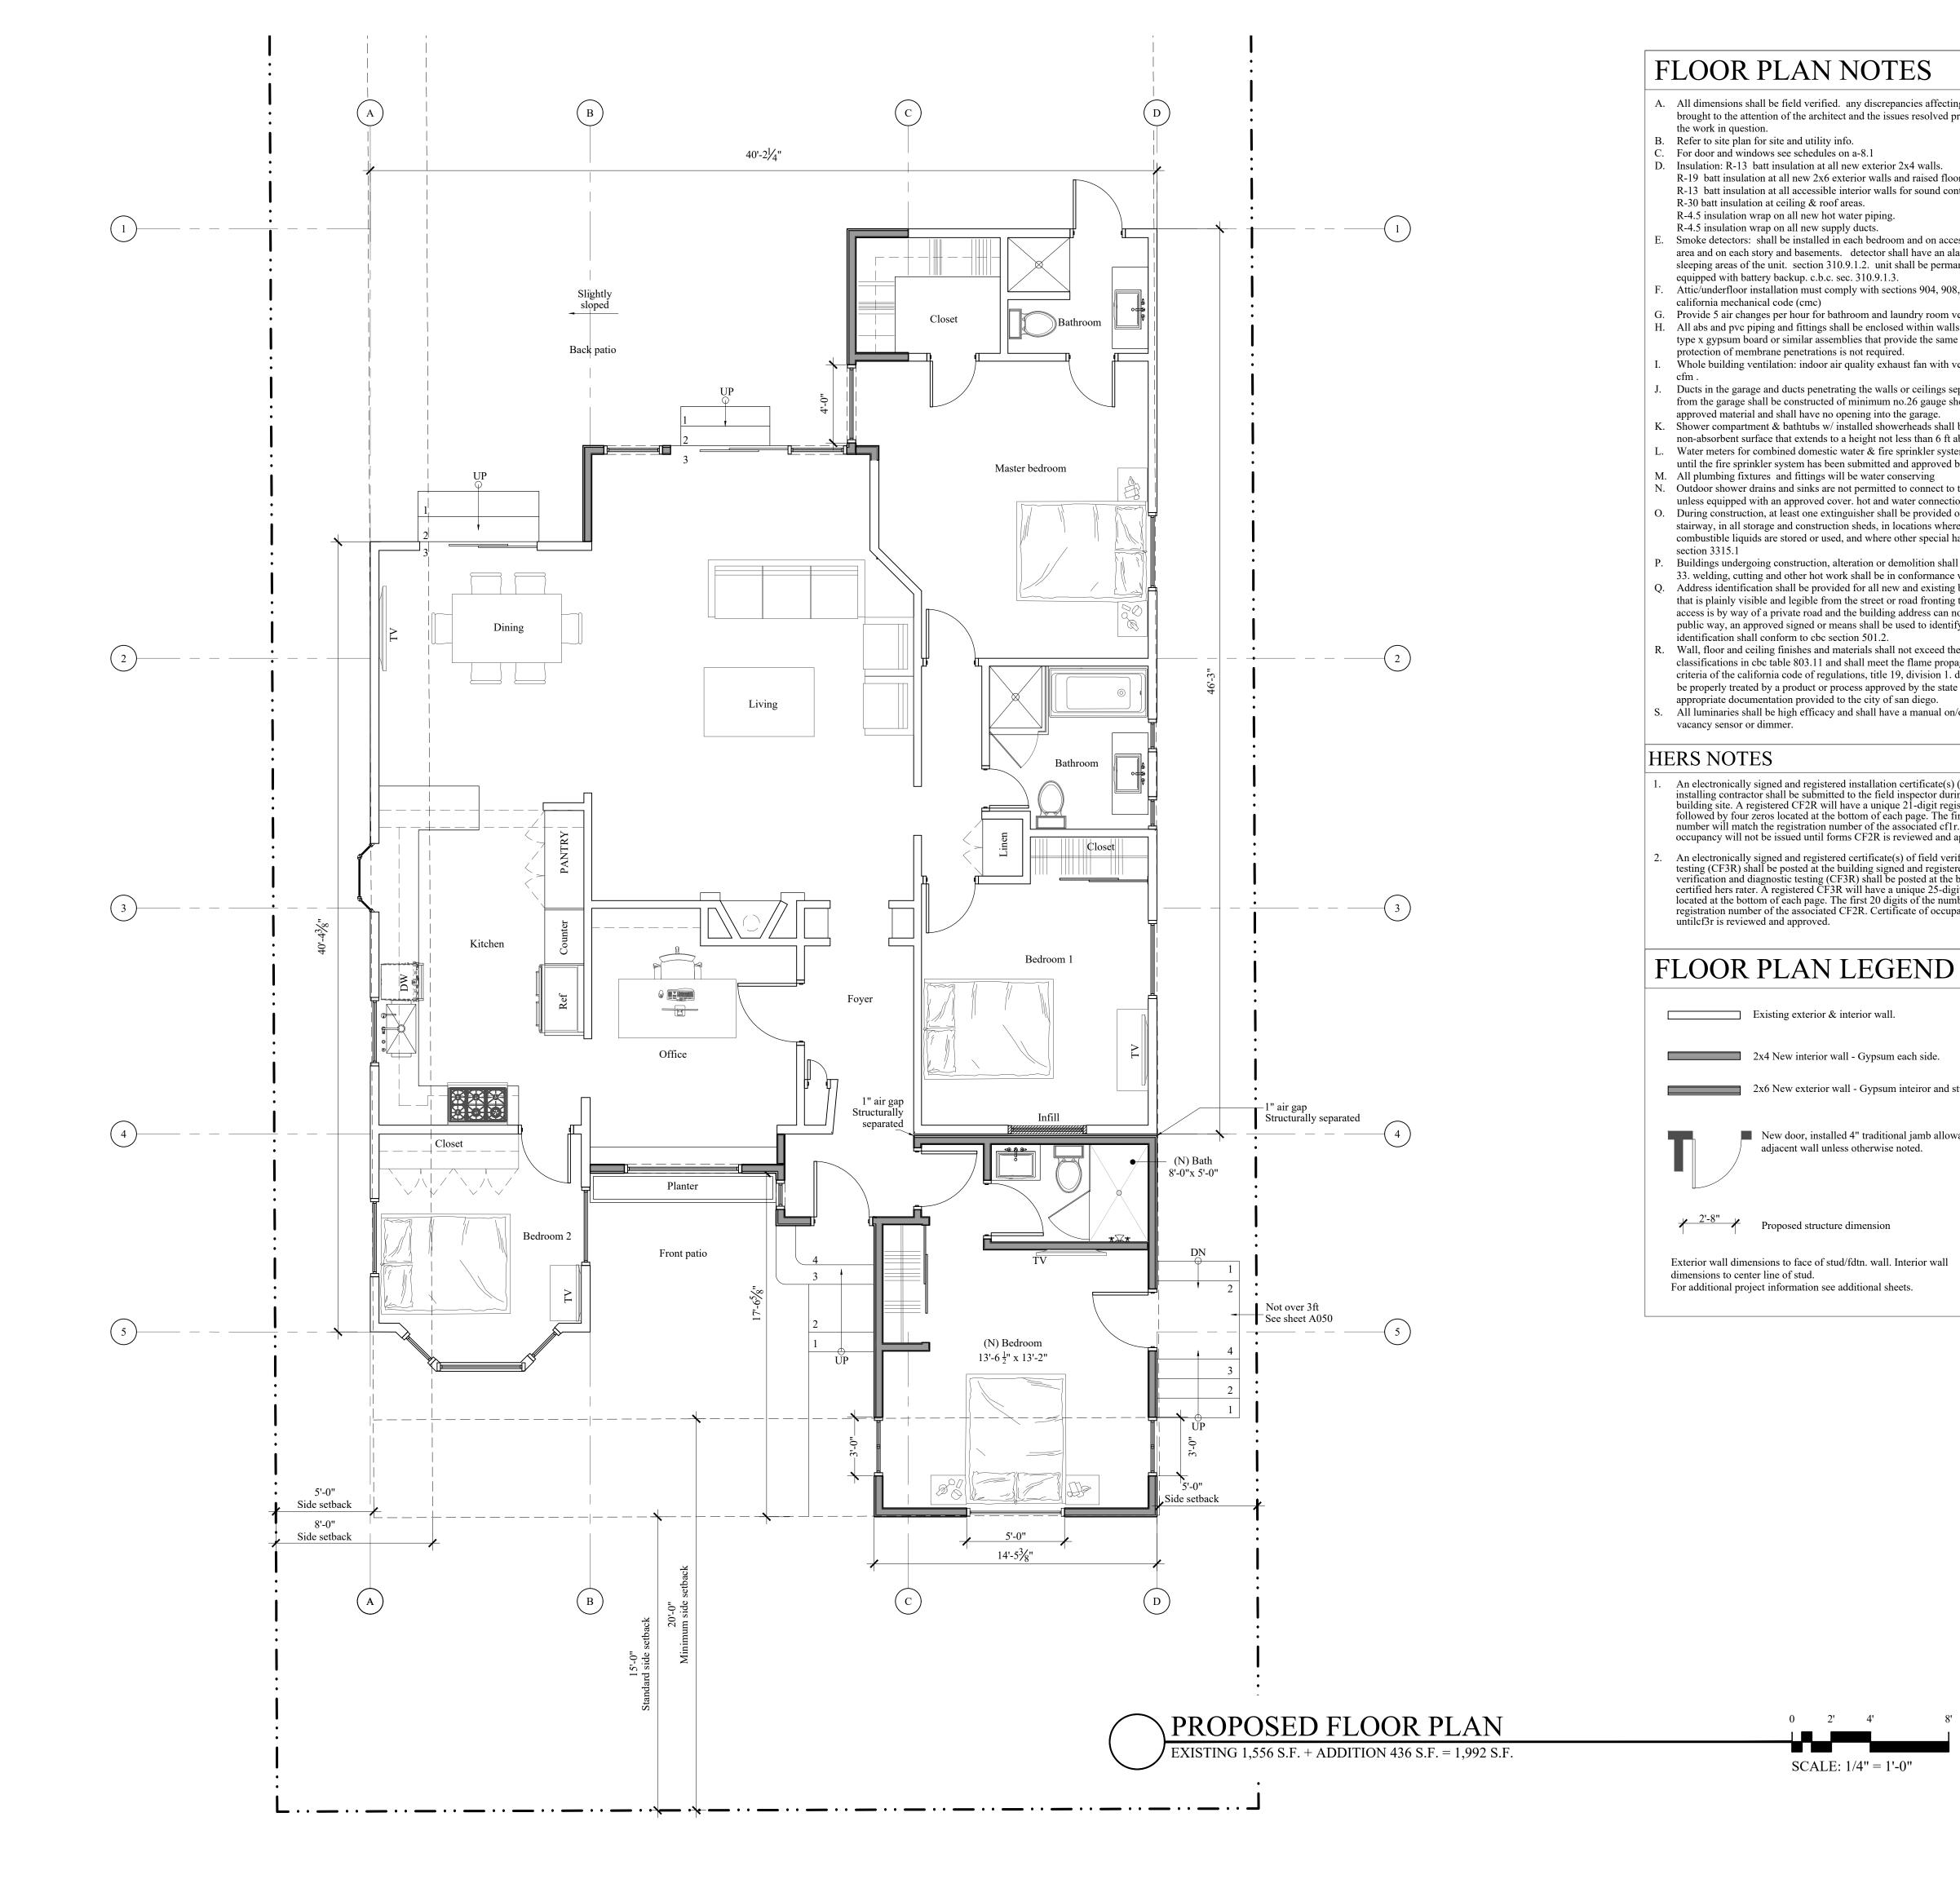R-4.5 insulation wrap on all new supply ducts.

- area and on each story and basements. detector shall have an alarm audible in all sleeping areas of the unit. section 310.9.1.2. unit shall be permanently wired and equipped with battery backup. c.b.c. sec. 310.9.1.3.
- F. Attic/underfloor installation must comply with sections 904, 908, and 909 of the california mechanical code (cmc)
- G. Provide 5 air changes per hour for bathroom and laundry room ventilation. H. All abs and pvc piping and fittings shall be enclosed within walls and floors covered with
- type x gypsum board or similar assemblies that provide the same level of fire protection. protection of membrane penetrations is not required.


Smoke detectors: shall be installed in each bedroom and on access point to each sleeping

- Whole building ventilation: indoor air quality exhaust fan with ventilation rate of 120 Ducts in the garage and ducts penetrating the walls or ceilings separating the dwelling
- from the garage shall be constructed of minimum no.26 gauge sheet steel or other approved material and shall have no opening into the garage. K. Shower compartment & bathtubs w/ installed showerheads shall be finished w/ a
- non-absorbent surface that extends to a height not less than 6 ft above flr. crc r307.2 L. Water meters for combined domestic water & fire sprinkler systems shall not be installed until the fire sprinkler system has been submitted and approved by the bldg official
- M. All plumbing fixtures and fittings will be water conserving N. Outdoor shower drains and sinks are not permitted to connect to the public sewer system
- unless equipped with an approved cover. hot and water connections allowed. O. During construction, at least one extinguisher shall be provided on each floor level at each stairway, in all storage and construction sheds, in locations where flammable or combustible liquids are stored or used, and where other special hazards are present per cfc
- P. Buildings undergoing construction, alteration or demolition shall conform to cfc chapter 33. welding, cutting and other hot work shall be in conformance with cfc chapter 35. Q. Address identification shall be provided for all new and existing buildings in a location
- that is plainly visible and legible from the street or road fronting the property. where access is by way of a private road and the building address can not be viewed from the public way, an approved signed or means shall be used to identify the structure. premises identification shall conform to cbc section 501.2. R. Wall, floor and ceiling finishes and materials shall not exceed the interior finish
- classifications in cbc table 803.11 and shall meet the flame propagation performance criteria of the california code of regulations, title 19, division 1. decorative materials shall be properly treated by a product or process approved by the state fire marshal with appropriate documentation provided to the city of san diego.
- S. All luminaries shall be high efficacy and shall have a manual on/off in addition to a vacancy sensor or dimmer.

HERS NOTES

- 1. An electronically signed and registered installation cestificate(s) (cf2r) posted by the installing contractor shall be submitted to the field inspector during construction at the building site.a registered cf2r will have a unique 21-digit registration number followed by four zeros located at the bottom of each page. the first 12 digits of the number will match the registration number of the associated cf1r. certificate of occupancy wid not be issued until forms cf2ris reviewed and approved.
- An electronically signed and registered certificate(s) of field verification and diagnostic testing (cf3r) shall be posted at the building signed and registered certificate(s) of field verification and diagnostic testing (cf3r) shall be posted at the building site by a certified hers rater. a registered cf3r will have a unique 25-digit registration number located at the bottom of each page. the first 20 digits of the number will match the registration number of the associated cf2r. certificate of occupancy will not be issued untilcf3r is reviewed

FLOOR PLAN LEGEND

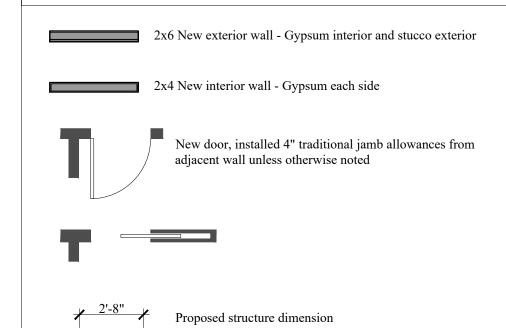

Exterior wall dimensions to face of stud/fdtn. wall. Interior wall dimensions to center line of stud.

For additional project information see additional sheets.

1,556 S.F. + 436 Addition

1,329 S.F. (including garages)

G.F.A. Calculations

LOT = 7,140 S.F..75 F.A.R. = 7,140 X .75 = 5,355 S.F.

Existing house = Unit #2 1st floor = Unit #2 2nd floor = Unit #2 3rd floor = Cabana for Unit #2 =

842 S.F. 1,156 S.F. 5,355 S.F.

ADU #1 1st floor = 150 S.F. ADU #1 2nd floor = TOTAL = 6,305 S.F. Marengo

Morton **Architects**

7724 Girard Ave. Second Floor La Jolla, CA 92037 Tel. (858) 459-3769 Fax. (858) 459-3768 Michael Morton AIA



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REVISIONS	
01/26/2022	PROJECT STAR

FEASIBILITY PHASE

PROJECT NO. 2021-46


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SHEET TITLE PROP. FIRST FLOOR PLAN (BACK HOUSE)



PROPOSED SECOND FLOOR PLAN

(UNIT 2: 842 S.F.) (ADU #1 UNIT: 800 S.F.)



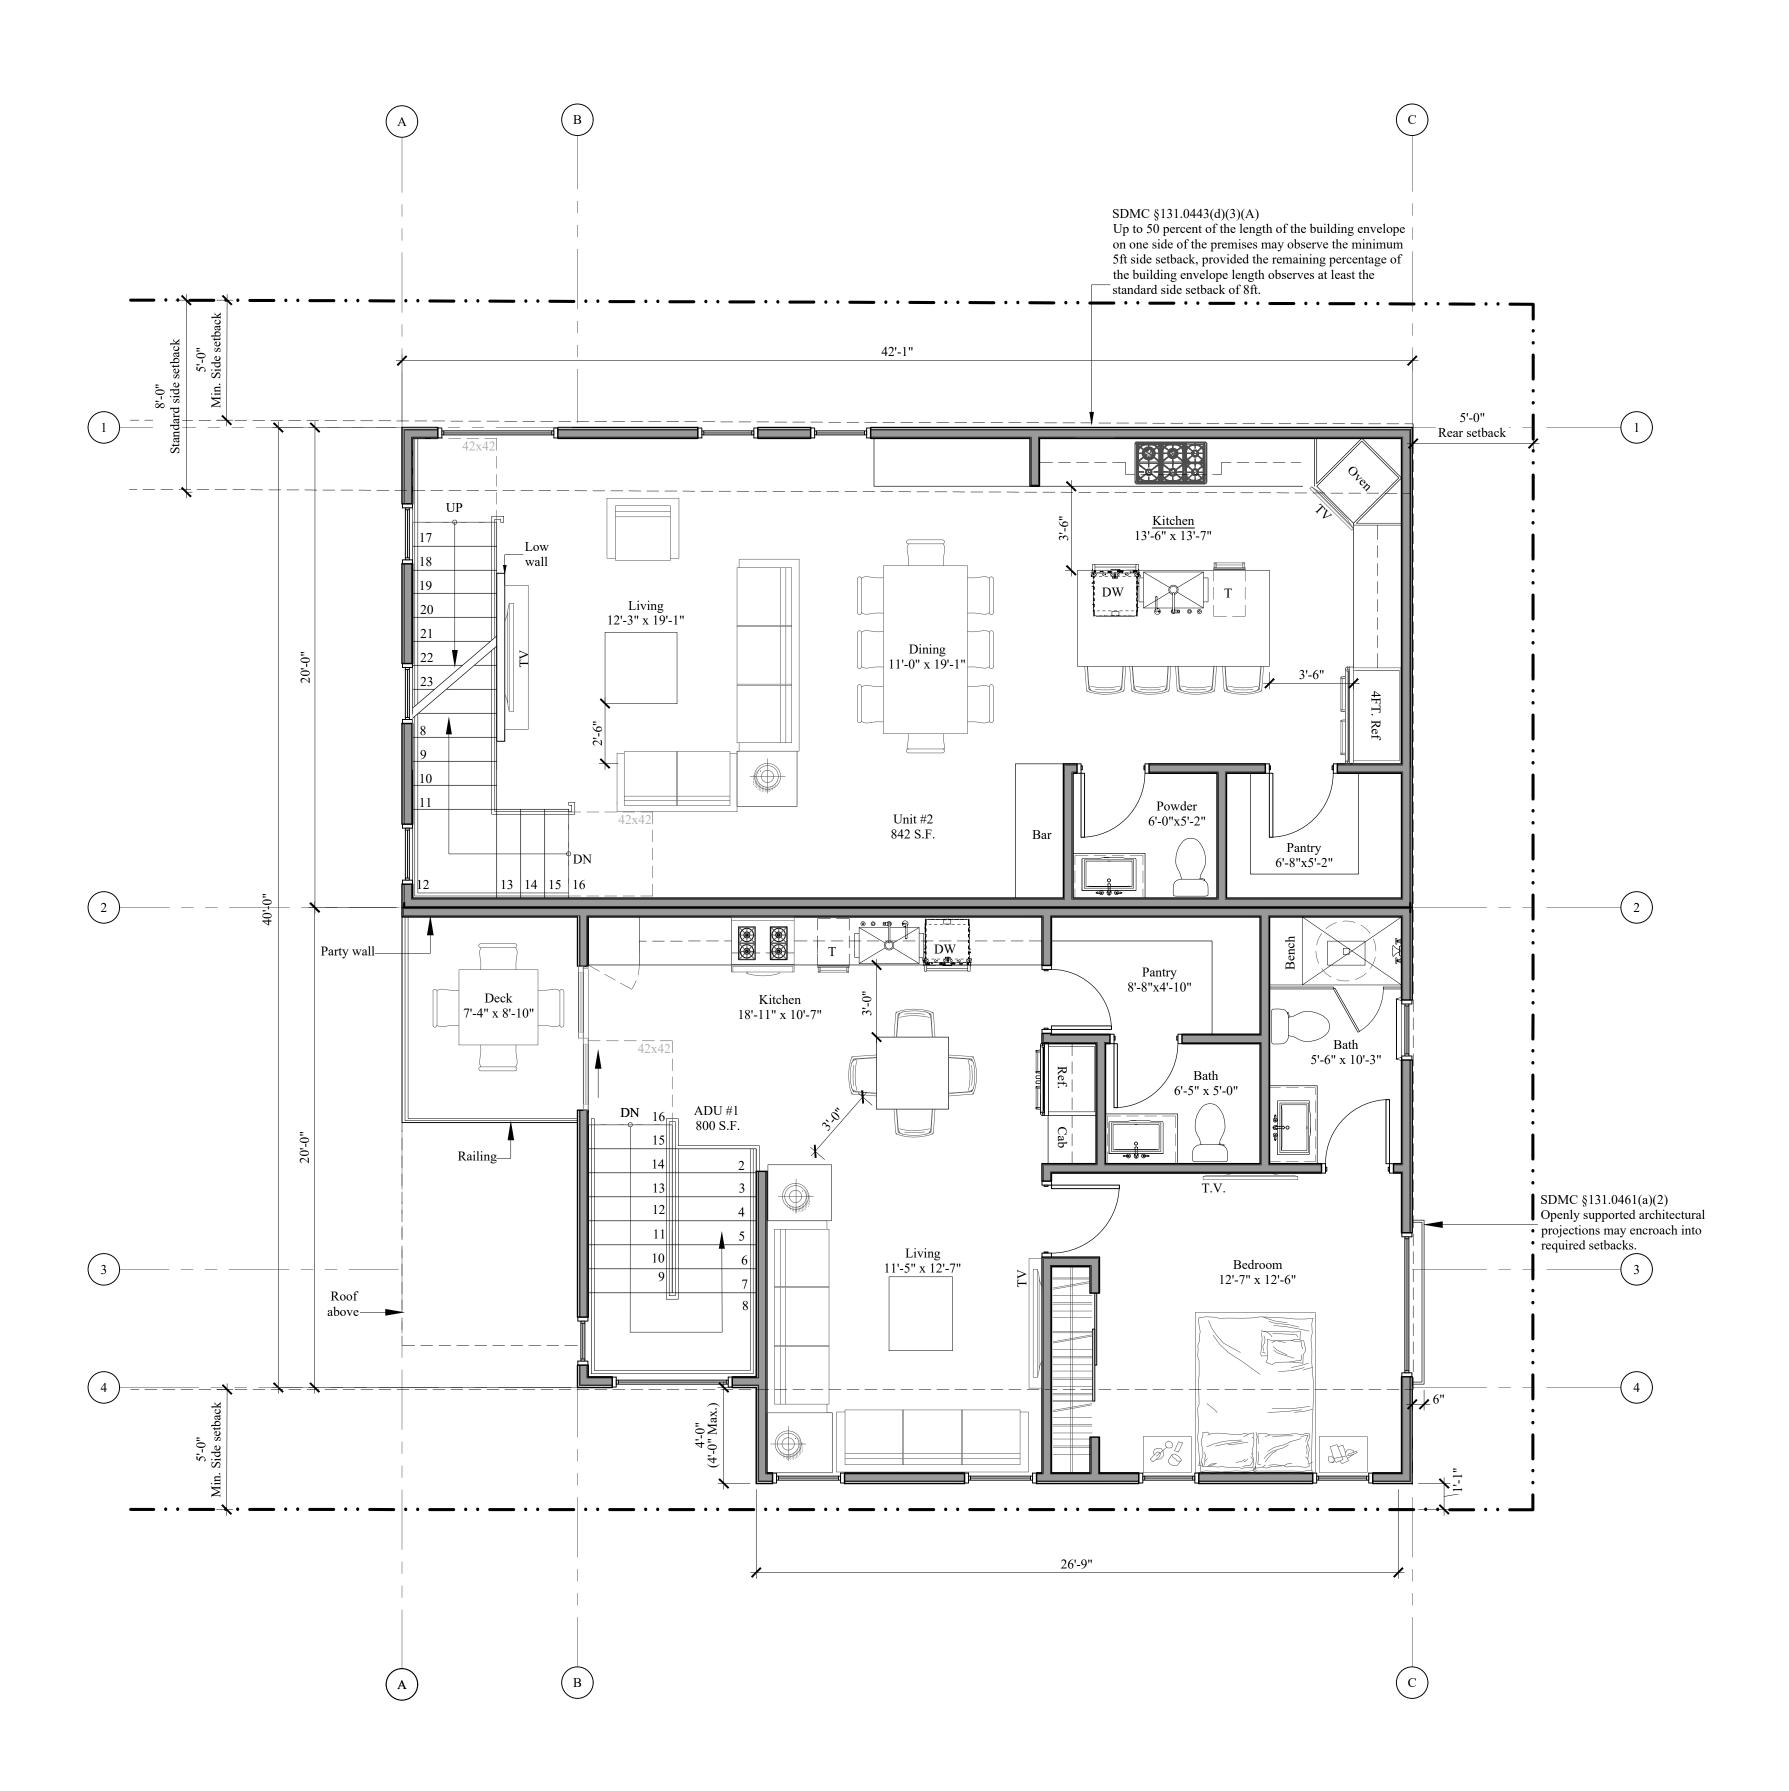

TOTAL =

Cabana for Unit #2 = 5,355 S.F.

ADU #1 1st floor = ADU #1 2nd floor =

ATTACHMENT 11



Marengo Morton Architects

7724 Girard Ave. Second Floor

Michael Morton AIA

Claude Anthony Marengo DESA

₹ C-19371

RENEWAL

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01/26/2022 PROJECT START

FEASIBILITY PHASE

PROJECT NO. 2021-46

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DATE 02/08/2024

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FLOOR PLAN (BACK HOUSE)

DRAWN BY AP

04/30/2025

La Jolla, CA 92037 Tel. (858) 459-3769

K. Shower compartment & bathtubs w/ installed showerheads shall be finished w/ a Fax. (858) 459-3768 non-absorbent surface that extends to a height not less than 6 ft above flr. crc r307.2

Water meters for combined domestic water & fire sprinkler systems shall not be installed until the fire sprinkler system has been submitted and approved by the bldg official

M. All plumbing fixtures and fittings will be water conserving N. Outdoor shower drains and sinks are not permitted to connect to the public sewer system

FLOOR PLAN NOTES

D. Insulation: R-13 batt insulation at all new exterior 2x4 walls.

equipped with battery backup. c.b.c. sec. 310.9.1.3.

protection of membrane penetrations is not required.

approved material and shall have no opening into the garage.

R-19 batt insulation at all new 2x6 exterior walls and raised floor areas R-13 batt insulation at all accessible interior walls for sound control.

B. Refer to site plan for site and utility info.C. For door and windows see schedules on a-8.1

R-30 batt insulation at ceiling & roof areas. R-4.5 insulation wrap on all new hot water piping. R-4.5 insulation wrap on all new supply ducts.

california mechanical code (cmc)

the work in question.

A. All dimensions shall be field verified. any discrepancies affecting project layout shall be brought to the attention of the architect and the issues resolved prior to proceeding with

Smoke detectors: shall be installed in each bedroom and on access point to each sleeping area and on each story and basements. detector shall have an alarm audible in all sleeping areas of the unit. section 310.9.1.2. unit shall be permanently wired and

Attic/underfloor installation must comply with sections 904, 908, and 909 of the

H. All abs and pvc piping and fittings shall be enclosed within walls and floors covered with

type x gypsum board or similar assemblies that provide the same level of fire protection.

Whole building ventilation: indoor air quality exhaust fan with ventilation rate of 120

J. Ducts in the garage and ducts penetrating the walls or ceilings separating the dwelling

from the garage shall be constructed of minimum no.26 gauge sheet steel or other

G. Provide 5 air changes per hour for bathroom and laundry room ventilation.

unless equipped with an approved cover. hot and water connections allowed. O. During construction, at least one extinguisher shall be provided on each floor level at each stairway, in all storage and construction sheds, in locations where flammable or combustible liquids are stored or used, and where other special hazards are present per cfc section 3315.1

P. Buildings undergoing construction, alteration or demolition shall conform to cfc chapter 33. welding, cutting and other hot work shall be in conformance with cfc chapter 35.

Q. Address identification shall be provided for all new and existing buildings in a location that is plainly visible and legible from the street or road fronting the property. where access is by way of a private road and the building address can not be viewed from the public way, an approved signed or means shall be used to identify the structure. premises identification shall conform to cbc section 501.2.

R. Wall, floor and ceiling finishes and materials shall not exceed the interior finish classifications in cbc table 803.11 and shall meet the flame propagation performance criteria of the california code of regulations, title 19, division 1. decorative materials shall be properly treated by a product or process approved by the state fire marshal with appropriate documentation provided to the city of san diego.

All luminaries shall be high efficacy and shall have a manual on/off in addition to a vacancy sensor or dimmer.

HERS NOTES

An electronically signed and registered installation cestificate(s) (cf2r) posted by the installing contractor shall be submitted to the field inspector during construction at the building site.a registered cf2r will have a unique 21-digit registration number followed by four zeros located at the bottom of each page, the first 12 digits of the number will match the registration number of the associated cflr. certificate of occupancy wid not be issued until forms cf2ris reviewed and approved.

An electronically signed and registered certificate(s) of field verification and diagnostic testing (cf3r) shall be posted at the building signed and registered certificate(s) of field verification and diagnostic testing (cf3r) shall be posted at the building site by a certified hers rater. a registered cf3r will have a unique 25-digit registration number located at the bottom of each page. the first 20 digits of the number will match the registration number of the associated cf2r. certificate of occupancy will not be issued untilcf3r is reviewed and approved.

FLOOR PLAN LEGEND

2x6 New exterior wall - Gypsum interior and stucco exterior 2x4 New interior wall - Gypsum each side New door, installed 4" traditional jamb allowances from adjacent wall unless otherwise noted

Proposed structure dimension Exterior wall dimensions to face of stud/fdtn. wall. Interior wall dimensions to center line of stud.

For additional project information see additional sheets.

G.F.A. Calculations

LOT = 7,140 S.F..75 F.A.R. = 7,140 X .75 = 5,355 S.F.

Existing house = Unit #2 1st floor = Unit #2 2nd floor = Unit #2 3rd floor =


1,556 S.F. + 436 Addition 1,329 S.F. (including garages) 842 S.F. 1,156 S.F.

6,305 S.F.

150 S.F. 800 S.F.

A024

SHEET TITLE PROP. SECOND

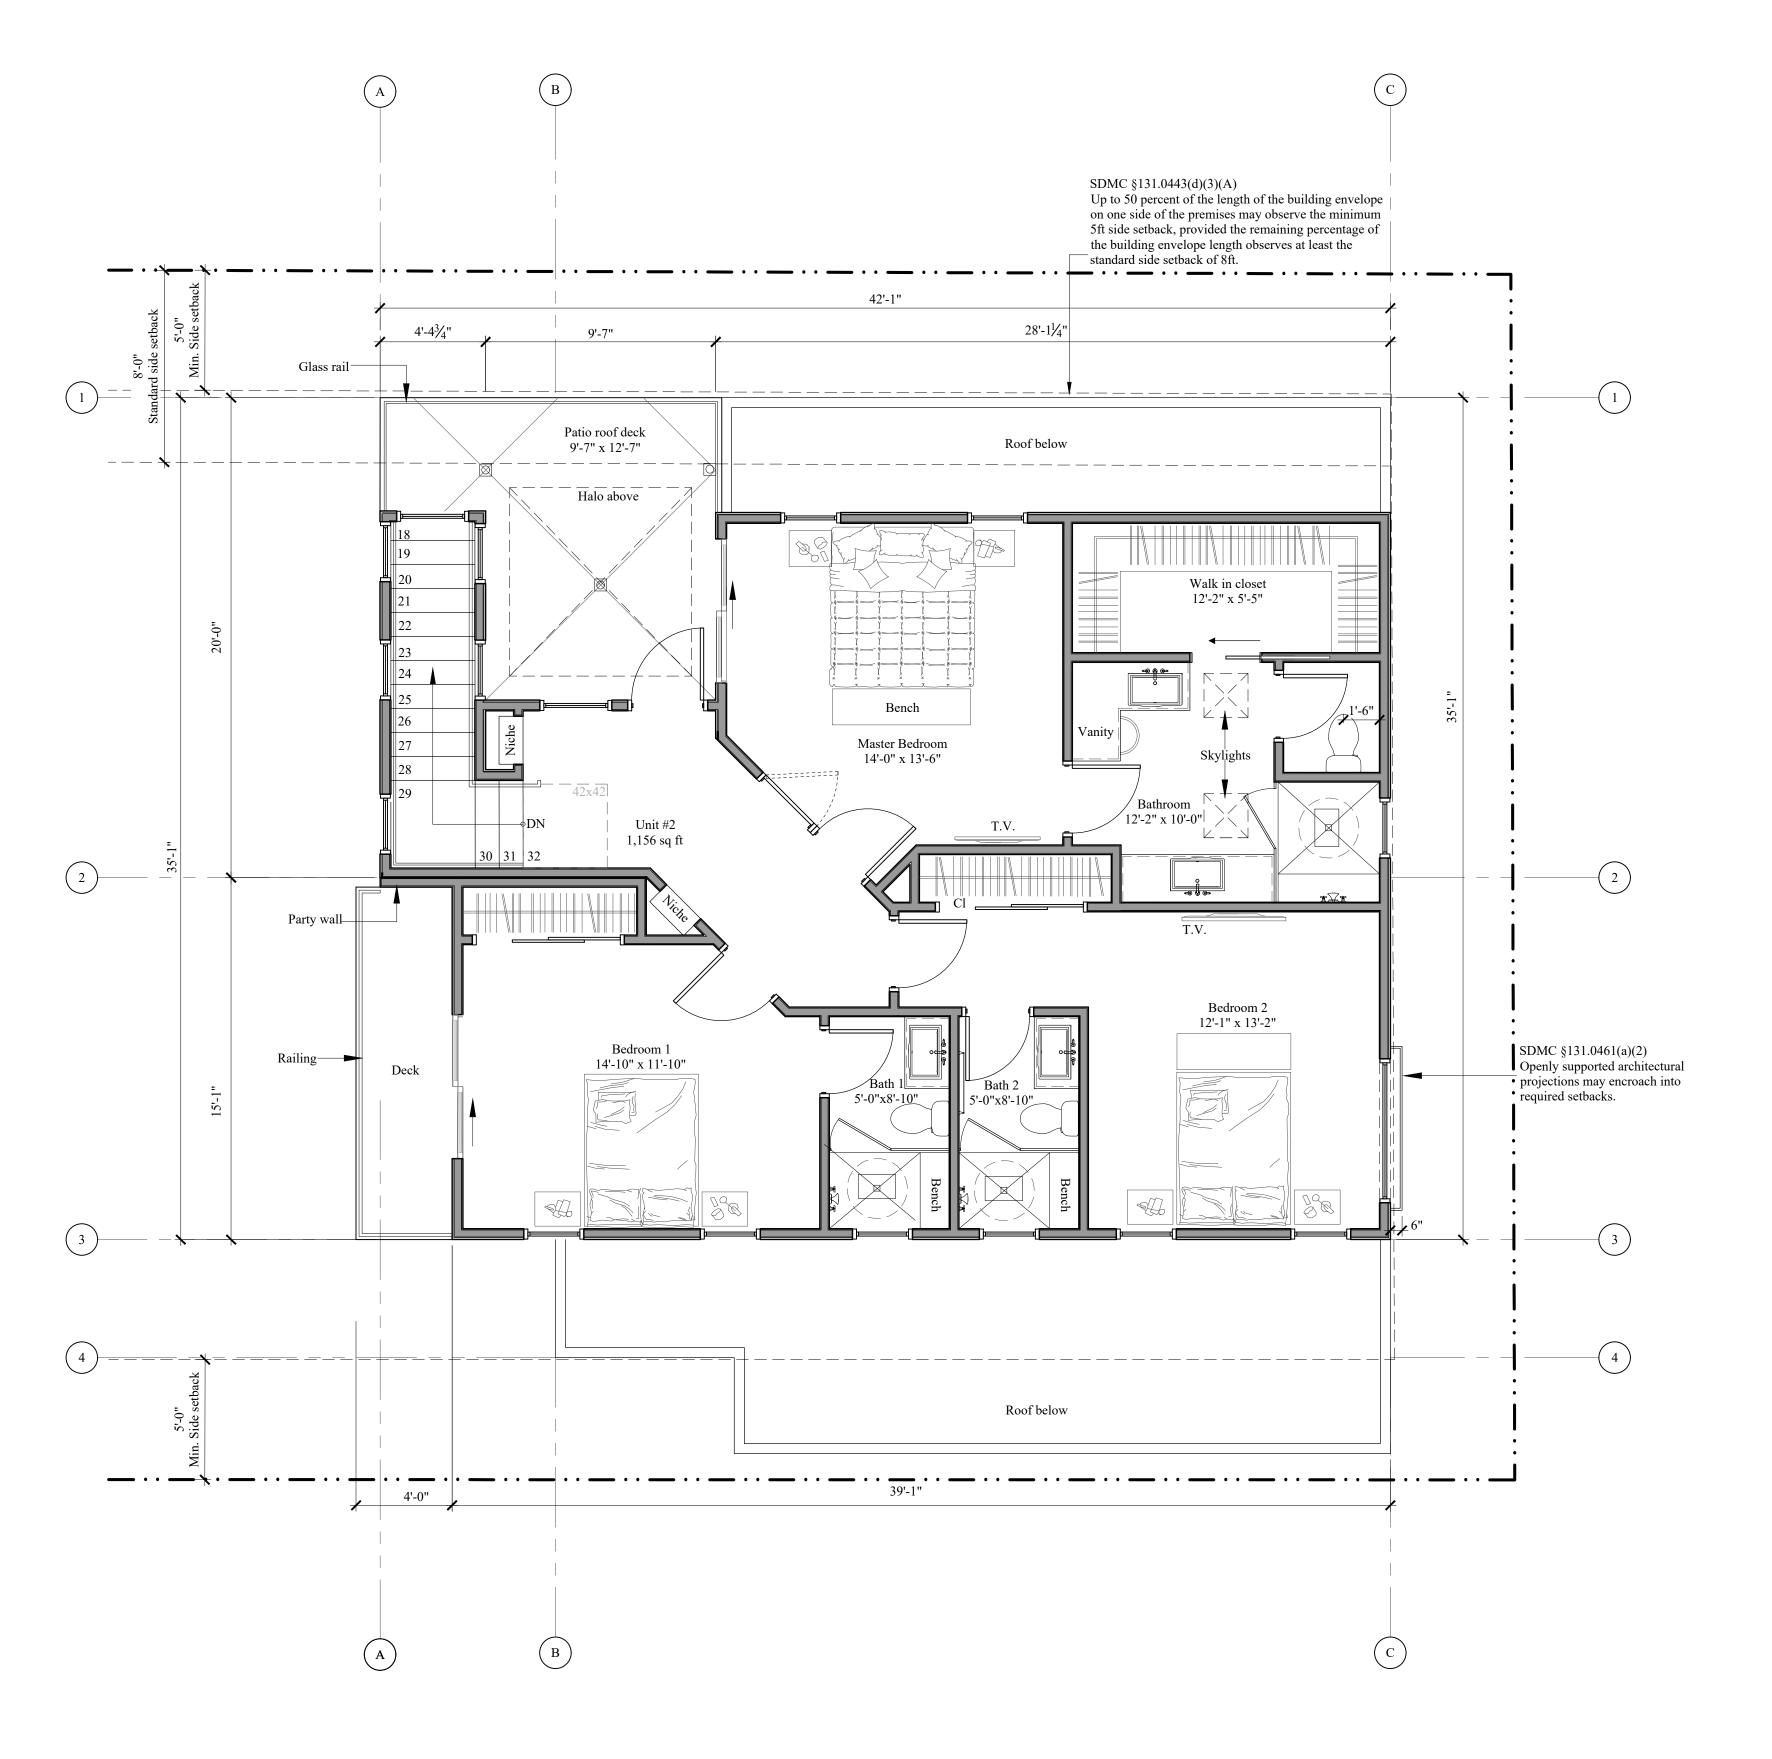

PROPOSED THIRD FLOOR PLAN

(UNIT 2: 1,156 S.F. @ SECOND FLOOR)

FLOOR PLAN NOTES

- A. All dimensions shall be field verified. any discrepancies affecting project layout shall be brought to the attention of the architect and the issues resolved prior to proceeding with the work in question.
- B. Refer to site plan for site and utility info.
- C. For door and windows see schedules on a-8.1 D. Insulation: R-13 batt insulation at all new exterior 2x4 walls. R-19 batt insulation at all new 2x6 exterior walls and raised floor areas R-13 batt insulation at all accessible interior walls for sound control.

R-30 batt insulation at ceiling & roof areas. R-4.5 insulation wrap on all new hot water piping.

- R-4.5 insulation wrap on all new supply ducts. Smoke detectors: shall be installed in each bedroom and on access point to each sleeping area and on each story and basements. detector shall have an alarm audible in all sleeping areas of the unit. section 310.9.1.2. unit shall be permanently wired and
- equipped with battery backup. c.b.c. sec. 310.9.1.3. F. Attic/underfloor installation must comply with sections 904, 908, and 909 of the california mechanical code (cmc)
- G. Provide 5 air changes per hour for bathroom and laundry room ventilation. H. All abs and pvc piping and fittings shall be enclosed within walls and floors covered with
- type x gypsum board or similar assemblies that provide the same level of fire protection. protection of membrane penetrations is not required. Whole building ventilation: indoor air quality exhaust fan with ventilation rate of 120
- J. Ducts in the garage and ducts penetrating the walls or ceilings separating the dwelling
- from the garage shall be constructed of minimum no.26 gauge sheet steel or other approved material and shall have no opening into the garage. K. Shower compartment & bathtubs w/ installed showerheads shall be finished w/ a
- non-absorbent surface that extends to a height not less than 6 ft above flr. crc r307.2 L. Water meters for combined domestic water & fire sprinkler systems shall not be installed until the fire sprinkler system has been submitted and approved by the bldg official
- M. All plumbing fixtures and fittings will be water conserving N. Outdoor shower drains and sinks are not permitted to connect to the public sewer system unless equipped with an approved cover. hot and water connections allowed.
- O. During construction, at least one extinguisher shall be provided on each floor level at each stairway, in all storage and construction sheds, in locations where flammable or combustible liquids are stored or used, and where other special hazards are present per cfc section 3315.1
- P. Buildings undergoing construction, alteration or demolition shall conform to cfc chapter 33. welding, cutting and other hot work shall be in conformance with cfc chapter 35. Address identification shall be provided for all new and existing buildings in a location that is plainly visible and legible from the street or road fronting the property. where access is by way of a private road and the building address can not be viewed from the public way, an approved signed or means shall be used to identify the structure. premises
- identification shall conform to cbc section 501.2. R. Wall, floor and ceiling finishes and materials shall not exceed the interior finish classifications in cbc table 803.11 and shall meet the flame propagation performance criteria of the california code of regulations, title 19, division 1. decorative materials shall be properly treated by a product or process approved by the state fire marshal with appropriate documentation provided to the city of san diego.
- All luminaries shall be high efficacy and shall have a manual on/off in addition to a vacancy sensor or dimmer.

HERS NOTES

- An electronically signed and registered installation cestificate(s) (cf2r) posted by the installing contractor shall be submitted to the field inspector during construction at the building site.a registered cf2r will have a unique 21-digit registration number followed by four zeros located at the bottom of each page. the first 12 digits of the number will match the registration number of the associated cf1r. certificate of occupancy wid not be issued until forms cf2ris reviewed and approved.
- An electronically signed and registered certificate(s) of field verification and diagnostic testing (cf3r) shall be posted at the building signed and registered certificate(s) of field verification and diagnostic testing (cf3r) shall be posted at the building site by a certified hers rater. a registered cf3r will have a unique 25-digit registration number located at the bottom of each page. the first 20 digits of the number will match the registration number of the associated cf2r. certificate of occupancy will not be issued untilcf3r is reviewed and approved.

FLOOR PLAN LEGEND

2x6 New exterior wall - Gypsum interior and stucco exterior 2x4 New interior wall - Gypsum each side New door, installed 4" traditional jamb allowances from adjacent wall unless otherwise noted



Proposed structure dimension

Exterior wall dimensions to face of stud/fdtn. wall. Interior wall dimensions to center line of stud.

For additional project information see additional sheets.

G.F.A. Calculations

LOT = 7,140 S.F..75 F.A.R. = 7,140 X .75 = 5,355 S.F.

SCALE: 1/4" = 1'-0"

Existing house = 1,556 S.F. + 436 Addition 1,329 S.F. (including garages) Unit #2 1st floor = Unit #2 2nd floor = 842 S.F. Unit #2 3rd floor = 1,156 S.F. 36 S.F. 5,355 S.F. Cabana for Unit #2 =

ADU #1 1st floor = 150 S.F. ADU #1 2nd floor = 800 S.F. 950 S.F. TOTAL =6,305 S.F.

ATTACHMENT 11



Marengo Morton **Architects**

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Claude Anthony Marengo Desa

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DEVELOPA

01/26/2022 PROJECT START

FEASIBILITY PHASE

PROJECT NO. 2021-46

REVIEWED BY CAM

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DATE 02/08/2024

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SHEET TITLE PROP. THIRD FLOOR PLAN (BACK HOUSE)

STORM DRAINAGE NOTES

PUBLIC STORM SEWER

MAINTENANCE PERSONNEL

HEIGHT NOTES

VERIFIED TO ENSURE COMPLIANCE

ROOF NOTES

30' ABOVE GRADE.

1. THE PRIMARY STORM DRAINAGE SYSTEM SHALL CONNECT TO THE BUILDING STORM WATER THAT CONNECTS TO AN UNDERGROUND

THE HIGHEST POINT OF THE ROOF, EQUIPMENT, OR ANY VENT,

PIPE, ANTENNA OR OTHER PROJECTION, SHALL NOT EXCEED

NO PORTION OF THE PROPOSED STRUCTURE WILL EXCEED THE

EXISTING BUILDING HEIGHT. PROPOSED HEIGHT TO BE FIELD

1. ROOFING UNDERLAYMENT SLOPE 3:12 OR LESS: "ICE AND WATER SHIELD" BY W.R. GRACE, ESR-1677, OR "WINTER GUARD HT" BY

INSTALL PER MANUFACTURER'S INSTRUCTIONS. INSTALL A #40

FIBERGLASS REINFORCED FELT SHEET OVER ROOF MEMBRANE.

USING G-26 (LATEX -CEMENT) FLOORING UNDERLAYMENT BY

CERTAIN TEED CORP. ESR-1492 (OR ARCHITECT APPROVED EOUAL).

COUNTER-SLOPES: ¼" PER 12" (MINIMUM) TOWARDS DRAINS CREATED

CROSSFIELD PRODUCTS CORP.
ROOF EDGE DRIP, METAL FLASHING, PANEL CLIPS AND COUNTER

OTHERWISE NOTED. SOLDER OR SEAL ALL SEAMS. HEM ALL EXPOSED

MODIFIED BITUMEN MINERAL SURFACED ROOFING SYSTEM. PROVED A

FLASHING: ALL EXTERIOR FLASHING TO BE 16 OZ COPPER UNLESS

BUILT-UP ROOFING SYSTEM: BY GAF, GAFGLAS 4-PLY HOT MOPPED

1/4" PER FOOT MINIMUM ROOF SLOPE. INSTALL PER MANUFACTURES

INSTRUCTION . ROOFING SYSTEM SHALL HAVE A MINIMUM 10 YEAR

LABOR AND MATERIAL WARRANTY. PER SPECIFICATION DIVISION 7.1, SECTION G. FOR FLASHING, "SPRINGLOK" FLASHING SYSTEM, TYPE STX.

BY FRY REGLET CORP. MATERIAL 26 GA. PROVIDE "WINDLOK" CLIPS

PARAPET, TRANSITIONS AND OTHER HORIZONTAL STUCCO SURFACE

WATERPROOFING: MEMBRANE WATERPROOFING SHALL BE JIFFY SEAL

BELOW EDGE OF PARAPET, EACH SIDE. PROVIDE A MINIMUM END LAP

OF 4" OVER ADJOINING MEMBRANE SHEETS. WHERE MEMBRANE ABUTS

VERTICAL SURFACES, THE MEMBRANE SHALL EXTEND 6" UP SURFACE,

ROOF DRAIN. ROOF DRAIN SHALL BE TPO-RD2NH - 2" TPO-CLAD NO-HUB

DOME STRAINER. TELEPHONE (800) 658-2473. PROVIDE 3" I.D. ABS DRAIN

BOTTOM OUTLET DRAIN BY **THUNDERBIRD PRODUCTS** WITH A.B.S.

LINES WITH MIN.¼":1' SLOPE, CONNECT TO BUILDING STORM WATER.

STEEL AS REQUIRED BY FIREPLACE MANUFACTURER. MINIMUM SIZE

MESH IN SPARK ARRESTOR SHALL BE 1/4". MESH SHALL BE STAINLESS

BE "CARMEL BLEND BY US TILE, ESR-1017. PROVIDE A 3'X3' SAMPLE OF MOCK OF TALE PATTER N AND COLOR FOR OWNER AND ARCHITECTS APPROVAL PRIOR TO ORDERING MATERIAL. INSTALL WITH RANDOM EXPOSURE PATTERN. PROVIDE 20% RANDOM FIELD BOOSTERS. INSTALL

ROOF GUTTERS SHALL BE PROVIDED WITH THE MEANS TO PREVENT THE ACCUMULATION OF LEAVES AND DEBRIS IN THE GUTTER. ALL ROOF

ROOF VENT: TPO PRE-MOLDED ROOF VENTING SEE DETAIL 6/A-10.4.1 10. CLAY TILE ROOFING: ROOFING SHALL BE TWO-PIECE MISSION TILE, TO

PER MANUFACTURERS INSTRUCTIONS OVER 40# ROOFING FELT UNDERLAYMENT AT ROOF WITH A MINIMUM OF 3 TO 12 SLOPE. ALL

GUTTERS AND DOWNSPOUTS SHALL BE CONSTRUCTED OF

12. DRIP EDGE FLASHING USED AT THE FREE EDGES OF ROOFING

CAP SHEET RUNNING THE FULL LENGTH OF THE VALLEY. 14. TURBINE ATTIC VENTS SHALL BE EQUIPPED TO ALLOW ONE-WAY DIRECTION ROTATION ONLY AND SHALL NOT FREE SPIN IN BOTH

13. VALLEY FLASHINGS SHALL BE NOT LESS THAN 0.019' (#26 COPPER GAUGE) CORROSION-RESISTANT METAL INSTALLED OVER A MIN. 36"-WIDE UNDERLAYMENT CONSISTING OF ONE LAYER OF NO. 72 ASTM

15. ENCLOSED RAFTER ASSEMBLIES NOT REQUIRED TO BE VENTED PER

COVERING THAT IS AT LEAST CLASS 'A' WHEN THE AREA OF THE

16. THE ENTIRE ROOF SHALL BE COVERED WITH A FIRE-RETARDANT ROOF

ADDITION TO THE EXISTING BUILDING IS MORE THAN TWENTY-FIVE PERCENT (25%) OF THE ORIGINAL FLOOR AREA OF THE BUILDING [SDMC

ROOF DRAIN WITH OVERFLOW, SEE DET. 4/A-10.3

ROOFING MATERIALS SHALL BE CLASS "A".

MATERIALS SHALL BE NON-COMBUSTIBLE.

NON-COMBUSTIBLE MATERIALS.

FIREPLACE VENT: FIREPLACE VENT SHALL BE TYPE B STAINLESS

140/60 BY PROTECTO WRAP. EXTEND MEMBRANE A MINIMUM OF 6"

AND PREFABRICATED MITERED CORNER SECTIONS. INSTALL PER MANUFACTURER'S SPECIFICATIONS. ROOFING SYSTEM SHALL BE A UL

CLASS "A" RATED. ICC REPORT UL ER 1306-02.

PLUMBING VENT: ABS PLASTIC TO BE FLASHED WITH

AND BE OVERLAPPED BY BUILDING WRAP. ESR-1127.

STEEL OR COPPER.

DIRECTIONS.

CRC R806.5.

149.0902(A)(2)].

ROOF LEGEND

SLOPE $\frac{1}{4}$: 12

CARLISLE-SYNTEC TPO PRE-MOLDED PIPE FLASHING.

THE SECONDARY ROOF DRAINAGE SYSTEM SHALL DISCHARGE ABOVE GRADE, IN A LOCATION OBSERVABLE BY THE BUILDING OCCUPANTS OR

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s Avenue A, 92037

01/26/2022 PROJECT START

FEASIBILITY PHASE

PROJECT NO. 2021-46


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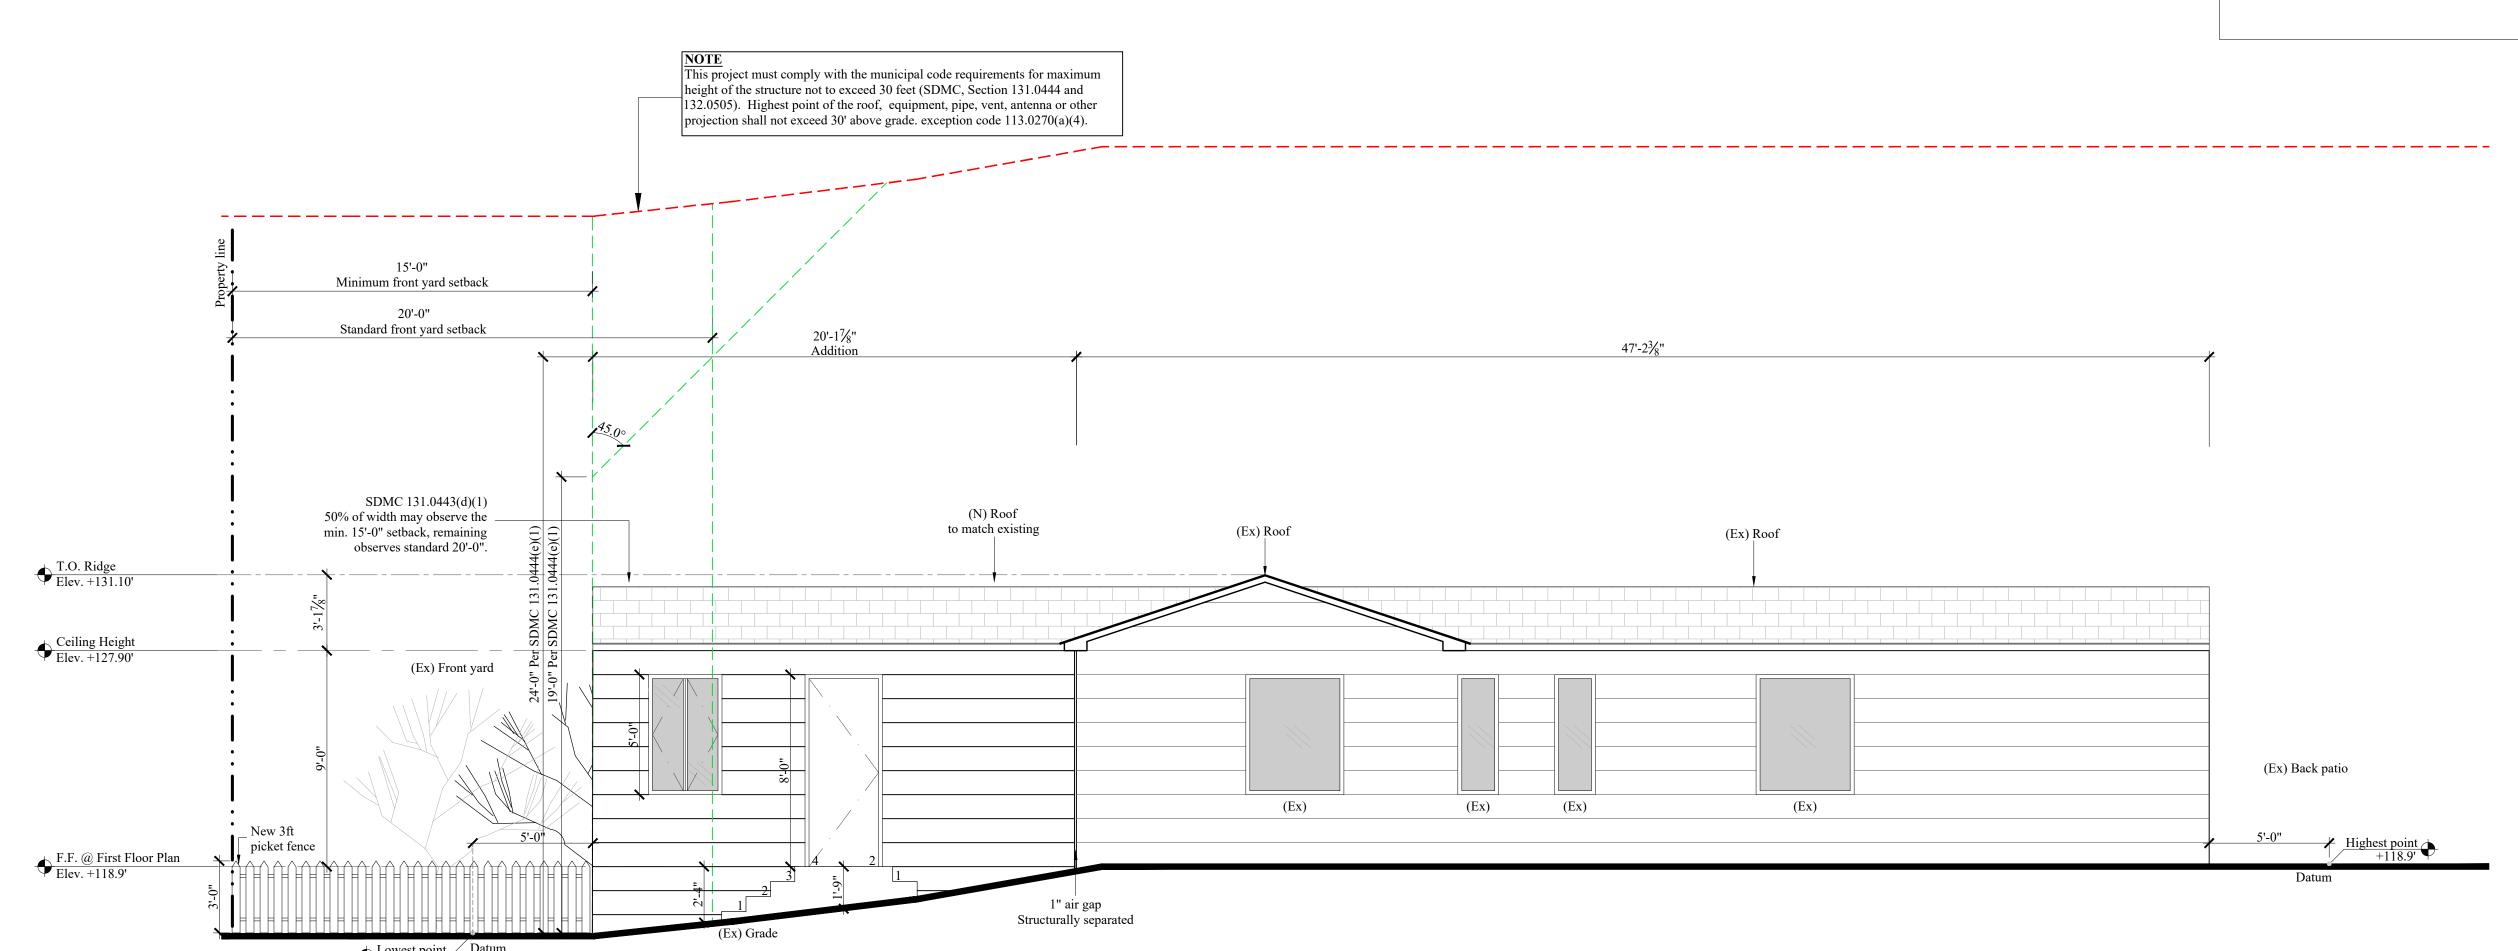
SHEET TITLE ROOF




PROPOSED ROOF PLAN


ELEVATION NOTES

- A. All dimensions shall be field verified. Any discrepancies affecting project layout shall be brought to the attention of the architect and the issues resolved prior to proceeding with the work in question.
- B. Refer to site plan for site and utility information.
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\PROPOSED SOUTH ELEVATION - EXISTING HOME - SIDE VIEW

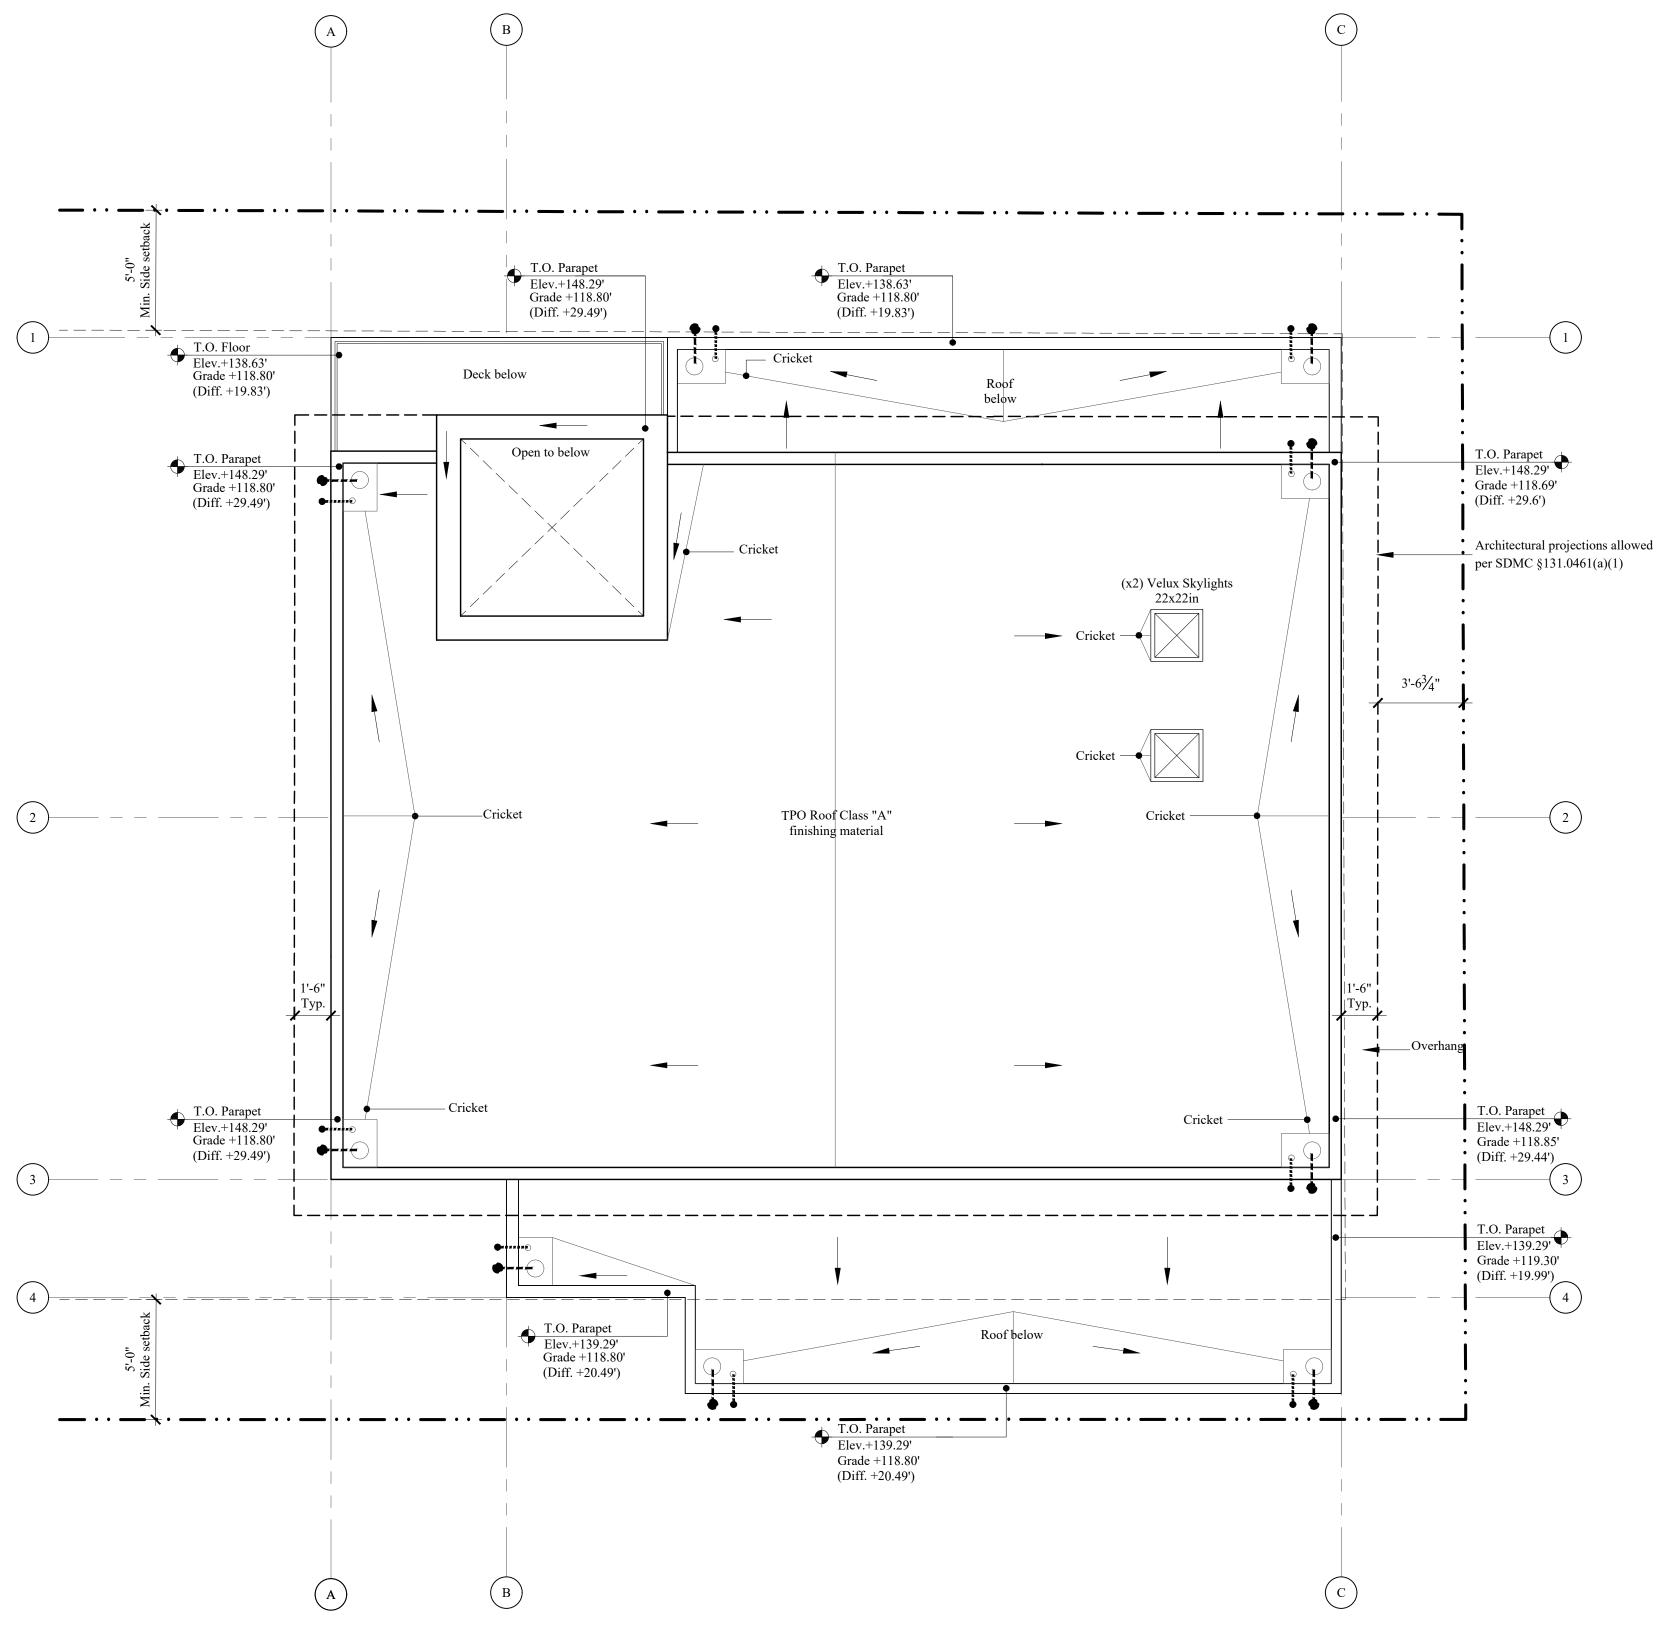

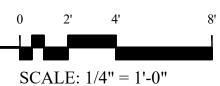

ATTACHMENT 11

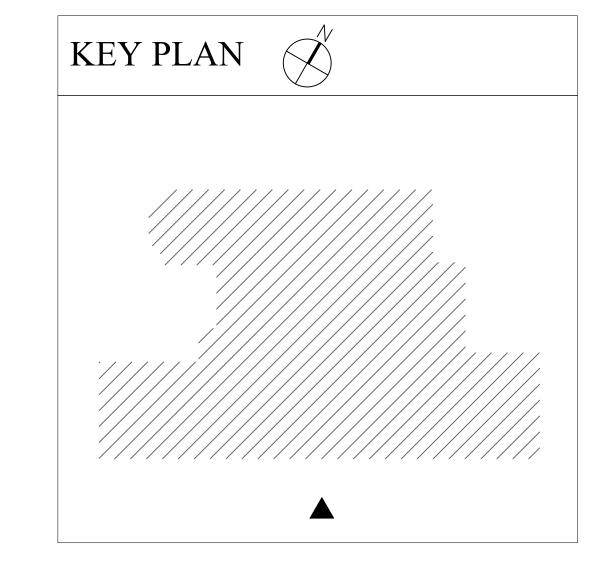

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EADS DEVELOPMENT
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REVISIONS 01/26/2022 PROJECT START

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FEASIBILITY PHASE

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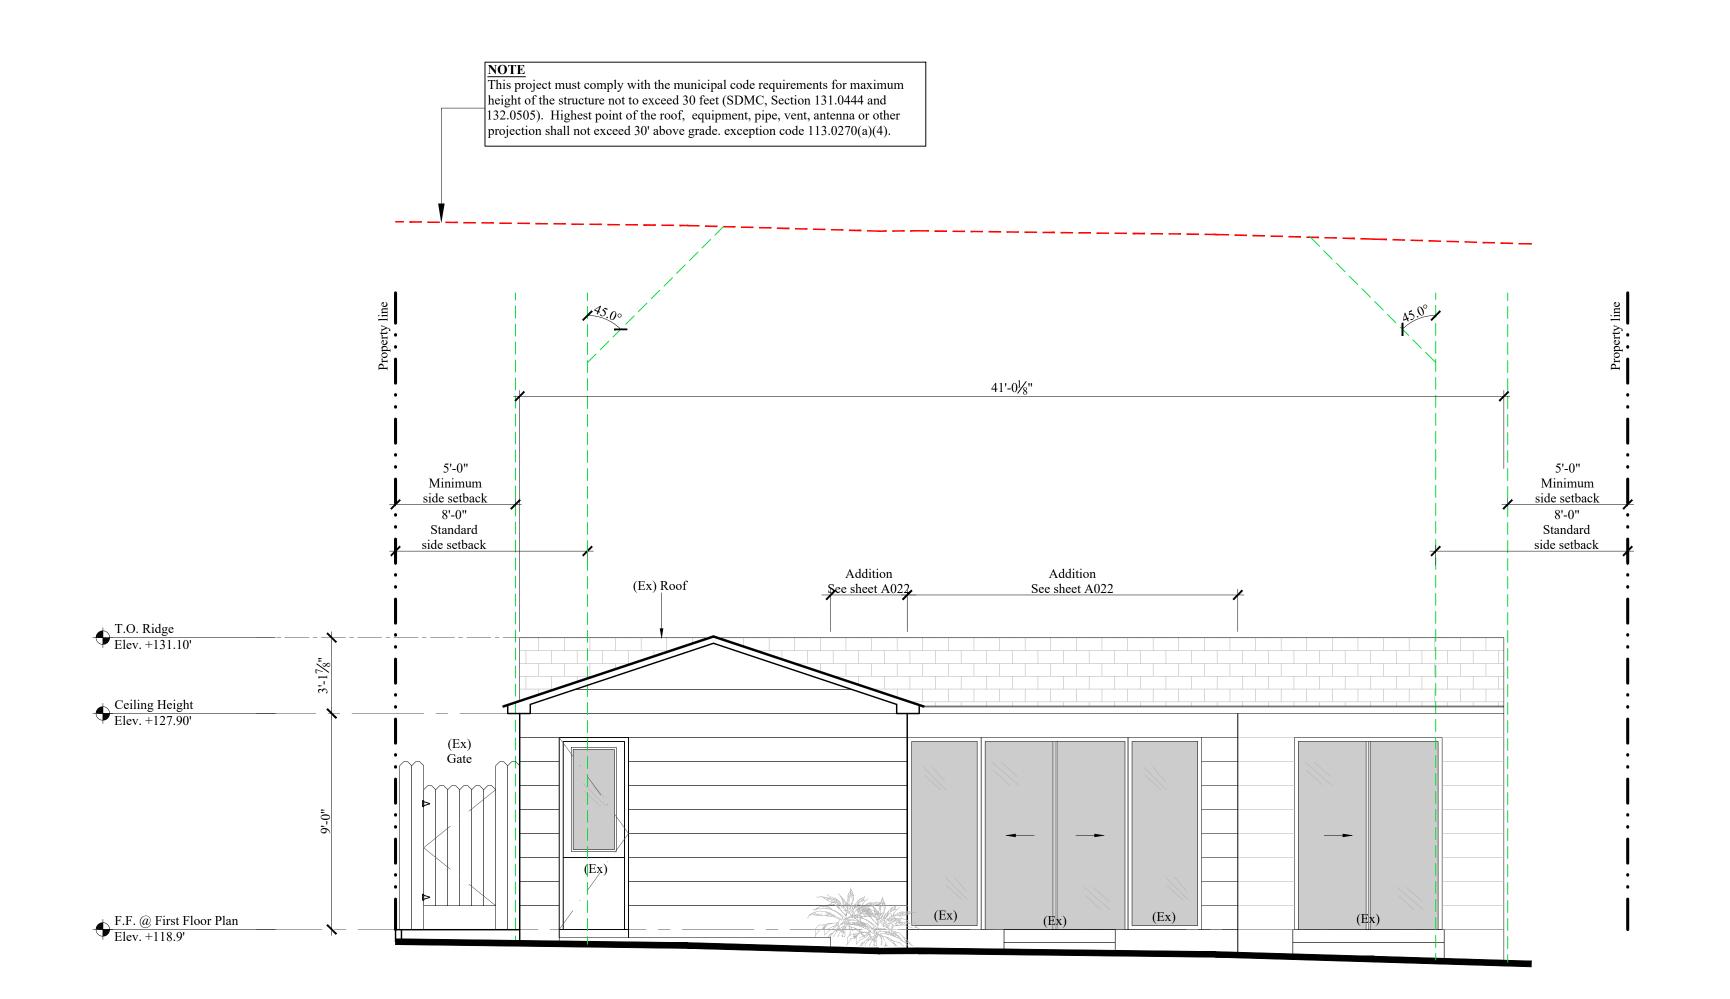
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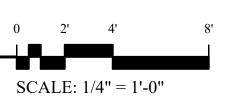
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SHEET TITLE PROPOSED EXTERIOR ELEVATION



PROPOSED EAST ELEVATION - EXISTING HOME - REAR VIEW



ATTACHMENT 11

ELEVATION NOTES

KEY PLAN

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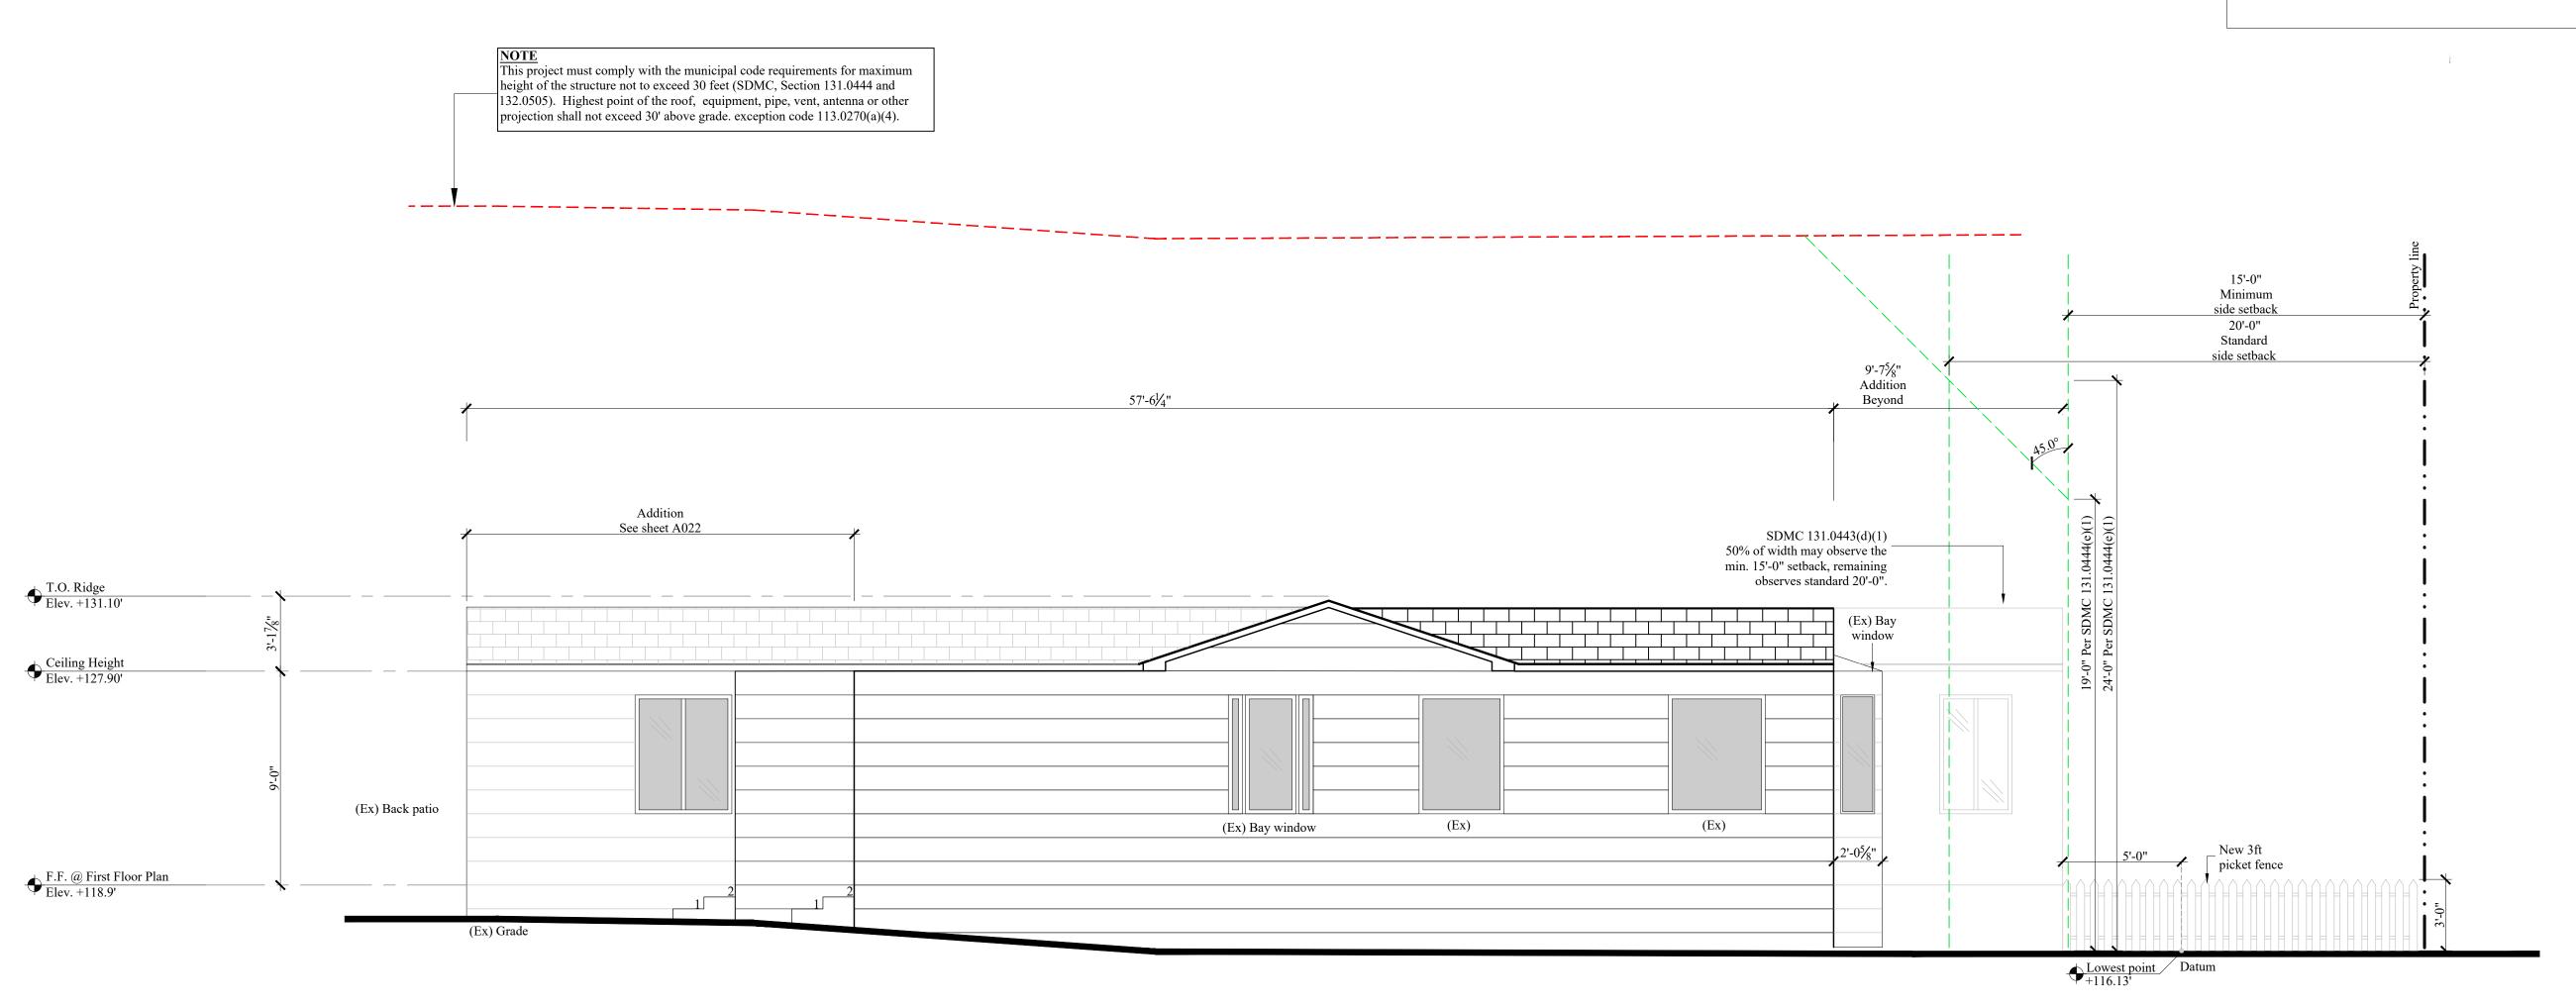
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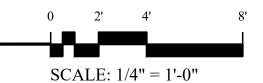
EXTERIOR ELEVATION


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\PROPOSED NORTH ELEVATION - EXISTING HOME - SIDE VIEW





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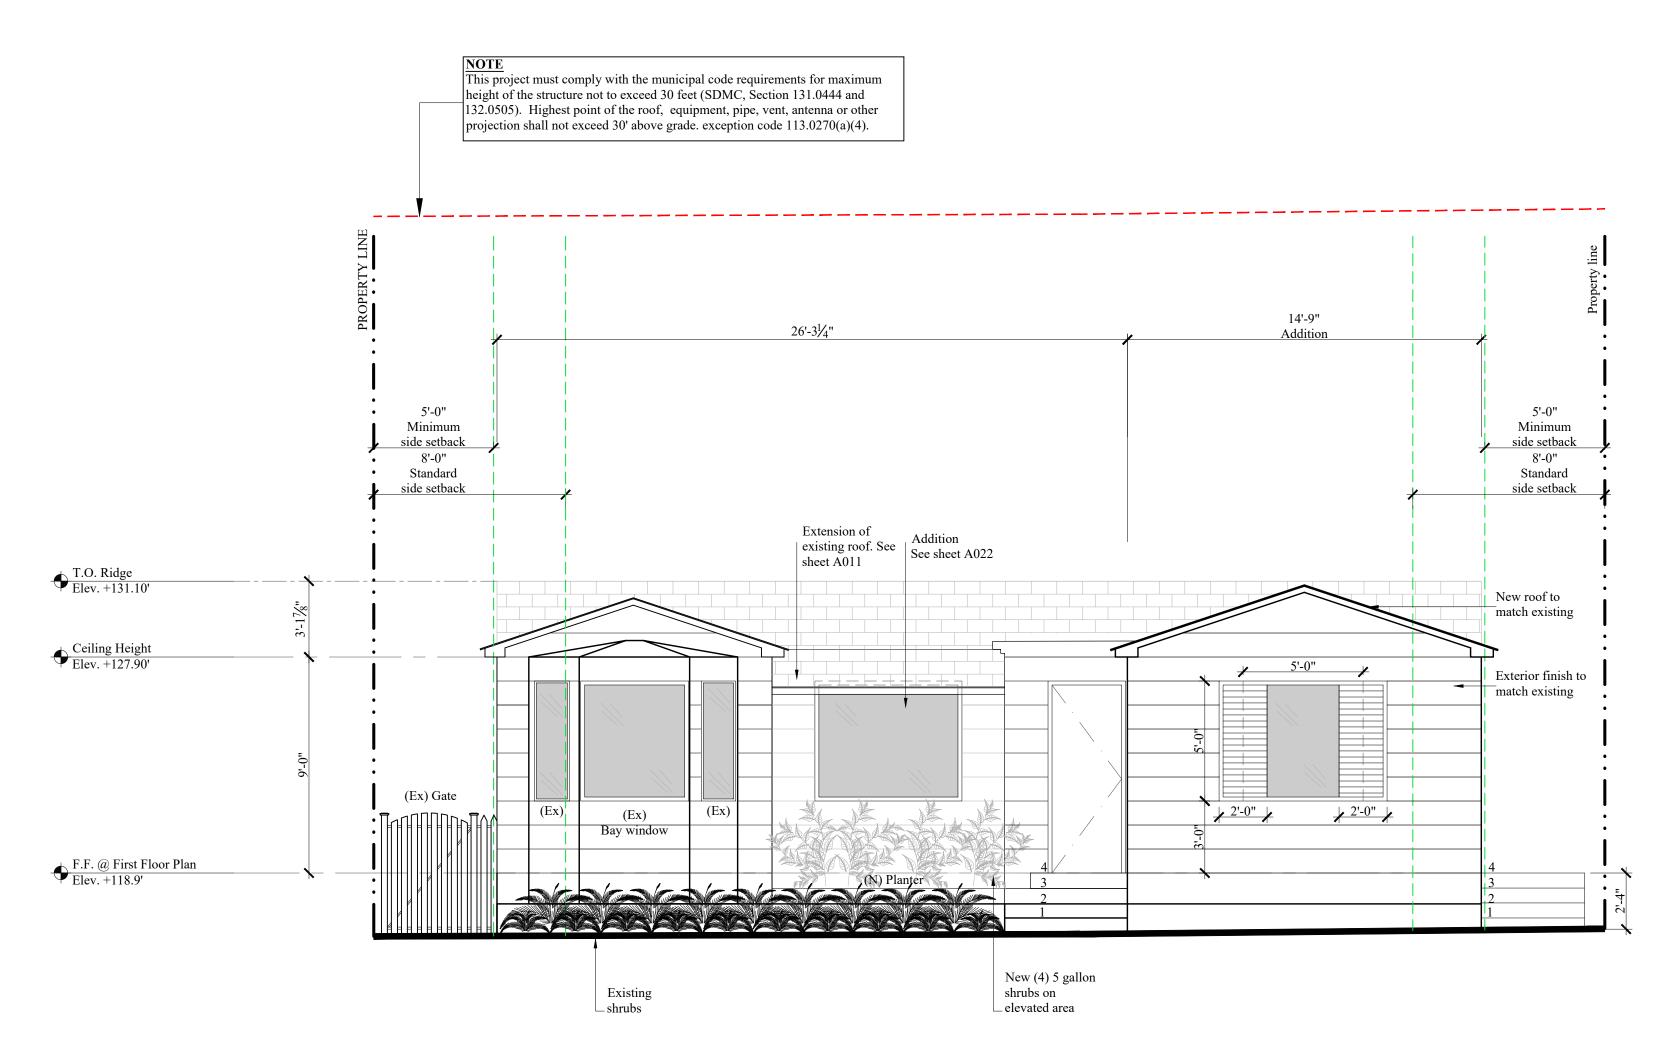
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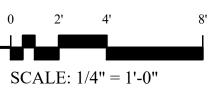
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EXTERIOR ELEVATION

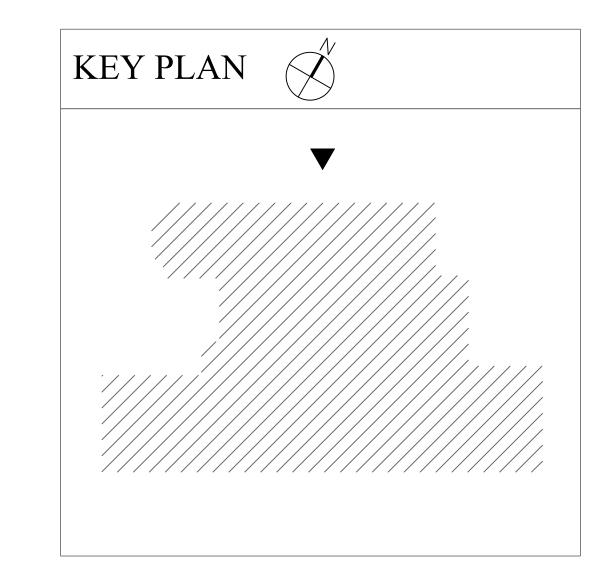

PROPOSED WEST ELEVATION - EXISTING HOME - FRONT VIEW



ATTACHMENT 11


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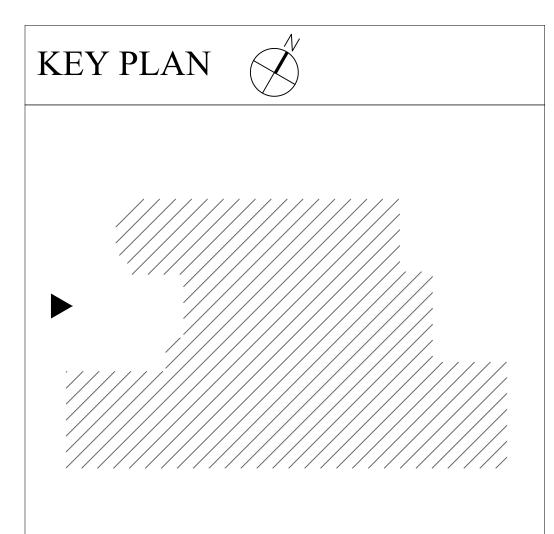
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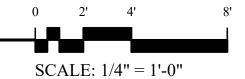
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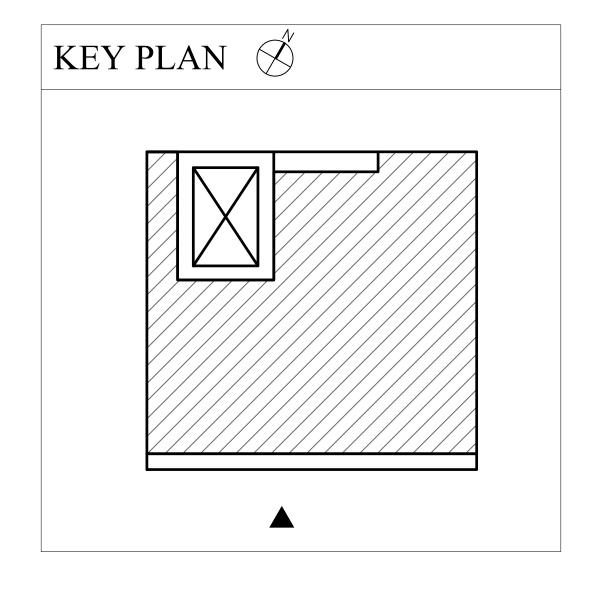
SHEET TITLE PROPOSED
EXTERIOR ELEVATION



field inspector before any subsequent inspections can be This project must comply with the municipal code requirements for maximum height of the structure not to exceed 30 feet (SDMC, Section 131.0444, 132.0505) and 113.0270(a)(2)). Highest point of the roof, equipment, pipe, vent, antenna or other projection shall not exceed 30' above grade. Exception code 113.0270(a)(4). Rear setback T.O. Parapet Elev. +148.29' ·-----Architectural projections allowed Ceiling Height Elev. +147.13' per SDMC §131.0461(a)(1) Deck SDMC 131.0443(d)(4) Where a rear yard abuts an alley, one half of the alley width, but not more • than 10 feet, may be counted toward the required rear yard. F.F. @ Third Floor Elev. +138.63' Ceiling Height Elev. +137.47' Control joists equally spaced while aligning with top and bottom of windows. - SDMC §131.0461(a)(2) Openly supported architectural projections may encroach into required setbacks. F.F. @ Second Floor ELEV. +128.97' Ceiling Height Elev. +127.81' New solid 6ft wood fence Garage entry F.F. @ First Floor Elev. +119.31' 3'-6" Pushed back ADU Entry Wood slats

\PROPOSED SOUTH ELEVATION - NEW BUILDING - SIDE VIEW



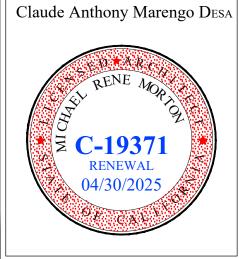

ELEVATION NOTES

work in question.

A. All dimensions shall be field verified. Any discrepancies

d. For door and windows see schedules on sheet A080 and A081.

notified immediately if any revisions to window sizes are

e. Install plaster control joints per manufacturer's instructions. If joints are not shown, see sheet sp-2 div. 09-200 3b criteria with

F. A pre-construction inspection is required due to the height of the

proposed structure being within two foot of the maximum height

allowed in the coastal height limit overlay zone (proposition d). pre-construction inspection must be scheduled and cleared by the

B. Refer to site plan for site and utility information.c. Refer to Sheet A060 and A061 for building sections.

required prior to start of construction.

the approval of the architect for locations.

affecting project layout shall be brought to the attention of the architect and the issues resolved prior to proceeding with the

All windows required for emergency exiting per C.B.C. shall be verified by the window subcontractor, and the architect shall be

ATTACHMENT 11

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7443 Eads Avenue

REVISIONS 01/26/2022 PROJECT START

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PROJECT NO. 2021-46


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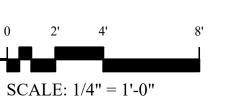
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SHEET TITLE PROPOSED EXTERIOR ELEVATION



PROPOSED NORTH ELEVATION - NEW BUILDING - SIDE VIEW



ATTACHMENT 11

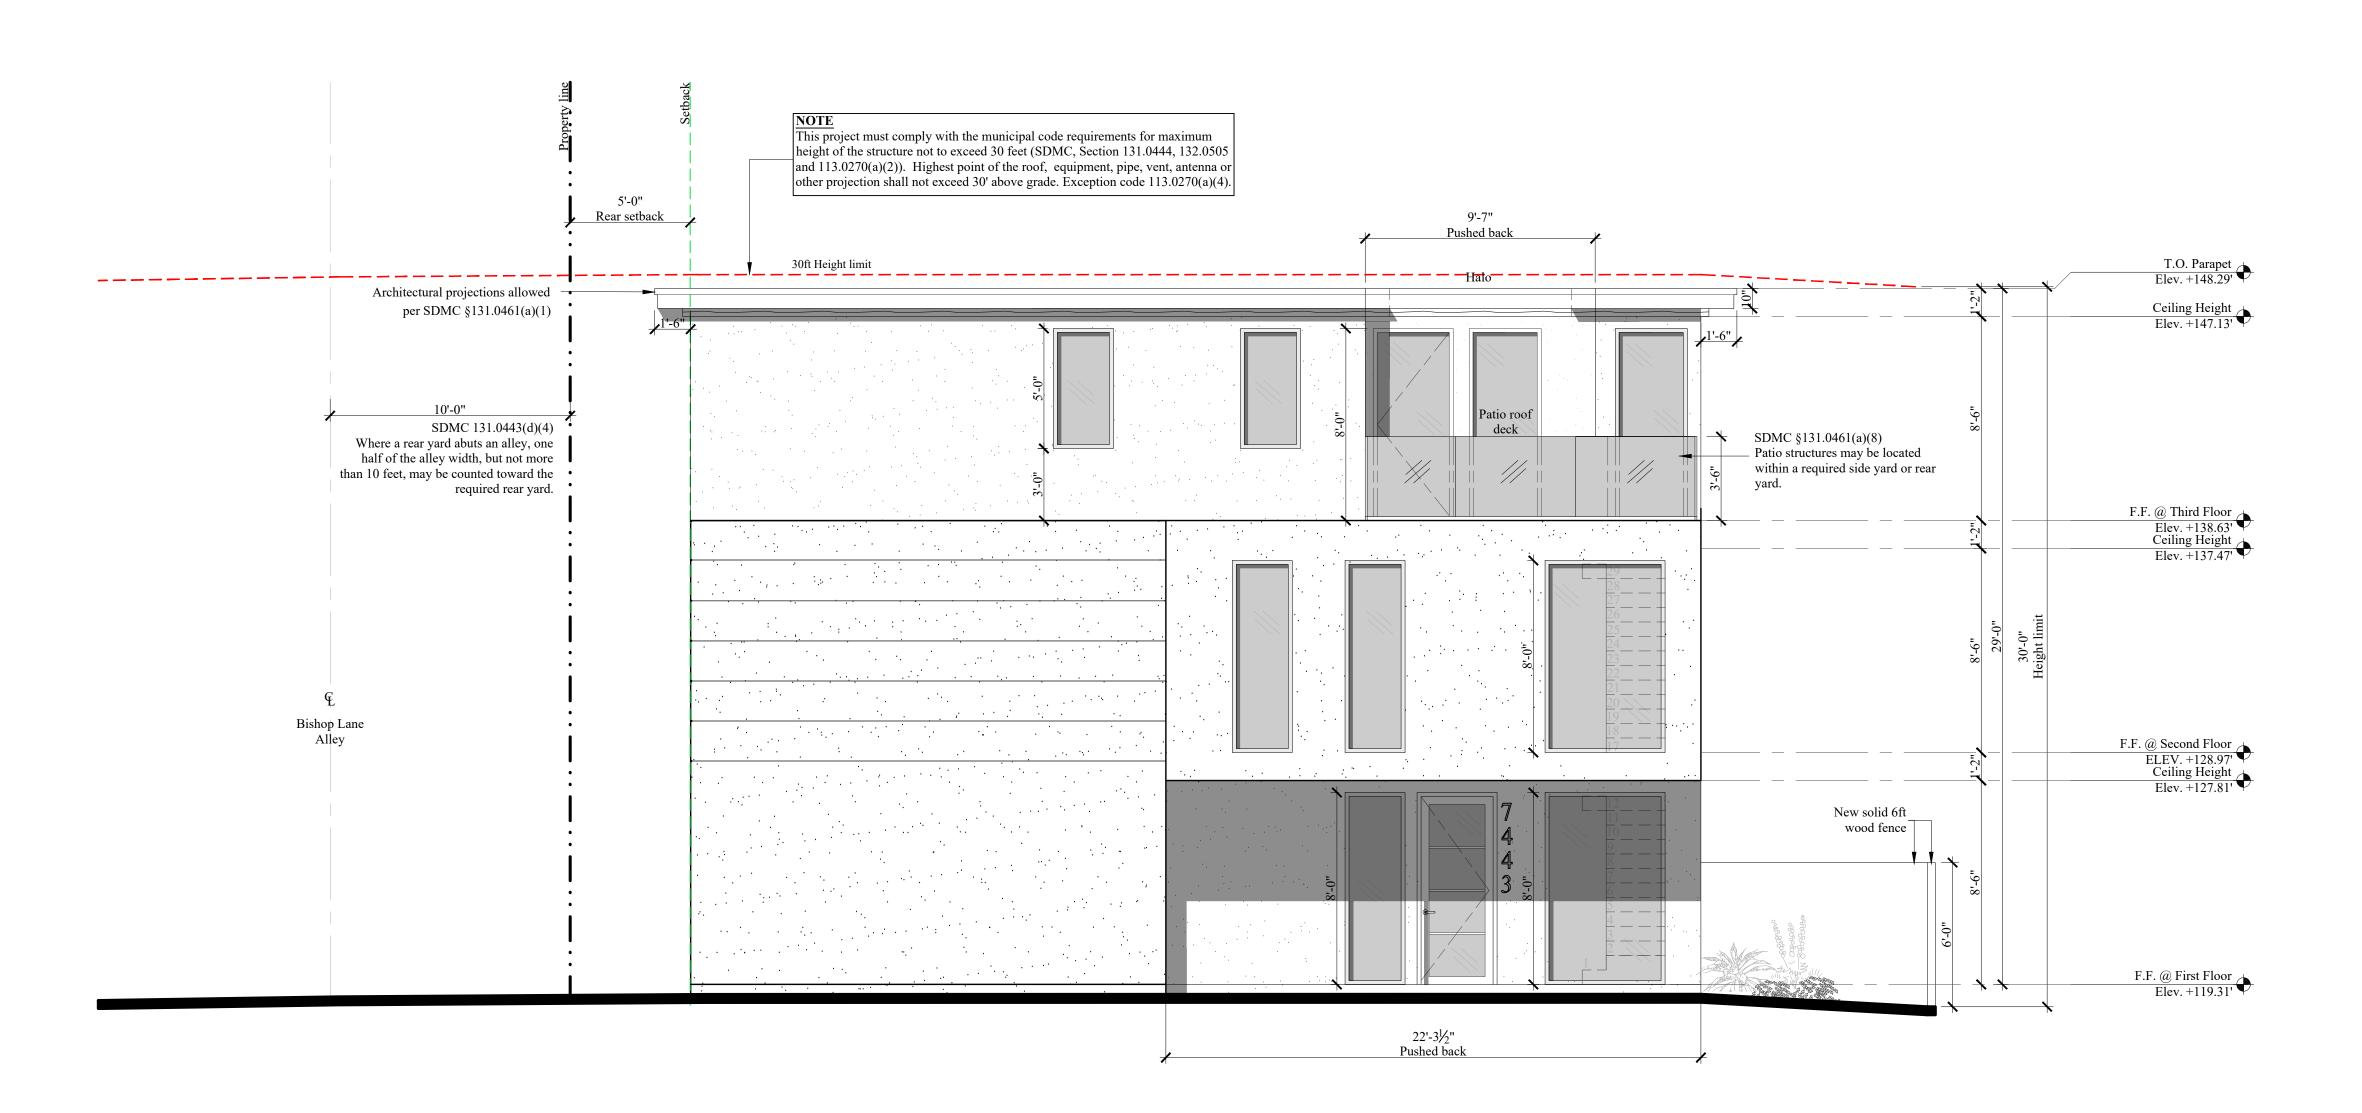

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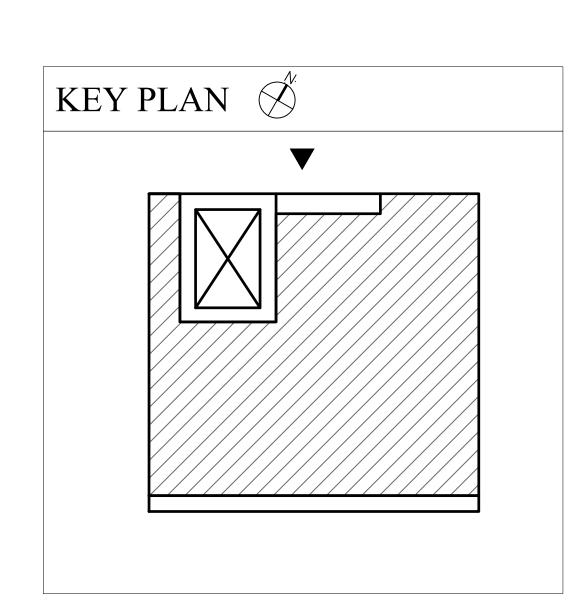
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SHEET TITLE PROPOSED

EXTERIOR ELEVATION

A055



ELEVATION NOTES

work in question.

scheduled.

A. All dimensions shall be field verified. Any discrepancies

B. Refer to site plan for site and utility information.c. Refer to Sheet A060 and A061 for building sections.

required prior to start of construction.

the approval of the architect for locations.

affecting project layout shall be brought to the attention of the architect and the issues resolved prior to proceeding with the

d. For door and windows see schedules on sheet A080 and A081.

notified immediately if any revisions to window sizes are

e. Install plaster control joints per manufacturer's instructions. If

All windows required for emergency exiting per C.B.C. shall be verified by the window subcontractor, and the architect shall be


joints are not shown, see sheet sp-2 div. 09-200 3b criteria with

allowed in the coastal height limit overlay zone (proposition d).


pre-construction inspection must be scheduled and cleared by the

F. A pre-construction inspection is required due to the height of the proposed structure being within two foot of the maximum height

field inspector before any subsequent inspections can be

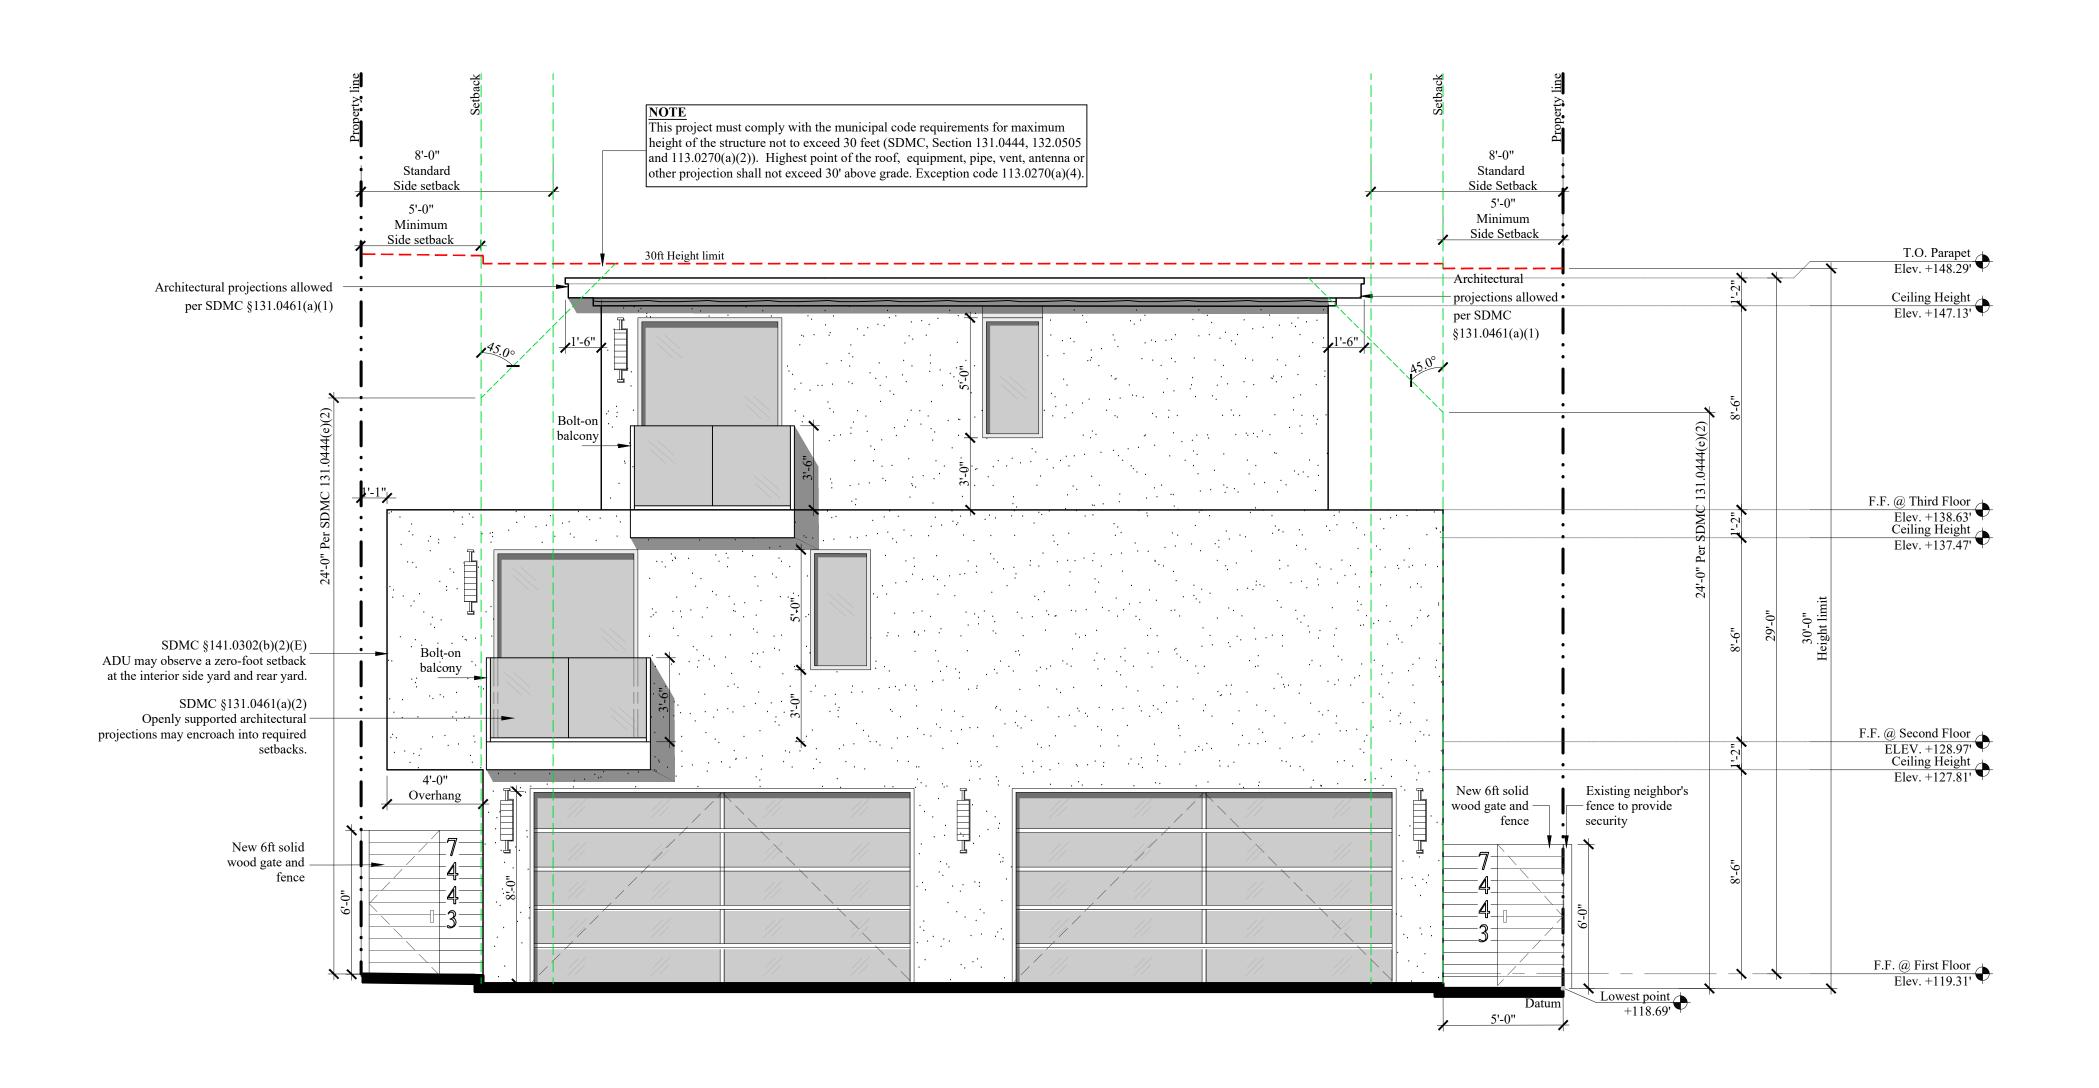

PROPOSED EAST ELEVATION - NEW BUILDING - REAR VIEW

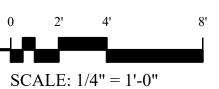

ATTACHMENT 11

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PROJECT NO. 2021-46


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SHEET TITLE PROPOSED
EXTERIOR ELEVATION

A056



ELEVATION NOTES

work in question.

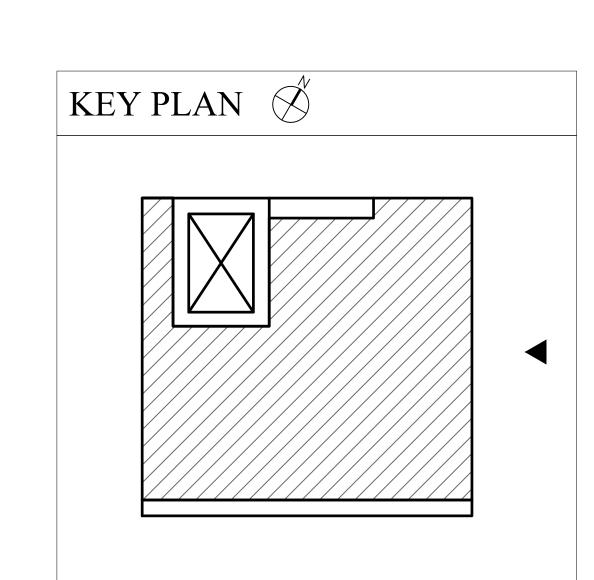A. All dimensions shall be field verified. Any discrepancies

B. Refer to site plan for site and utility information.c. Refer to Sheet A060 and A061 for building sections.

required prior to start of construction.

the approval of the architect for locations.

affecting project layout shall be brought to the attention of the architect and the issues resolved prior to proceeding with the

d. For door and windows see schedules on sheet A080 and A081.

notified immediately if any revisions to window sizes are

e. Install plaster control joints per manufacturer's instructions. If

All windows required for emergency exiting per C.B.C. shall be verified by the window subcontractor, and the architect shall be


joints are not shown, see sheet sp-2 div. 09-200 3b criteria with

proposed structure being within two foot of the maximum height


allowed in the coastal height limit overlay zone (proposition d).
pre-construction inspection must be scheduled and cleared by the

F. A pre-construction inspection is required due to the height of the

field inspector before any subsequent inspections can be

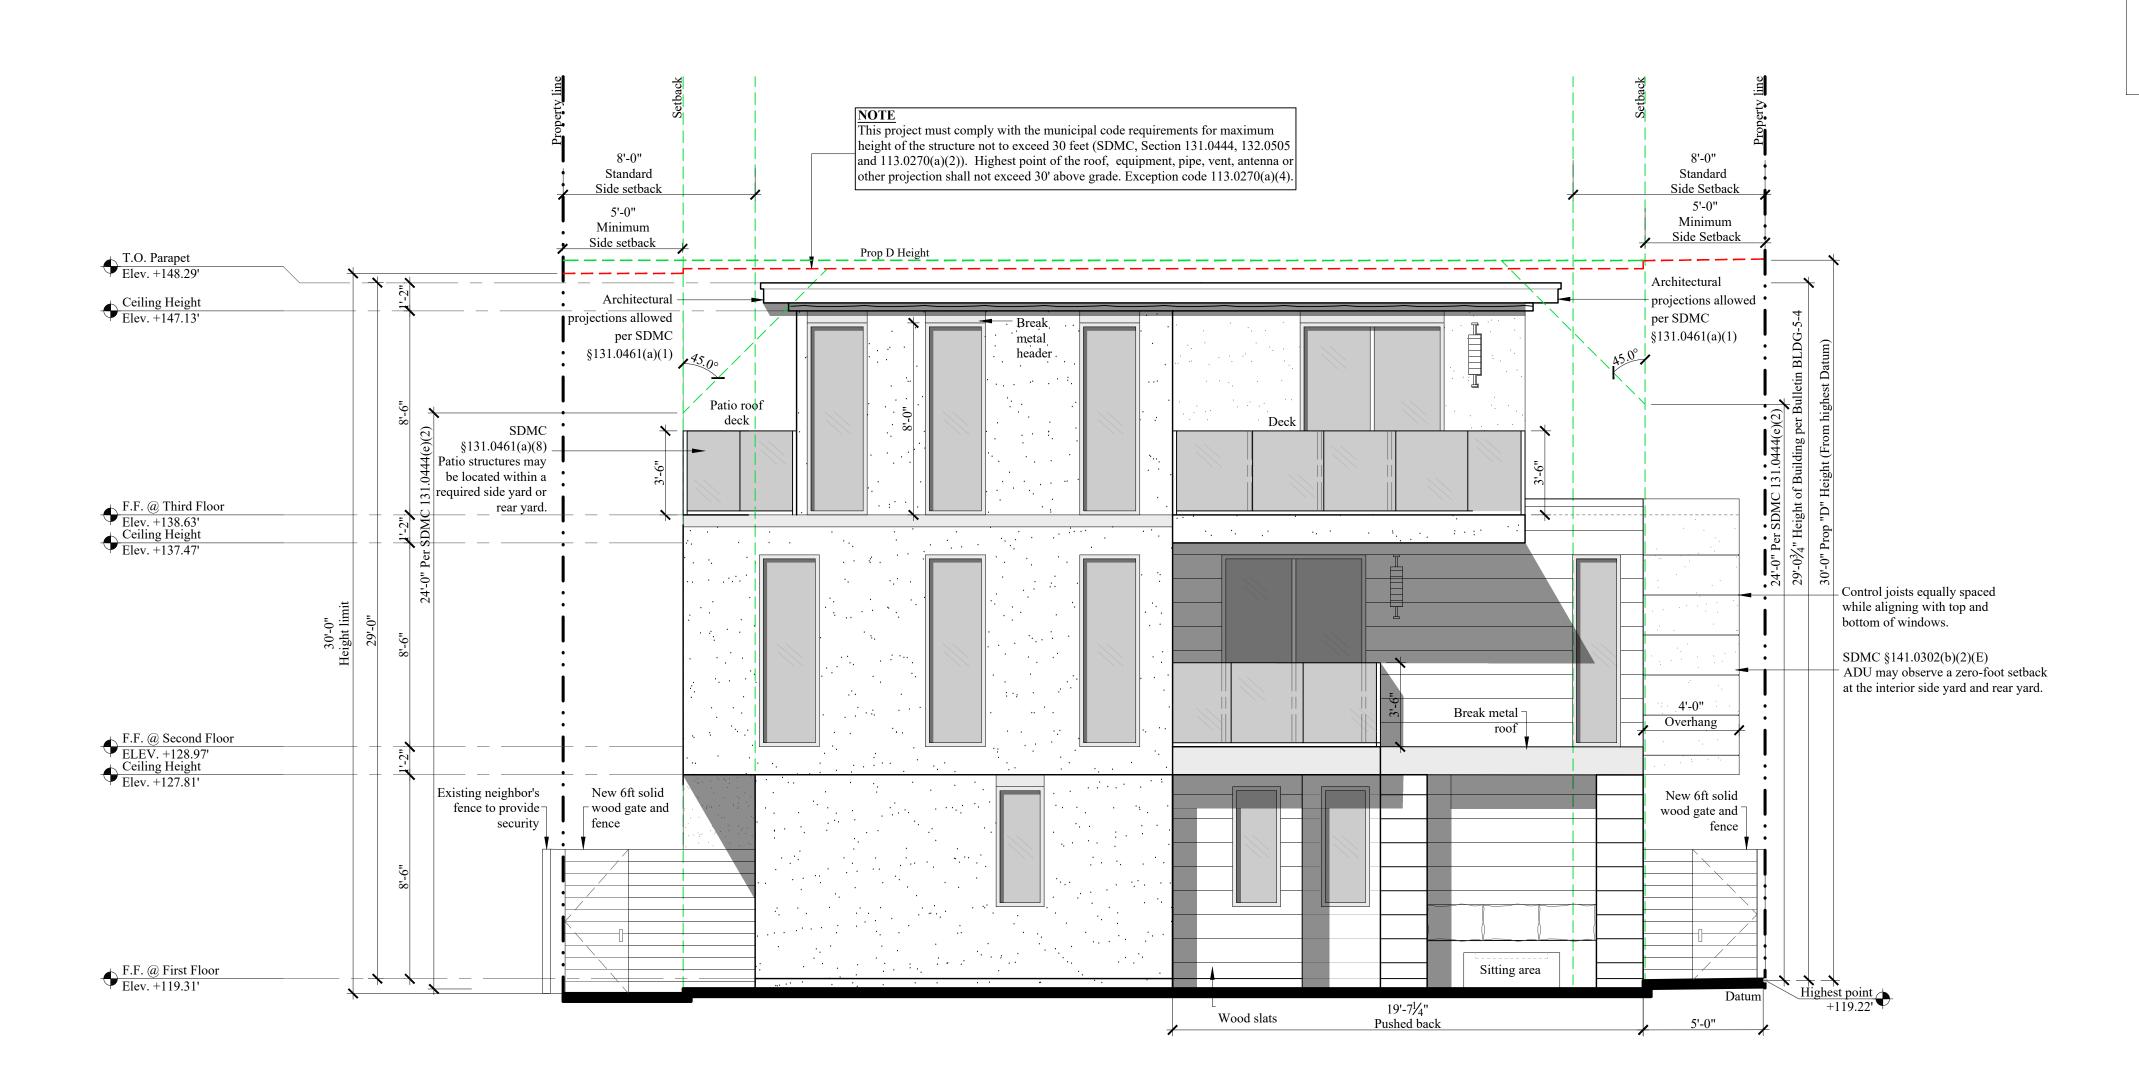

PROPOSED WEST ELEVATION - NEW BUILDING - FRONT VIEW

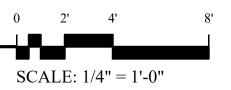

ATTACHMENT 11

ELEVATION NOTES

- A. All dimensions shall be field verified. Any discrepancies affecting project layout shall be brought to the attention of the architect and the issues resolved prior to proceeding with the work in question.
- B. Refer to site plan for site and utility information.c. Refer to Sheet A060 and A061 for building sections.
- d. For door and windows see schedules on sheet A080 and A081. All windows required for emergency exiting per C.B.C. shall be verified by the window subcontractor, and the architect shall be notified immediately if any revisions to window sizes are required prior to start of construction.
- e. Install plaster control joints per manufacturer's instructions. If joints are not shown, see sheet sp-2 div. 09-200 3b criteria with the approval of the architect for locations.
- F. A pre-construction inspection is required due to the height of the proposed structure being within two foot of the maximum height allowed in the coastal height limit overlay zone (proposition d).

 pre-construction inspection must be scheduled and cleared by the field inspector before any subsequent inspections can be



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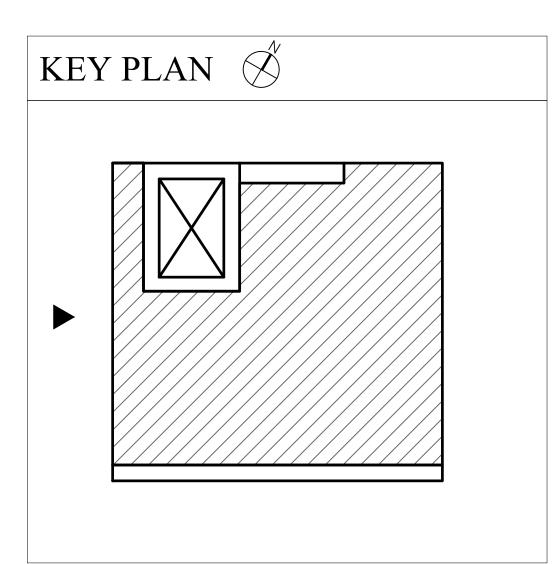
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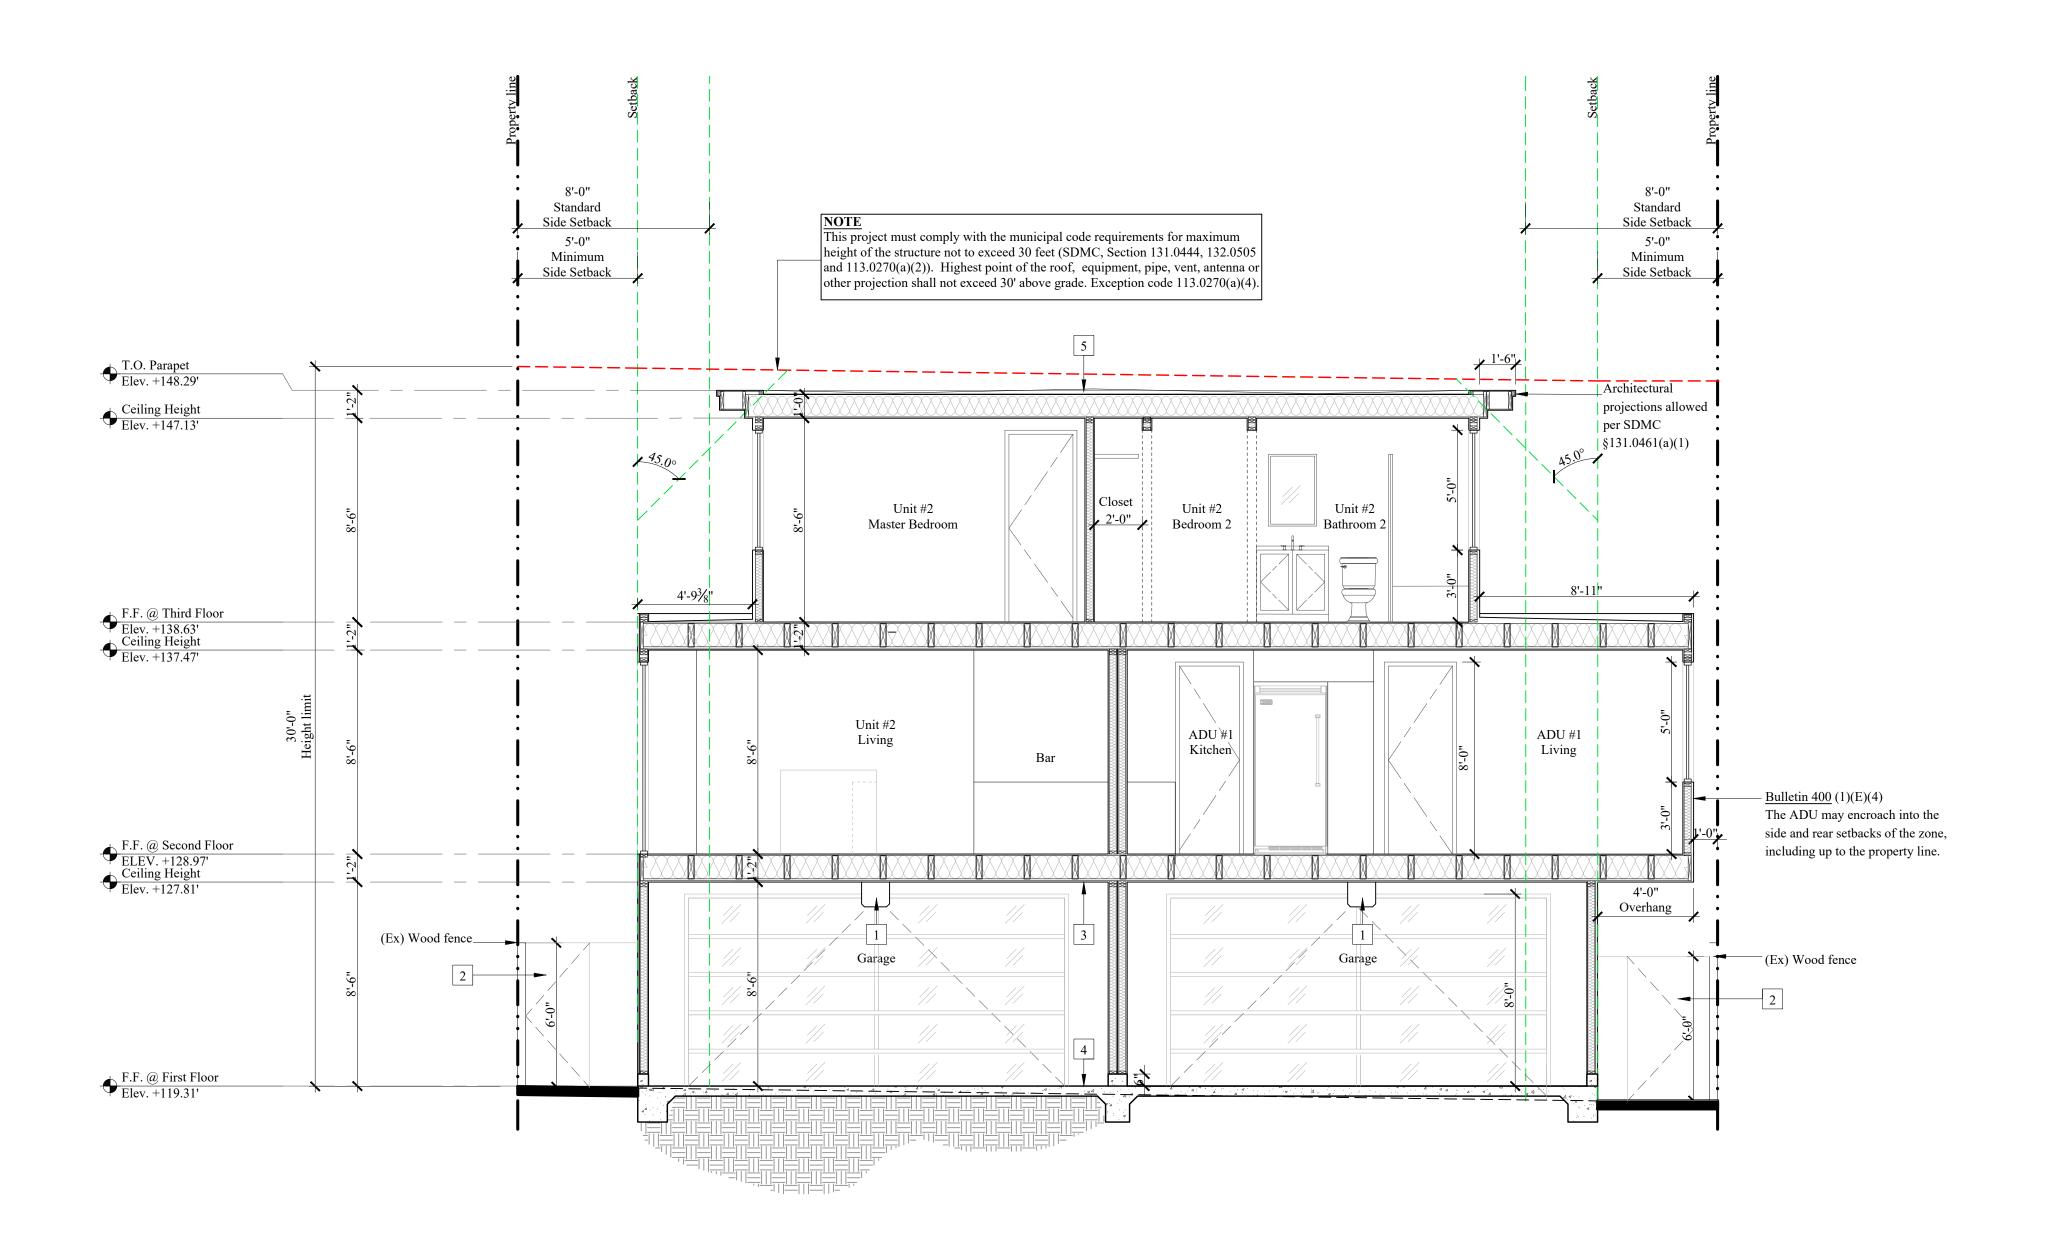
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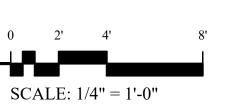
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SHEET TITLE PROPOSED EXTERIOR ELEVATION





(A) PROPOSED BUILDING SECTION



ATTACHMENT 11



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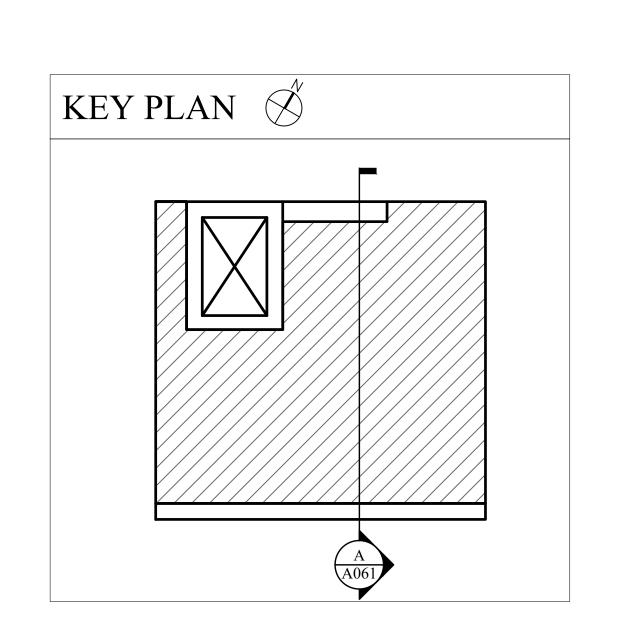
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SHEET TITLE PROPOSED
BUILDING SECTION

A061



KEY NOTES


1 Garage door opener motor

3 1hr. Fire rating 5/8" drywall


4 1/8":12" Slope towards alley

5 TPO Roofing Class "A" with gravel

New gate - Open 75%

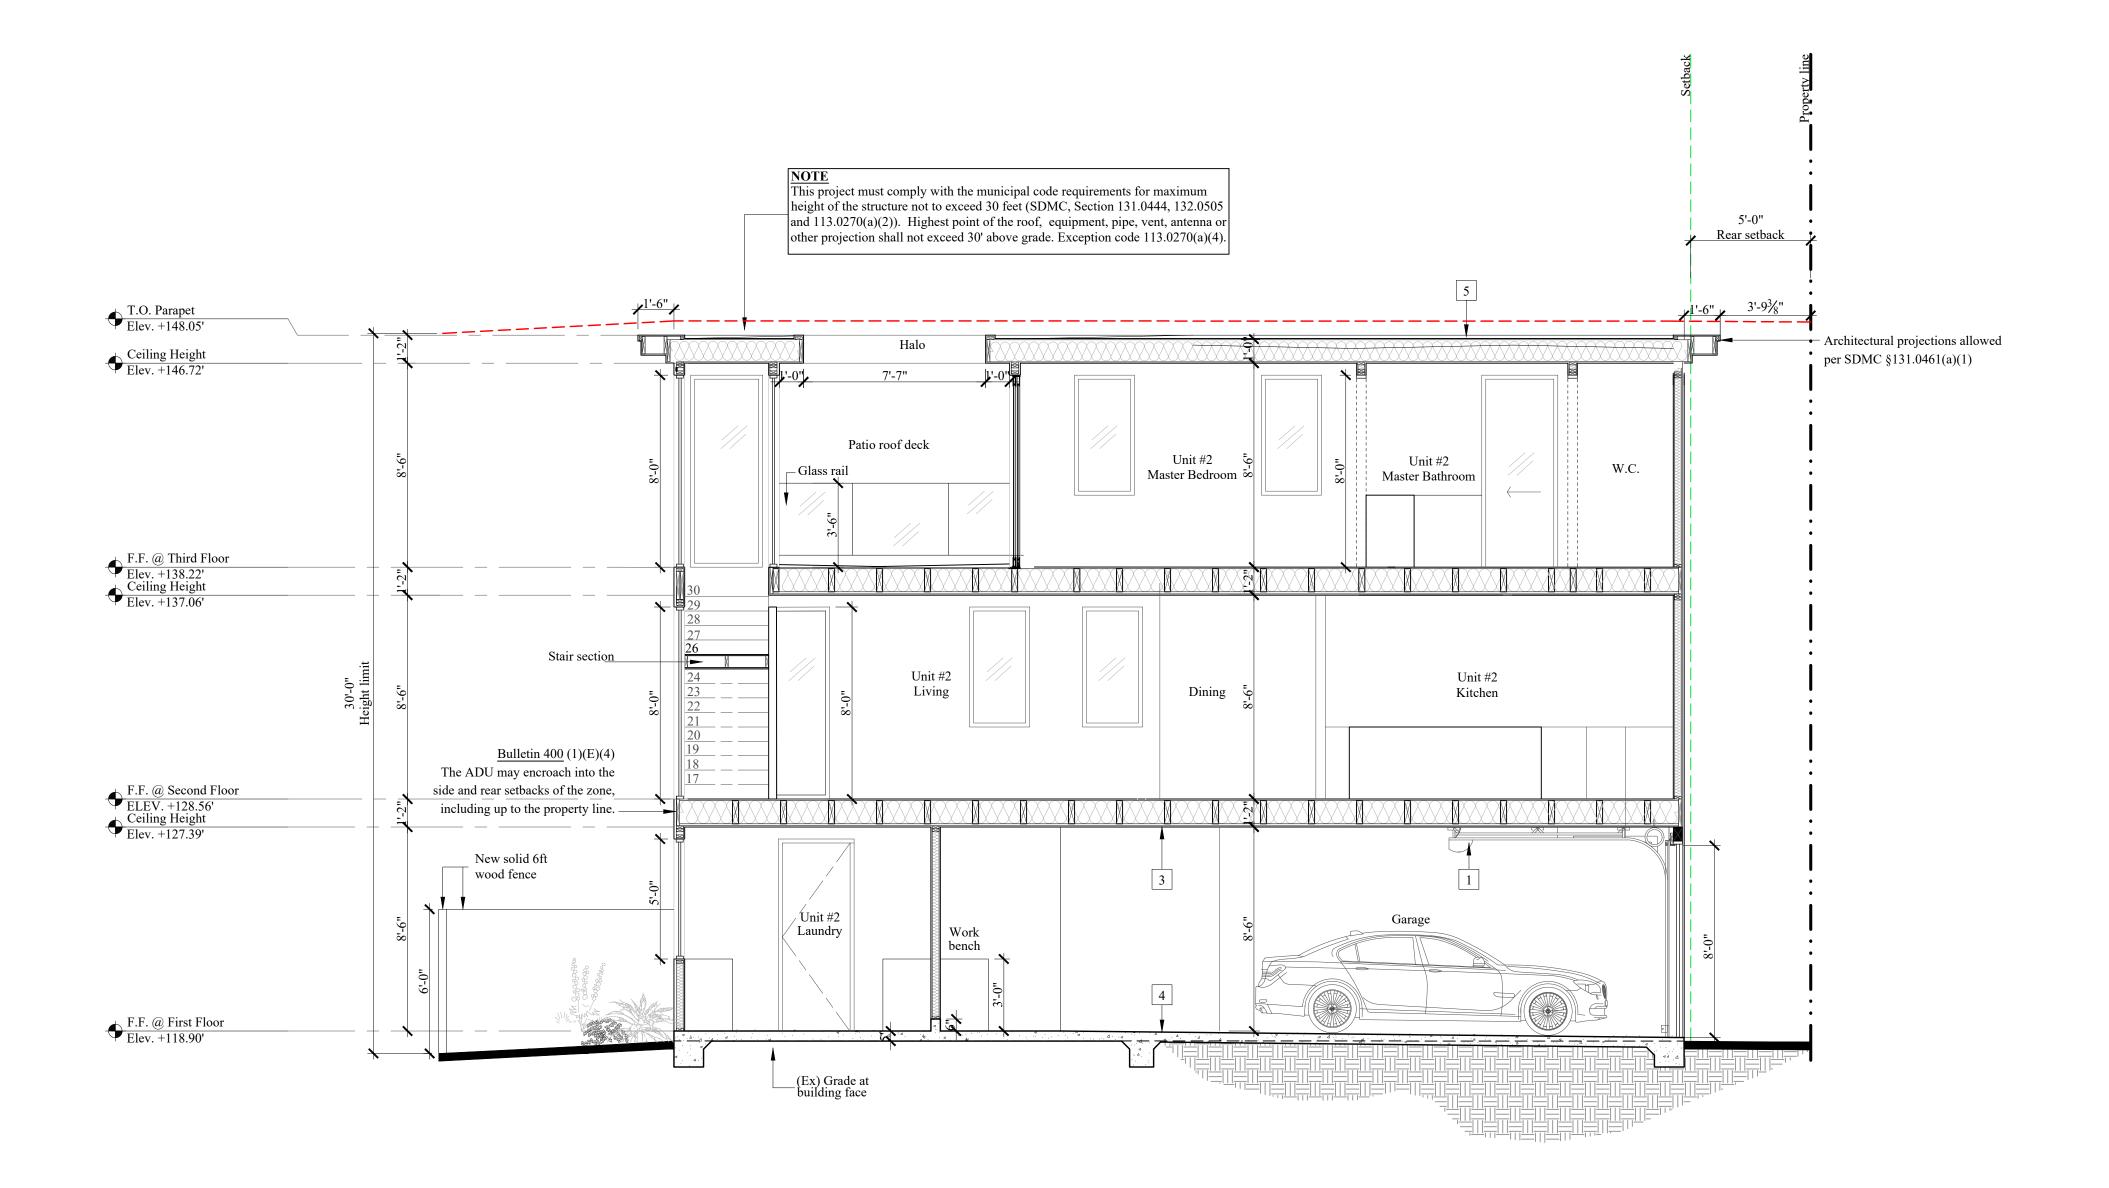

PROPOSED BUILDING SECTION

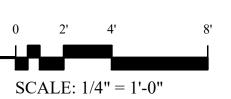

ATTACHMENT 11

KEY NOTES 1 Garage door opener motor New gate - Open 75% 3 1hr. Fire rating 5/8" drywall 4 1/8":12" Slope towards alley

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SHEET TITLE PROPOSED **BUILDING SECTION**

