



THE CITY OF SAN DIEGO

Report to the Hearing Officer

DATE ISSUED: March 13, 2024 REPORT NO. HO-24-009

HEARING DATE: March 20, 2024

SUBJECT: AT&T MOBILITY COMMUNITY CONGREGATIONAL CHURCH, Process Three Decision

PROJECT NUMBER: [1081156](#)

OWNER/APPLICANT: COMMUNITY CONGREGATIONAL CHURCH, OWNER & AT&T MOBILITY, PERMITTEE

SUMMARY

Issue: Should the Hearing officer approve the continued use and modification of an existing Wireless Communication Facility (WCF) located at 2088 Beryl Street within the Pacific Beach Community Area?

Proposed Actions:

1. APPROVE Conditional Use Permit (CUP) No. 3200925; and
2. APPROVE Neighborhood Development Permit (NDP) No. 3267836

Fiscal Considerations: None with this action. All costs associated with the processing of this project are paid from a deposit account maintained by the applicant.

Code Enforcement Impact: None with this action.

Housing Impact Statement: None with this action.

Community Planning Group Recommendation: On November 8, 2023, the Pacific Beach Community Planning Group voted 7-0-0 to approve the project with no conditions. (Attachment 9)

BACKGROUND

The project is a request for the continued use of an existing (WCF) with modification. The site is located at 2088 Beryl Street in the RM-1-1 Zone of the Pacific Beach Community. The site is

developed with a building for the use of Community Congregational Church. The initial project was approved by the Planning Commission in October of 2011 and the permit has expired. A ten-year expiration was added to the permit for upgrade in technology, design and any changes to development regulations. AT&T modification includes removal of a 30-foot-tall mono-cypress faux tree supporting six antennas and six Remote Radio Units (RRUs), removal of three antennas inside a canister on a 30-foot-tall light pole; and replace it with a 30-foot-tall mono-eucalyptus faux tree supporting 12 antennas and nine RRUs. The equipment to remain inside an existing 463.24 square-feet enclosure on the ground. Figure 1 shows existing and proposed faux tree.



Figure 1- Existing and proposed site

DISCUSSION

Project Description:

AT&T is requesting a new permit to continue the use of an existing facility with modification. The project is located on the premises of Community Congregational Church, a non-residential use in the residential zone. The sites to the south, north and east are residential Zone, with Kate session elementary school to the east of the project site. (Attachment 1-3) The proposed replacement WCF will be located on a faux mono-eucalyptus tree and the equipment will remain inside an enclosure located in the parking lot. The site is an established WCF that has served the community for over a decade.

WCFs are allowed in the residential zone with approval of a CUP, pursuant to SDMC Section [141.0420 \(c\)\(1\)\(A\)\(i\)](#), which is a process three decision. An NDP is required pursuant to SDMC Section [126.0402\(m\)](#) for WCF equipment that exceeds the 250-square feet allowed by the development regulations. The existing equipment enclosure for this site is 463.24 square-feet. Processing of this NDP satisfies this requirement.

Community Plan Analysis:

The Pacific Beach Community Plan defers all WCFs to the WCF Guidelines, regulations, and the General Plan. The City of San Diego General Plan requires all wireless facilities to minimize visual impacts under Urban Design Element ([UD-A.15.a](#)). It also includes the following provisions: A) Conceal wireless facilities in existing structures, when possible, otherwise use camouflage and screening techniques to hide or blend them into the surrounding area. B) Design facilities to be aesthetically pleasing and respectful of the neighborhood context. C) Conceal mechanical equipment and devices associated with wireless facilities in underground vaults or unobtrusive structures.

As part of this modification AT&T places all antennas on a single faux mono-eucalyptus tree, replacing the previous mono-cypress and removing three antennas from a nearby light pole, in order to better integrate all antennas in one location. The mono-eucalyptus tree has more foliage and provides a more natural setting to screen the antennas and blend it with the background, making it visually appealing while concealing the antennas. The equipment is located on the interior portion of the parking lot inside an enclosure screened from the view. (Attachment 7) The modification of this facility will provide continued/increased cellular service to the surrounding residential community including Little Free Library at Session Elementary School and major Freeway-5 east of the site as indicated in the Coverage Map. (Attachment12).

The Pacific Beach Community Planning Group voted 7-0-0 on November 8, 2023, to approve the project with no conditions. (Attachment 9)

Council Policy [600-43](#) guidelines establish hierarchy from the most preferred location (Preference 1) to the least preferred location (Preference 4) for WCFs. The project is proposed within a Preference 3 location according to Council Policy. The applicant is required to submit a site justification explaining why a Preference 3 site was selected over any lower Preference level sites. The applicant has indicated that this is an established WCF site, previously approved by the Hearing officer over a decade ago, and the continued use of it will ensure continued service to the surrounding community. (Attachment 12)

Environmental Impact:

This project was determined to be categorically exempt from the California Environmental Quality Act (CEQA) pursuant to Section 15301 (Existing Facilities). This project is not pending an appeal of the environmental determination. The environmental exemption determination for this project was made on January 4, 2024, and the opportunity to appeal that determination ended January 19, 2024. (Attachment 6)

The Telecommunication Act of 1996 preempts local governments from regulating the "placement, construction and modification of wireless communication facilities on the basis of the environmental effects of Radio Frequency (RF) emissions to the extent that such facilities comply with the Federal Communication Commission's (FCC) standards for such emissions." The proposed project would be consistent with the FCC's regulations for wireless facilities. AT&T Mobility has submitted an RF

Report- prepared by EBI Consulting, dated October 11, 2022, demonstrating compliance with the required FCC regulations.


Conclusion:

The project has been determined by staff to be consistent with the purpose and intent of the applicable development regulations of the San Diego Municipal Code Sections [131.0401](#), [141.0420](#), [126.0303](#), and [126.0402 \(m\)](#), the development regulations and the Wireless Communication Facilities Regulations. Therefore, staff recommends Hearing Officer approve CUP No. 3200925 and NDP No. 3267836.

ALTERNATIVES

1. Approve CUP No. 3200925 and NDP No. 3267836, with modifications.
2. Deny CUP No. 3200925 and NDP No. 3267836, if the findings required to approve the project cannot be affirmed.

Respectfully submitted,

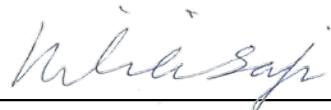


Nilia Safi
Development Project Manager
Development Services Department

Attachments:


1. Aerial Photographs
2. Community Plan Land Use Map
3. Project Location Map
4. Draft Permit Resolution with Findings
5. Draft Permit with Findings
6. Environmental Exemption
7. Photo Simulations
8. Photo Survey
9. Community Plan Recommendation
10. Project Plans
11. Ownership Disclosure Form
12. Site Justification/Coverage




Aerial Photograph

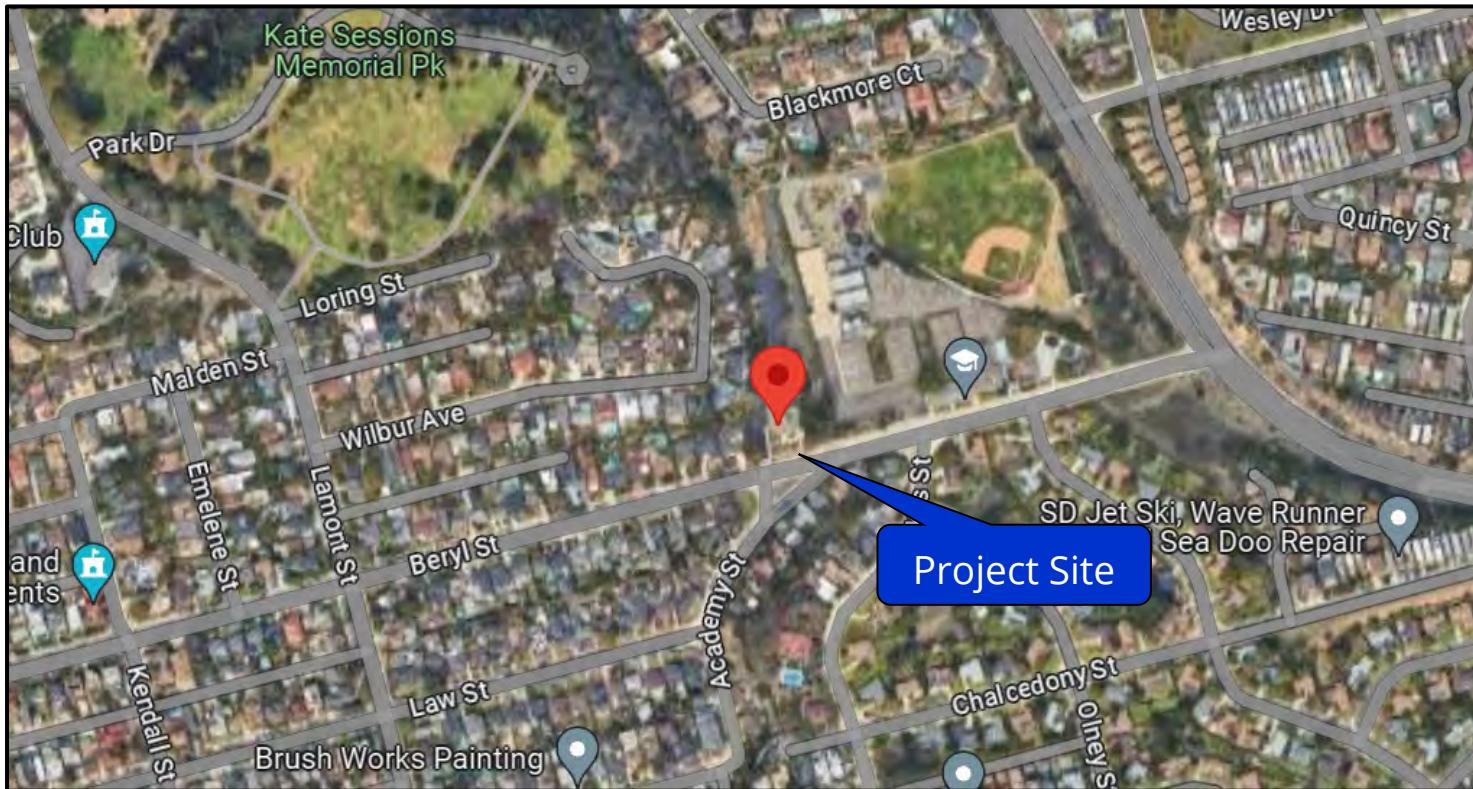


AT&T Community Congregational Church CUP Project No. 1081156
2088 Beryl Street

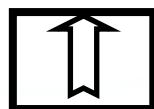

Pacific Beach Community Land Use Map

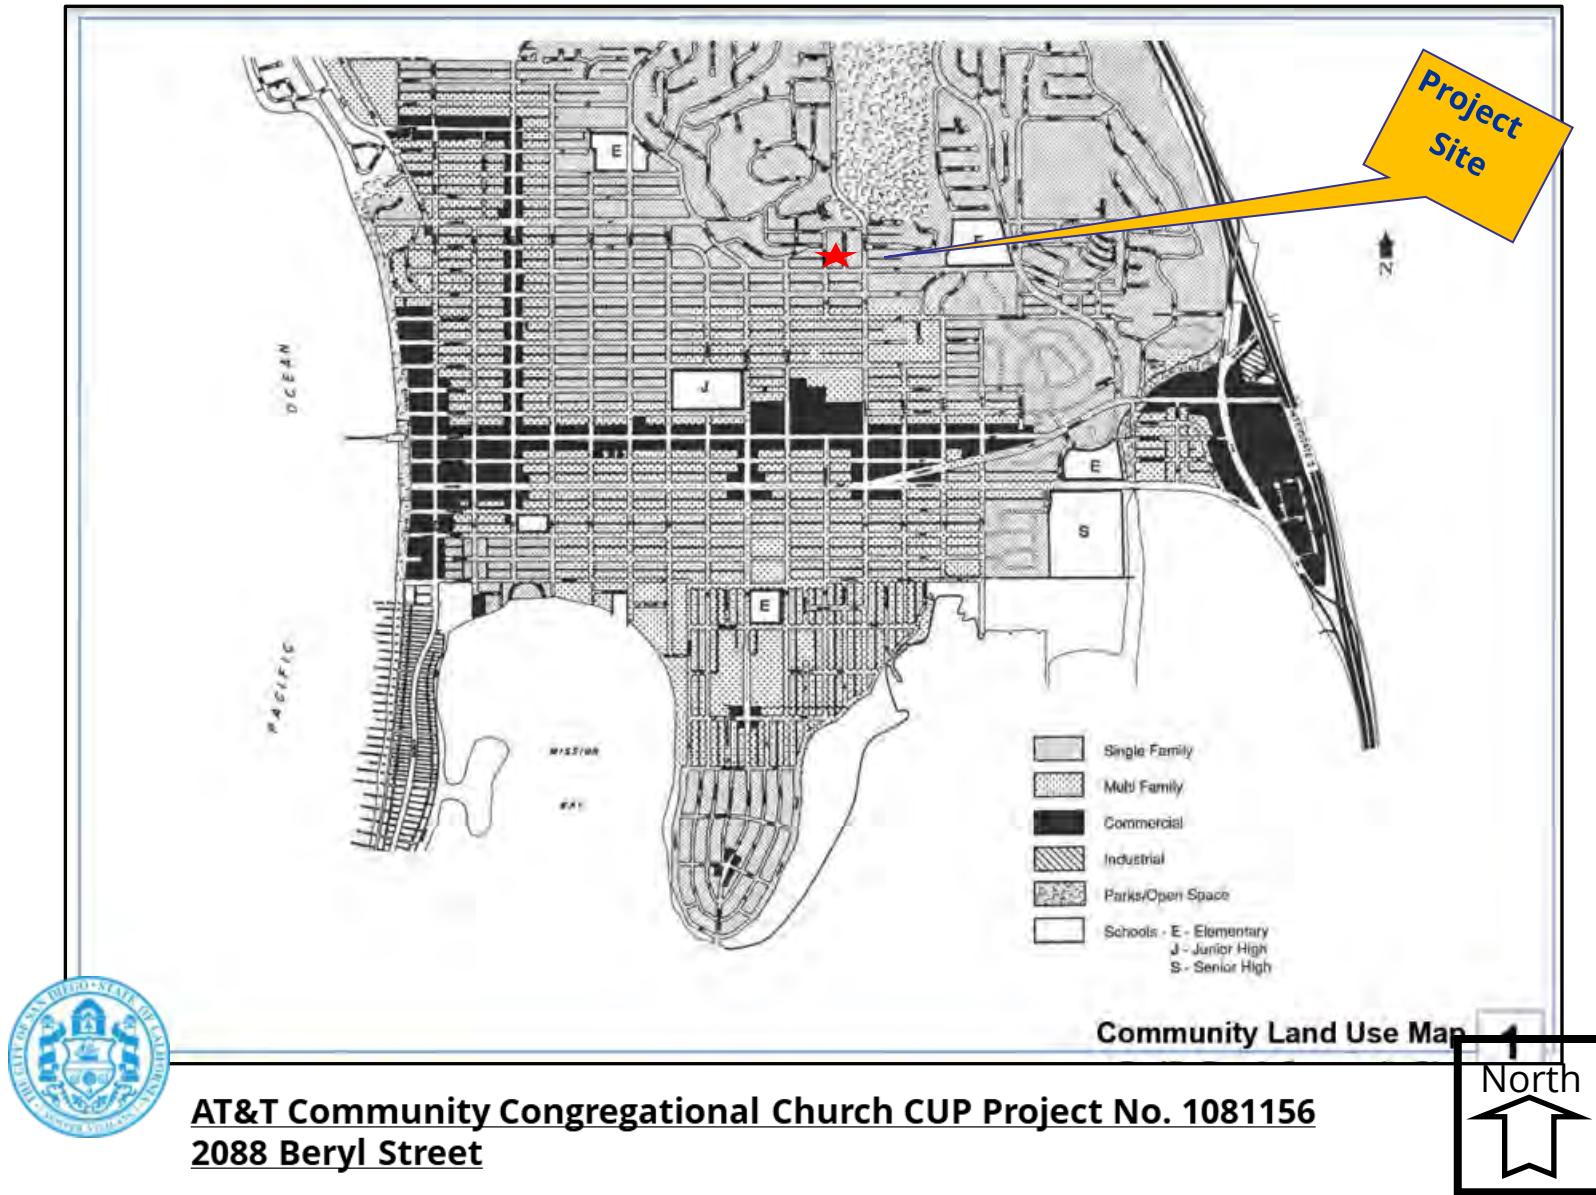

Project Location Map

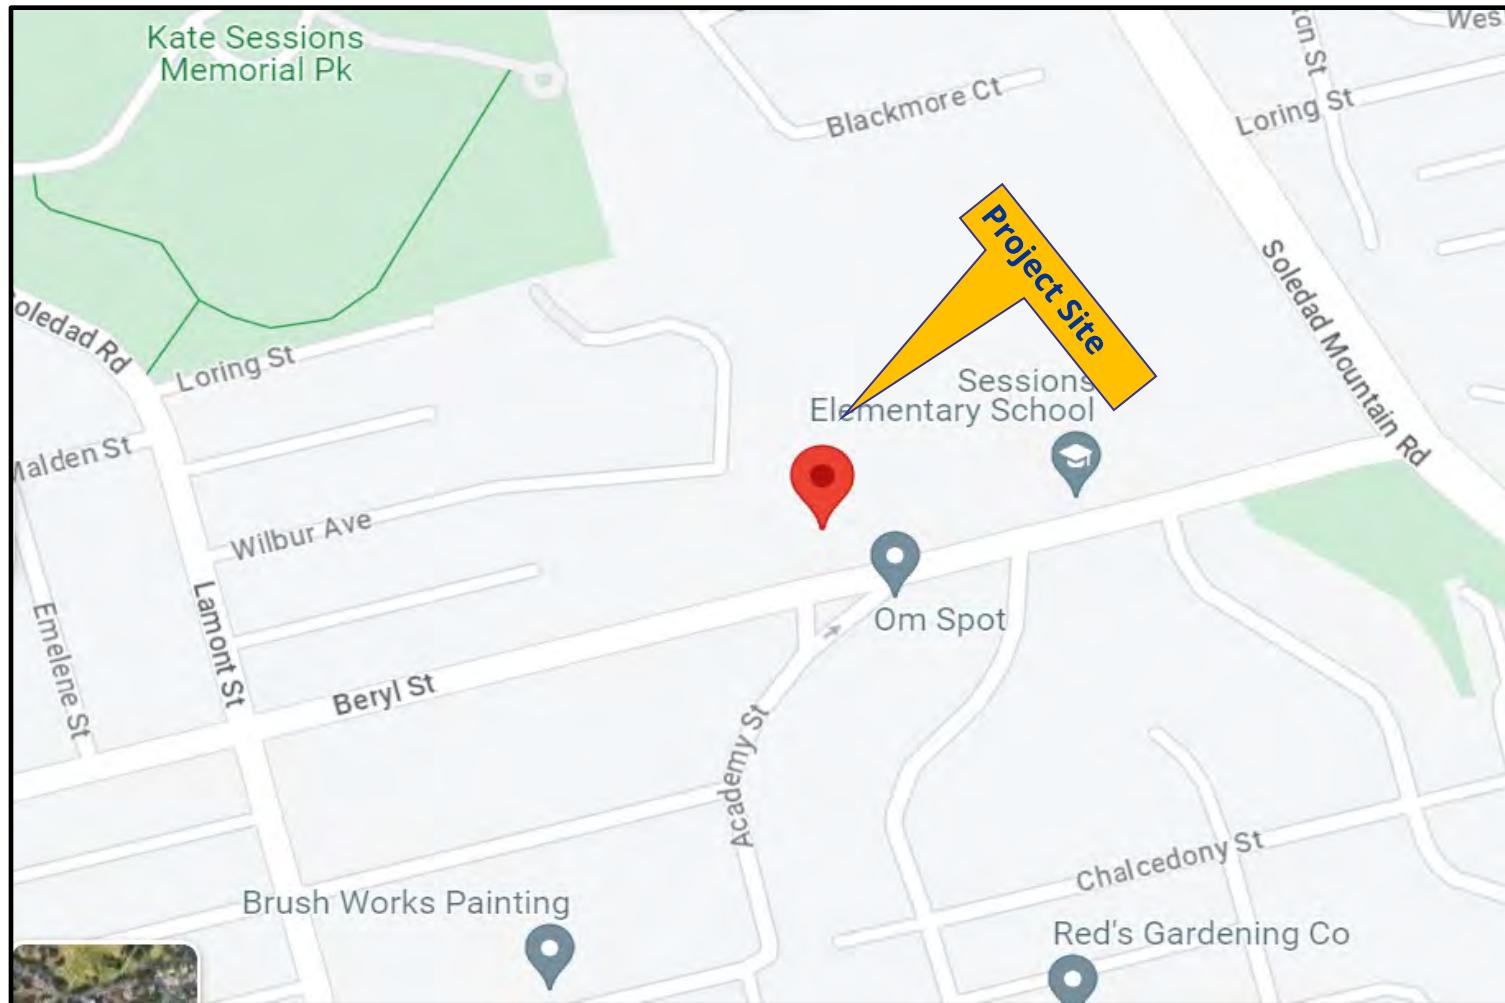

**AT&T Community Congregational Church CUP Project No. 1081156
2088 Beryl Street**



ATTACHMENT 4

HEARING OFFICER
RESOLUTION NO. xxxx
CONDITIONAL USE PERMIT PMT-3200925
NEIGHBORHOOD DEVELOPMENT PERMIT PMT-3267836
AT&T MOBILITY COMMUNITY CONGREGATIONAL CHURCH PROJECT NO. 1081156

WHEREAS, COMMUNITY CONGREGATIONAL CHURCH, Owner and AT&T, Permittee, filed an application with the City of San Diego for a new permit for a Wireless Communication Facility (WCF) (as described in and by reference to the approved Exhibits "A" and corresponding conditions of approval for the associated Conditional Use Permit (CUP) No. 3200925 and Neighborhood Development Permit (NDP) No. 3267836);

WHEREAS, the project site is located at 2088 Beryl Street in the RM-1-1 Zone of the Pacific Beach Community Plan;

WHEREAS, the project site is legally described as Lot 1 of Church in the Vale, in the City of La Jolla, County of San Diego, State of California, per Map No. 5700, filed in the Office of the County Recorder of San Diego County, February 25, 1966;

WHEREAS, on January 2, 2024, the City of San Diego, as Lead Agency, through the Development Services Department, made and issued an Environmental Determination that the project is exempt from the California Environmental Quality Act (CEQA) (Public Resources Code Section 21000 et seq.) under CEQA Guideline Section 15301 (Existing Facilities) and there was no appeal of the Environmental Determination filed within the time period provided by San Diego Municipal Code Section 112.0520;

WHEREAS, on March 20, 2024, the Hearing Officer of the City of San Diego considered CUP No. 3200925 and NDP No. 3267836 pursuant to the Land Development Code of the City of San Diego;

BE IT RESOLVED by the Hearing Officer of the City of San Diego, that it adopts the following findings with respect to CUP No. 3200925 and NDP No.3267836:

A. **[CONDITIONAL USE PERMIT [126.0305]]**

1. **Findings for all CUPs:**

a. **The proposed development will not adversely affect the applicable land use plan.**

The project is the continued use and modification to an existing (WCF) that includes the removal of a 30-foot-tall mono-cypress faux tree supporting six antennas and six Remote Radio Units (RRUs), the removal of three antennas inside a canister on a 30-foot-tall light pole and replace it with a 30-feet tall mono-eucalyptus faux tree supporting 12 antennas and nine RRUs. The equipment is to remain inside an existing 463.24 square-foot enclosure on the ground. The site is at 2088 Beryl St. in the RM-1-1 Zone of the Pacific Beach Community.

WCFs are allowed, with approval of a CUP, in residential zones within non-residential uses pursuant to SDMC Section [141.420.\(c\)\(1\)\(A\)\(i\)](#) under a process three decision. An NDP is required pursuant to SDMC Section [126.0402\(m\)](#) for WCF equipment that exceeds the 250 square feet allowed by the development regulations. The existing equipment enclosure for this site is 463 square feet. Processing this permit satisfies this requirement.

The Pacific Beach Community Plan defers all WCFs to the WCF Guidelines, regulations, and the General Plan. The City of San Diego General Plan requires all wireless facilities to minimize visual impacts under the Urban Design Element ([UD-A.15.a](#)). It also includes the following provisions: A) Conceal wireless facilities in existing structures, when possible, otherwise use camouflage and screening techniques to hide or blend them into the surrounding area. B) Design facilities to be aesthetically pleasing and respectful of the neighborhood context. C) Conceal mechanical equipment and devices associated with wireless facilities in underground vaults or unobtrusive structures.

In this case, AT&T has placed all antennas on a single faux mono-eucalyptus tree, replacing the previous mono-cypress and removing two antennas from a nearby light pole to integrate all antennas in one location better. The mono-eucalyptus tree has more foliage and provides a more natural setting to screen the antennas. The equipment is located inside an enclosure screened from the view. Therefore, the proposed development will not adversely affect the applicable land use plan.

b. **The proposed development will not be detrimental to the public health, safety, and welfare.**

The project is the continued use and modification to an existing WCF that includes the removal of a 30-foot-tall mono-cypress faux tree supporting six antennas and six Remote

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Radio Units (RRUs), the removal of three antennas inside a canister on a 30-foot-tall light pole and replace it with a 30-feet tall mono-eucalyptus faux tree supporting 12 antennas and nine RRUs. The equipment is to remain inside an existing 463.24 square-foot enclosure on the ground. The site is at 2088 Beryl St. in the RM-1-1 Zone of the Pacific Beach Community.

The project was determined to be exempt from CEQA pursuant to Section 15301 (Existing Facility). The conditions of approval of the permit for the project will require compliance with several operational constraints and development controls intended to assure continued public health, safety, and welfare.

The Telecommunication Act of 1996 preempts local governments from regulating the "placement, construction and modification of wireless communication facilities on the basis of the environmental effects of Radio Frequency (RF) emissions to the extent that such facilities comply with the Federal Communication Commission's (FCC) standards for such emissions." The proposed project would be consistent with the FCC's regulations for wireless facilities. Dish Wireless has submitted an RF Report- prepared by EBI Consulting, dated October 11, 2022, demonstrating compliance with the required FCC regulations.

Therefore, based on the above, the project would not result in any significant health or safety risks to the surrounding area within matters of City's jurisdiction and will not be detrimental to the public health, safety, and welfare.

c. The proposed development will comply with the applicable regulations of the Land Development Code including any allowable deviations pursuant to the Land Development Code.

The project is the continued use and modification to an existing WCF that includes the removal of a 30-foot-tall mono-cypress faux tree supporting six antennas and six Remote Radio Units (RRUs), the removal of three antennas inside a canister on a 30-foot-tall light pole and replace it with a 30-feet tall mono-eucalyptus faux tree supporting 12 antennas and nine RRUs. The equipment is to remain inside an existing 463.24 square-foot enclosure on the ground. The site is at 2088 Beryl St. in the RM-1-1 Zone of the Pacific Beach Community.

WCFs are allowed in the residential zone with approval of a CUP, pursuant to SDMC Section [141.0420 \(c\)\(1\)\(A\)\(i\)](#), which is a process three decision. An NDP is required pursuant to SDMC Section [126.0402\(m\)](#) for a WCF equipment that exceeds the 250 square feet, the maximum allowed per the development regulations. The existing equipment enclosure for this site is 463.24 square-foot which exceeds the allowed maximum. This deviation is addressed through processing of an NDP, processing of this permit that satisfies this requirement.

AT&T has placed all antennas on a single faux mono-eucalyptus tree replacing the previous mono-cypress, and removing three antennas from a nearby light pole, in order to better integrate all antennas in one location. The mono-eucalyptus tree has more

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foliage and provides a more natural setting to screen the antennas as it blends with the existing trees. The equipment is located on the interior portion of the parking lot inside an enclosure screened from the view. Therefore, the proposed development will comply to the maximum extent feasible with the regulations of the Land Development Code including the allowable deviation described above.

d. The proposed use is appropriate at the proposed location.

The project is the continued use and modification to an existing WCF that includes the removal of a 30-foot-tall mono-cypress faux tree supporting six antennas and six Remote Radio Units (RRUs), the removal of three antennas inside a canister on a 30-foot-tall light pole and replace it with a 30-feet tall mono-eucalyptus faux tree supporting 12 antennas and nine RRUs. The equipment is to remain inside an existing 463.24 square-foot enclosure on the ground. The site is at 2088 Beryl St. in the RM-1-1 Zone of the Pacific Beach Community.

[Council Policy 600-43](#) guidelines establish hierarchy from the most preferred location (Preference 1) to the least preferred location (Preference 4) for WCFs. The project is proposed within a Preference 3 location which is a nonresidential use within a residential zone. AT&T is requesting a permit for the continued use of an existing facility with modification to upgrade to new technology. The original permit was approved by the Planning Commission in October of 2011. This site, a preference 3 location (non-residential use within a residential zone), has been serving the community over the past decade. The modification of this facility will provide increased cellular service to the surrounding residential community including Little Free Library, Session Elementary School and major Freeway-5 east of the site as indicated in the Coverage Map. (Attachment 12).

Lastly, in addition to the Council Policy, the project is consistent with the City adopted [WCF Design Guidelines](#), and [SDMC Section 141.0420 \(d\) and \(e\)](#), the project is appropriately designed and integrated with the existing use of the site. Therefore, staff has determined that the proposed WCF use is appropriate at the proposed location based on the justification report, coverage map, and the overall design of the WCF.

B. [NEIGHBORHOOD DEVELOPMENT PERMIT [126.0404]]

(1) Findings for all Neighborhood Development Permits

(a) The proposed development will not adversely affect the applicable land use plan;

See Section A.1.a

(b) The proposed development will not be detrimental to the public health, safety, and welfare; and

See Section A.1.b

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(c) The proposed development will comply with the applicable regulations of the Land Development Code including any allowable deviations pursuant to the Land Development Code.

The project is the continued use and modification to an existing (WCF) that includes the removal of a 30-foot-tall mono-cypress faux tree supporting six antennas and six Remote Radio Units (RRUs), the removal of three antennas inside a canister on a 30-foot-tall light pole and replace it with a 30-feet tall mono-eucalyptus faux tree supporting 12 antennas and nine RRUs. The equipment is to remain inside an existing 463.24 square-foot enclosure on the ground. The site is at 2088 Beryl St. in the RM-1-1 Zone of the Pacific Beach Community.

An NDP is required pursuant to SDMC [Section 126.0402\(m\)](#) for WCF equipment that exceeds the 250-square feet allowed by the development regulations. The existing equipment enclosure for this site is 463 square-feet. Processing this permit satisfies this requirement. The proposed deviation in the size of the equipment is necessary as part of the WCF to support the antennas and to provide service. The equipment enclosure is screened inside an enclosure and does not cause any visual impact. Therefore, the proposed deviation is appropriate at this location, and it will comply with the applicable regulations of the Land Development Code including any allowable deviations pursuant to the Land Development Code.

The above findings are supported by the minutes, maps and exhibits, all of which are incorporated herein by this reference.

BE IT FURTHER RESOLVED that, based on the findings hereinbefore adopted by the Hearing Officer, CUP PMT-3200925 and NDP PMT-3267836 is hereby GRANTED by the Hearing Officer to the referenced Owner/Permittee, in the form, exhibits, terms and conditions as set forth in Permits PMT-3200925 and PMT-3267836, a copy of which is attached hereto and made a part hereof.

Nilia Safi
Development Project Manager
Development Services

Adopted on: March 20, 2024

IO#: 11003679

RECORDING REQUESTED BY
CITY OF SAN DIEGO
DEVELOPMENT SERVICES
PERMIT INTAKE, MAIL STATION
501

WHEN RECORDED MAIL TO
PROJECT MANAGEMENT
PERMIT CLERK
MAIL STATION 501

INTERNAL ORDER NUMBER: 11003679

SPACE ABOVE THIS LINE FOR RECORDER'S USE

CONDITIONAL USE PERMIT No. 3200925

NEIGHBORHOOD DEVELOPMENT PERMIT No. 3267836

AT&T MOBILITY COMMUNITY CONGREGATIONAL CHURCH PROJECT NO. 1081156
HEARING OFFICER

This Conditional Use Permit (CUP) No. 3200925 and Neighborhood Development Permit (NDP) No. 3267836 is granted by the Hearing Officer of the City of San Diego to Community Congregational Church, Owner, and AT&T, Permittee, pursuant to San Diego Municipal Code [SDMC] sections [131.0401](#), [141.0420](#), [126.0303](#) and [126.0402 \(m\)](#). The site is located at 2088 Beryl Street in the RM-1-1 Zone within the Pacific Beach Community Plan. The project site is legally described as: Lot 1 of Church in the Vale, in the City of La Jolla, County of San Diego, State of California, per Map No. 5700, filed in the Office of the County Recorder of San Diego County, February 25, 1966.

Subject to the terms and conditions set forth in this Permit, permission is granted to Owner and Permittee for a Wireless Communication Facility (WCF) as described and identified by size, dimension, quantity, type, and location on the approved exhibits [Exhibit "A"] dated March 20, 2024, on file in the Development Services Department.

The project shall include:

- a. Continued use and modification to an existing (WCF) that includes removal of a 30-foot-tall mono-cypress faux tree supporting six antennas and six Remote Radio Units (RRUs), removal of three antennas inside a canister on a 30-foot-tall light pole and replace it with a 30-feet tall mono-eucalyptus faux tree supporting 12 antennas and nine RRUs.
- b. Equipment enclosure to remain inside an existing 463.24 square feet enclosure on the ground.
- c. Public and private accessory improvements determined by the Development Services Department to be consistent with the land use and development standards for this site in accordance with the adopted community plan, the California Environmental Quality Act [CEQA] and the CEQA Guidelines, the City Engineer's requirements, zoning regulations, conditions of this Permit, and any other applicable regulations of the SDMC.

STANDARD REQUIREMENTS:

1. This permit must be utilized within thirty-six (36) months after the date on which all rights of appeal have expired. If this permit is not utilized in accordance with Chapter 12, Article 6, Division 1 of the SDMC within the 36-month period, this permit shall be void unless an Extension of Time has been granted. Any such Extension of Time must meet all SDMC requirements and applicable guidelines in effect at the time the extension is considered by the appropriate decision maker. This permit must be utilized by April 3, 2027.
2. No permit for the construction, occupancy, or operation of any facility or improvement described herein shall be granted, nor shall any activity authorized by this Permit be conducted on the premises until:
 - a. The Owner/Permittee signs and returns the Permit to the Development Services Department; and
 - b. The Permit is recorded in the Office of the San Diego County Recorder.
3. This CUP & NDP and corresponding use of this site shall expire on **March 20, 2034**. Upon expiration of this Permit, the facilities and improvements described herein shall be removed from this site and the property shall be restored to its original condition preceding approval of this Permit.
4. While this Permit is in effect, the subject property shall be used only for the purposes and under the terms and conditions set forth in this Permit unless otherwise authorized by the appropriate City decision maker.
5. This Permit is a covenant running with the subject property and all of the requirements and conditions of this Permit and related documents shall be binding upon the Owner/Permittee and any successor(s) in interest.
6. The continued use of this Permit shall be subject to the regulations of this and any other applicable governmental agency.
7. Issuance of this Permit by the City of San Diego does not authorize the Owner/Permittee for this Permit to violate any Federal, State or City laws, ordinances, regulations or policies including, but not limited to, the Endangered Species Act of 1973 [ESA] and any amendments thereto (16 U.S.C. § 1531 et seq.).
8. The Owner/Permittee shall secure all necessary building permits. The Owner/Permittee is informed that to secure these permits, substantial building modifications and site improvements may be required to comply with applicable building, fire, mechanical, and plumbing codes, and State and Federal disability access laws.

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9. Construction plans shall be in substantial conformity to Exhibit "A." Changes, modifications, or alterations to the construction plans are prohibited unless appropriate application(s) or amendment(s) to this Permit have been granted.

10. All of the conditions contained in this Permit have been considered and were determined necessary to make the findings required for approval of this Permit. The Permit holder is required to comply with each and every condition in order to maintain the entitlements that are granted by this Permit.

If any condition of this Permit, on a legal challenge by the Owner/Permittee of this Permit, is found or held by a court of competent jurisdiction to be invalid, unenforceable, or unreasonable, this Permit shall be void. However, in such an event, the Owner/Permittee shall have the right, by paying applicable processing fees, to bring a request for a new permit without the "invalid" condition(s) back to the discretionary body which approved the Permit for a determination by that body as to whether all of the findings necessary for the issuance of the proposed permit can still be made in the absence of the "invalid" condition(s). Such hearing shall be a hearing de novo, and the discretionary body shall have the absolute right to approve, disapprove, or modify the proposed permit and the condition(s) contained therein.

11. The Owner/Permittee shall defend, indemnify, and hold harmless the City, its agents, officers, and employees from any and all claims, actions, proceedings, damages, judgments, or costs, including attorney's fees, against the City or its agents, officers, or employees, relating to the issuance of this permit including, but not limited to, any action to attack, set aside, void, challenge, or annul this development approval and any environmental document or decision. The City will promptly notify Owner/Permittee of any claim, action, or proceeding and, if the City should fail to cooperate fully in the defense, the Owner/Permittee shall not thereafter be responsible to defend, indemnify, and hold harmless the City or its agents, officers, and employees. The City may elect to conduct its own defense, participate in its own defense, or obtain independent legal counsel in defense of any claim related to this indemnification. In the event of such election, Owner/Permittee shall pay all of the costs related thereto, including without limitation reasonable attorney's fees and costs. In the event of a disagreement between the City and Owner/Permittee regarding litigation issues, the City shall have the authority to control the litigation and make litigation related decisions, including, but not limited to, settlement or other disposition of the matter. However, the Owner/Permittee shall not be required to pay or perform any settlement unless such settlement is approved by Owner/Permittee.

12. No later than ninety (90) days prior to the expiration of this approval, the Permittees may submit a new application to the Development Services Department for consideration with review and a decision by the appropriate decision maker at that time. Failure to submit prior to the deadline will be cause for enforcement for noncompliance, which may include penalties and fines.

13. Under no circumstances, does approval of this permit authorize the Owner/Permittee to utilize this site for WCF purposes beyond the permit expiration date. Use of this permit approval beyond the expiration date of this permit is prohibited.

ENGINEERING REQUIREMENTS:

14. Prior to the issuance of any construction permit the Owner/Permittee shall submit a Water Pollution Control Plan (WPCP). The WPCP shall be prepared in accordance with the guidelines in Part 2 Construction BMP Standards Chapter 4 of the City's Storm Water Standards.

LANDSCAPE REQUIREMENTS:

15. The Owner/Permittee shall be responsible for the maintenance of all landscape improvements shown on the approved plans, including in the right-of-way, unless long-term maintenance of said landscaping will be the responsibility of another entity approved by the Development Services Department. All required landscape shall be maintained consistent with the Landscape Standards in a disease, weed, and litter free condition at all times. Severe pruning or "topping" of trees is not permitted.

16. If any required landscape (including existing or new plantings, hardscape, landscape features, etc.) indicated on the approved construction documents is damaged or removed, the Owner/Permittee shall repair and/or replace in kind and equivalent size per the approved documents to the satisfaction of the Development Services Department within 30 days of damage or Certificate of Occupancy.

PLANNING/DESIGN REQUIREMENTS:

17. Every aspect of this project is considered an element of concealment including but not limited to the dimensions, bulk and scale, color, materials and texture. Any future modifications to this permit must not defeat concealment.

18. The WCF shall conform to the approved construction plans.

19. Photo simulations shall be printed in color on the construction plans.

20. The City may require the Owner/Permittee to provide a topographical survey conforming to the provisions of the SDMC may be required if the City determines during construction, that there may be a conflict between the building(s) under construction and a condition of this Permit or a regulation of the underlying zone. The cost of any such survey shall be borne by the Owner/Permittee.

21. The Owner/Permittee shall install and maintain appropriate warning signage on the WCF as required by State and Federal regulations. The Owner/Permittee shall be responsible for complying with all State and Federal regulations.

22. The accuracy and validity of the RF Compliance Report, submitted by the Permittee, shall be assured while the WCF is in operation. If requested by the City, Owner/Permittee shall provide an updated RF Compliance Report to address any issues associated with the emitting components of the WCF.

ATTACHMENT 5

23. All equipment, including transformers, emergency generators and air conditioners belonging to the Owner/Permittee shall be designed and operated consistent with the City noise ordinance. Ventilation openings shall be baffled and directed away from residential areas. The vibration resonance of operating equipment in the equipment enclosures shall be eliminated.
 24. All facilities and related equipment shall be maintained in good working order. Any damaged equipment shall be repaired or replaced within thirty (30) calendar days of notification by the City of San Diego.
 25. The Owner/Permittee shall notify the City within 30 days of the sale or transfer of this site to any other provider or if the site is no longer operational, in which case, the removal and restoration of this site to its original condition is required.
 26. All private outdoor lighting shall be shaded and adjusted to fall on the same premises where such lights are located and in accordance with the applicable regulations in the SDMC.
 27. All proposed hand-holes shall be covered with bark material to match the mono-eucalyptus trunk to the satisfaction of the Development Services Department.
 28. All coaxial conduits shall be routed up through the caisson and into the tree to the satisfaction of the Development Services Department. "Doghouse" cable housings are not permitted.
 29. All branches at the antenna level shall extend a minimum of 24 inches beyond the entire vertical face of the proposed antennas to the satisfaction of the Development Services Department.
 30. Starting branch height shall be no lower than 10 feet, as illustrated on the stamped, approved Exhibit "A."
- All exposed cables, brackets, and supports shall be painted to match the faux tree foliage to the satisfaction of the Development Services Department.
31. RF socks fully covering the front, back, and sides of the antennas (and any other components) shall be used.
 32. A minimum of four branches per foot for full density coverage with limited spacing between the branches, unless 3D models justify lower branch counts.
 33. There should be no gaps in branch coverage. All branch ports should be used for branches. Branches should blend down the tree with no abrupt transitions.
 34. No exposed mounting apparatus may remain.
 35. Use 90-degree connectors to eliminate large looping cables from the antennas' bottom.

ATTACHMENT 5

36. Any changes to branches will require a building permit and should appear on the scope of work of any plans submitted. Faux vegetation should not be rebranched without a permit, even if no other work exists.

INFORMATION ONLY:

- Please note that a Telecom Planning Inspection Issue will be placed on the project prior to Final Clearance from the City's Building Inspector to ensure compliance with the approved plans and associated conditions. Prior to calling for your Final Inspection from your building inspection official, please contact the Development Services Department Wireless Communication Facilities staff listed on City webpage, <https://www.sandiego.gov/development-services/codes-regulations/wireless-communication-facilities>, to schedule an inspection of the completed facility. Please schedule this administrative inspection at least five working days ahead of the requested Final Inspection date.
- The issuance of this discretionary permit alone does not allow the immediate commencement or continued operation of the proposed use on site. Any operation allowed by this discretionary permit may only begin or recommence after all conditions listed on this permit are fully completed and all required ministerial permits have been issued and received final inspection.
- Any party on whom fees, dedications, reservations, or other exactions have been imposed as conditions of approval of this Permit, may protest the imposition within ninety days of the approval of this development permit by filing a written protest with the City Clerk pursuant to California Government Code-section 66020.
- This development may be subject to impact fees at the time of construction permit issuance.

APPROVED by the Hearing Officer of the City of San Diego on March 20, 2024, and Approved Resolution Number XXXX.

ATTACHMENT 5

Permit Type/PTS Approval No.: CUP/PMT-3200925

NDP/PMT-3267836

Date of Approval: March 20, 2024

AUTHENTICATED BY THE CITY OF SAN DIEGO DEVELOPMENT SERVICES DEPARTMENT

Nilia Safi
Development Project Manager

**NOTE: Notary acknowledgment
must be attached per Civil Code
section 1189 et seq.**

The undersigned Owner/Permittee, by execution hereof, agrees to each and every condition of this Permit and promises to perform each and every obligation of Owner/Permittee hereunder.

Community Congregational Church
Owner

By _____
NAME
TITLE

AT&T Mobility
Permittee

By _____
NAME
TITLE

**NOTE: Notary acknowledgments
must be attached per Civil Code
section 1189 et seq.**



THE CITY OF SAN DIEGO

Date of Notice: January 2, 2024

NOTICE OF RIGHT TO APPEAL ENVIRONMENTAL DETERMINATION DEVELOPMENT SERVICES DEPARTMENT

SAP or I.O. No. 11004545

PROJECT NAME / NUMBER: Beryl Street Wireless Communication Facility/1081156

COMMUNITY PLAN AREA: Pacific Beach

COUNCIL DISTRICT: 2

LOCATION: 2088 Beryl Street San Diego, CA 92109

PROJECT DESCRIPTION: Conditional Use Permit (CUP) to remove (1) monocypress tree, (1) cannister, (9) antennas (3), (6) radio remote units (RRU), (11) tower mounted amplifiers and (12) batteries and install (12) antennas, (9) RRU's, and (1) battery cabinet containing (24) batteries on a new monoeucalyptus tree. The property is located at 2088 Beryl Street in the residential RM1-1 zone of the Pacific Beach Community Planning area, and Council District 2. The WCF is unmanned and is not for human habitation.

ENTITY CONSIDERING PROJECT APPROVAL: City of San Diego Hearing Officer

ENVIRONMENTAL DETERMINATION: Categorically exempt from CEQA pursuant to CEQA State Guidelines, Section 15301 (Existing Facilities).

ENTITY MAKING ENVIRONMENTAL DETERMINATION: City of San Diego, Development Services Department

STATEMENT SUPPORTING REASON FOR ENVIRONMENTAL DETERMINATION The City of San Diego conducted an environmental review and determined that the project would qualify to be categorically exempt from CEQA pursuant to Section 15301 (Existing Facilities). Section 15301 Section allows for the operation, repair, maintenance, permitting, leasing, licensing, or minor alteration of existing facilities (public or private), involving negligible or no expansion of use beyond that existing at the time of the determination. Since the project would involve negligible expansion with the removal of existing WCF equipment and installation of new equipment, the exemption was deemed appropriate and no environmental impacts would occur. None of the exceptions described in CEQA Guidelines Section 15300.2 apply.

DEVELOPMENT PROJECT MANAGER:

Nilia Safi

MAILING ADDRESS:

1222 First Avenue, MS 501, San Diego, CA 92101-4153

PHONE NUMBER / EMAIL:

(619) 446-5236/ nsafi@sandiego.gov

On January 2, 2024 the City of San Diego made the above-referenced environmental determination pursuant to the California Environmental Quality Act (CEQA). This determination is appealable to the City Council. If you have any questions about this determination, contact the City Development Project Manager listed above.

Applications to appeal CEQA determination made by staff (including the City Manager) to the City Council must be filed in the office of the City Clerk by 5:00pm within 10 business days from the date of the posting of this Notice (January 17, 2024). Appeals to the City Clerk must be filed by email or in-person as follows:

- 1) **Appeals filed via E-mail:** The Environmental Determination Appeal Application Form [DS-3031](#) can be obtained at <https://www.sandiego.gov/sites/default/files/legacy/development-services/pdf/industry/forms/ds3031>. Send the completed appeal form (including grounds for appeal and supporting documentation in pdf format) by email to Hearings1@sandiego.gov by 5:00p.m. on the last day of the appeal period; your email appeal will be acknowledged within 24 business hours. You must separately mail the appeal fee by check payable to the City Treasurer to: City Clerk/Appeal, MS 2A, 202 C Street, San Diego, CA 92101. The appeal filing fee must be United States Postal Service (USPS) postmarked before or on the final date of the appeal. Please include the project number on the memo line of the check.

- 2) **Appeals filed in person:** Environmental Determination Appeal Application Form [DS-3031](#) can be obtained at <https://www.sandiego.gov/sites/default/files/legacy/development-services/pdf/industry/forms/ds3031.pdf>. Bring the fully completed appeal application [DS-3031](#) (including grounds for appeal and supporting documentation) to the City Administration Building—Public Information Counter (Open 8:00am to 5:00pm Monday through Friday excluding City-approved holidays), 1st Floor Lobby, located at 202 C Street, San Diego, CA 92101, by 5:00pm on the last day of the appeal period. The completed appeal form shall include the required appeal fee, with a check payable to: City Treasurer.

The appeal application can also be obtained from the City Clerk, 202 'C' Street, Second Floor, San Diego, CA 92101.


This information will be made available in alternative formats upon request.

CAL02071 - Community Congregational Church

MD7

2088 Beryl Street, San Diego, CA 92109

Map

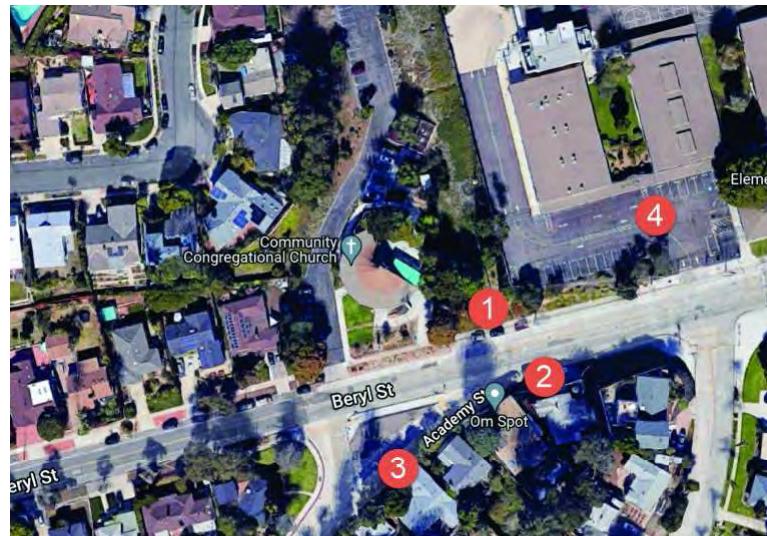

LOCATION

©2018 Google Maps

ACCURACY OF PHOTO SIMULATION BASED UPON INFORMATION PROVIDED BY PROJECT APPLICANT.

CAL02071 - Community Congregational Church

MD7

2088 Beryl Street, San Diego, CA 92109

VIEW 1



EXISTING



PROPOSED

ACCURACY OF PHOTO SIMULATION BASED UPON INFORMATION PROVIDED BY PROJECT APPLICANT.

CAL02071 - Community Congregational Church

MD7

2088 Beryl Street, San Diego, CA 92109

VIEW 2



EXISTING



PROPOSED

ACCURACY OF PHOTO SIMULATION BASED UPON INFORMATION PROVIDED BY PROJECT APPLICANT.

CAL02071 - Community Congregational Church


MD7

2088 Beryl Street, San Diego, CA 92109

VIEW 3



EXISTING

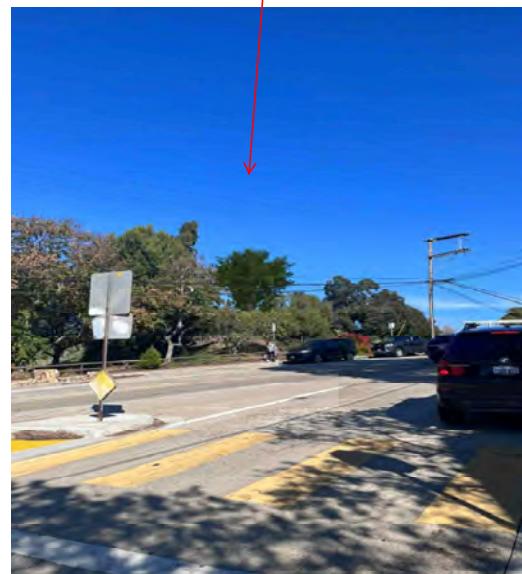

PROPOSED

ACCURACY OF PHOTO SIMULATION BASED UPON INFORMATION PROVIDED BY PROJECT APPLICANT.

CAL02071 - Community Congregational Church

MD7

2088 Beryl Street, San Diego, CA 92109

VIEW 4



EXISTING



PROPOSED


ACCURACY OF PHOTO SIMULATION BASED UPON INFORMATION PROVIDED BY PROJECT APPLICANT.

10090957 - Community Congregational Church

MD7

2088 Beryl Street, San Diego, CA 92109

Map

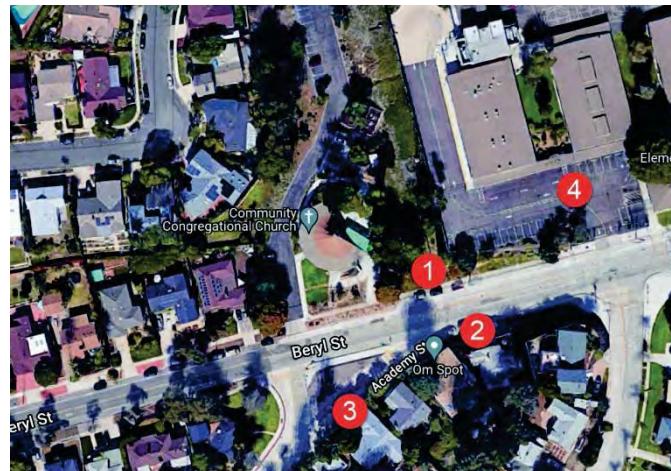

LOCATION

©2018 Google Maps

ACCURACY OF PHOTO SIMULATION BASED UPON INFORMATION PROVIDED BY PROJECT APPLICANT.

10090957 - Community Congregational Church

MD7

2088 Beryl Street, San Diego, CA 92109

VIEW 1



SOUTH VIEW

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10090957 - Community Congregational Church

MD7

2088 Beryl Street, San Diego, CA 92109

[VIEW 2](#)



NORTH VIEW


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10090957 - Community Congregational Church

MD7

2088 Beryl Street, San Diego, CA 92109

VIEW 3

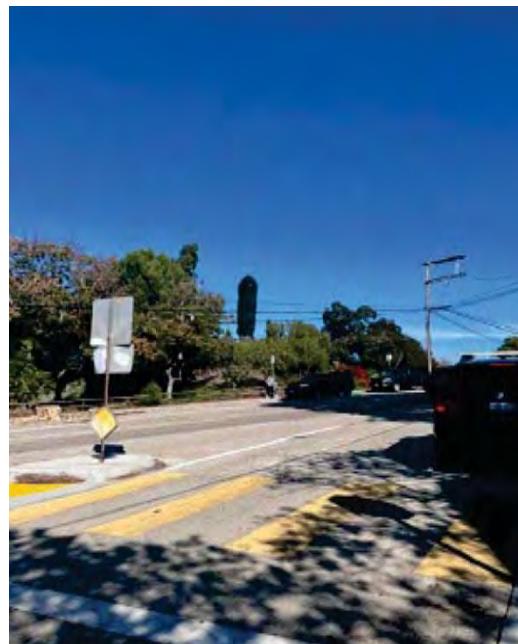

WEST VIEW

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10090957 - Community Congregational Church

MD7

2088 Beryl Street, San Diego, CA 92109

VIEW 3



WEST VIEW

©2018 Google Maps



**City of San Diego
Development Services**
1222 First Ave., MS-302
San Diego, CA 92101

Community Planning Committee Distribution Form

Project Name:
2088 Beryl Street

Project Number:
1081156

Community: Pacific Beach

For project scope and contact information (project manager and applicant),
log into OpenDSD at <https://aca.accela.com/SANDIEGO>.

Select "Search for Project Status" and input the Project Number to access project information.

Vote to Approve

Vote to Approve with Conditions Listed Below

Vote to Approve with Non-Binding Recommendations Listed Below

Vote to Deny

Date of Vote:

November 08,

of Members Yes

8

of Members No

0

of Members Abstain

1

Conditions or Recommendations:

N/A

No Action

(Please specify, e.g., Need further information, Split vote, Lack of quorum, etc.)

NAME: JOHN C TERELL

TITLE: Chair, Development Subcommittee

DATE: November 13, 2023


Attach additional pages if necessary (maximum 3 attachments).

Visit our web site at www.sandiego.gov/development-services.

Upon request, this information is available in alternative formats for persons with disabilities.


DS-5620 (08-18) ONLINE FORM

SPECIAL INSPECTION REQUIRED.
SEE SPECIAL INSPECTION
SUMMARY ON SHEET S01.0.

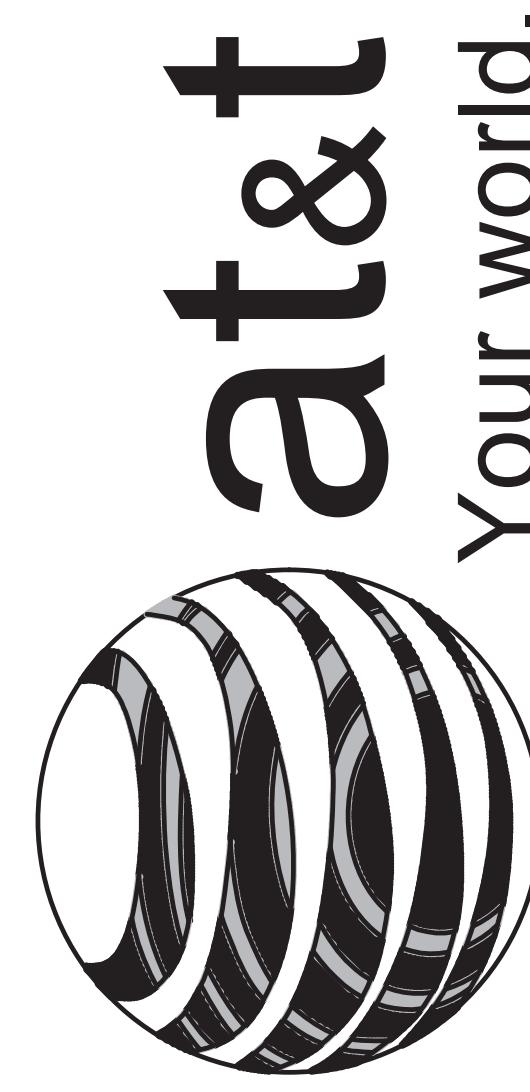

Your world. Delivered.

VICINITY MAP

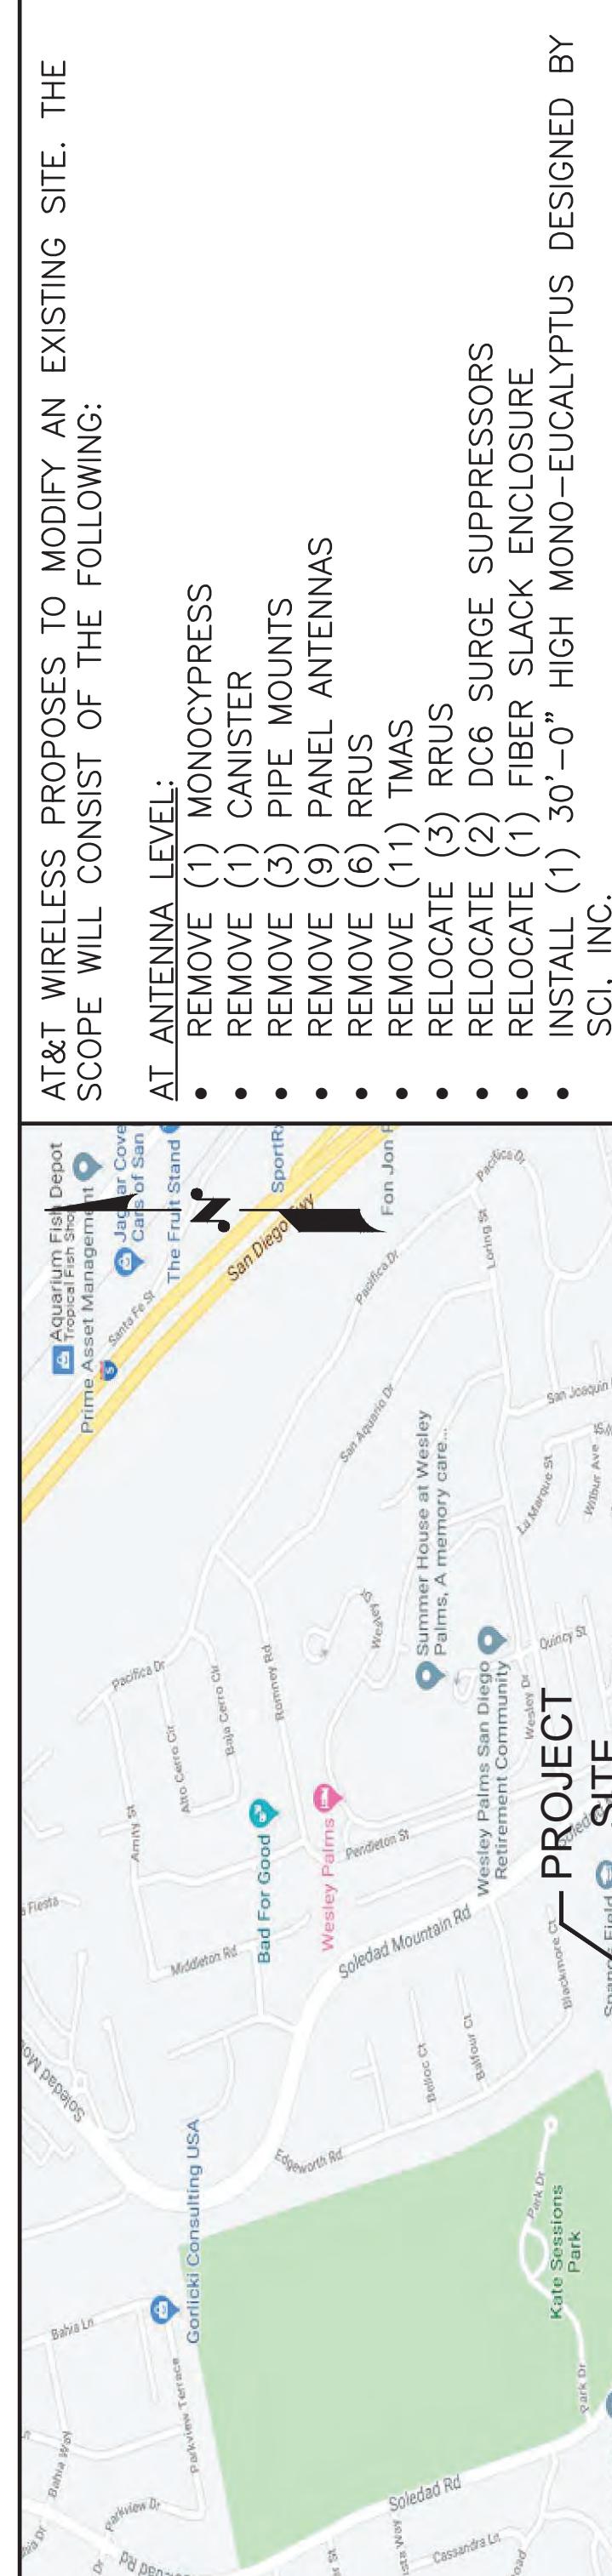

SCOPE OF WORK

AT&T WIRELESS PROPOSES TO MODIFY AN EXISTING SITE. THE SCOPE WILL CONSIST OF THE FOLLOWING:

AT ANTENNA LEVEL:

- REMOVE (1) MONOCYPRESS
- REMOVE (1) CANISTER
- REMOVE (3) PIPE MOUNTS
- REMOVE (9) PANEL ANTENNAS
- REMOVE (6) RRUS
- REMOVE (11) TMAS
- RELOCATE (3) RRUS
- RELOCATE (2) DC6 SURGE SUPPRESSORS
- RELOCATE (1) FIBER SLACK ENCLOSURE
- INSTALL (1) 30'-0" HIGH MONO-EUCALYPTUS DESIGNED BY SCI, INC.

CONTACTS

INDEX OF DRAWINGS

DO NOT SCALE DRAWINGS. CONTRACTOR MUST VERIFY ALL DIMENSIONS AND ADVISE CONSULTANT OF ANY VARIATIONS OR SHOWN SHALL BE IMPLEMENTED DURING CONSTRUCTION. THIS DRAWING IS SUPERSEDED BY THE LATEST REVISION. ALL DRAWINGS AND SPECIFICATIONS REMAIN THE PROPERTY OF MORRISON HERSHFIELD CORP. CONTRACTOR SHALL NOT COPY OR REPRODUCE THIS DRAWING WITHOUT THE APPROVAL OF THE PREVIOUS ISSUER OF THIS DRAWING BEING PROVIDED CONSTRUCTION REVIEW OF THIS PROJECT.

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COMMUNITY CONGREGATIONAL CHURCH

SITE ID: SS0071

2088 BERYL STREET
SAN DIEGO, CA 92109

FA: 10090957

LTE 4C / 5C / 5G NR 1SR CBAND

MRSSDL039103 / MRSSDL037354 / MRSSDL037671 / MRSSDL037210 / MRSSDL033411 / MRSSDL033437 MRSSDL033616

PROJECT SITE	DRIVING DIRECTIONS	APPLICABLE CODES	PROPERTY SUMMARY
	FROM AT&T OFFICE (7337 TRADE STREET, SAN DIEGO, CA 92121): HEAD WEST ON TRADE ST TOWARD CAMINO SANTA FE. TURN LEFT ONTO CAMINO SANTA FE. USE THE RIGHT 2 LANES TO TURN RIGHT ONTO MIRAMAR RD. TURN RIGHT TO MERGE WITH I-805 S. USE THE RIGHT LANE TO TAKE EXIT 1A TO MERGE WITH CA-52 W. USE THE RIGHT 2 LANES TO TAKE EXIT 1A TO MERGE WITH I-5 S. TAKE EXIT 23 TOWARD BALBOA AVE/GARNET AVE. CONTINUE ONTO MISSION BAY DR. USE THE RIGHT 2 LANES TO TURN RIGHT ONTO GARNET AVE. TURN RIGHT ONTO SOLEDAD MOUNTAIN RD. TURN LEFT ONTO BERYL ST. TURN RIGHT AT ACADEMY ST. DESTINATION WILL BE ON THE RIGHT.	ADDITIONS AND MODIFICATIONS TO THE CALIFORNIA CODES: A. CALIFORNIA BUILDING CODE – CHAPTER 14, ARTICLE 5, DIVISION 1-36 B. CALIFORNIA EXISTING BUILDING CODE – CHAPTER 14, ARTICLE 11, DIVISION 1-17	PROPERTY OWNER: COMMUNITY CONGREGATIONAL CHURCH OF PACIFIC BEACH 2088 BERYL STREET SAN DIEGO, CA 92109 CONTACT: CHUCK KILGORE (619) 665-9336 TEL: 603-985-9128 FAX: 603-985-9136 www.morrisonhershfield.com
	AT EQUIPMENT LEVEL: • REMOVE (1) -48VDC POWER CABINET • REMOVE (12) BATTERIES • DE-ENERGIZE (2) UMTS CABINETS • INSTALL (1) VERTIV STD -48VDC OUTDOOR NETSURE 5100 SYSTEM 525A POWER PLANT SYSTEM • INSTALL (12) EMERSON 2KW HE -48 RECTIFIERS • INSTALL (24) GNB M12V180FT BATTERIES • INSTALL (1) -48VDC NETEXTEND FLEX BATTERY CABINET • INSTALL (1) DC12 SURGE SUPPRESSOR • INSTALL OR RE-USE (3) 25A DC BREAKERS FOR NEW B14 RRUS • INSTALL OR RE-USE (6) 40A DC BREAKERS FOR NEW B5/12, 8B4-3 B2/B66 RRUS • INSTALL OR RE-USE (3) 50A DC BREAKERS FOR NEW AIR 6449 B77D ANTENNAS • INSTALL OR RE-USE (3) 45A DC BREAKERS FOR NEW B77G ANTENNAS • RE-ROUTE EXISTING COAX/POWER CABLES TO NEW TOWER EXISTING LIGHT POLE WITH EXISTING LIGHT FIXTURES & CANISTER TO REMAIN AFTER ANTENNAS HAS BEEN REMOVED.	1. 2022 EDITION OF THE CALIFORNIA BUILDING CODE VOLUME 1 2. 2019 EDITION OF THE CALIFORNIA BUILDING CODE VOLUME 2 3. 2019 EDITION OF THE CALIFORNIA MECHANICAL CODE 4. 2019 EDITION OF THE CALIFORNIA PLUMBING CODE 5. 2019 EDITION OF THE CALIFORNIA ELECTRICAL CODE 6. 2019 EDITION OF THE EXISTING BUILDING CODE 7. 2019 EDITION OF THE CALIFORNIA FIRE CODE 8. 2019 EDITION OF THE CALIFORNIA ENERGY CODE 9. 2019 EDITION OF THE CALIFORNIA GREEN BUILDING STANDARDS CODE 10. 2018 INTERNATIONAL PROPERTY MANAGEMENT CODE	PARCEL #: 4478 LATITUDE: 32° 48' 31.2" LONGITUDE: -117° 14' 01.3" ZONING JURISDICTION: CITY OF SAN DIEGO ZONING CLASSIFICATION: RM-1-1 COUNTY: SAN DIEGO COUNTY GROUND ELEVATION: 163' AMSL ANTENNA TOP HEIGHT: ±27'-0" OCCUPANCY GROUP: U CONSTRUCTION TYPE: V-B POWER COMPANY: - TELEPHONE COMPANY: -
	LEGAL DESCRIPTION	LOT 1*	TITLE SHEET
	APPROVALS	EXISTING ANTENNA COUNT: 09 FINAL ANTENNA COUNT: 12 EXISTING RRU COUNT: 09 FINAL RRU COUNT: 12	Project No.: 210359800 Designer: SB Date: 05/06/22 Drawn By: GD Checked By: JR PM Review: Client Approval: G Issue No.: G Site Acq: TSO1 A

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- A. REMOVE FROM THE SITE AND DISPOSE IN AN AUTHORIZED LANDFILL ALL DEBRIS RESULTING FROM CLEARING AND GRUBBING OPERATIONS. BURNING WILL NOT BE PERMITTED.

PART 2 – PRODUCTS

- 2.1 SUITABLE BACKFILL: ASTM D2321 (CLASS I, II, III OR IV) FREE FROM FROZEN LUMPS, REFUSE, STONES OR ROCKS LARGER THAN 3 INCHES IN ANY DIMENSION OR OTHER MATERIAL THAT MAY MAKE THE INORGANIC MATERIAL UNSUITABLE FOR BACKFILL.

- 2.2 NON-POROUS GRANULAR EMBANKMENT AND BACKFILL: ASTM D2321 (CLASS III, IVA OR IVB) COARSE AGGREGATE, FREE FROM FROZEN LUMPS, REFUSE, STONES OR ROCKS LARGER THAN 3 INCHES IN ANY DIMENSION OR OTHER MATERIAL THAT MAY MAKE THE INORGANIC MATERIAL UNSUITABLE FOR BACKFILL.

- 2.3 POROUS GRANULAR EMBANKMENT AND BACKFILL: ASTM D2321 (CLASS IA, IB OR II) COARSE AGGREGATE FREE FROM FROZEN LUMPS, REFUSE, STONES OR ROCKS LARGER THAN 3 INCHES IN ANY DIMENSION OR OTHER MATERIAL THAT MAY MAKE THE INORGANIC MATERIAL UNSUITABLE FOR BACKFILL.

- 2.4 SELECT STRUCTURAL FILL: GRANULAR FILL MATERIAL MEETING THE REQUIREMENTS OF ASTM E850-95. FOR USE AROUND AND UNDER STRUCTURES WHERE STRUCTURAL FILL MATERIAL ARE REQUIRED.

- 2.5 GRANULAR BEDDING AND TRENCH BACKFILL: WELL-GRADED SAND MEETING THE GRADATION REQUIREMENTS OF ASTM D2487 (SE OR SW-SM).

- 2.6 COARSE AGGREGATE FOR ACCESS ROAD SUBBASE COURSE SHALL CONFORM TO ASTM D2940.

- 2.7 UNSUITABLE MATERIAL HIGH AND MODERATELY PLASTIC SILTS AND CLAYS ($LL > 45$), MATERIAL CONTAINING REFUSE, FROZEN LUMPS, DEMOLISHED BITUMINOUS MATERIAL, VEGETATIVE MATTER, WOOD, STONES IN EXCESS OF 3 INCHES IN ANY DIMENSION, AND DEBRIS AS DETERMINED BY THE CONSTRUCTION MANAGER, TYPICAL THESE WILL BE SOILS CLASSIFIED BY ASTM AS PT, MH, CH, OH, ML, AND OL.

- 2.8 GEOTEXTILE FABRIC: MIRAFI 500X OR APPROVED EQUAL.

- 2.9 PLASTIC MARKING TAPE: SHALL BE ACID AND ALKALI RESISTANT POLYETHYLENE FILM SPECIFICALLY MANUFACTURED FOR MARKING AND LOCATING UNDERGROUND UTILITIES. 6 INCHES WIDE WITH A MINIMUM THICKNESS OF 0.004 INCH. TAPE SHALL HAVE MINIMUM STRENGTH OF 1500 PSI IN BOTH DIRECTIONS AND MANUFACTURED WITH INTEGRAL CONDUCTORS, FOIL BACKING OR OTHER MEANS TO ENABLE DETECTION BY A METAL DETECTOR WHEN BURIED UP TO 3 FEET DEEP. THE METALLIC CORE OF THE TAPE SHALL BE ENCASED IN A PROTECTIVE JACKET OR PROVIDED WITH OTHER MEANS TO PROTECT IT FROM CORROSION. TAPE COLOR SHALL BE RED FOR ELECTRIC UTILITIES AND ORANGE FOR TELECOMMUNICATION UTILITIES.

PART 3 – EXECUTION

3.1 GENERAL:

- A. BEFORE STARTING GENERAL SITE PREPARATION ACTIVITIES, INSTALL EROSION AND SEDIMENT CONTROL MEASURES. THE WORK AREA SHALL BE CONSTRUCTED AND MAINTAINED IN SUCH CONDITION THAT IN THE EVENT OF RAIN THE SITE WILL BE DRAINED AT ANY TIME.

- B. BEFORE ALL SURVEY, LAYOUT, STAKING, AND MARKING, ESTABLISH AND MAINTAIN ALL LINES, GRADES, ELEVATIONS AND BENCHMARKS NEEDED FOR EXECUTION OF THE WORK.

- C. CLEAR AND GRUB THE AREA WITHIN THE LIMITS OF THE SITE, REMOVE TREES, BRUSH, STUMPS, RUBBISH AND OTHER DEBRIS AND VEGETATION RESTING ON OR PROTRUDING THROUGH THE SURFACE OF THE SITE AREA TO BE CLEARED.

1. REMOVE THE FOLLOWING MATERIALS TO A DEPTH OF NO LESS THAN 12 INCHES BELOW THE ORIGINAL GROUND SURFACE: ROOTS, STUMPS, AND OTHER DEBRIS, BRUSH, AND REFUSE EMBEDDED IN OR PROTRUDING THROUGH THE GROUND SURFACE. RAKE, DISK, OR PLOW THE AREA TO A DEPTH OF NO LESS THAN 6 INCHES, AND REMOVE TO A DEPTH OF 12 INCHES ALL ROOTS AND OTHER DEBRIS THEREBY EXPOSED.

2. REMOVE TOPSOIL MATERIAL COMPLETELY FROM THE SURFACE UNTIL THE SOIL NO LONGER MEETS THE DEFINITION OF TOPSOIL. AVOID MIXING TOPSOIL WITH SUBSOIL OR OTHER UNDESIRABLE MATERIALS.

3. EXCEPT WHERE EXCAVATION TO GREATER DEPTH IS INDICATED, FILL DEPRESSIONS RESULTING FROM CLEARING, GRUBBING AND DEMOLITION WORK COMPLETELY WITH SUITABLE FILL.

- G. COMPACT FINAL TRENCH BACKFILL TO A DENSITY EQUAL TO OR GREATER THAN THAT OF THE EXISTING UNDISTURBED MATERIAL IMMEDIATELY ADJACENT TO THE TRENCH BUT NO LESS THAN A MINIMUM OF 95 PERCENT OF THE MAXIMUM DRY DENSITY AS PROVIDED BY THE MODIFIED PROCTOR TEST, ASTM D 698.

3.5 AGGREGATE ACCESS ROAD:

- A. CLEAR, GRUB, STRIP AND EXCAVATE FOR THE ACCESS ROAD TO THE LINES AND GRADES INDICATED ON THE DRAWINGS. SCARIFY TO A DEPTH OF 6 INCHES AND PROOF-ROLL. ALL HOLES, RUTS, SOFT PLACES AND OTHER DEFECTS SHALL BE CORRECTED.

C. AFTER PREPARATION OF THE SUBGRADE IS COMPLETE THE GEOTEXTILE FABRIC (MIRAFI 500X) SHALL BE INSTALLED TO THE LIMITS INDICATED ON THE DRAWINGS BY ROLLING THE FABRIC OUT LONGITUDINALLY ALONG THE ROADWAY. THE FABRIC SHALL NOT BE DRAGGED ACROSS THE SUBGRADE. PLACE THE ENTIRE ROLL IN A SINGLE OPERATION, ROLLING OUT AS SMOOTHLY AS POSSIBLE.

1. OVERLAPS PARALLEL TO THE ROADWAY WILL BE PERMITTED AT THE CENTERLINE AND AT LOCATIONS BEYOND THE ROADWAY SURFACE WIDTH (I.E. WITHIN THE SHOULDER WIDTH) ONLY. NO LONGITUDINAL OVERLAPS SHALL BE LOCATED BETWEEN THE CENTERLINE AND THE SHOULDER. PARALLEL OVERLAPS SHALL BE A MINIMUM OF 3 FEET WIDE.

2. TRANSVERSE (PERPENDICULAR TO THE ROADWAY) OVERLAPS AT THE END OF A ROLL SHALL OVERLAP IN THE DIRECTION OF THE AGGREGATE PLACEMENT (PREVIOUS ROLL ON TOP) AND SHALL HAVE A MINIMUM LENGTH OF 3 FEET.

3. ALL OVERLAPS SHALL BE PINNED WIN STAPLES OR NAILS A MINIMUM OF 10 INCHES LONG TO INSURE POSITIONING DURING PLACEMENT OF AGGREGATE. PIN LONGITUDINAL SEAMS AT 25 FOOT CENTERS AND TRANSVERSE SEAMS EVERY 5 FEET.

- D. THE AGGREGATE BASE AND SURFACE COURSES SHALL BE CONSTRUCTED IN LAYERS NOT MORE THAN 4 INCH (COMPACTED) THICKNESS. AGGREGATE TO BE PLACED ON GEOTEXTILE FABRIC OR OVER PREVIOUSLY PLACED AGGREGATE. THE FIRST LIFT SHALL BE BLADED DOWN TO A THICKNESS OF 8 INCHES PRIOR TO COMPACTION. AT NO TIME SHALL EQUIPMENT, EITHER TRANSPORTING THE AGGREGATE OR GRADING THE AGGREGATE, BE PERMITTED ON THE ROADWAY WITH LESS THAN 4 INCHES OF MATERIAL COVERING THE FABRIC.

- E. THE AGGREGATE SHALL BE IMMEDIATELY COMPACTION TO NOT LESS THAN 95 PERCENT OF THE MAXIMUM DRY DENSITY AS PROVIDED BY THE MODIFIED PROCTOR TEST, ASTM D 1557 WITH A TAMPER ROLLER, OR WITH A PNEUMATIC-TIRED ROLLER, OR WITH A VIBRATORY MACHINE OR ANY COMBINATION OF THE ABOVE. THE TOP LAYER SHALL BE GIVEN A FINAL ROLLING WITH A THREE-WHEEL OR TANDEM ROLLER.

3.6 FINISH GRADING:

- A. PERFORM ALL GRADING TO PROVIDE POSITIVE DRAINAGE AWAY FROM STRUCTURES AND SMOOTH, EVEN SURFACE DRAINAGE OF THE ENTIRE AREA WITHIN THE LIMITS OF CONSTRUCTION. GRADING SHALL BE COMPATIBLE WITH ALL SURROUNDING TOPOGRAPHY AND STRUCTURES.

- B. UTILIZE SATISFACTORY ALL MATERIAL RESULTING FROM THE EXCAVATION WORK IN THE CONSTRUCTION OF FILLS, EMBANKMENTS AND FOR REPLACEMENT OF REMOVED UNSUITABLE MATERIALS.



- C. ACHIEVE FINISHED GRADE BY PLACING A MINIMUM OF 4 INCHES OF 1/2" – 3/4" CRUSHED STONE ON TOP SOIL STABILIZER FABRIC.

- D. REPAIR ALL ACCESS ROADS AND SURROUNDING AREAS USED DURING THE COURSE OF THIS WORK TO THEIR ORIGINAL CONDITION.

3.7 ASPHALT PAVING ROAD:

- A. CHAPTER 630 – CALIFORNIA DEPARTMENT OF TRANSPORTATION FLEXIBLE PAVEMENT. B. DESIGN GUIDE AND STANDARDS FOR ROADWAY REHABILITATION PROJECTS (DB 79-03).

- C. CONDUCT UTILITY CHECK TESTS BEFORE BACKFILLING. BACKFILL AND COMPACT TRENCH BEFORE ACCEPTANCE TESTING.
- D. PLACE GRANULAR TRENCH BACKFILL UNIFORMLY ON BOTH SIDES OF THE CONDUITS IN 6-INCH UNCOMPACTED LIFTS UNTIL 12 INCHES OVER THE CONDUITS. SOLIDLY RAM AND TAMP BACKFILL INTO SPACE AROUND CONDUITS.
- E. PROTECT CONDUIT FROM LATERAL MOVEMENT. IMPACT DAMAGE, OR UNBALANCED LOADING.
- F. ABOVE THE CONDUIT EMBEDMENT ZONE, PLACE AND COMPACT SATISFACTORY BACKFILL MATERIAL IN 8-INCH MAXIMUM LOOSE THICKNESS LIFTS TO RESTORE THE REQUIRED FINISHED SURFACE GRADE.

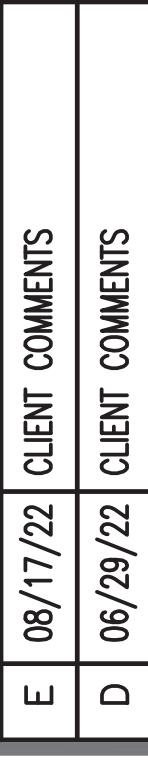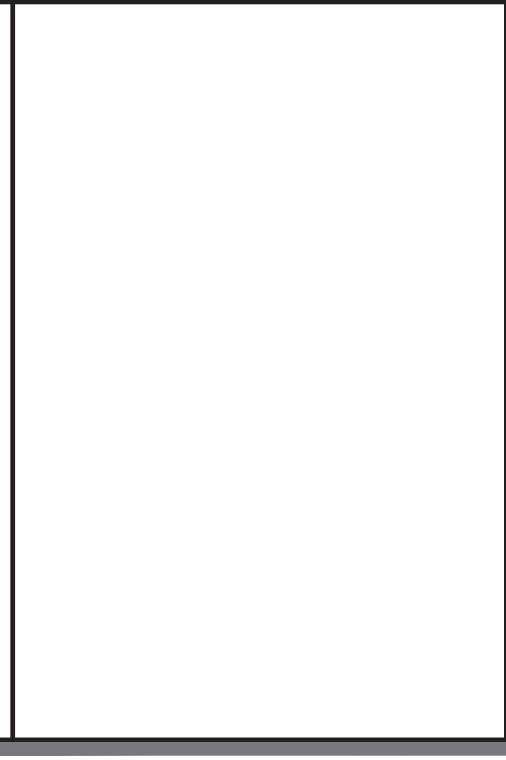

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- G. COMPACT FINAL TRENCH BACKFILL TO A DENSITY EQUAL TO OR GREATER THAN THAT OF THE EXISTING UNDISTURBED MATERIAL IMMEDIATELY ADJACENT TO THE TRENCH BUT NO LESS THAN A MINIMUM OF 95 PERCENT OF THE MAXIMUM DRY DENSITY AS PROVIDED BY THE MODIFIED PROCTOR TEST, ASTM D 698.

3.5 AGGREGATE ACCESS ROAD:

- A. CLEAR, GRUB, STRIP AND EXCAVATE FOR THE ACCESS ROAD TO THE LINES AND GRADES INDICATED ON THE DRAWINGS. SCARIFY TO A DEPTH OF 6 INCHES AND PROOF-ROLL. ALL HOLES, RUTS, SOFT PLACES AND OTHER DEFECTS SHALL BE CORRECTED.

- B. THE ENTIRE SUBGRADE SHALL BE COMPACTED TO NOT LESS THAN 95 PERCENT OF THE MAXIMUM DRY DENSITY AS PROVIDED BY THE MODIFIED PROCTOR TEST, ASTM D 698.

C. AFTER PREPARATION OF THE SUBGRADE IS COMPLETE THE GEOTEXTILE FABRIC (MIRAFI 500X) SHALL BE INSTALLED TO THE LIMITS INDICATED ON THE DRAWINGS BY ROLLING THE FABRIC OUT LONGITUDINALLY ALONG THE ROADWAY. THE FABRIC SHALL NOT BE DRAGGED ACROSS THE SUBGRADE. PLACE THE ENTIRE ROLL IN A SINGLE OPERATION, ROLLING OUT AS SMOOTHLY AS POSSIBLE.

1. OVERLAPS PARALLEL TO THE ROADWAY WILL BE PERMITTED AT THE CENTERLINE AND AT LOCATIONS BEYOND THE ROADWAY SURFACE WIDTH (I.E. WITHIN THE SHOULDER WIDTH) ONLY. NO LONGITUDINAL OVERLAPS SHALL BE LOCATED BETWEEN THE CENTERLINE AND THE SHOULDER. PARALLEL OVERLAPS SHALL BE A MINIMUM OF 3 FEET WIDE.

2. TRANSVERSE (PERPENDICULAR TO THE ROADWAY) OVERLAPS AT THE END OF A ROLL SHALL OVERLAP IN THE DIRECTION OF THE AGGREGATE PLACEMENT (PREVIOUS ROLL ON TOP) AND SHALL HAVE A MINIMUM LENGTH OF 3 FEET.

3. ALL OVERLAPS SHALL BE PINNED WIN STAPLES OR NAILS A MINIMUM OF 10 INCHES LONG TO INSURE POSITIONING DURING PLACEMENT OF AGGREGATE. PIN LONGITUDINAL SEAMS AT 25 FOOT CENTERS AND TRANSVERSE SEAMS EVERY 5 FEET.

- D. THE AGGREGATE BASE AND SURFACE COURSES SHALL BE CONSTRUCTED IN LAYERS NOT MORE THAN 4 INCH (COMPACTED) THICKNESS. AGGREGATE TO BE PLACED ON GEOTEXTILE FABRIC OR OVER PREVIOUSLY PLACED AGGREGATE. THE FIRST LIFT SHALL BE BLADED DOWN TO A THICKNESS OF 8 INCHES PRIOR TO COMPACTION. AT NO TIME SHALL EQUIPMENT, EITHER TRANSPORTING THE AGGREGATE OR GRADING THE AGGREGATE, BE PERMITTED ON THE ROADWAY WITH LESS THAN 4 INCHES OF MATERIAL COVERING THE FABRIC.

- E. THE AGGREGATE SHALL BE IMMEDIATELY COMPACTION TO NOT LESS THAN 95 PERCENT OF THE MAXIMUM DRY DENSITY AS PROVIDED BY THE MODIFIED PROCTOR TEST, ASTM D 1557 WITH A TAMPER ROLLER, OR WITH A PNEUMATIC-TIRED ROLLER, OR WITH A VIBRATORY MACHINE OR ANY COMBINATION OF THE ABOVE. THE TOP LAYER SHALL BE GIVEN A FINAL ROLLING WITH A THREE-WHEEL OR TANDEM ROLLER.

3.6 FINISH GRADING:

- A. PERFORM ALL GRADING TO PROVIDE POSITIVE DRAINAGE AWAY FROM STRUCTURES AND SMOOTH, EVEN SURFACE DRAINAGE OF THE ENTIRE AREA WITHIN THE LIMITS OF CONSTRUCTION. GRADING SHALL BE COMPATIBLE WITH ALL SURROUNDING TOPOGRAPHY AND STRUCTURES.

- B. UTILIZE SATISFACTORY ALL MATERIAL RESULTING FROM THE EXCAVATION WORK IN THE CONSTRUCTION OF FILLS, EMBANKMENTS AND FOR REPLACEMENT OF REMOVED UNSUITABLE MATERIALS.

- C. ACHIEVE FINISHED GRADE BY PLACING A MINIMUM OF 4 INCHES OF 1/2" – 3/4" CRUSHED STONE ON TOP SOIL STABILIZER FABRIC.

- D. REPAIR ALL ACCESS ROADS AND SURROUNDING AREAS USED DURING THE COURSE OF THIS WORK TO THEIR ORIGINAL CONDITION.

3.7 ASPHALT PAVING ROAD:

- A. CHAPTER 630 – CALIFORNIA DEPARTMENT OF TRANSPORTATION FLEXIBLE PAVEMENT. B. DESIGN GUIDE AND STANDARDS FOR ROADWAY REHABILITATION PROJECTS (DB 79-03).

- C. CONDUCT UTILITY CHECK TESTS BEFORE BACKFILLING. BACKFILL AND COMPACT TRENCH BEFORE ACCEPTANCE TESTING.

- D. PLACE GRANULAR TRENCH BACKFILL UNIFORMLY ON BOTH SIDES OF THE CONDUITS IN 6-INCH UNCOMPACTED LIFTS UNTIL 12 INCHES OVER THE CONDUITS. SOLIDLY RAM AND TAMP BACKFILL INTO SPACE AROUND CONDUITS.

- E. PROTECT CONDUIT FROM LATERAL MOVEMENT. IMPACT DAMAGE, OR UNBALANCED LOADING.

STORM WATER CONSTRUCTION BMP NOTES

1. ALL REQUIREMENTS OF THE CITY OF SAN DIEGO "STORM WATER STANDARDS MANUAL" MUST BE INCORPORATED INTO THE DESIGN AND CONSTRUCTION OF THE APPROVED GRADING/IMPROVEMENTS CONSISTENT WITH THE APPROVED STORM WATER POLLUTION PREVENTION PLAN (SWPPP) AND/OR WATER POLLUTION CONTROL PLAN (WPCCP) FOR CONSTRUCTION LEVEL BMPS AND, IF APPLICABLE, THE STORM WATER QUALITY MANAGEMENT PLAN (SWQMP) FOR POST-CONSTRUCTION BMP.
2. THE CONTRACTOR SHALL INSTALL AND MAINTAIN ALL STORM DRAIN INLET PROTECTION, INLET PROTECTION IN THE PUBLIC RIGHT-OF-WAY MUST SE TEMPORARILY REMOVED PRIOR TO A RAIN EVENT TO ENSURE NO FLOODING OCCURS AND REINSTALLED AFTER RAIN IS OVER.
3. ALL CONSTRUCTION BMPS SHALL BE INSTALLED AND PROPERLY MAINTAINED THROUGHOUT THE DURATION OF CONSTRUCTION.
4. THE CONTRACTOR SHALL ONLY GRADE, INCLUDING CLEARING AND CRUBBING, AREAS FOR WHICH THE CONTRACTOR OR QUALIFIED CONTACT PERSON CAN PROVIDE EROSION AND SEDIMENT CONTROL MEASURES.
5. THE CONTRACTOR IS RESPONSIBLE FOR ENSURING THAT ALL SUB-CONTRACTORS AND SUPPLIERS ARE AWARE OF ALL STORM WATER BMPS AND IMPLEMENT SUCH MEASURES, FAILURE TO COMPLY WITH THE APPROVED SWPPP/WPCCP WILL RESULT IN THE ISSUANCE OF CORRECTION NOTICES, CITATIONS, CIVIL PENALTIES, AND/OR STOP WORK NOTICES.
6. THE CONTRACTOR OR QUALIFIED CONTACT PERSON SHALL BE RESPONSIBLE FOR CLEANUP OF ALL SILT, DEBRIS, AND MUD ON AFFECTED AND ADJACENT STREET(S) AND WITHIN STORM DRAIN SYSTEM DUE TO CONSTRUCTION VEHICLES/EQUIPMENT AND CONSTRUCTION ACTIVITY AT THE END OF EACH WORKDAY.
7. THE CONTRACTOR SHALL PROTECT NEW AND EXISTING STORM WATER CONVEYANCE SYSTEMS FROM SEDIMENTATION, CONCRETE RINSE, OR OTHER CONSTRUCTION-RELATED DEBRIS AND DISCHARGES WITH THE APPROPRIATE BMPS THAT ARE ACCEPTABLE TO THE CITY RESIDENT ENGINEER AND AS INDICATED IN THE SWPPP/WPCCP.
8. THE CONTRACTOR OR QUALIFIED CONTACT PERSON SHALL CLEAR DEBRIS, SILT, AND MUD FROM ALL DITCHES AND SWALES PRIOR TO AND WITHIN 3 BUSINESS DAYS AFTER EACH RAIN EVENT OR PRIOR TO THE NEXT RAIN EVENT, WHICHEVER IS SOONER.
9. IF A NON-STORM WATER DISCHARGE LEAVES THE SITE, THE CONTRACTOR SHALL IMMEDIATELY STOP THE ACTIVITY AND REPAIR THE DAMAGES, THE CONTRACTOR SHALL NOTIFY THE CITY RESIDENT ENGINEER OF THE DISCHARGE, PRIOR TO RESUMING CONSTRUCTION ACTIVITY. ANY AND ALL WASTE MATERIAL, SEDIMENT, AND DEBRIS FROM EACH NON-STORM WATER DISCHARGE SHALL BE REMOVED FROM THE STORM DRAIN CONVEYANCE SYSTEM AND PROPERLY DISPOSED OF BY THE CONTRACTOR.
10. EQUIPMENT AND WORKERS FOR EMERGENCY WORK SHALL BE MADE AVAILABLE AT ALL TIMES. ALL NECESSARY MATERIALS SHALL BE STOCKPILED ON SITE AT CONVENIENT LOCATIONS TO FACILITATE RAPID DEPLOYMENT OF CONSTRUCTION BMPS WHEN RAIN IS IMMINENT.
11. THE CONTRACTOR SHALL RESTORE AND MAINTAIN ALL EROSION AND SEDIMENT CONTROL BMPS WORKING ORDER YEAR-ROUND.
12. THE CONTRACTOR SHALL INSTALL ADDITIONAL EROSION AND SEDIMENT CONTROL MEASURES DUE TO UNFORESEEN CIRCUMSTANCES TO PREVENT NON-STORM WATER AND SEDIMENT-LADEN DISCHARGES.
13. THE CONTRACTOR SHALL BE RESPONSIBLE AND SHALL TAKE NECESSARY PRECAUTIONS TO PREVENT PUBLIC TRESPASS ONTO AREAS WHERE IMPOUNDED WATERS CREATE A HAZARDOUS CONDITION.

14. ALL EROSION AND SEDIMENT CONTROL MEASURES PROVIDED PER THE APPROVED SWPPP/WPCCP SHALL BE INSTALLED AND MAINTAINED. ALL EROSION AND SEDIMENT CONTROLS FOR INTERIM CONDITIONS SHALL BE PROPERLY DOCUMENTED AND INSTALLED TO THE SATISFACTION OF THE CITY RESIDENT ENGINEER.

15. AS NECESSARY, THE CITY RESIDENT ENGINEER SHALL SCHEDULE MEETINGS FOR THE PROJECT TEAM (GENERAL CONTRACTOR, QUALIFIED CONTRACT PERSON, EROSION CONTROL SUBCONTRACTOR IF ANY, ENGINEER OF WORK, OWNER/DEVELOPER, AND THE CITY RESIDENT ENGINEER) TO EVALUATE THE ADEQUACY OF THE EROSION AND SEDIMENT CONTROL MEASURES AND OTHER BMPs RELATIVE TO ANTICIPATED CONSTRUCTION ACTIVITIES.

16. THE CONTRACTOR OR QUALIFIED CONTACT PERSON SHALL CONDUCT VISUAL INSPECTIONS AND MAINTAIN ALL BMPS DAILY AND AS NEEDED. VISUAL INSPECTIONS AND MAINTENANCE OF ALL BMPS SHALL BE CONDUCTED BEFORE, DURING, AND AFTER EVERY RAIN EVENT AND EVERY 24 HOURS DURING ANY PROLONGED RAIN EVENT, THE CONTRACTOR SHALL MAINTAIN AND REPAIR ALL BMPS AS SOON AS POSSIBLE AS SAFETY ALLOWS.

17. CONSTRUCTION ENTRANCE AND EXIT AREA, TEMPORARY CONSTRUCTION ENTRANCE AND EXITS SHALL BE CONSTRUCTED IN ACCORDANCE WITH CASCA FACT SHEET TC-10 R CAL TRANS-FACT SHEETTC-01 TO PREVENT TRACKING OF SEDIMENT AND OTHER POTENTIAL POLLUTANTS ONTO PAVED SURFACES AND TRAVELED WAYS. WIDTH SHALL BE 10' OR THE MINIMUM NECESSARY TO ACCOMMODATE VEHICLES AND EQUIPMENT WITHOUT BY-PASSING THE ENTRANCE, (A) NON-STORM WATER DISCHARGES SHALL BE EFFECTIVELY MANAGED PER THE SAN DIEGO MUNICIPAL CODE CHAPTER 4, ARTICLE 3, DIVISION 3 "STORM WATER MANAGEMENT AND DISCHARGE CONTROL".

- No. Date Action
- Plans Prepared For:



10590 WEST OCEAN AIR DRIVE
SUITE 300
SAN DIEGO, CA 92130

Applicant:
at&t
Your world. Delivered.
Plans Prepared By:

MH
MORRISON HERSHFIELD
5100 MACADAM AVE, SUITE 500
PORTLAND, OR 97239
Tel: 503-958-9128 Fax: 503-958-9136
www.morrisonhershfield.com

Project: **COMMUNITY CONGREGATIONAL CHURCH**
SITE ID: SS0071
2058 BERYL STREET
SAN DIEGO, CA 92109
FA: 10090957
Drawing Title:

GENERAL NOTES

Project No.: 210359800	Date: 05/06/22
Designer: SB	Drawn By: GD
Checked By: SS	PM Review: JR
Client Approval:	
Issue No.: G	GNO3



STATEMENT OF SPECIAL INSPECTIONS


1. THE OWNER OR REGISTERED DESIGN PROFESSIONAL OF RECORD WILL EMPLOY THE SERVICES OF ONE OR MORE SPECIAL INSPECTORS TO PROVIDE SPECIAL INSPECTIONS DURING CONSTRUCTION FOR THE ITEMS IN THE SPECIAL INSPECTION TABLE BELOW.
2. THE SPECIAL INSPECTOR SHALL BE A QUALIFIED PERSON WHO SHALL DEMONSTRATE COMPETENCE, TO THE SATISFACTION OF THE BUILDING OFFICIAL AND THE REGISTERED DESIGN PROFESSIONAL RESPONSIBLE FOR THE DESIGN OF THE STRUCTURE, FOR INSPECTION OF THE PARTICULAR TYPE OF CONSTRUCTION OR OPERATION REQUIRING SPECIAL INSPECTION.
3. DUTIES AND RESPONSIBILITIES OF THE SPECIAL INSPECTOR:
 - 3.1. THE SPECIAL INSPECTOR SHALL OBSERVE THE WORK ASSIGNED FOR CONFORMANCE WITH THE APPROVED DESIGN DRAWINGS AND SPECIFICATIONS. THE INSPECTOR MAY NOT ALTER, MODIFY, ENLARGE OR WAIVE ANY OF THE REQUIREMENTS OF THE DOCUMENTS.
 - 3.2. THE SPECIAL INSPECTOR SHALL FURNISH INSPECTION REPORTS TO THE BUILDING OFFICIAL, THE PROFESSIONAL OF RECORD, AND THE CONTRACTOR. ALL DISCREPANCIES SHALL BE BROUGHT TO THE IMMEDIATE ATTENTION OF THE CONTRACTOR FOR CORRECTION. THEN, IF UNCORRECTED, SUBMIT A COMPLETE LIST OF ALL OUTSTANDING DISCREPANCIES ON A WEEKLY BASIS TO THE OWNER, THE BUILDING OFFICIAL, AND THE PROFESSIONAL OF RECORD UNTIL ALL CORRECTIONS HAVE BEEN COMPLETED.
 - 3.3. THE SPECIAL INSPECTOR SHALL SUBMIT A FINAL SIGNED REPORT STATING WHETHER THE WORK REQUIRING SPECIAL INSPECTION WAS, TO THE BEST OF THE INSPECTOR'S KNOWLEDGE, IN CONFORMANCE WITH THE APPROVED PLANS AND SPECIFICATIONS AND THE APPLICABLE WORKMANSHIP PROVISIONS OF THE CODE.
 - 3.4. WHERE SPECIAL INSPECTION REQUIREMENTS DUPLICATE THE REQUIREMENTS OF SPECIFIED QUALITY ASSURANCE TESTING, DUPLICATE INSPECTIONS SHALL NOT BE REQUIRED.
 5. OBSERVATIONS OR SITE VISITS PERFORMED BY THE ENGINEER OR ARCHITECT DUE NOT CONSTITUTE SPECIAL INSPECTIONS.
 6. THE CONTRACTOR SHALL PROVIDE ADEQUATE NOTIFICATION OF SCHEDULE OF WORK REQUIRING INSPECTION OR TESTING TO THE SPECIAL INSPECTION TO ALLOW COORDINATION.
 7. THE MATERIALS, SYSTEMS, COMPONENTS AND WORK REQUIRED TO HAVE SPECIAL INSPECTION OR TESTING ARE OUTLINED ON THESE DRAWINGS ALONG WITH THE TYPE AND EXTENT OF EACH INSPECTION AND TEST AND WHETHER IT IS CONTINUOUS OR PERIODIC IN NATURE. IF IT IS NOT INDICATED OTHERWISE, INSPECTION SHALL BE CONTINUOUS.
 8. EACH CONTRACTOR RESPONSIBLE FOR THE CONSTRUCTION OF A MAIN WINDOR SEISMIC-FORCE-RESISTING SYSTEM, DESIGNATED SEISMIC SYSTEM OR A WIND- OR SEISMIC-RESISTING COMPONENT SHALL PROVIDE A WRITTEN STATEMENT OF RESPONSIBILITY TO THE OWNER AND THE BUILDING OFFICIAL PRIOR TO COMMENCEMENT OF WORK ON THE SYSTEM OR COMPONENT AS REQUIRED BY CBC SECTION 1709.
 9. NOTICE TO THE APPLICANT/OWNER/OWNER'S AGENT/ARCHITECT OR ENGINEER OF RECORD: BY USING THIS PERMITTED CONSTRUCTION DRAWINGS FOR CONSTRUCTION/INSTALLATION OF THE WORK SPECIFIED HEREIN, YOU AGREE TO COMPLY WITH THE REQUIREMENTS OF CITY OF SAN DIEGO FOR SPECIAL INSPECTIONS, STRUCTURAL OBSERVATIONS, CONSTRUCTION MATERIAL TESTING AND OFF-SITE FABRICATION OF BUILDING COMPONENTS, CONTAINED IN THE STATEMENT OF SPECIAL INSPECTIONS AND, AS REQUIRED BY THE CALIFORNIA CONSTRUCTION CODES.
 10. NOTICE TO THE CONTRACTOR/BUILDER/INSTALLER/SUB-CONTRACTOR/OWNER-BUILDER: BY USING THIS PERMITTED CONSTRUCTION DRAWINGS FOR CONSTRUCTION/INSTALLATION OF THE WORK SPECIFIED HEREIN, YOU ACKNOWLEDGE AND ARE AWARE OF, THE REQUIREMENTS CONTAINED IN THE STATEMENT OF SPECIAL INSPECTIONS. YOU AGREE TO COMPLY WITH THE REQUIREMENTS OF CITY OF SAN DIEGO FOR SPECIAL INSPECTIONS, STRUCTURAL OBSERVATIONS, CONSTRUCTION MATERIAL TESTING AND OFF-SITE FABRICATION OF BUILDING COMPONENTS, CONTAINED IN THE STATEMENT OF SPECIAL INSPECTIONS AND, AS REQUIRED BY THE CALIFORNIA CONSTRUCTION CODES.
 11. THE SPECIAL INSPECTOR MUST BE REGISTERED BY THE CITY OF SAN DIEGO, DEVELOPMENT SERVICES, IN THE CATEGORY OF WORK REQUIRED TO HAVE SPECIAL INSPECTION.
 12. THE CONSTRUCTION MATERIALS TESTING LABORATORY MUST BE APPROVED BY THE CITY OF SAN DIEGO, DEVELOPMENT SERVICES, FOR TESTING OF MATERIALS, SYSTEMS, COMPONENTS AND EQUIPMENT.
 13. OFFSITE FABRICATOR MUST BE APPROVED BY THE CITY OF SAN DIEGO, DEVELOPMENT SERVICES FOR THE FABRICATION OF MEMBERS AND ASSEMBLIES ON THE PREMISES OF THE FABRICATOR'S SHOP.
 14. OFFSITE FABRICATOR SHALL SUBMIT AN 'APPLICATION TO PERFORM OFF-SITE FABRICATION' TO THE INSPECTION SERVICES DIVISION FOR APPROVAL PRIOR TO COMMENCEMENT OF FABRICATION."
 15. OFFSITE FABRICATOR SHALL SUBMIT A 'CERTIFICATE OF COMPLIANCE FOR OFF-SITE FABRICATION' TO THE INSPECTION SERVICES DIVISION PRIOR TO ERECTION OF FABRICATED ITEMS AND ASSEMBLIES.

16. THE SPECIAL INSPECTIONS IDENTIFIED ON PLANS ARE, IN ADDITION TO, AND NOT A SUBSTITUTE FOR, THOSE INSPECTIONS REQUIRED TO BE PERFORMED BY A CITY'S BUILDING INSPECTOR.
17. SPECIAL INSPECTIONS, STRUCTURAL TESTS AND STRUCTURAL OBSERVATIONS SHALL COMPLY WITH THE APPLICABLE PROVISIONS OF THE 2019 CBC, CHAPTER 17, SPECIAL INSPECTIONS AND TESTS.
18. PER CALIFORNIA BUILDING CODE, CHAPTER 1704, SPECIAL INSPECTION OF EPOXY ANCHORAGE SHALL BE REQUIRED. HOLES SHALL BE DRILLED AND CLEANED IN ACCORDANCE WITH MANUFACTURER INSTRUCTIONS. EPOXY SHALL BE INSTALLED AND SET WITH ANCHOR IN HOLE. SPECIAL INSPECTOR SHALL BE PRESENT TO VERIFY THE HOLE IS CLEAN AND EPOXY INSTALLED IN ACCORDANCE WITH MANUFACTURER INSTRUCTIONS.

WORK REQUIRING SPECIAL INSPECTION	ITEM DESCRIPTION AND LOCATION	DESIGN STRENGTH	NAME OF SPECIAL INSPECTOR	PHONE NUMBER OF SPECIAL INSPECTOR
SPECIAL INSPECTIONS REQUIRED BY CBC SECTION 1705 *FOR R3 AND U OCCUPANCIES ACCESSORY TO RESIDENTIAL OCCUPANCIES				
SPECIAL INSPECTION IS NOT REQUIRED FOR: ITEMS 1b, 2a (WHEN $f_c \leq 3,000$ psi), 2c, 3a (WHEN $f_m \leq 1,500$ psi), and 3b (WHEN WALL HEIGHT IS ≤ 10 FT.).				
STRUCTURAL OBSERVATION IS PERMITTED IN LIEU OF SPECIAL INSPECTION FOR: ITEMS 1d, 3a, 3b (WHEN WALL HEIGHT IS > 10 FT.), 4a, AND 4b.				
1. Steel Construction a. Field welding b. Steel frame*				G 05/24/23 JX COMMENTS
c. High-strength bolts d. Cold-formed steel framing*				F 11/14/22 CLIENT COMMENTS
2. Concrete Construction a. $f_c > 2,500$ psi*				E 08/17/22 CLIENT COMMENTS
b. Post Installed Anchors	HILTIKWIK BOLTZ SS @ NEW BATTERY CABINET & POWER PLANT IN EQUIPMENT COMPOUND	1340 LB MIN (SHEAR) 1450 LB MIN (PULL-OUT)	ROBERT MOTINGER	B 06/07/22 JX COMMENTS
c. Structural slabs*				No. Date Action
d. Pre-stressed / post-tensioned slabs				
3. Masonry Construction a. Masonry walls*				
b. Site walls other than County Standard plans*				
4. Wood Construction a. High-load diaphragms*				
b. Structural wood: Nailing, bolting, anchoring and other fastening of components within their lateral force-resisting system where fastener spacing of sheathing is 4 inches o.c. or less*				
5. Foundations a. Driven deep foundations b. Cast-in-place deep foundations c. Helical pile foundations				
6. Sprayed fire-resistant materials				
7. Masonic and intumescent fire-resistant coatings				
8. Exterior insulation and finish systems (EIFS)				
9. Fire-resistant penetrations and joints in Risk Category III or IV buildings				
10. Smoke control systems				
11. Installation and anchorage of mechanical and electrical components				
a. Electrical equipment for emergency standby power systems				
b. Other electrical equipment in structures in Seismic Design Category E or F				
c. Piping systems or ductwork designed to carry hazardous materials				
d. Vibration isolation systems with 1/4 inch or less clearance required between support frame and restraint				
12. Storage racks				
13. Seismic isolation systems				

PDS 006 REV: 01/01/2017

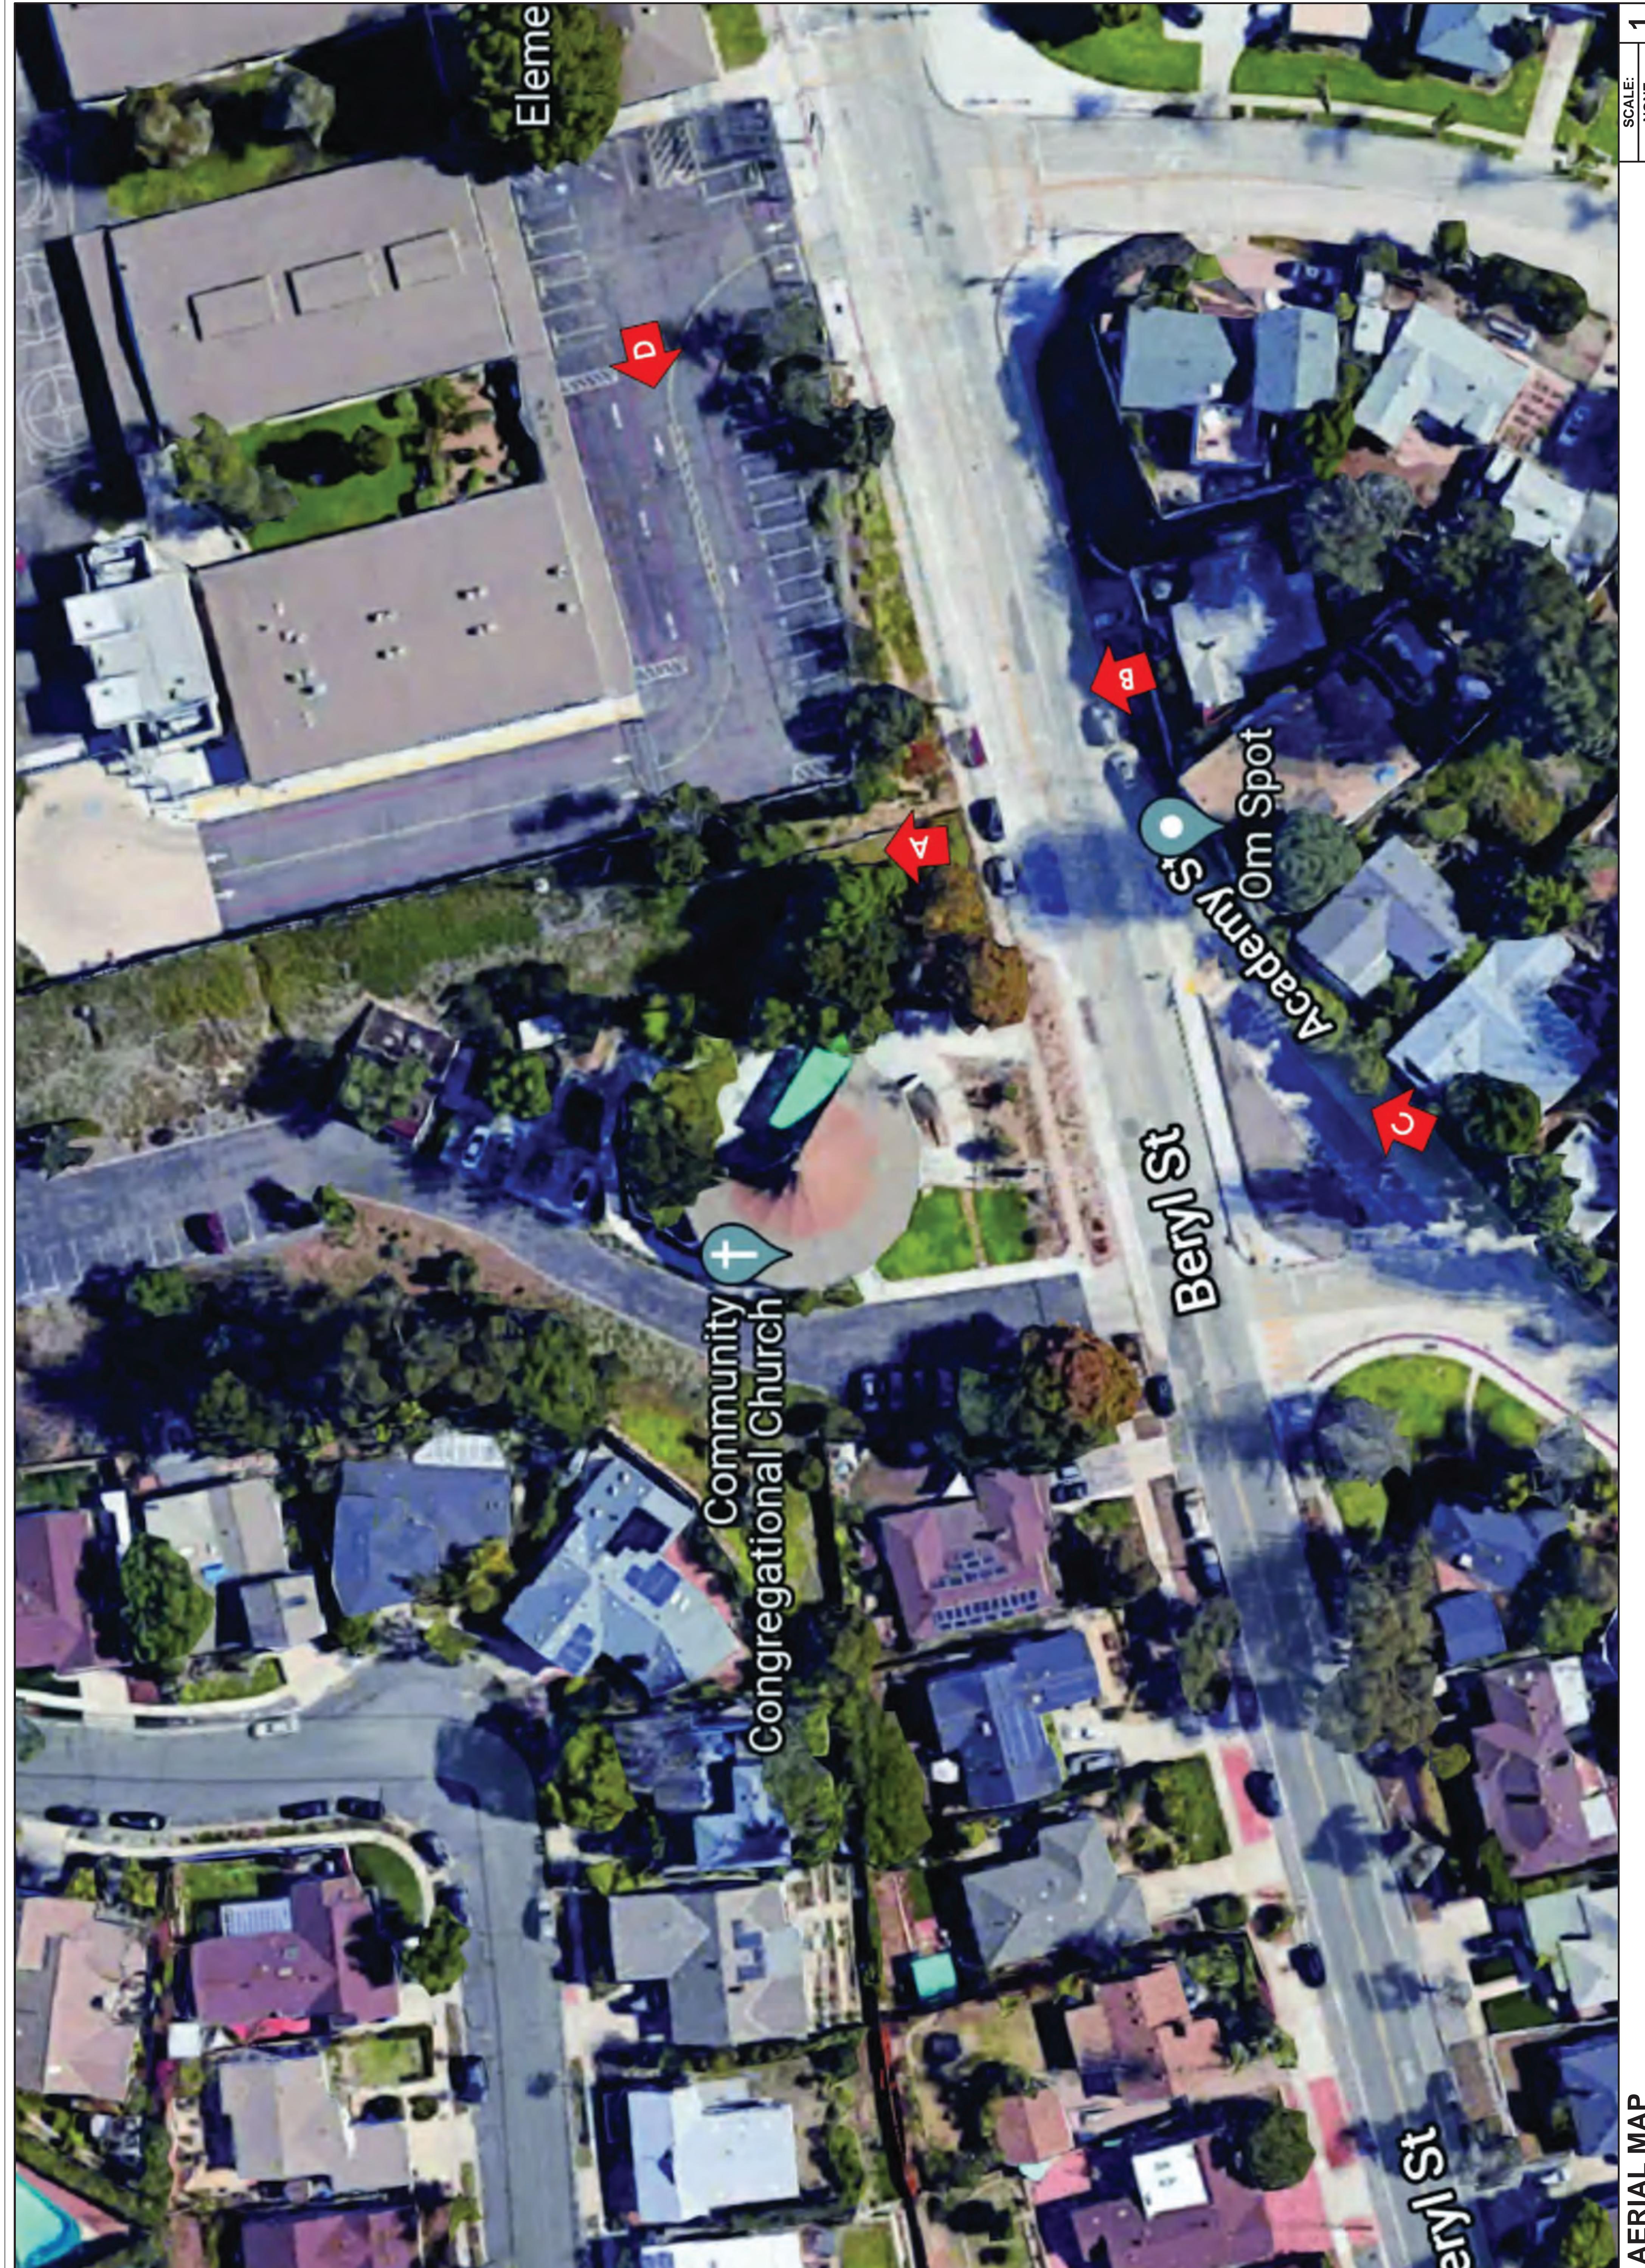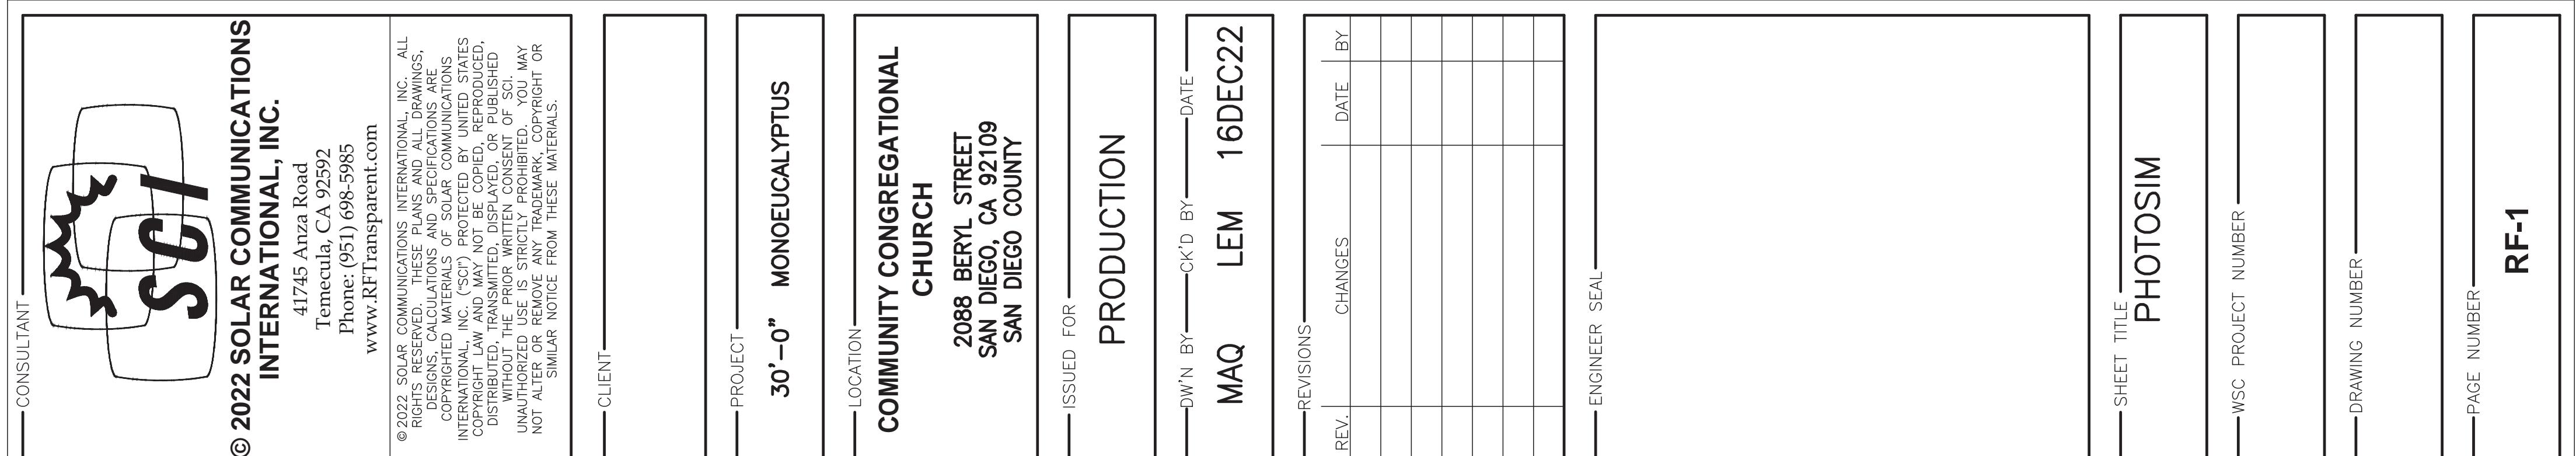

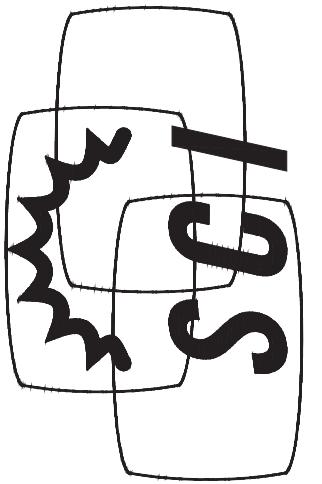
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	41745 Anza Road Temecula, CA 92592 Phone: (951) 698-5985 www.RTRtransparent.com	PROJECT 30'-0" MONOEUCALYPTUS	LOCATION COMMUNITY CONGREGATIONAL CHURCH 2088 BERYL STREET SAN DIEGO, CA 92109 SAN DIEGO COUNTY
CLIENT _____	ISSUED FOR PRODUCTION	DW/N BY _____ CK'D BY _____ DATE _____ MAQ LEM 16DEC22	REVISIONS REV. CHANGES DATE BY _____
ENGINEER SEAL _____		SHEET TITLE PHOTOSIM	
		WSC PROJECT NUMBER _____	
		DRAWING NUMBER _____	
		PAGE NUMBER _____	
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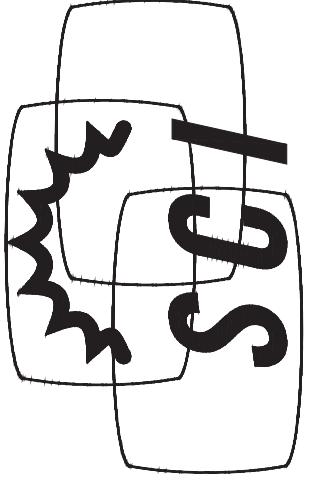


PROPOSED VIEW-A

EXISTING VIEW-A

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LOCATION	COMMUNITY CONGREGATIONAL CHURCH 2088 BERYL STREET SAN DIEGO, CA 92109 SAN DIEGO COUNTY																																		
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PAGE 3		PAGE 2																																	

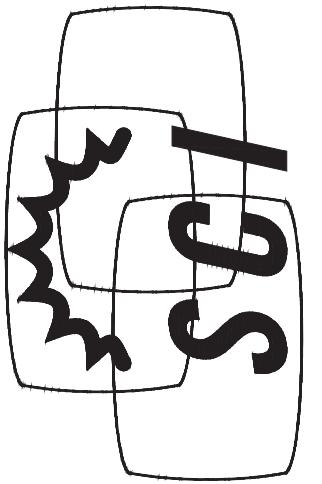



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-CLIENT

— PROJECT — **MONOEUCALYPTUS**
30' - 0"

COMMUNITY CONGREGATIONAL CHURCH

2008 BERYL STREET
SAN DIEGO, CA 92110
SAN DIEGO COUNTY

ISSUED FOR -

PRODUCTION

MAQ

REV. C

EIGENVALUES

SHEET TITLE _____
PHOTOSIM

— WSC PROJECT NUMBER


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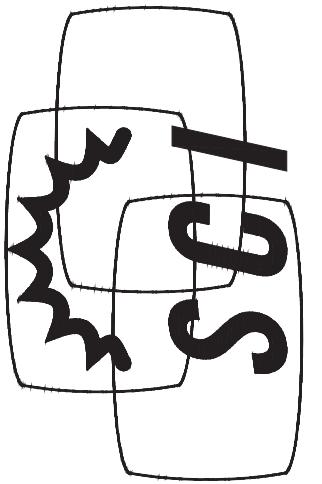
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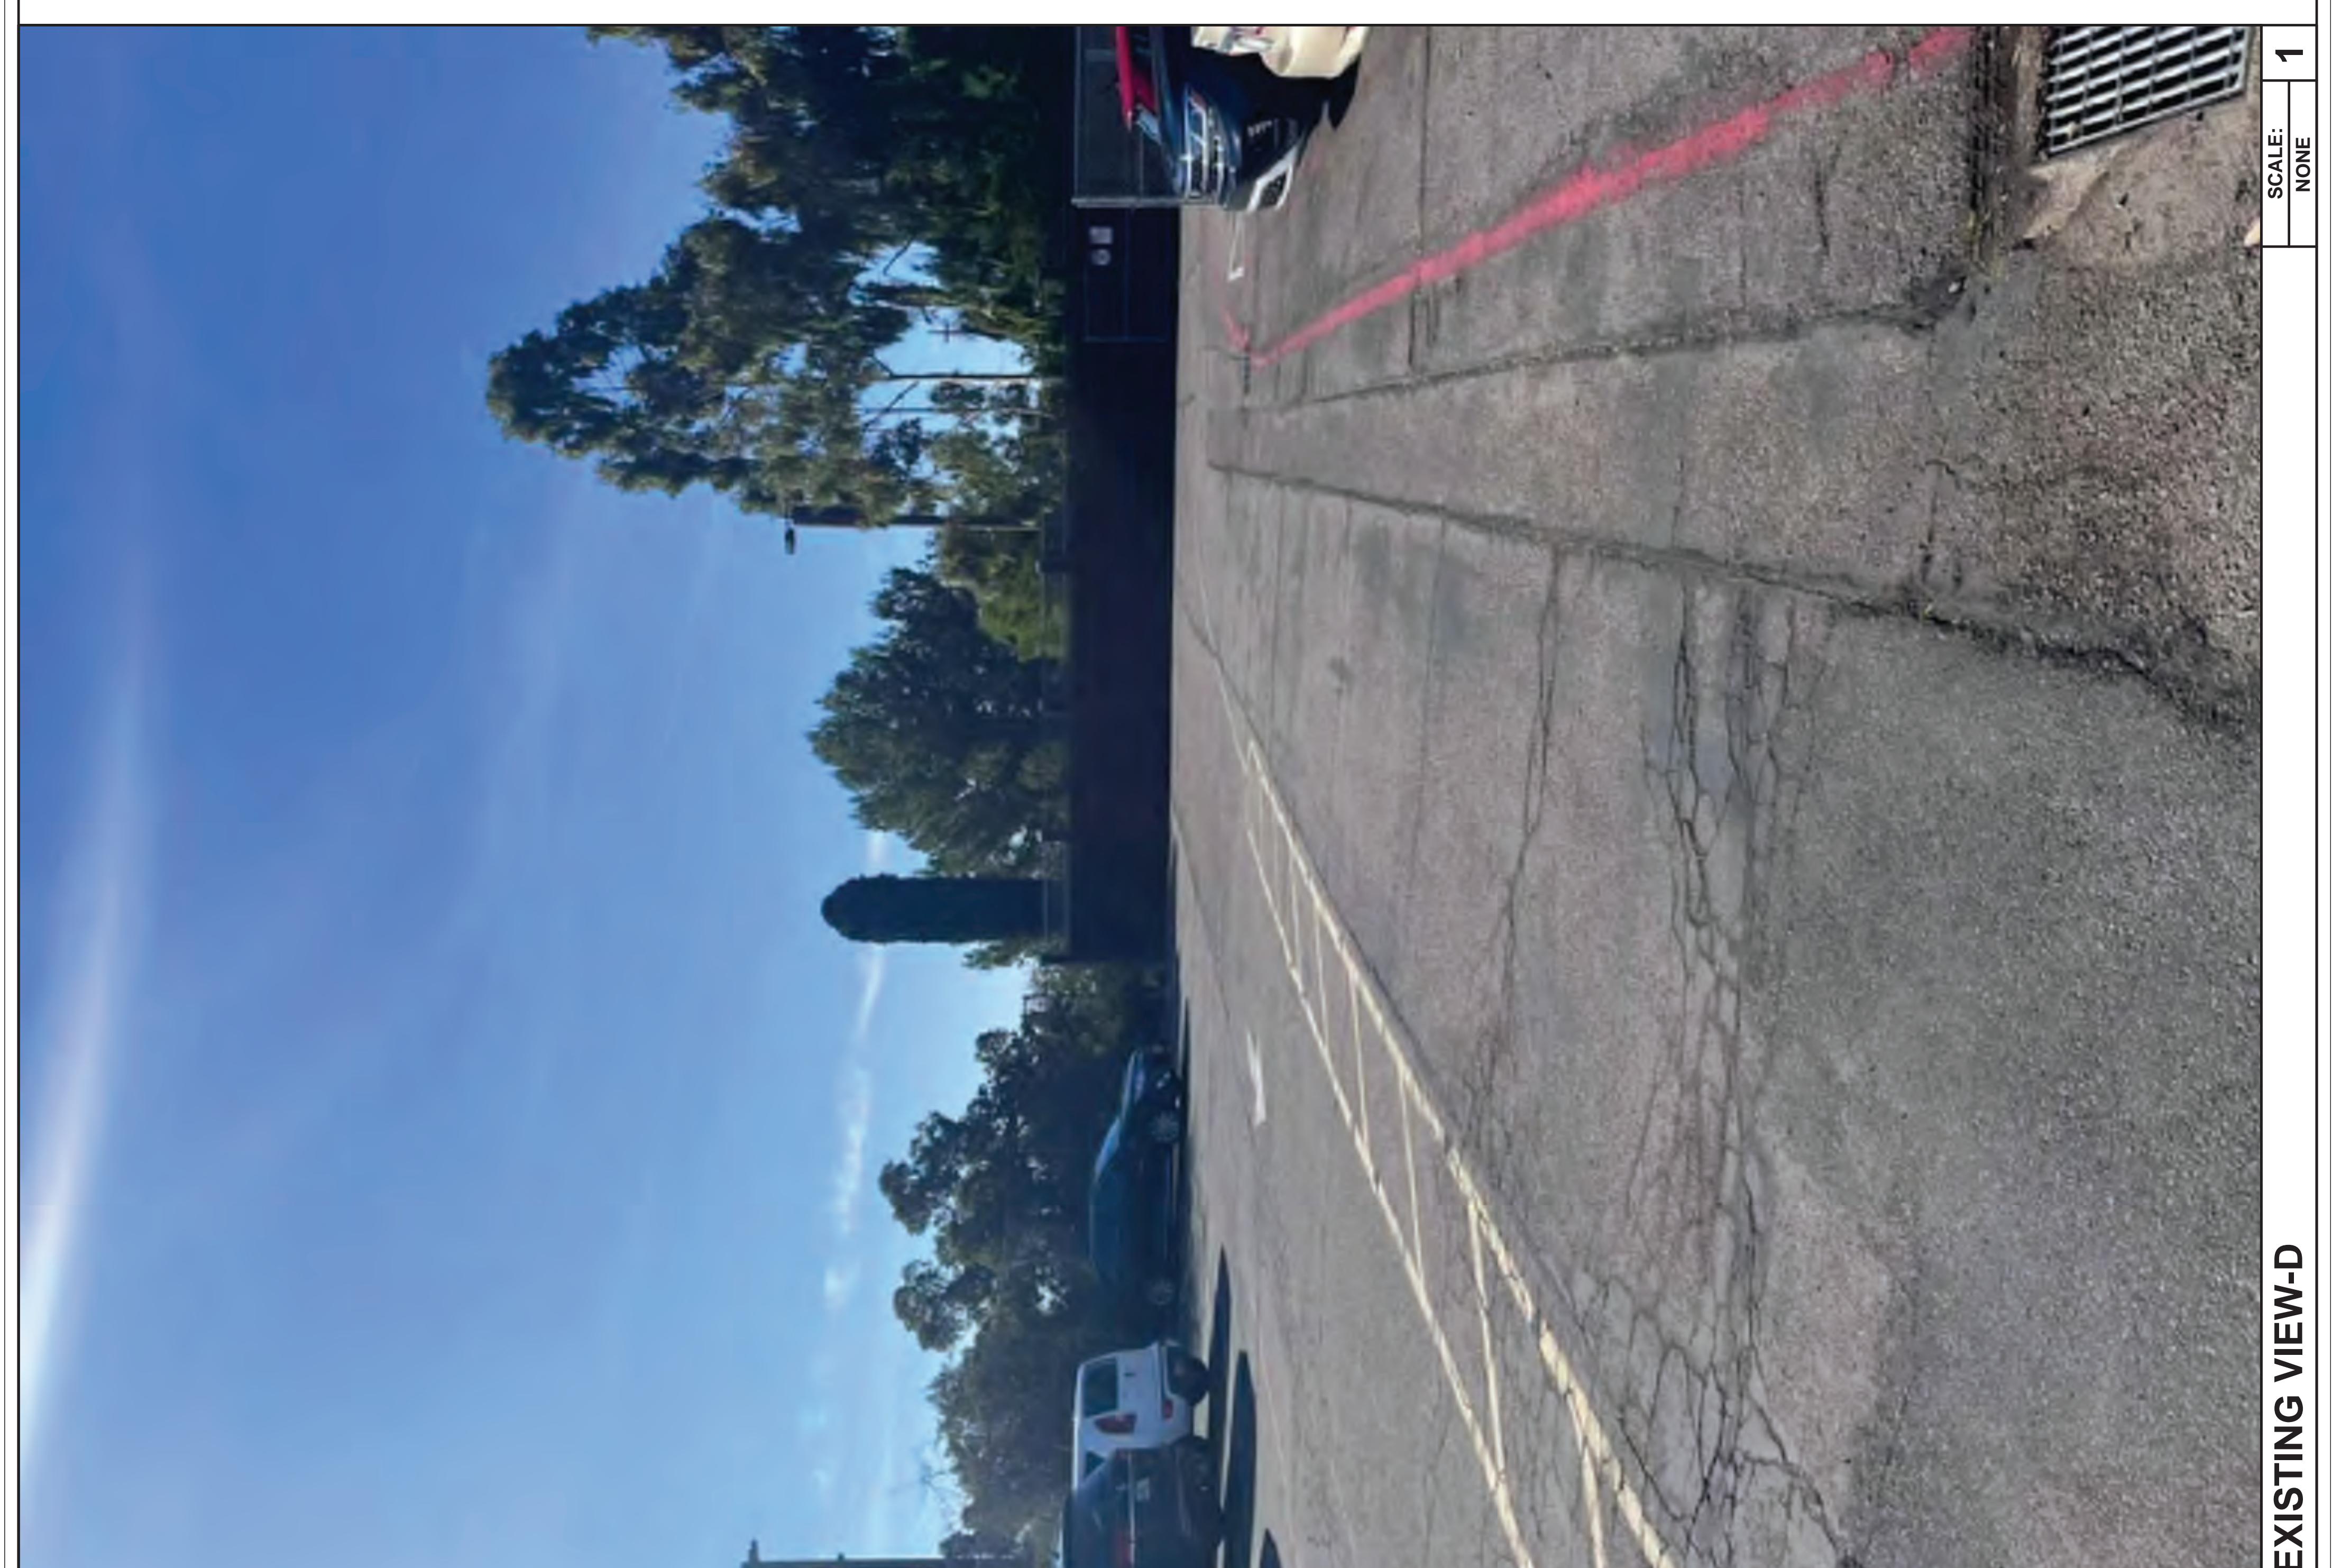
PROPOSED VIEW-C

2

EXISTING VIEW-C




 <p>SCI</p> <p>CONSULTANT</p>		<p>© 2022 SOLAR COMMUNICATIONS INTERNATIONAL, INC.</p> <p>41745 Anza Road Temecula, CA 92592 Phone: (951) 698-5985 www.RTRtransparent.com</p>	
<p>CLIENT _____</p>		<p>PROJECT _____</p>	
<p>LOCATION _____</p>		<p>30'-0" MONOEUCALYPTUS</p>	
<p>COMMUNITY CONGREGATIONAL CHURCH</p> <p>2088 BERYL STREET SAN DIEGO, CA 92109 SAN DIEGO COUNTY</p>		<p>ISSUED FOR PRODUCTION</p>	
<p>DW/N BY _____ CK'D BY _____ DATE _____</p>		<p>REV. CHANGES DATE BY</p> <p>MAQ LEM 16DEC22</p>	
<p>ENGINEER SEAL _____</p>		<p>SHEET TITLE PHOTOSIM</p>	
<p>WSC PROJECT NUMBER _____</p>		<p>DRAWING NUMBER _____</p>	
<p>PAGE NUMBER _____</p>		<p>SCALE: 2</p>	
		<p>RF-5</p>	

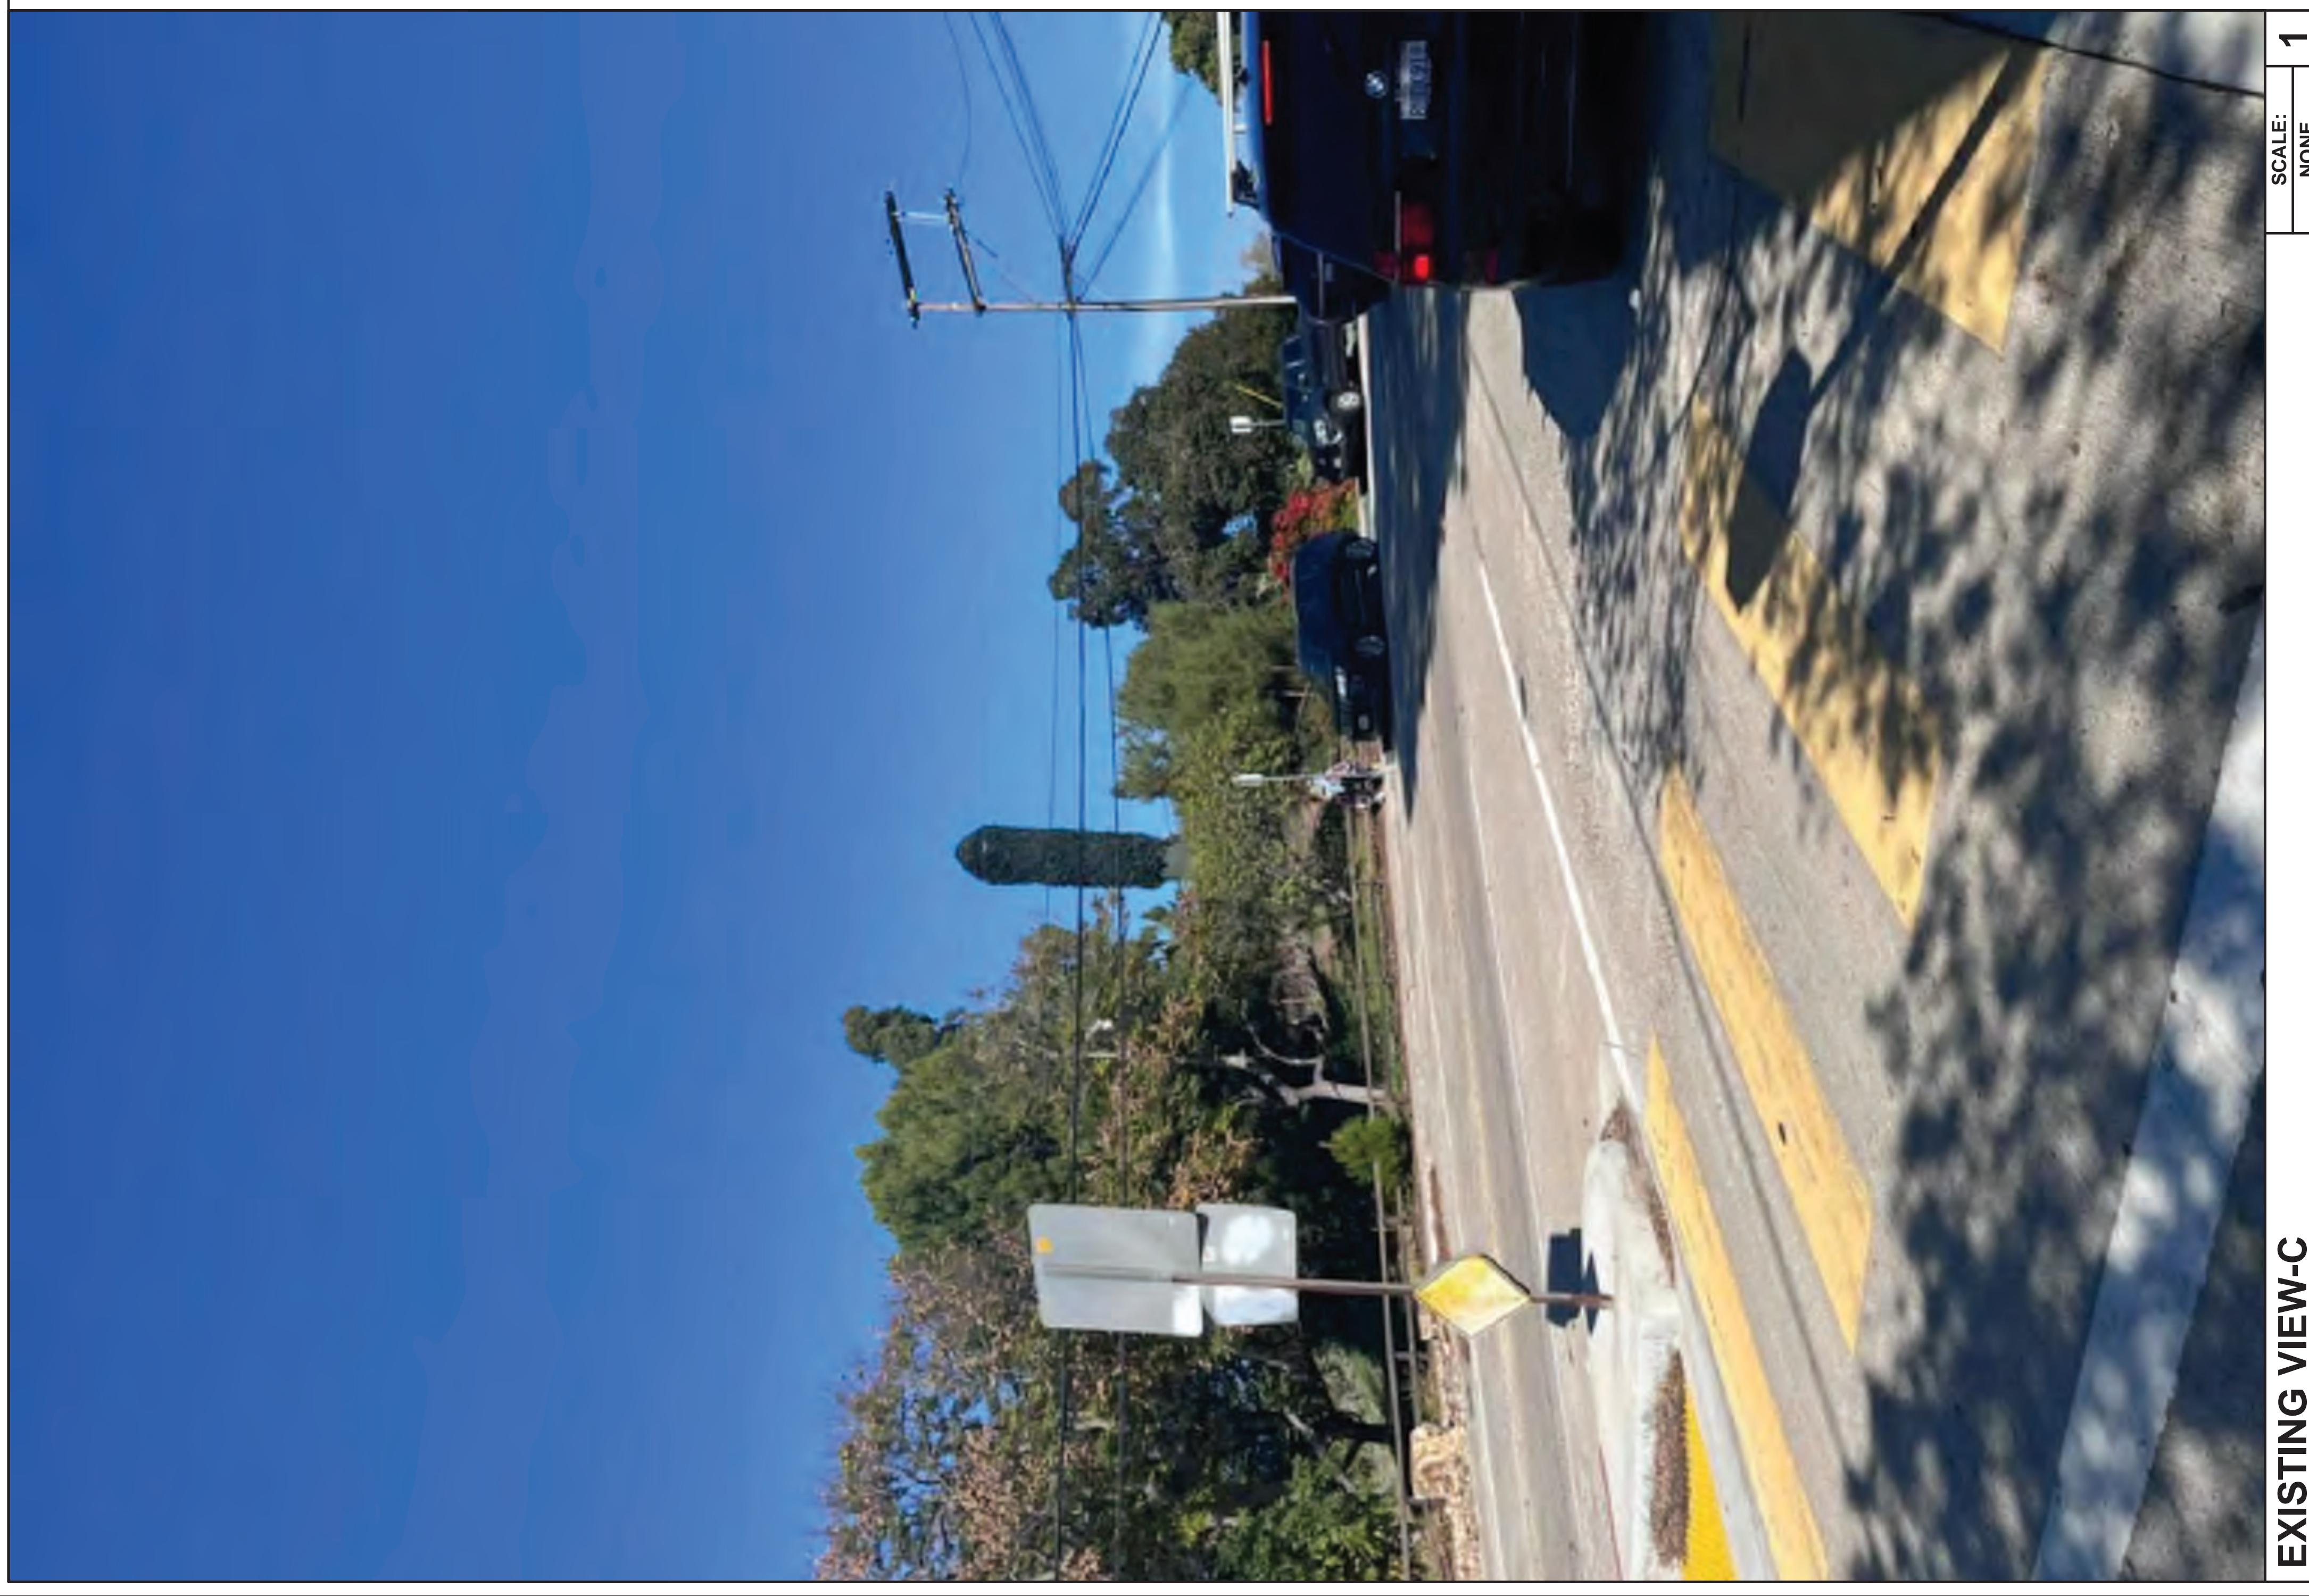

Silt Fence

SE-1

SE-1

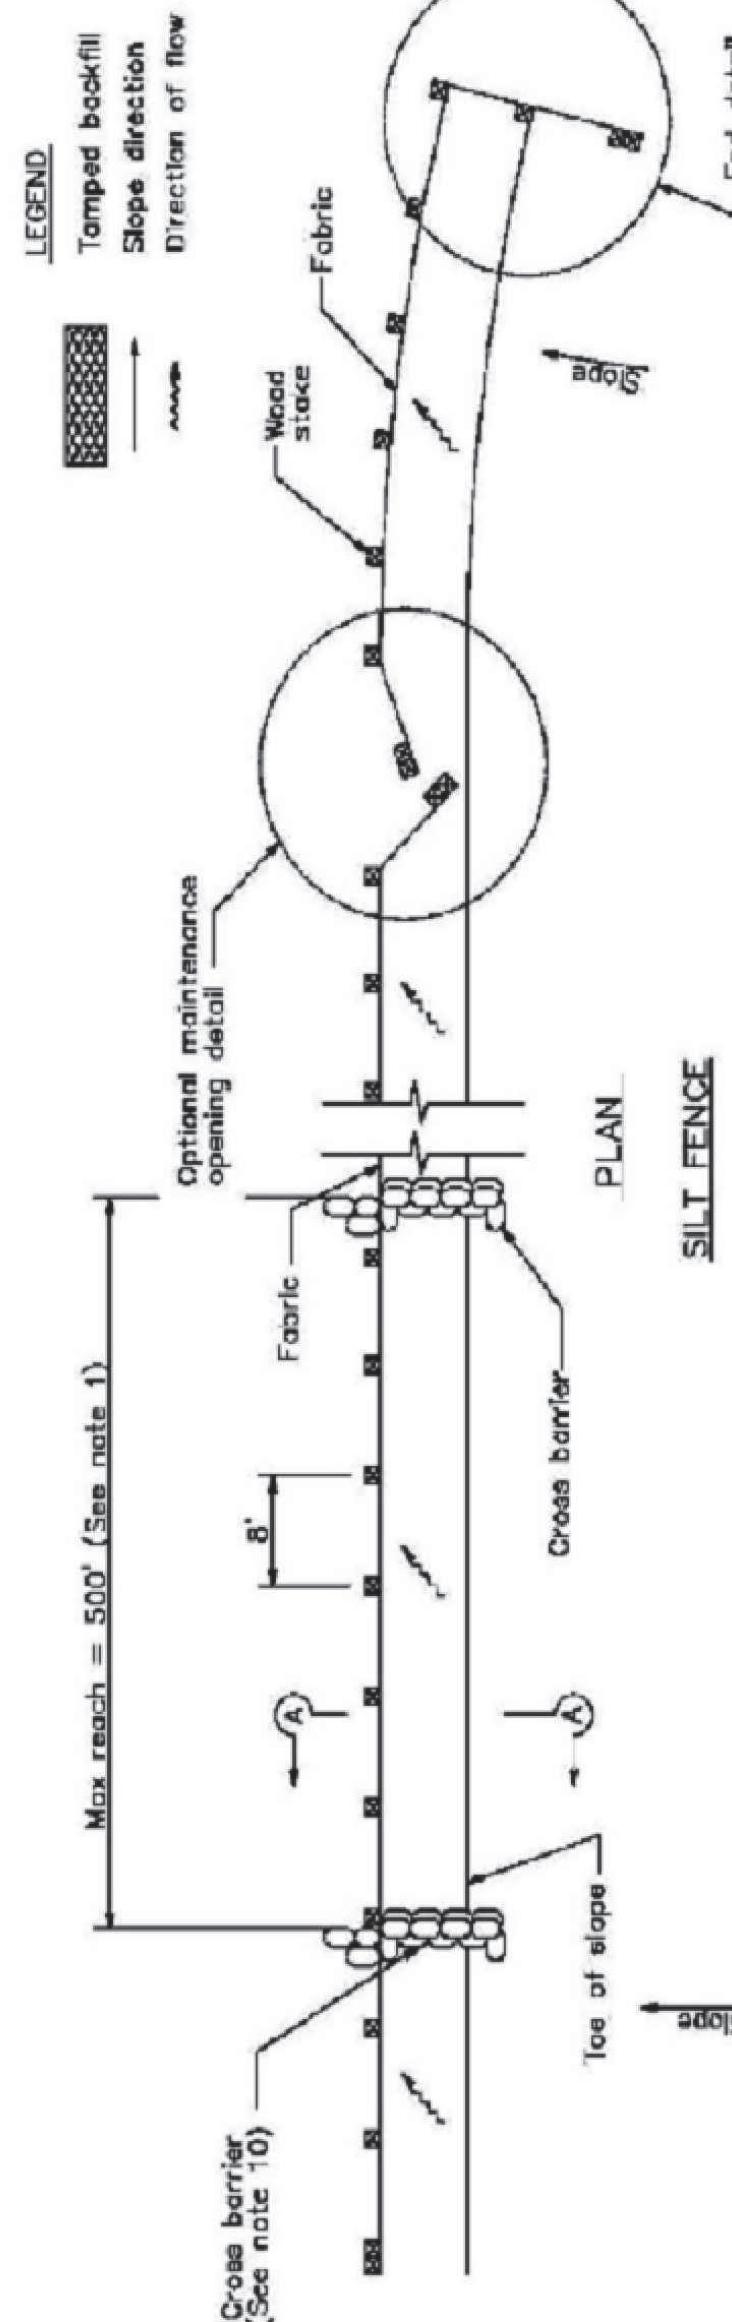

NOTES

- Construct the length of each reach so that the change in base barrier, in no case shall the reach length exceed 1/3 the height of the linear elevation along the reach does not exceed 1/3 the height of the linear elevation.
- The last 8'-0" of fence shall be turned up slope.
- Stake dimensions are nominal.
- Dimension may vary to fit field condition.
- Stakes shall be spaced at 8'-0" maximum and shall be positioned on downstream side of fence.
- Stakes to overlap and fence fabric to fold around each stake one full turn. Secure fabric to stake with 4 staples.
- Stakes shall be driven lightly (tighter to prevent potential pull-through or settlement of joints).
- Fence and stakes, fence fabric shall be folded around two stakes one full turn and secured with 4 staples.
- Minimum 4 staples per stake. Dimensions shown are typical.
- Cross barriers shall be a minimum of 1/3 and a maximum of 1/2 the height of the linear barrier.
- Maintenance openings shall be constructed in a manner to ensure sufficient room behind all fence.
- Joining sections shall not be placed at sump locations.
- Sanction rows and layers shall be offset to eliminate gaps.
- Add 3-4 bags to cross barrier on downgradient side of silt fence as needed to prevent bypass or undermining and as allowable based on site limits of disturbance.

July 2012

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DO NOT SCALE DRAWINGS. CONTRACTOR MUST VERIFY ALL DIMENSIONS AND ADVISE CONSULTANTS OF ANY VARIATIONS OR CHANGES IN ELEVATION. THIS DRAWING IS FOR INFORMATION ONLY AND SHOULD NOT BE IMPLEMENTED DIRECTLY PRIOR TO PROJECT APPROVAL. ALL PREVIOUS ISSUES OF THIS DRAWING ARE SUPERSEDED BY THE LATEST REVISION. REMAIN IN PROPERTY OF MORRISON HERSHFIELD. CONTRACTOR TO NOTIFY MORRISON HERSHFIELD OF CONSTRUCTION ACTIVITIES AND HAVE THEM BE PROVIDED CONSTRUCTION REVIEW OF THIS PROJECT.

G 05/24/23 JX COMMENTS


F 11/14/22 CLIENT COMMENTS
E 08/17/22 CLIENT COMMENTS
D 06/29/22 CLIENT COMMENTS
C 06/15/22 CLIENT COMMENTS
B 06/07/22 JX COMMENTS

No. Date Action

Plans Prepared For:

MD7
10590 WEST OCEAN AIR DRIVE
SUITE 300
SAN DIEGO, CA 92130

Applicant:

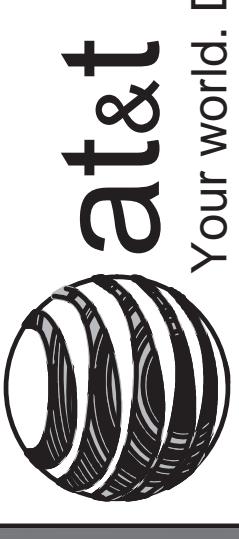


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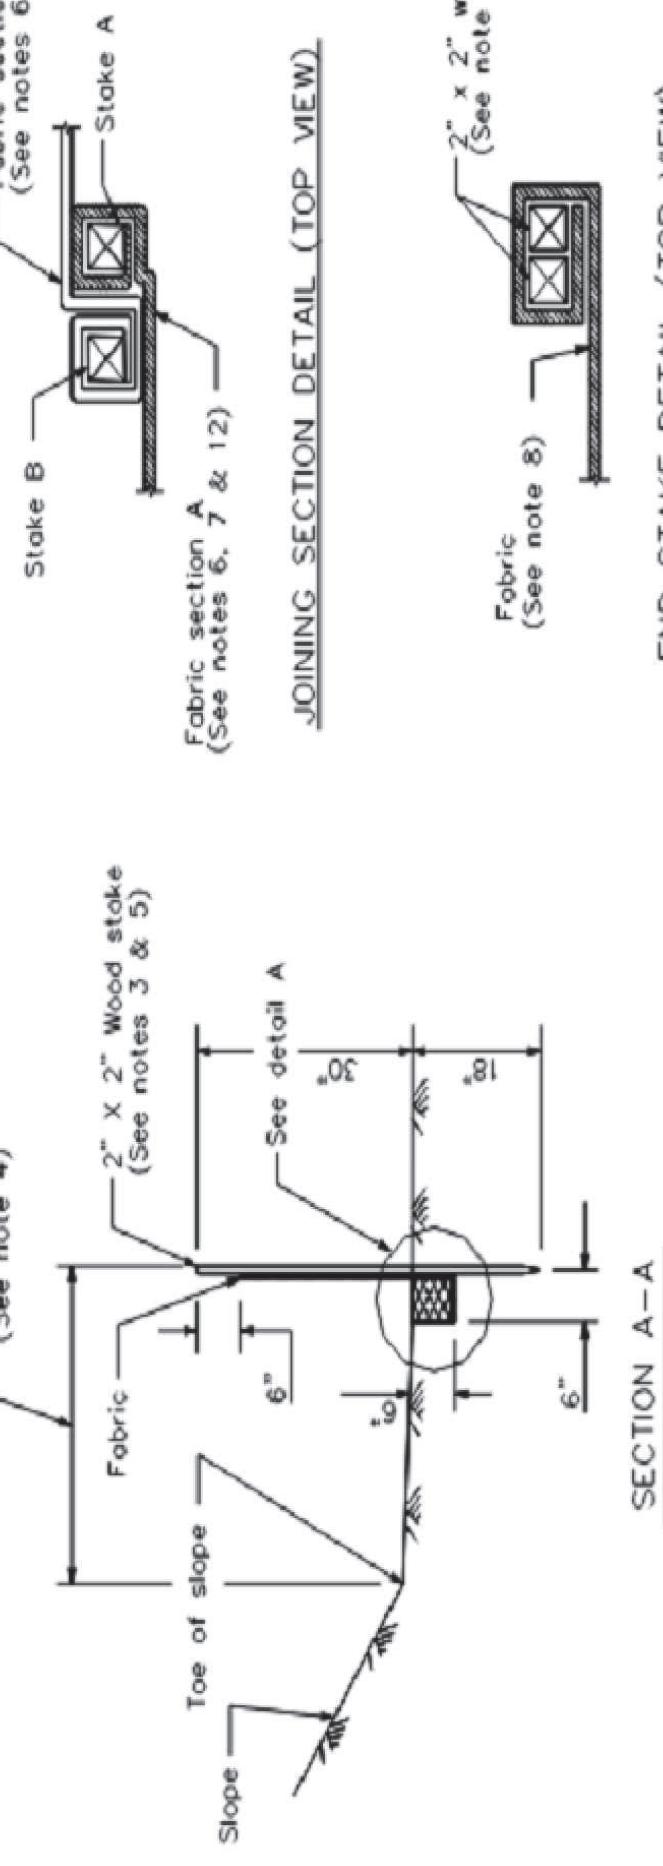
Silt Fence

SE-1

SE-1



SECTION C-C

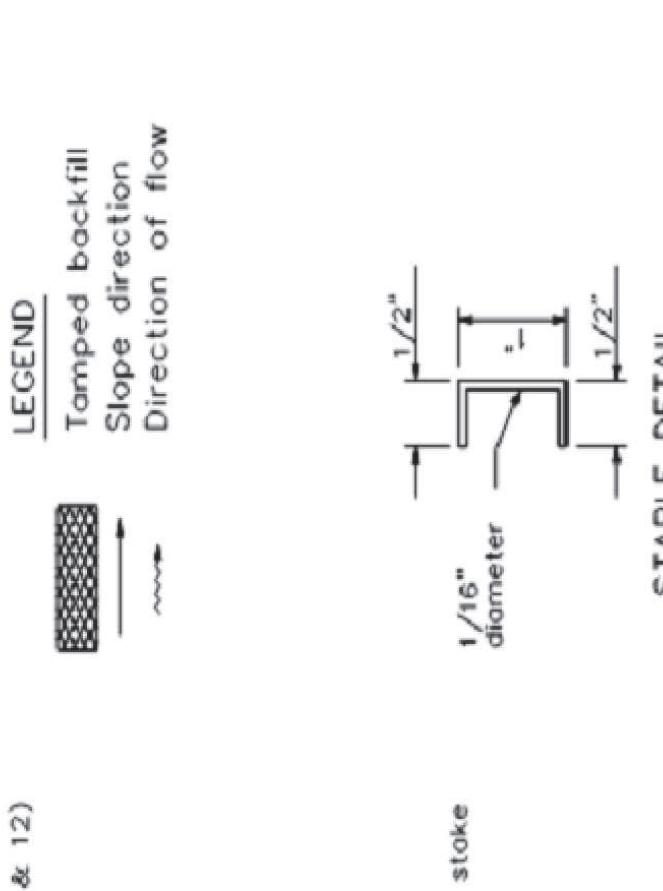

END STAKE DETAIL (TOP VIEW)

(SEE NOTE 9)

SECTION A-A

(SEE NOTE 4)

SETBACK VORIES

(SEE NOTE 4)


TOE OF SLOPE

SLOPE

SECTION A-A

DETAIL A


END DETAIL

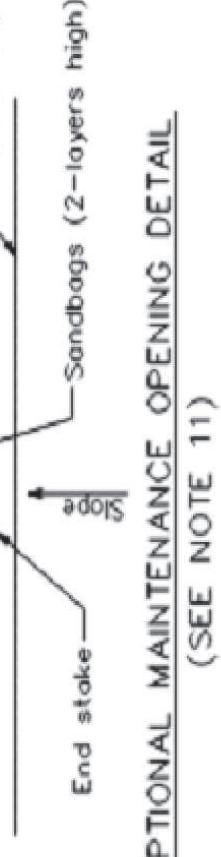

Silt Fence

SE-1

SE-1

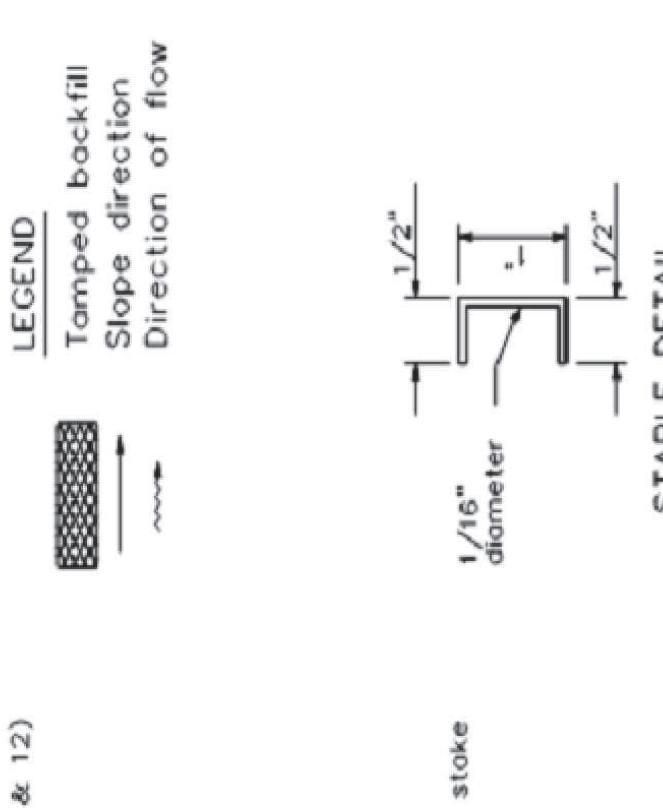

STAKE DETAIL (SEE NOTE 9)

(SEE NOTE 9)

STAKE DETAIL (SEE NOTE 9)

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STAKE DETAIL (SEE NOTE 9)

(SEE NOTE 9)

STAKE DETAIL (SEE NOTE 9)

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STAKE DETAIL (SEE NOTE 9)

(SEE NOTE 9)

STAKE DETAIL (SEE NOTE 9)

(SEE NOTE 9)

SILT FENCE DETAIL

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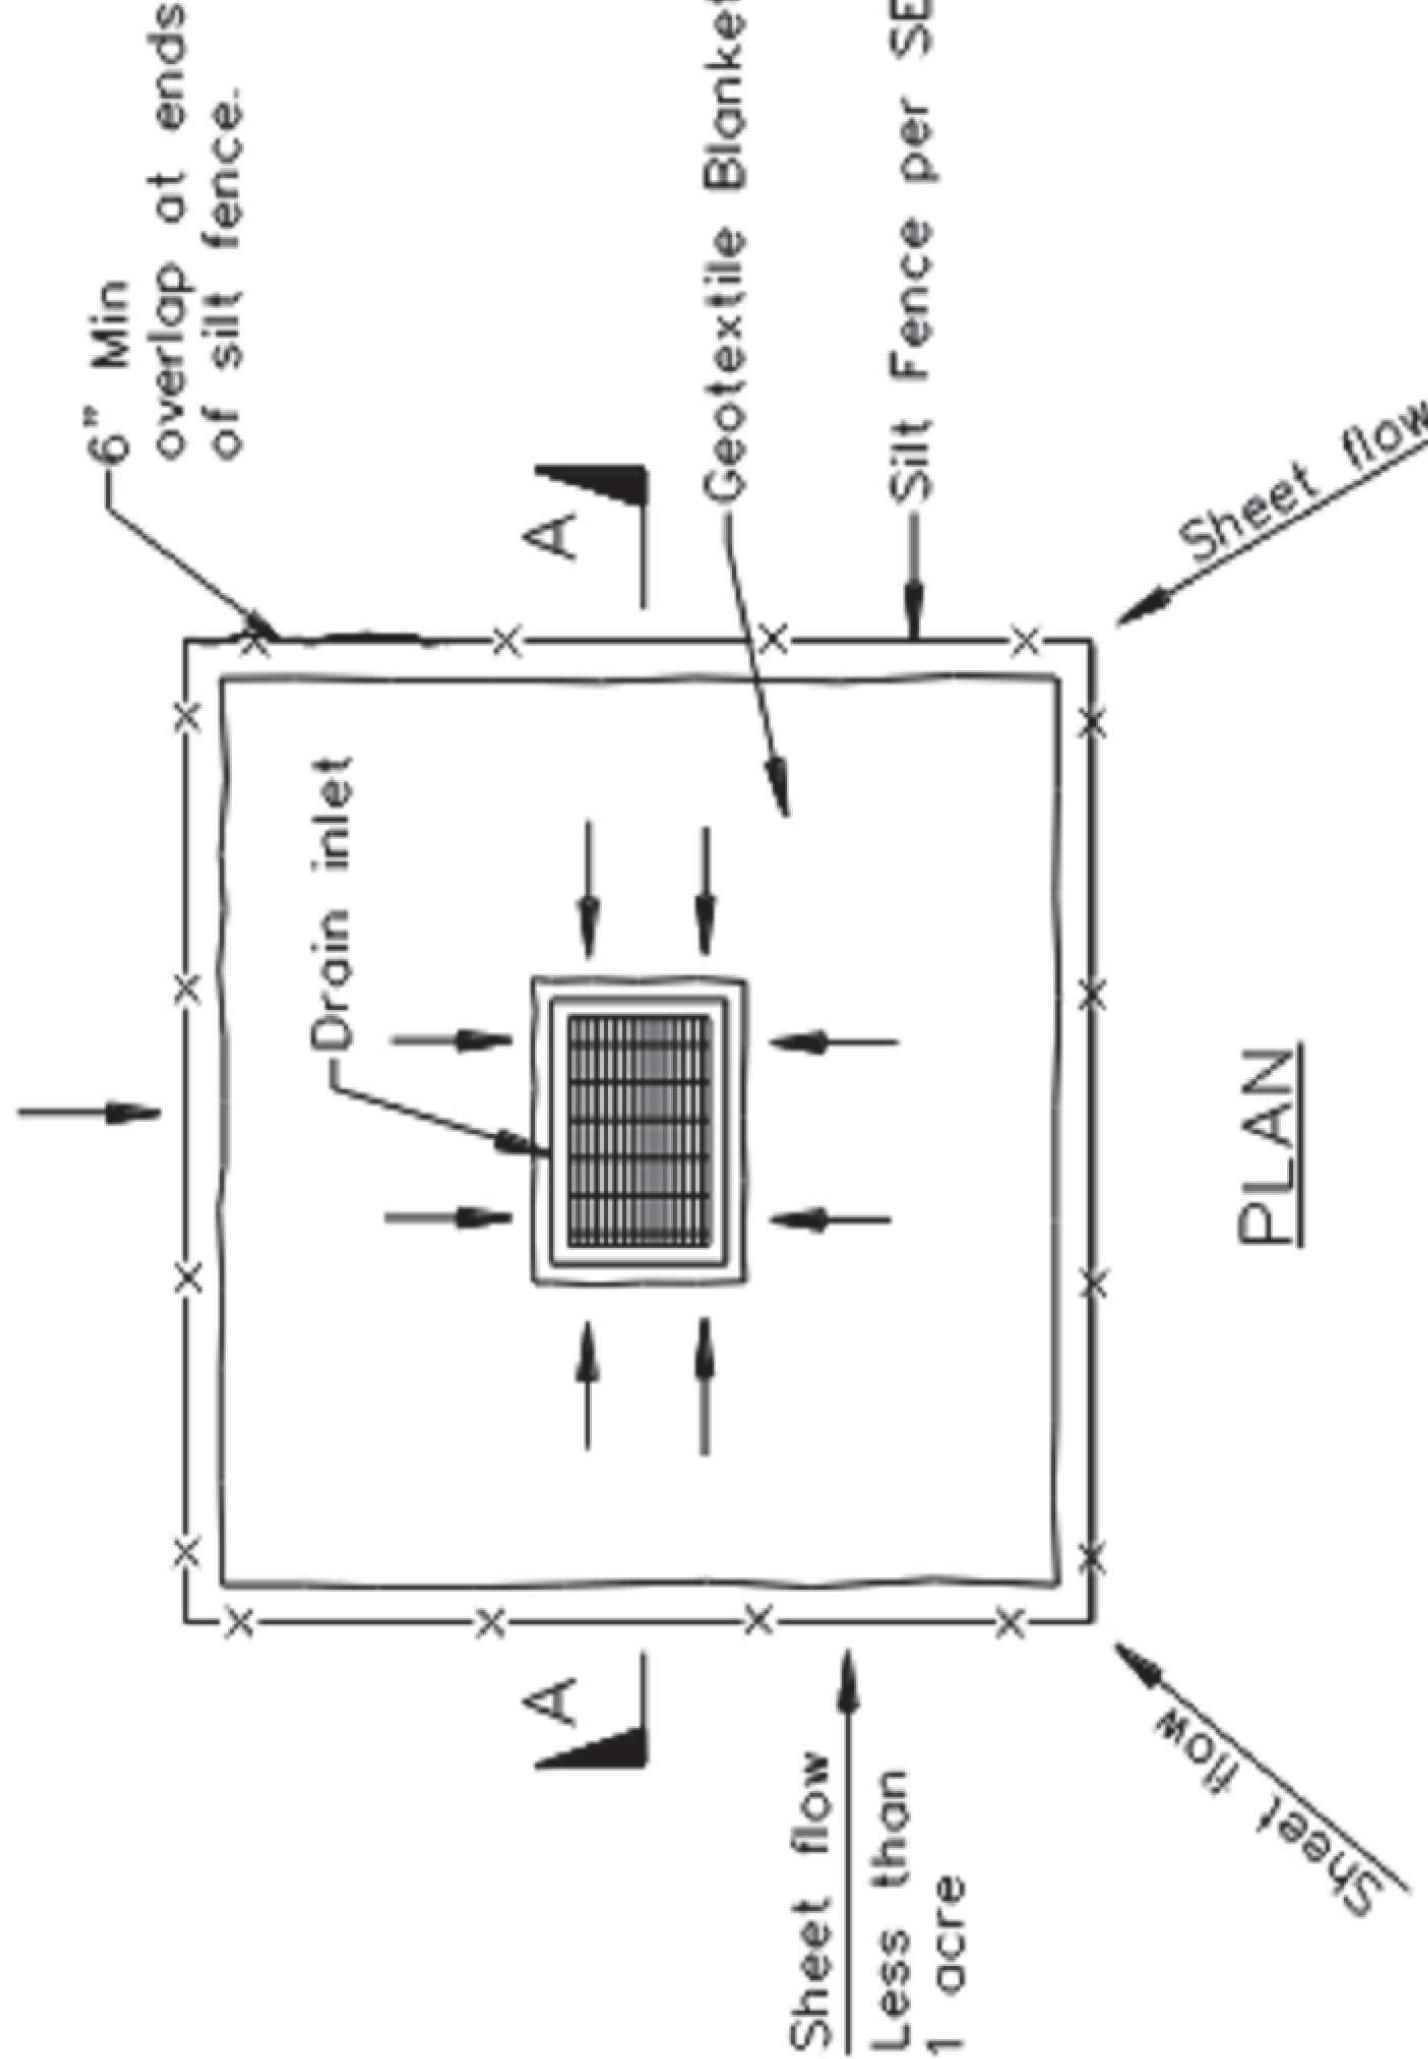
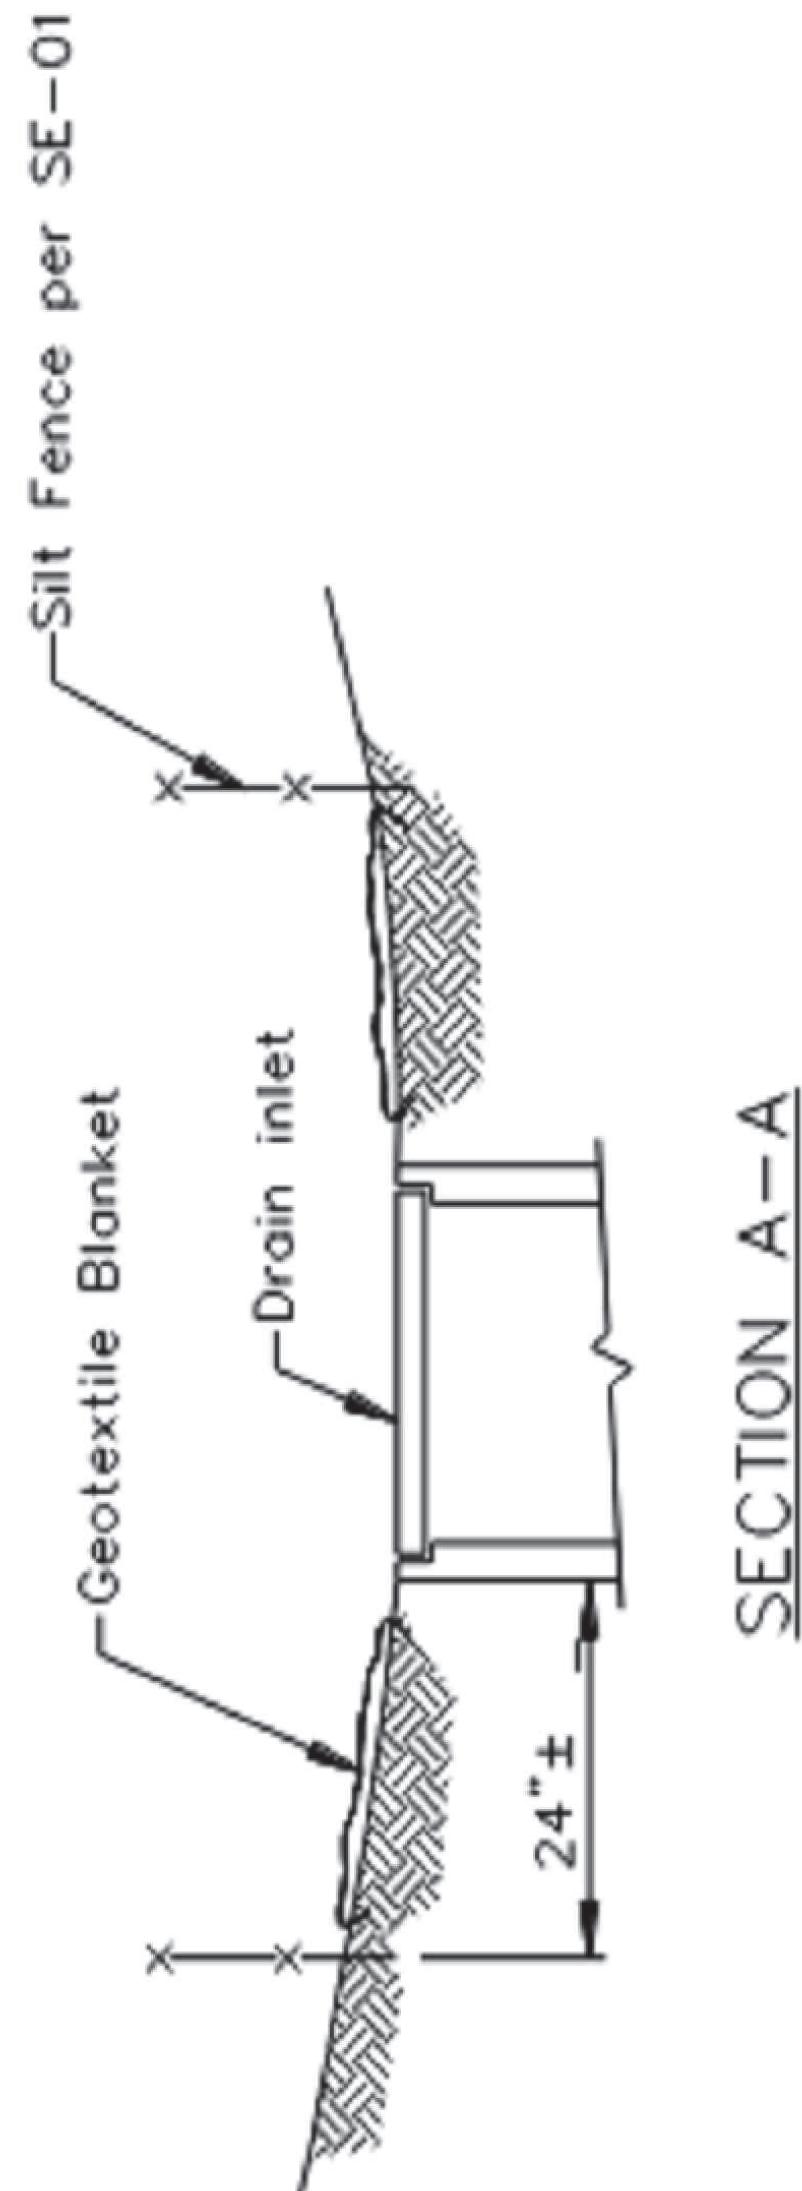
89

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Storm Drain Inlet Protection SE-10

Storm Drain Inlet Protection



NOTES:

1. Intended for short-term use.
2. Use to inhibit non-storm water flow.
3. Allow for proper maintenance and cleanup.
4. Bags must be removed after adjacent operation is completed.
5. Not applicable in areas with high silts and clays without filter fabric.
6. Protection can be effective even if it is not immediately adjacent to the inlet provided that the inlet is protected from potential sources of pollution.

D1 PROTECTION TYPE 1 NOT TO SCALE

- NOTES:**
1. For use in areas where grading has been completed and final soil stabilization and seeding are pending.
 2. Not applicable in paved areas.
 3. Not applicable with concentrated flows.

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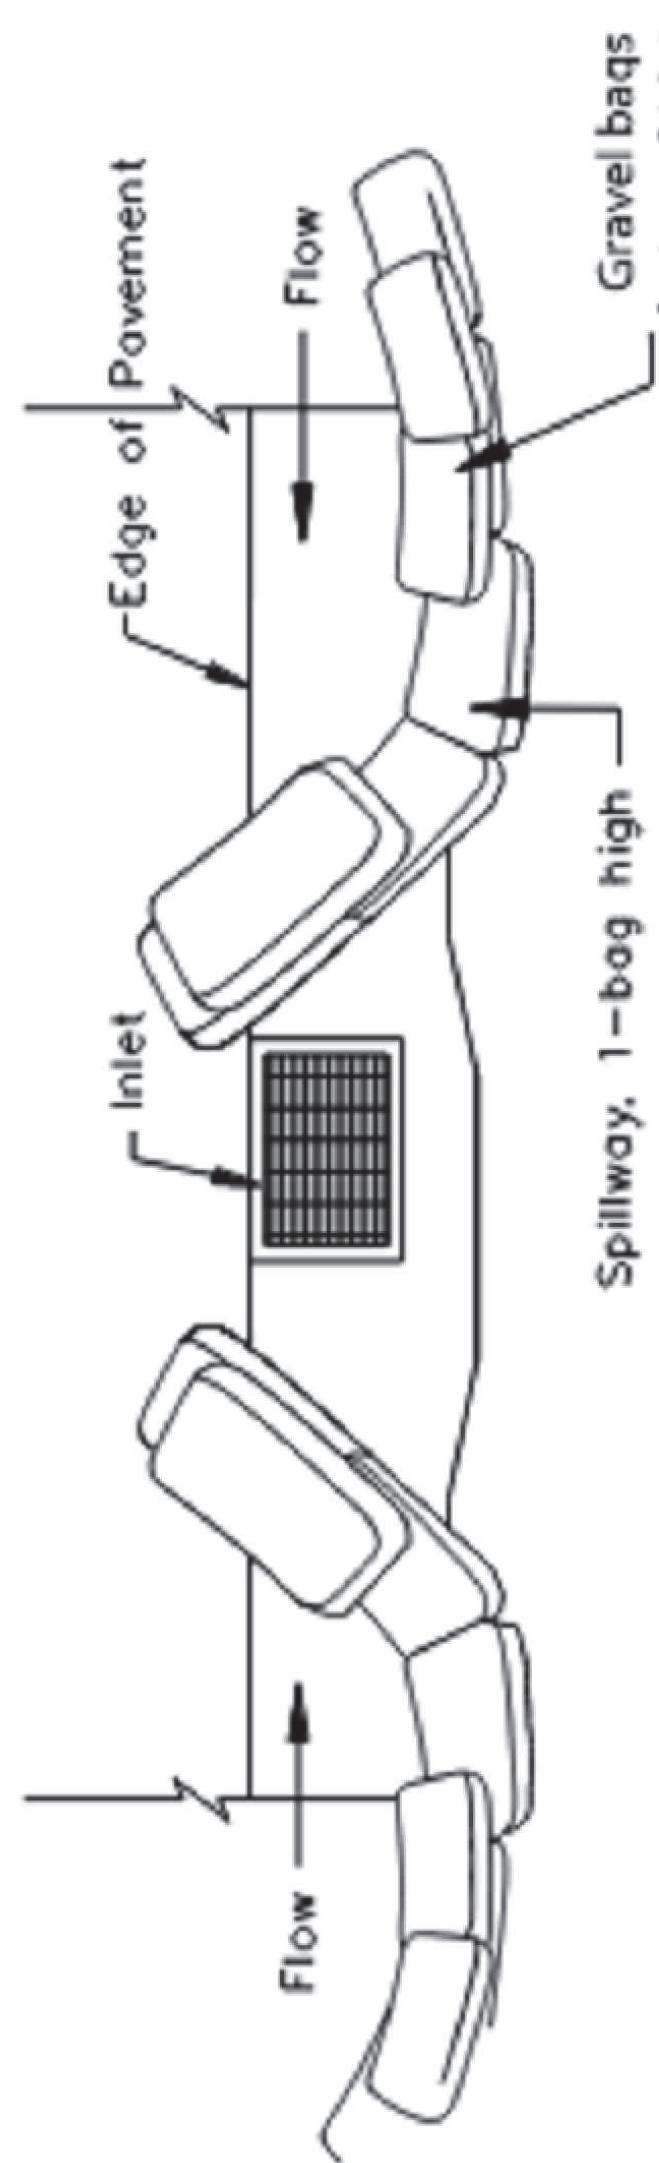
June 2012

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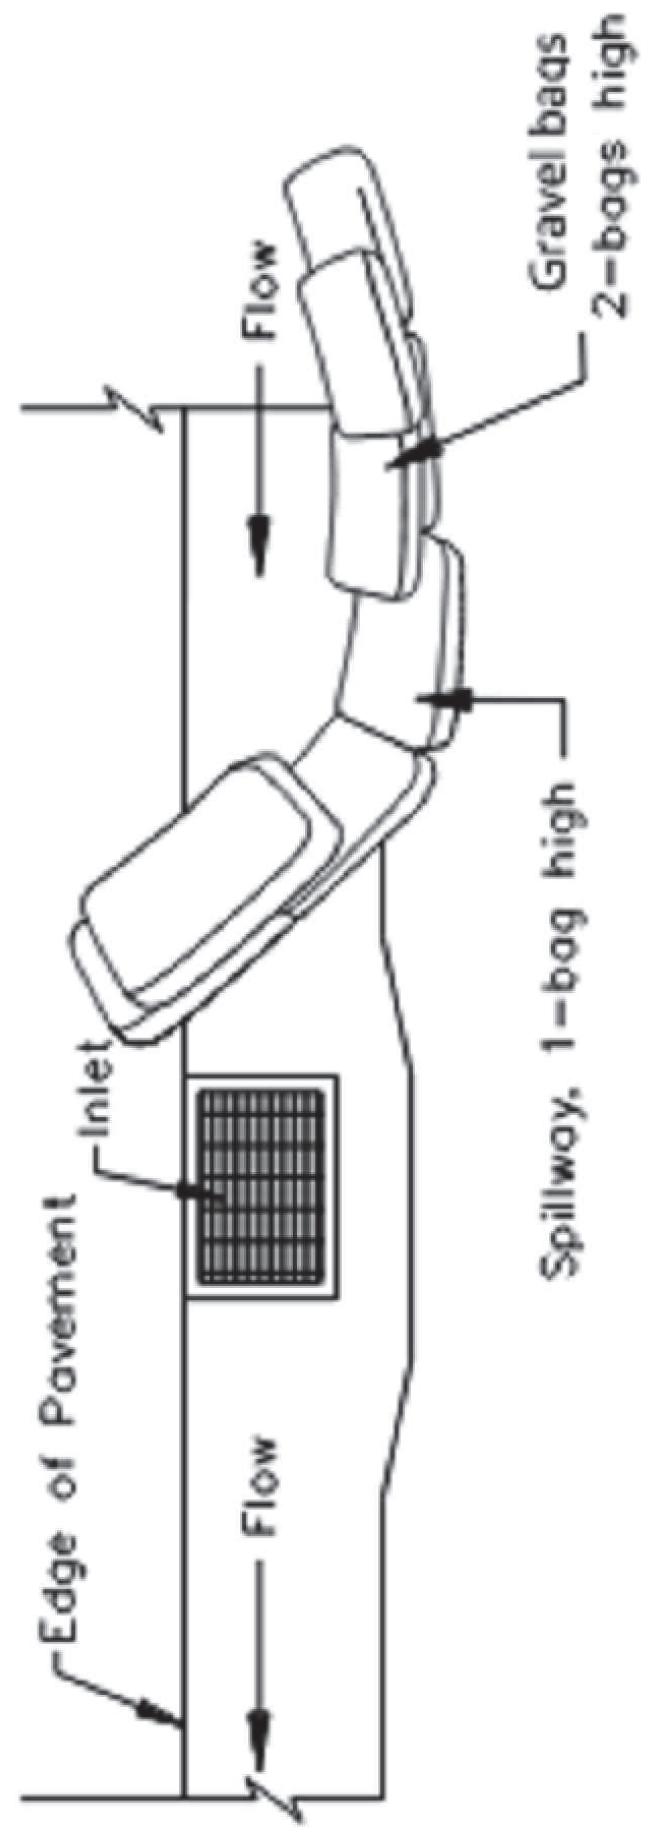
NOT TO SCALE

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SE-10




TYPICAL PROTECTION FOR INLET ON SUMP



TYPICAL PROTECTION FOR INLET ON GRADE

Plans Prepared For:
MD7
10590 WEST OCEAN AIR DRIVE
SUITE 300
SAN DIEGO, CA 92130

Applicant:

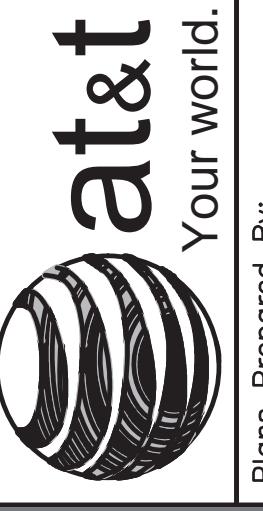

Plans Prepared By:

MH
MORRISON HERSHFIELD
5100 SW MACADAM AVE, SUITE 500
PORTLAND, OR 97239
Tel: 503-958-9128 Fax: 503-958-9136
www.morrisonhershfield.com

Project: COMMUNITY
CONGREGATIONAL CHURCH
SITE ID: SS0071
2058 BERYL STREET
SAN DIEGO, CA 92109
FA: 10090957

Drawing Title:
BMP DETAILS

Project No.:
210359800

Designer:
SB Date:
05/06/22
Drawn By:
GD Checked By:
SS
PM Review:
JR Client Approval

A

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NOT TO SCALE

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5

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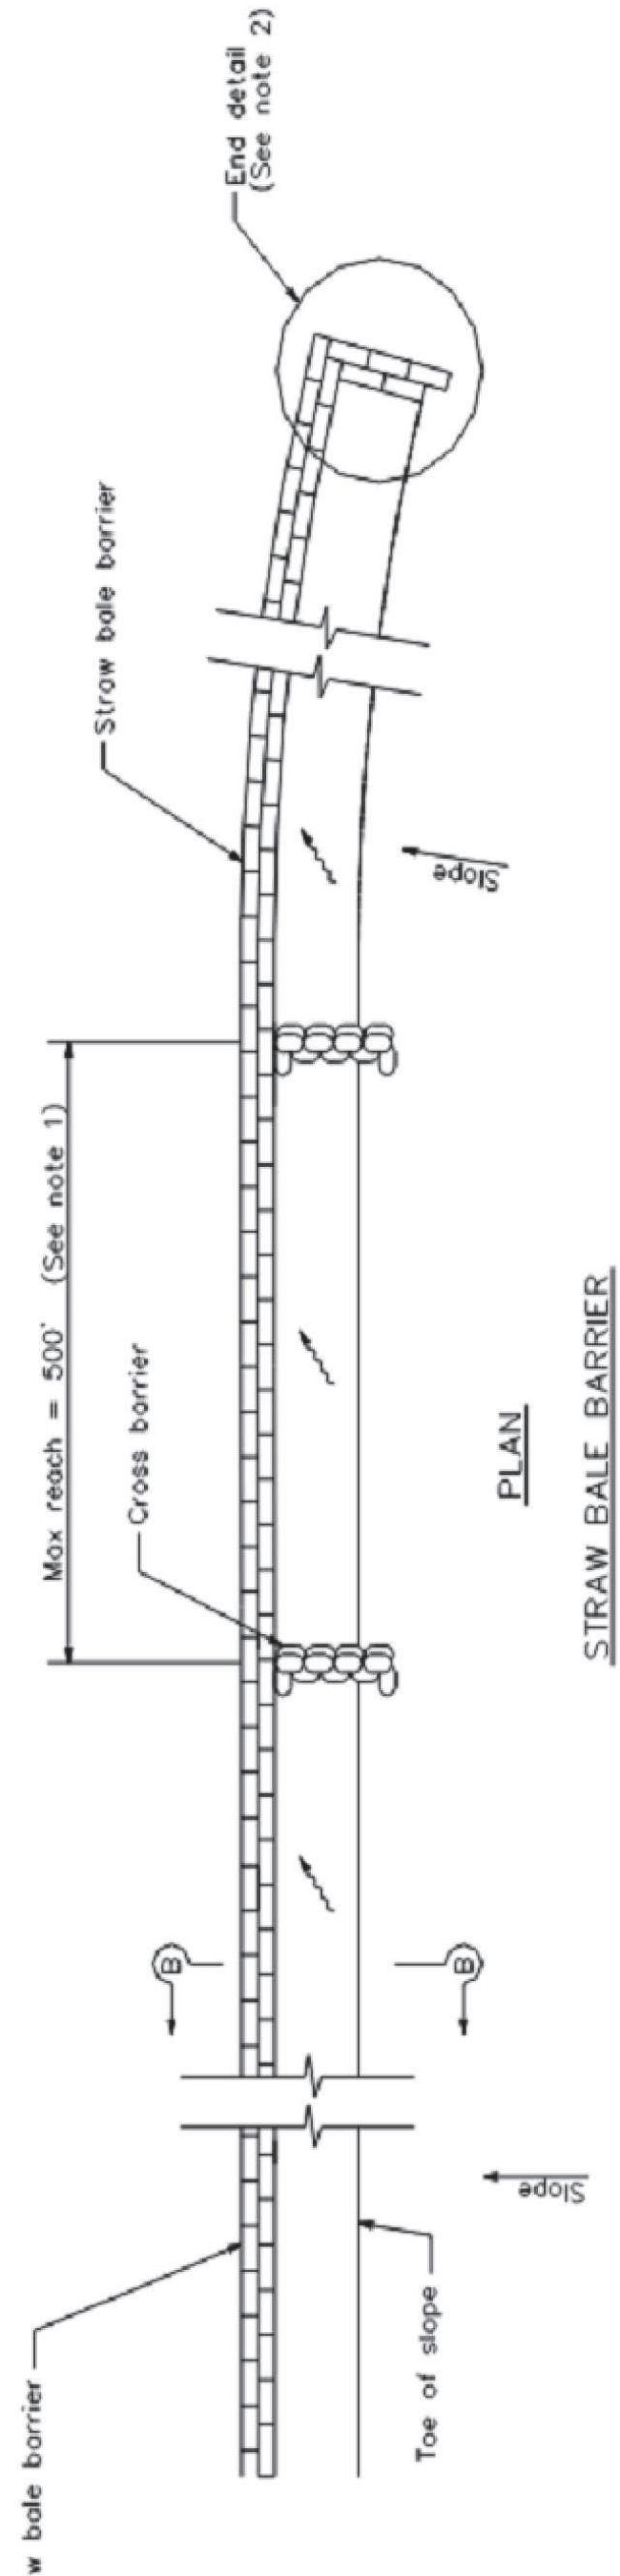
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NOT TO SCALE

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Straw Bale Barrier



NOTES


1. Construct the length of each reach so that the change in base elevation along the reach does not exceed $1/2$ the height of the linear barrier. In no case shall the reach length exceed 500'.
2. The end of barrier shall be turned up slope.
3. Dimension may vary to fit field condition.
4. Stake dimensions are nominal.
5. Place straw bales tightly together.
6. Tamp embedment spoils against sides of installed bales.
7. Drive angled wood stake before vertical stake to ensure tight obutment to adjacent bale.
8. Sandbag cross barriers should be a min of $1/2$ and a max of $2/3$ the height of the linear barrier.
9. Sandbag rows and layers should be offset to eliminate gaps.

May 2011

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STRAW BALE BARRIER DETAIL

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The image shows the AT&T logo, which consists of a stylized globe composed of horizontal bands of varying shades of gray. To the left of the globe, the letters "at&t" are written in a bold, lowercase, sans-serif font. To the right of the globe, the words "Your world. Delivered." are written vertically in a smaller, lowercase, sans-serif font.

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BMP DETAILS
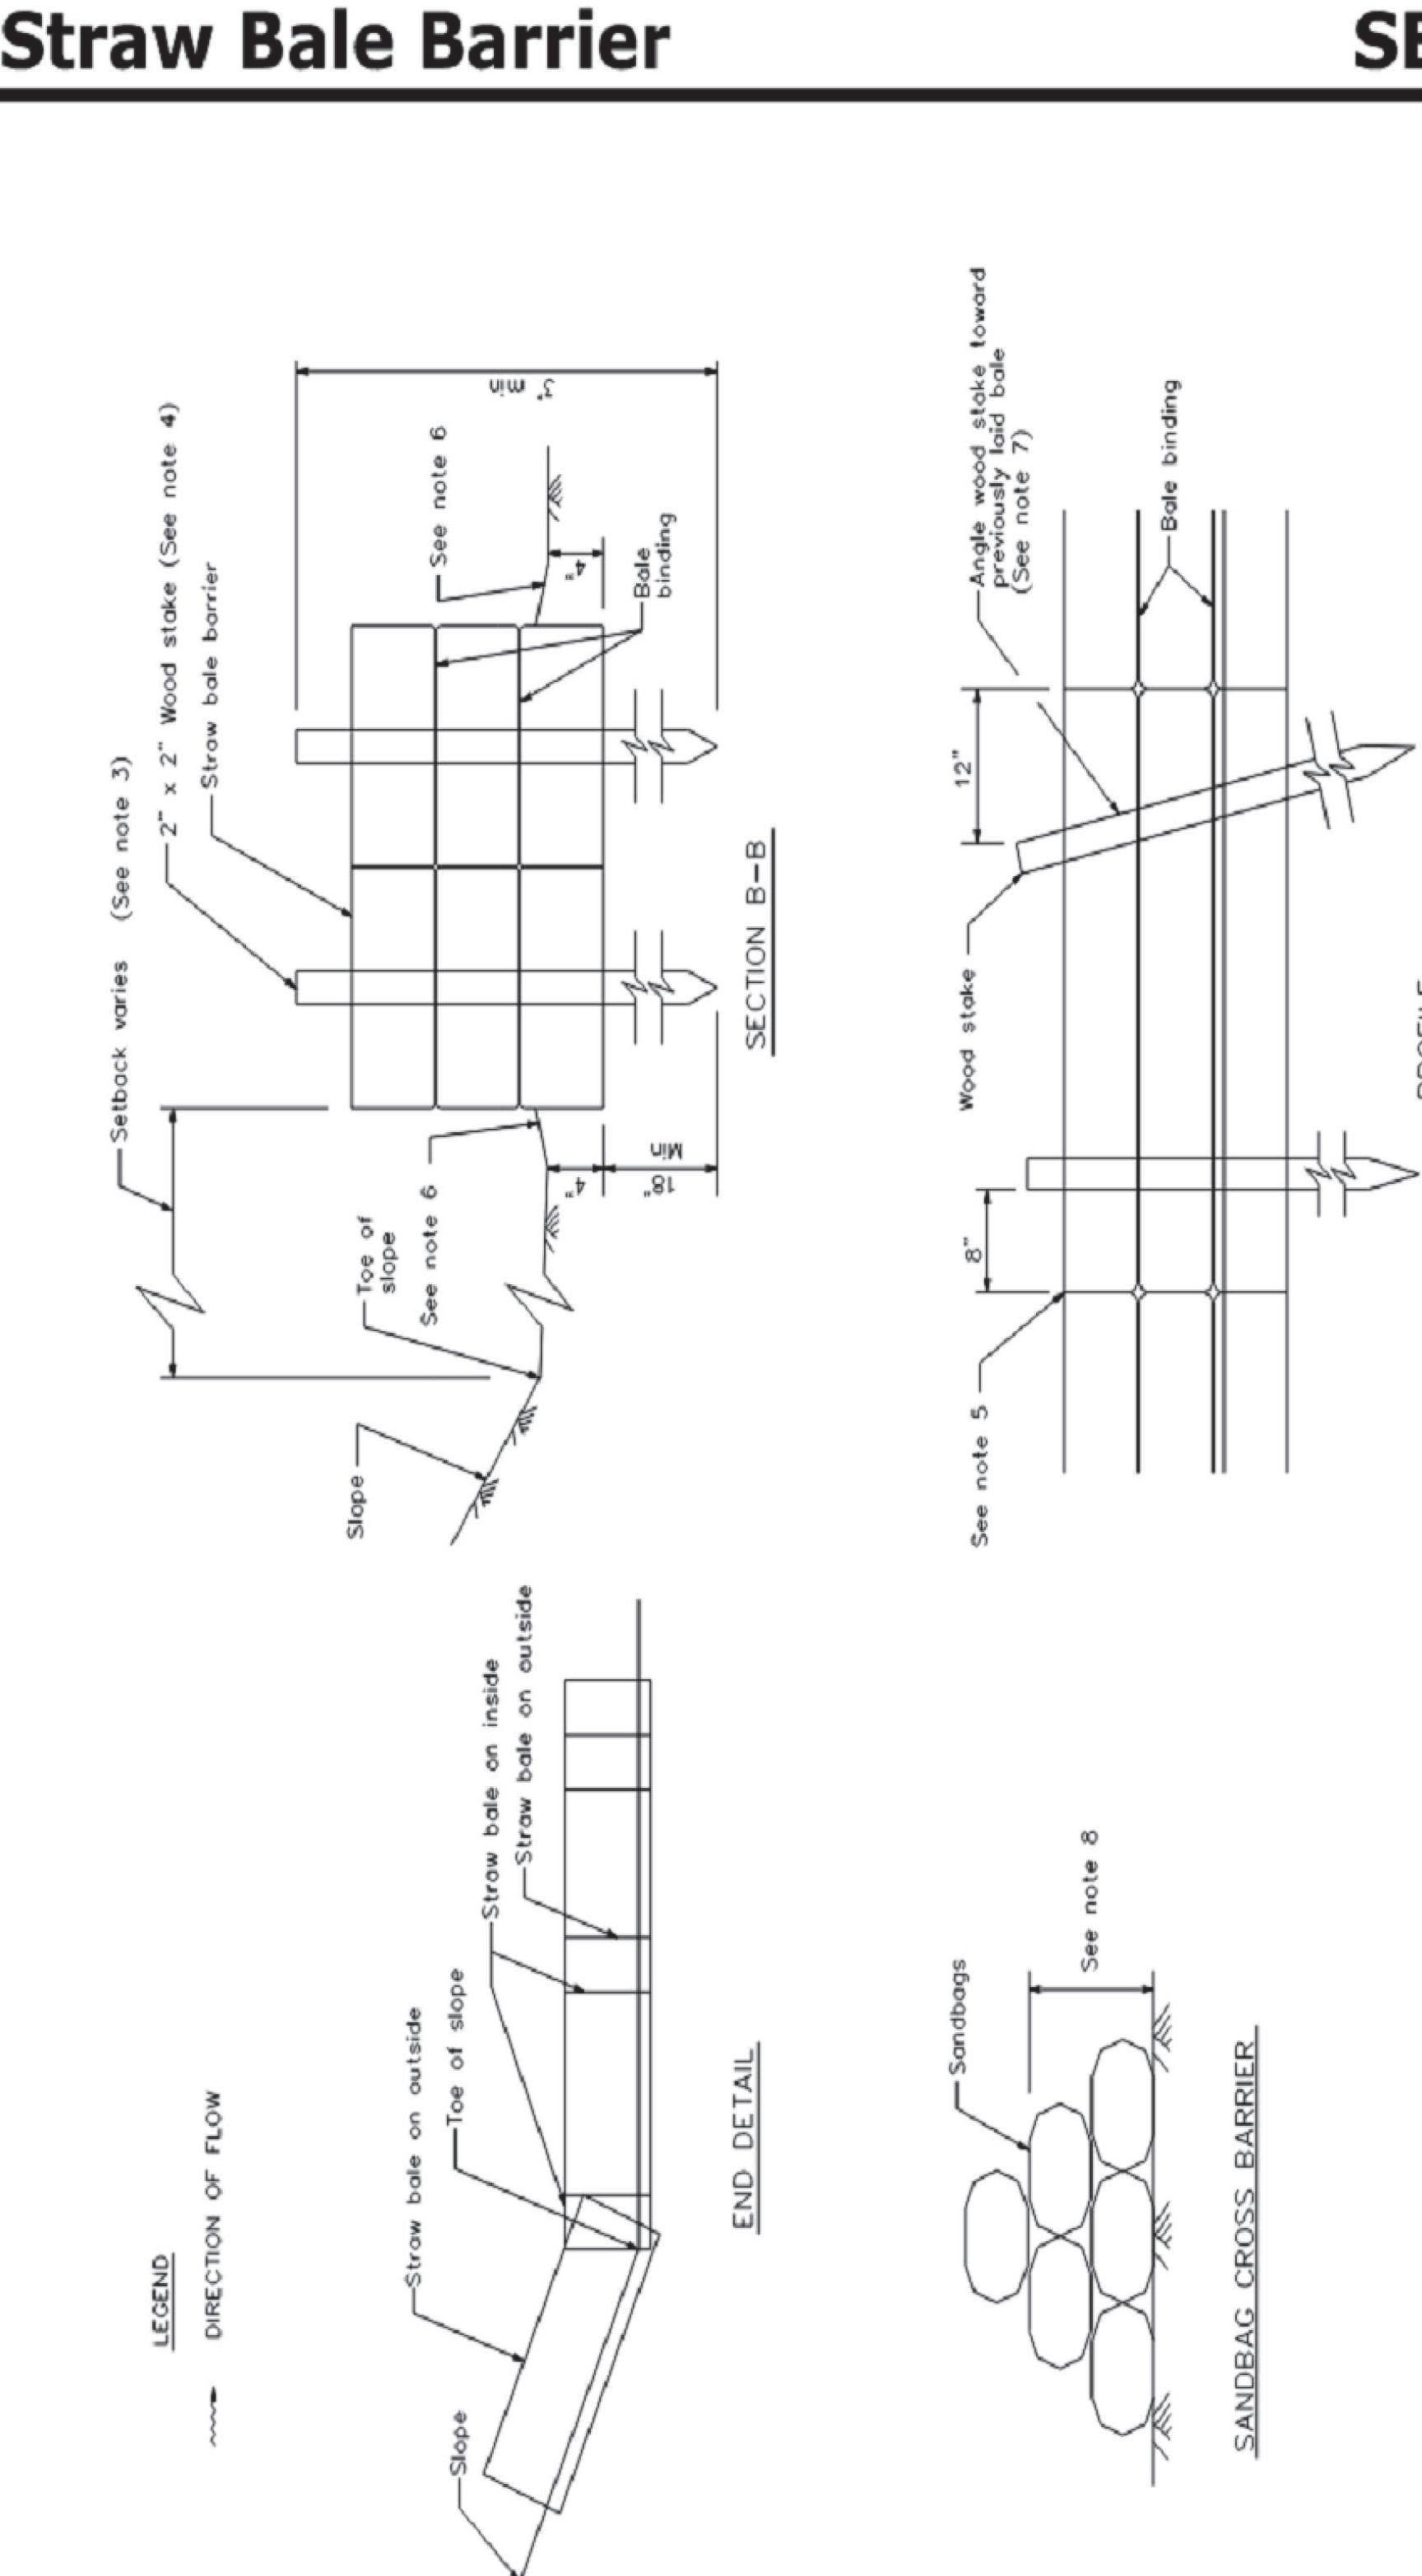
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SCALE IS BASED ON 22" X 34" "D" SIZE

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THIS IS NOT A SURVEY

ALL INFORMATION AND TRUE NORTH
HAVE BEEN OBTAINED FROM EXISTING
DRAWINGS AND ARE APPROXIMATE.

NOTE:
REFER TO SHEETS L-1 TO L-3 FOR LANDSCAPING PLANS.


NOTE:

"IF ANY REQUIRED LANDSCAPE INDICATED ON THE
APPROVED CONSTRUCTION DOCUMENTS IS DAMAGED
OR REMOVED, IT SHALL BE REPAIRED AND/OR REPLACED IN
KIND AND EQUIVALENT SIZE PER THE APPROVED
DOCUMENTS TO THE SATISFACTION OF THE DEVELOPMENT
SERVICES DEPARTMENT WITHIN 30 DAYS OF DAMAGE."


NOTE:

"EXISTING TREES TO REMAIN ON SITE WITHIN 10'-FT OF THE
AREA OF WORK WILL BE PROTECTED IN PLACE. THE
FOLLOWING PROTECTION MEASURES WILL BE PROVIDED:
1. A BRIGHT YELLOW OR ORANGE TEMPORARY FENCE WILL
BE PLACED AROUND EXISTING TREES AT THE DRIP LINE.
2. STOCKPILING, "TOPSOIL DISTURBANCE, VEHICLE USE,
AND MATERIAL STORAGE OF ANY KIND IS PROHIBITED
WITHIN THE DRIP LINE.
3. A TREE WATERING SCHEDULE WILL BE MAINTAINED AND
DOCUMENTED DURING CONSTRUCTION.
4. ALL DAMAGED TREES WILL BE REPLACED WITH ONE OF
EQUAL OR GREATER SIZE."

EXISTING ELEMENTARY SCHOOL

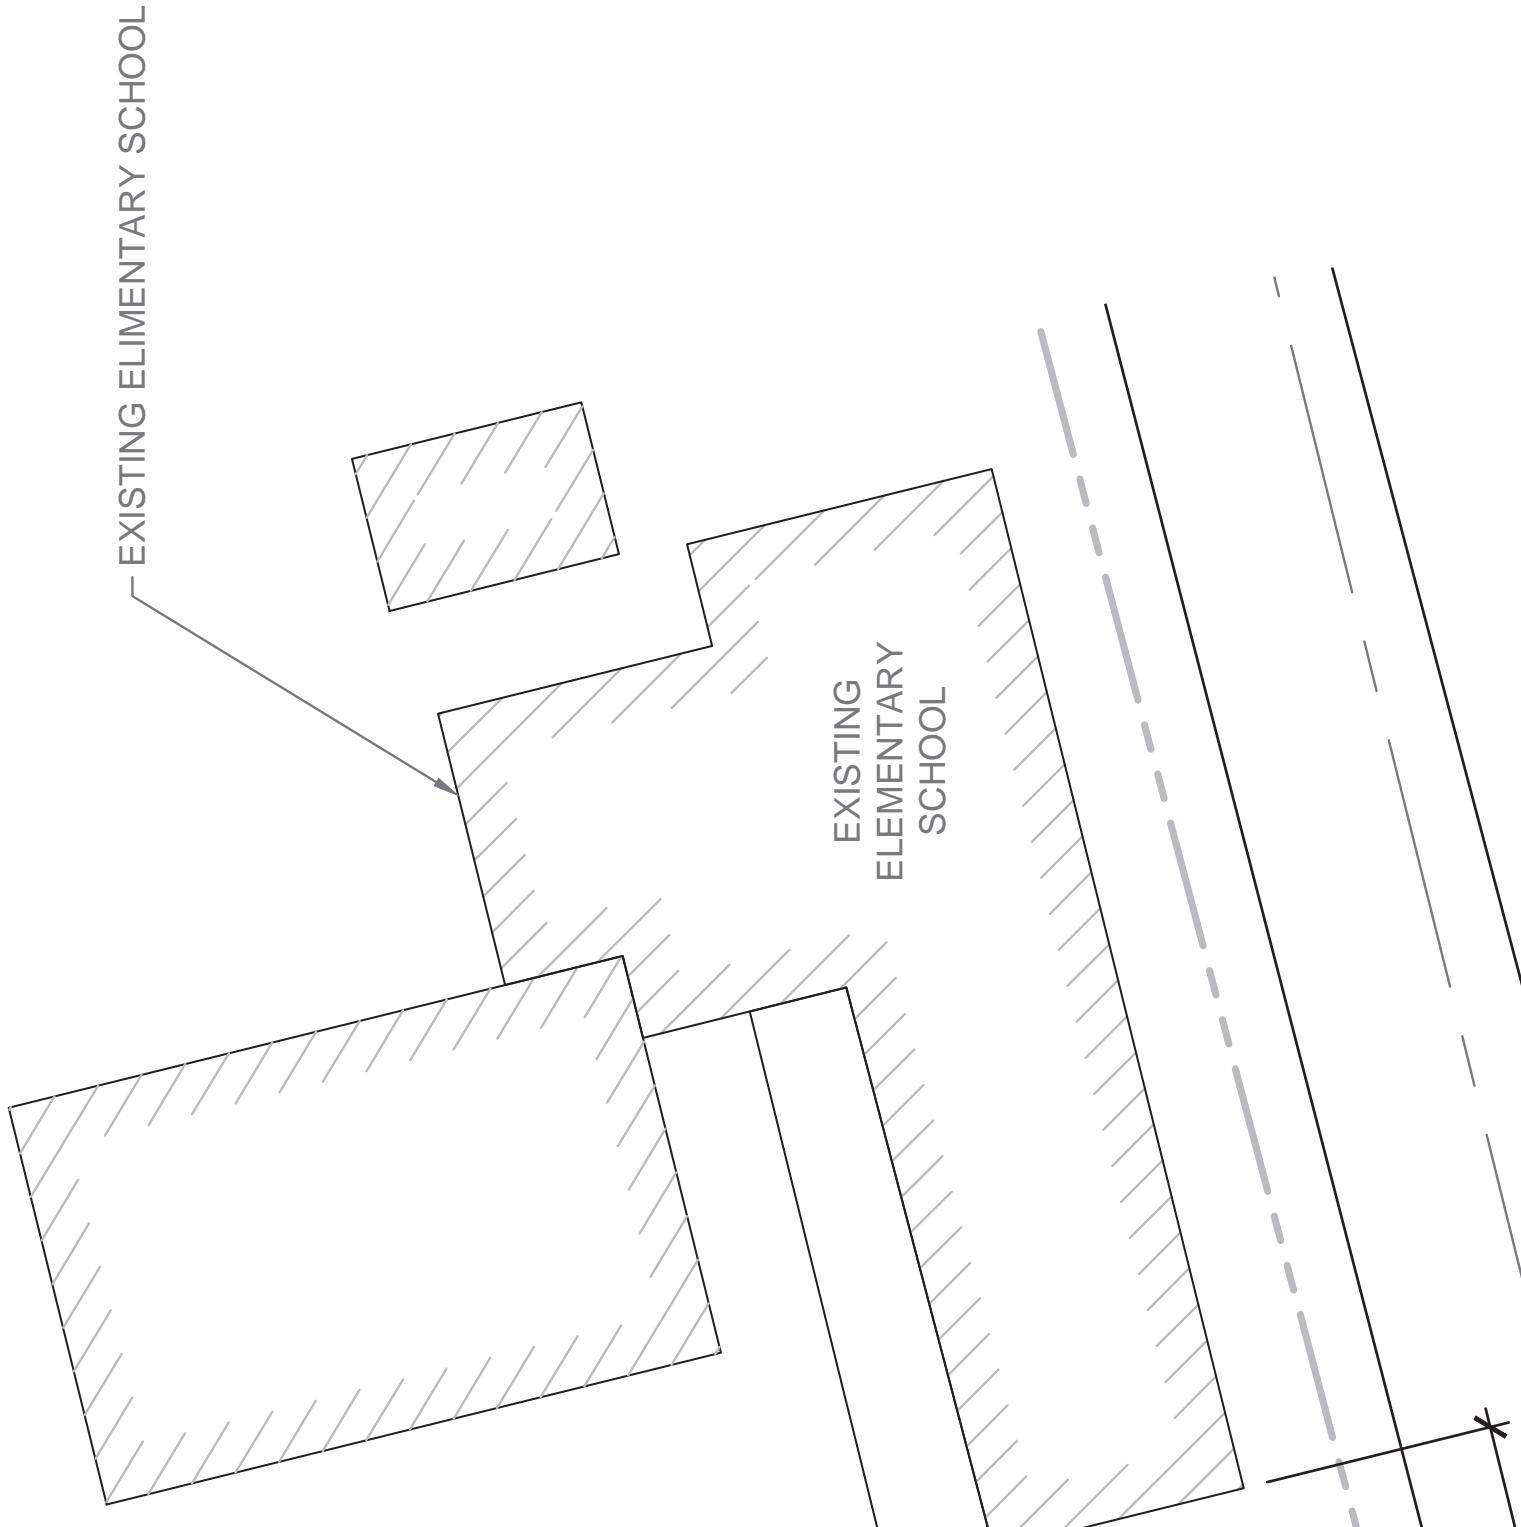

LOCATION OF EXISTING AT&T
EQUIPMENT COMPOUND

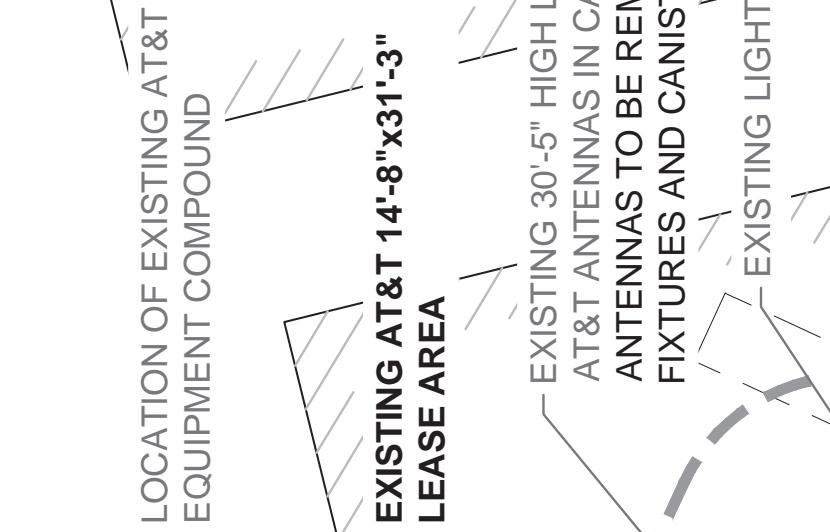

LEASE AREA




EXISTING 30'-5" HIGH LIGHT POLE W/
AT&T ANTENNAS IN CANISTER
ANTENNAS TO BE REMOVED AND LIGHT
FIXTURES AND CANISTER TO REMAIN.




PROPOSED 30'-0" HIGH
MONO-EUCALYPTUS
(DESIGNED BY SCI, INC.)
REFER TO SHEETS 19-28




EXISTING 27'-0" HIGH
MONOCYPRESS W/AT&T
ANTENNAS TO BE REMOVED

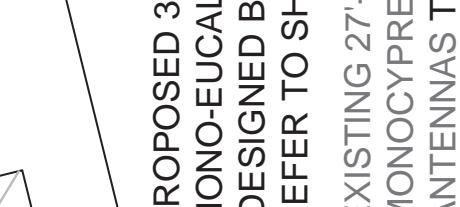


239'-7"

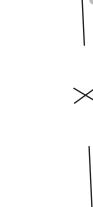

EXISTING TREE (TYP)

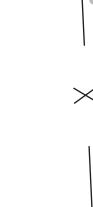


EXISTING ACCESS DRIVE

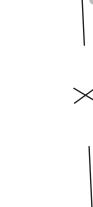


BERYL ST




EGRESS

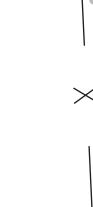


INGRESS

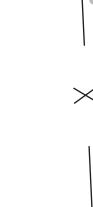


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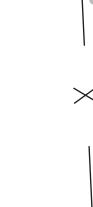
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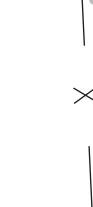
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PARCEL NUMBER:
4162601600

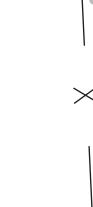


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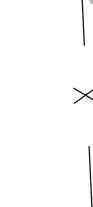
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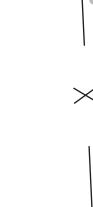
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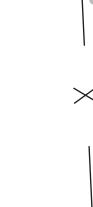
EXISTING EASEMENT
(TYP)

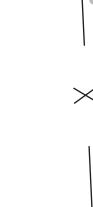


EXISTING BUILDING
(TYP)

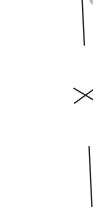


EXISTING ADJACENT
PROPERTY LINE

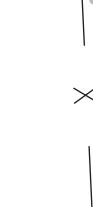


EXISTING PROPERTY LINE

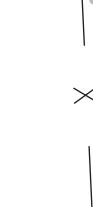


EXISTING CHAIN
LINK FENCE

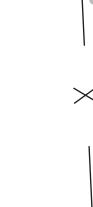


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PARCEL NUMBER:
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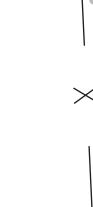
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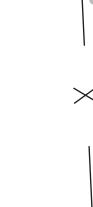
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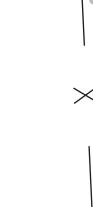
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PARCEL NUMBER:
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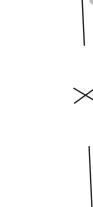
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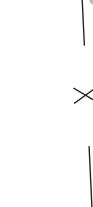
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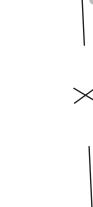
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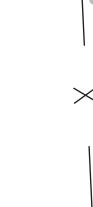
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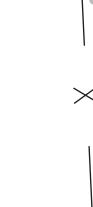
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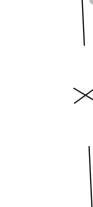
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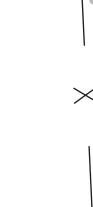
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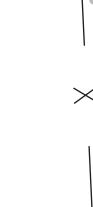
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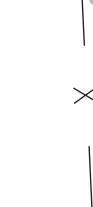
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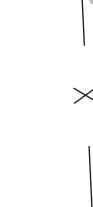
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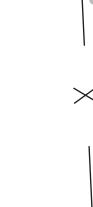
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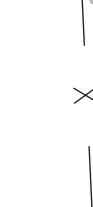
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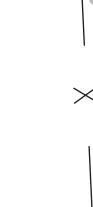
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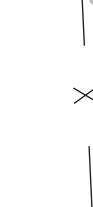
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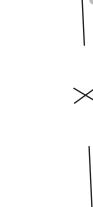
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PARCEL NUMBER:
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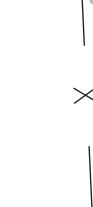
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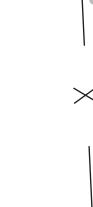
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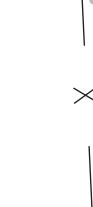
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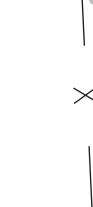
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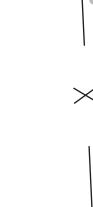
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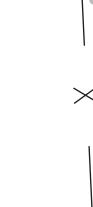
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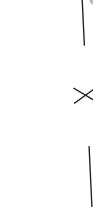
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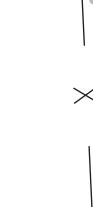
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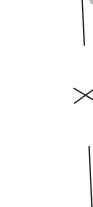
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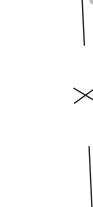
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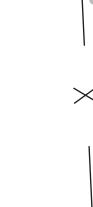
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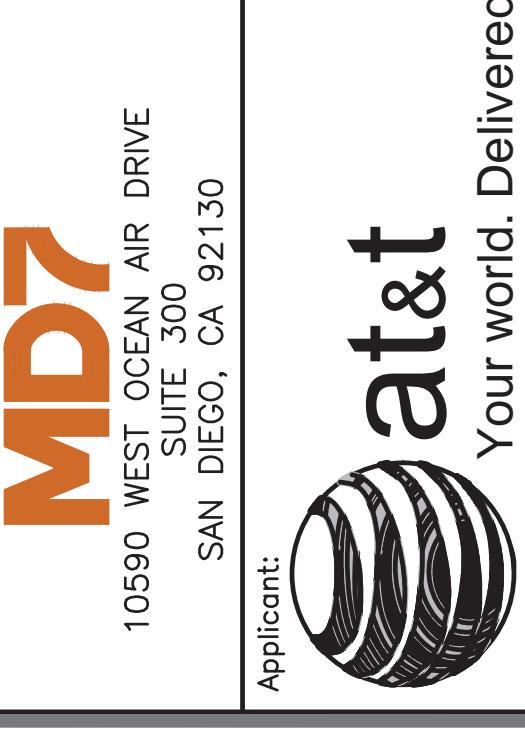


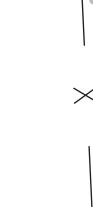EXISTING ANTENNA CONFIGURATION AND SCHEDULE - PER RFDS VERSION 1.0 - DATED 04-25-22									
CARRIER/SPECTRUM	ANTENNA POSITION	AZIMUTH	RAD CENTER	MODEL	TMA	RRU	OTHER EQUIPMENT	FEEDER JUMPER	FEEDER LENGTH
UMTS 850	A1	0°	26° 2'	7780	(1) ERICSON TMA	-	-	7/8" COAX	±135.0'
UMTS 1900	A2	0°	23° 0"	SBNHH-1D65B	(2) KRY 112 75/1	(1) RRUS-32-B30	(1) DC6	7/8" COAX	±12.0'
GSM 850	A3	0°	23° 0"	SBNHH-1D65B	-	(1) RRUS-32-B2	-	7/8" COAX	±12.0'
LTE 700	B1	120°	26° 2"	7780	(1) ERICSON TMA	-	-	7/8" COAX	±135.03'
LTE 1900	B2	120°	23° 0"	SBNHH-1D65B	(2) KRY 112 75/1	(1) RRUS-32-B30	(1) DC6	7/8" COAX	±12.0'
LTE 700	B3	120°	23° 0"	SBNHH-1D65B	(1) KRY 112 75/1	(1) RRUS-11-B12 (1) RRUS-32-B2	-	7/8" COAX	±12.0'
CARRIER/SPECTRUM	ANTENNA POSITION	AZIMUTH	RAD CENTER	MODEL	TMA	RRU	OTHER EQUIPMENT	FEEDER JUMPER	FEEDER LENGTH
UMTS 850	C1	240°	26° 2"	7780	(1) ERICSON TMA	-	-	7/8" COAX	±135.03'
GSM 850	C2	240°	23° 0"	SBNHH-1D65B	(2) KRY 112 75/1	(1) RRUS-32-B30	(1) DC6	7/8" COAX	±12.0'
LTE 700	C3	240°	23° 0"	SBNHH-1D65B	(1) KRY 112 75/1	(1) RRUS-11-B12 (1) RRUS-32-B2	-	7/8" COAX	±12.0'
LTE 1900									

PROPOSED ANTENNA CONFIGURATION AND SCHEDULE - PER RFDS VERSION 1.0 - DATED 04-25-22									
CARRIER/SPECTRUM	ANTENNA POSITION	AZIMUTH	RAD CENTER	MODEL	TMA	RRU	OTHER EQUIPMENT	FEEDER JUMPER	FEEDER LENGTH
B1/7850/PCS/AWS	A1	0°	24° 0"	NNHH-65B-R6H4	-	(1) 4449B5/B12 (1) 8843-B2/B66A	-	1/2" COAX	±10'-0"
5G DOD	A2	0°	25° 10"	AIR849-B77G	-	-	(1) DC6	-	-
5G CBAND	A3	0°	25° 9"	AIR849-B77D	-	-	-	-	-
B14/WCS	A4	0°	24° 0"	NNHH-65B-R4	-	(1) 4478-B14 (1) RRUS-32-B30	-	1/2" COAX	±10'-0"
CARRIER/SPECTRUM	ANTENNA POSITION	AZIMUTH	RAD CENTER	MODEL	TMA	RRU	OTHER EQUIPMENT	FEEDER JUMPER	FEEDER LENGTH
B1/7850/PCS/AWS	B1	120°	24° 0"	NNHH-65B-R6H4	-	(1) 4449B5/B12 (1) 8843-B2/B66A	-	1/2" COAX	±10'-0"
5G DOD	B2	120°	25° 10"	AIR849-B77G	-	-	(1) DC6	-	-
B14/WCS	B3	120°	25° 9"	NNHH-65B-R4	-	(1) 4478-B14 (1) RRUS-32-B30	-	1/2" COAX	±10'-0"
CARRIER/SPECTRUM	ANTENNA POSITION	AZIMUTH	RAD CENTER	MODEL	TMA	RRU	OTHER EQUIPMENT	FEEDER JUMPER	FEEDER LENGTH
B1/7850/PCS/AWS	C1	240°	24° 0"	NNHH-65B-R6H4	-	(1) 4449B5/B12 (1) 8843-B2/B66A	-	1/2" COAX	±10'-0"
5G DOD	C2	240°	25° 10"	AIR849-B77G	-	-	(1) DC6	-	-
5G CBAND	C3	240°	25° 9"	AIR849-B77D	-	-	(1) FIBER SLACK ENCLOSURE	-	-
B14/WCS	C4	240°	24° 0"	NNHH-65B-R4	-	(1) 4478-B14 (1) RRUS-32-B30	-	1/2" COAX	±10'-0"
NOTE:									

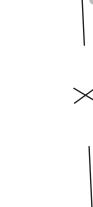1. REMOVE ALL UNNECESSARY HARDWARE AND TMAs TO MAKE SPACE FOR PROPOSED RRUs AND SURGE PROTECTORS.

CARRIER/SPECTRUM	ANTENNA POSITION	AZIMUTH	RAD CENTER	MODEL	TMA	RRU	OTHER EQUIPMENT	FEEDER JUMPER	FEEDER LENGTH
B1/7850/PCS/AWS	A1	0°	24° 0"	NNHH-65B-R6H4	-	(1) 4449B5/B12 (1) 8843-B2/B66A	-	1/2" COAX	±10'-0"
5G DOD	A2	0°	25° 10"	AIR849-B77G	-	-	(1) DC6	-	-
5G CBAND	A3	0°	25° 9"	AIR849-B77D	-	-	-	-	-
B14/WCS	A4	0°	24° 0"	NNHH-65B-R4	-	(1) 4478-B14 (1) RRUS-32-B30	-	1/2" COAX	±10'-0"
CARRIER/SPECTRUM	ANTENNA POSITION	AZIMUTH	RAD CENTER	MODEL	TMA	RRU	OTHER EQUIPMENT	FEEDER JUMPER	FEEDER LENGTH
B1/7850/PCS/AWS	B1	120°	24° 0"	NNHH-65B-R6H4	-	(1) 4449B5/B12 (1) 8843-B2/B66A	-	1/2" COAX	±10'-0"
5G DOD	B2	120°	25° 10"	AIR849-B77G	-	-	(1) DC6	-	-
B14/WCS	B3	120°	25° 9"	AIR849-B77D	-	-	(1) FIBER SLACK ENCLOSURE	-	-
CARRIER/SPECTRUM	ANTENNA POSITION	AZIMUTH	RAD CENTER	MODEL	TMA	RRU	OTHER EQUIPMENT	FEEDER JUMPER	FEEDER LENGTH
B1/7850/PCS/AWS	C1	240°	24° 0"	NNHH-65B-R6H4	-	(1) 4449B5/B12 (1) 8843-B2/B66A	-	1/2" COAX	±10'-0"
5G DOD	C2	240°	25° 10"	AIR849-B77G	-	-	(1) DC6	-	-
5G CBAND	C3	240°	25° 9"	AIR849-B77D	-	-	(1) FIBER SLACK ENCLOSURE	-	-
B14/WCS	C4	240°	24° 0"	NNHH-65B-R4	-	(1) 4478-B14 (1) RRUS-32-B30	-	1/2" COAX	±10'-0"
NOTE:									

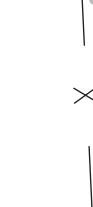

10590 WEST OCEAN AIR DRIVE
SUITE 300
SAN DIEGO, CA 92130


Applicant:
 at&t
Your world. Delivered.

MORRISON HERSHFIELD
5100 MACADAM AVE, SUITE 500
PORTLAND, OR 97239
Tel: 503-958-9128 Fax: 503-958-9136
www.morrisonhershfield.com

Project: COMMUNITY CONGREGATIONAL CHURCH
SITE ID: SS0071
2058 BERYL STREET
SAN DIEGO, CA 92109
FA: 10090957

ANTENNA SCHEDULES

Project No.: 210359800	Date: 05/06/22
Designer: SB	Drawn By: GD
Checked By: SS	PM Review: JR
Client Approval: G	Drawing Title:
Issue No.: G	ANTENNA SCHEDULES

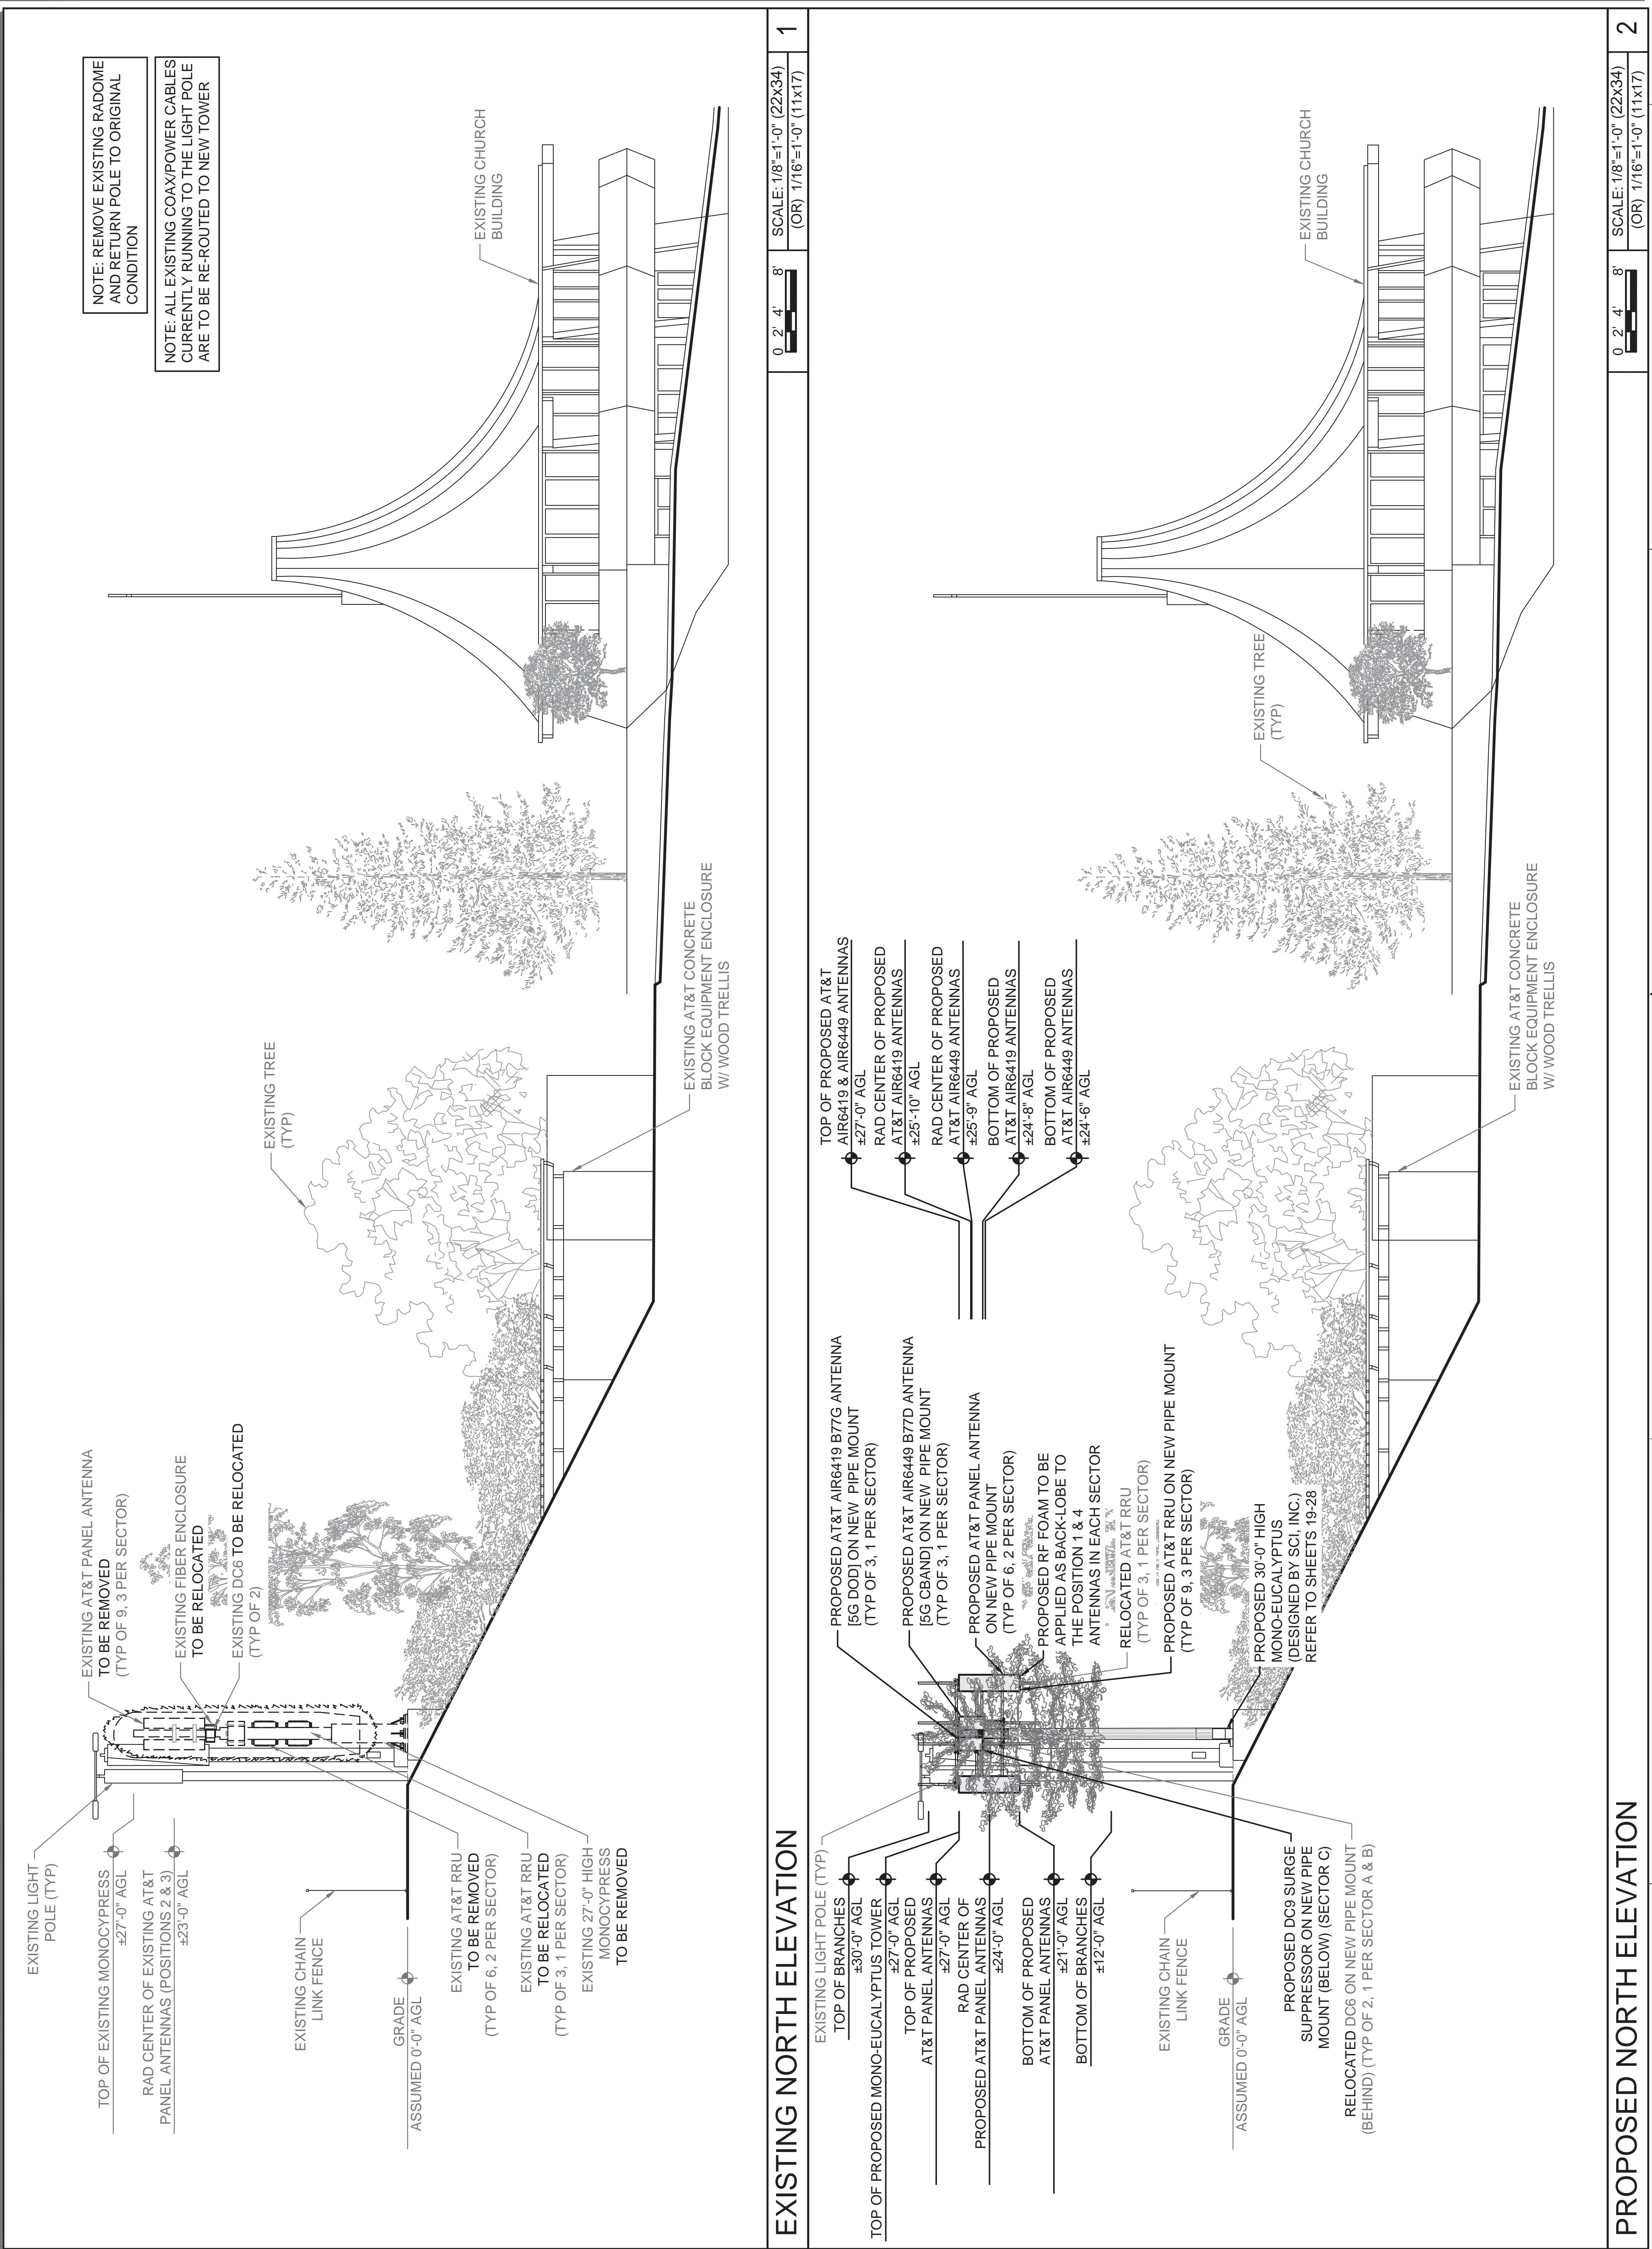

**NOTE: REMOVE EXISTING RADOME
AND RETURN POLE TO ORIGINAL
CONDITION**

NOTE: ALL EXISTING COAX/POWER CABLES CURRENTLY RUNNING TO THE LIGHT POLE ARE TO BE RE-ROUTED TO NEW TOWER

This architectural site plan illustrates the layout of utility poles, trees, and equipment enclosures. Key features include:

- EXISTING TMAS TO BE REMOVED (TYP OF 11)**: Indicated by a leader line pointing to a small utility pole.
- EXISTING 30'-5" HIGH LIGHT POLE WITH LIGHT FIXTURES TO REMAIN**: Indicated by a leader line pointing to a taller utility pole.
- EXISTING 25"Ø CANISTER TO REMAIN**: Indicated by a leader line pointing to a utility pole with a canister.
- RAD CENTER OF EXISTING AT&T PANEL ANTENNAS (POSITION 1)**: Indicated by a leader line pointing to a utility pole with a panel antenna.
- ±26'-2" AGL**: An elevation reference mark indicating the height above ground level.
- 10'-0"**: A dimension line indicating a distance of 10 feet 0 inches.
- EXISTING TREE (TYP)**: Indicated by a leader line pointing to a large tree.
- EXISTING**: Labels indicating existing structures or fixtures.
- POWER CABLES**: A label enclosed in a box, likely referring to underground or overhead power lines.
- EXISTING AT&T CONCRETE BLOCK EQUIPMENT ENCLOSURE W/ WOOD TRELLIS**: Indicated by a leader line pointing to a rectangular concrete foundation with a wooden trellis attached.

EXISTING WEST ELEVATION

<u>AIR6419 & AIR6449 ANTENNAS</u>	<u>RAD CENTER OF PROPOSED AT&T AIR6419 ANTENNAS</u>	<u>BOTTOM OF PROPOSED AT&T AIR6419 ANTENNAS</u>	<u>BOTTOM OF PROPOSED AT&T AIR6449 ANTENNAS</u>
±27'-0" AGL	±25'-10" AGL	±25'-9" AGL	±24'-8" AGL

EXISTING CHAIN
LINK FENCE

The diagram illustrates the elevation of a building facade with three proposed antenna installations:

- Top:** A horizontal line at ±27'-0" AGL labeled "RAD CENTER OF PROPOSED AT&T AIR6419 ANTENNAS".
- Middle:** A horizontal line at ±25'-10" AGL labeled "RAD CENTER OF PROPOSED AT&T AIR6449 ANTENNAS".
- Bottom:** A horizontal line at ±25'-9" AGL labeled "BOTTOM OF PROPOSED AT&T AIR6419 ANTENNAS".

Brackets on the right side of the diagram group these lines and labels under specific identifiers:

- A bracket groups the top two lines and is labeled "EXISTING 25\"Ø CANISTER".
- A bracket groups the bottom two lines and is labeled "EXISTING 30'-5" HIGH LIGHT POLE WITH LIGHT FIXTURES".

PROPOSED AT&T AIR6449 B77D
ANTENNA [5G CBAND] ON NEW
PIPE MOUNT (BEHIND)
(TYP OF 3, 1 PER SECTOR)

PROPOSED AT&T PANEL ANTENNA
ON NEW PIPE MOUNT
(TYP OF 6, 2 PER SECTOR)

Project: COMMUNITY
CONGREGATIONAL CHURCH
SITE ID: SS0071

FA: 1009095/
Drawing Title:
**WEST
ELEVATIONS**


210339800	Designer: SB	Date: 05/06/22
Drawn By: GD	Checked By: SS	Client Approval
PM Review: JR		
Issue No.:		

PROPOSED WEST EVALUATION

A04. | G

A04.1

0 3' 6' 12'  SCALE: 3/32"=1'-0" (22x34) 2

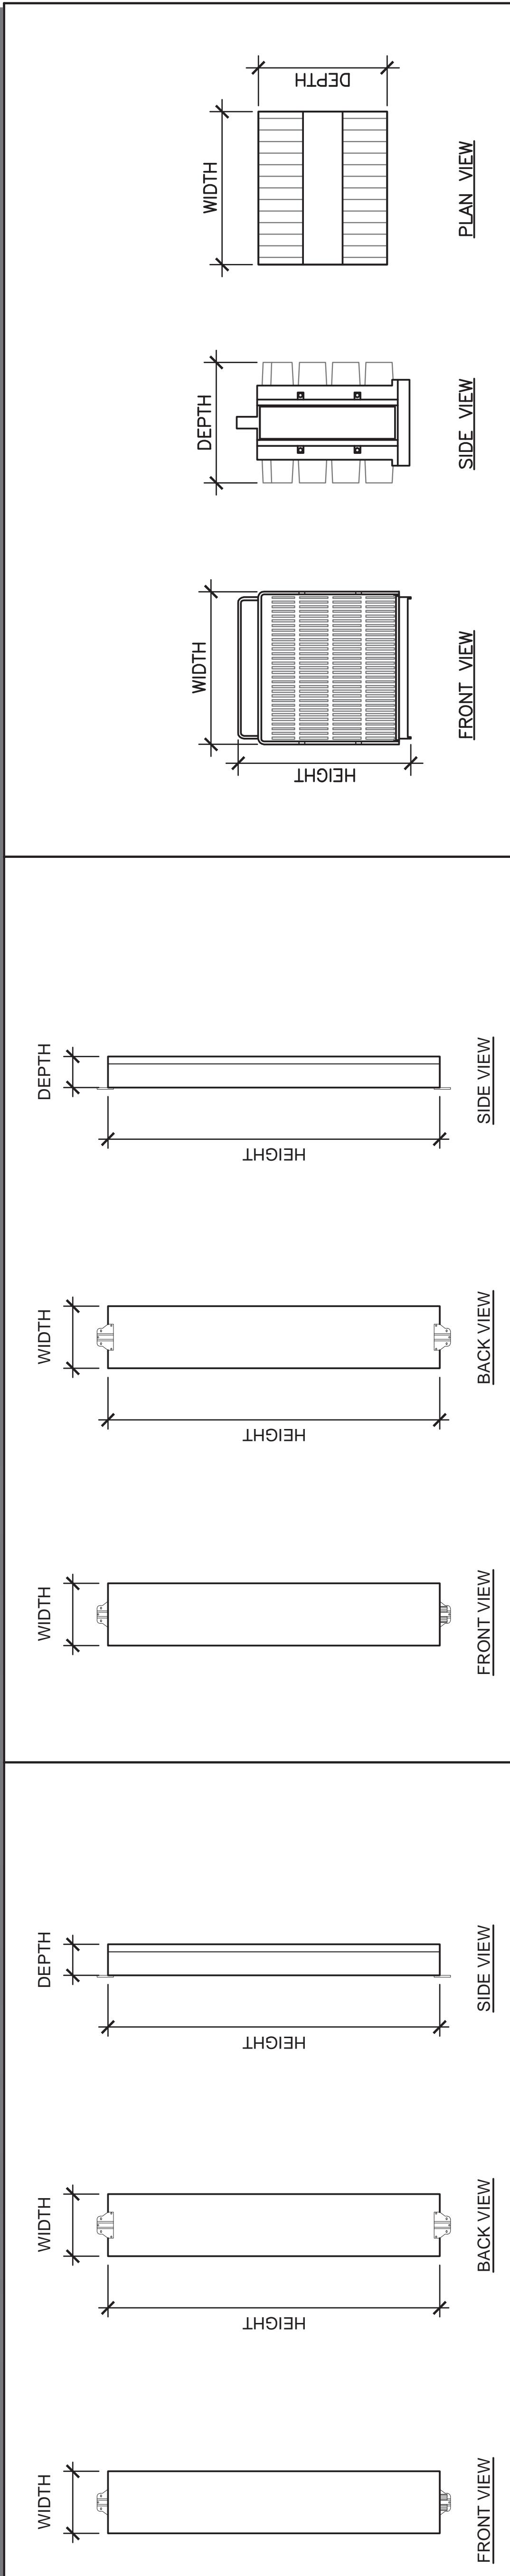

ANTENNA SPECIFICATIONS			
SCALE N.T.S.	1	ANTENNA SPECIFICATIONS	
2		FRONT VIEW	PLAN VIEW
3		SIDE VIEW	

COMMSCOPE NNHH-65B-R4			
SIZE AND WEIGHT TABLE			
HEIGHT	WIDTH	DEPTH	WEIGHT
72"	19.6"	7.7"	78.4 LBS

ANTENNA SPECIFICATIONS			
SCALE N.T.S.	1	ANTENNA SPECIFICATIONS	
2		FRONT VIEW	PLAN VIEW
3		SIDE VIEW	

COMMSCOPE : NNH4-65B-R6H4 & NNHH-65B-R4			
MOUNTING KIT			
REV.	DESCRIPTION	DATE	APPROVED
A	ECR 8000026173: RELEASE TO PRODUCTION.	14SEP17 LS	S.LIU/JIHE
B	ECR 8000026769: CHG 100936-21 TO 100936-33.	27OCT17 HWW	S.LIU/JIHE

RRU SPECIFICATIONS			
SCALE N.T.S.	2	RRU SPECIFICATIONS	
3		FRONT VIEW	PLAN VIEW
4		SIDE VIEW	

ERICSSON 4449 (B5/B12)			
SIZE AND WEIGHT TABLE			
WIDTH	DEPTH	HEIGHT W/O CABLE MANAGEMENT COVER	WEIGHT W/O BRACKET
13.19"	10.43"	14.96"	73.00 LBS

NOTE:
DIMENSIONS DO NOT INCLUDE MOUNTING BRACKET AND SOLAR SHIELD.

RRU SPECIFICATIONS			
SCALE N.T.S.	2	RRU SPECIFICATIONS	
3		FRONT VIEW	PLAN VIEW
4		SIDE VIEW	

ERICSSON 4478 (B14)			
SIZE AND WEIGHT TABLE			
WIDTH	DEPTH	HEIGHT W/O CABLE MANAGEMENT COVER	WEIGHT W/O BRACKET
13.40"	7.70"	16.50"	59.90 LBS

NOTE:
DIMENSIONS DO NOT INCLUDE MOUNTING BRACKET AND SOLAR SHIELD.




I. PRODUCT IDENTIFICATION

 CHEMICAL/TRADE NAME
 (as used on label)

MARATHON V-0 and

SPRINTER V-0

Valve Regulated Lead Acid Battery

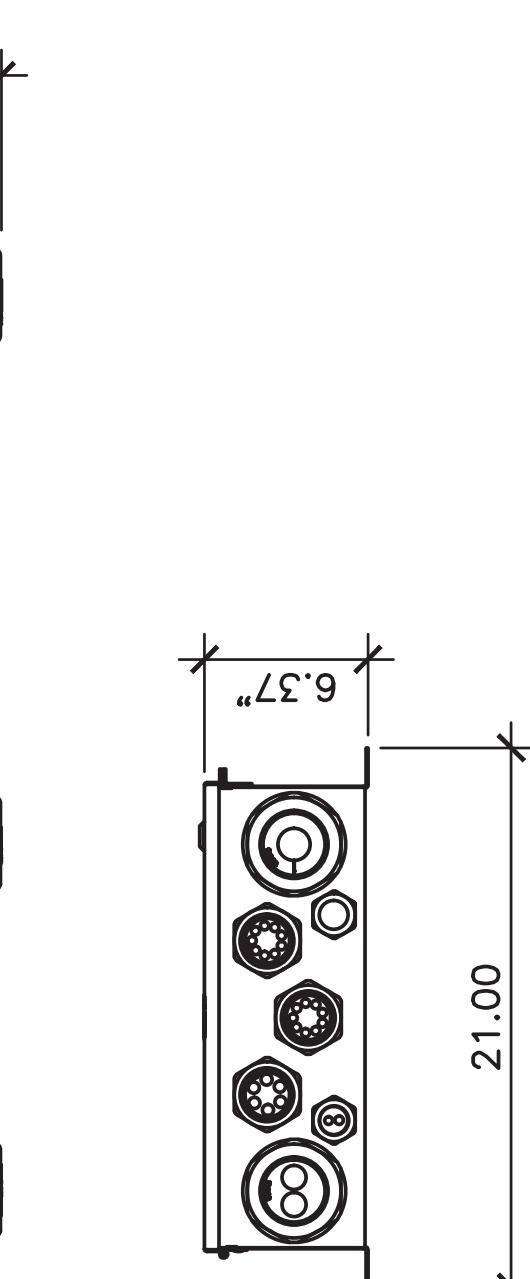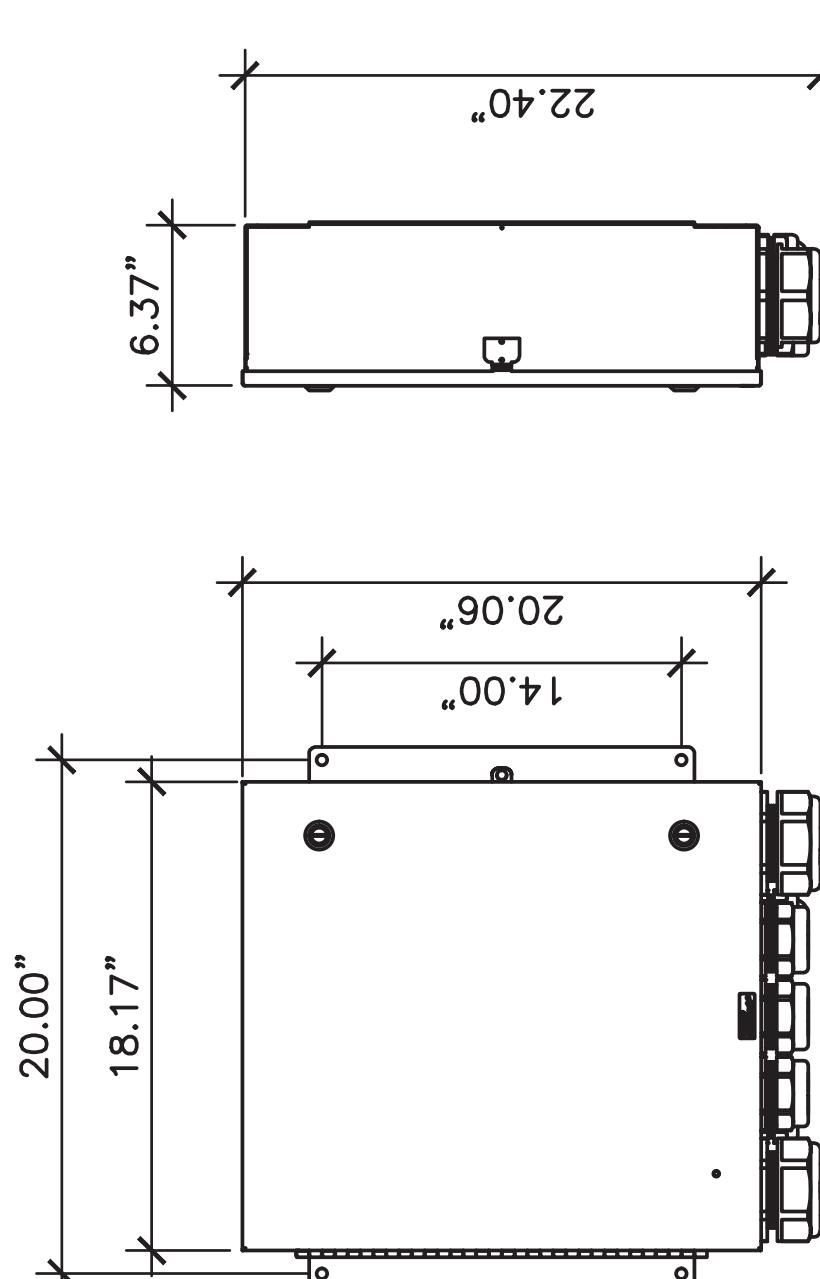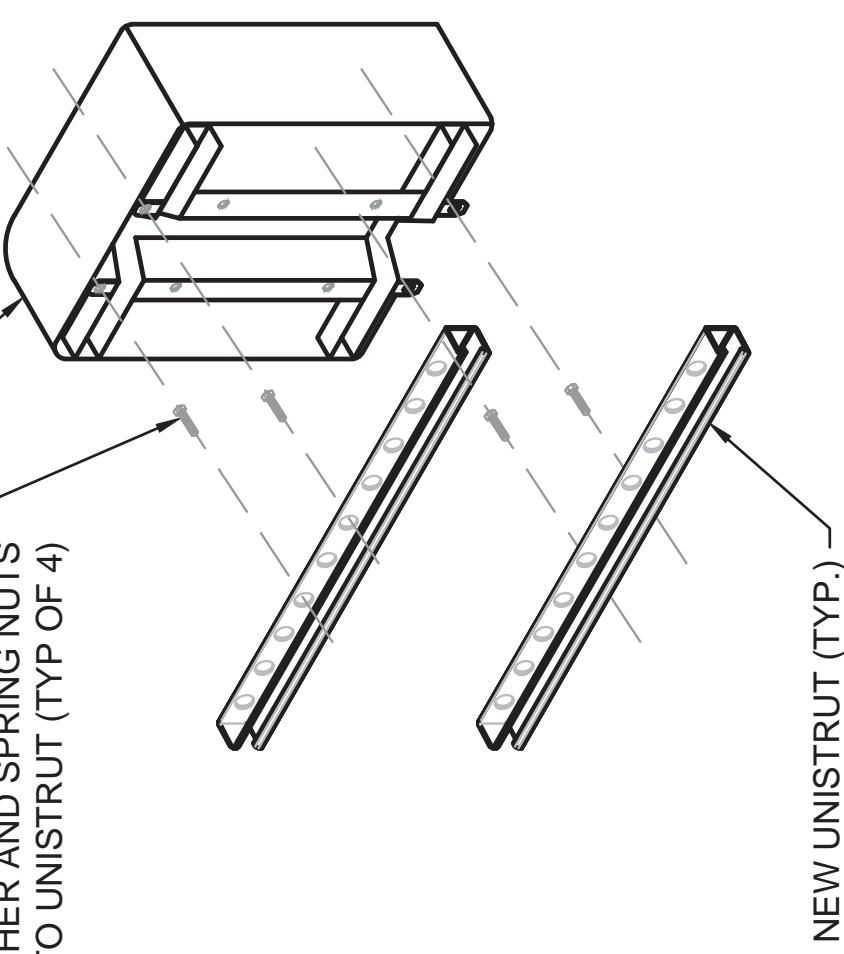 MANUFACTURER
 Exide Technologies Industrial Energy
 3950 Sussex Avenue
 Aurora, IL 60504-7932

DC12 SPECIFICATIONS

 SCALE
 N.T.S.

1

DC12 MOUNTING DETAIL

2


MF22-0009-00
APPLICATIONS
 Lossy Foam Absorber, constant loading, 1.0" thick

ELECTRICAL PERFORMANCE
 This performance data illustrates the insertion loss performance of this material. Insertion loss is measured in a transmission line test setup; for more information refer to Tech Bulletin 103. Additional electrical test data may be available upon request.

Solubility in Water (Bury acetate=1)	Less Than 1	Vapor Density (AIR=1)	Greater than 1
Appearance and Odor	A clear liquid with a sharp, penetrating, pungent odor. A battery is a manufactured article; no apparent odor.	% Volatiles by Weight	Not Applicable

FEATURES & BENEFITS

 Lightweight polyether ether ketone (PEEK)
 Co-extruded broadband material
 Easily applied with PSA
 Most broadband absorber material
 RoHS Compliant
 Halogen Free
 Dual use air filter/EMI absorber

TYPICAL PROPERTIES

 Thickness: 1/16" (2.54mm)
 Adhesive Thickness: 0.015" (0.12mm)
 Color: Black
 Operating Temperature: -40°F to 250°F

AVAILABILITY

 Standard Sizes: 24" x 24" (610 x 610 mm)
 Format: Sheets, Die Cut, Kiss Cut Pads
 MR22-0009-XX
 00: No PSA Backing
 >10: Die Cut

 Innovative Materials for Integrated Solutions
 sales@masttechnologies.com | www.masttechnologies.com | 1.858.452.1700
 Revision: 03/2018

Project Battery System Data

 Page 1 of 5
 ANY PHOTOCOPY MUST BE OF THIS ENTIRE DOCUMENT

4

5


C

A

G

6

RAYCAP DC12-48-60-0-25E:

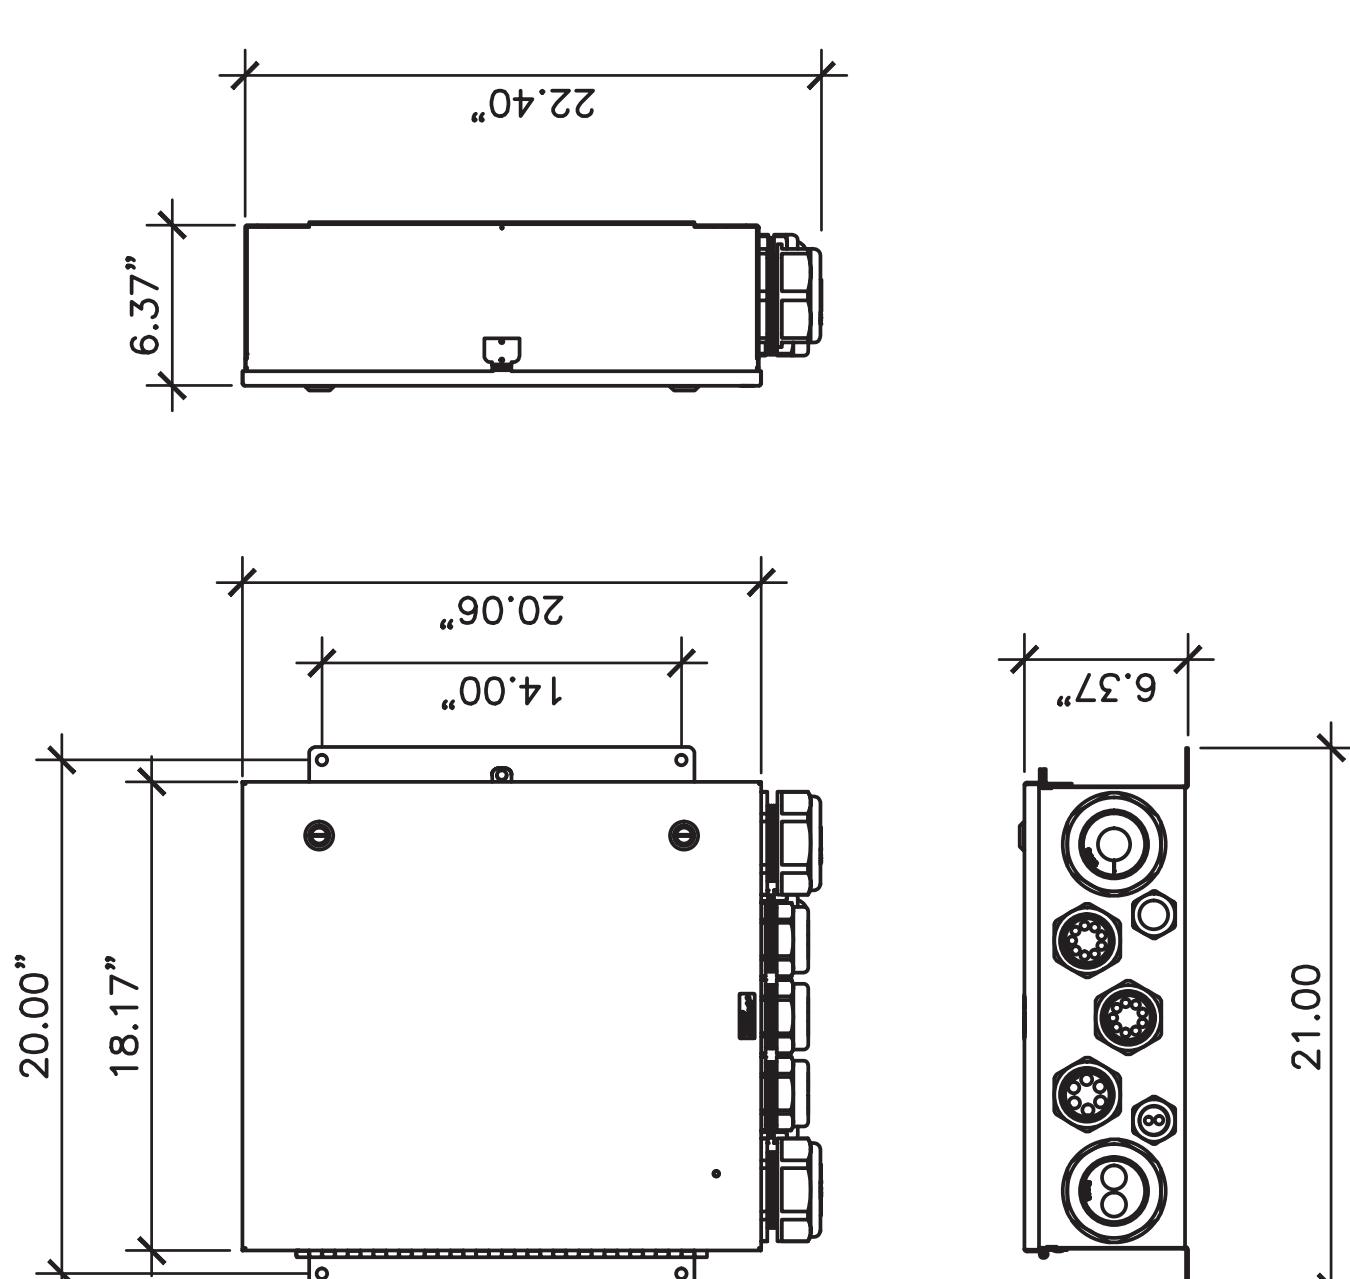 DIMENSIONS, LxWxH:
 NOMINAL OPERATING VOLTAGE: 48 V
 OPERATING DISCHARGE CURRENT: 20 KA 8/20ms
 MAX DISCHARGE CURRENT: 60 KA 8/20ms
 VOLTAGE PROTECTION LEVEL: (UP) PER IEC 61643-11:
 VOLTAGE PROTECTION RANKING (VPR): 700V
 TOTAL WEIGHT: 25.54 kg | 56.3 lbs

AIR6419 ANTENNA MOUNTING DETAIL

SCALE

N.T.S.

3

RF FOAM SPECIFICATIONS

4

DETAILS


MF22-0009-XX
PART NUMBERING
 MR22-0009-XX
 00: No PSA Backing
 >10: Die Cut

AVAILABILITY

 Standard Sizes: 24" x 24" (610 x 610 mm)
 Format: Sheets, Die Cut, Kiss Cut Pads

PROJECT NUMBER

 01: 0.005" PSA Backing
 10: Die Cut

GENERAL INFORMATION

All information on this sheet is based on laboratory tests and is not intended for legal purposes. MAST Technologies makes no representations or warranties of any kind concerning the data. For part number quality assurance specifications, please contact a MAST Technologies technical representative.

REVISION

Revision: 03/2018


Project Battery System Data

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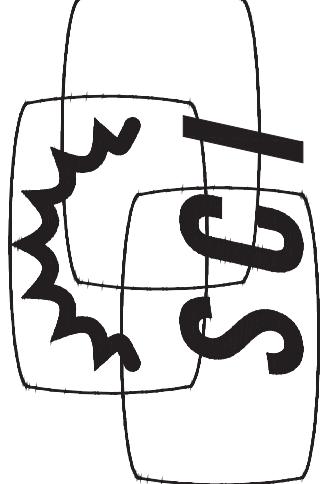



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COMMUNITY CONGREGATIONAL CHURCH

SITE #: SS0071
30'-0" MONOEUCALYPTUS

LOCATION:
2088 BERYL STREET
SAN DIEGO, CA 92109
SAN DIEGO COUNTY

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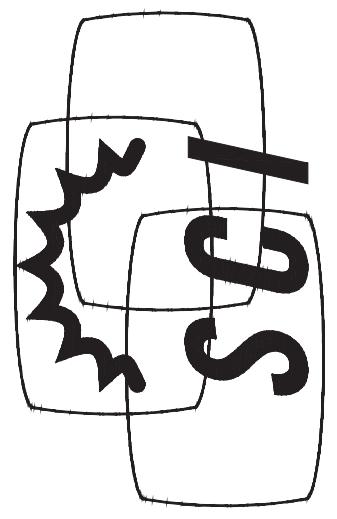
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<p>30'-0" MONOPOLE CATALYSTS SITE #: SS0071</p> <p>COMMUNITY CONGREGATIONAL CHURCH</p> <p>NOTES & SPECIFICATIONS</p>																						
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<h3>SPECIAL INSPECTIONS</h3>	
<p>1) CONTRACTOR SHALL FIELD VERIFY SITE OR LAYOUT RESTRICTIONS, SITE CONDITIONS, DIMENSIONS, AND ELEVATIONS BEFORE START OF CONSTRUCTION. ANY DISCREPANCIES SHALL BE BROUGHT TO THE ATTENTION OF SCI, INC. PRIOR TO BEGINNING PROJECT. ALL WORK SHALL BE PERFORMED USING ACCEPTED CONSTRUCTION PRACTICES. CONTRACTOR TO VERIFY MATERIALS PROVIDED BY SCI PRIOR TO INSTALLATION.</p> <p>2) ALL ENGINEERING PLANS, DRAWINGS, DESIGNS, CALCULATIONS AND SPECIFICATIONS (COLLECTIVELY, "PLANS") ARE DESIGNATED TO THE PROPRIETARY MANUFACTURER AUTHORIZED SOLELY FOR USE WITH PRODUCT PRODUCED BY SCI. UNAUTHORIZED USE IS STRICTLY PROHIBITED. CUSTOMER AGREES TO DEFEND, INDEMNIFY AND HOLD SCHARMLESS FROM AND AGAINST ANY AND ALL DEMANDS, CLAIMS, SUITS, PROCEEDINGS, LOSSES, LIABILITIES, DAMAGES, FEES, COSTS AND EXPENSES (INCLUDING, WITHOUT LIMITATION, ATTORNEY'S FEES AND COSTS), ARISING FROM OR RELATING TO ANY UNAUTHORIZED USE OF SCI'S PLANS BY CUSTOMER.</p> <p>3) NO FIELD MODIFICATIONS MAY BE MADE TO STRUCTURE WITHOUT THE EXPRESS WRITTEN CONSENT FROM THE ENGINEER OF RECORD. SCI, INC. AND ENGINEER OF RECORD ASSUME NO RESPONSIBILITY FOR THE STRUCTURE IF ALTERATIONS AND/OR ADDITIONS ARE MADE TO THE DESIGN AS SHOWN IN THESE DRAWINGS.</p> <p>4) THE CONTRACTORS AND ALL SUBCONTRACTORS SHALL COMPLY WITH ALL LOCAL CODES REGULATIONS, AND ORDINANCES AS WELL AS STATE DEPARTMENT OF INDUSTRIAL REGULATIONS AND DIVISION OF INDUSTRIAL SAFETY (OSHA) REQUIREMENTS.</p> <p>5) THE CONTRACTOR SHALL SUPERVISE AND DIRECT ALL WORK TO THE BEST OF HIS/HER ABILITY AND SKILL. CONTRACTOR SHALL BE SOLELY RESPONSIBLE FOR ALL CONSTRUCTION METHODS, TECHNIQUES, PROCEDURES, AND SEQUENCES, AND FOR COORDINATING ALL PORTIONS OF THE WORK UNDER THE CONTRACT.</p> <p>6) THE CONTRACTOR SHALL VERIFY, COORDINATE, AND PROVIDE ALL NECESSARY BLOCKING, BACKING, FRAMING, HANGERS OR OTHER SUPPORTS FOR ALL ITEMS REQUIRING SAME, WHETHER SHOWN OR NOT. THE CONTRACTOR SHALL BE RESPONSIBLE FOR ALL TEMPORARY BRACING, SHORING, FORMWORK ETC. AND SHALL CONFORM TO ALL NATIONAL, STATE, AND LOCAL ORDINANCES AND CODES, IN ORDER TO SAFELY EXECUTE ALL STAGES OF WORK TO COMPLETE THIS PROJECT.</p> <p>7) IT IS THE INTENT OF THESE DRAWINGS TO SHOW THE COMPLETED INSTALLATION OF THE STRUCTURE SHOWN.</p> <p>8) CONTRACTOR ASSUMES RESPONSIBILITY FOR JOB SITE CONDITIONS DURING THE COURSE OF CONSTRUCTION OF THE PROJECT, INCLUDING THE SAFETY OF ALL PERSONS AND PROPERTY IN ACCORDANCE WITH GENERALLY ACCEPTED CONSTRUCTION PRACTICES; THIS REQUIREMENT APPLIES CONTINUOUSLY, AND IS NOT LIMITED TO NORMAL WORKING HOURS.</p> <p>9) IT IS THE RESPONSIBILITY OF THE CONTRACTOR TO LOCATE ALL EXISTING UTILITIES, SHOWN OR NOT SHOWN, THE CONTRACTOR IS FINANCIALLY RESPONSIBLE FOR REPAIR OR REPLACEMENT OF UTILITIES OR OTHER PROPERTY DAMAGED IN CONJUNCTION WITH THE EXECUTION OF WORK ON THIS PROJECT.</p>	
<p>1. STEEL FABRICATION SHALL BE DONE ON THE PREMISES OF A FABRICATOR REGISTERED AND APPROVED AS REQUIRED BY THE BUILDING OFFICIAL TO PERFORM SUCH WORK WITHOUT SPECIAL INSPECTION. ALTERNATIVELY, SPECIAL INSPECTION OF MATERIALS, WELDING, AND FABRICATION PROCEDURES SHALL BE REQUIRED FOR FABRICATION BY AN UNAPPROVED FABRICATOR.</p> <p>2. NO FIELD WELDING SHALL BE PERMITTED</p> <p>3. THE FOLLOWING SPECIAL INSPECTIONS SHALL BE REQUIRED PER CHAPTER 17 OF THE BUILDING CODE:</p> <ul style="list-style-type: none"> • SPECIAL INSPECTION OF HIGH-STRENGTH BOLTING (WHEN APPLICABLE); • PERIODIC SPECIAL INSPECTION IF BOLTS ARE PRETENSIONED WITH MATCH-MARKING • CONTINUOUS SPECIAL INSPECTION IF BOLTS ARE PRETENSIONED WITH MATCH-MARKING • PERIODIC SPECIAL INSPECTION OF ALL OTHER HIGH-STRENGTH BOLTING • CONTINUOUS SPECIAL INSPECTION OF PLACEMENT OF REINFORCING STEEL • CONCRETE PLACEMENT • CONTINUOUS SPECIAL INSPECTION OF CONCRETE PLACEMENT OF ANCHOR BOLTS PRIOR TO AND DURING DRILLING OPERATIONS FOR PIER FOUNDATIONS • CONTINUOUS SPECIAL INSPECTION OF DRILLING OPERATIONS FOR PIER FOUNDATIONS • CONTINUOUS SPECIAL INSPECTION TO VERIFY LOCATION, PLUMBNESS, DIAMETER, AND LENGTH OF PIER FOUNDATIONS • SAMPLING & TESTING OF CONCRETE PER CHAPTER 17 OF THE BUILDING CODE TO VERIFY STRENGTH AND SLUMP • SPECIAL INSPECTION IS NOT REQUIRED FOR WORK OF A MINOR NATURE OR AS WARRANTED BY CONDITIONS IN THE JURISDICTION AS APPROVED BY THE BUILDING OFFICIAL. THIS, SPECIAL INSPECTION ITEMS ABOVE MAY BE WAIVED AS DEEMED APPROPRIATE BY THE BUILDING OFFICIAL. 	
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<h3>GENERAL NOTES</h3>	
<p>STRUCTURAL OBSERVATION</p>	
<p>DISCLAIMERS</p>	
<p>1. ALL STRUCTURAL COMPONENTS TO BE CONNECTED TOGETHER SHALL BE COMPLETELY FIT UP ON THE GROUND OR OTHERWISE VERIFIED FOR COMPATIBILITY PRIOR TO LIFTING ANY COMPONENT INTO PLACE. REPAIRS REQUIRED DUE TO FIT-UP OR CONNECTION COMPATIBILITY PROBLEMS AFTER PARTIAL ERECTION ARE THE FINANCIAL RESPONSIBILITY OF THE CONTRACTOR.</p> <p>2. SOME TELECOMMUNICATION STRUCTURES ARE SUSCEPTIBLE TO WIND-INDUCED OSCILLATIONS. OSCILLATIONS MAY OCCUR AT LOW OR MODERATE WIND SPEEDS AND MAY CAUSE STRUCTURAL DAMAGE. TIA PROVIDES NO PRACTICAL ANALYTICAL METHOD TO PREDICT AND PREVENT WIND-INDUCED STRUCTURAL OSCILLATIONS. VECTOR STRUCTURAL ENGINEERING RECOMMENDS FREQUENT MONITORING TO IDENTIFY WIND-INDUCED OSCILLATION AND REGULAR CONDITION ASSESSMENTS TO IDENTIFY DEFECTS, ANY OSCILLATION OR DEFECTS OBSERVED SHALL BE IMMEDIATELY REPORTED TO VECTOR STRUCTURAL ENGINEERING FOR FURTHER EVALUATION AND POSSIBLE REPAIRS OR MODIFICATIONS WHICH MAY BE REQUIRED AT THE OWNER'S EXPENSE.</p> <p>3. WHERE EFFECTIVE PROJECTED AREAS (EPA) ARE USED, IT IS THE RESPONSIBILITY OF OTHERS TO VERIFY INSTALLED EQUIPMENT DOES NOT EXCEED LISTED EPA.</p>	
<h3>STRUCTURAL STEEL</h3>	
<p>1. POLYGONAL MONOPOLE SHAFT STEEL SHALL CONFORM w/ ASTM A572 GR. 65, U.N.O.</p> <p>2. BASEPLATE STEEL SHALL CONFORM w/ ASTM A572 GR. 50, U.N.O.</p> <p>3. REINFORCED PORT STEEL SHALL CONFORM w/ ASTM A572 GR. 50, OR EQUIVALENT, U.N.O.</p> <p>4. ALL OTHER STEEL SHAPES & PLATES SHALL CONFORM w/ ASTM A36, U.N.O.</p> <p>5. ALL BOLTS FOR STEEL-TO-STEEL CONNECTIONS SHALL CONFORM w/ ASTM F3125 GR. A325, U.N.O.</p> <p>6. ALL ANCHOR BOLTS SHALL CONFORM w/ ASTM F1554 GR. 55, U.N.O.</p> <p>7. ALL WELDING SHALL BE PERFORMED IN ACCORDANCE WITH THE SPECIFICATIONS AND PROCEDURES OF THE AMERICAN WELDING SOCIETY (AWS) BY CERTIFIED WELDERS PER AWS D1.1. WELDS SHALL BE PERFORMED WITH MINIMUM E70XX LOW-HYDROGEN ELECTRODE EXCEPT WHERE HIGHER STRENGTH ELECTRODE IS REQUIRED BY AWS D1.1. F2329 STANDARDS.</p> <p>8. ALL STEEL SURFACES SHALL BE SMOOTH AND VIBRATION FREE IN ACCORDANCE w/ ASTM A123 AND ASTM A36, U.N.O.</p> <p>9. ALL STRUCTURAL BOLTS SHALL BE TIGHTENED PER AN APPROVED PRETENSIONING METHOD AS DEFINED BY AISC. FOR EASE OF INSPECTION, THE "TURN-OF-NUT" METHOD AS DEFINED BY AISC, IS RECOMMENDED.</p> <p>10. ALL BOLT HOLES SHALL BE STANDARD SIZE PER TABLE 33.3 OF AISI U.N.O. WASHERS ARE REQUIRED FOR ANY CONNECTION THAT HAS LARGER THAN STANDARD SIZED BOLT HOLES.</p> <p>11. ALL HEAVY HEX NUTS SHALL BE ASTM A563 GR. C OR D OR EQUIVALENT.</p> <p>12. ALL HARDENED WASHERS SHALL BE ASTM F436 OR EQUIVALENT.</p>	
<h3>BASE DESIGN REACTIONS</h3>	
<p>MOMENT, M = 207 K-FT (1.0 WIND) SHEAR, V = 14 K (1.0 WIND) AXIAL, R = 11.3 K (1.2 DEAD)</p>	

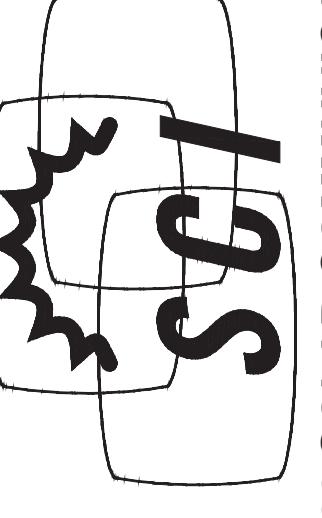

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DATE: 11/18/22

DESIGNED: EME

DRAFTER: EME

REVISIONS

REV

DATE

DESCRIPTION

30'-0" MONO-EUCA LYPTUS
SITE #: SS0071
COMMUNITY CONGREGATIONAL CHURCH
2088 BERYL STREET
SAN DIEGO, CA 92109
SAN DIEGO COUNTY



11/08/2022

U1085.1795.221


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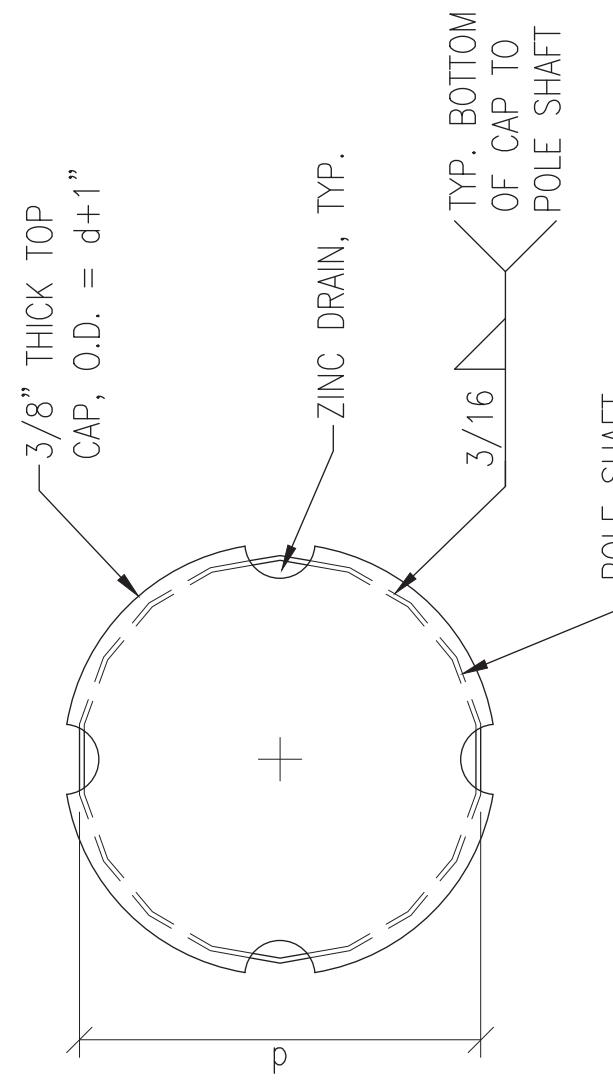
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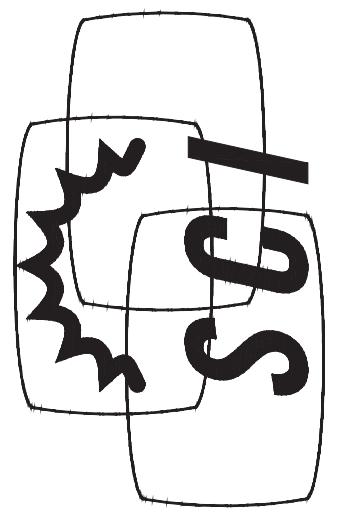
BASEPLATE

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TOP CAP

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REV	DATE	DESCRIPTION

AT&T

30'-0" MONO-EUCALYPTUS
SITE #: SS0071
COMMUNITY CONGREGATIONAL CHURCH
2088 BERYL STREET
SAN DIEGO, CA 92109

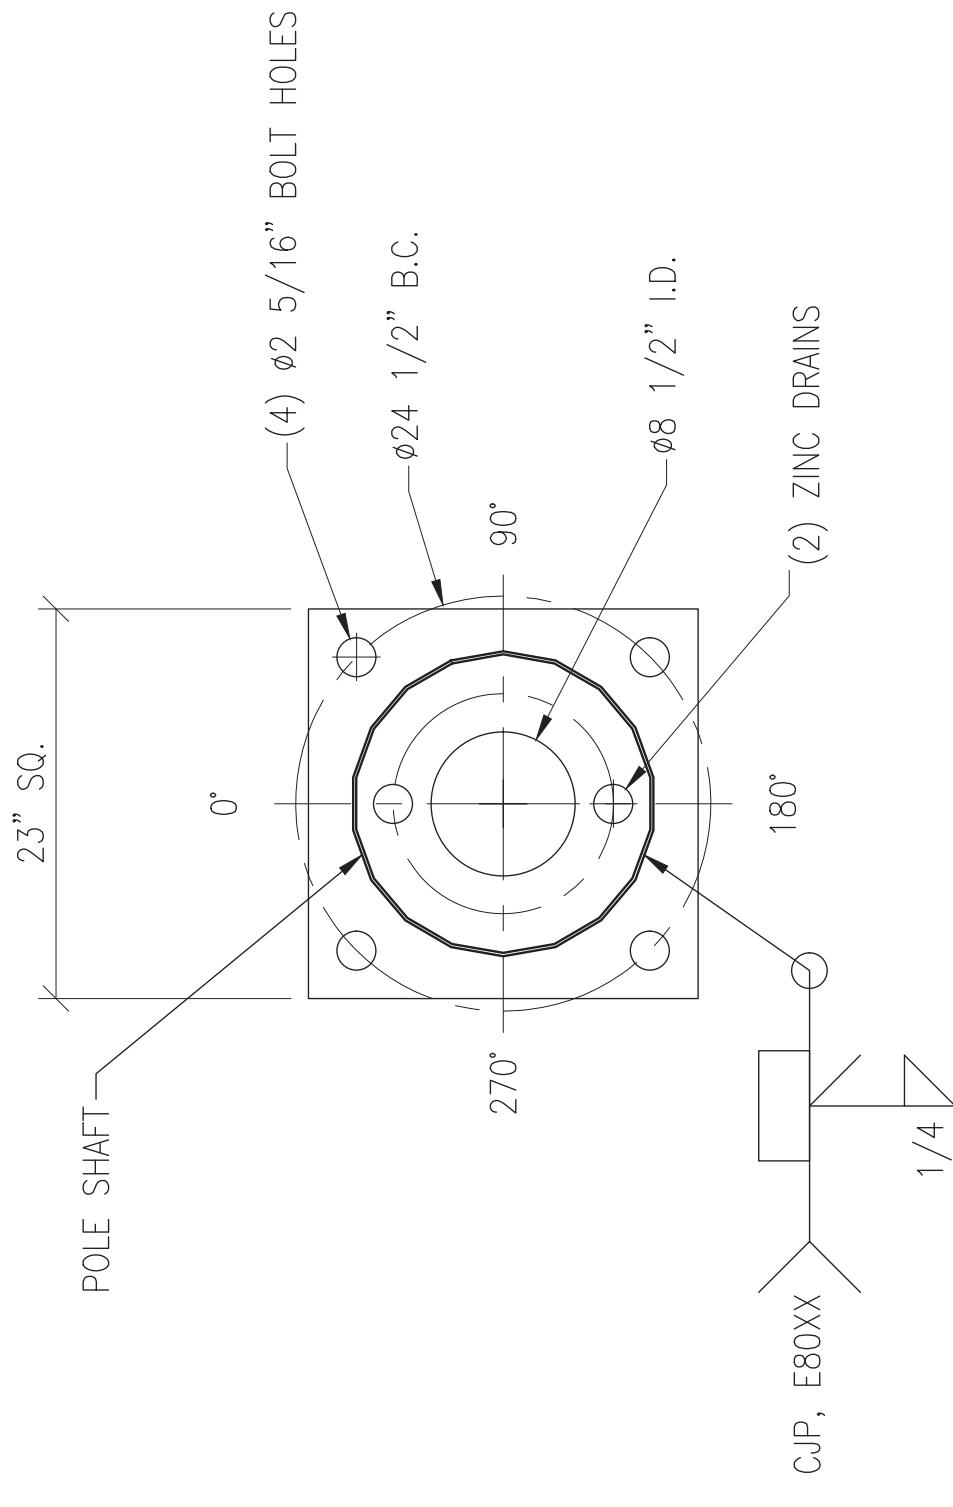

11/08/2022


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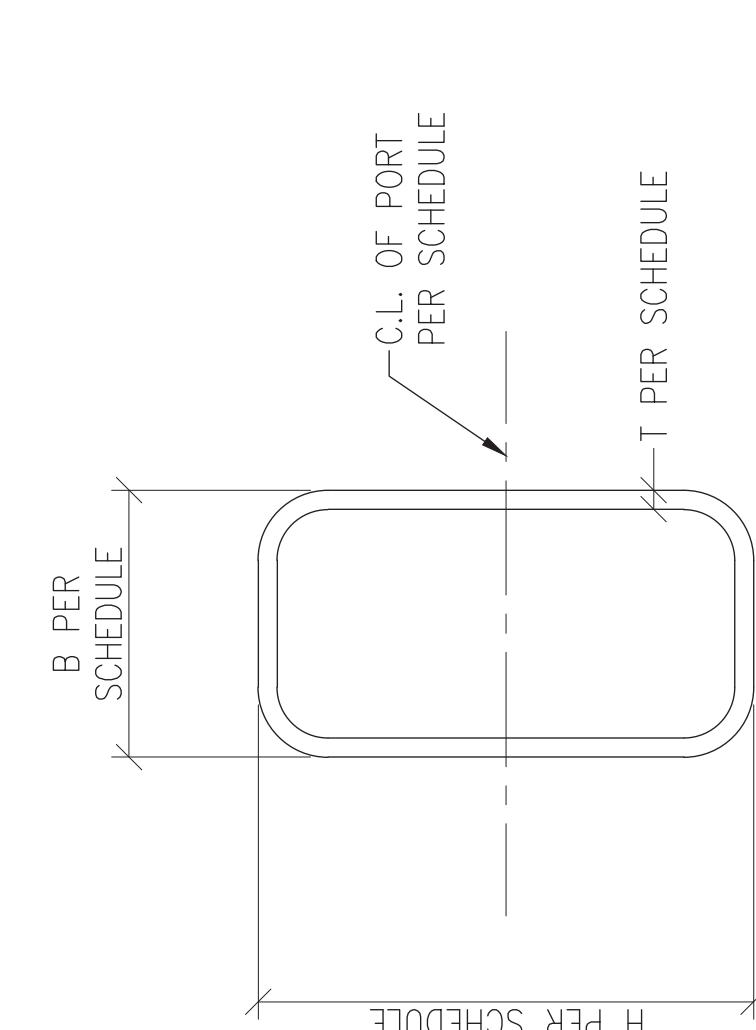
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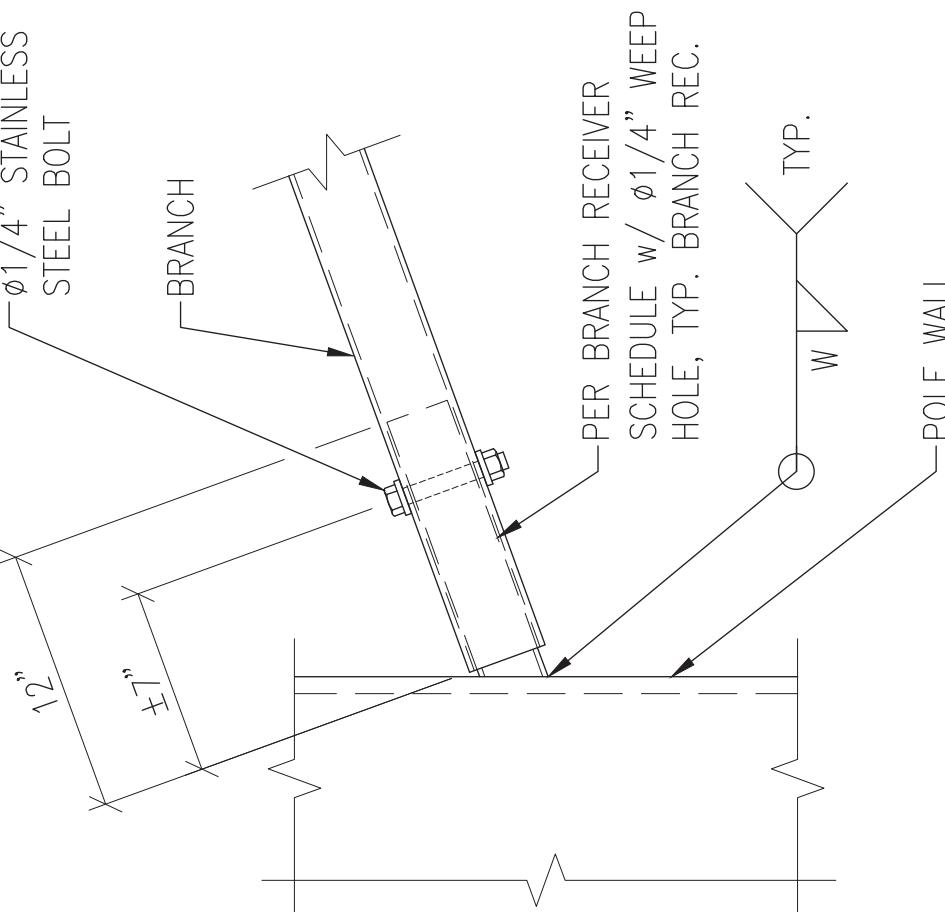
NOTE: SEE GENERAL
NOTES FOR REINFORCED
PORT MATERIAL GRADE.



ELEVATION VIEW

NOTE: SEE SCHEDULE FOR
PORT QUANTITY & AZIMUTHS

NOTE: SEE DTL 3/S1 FOR
POLE SHAFT THICKNESS, t

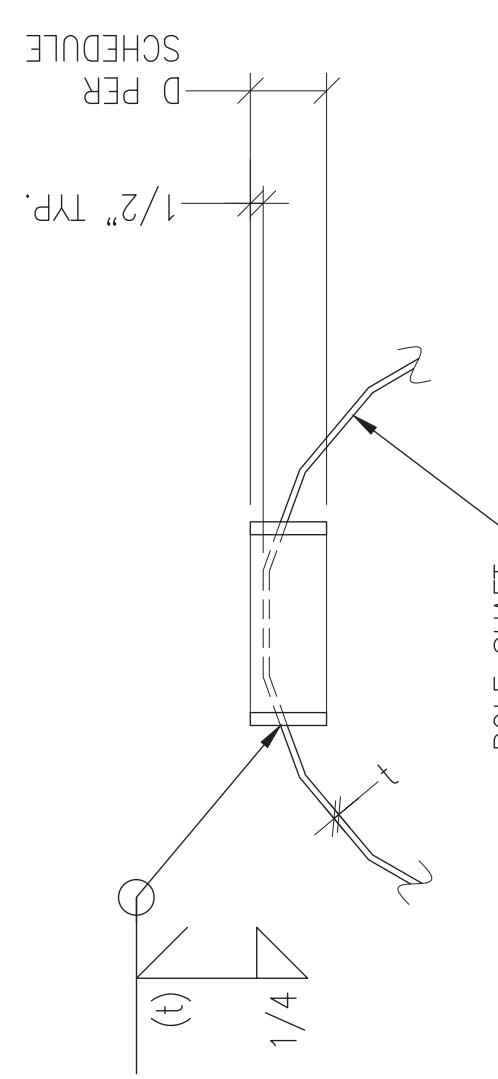

BRANCH RECEIVER SCHEDULE

BRANCH LENGTH	YIELD STRENGTH (KSI)	SIZE	W
4'-0"	35	1 1/4" SCH 40	3/16
6'-0"	35	1 1/4" SCH 40	3/16
8'-0"	35	1 1/4" SCH 40	3/16
10'-0"	35	1 1/4" SCH 40	3/16
12'-0"	35	1 1/4" SCH 80	1/4

NOTE: BRANCH RECEIVERS ARE DESIGNED FOR A MAX WIND SPEED OF 110 MPH (REV G OR H), EXPOSURE C, AND MAX HEIGHT FOR 4'-8' BRANCHES IS 120' A.G.L. 10' BRANCHES ARE LIMITED TO 80'-0" A.G.L. AND 12' TO A HEIGHT OF 45' A.G.L.

TYPICAL BRANCH RECEIVER


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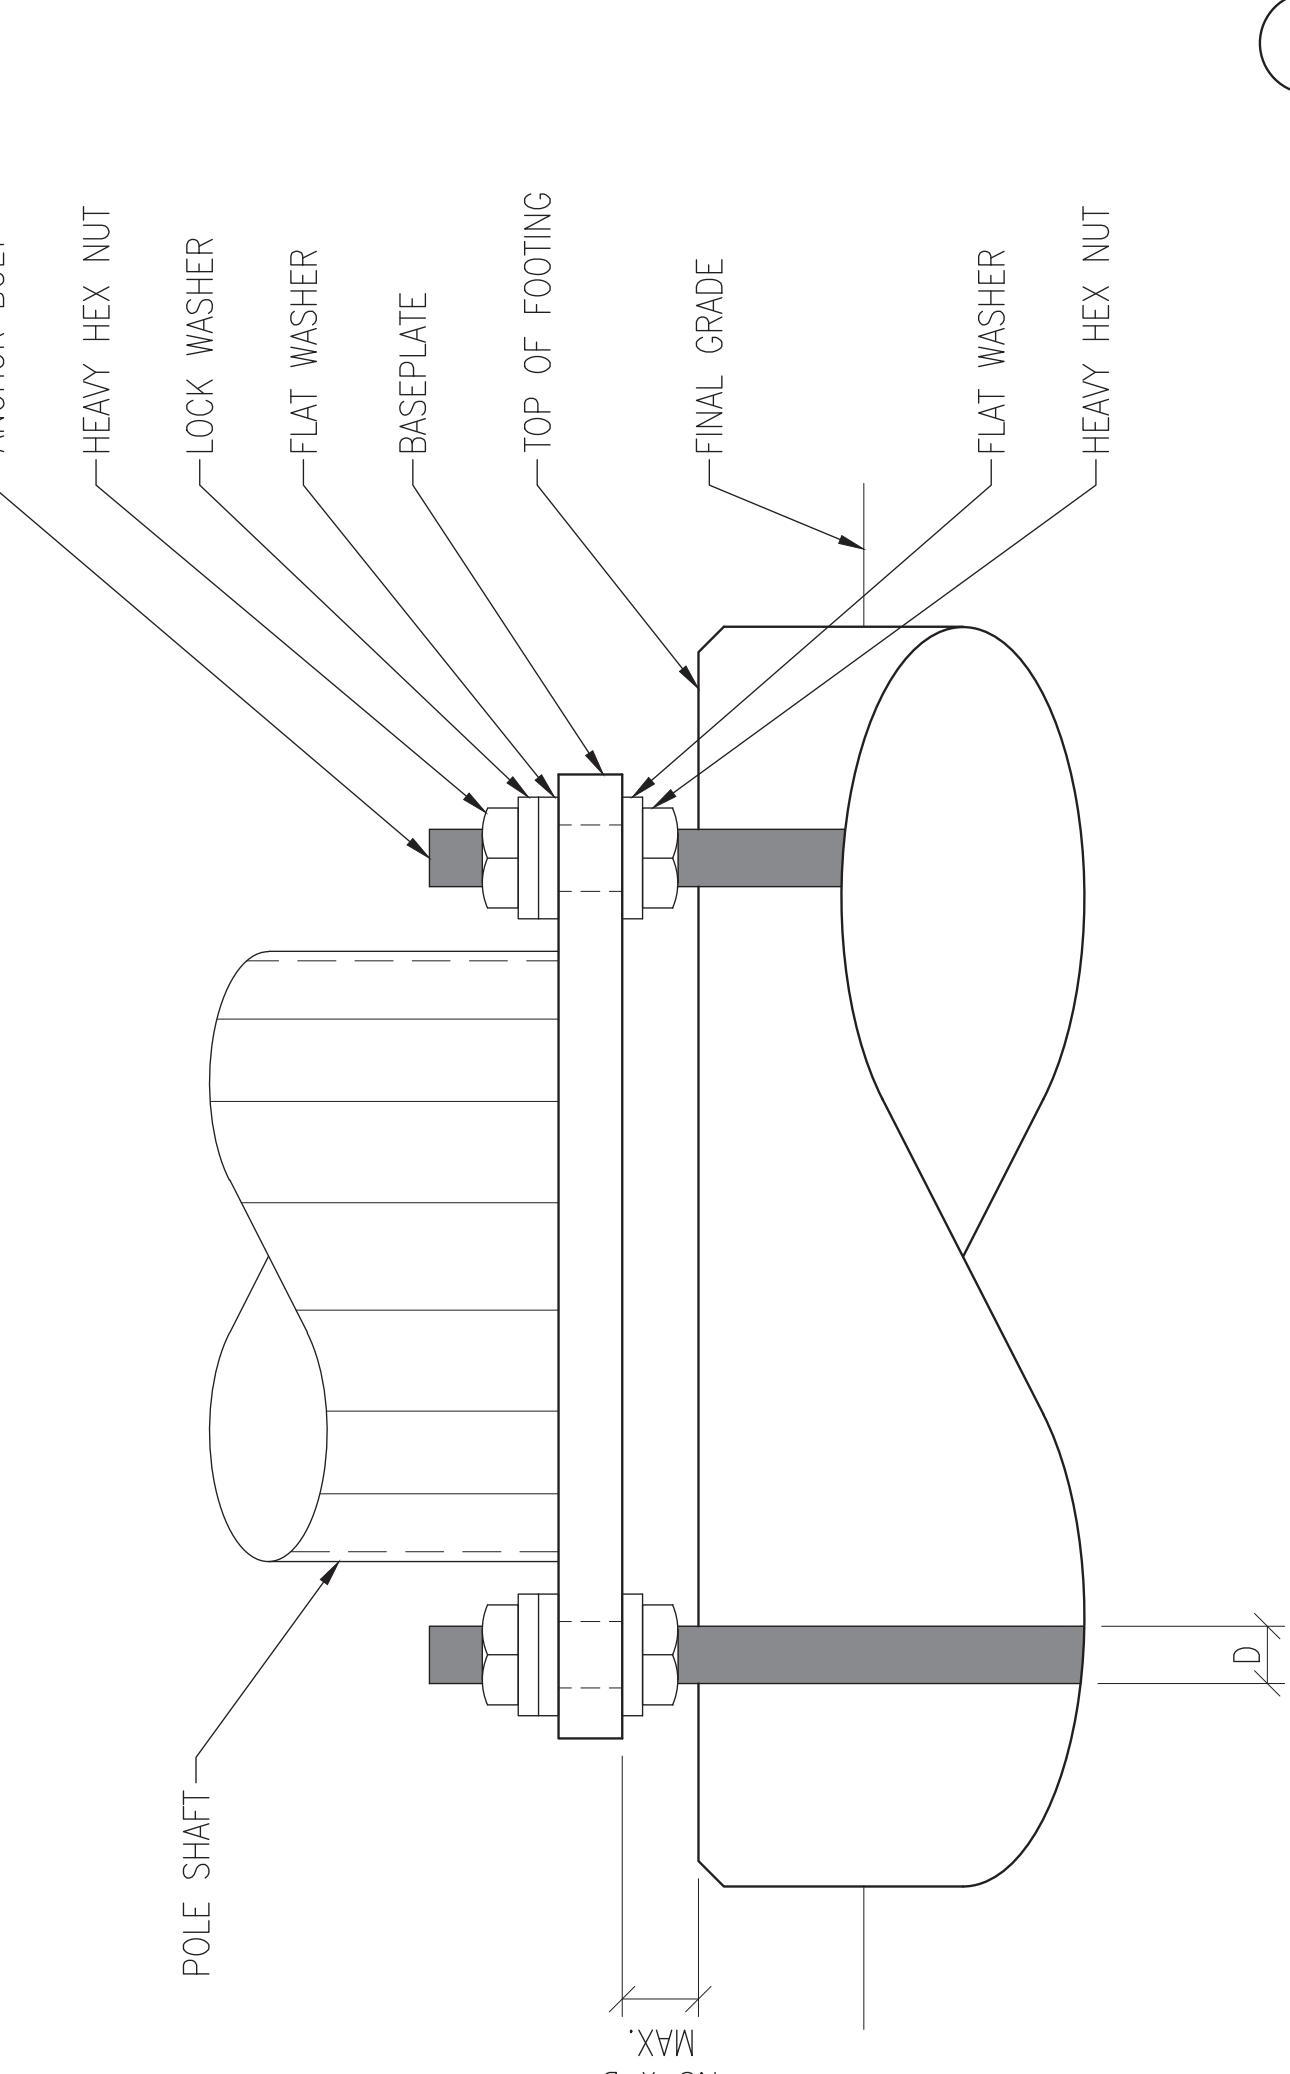
PORT SCHEDULE					
C.L. ELEV.	PORT SIZE (B x H)	D	T	QTY	AZIMUTH(S)
24'-0"	6"x12"	3"	1/2"	3	120° SEPARATION
3'-0"	10"x20"	3.5"	3/4"	2	180° SEPARATION

FOUNDATION NOTES

- FOUNDATION DESIGN IS BASED ON THE FOLLOWING GEOTECHNICAL REPORT:
TORO INTERNATIONAL
REPORT: 22-008-1
DATE: OCTOBER 27, 2022
- ALL CONCRETE SHALL USE TYPE II PORTLAND CEMENT AND HAVE A MINIMUM COMPRESSIVE STRENGTH OF 4000 PSI AT 28 DAYS.
CONCRETE SHALL HAVE A MINIMUM OF 8% ENTRAINED AIR (WHERE CONCRETE DEPTH > 0'), CONCRETE SHALL HAVE A MAXIMUM WATER/CEMENT RATIO OF 0.50. CONCRETE SHALL HAVE A SLUMP OF 5'-4" (41") UNLESS OTHERWISE SPECIFIED IN THE GEOTECHNICAL REPORT. ALL CONCRETE WORK SHALL BE IN ACCORDANCE WITH THE BUILDING CODE REQUIREMENTS FOR REINFORCED CONCRETE, ACI 318-14 FOUNDATION INSTALLATION SHALL BE IN ACCORDANCE WITH ACI 336, "STANDARD SPECIFICATIONS FOR THE CONSTRUCTION OF DRILLED PIERS", LATEST EDITION.
- REINFORCING STEEL SHALL CONFORM WITH THE REQUIREMENTS OF ASTM A-615, GRADE 60. ALL REINFORCING DETAILS SHALL CONFORM TO MANUAL OF STANDARD PRACTICE FOR DETAILING REINFORCED CONCRETE STRUCTURES, ACI 315, LATEST EDITION, UNLESS DETAILED OTHERWISE ON THIS DRAWING. CONTRACTOR SHALL USE STEEL WIRE TO HOLD REINFORCING BARS TOGETHER. IF WELDING REBAR IS PREFERRED, SUBSTITUTE A706 GR. 60 DEFORMED BARS.
- CONTRACTOR IS RESPONSIBLE FOR CHECKING AREA FOR UNDERGROUND FACILITIES PRIOR TO EXCAVATING ANY MATERIALS.
- CONTRACTOR SHALL REFER TO SOILS REPORT FOR SITE CONDITIONS AND FURTHER CONSTRUCTION INFORMATION.
- CONTRACTOR SHALL INSPECT AND REMOVE ALL DEBRIS FROM BOTTOM OF EXCAVATION.
- CONTRACTOR SHALL VERIFY ANCHOR BOLT LAYOUT PRIOR TO AND IMMEDIATELY AFTER PLACING CONCRETE. ANCHOR BOLT LAYOUT IS CRITICAL FOR STRUCTURE INSTALLATION.
- CONCRETE SHALL BE CONSOLIDATED USING VIBRATORY METHODS THROUGHOUT DEPTH OF FOUNDATION. VIBRATING LOWER DEPTHS MAY NOT BE ACCOMPLISHED BY TOUCHING REBAR CAGE WITH VIBRATOR.
- DEPENDING ON SOIL CONDITIONS, CONTRACTOR SHOULD ANTICIPATE THE USE OF A FULL-LENGTH TEMPORARY CASING TO STABILIZE THE EXCAVATION. THE CASING SHALL BE WITHDRAWN DURING THE PLACEMENT OF CONCRETE IN THE EXCAVATED HOLE. CONCRETE SHALL NOT FREE FALL. CONCRETE MAY BE PLACED BELOW WATER USING TREMIE METHODS.
- ANCHOR BOLTS, AND CONCRETE SHALL BE PLACED WITHIN 24 HOURS OF COMPLETING THE EXCAVATION. COLD JOINTS ARE NOT ALLOWED. UNO.
- THE CONTRACTOR IS RESPONSIBLE FOR VERIFYING ADEQUATE CONCRETE COVERAGE OVER REINFORCING BARS. UNLESS OTHERWISE NOTED, CONTRACTOR SHALL USE 3" CONCRETE COVER OVER REBAR. TOP OF FOOTING SHALL BE TROWEL LEVEL AND SMOOTH.
- INSTALLATION OF FOUNDATION MUST BE OBSERVED BY A REPRESENTATIVE OF THE GEOTECHNICAL ENGINEER FIRM. GEOTECHNICAL ENGINEER TO PROVIDE A NOTICE OF INSPECTION FOR THE BUILDING INSPECTOR FOR REVIEW AND RECORD PURPOSES.
- CONTRACTOR SHALL REFER TO GEOTECHNICAL REPORT FOR INFORMATION REGARDING INSTALLATION METHOD, REQUIRED INSTALLATION EQUIPMENT, AND ALL OTHER REQUIREMENTS RELATED TO THE INSTALLATION OF THE PIER.
- STRUCTURE MAY BE ERECTED 3-DAYS AFTER FOUNDATION IS INSTALLED AND ONCE CONCRETE STRENGTH IS AT LEAST 4000 PSI.



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N.T.S.

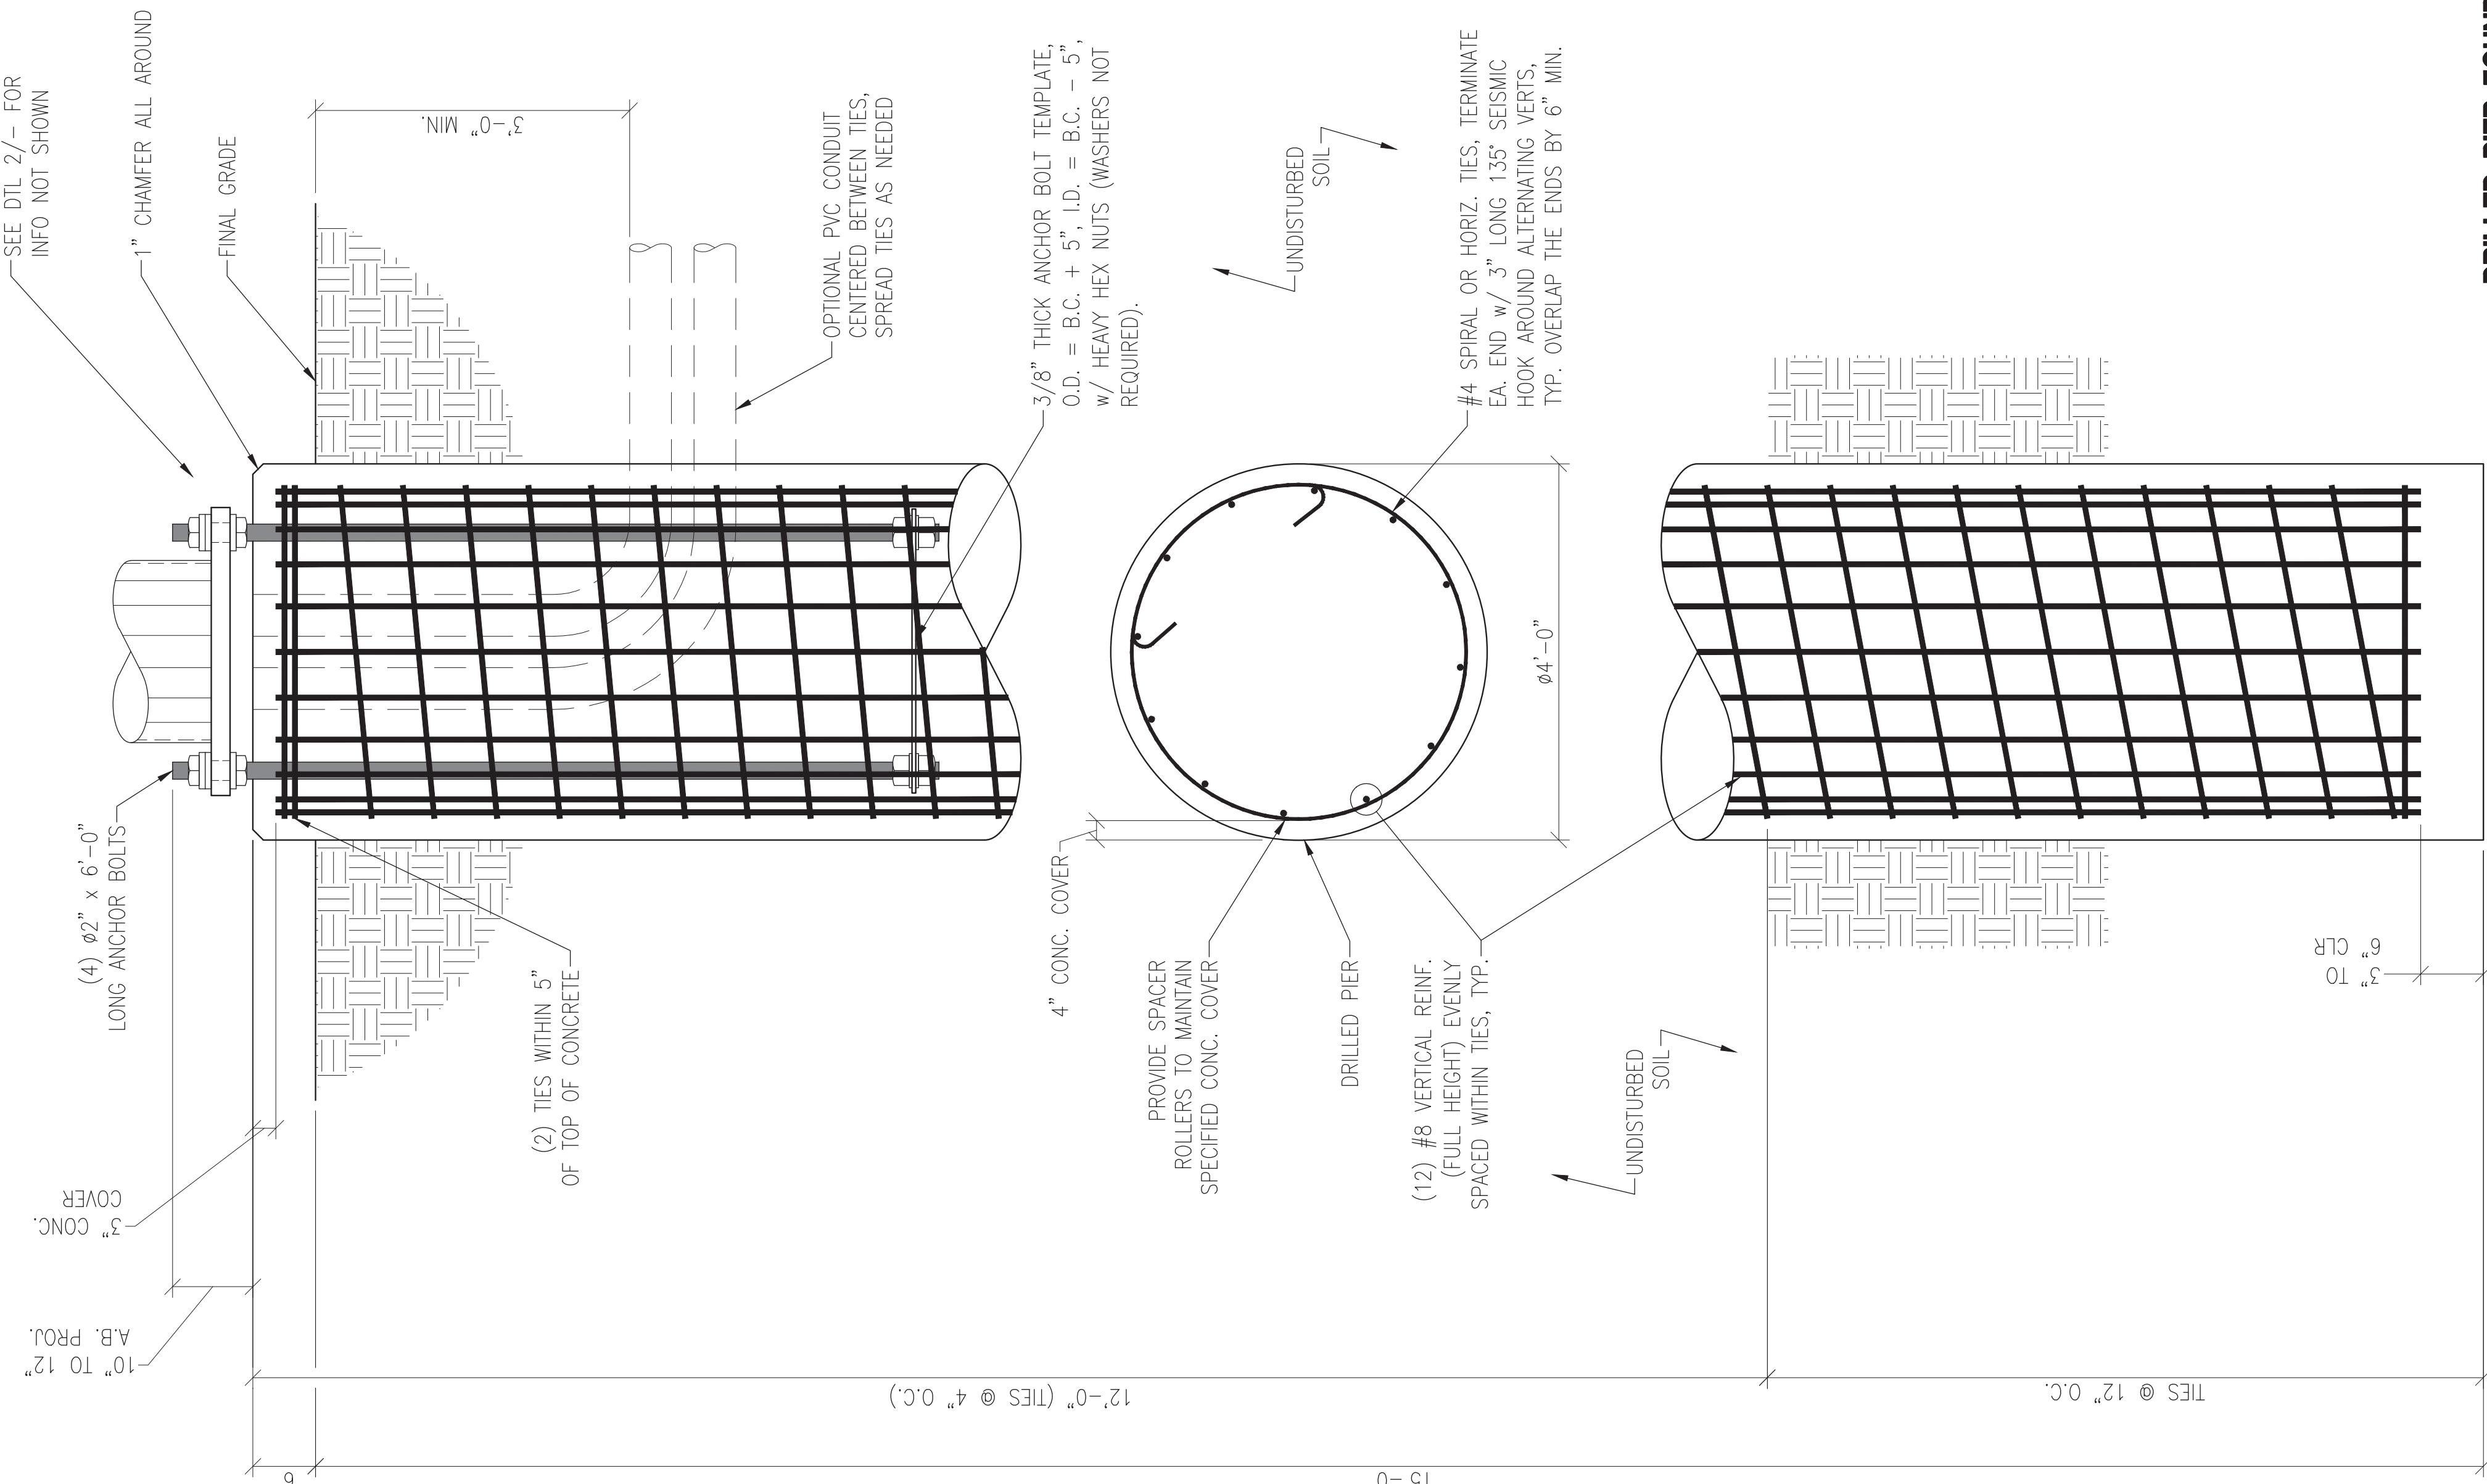DRILLED PIER FOUNDATION

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DATE: 11/8/22

DESIGNED: EME DRAFTER: EME

REV: 1

DESCRIPTION

REV	DATE

30'-0" MONOECALYPTUS
SITE #: SS0071

COMMUNITY CONGREGATIONAL CHURCH
DRILLED PIER FOUNDATION

SAN DIEGO COUNTY
SAN DIEGO, CA 92109



11/08/2022


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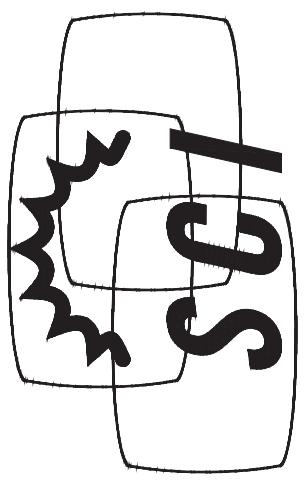
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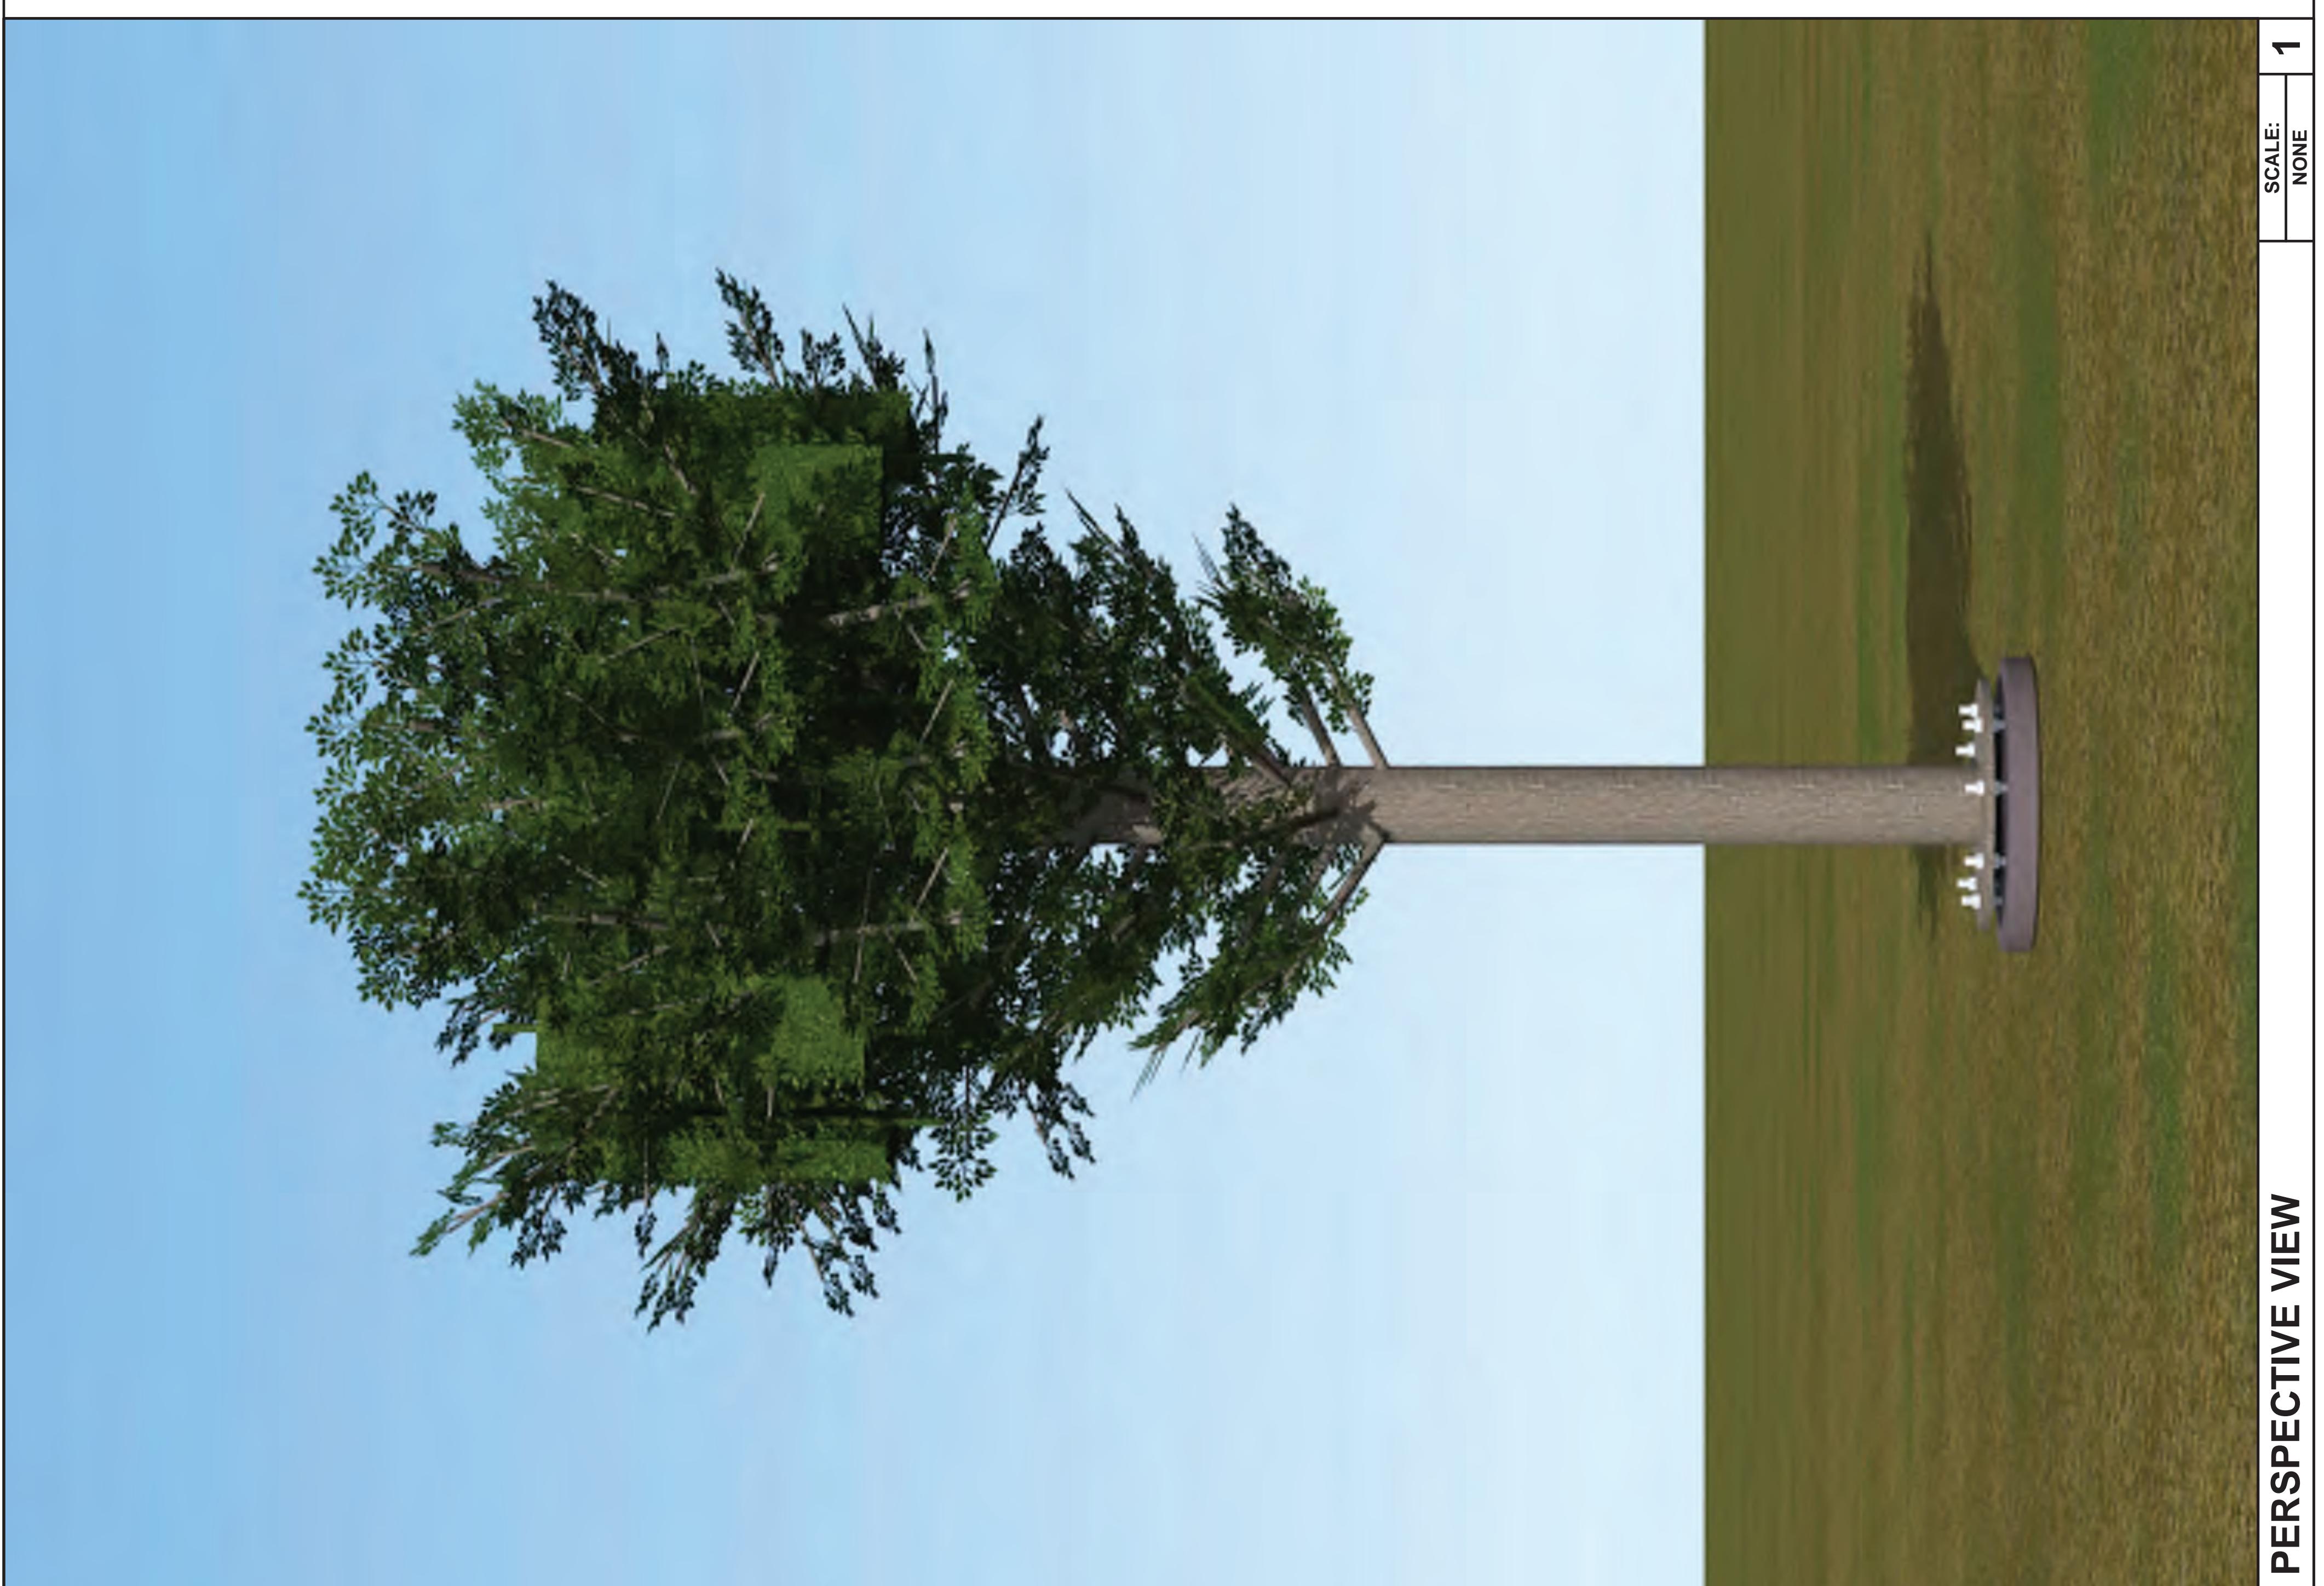
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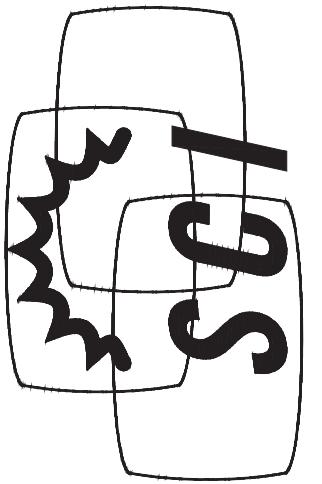
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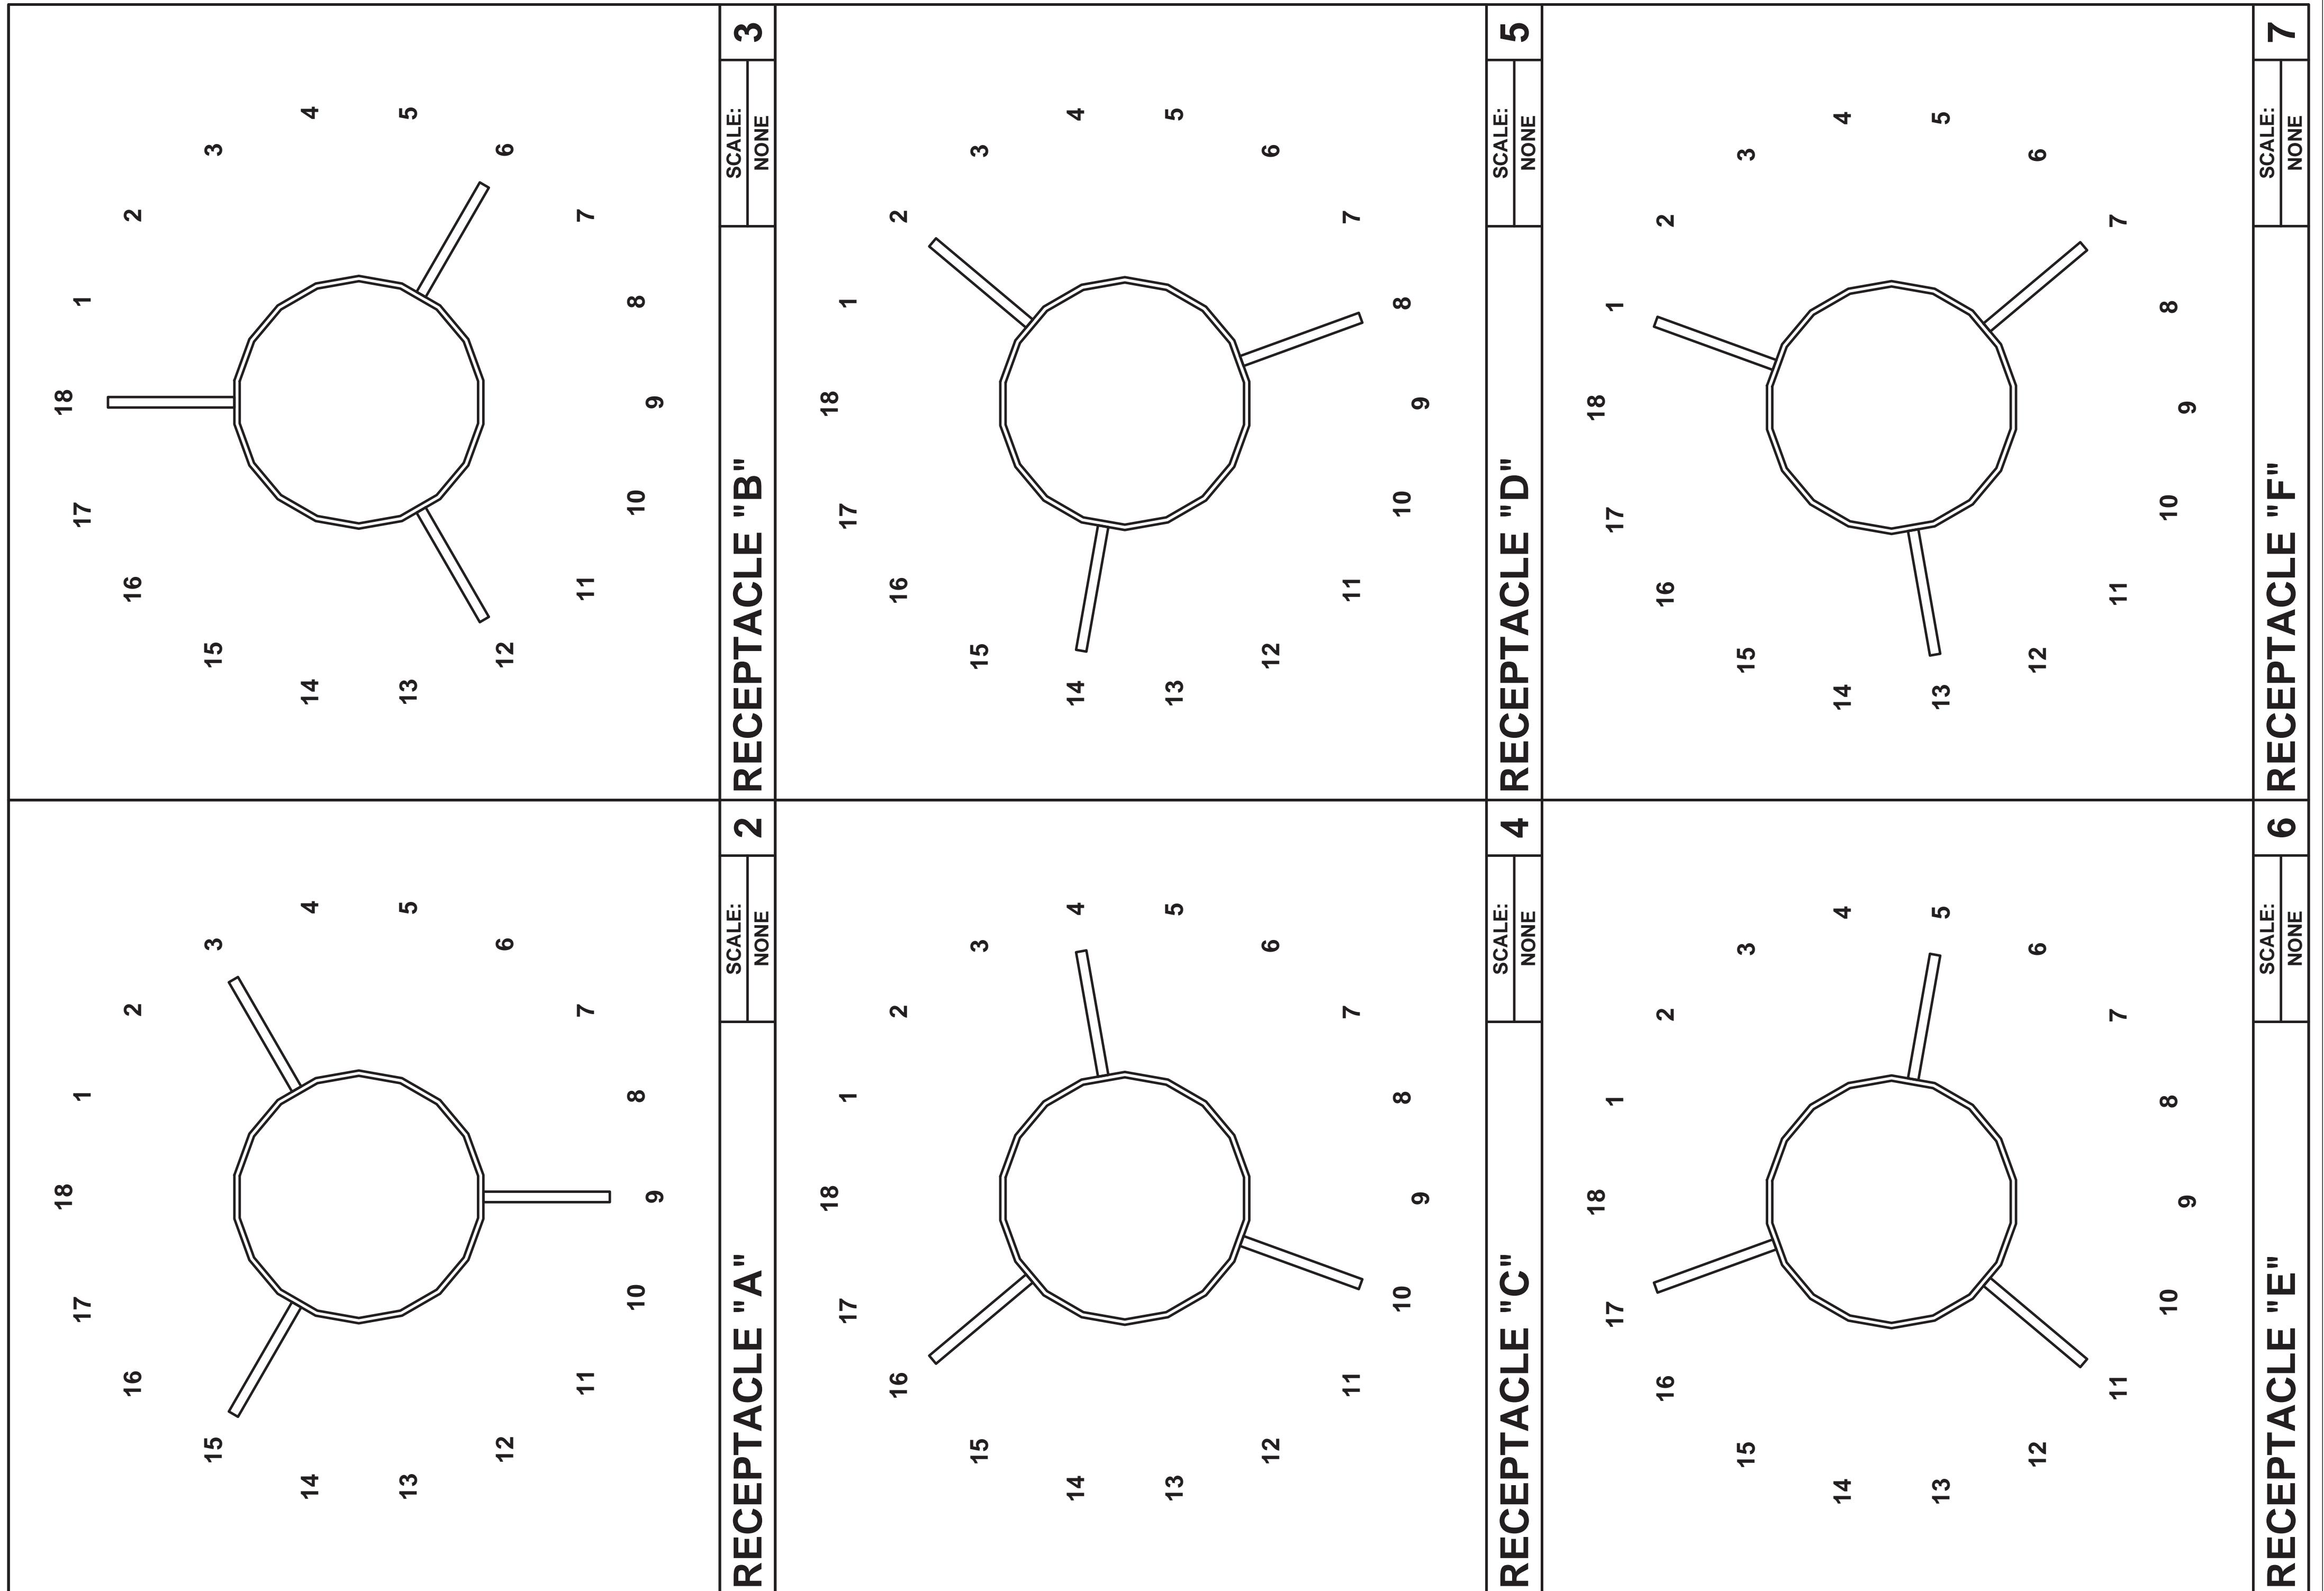
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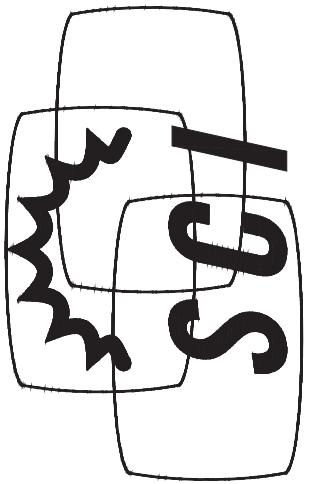





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CLIENT	PROJECT																				
<p>LOCATION — COMMUNITY CONGREGATIONAL CHURCH 2088 BERM STREET SAN DIEGO, CA 92109 SAN DIEGO COUNTY</p> <p>ISSUED FOR — PRODUCTION</p> <p>OWN BY — CKD BY — DATE — MAQ LEM 11NOV22</p>																					
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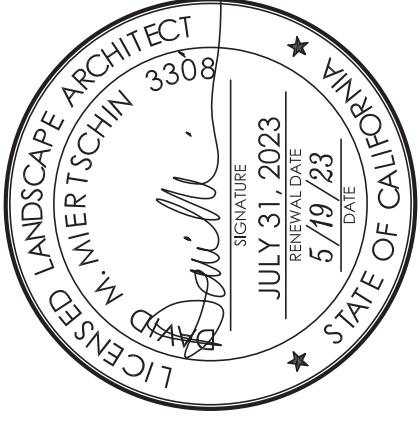
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PROJECT	LOCATION	30'-0" MONOEUCALYPTUS
COMMUNITY CONGREGATIONAL CHURCH 2088 BERYL STREET SAN DIEGO, CA 92109 SAN DIEGO COUNTY	ISSUED FOR	PRODUCTION
DW/N BY _____ CK'D BY _____ DATE _____	MAQ	LEM 10NOV22
REVISIONS	REV.	DATE
		BY
		ENGINEER SEAL
SHEET TITLE	ELEVATION & PLAN VIEW	
WSC PROJECT NUMBER		
DRAWING NUMBER		
PAGE NUMBER		
RF-1		



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CLIENT	PROJECT	LOCATION
	30'-0" MONOEUCALYPTUS	COMMUNITY CONGREGATIONAL CHURCH 2088 BERYL STREET SAN DIEGO, CA 92109 SAN DIEGO COUNTY
ISSUED FOR	PRODUCTION	D/W/N BY CK'D BY DATE
	MAQ LEM 10NOV22	REV. CHANGES DATE BY
ENGINEER SEAL		
DETAILS VIEW		
WSC PROJECT NUMBER		
DRAWING NUMBER		
PAGE NUMBER		
RF-2		
SCALE: NONE		

ELEVATION VIEW	PLAN VIEW																
																	
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PLAN VIEW																	
																	
RECEP TACLE FOR 4', 6', 8' & 10'																	
SCALE: NONE	2 RECEP TACLE DETAIL	SCALE: NONE															
3	BRANCH LAYOUT	6															

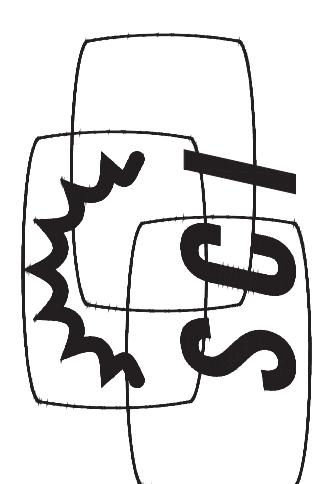
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THIS IS NOT A SURVEY

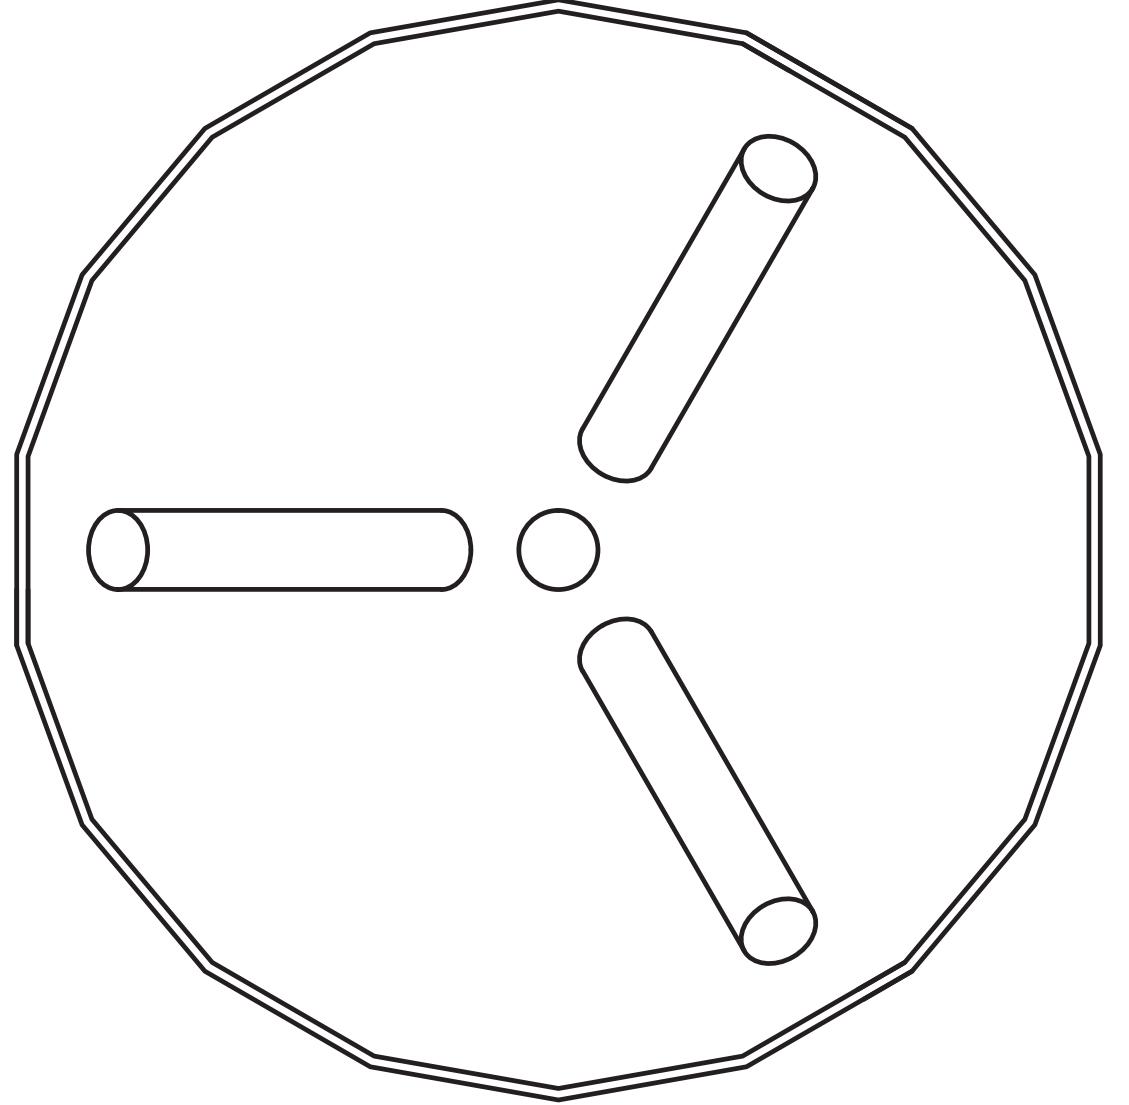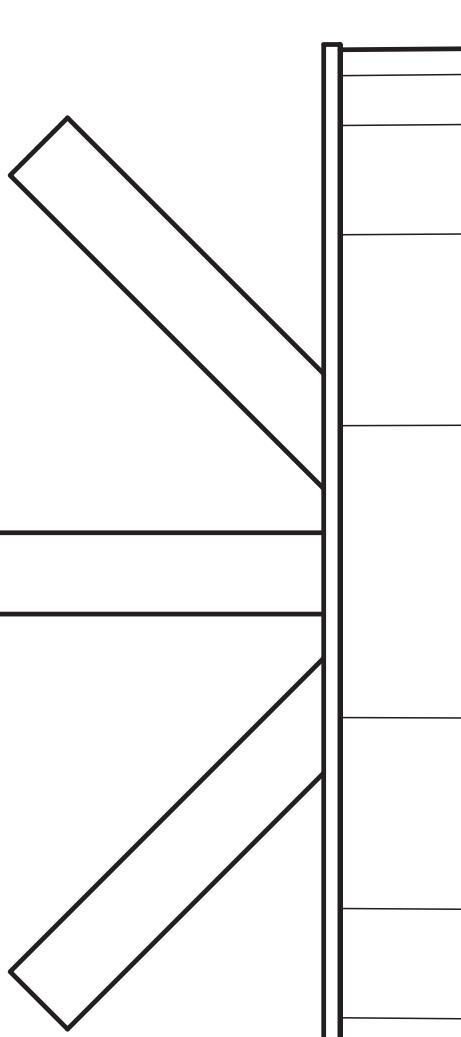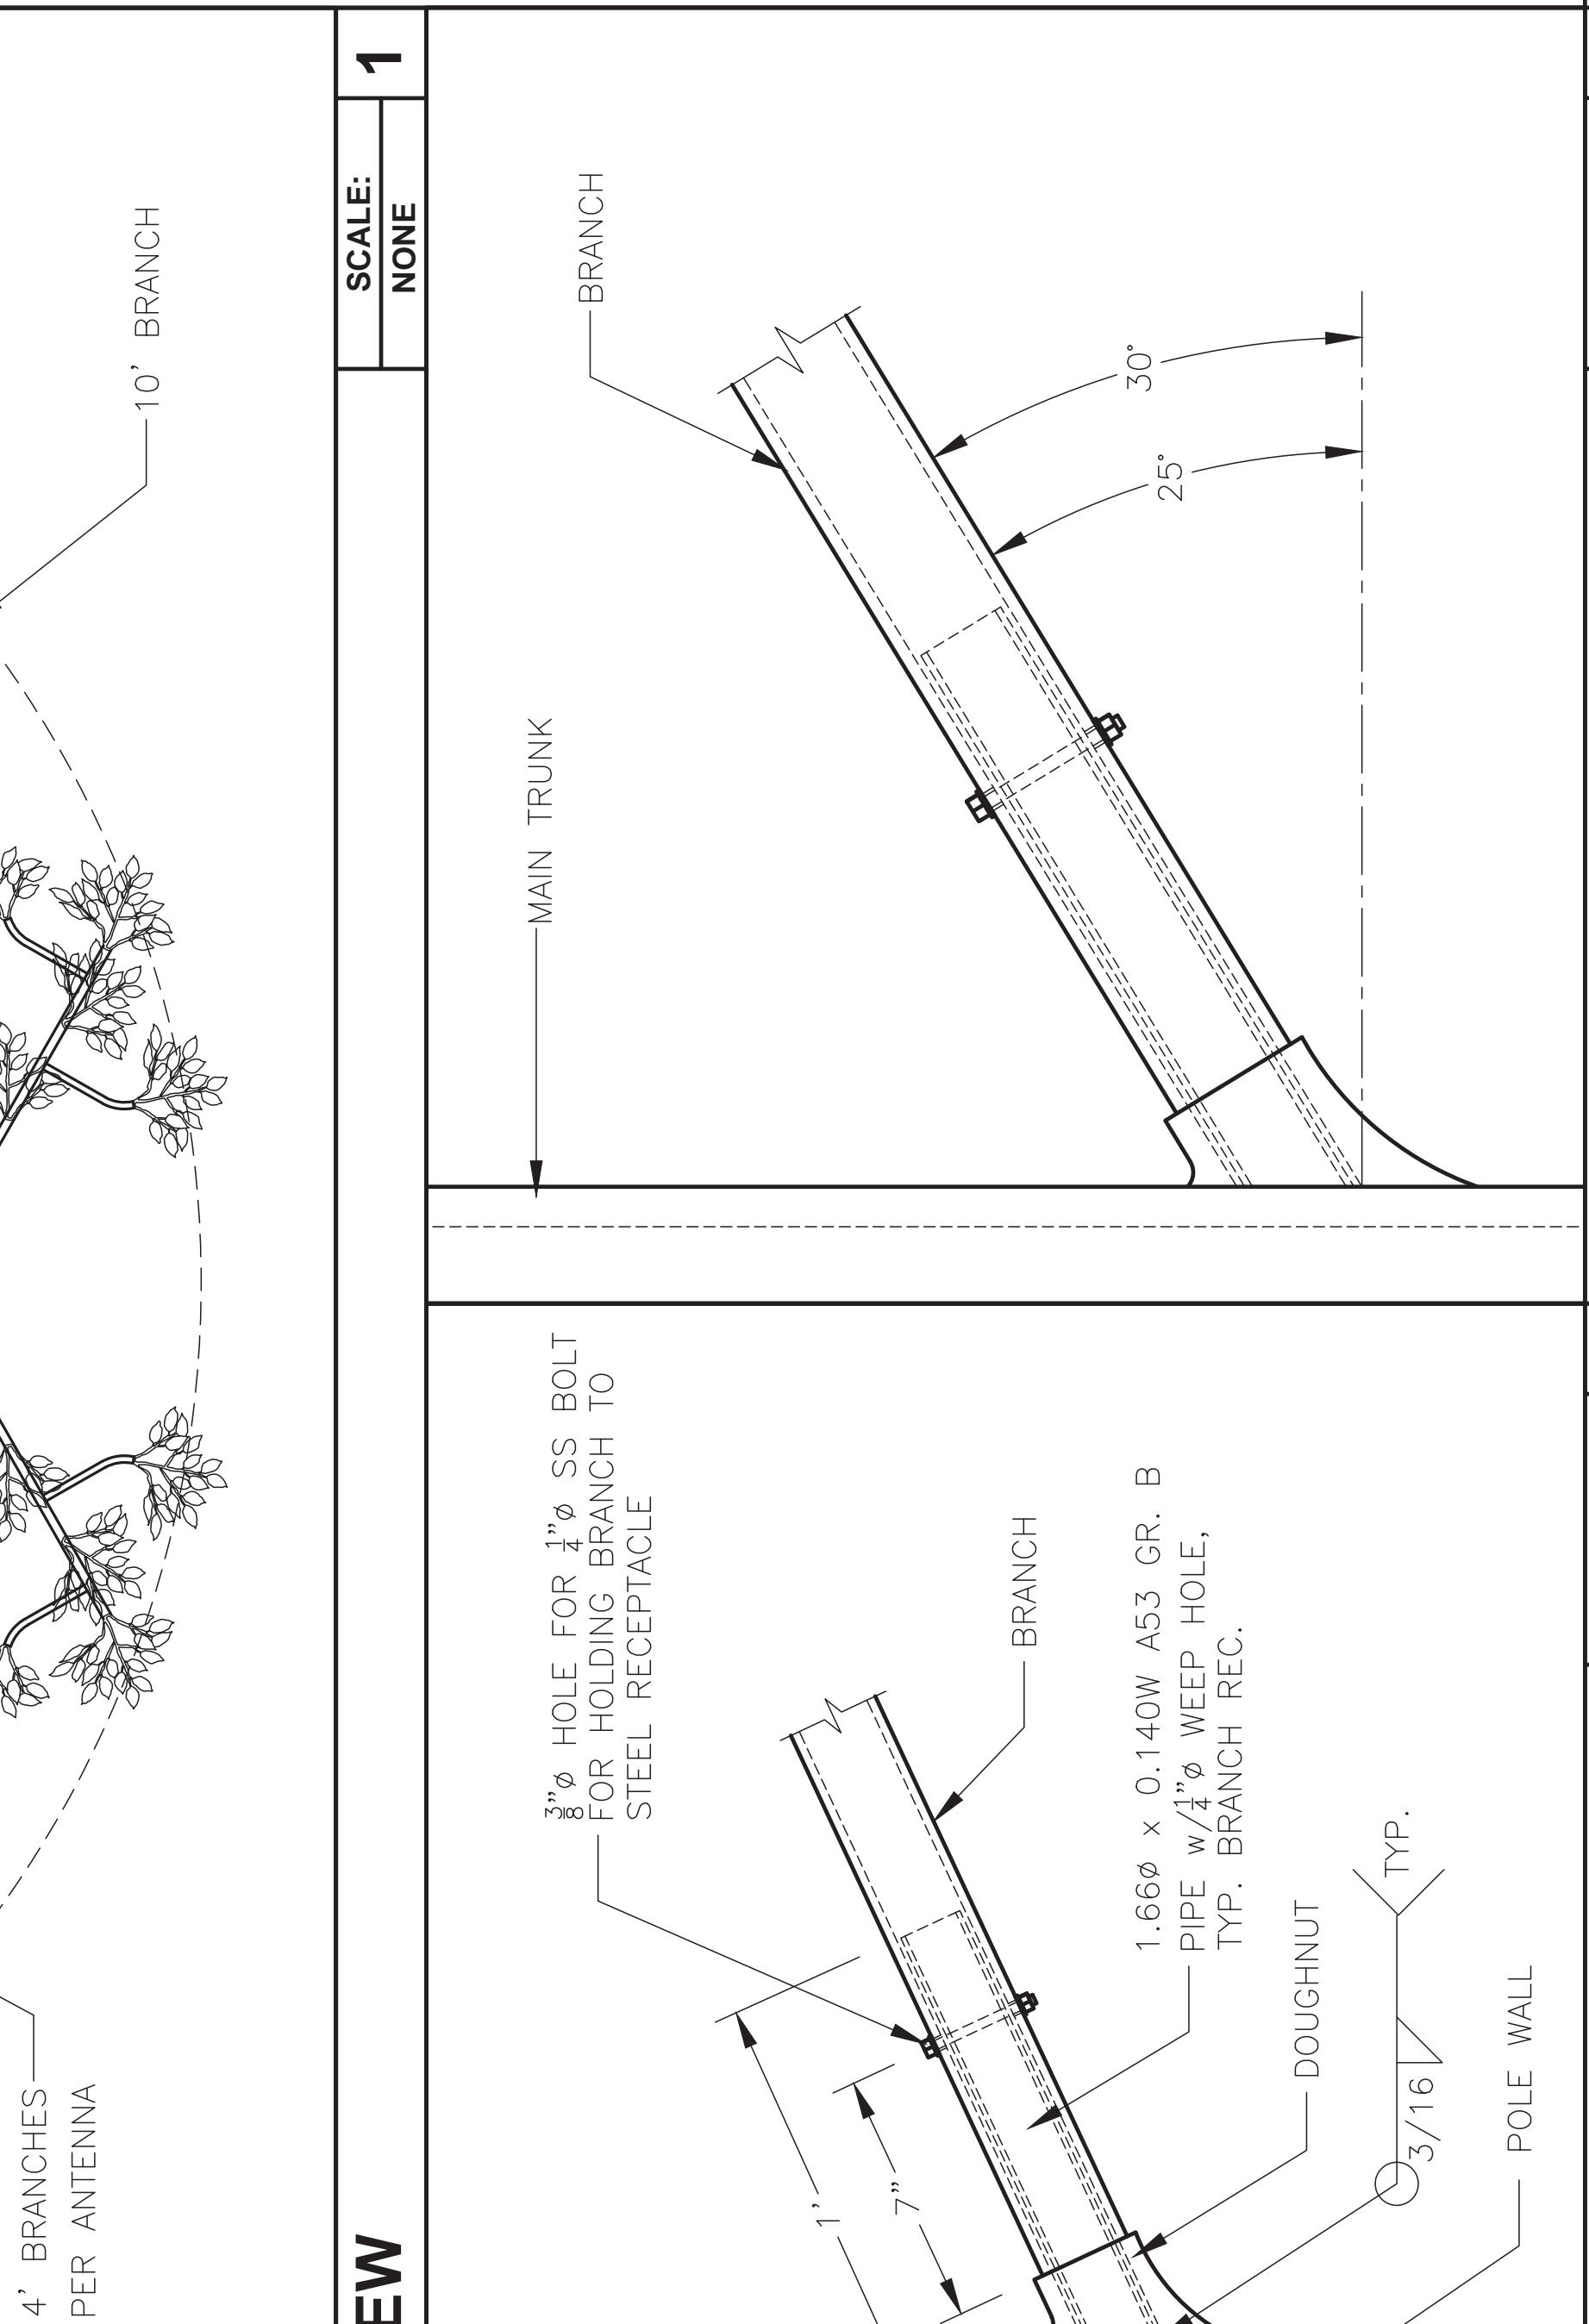CITY REQUIRED NOTES	
<p>IF ANY REQUIRED LANDSCAPE INDICATED ON THE APPROVED CONSTRUCTION DOCUMENT PLANS IS DAMAGED OR REMOVED DURING DEMOLITION OR CONSTRUCTION, IT SHALL BE REPAIRED AND/OR REPLACED IN KIND AND EQUIVALENT SIZE PER THE APPROVED DOCUMENTS TO THE SATISFACTION OF THE DEVELOPMENT SERVICES DEPARTMENT WITHIN 30 DAYS OF DAMAGE.</p> <p>EXISTING TREES TO REMAIN ON SITE WITHIN THE AREA OF WORK WILL BE PROTECTED IN PLACE. THE FOLLOWING PROTECTION MEASURES WILL BE PROVIDED:</p> <ol style="list-style-type: none"> 1. A BRIGHT YELLOW OR ORANGE TEMPORARY FENCE WILL BE PLACED AROUND EXISTING TREES AT THE DRIP LINE. 2. STOCKPILING, TOPSOIL DISTURBANCE, VEHICLE USE, AND MATERIAL STORAGE OF ANY KIND IS PROHIBITED WITHIN THE DRIP LINE. 3. A TREE WATERING SCHEDULE WILL BE MAINTAINED AND DOCUMENTED DURING CONSTRUCTION. 4. ALL DAMAGED TREES WILL BE REPLACED WITH ONE OF EQUAL OR GREATER SIZE. 	



(E) LANDSCAPE PLAN

PLAN NORTH
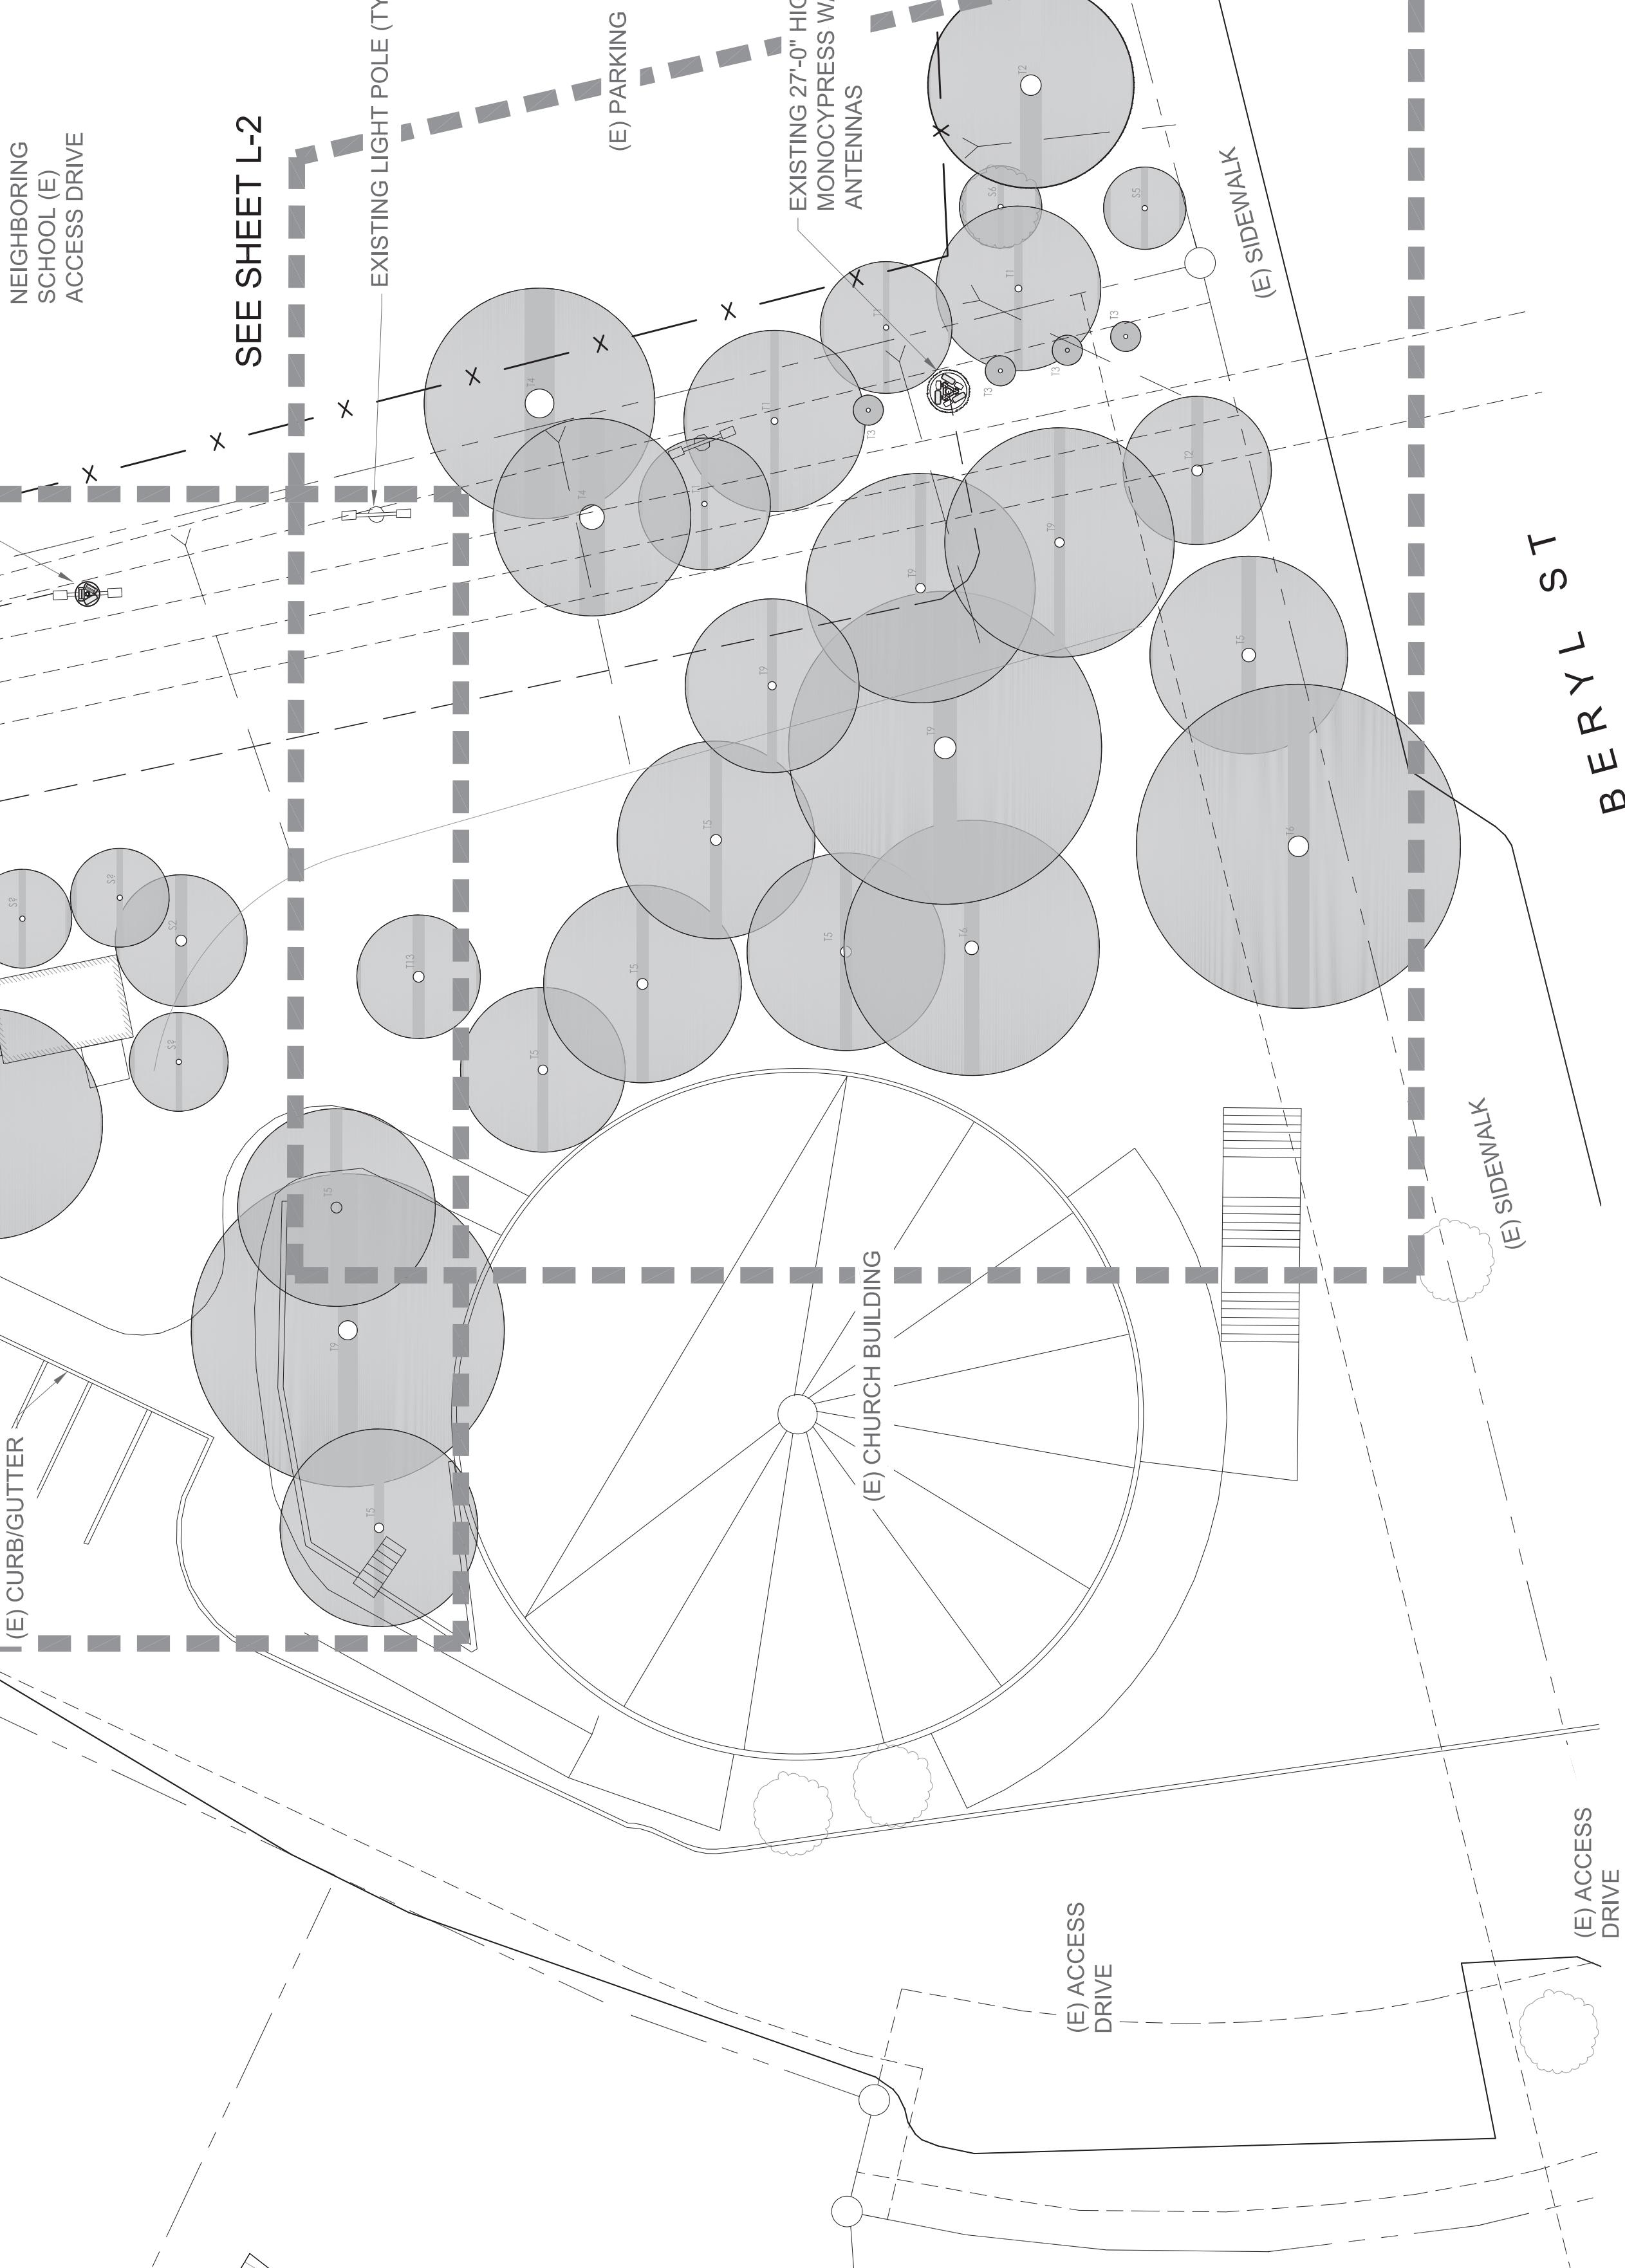
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L-1

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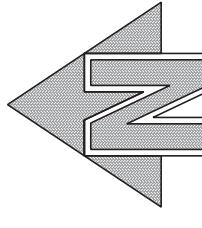
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6

SCALE IS BASE ON 22" x 34" size

SCALE: 1"-40'-0" (22x34)
(OR) 1/2"-40'-0" (11x17)

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FOR ENLARGED PLAN SEE SHEET L-2 AND L-3

EXISTING LANDSCAPE PLAN

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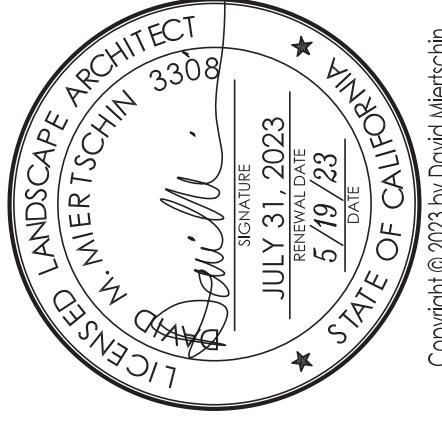
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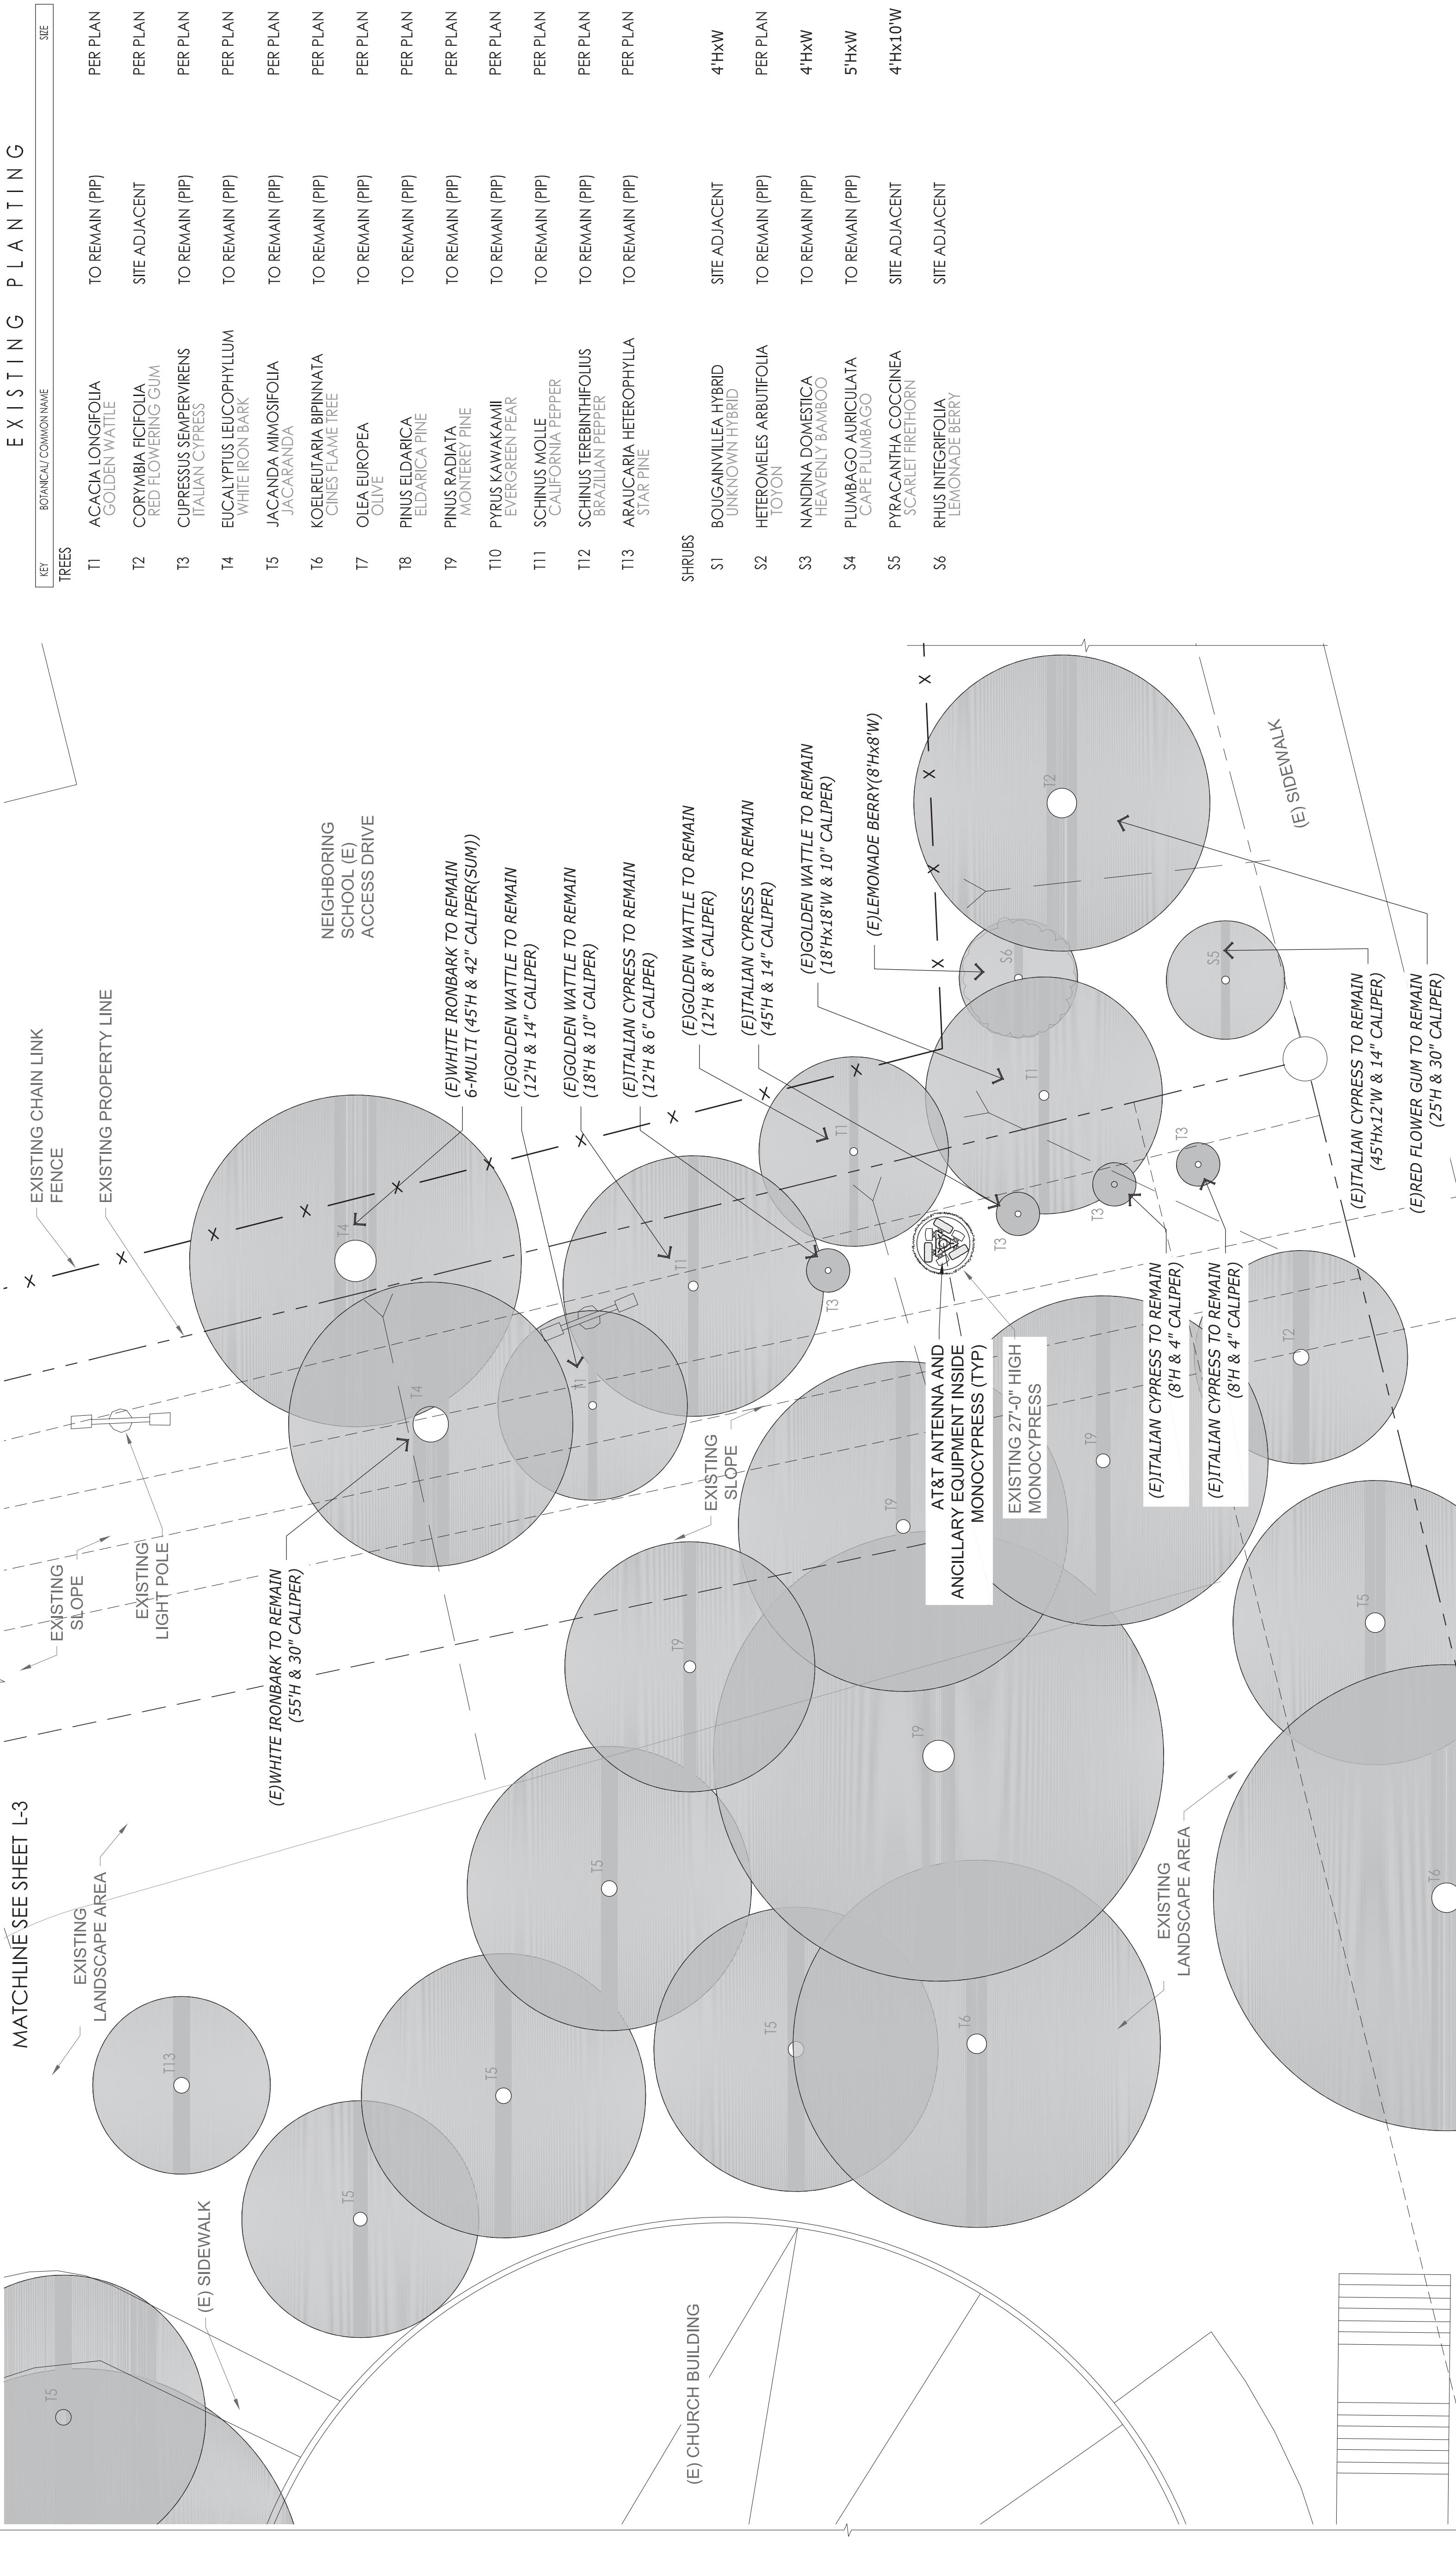
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EXISTING PLANTING




Plans Prepared For:




10590 WEST OCEAN AIR DRIVE, SUITE 300 SAN DIEGO, CA 92130

Applicant:

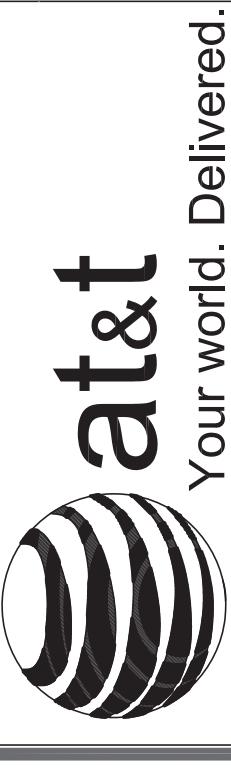

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Plans Prepared By:

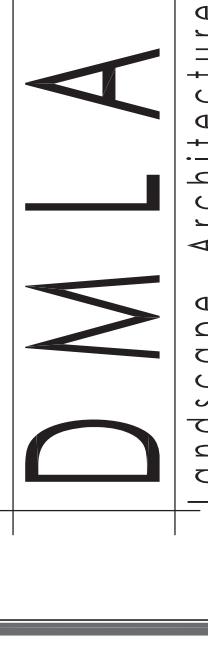

Landscape Architecture
3402 Alcatraz Dr, Dana Point, CA 92629
david@dmolonline.com (949) 388-3369

Project: COMMUNITY CONGREGATIONAL CHURCH
SITE ID: SS0071
2088 BERYL STREET
SAN DIEGO, CA 92109
FA: 10090957

Drawing Title:
EXISTING LANDSCAPE ENLARGED PLAN

Project No.:
2021071

Designer:
SB
Drawn By:
GD
PM Review:
JR

Date:
08/13/20
Checked By:
SS
Client Approval

Drawing No.:
0
Drawing No.:
L-2

SCALE IS BASE ON 22" x 34" size
(OR) 1/16"-1'-0" (11x17") 1

EXISTING LANDSCAPE ENLARGED PLAN

PLAN NORTH

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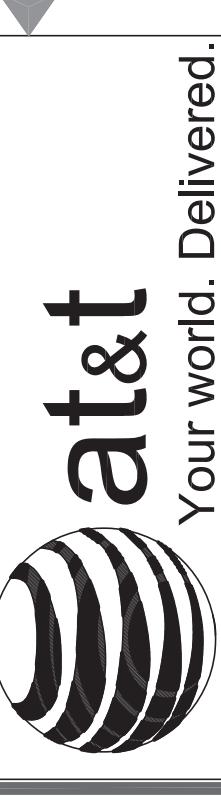
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EXISTING PLANTING

KEY	BOTANICAL/COMMON NAME	SITE
TREES		PER PLAN
T1	ACACIA LONGIFOLIA GOLDEN WATTLE	TO REMAIN (PIP)
T2	CORYMBIA FICIFOLIA RED FLOWERING GUM	SITE ADJACENT
T3	CUPRESSUS SEMPERVIRENS ITALIAN CYPRESS	TO REMAIN (PIP)
T4	EUCALYPTUS LEUCOPHYLLUM WHITE IRON BARK	TO REMAIN (PIP)
T5	JACANDA MIMOSIFOLIA JACARANDA	TO REMAIN (PIP)
T6	KOERUETARIA BIPINNATA CINES FLAME TREE	TO REMAIN (PIP)
T7	OLEA EUROPEA OLIVE	TO REMAIN (PIP)
T8	PINUS ELDARICA ELDARICA PINE	TO REMAIN (PIP)
T9	PINUS RADIANA MONTEREY PINE	TO REMAIN (PIP)
T10	PYRUS KAWAKAMI EVERGREEN PEAR	TO REMAIN (PIP)
T11	SCHINUS TERRBINTHIFOLIUS CALIFORNIA PEPPER	TO REMAIN (PIP)
T12	SCHINNUS TERRBINTHIFOLIUS BRAZILIAN PEPPER	TO REMAIN (PIP)
T13	ARAUCARIA HETEROPHYLLA STAR PINE	TO REMAIN (PIP)
SHRUBS		PER PLAN
S1	BOUGAINVILLEA HYBRID UNKNOWN HYBRID	SITE ADJACENT
S2	HETEROMELES ARBUTIFOLIA TOYON	TO REMAIN (PIP)
S3	NANDINA DOMESTICA HEAVENLY BAMBOO	TO REMAIN (PIP)
S4	PLUMBAGO AURICULATA CAFE PLUMBAGO	TO REMAIN (PIP)
S5	PYRACANTHA COCCINEA SCARLET FIREHORN	SITE ADJACENT
S6	RHUS INTEGRIFOLIA LEMONADE BERRY	TO REMAIN (PIP)



Plans Prepared By:



Landscape Architecture
3402 Alcatraz Dr, Dana Point, CA 92629
david@dmolandscape.com (949) 388-3369

Project: COMMUNITY CONGREGATIONAL CHURCH
SITE ID: SS0071
2088 BERYL STREET
SAN DIEGO, CA 92109
FA: 10090957

Drawing Title: EXISTING LANDSCAPE ENLARGED PLAN

Project No.: 20210711
Designer: SB
Drawn By: GD
PM Review: SS
Issue No.: Drawing No.

Date: 08/13/20
Checked By: SS
Client Approval: JR

Drawing No.: L-3

EXISTING LANDSCAPE ENLARGED PLAN

PLAN NORTH

5

4


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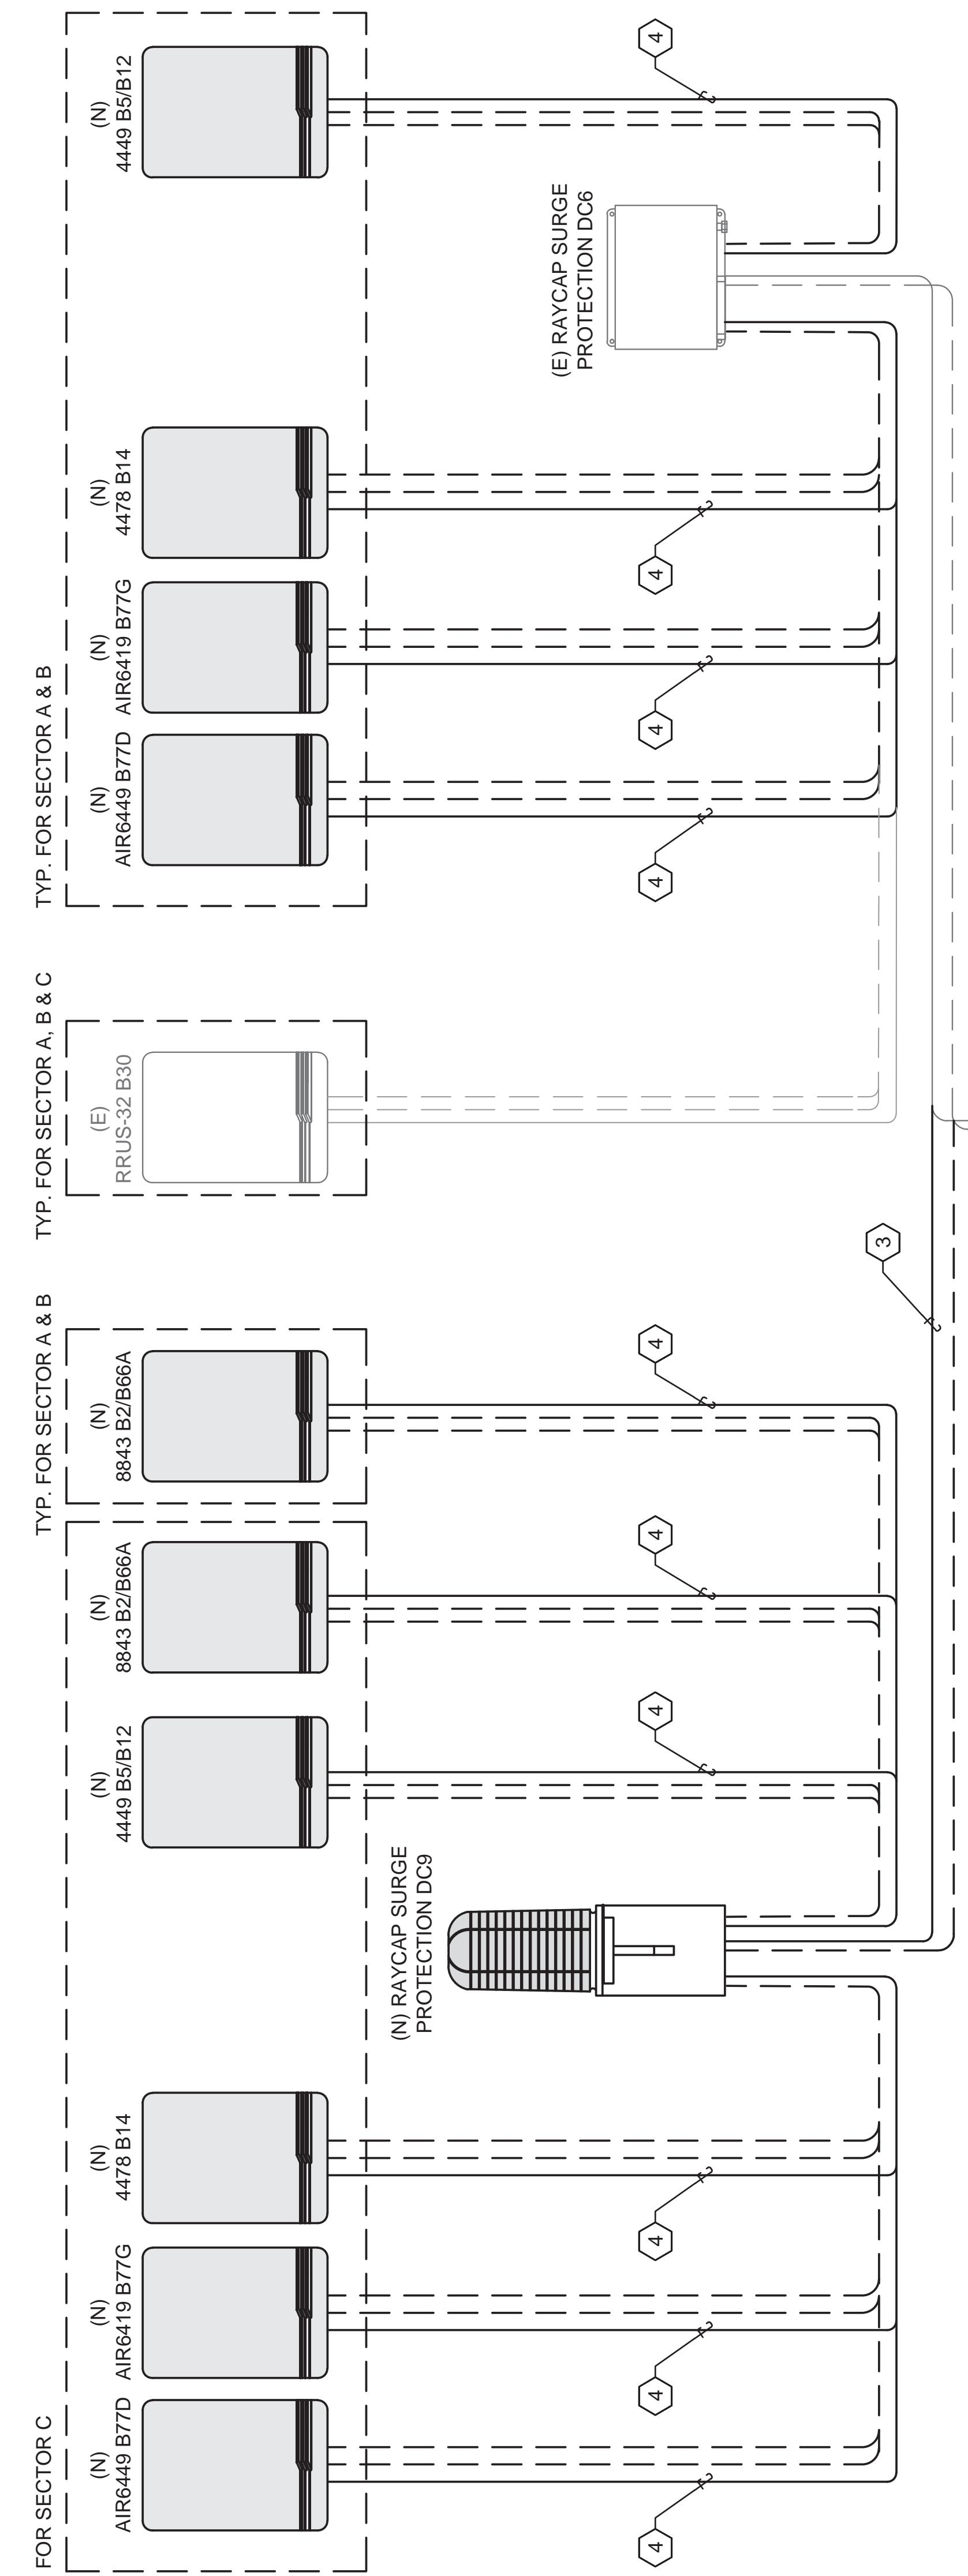
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6



SCALE IS BASE ON 22" x 34" size

0 2' 4' 8' (OR) 1/16"-1'-0" (11x17") 1

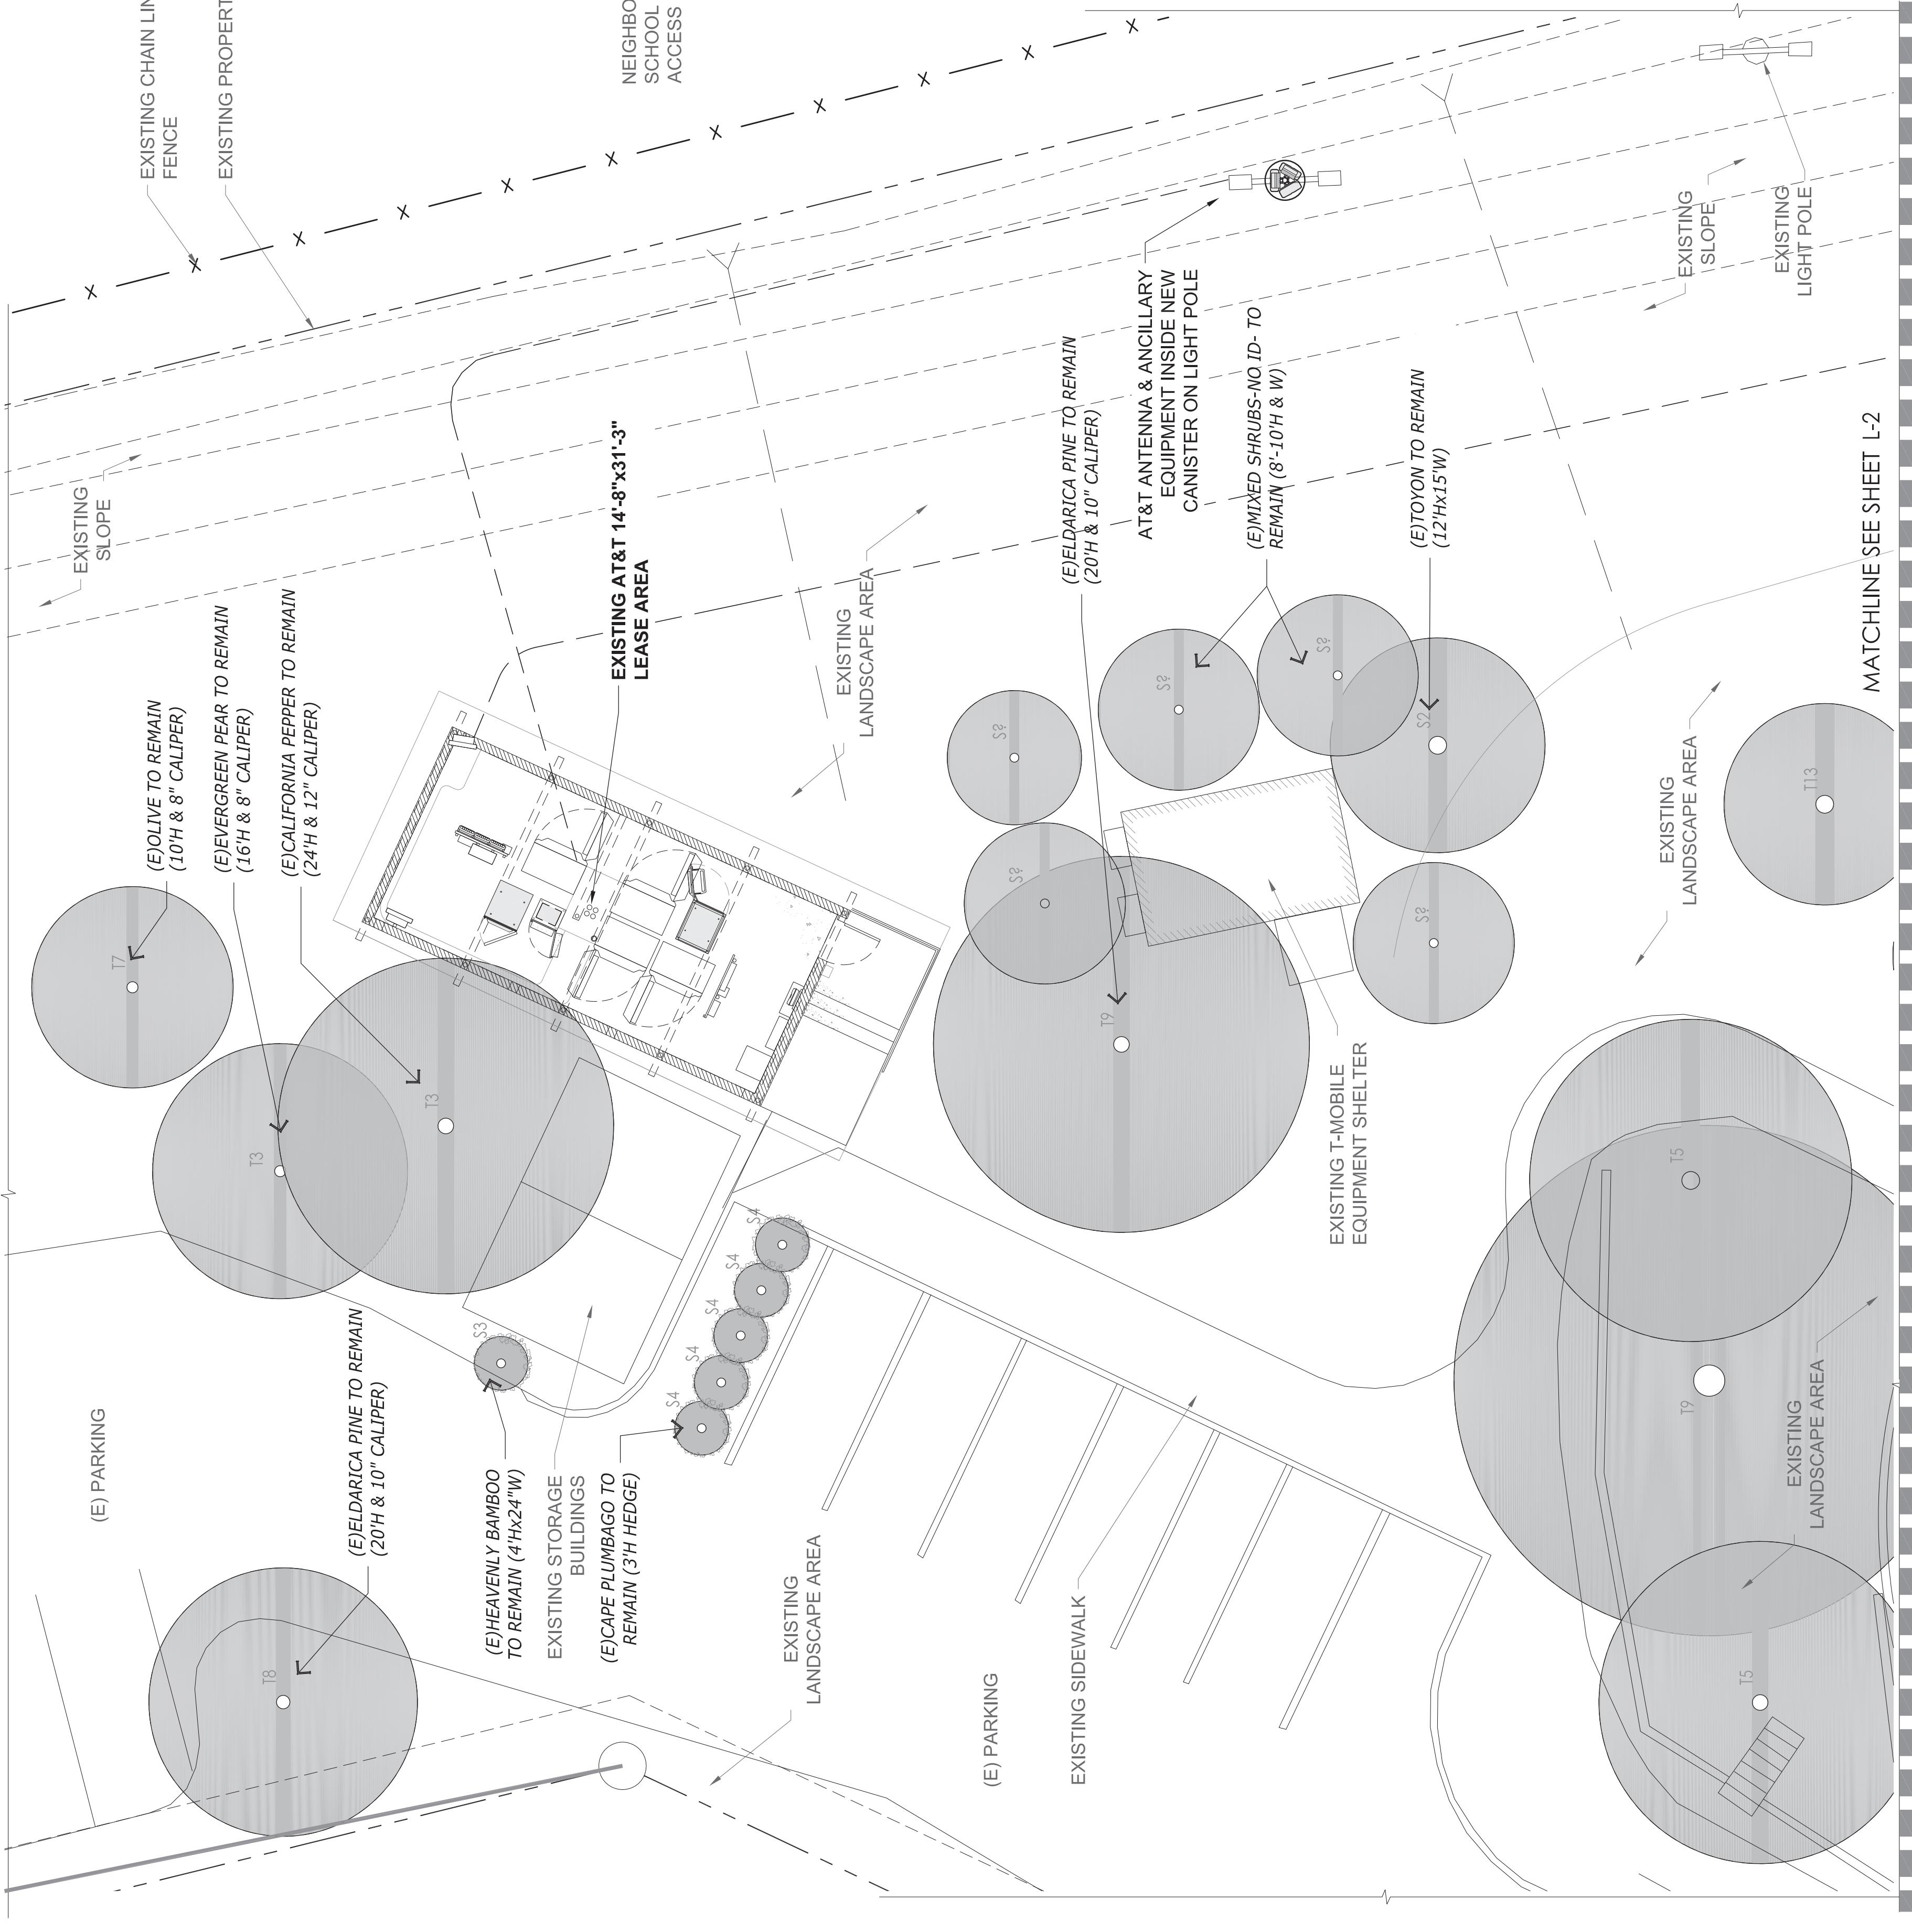

EQUIPMENT LEVEL

(N) POWER PLANT

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G 05/24/23 JX COMMENTS

F 11/14/22 CLIENT COMMENTS

E 08/17/22 CLIENT COMMENTS

D 06/29/22 CLIENT COMMENTS

C 06/15/22 CLIENT COMMENTS


B 06/07/22 JX COMMENTS

No. Date Action

Plans Prepared For:

MD710590 WEST OCEAN AIR DRIVE
SUITE 300
SAN DIEGO, CA 92130

Applicant:

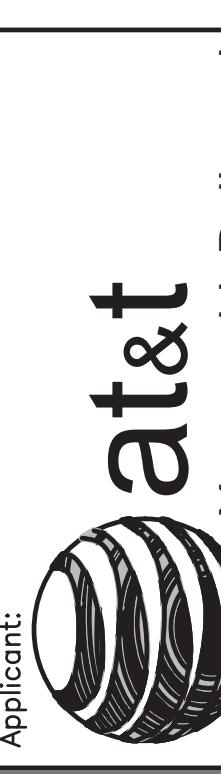

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B

MORRISON HERSHFIELD
5100 MACADAM AVE, SUITE 500
PORTLAND, OR 97239
Tel: 503-958-9136
www.morrisonhershfield.com

Project: COMMUNITY
CONGREGATIONAL CHURCH
SITE ID: SS0071
2058 BERYL STREET
SAN DIEGO, CA 92109
FA: 10090957


Drawing Title:
**ELECTRICAL DC
ONE-LINE DIAGRAM**Project No.:
210359800

Designer: SB Date: 05/06/22
Drawn By: GD Checked By:
PM Review: JR Client Approval

Issue No.: G G 01.0
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ELECTRICAL DC ONE-LINE DIAGRAM

SCALE N.T.S. 1
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TYPICAL GROUND BAR CONNECTION DETAIL

SCALE
N.T.S. 2

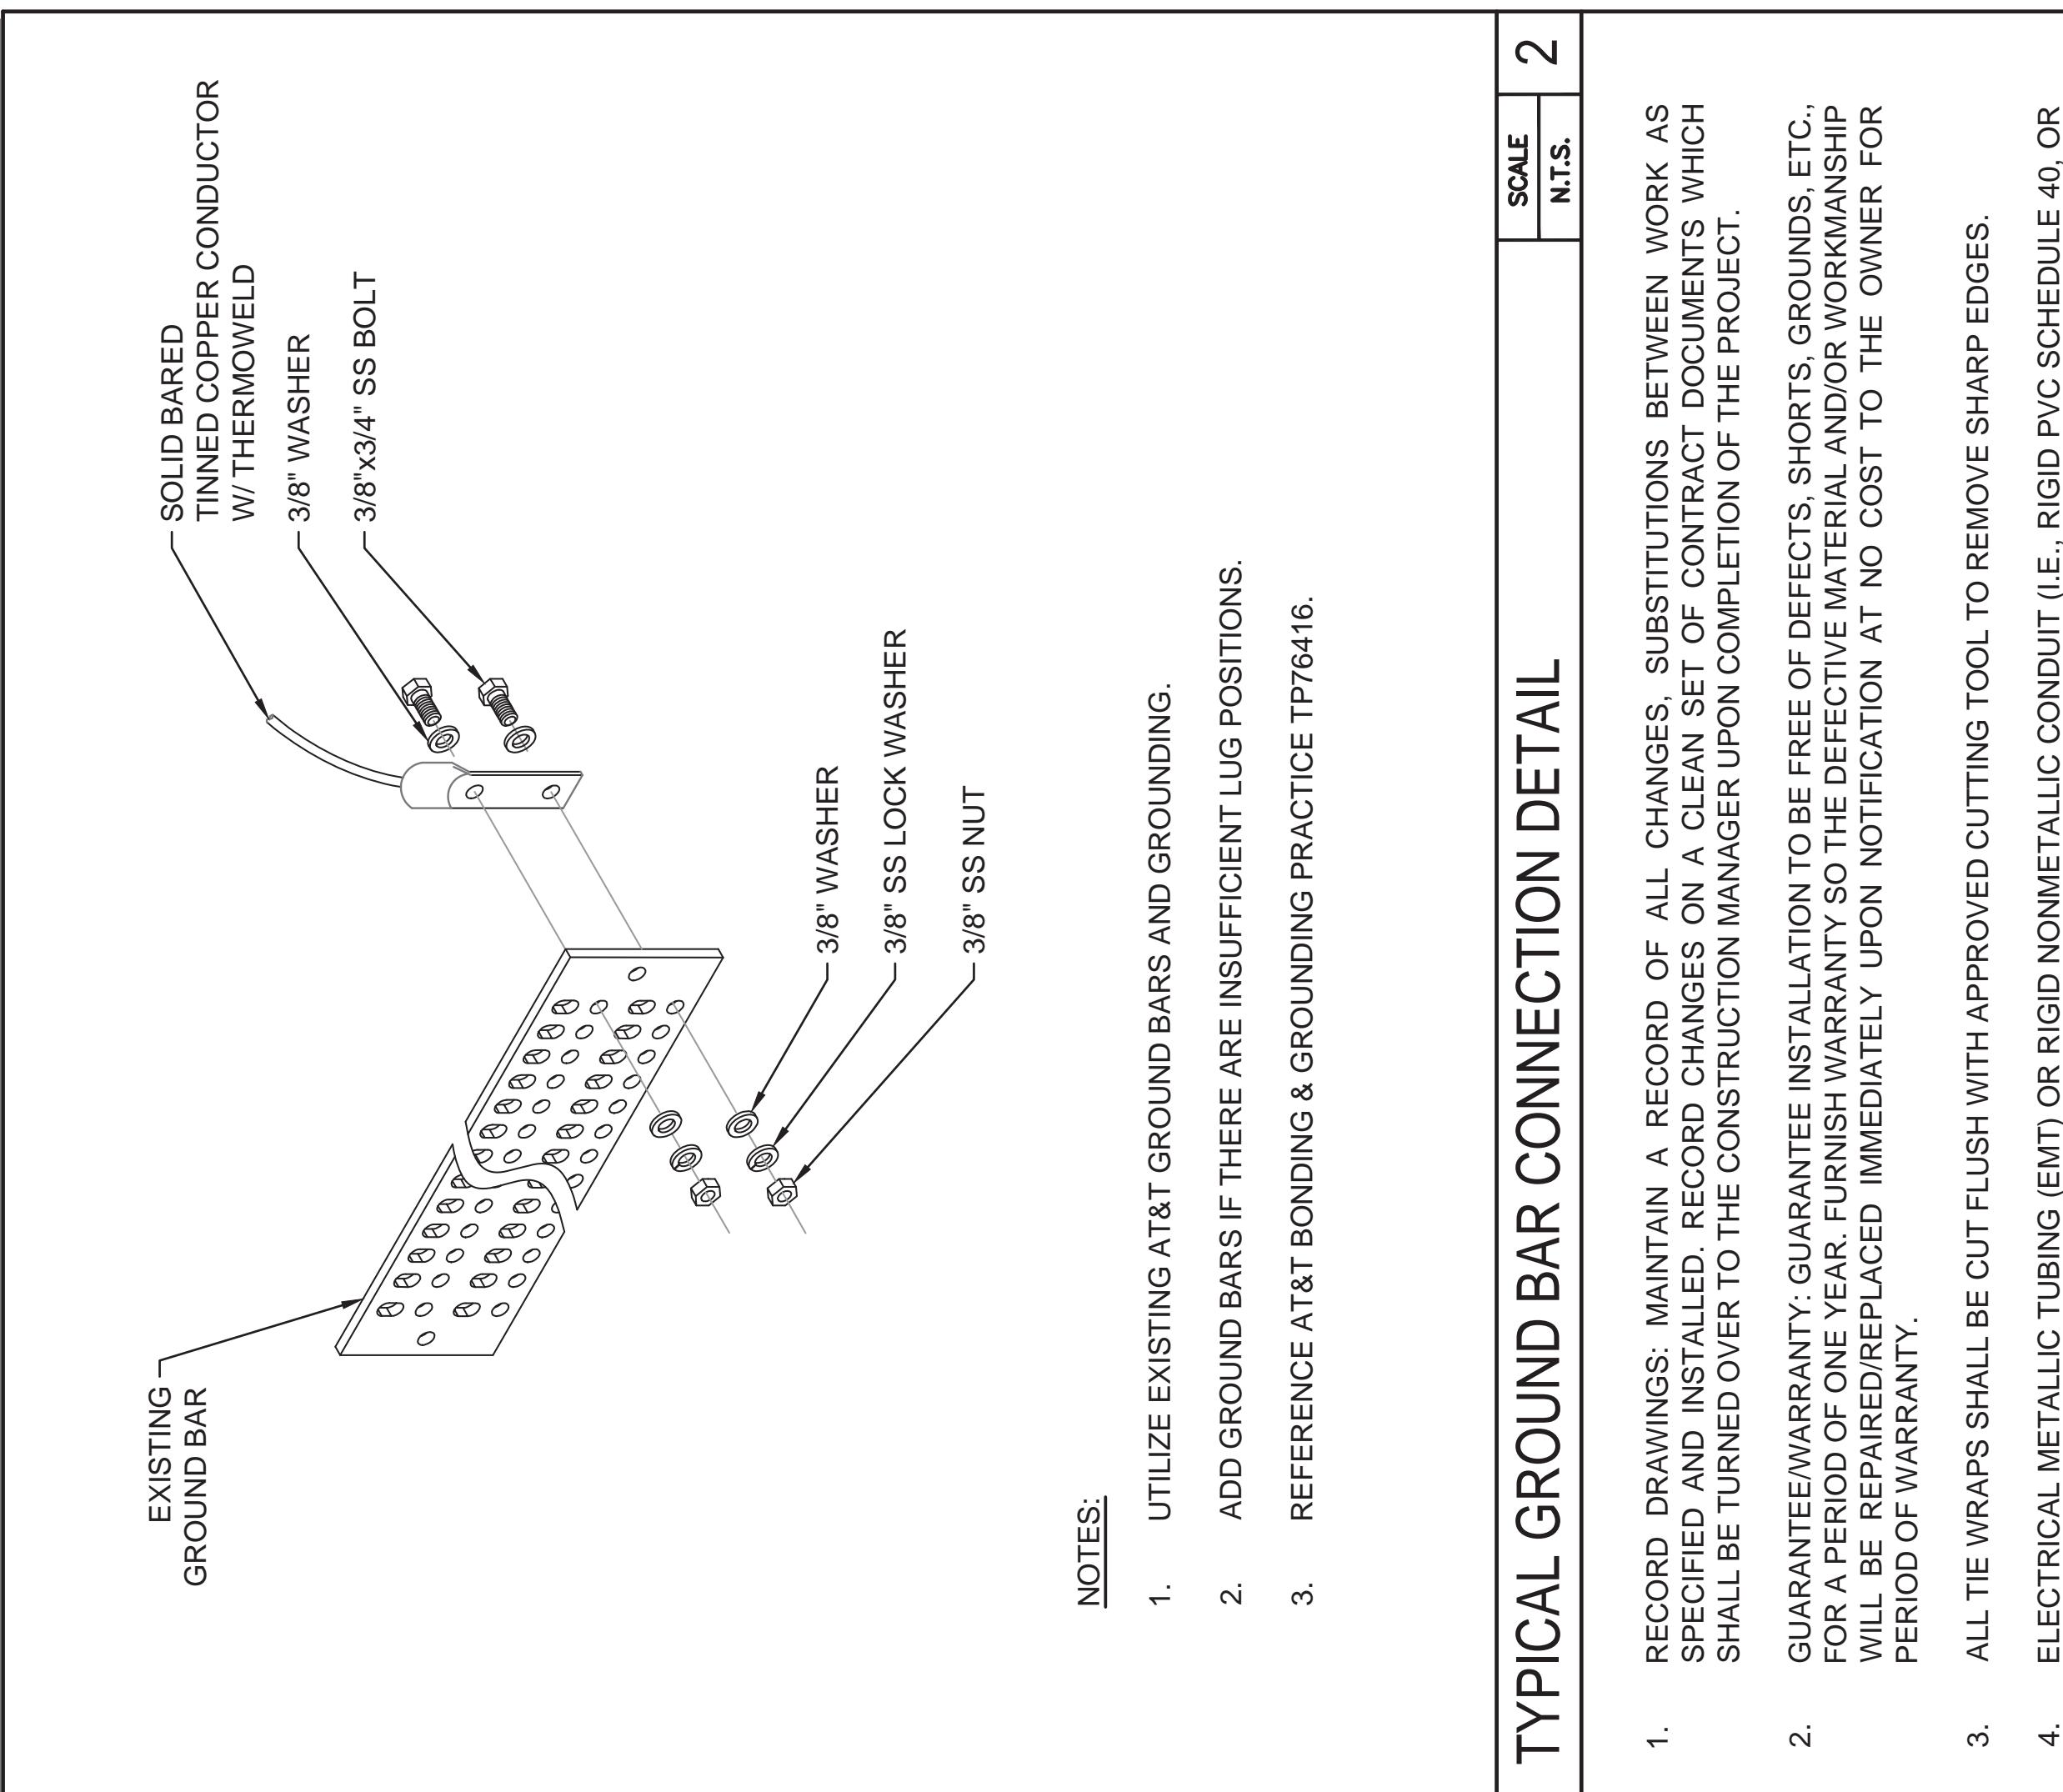No. Date Action
F 11/14/22 CLIENT COMMENTS
E 08/17/22 CLIENT COMMENTS
D 06/29/22 CLIENT COMMENTS
C 06/15/22 CLIENT COMMENTS
B 06/07/22 JX COMMENTS

Plans Prepared For:
MD7
10590 WEST OCEAN AIR DRIVE
SUITE 300
SAN DIEGO, CA 92130
Applicant:


Plans Prepared By:
at&t
Your world. Delivered.

Project: COMMUNITY CONGREGATIONAL CHURCH SITE ID: SS0071
2058 BERYL STREET SAN DIEGO, CA 92109 FA: 10090957
Drawing Title:

Project No.: 210359800
Designer: SB Date: 05/06/22
Drawn By: GD Checked By: SS
PM Review: JR Client Approval

Issue No.: G

Scale: 3
N.T.S.

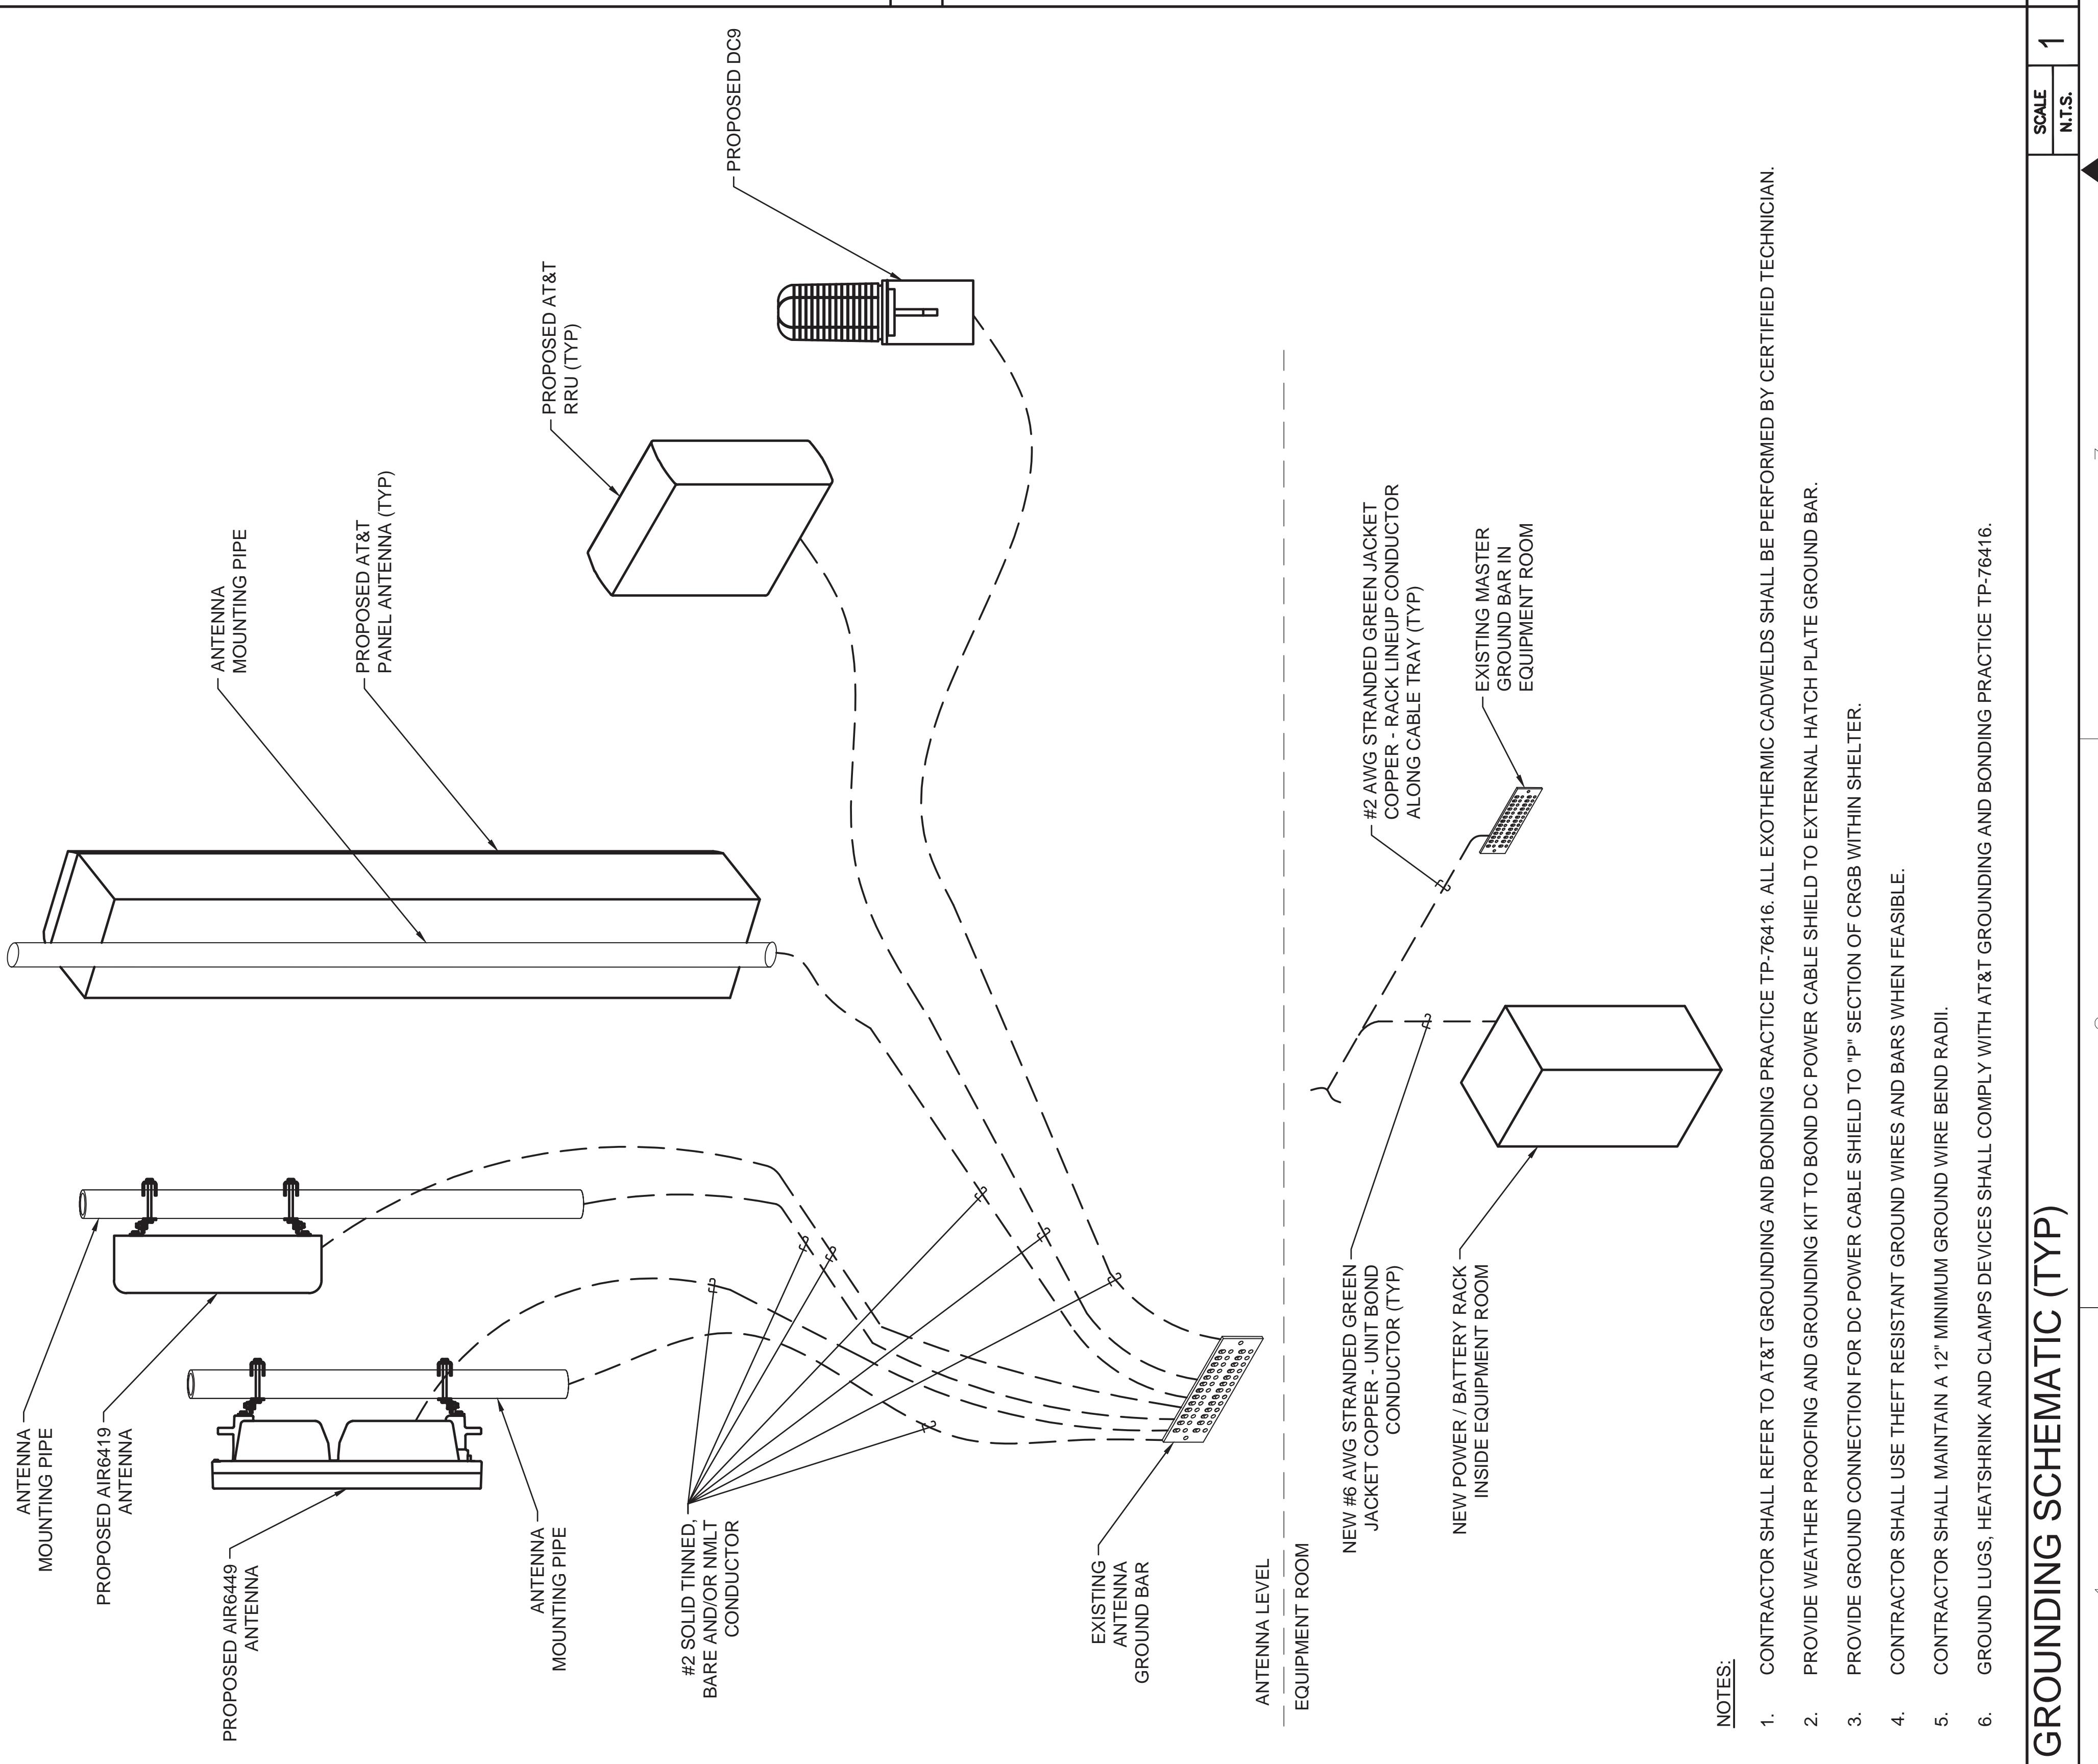

GROUNDING SCHEMATIC (TYP)

SCALE
N.T.S. 1

SCALE
N.T.S. 2

SCALE
N.T.S. 3

SCALE
N.T.S. 4

SCALE
N.T.S. 5

SCALE
N.T.S. 6

ELECTRICAL NOTES

6. FIELD FABRICATED CONDUITS SHALL BE CUT SQUARE WITH A CONDUIT CUTTING TOOL AND REAMED TO PROVIDE A SMOOTH INSIDE SURFACE.
7. PROVIDE INSULATED GROUNDING BUSHING FOR ALL CONDUITS.
8. SUBCONTRACTOR IS RESPONSIBLE FOR PROTECTING ALL CONDUITS DURING CONSTRUCTION. TEMPORARY OPENINGS IN THE CONDUIT SYSTEM SHALL BE PLUGGED OR CAPPED TO PREVENT ENTRANCE OF MOISTURE OR FOREIGN MATTER. SUBCONTRACTOR SHALL REPLACE ANY CONDUITS CONTAINING FOREIGN MATERIALS THAT CANNOT BE REMOVED.
9. ALL CONDUITS SHALL BE SWABBED CLEAN BY PULLING AN APPROPRIATE SIZE MANDREL THROUGH THE CONDUIT BEFORE INSTALLATION OF CONDUCTORS OR CABLES. CONDUIT SHALL BE FREE OF DIRT AND DEBRIS.
10. INSTALL PULL STRINGS IN ALL CLEAN EMPTY CONDUITS. IDENTIFY PULL STRINGS AT EACH END.
11. INSTALL 2" HIGHLY VISIBLE AND DETECTABLE TAPE 12" ABOVE ALL UNDERGROUND CONDUITS AND CONDUCTORS.
12. CONDUITS SHALL BE INSTALLED IN SUCH A MANNER AS TO INSURE AGAINST COLLECTION OF TRAPPED CONDENSATION.
13. PROVIDE CORE DRILLING AS NECESSARY FOR PENETRATIONS TO ALLOW FOR RACEWAYS AND CABLES TO BE ROUTED THROUGH THE BUILDING. DO NOT PENETRATE STRUCTURAL MEMBERS, SLEEVES AND/OR PENETRATIONS IN FIRE RATED CONSTRUCTION SHALL BE EFFECTIVELY SEALED WITH FIRE RATED MATERIAL WHICH SHALL MAINTAIN THE FIRE RATING OF THE WALL OR STRUCTURE. FIRE STOPS AT FLOOR PENETRATIONS SHALL PREVENT PASSAGE OF WATER, SMOKE, FIRE, AND FUMES. ALL MATERIAL SHALL BE UL APPROVED FOR THIS PURPOSE.
- B. CONDUCTORS AND CABLE:
1. ALL POWER WIRING SHALL BE COLOR CODED AS FOLLOWS:
DESCRIPTION 208/240/120 VOLT SYSTEMS
PHASE A BLACK
PHASE B RED
PHASE C BLUE
NEUTRAL WHITE
GROUNDING GREEN
4. SPLICES SHALL BE MADE ONLY AT OUTLETS, JUNCTION BOXES, OR ACCESSIBLE RACEWAY CONDUITS APPROVED FOR THIS PURPOSE.
5. PULLING LUBRICANTS SHALL BE UL APPROVED. SUBCONTRACTOR SHALL USE NYLON OR HEMP ROPE FOR PULLING CONDUCTOR OR CABLES INTO THE CONDUIT.
6. CABLES SHALL BE NEATLY TRAINED, WITHOUT INTERLACING AND BE OF SUFFICIENT LENGTH IN ALL BOXES & EQUIPMENT TO PERMIT MAKING A NEAT ARRANGEMENT. CABLES SHALL BE SECURED IN A MANNER TO AVOID TENSION ON CONDUCTORS OR TERMINALS. CONDUCTORS SHALL BE PROTECTED FROM MECHANICAL INJURY AND MOISTURE. SHARP BENDS OVER CONDUIT BUSHINGS ARE PROHIBITED. DAMAGED CABLES SHALL BE REMOVED AND REPLACED AT THE SUBCONTRACTOR'S EXPENSE.
- C. DISCONNECT SWITCHES:
1. INSTALL DISCONNECT SWITCHES LEVEL AND PLUMB. CONNECT TO WIRING SYSTEM AND GROUNDING SYSTEM AS INDICATED.
- D. GROUNDING:
1. ALL METALLIC PARTS OF ELECTRICAL EQUIPMENT WHICH DO NOT CARRY CURRENT SHALL BE GROUNDED IN ACCORDANCE WITH THE REQUIREMENTS OF THE BUILDING MANUFACTURER, AT&T GROUNDING AND BONDING STANDARDS TP-76416, ND-00135, AND THE NATIONAL ELECTRICAL CODE.
2. PROVIDE ELECTRICAL GROUNDING AND BONDING SYSTEM INDICATED WITH ASSEMBLY OF MATERIALS, INCLUDING GROUNDING ELECTRODES, BONDING JUMPERS AND ADDITIONAL ACCESSORIES AS REQUIRED FOR A COMPLETE INSTALLATION.
3. ALL GROUNDING CONDUCTORS SHALL PROVIDE A STRAIGHT DOWNWARD PATH TO GROUND WITH GRADUAL BEND AS REQUIRED. GROUNDING CONDUCTORS SHALL NOT BE LOOPED OR SHARPLY BENT. ROUTE GROUNDING CONNECTIONS AND CONDUCTORS TO GROUND IN THE SHORTEST AND STRAIGHTEST PATHS POSSIBLE TO MINIMIZE TRANSIENT VOLTAGE RISES.
4. BUILDINGS AND/OR NEW TOWERS GREATER THAN 75 FEET IN HEIGHT AND WHERE THE MAIN GROUNDING CONDUCTORS ARE REQUIRED TO BE ROUTED TO GRADE, THE SUBCONTRACTOR SHALL ROUTE TWO GROUNDING CONDUCTORS FROM THE ROOFTOP,

- TOWERS, AND WATER TOWERS GROUNDING RING, TO THE EXISTING GROUNDING SYSTEM, THE GROUNDING CONDUCTORS SHALL NOT BE SMALLER THAN 2/0 AWG COPPER. ROOFTOP GROUNDING RING SHALL BE BONDED TO THE EXISTING GROUNDING SYSTEM, THE BUILDING STEEL COLUMNS, LIGHTNING PROTECTION SYSTEM, AND BUILDING MAIN WATER LINE (FERROUS OR NONFERROUS METAL PIPING ONLY). SEE STANDARD 6.3.2.2.
5. TIGHTEN GROUNDING AND BONDING CONNECTORS, INCLUDING SCREWS AND BOLTS, IN ACCORDANCE WITH MANUFACTURER'S PUBLISHED TORQUE TIGHTENING VALUES FOR CONNECTORS AND BOLTS. WHERE MANUFACTURER'S TORQUING REQUIREMENTS ARE NOT AVAILABLE, TIGHTEN CONNECTIONS TO COMPLY WITH TIGHTENING TORQUE VALUES SPECIFIED IN UL TO ASSURE PERMANENT AND EFFECTIVE GROUNDING. SUBCONTRACTOR SHALL VERIFY THE LOCATIONS OF GROUNDING TIE-IN-POINTS TO THE EXISTING.
6. GROUNDING SYSTEM. ALL UNDERGROUND GROUNDING CONNECTIONS SHALL BE MADE BY THE EXOTHERMIC WELD PROCESS AND INSTALLED IN ACCORDANCE WITH THE MANUFACTURER'S INSTRUCTIONS.
7. ALL GROUNDING CONNECTIONS SHALL BE INSPECTED FOR TIGHTNESS. EXOTHERMIC WELDED CONNECTIONS SHALL BE APPROVED BY THE INSPECTOR HAVING JURISDICTION BEFORE BEING PERMANENTLY CONCEALED.
8. APPLY CORROSION-RESISTANCE FINISH TO FIELD CONNECTIONS AND PLACES WHERE FACTORY APPLIED PROTECTIVE COATINGS HAVE BEEN DESTROYED. USE KOPR-SHIELD ANTI-OXIDATION COMPOUND ON ALL COMPRESSION GROUNDING CONNECTIONS.
9. A SEPARATE, CONTINUOUS, INSULATED EQUIPMENT GROUNDING CONDUCTOR SHALL BE INSTALLED IN ALL FEEDER AND BRANCH CIRCUITS.
10. BOND ALL INSULATED GROUNDING BUSHINGS WITH A BARE 6 AWG GROUNDING CONDUCTOR TO A GROUND BUS.
11. DIRECT BURIED GROUNDING CONDUCTORS SHALL BE INSTALLED AT A NOMINAL DEPTH OF 36" MINIMUM BELOW GRADE, OR 6" BELOW THE FROST LINE, USE THE GREATER OF THE TWO DISTANCES.
12. ALL GROUNDING CONDUCTORS EMBEDDED IN OR PENETRATING CONCRETE SHALL BE INSTALLED IN SCHEDULE 40 PVC CONDUIT.
13. THE INSTALLATION OF CHEMICAL ELECTROLYTIC GROUNDING SYSTEM IN STRICT ACCORDANCE WITH MANUFACTURER'S INSTRUCTIONS. REMOVE SEALING TAPE FROM LEACHING AND BREATHER HOLES. INSTALL PROTECTIVE BOX FLUSH WITH GRADE.
14. DRIVE GROUND RODS UNTIL TOPS ARE A MINIMUM DISTANCE OF 36" DEPTH OR 6" BELOW FROST LINE, USING THE GREATER OF THE TWO DISTANCES.
15. IF COAX ON THE ICE BRIDGE IS MORE THAN 6 FT. FROM THE GROUNDING BAR AT THE BASE OF THE TOWER, A SECOND GROUNDING BAR WILL BE NEEDED AT THE END OF THE ICE BRIDGE, TO GROUND THE COAX CABLE GROUNDING KITS AND IN-LINE ARRESTERS.
16. SUBCONTRACTOR SHALL REPAIR, AND/OR REPLACE, EXISTING GROUNDING SYSTEM COMPONENTS DAMAGED DURING CONSTRUCTION AT THE SUBCONTRACTORS EXPENSE.

3.5 ACCEPTANCE TESTING:


- A. CERTIFIED PERSONNEL USING CERTIFIED EQUIPMENT SHALL PERFORM REQUIRED TESTS AND SUBMIT WRITTEN TEST REPORTS UPON COMPLETION.
- B. WHEN MATERIAL AND/OR WORKMANSHIP IS FOUND NOT TO COMPLY WITH THE SPECIFIED REQUIREMENTS, THE NON COMPLYING ITEMS SHALL BE REMOVED FROM THE PROJECT SITE AND REPLACED WITH ITEMS COMPLYING WITH THE SPECIFIED REQUIREMENTS PROMPTLY AFTER RECEIPT OF NOTICE FOR NON-COMPLIANCE.

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- C. TEST PROCEDURES:
1. ALL FEEDERS SHALL HAVE INSULATION TESTED AFTER INSTALLATION, BEFORE CONNECTION TO DEVICES. THE CONDUCTORS SHALL TEST FREE FROM SHORT CIRCUITS AND GROUNDS. TESTING SHALL BE FOR ONE MINUTE USING 1000V DC. PROVIDE WRITTEN DOCUMENTATION FOR ALL TEST LISTED TO SUBCONTRACTOR.
2. PRIOR TO ENERGIZING CIRCUITRY, TEST WIRING DEVICES FOR ELECTRICAL CONTINUITY AND PROPER POLARITY CONNECTIONS.
3. MEASURE AND RECORD VOLTAGES BETWEEN PHASES AND BETWEEN PHASE CONDUCTORS AND NEUTRALS. SUBMIT A REPORT OF MAXIMUM AND MINIMUM VOLTAGES.
4. PERFORM GROUNDING TEST TO MEASURE GROUNDING RESISTANCE OF GROUNDING SYSTEM USING THE IEEE STANDARD 3-POINT "FALL-OF-POTENTIAL" METHOD. PROVIDE PLOTTED TEST VALUES AND LOCATION SKETCH. NOTIFY THE ENGINEER IMMEDIATELY IF MEASURED VALUE IS OVER 5 OHMS.

- D. 05/24/23 JX COMMENTS
- F 11/14/22 CLIENT COMMENTS
- E 08/17/22 CLIENT COMMENTS
- D 06/29/22 CLIENT COMMENTS
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- B 06/07/22 JX COMMENTS
- No. Date Action
- Plans Prepared For:



10590 WEST OCEAN AIR DRIVE
SUITE 300
SAN DIEGO, CA 92130

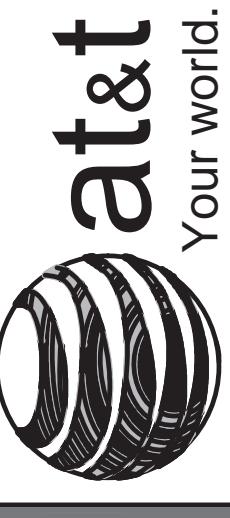Plants Prepared By:
MORRISON HERSHFIELD
5100 SW MACADAM AVE, SUITE 500
PORTLAND, OR 97239
Tel: 503-958-9128 Fax: 503-958-9136
www.morrisonhershfield.com

Project: COMMUNITY CONGREGATIONAL CHURCH
SITE ID: SS0071
2058 BERYL STREET
SAN DIEGO, CA 92109
FA: 10090957
Drawing Title:
ELECTRICAL NOTES

Project No.: 210359800
Designer: SB Date: 05/06/22
Drawn By: GD Checked By: SS
PM Review: JR Client Approval:
Issue No.: G



**City of San Diego
Development Services**
1222 First Ave., MS 302
San Diego, CA 92101
(619) 446-5000

Ownership Disclosure Statement

**FORM
DS-318**

October 2017

Approval Type: Check appropriate box for type of approval(s) requested: Neighborhood Use Permit Coastal Development Permit
 Neighborhood Development Permit Site Development Permit Planned Development Permit Conditional Use Permit Variance
 Tentative Map Vesting Tentative Map Map Waiver Land Use Plan Amendment • Other _____

Project Title: Community Congregational Church

Project No. For City Use Only: _____

Project Address: 2088 Beryl Street San Diego, CA 92109

Specify Form of Ownership/Legal Status (please check):

Corporation Limited Liability -or- General - What State? CA Corporate Identification No. C 0346364

Partnership Individual

By signing the Ownership Disclosure Statement, the owner(s) acknowledge that an application for a permit, map or other matter will be filed with the City of San Diego on the subject property with the intent to record an encumbrance against the property. Please list below the owner(s), applicant(s), and other financially interested persons of the above referenced property. A financially interested party includes any individual, firm, co-partnership, joint venture, association, social club, fraternal organization, corporation, estate, trust, receiver or syndicate with a financial interest in the application. If the applicant includes a corporation or partnership, include the names, titles, addresses of all individuals owning more than 10% of the shares. If a publicly-owned corporation, include the names, titles, and addresses of the corporate officers. (A separate page may be attached if necessary.) If any person is a nonprofit organization or a trust, list the names and addresses of ANY person serving as an officer or director of the nonprofit organization or as trustee or beneficiary of the nonprofit organization. A signature is required of at least one of the property owners. Attach additional pages if needed. Note: The applicant is responsible for notifying the Project Manager of any changes in ownership during the time the application is being processed or considered. Changes in ownership are to be given to the Project Manager at least thirty days prior to any public hearing on the subject property. Failure to provide accurate and current ownership information could result in a delay in the hearing process.

Property Owner

Name of Individual: Community Congregational Church Of Pacific Beach Owner Tenant/Lessee Successor Agency

Street Address: 2088 Beryl Street

City: San Diego State: CA Zip: 92109

Phone No.: 858-274-6600 Fax No.: _____ Email: administrator@uccpacificbeach.com

Signature: Kathleen Mandenthal Date: 6/26/22

Additional pages Attached: Yes No

Applicant

Name of Individual: Tara Carmichael, MD7 LLC, obo AT&T Owner Tenant/Lessee Successor Agency

Street Address: 10590 West Ocean Air Drive

City: San Diego State: CA Zip: 92130

Phone No.: 858-952-1936 Fax No.: _____ Email: tcarmichael@md7.com

Signature: Tara Carmichael Date: 06/17/2022

Additional pages Attached: Yes No

Other Financially Interested Persons

Name of Individual: _____ Owner Tenant/Lessee Successor Agency

Street Address: _____

City: _____ State: _____ Zip: _____

Phone No.: _____ Fax No.: _____ Email: _____

Signature: _____ Date: _____

Additional pages Attached: Yes No

Printed on recycled paper. Visit our web site at www.sandiegocounty.gov/government/development-services/.
Upon request, this information is available in alternative formats for persons with disabilities.


CAL02071 Coverage plots FA: 10090957

May 3rd, 2022

Jorge Melchor



Existing/proposed coverage With CAL02071

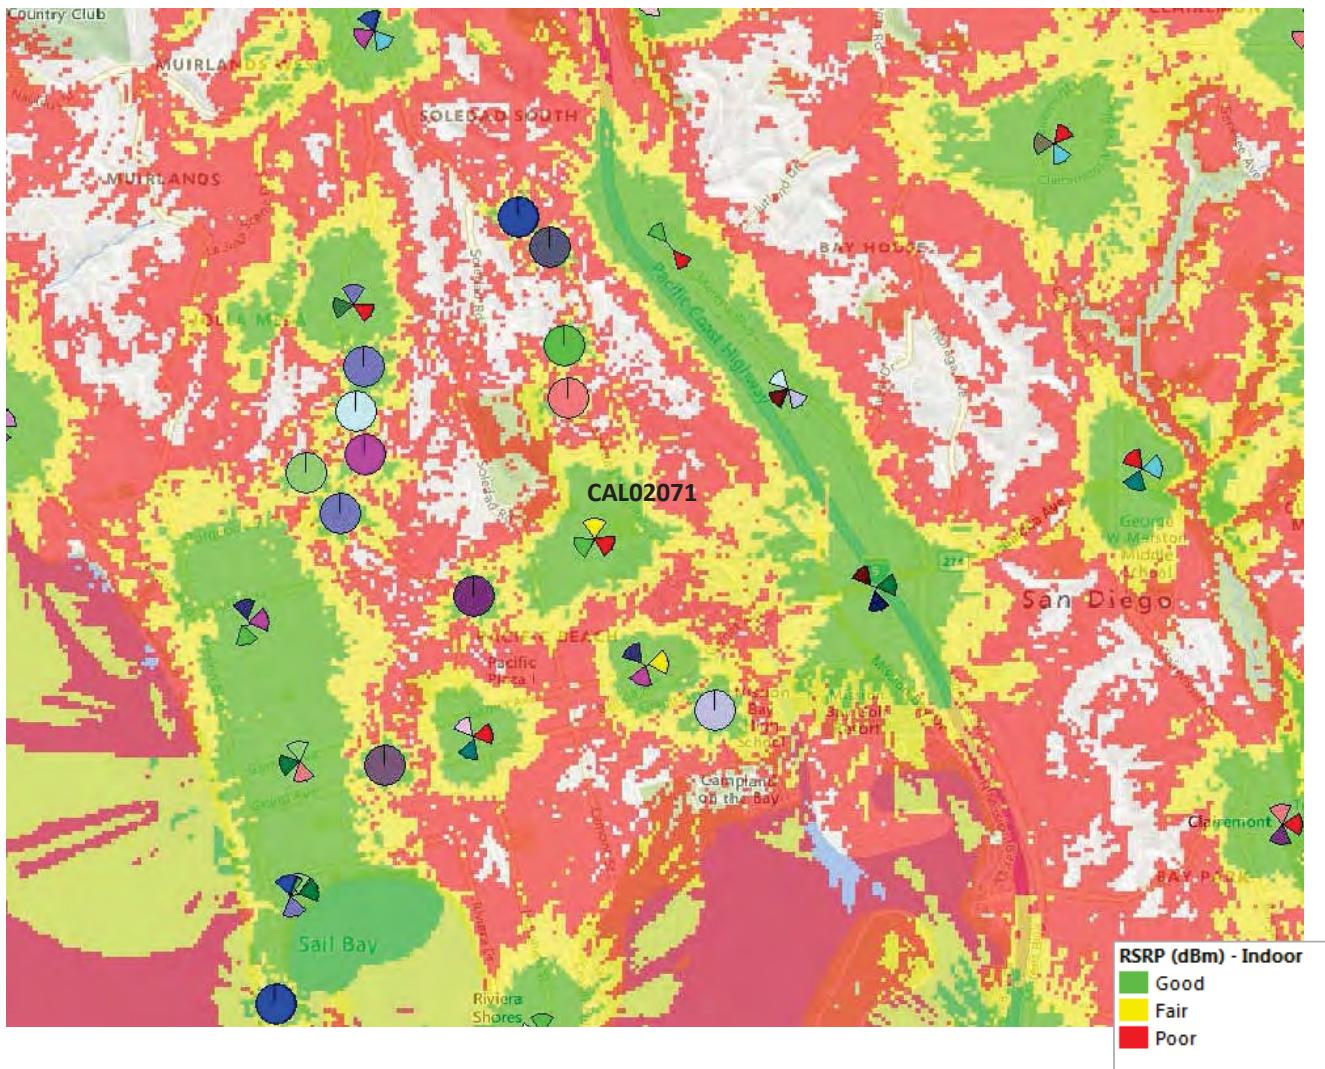

Coverage Without CAL02071

