#### La Jolla Shores Planned District Advisory Board (LJSPDAB) APPLICANT PROJECT INFORMATION FORM

Please provide the following information on this form to schedule your project at an upcoming La Jolla Shores Planned District Advisory Board meeting.

#### For Action Items

- Project Tracking System (PTS) Number/Accela "PRJ" Number and Project Name (only submitted projects to the Development Services Department can be heard as action items):
   PRJ-1107292, La Jolla Community Entry Sign
- Address and APN(s): Located in the public right-of-way directly adjacent to 2204 Torey Pines Rd (located in the triangle median between Torrey Pines Road and La Jolla Shores Drive)
- Project contact name, phone, e-mail:

### Rotary Club of La Jolla/Project Representative: Cindy Goodman, <u>cynthiagoodman4@gmail.com</u>, 858-456-2545

Civil Engineer/Permit POC: Sarah Hess, <u>shess@plsaengineering.com</u>, 858-259-8212, ext 151

- Project description: Installation of a new, non-illuminated, "Welcome to La Jolla" Community Entry Sign
- Please indicate the action you are seeking from the Advisory Board:
   Recommendation that the Project is minor in scope (Process 1)
   Recommendation of approval of a Site Development Permit (SDP)
   Recommendation of approval of a Site Development Permit (SDP) and Coastal Development Permit (CDP)
   Other:
- In addition, provide the following:
  - o lot size: N/A
  - $\circ$  existing structure square footage and FAR (if applicable): **N/A**
  - proposed square footage and FAR: **N/A**
  - existing and proposed setbacks on all sides: N/A
  - height if greater than 1-story (above ground): **N/A**

**For Information Items** (For projects seeking input and direction. No action at this time)

- Project name (Unsubmitted projects can be informational items if the development team is seeking comments and direction from the Board on the concept): \_\_\_\_\_\_
- Address and APN(s): \_\_\_\_\_
- Project description: \_\_\_\_\_\_
- In addition to the project description, please provide the following:
  - lot size: \_\_\_\_\_
  - existing structure square footage and FAR (if applicable): \_\_\_\_\_

- existing and proposed setbacks on all sides: \_\_\_\_\_
- height if greater than 1-story (above ground): \_\_\_\_
- Project aspect(s) that the applicant team is seeking Advisory Board direction on. (Community character, aesthetics, design features, etc.): \_\_\_\_\_\_

#### Exhibits and other materials to provide:

Exhibits and other project-related presentation materials (e.g. site plan, elevations, exhibits showing addition/remodel areas, etc.) although not required, are extremely helpful in informing the Advisory Board's review and understanding of a project. The following exhibits and materials are recommended and if provided by the applicant, will be attached to the agenda and posted to the City's website:

<u>https://www.sandiego.gov/planning/community/profiles/lajolla/pddoab</u> for view by the public:

- All exhibits should be sized to 8 ½" X 11" format
- Exhibits, which can contain the following:
  - A. A site plan showing the street, the property line on all sides, the setbacks on all sides, and the setbacks from the property lines to the neighboring building;
  - B. Elevations for all sides;
  - C. If the proposal is for a remodel, a clear delineation of what part of the proposed structure is new construction
  - D. If the proposal is for a building with more than one story, show:
    - how the upper story sits on the story beneath it (setback of the upper story from the lower story);
    - the distance from the proposed upper story to comparable stories of the neighboring buildings; and
    - > the height of neighboring buildings compared to the proposed structure's height.
- Any surveys that indicate similarities in floor area or architectural style in the surrounding neighborhood
- Any communications such as letter and emails from adjacent neighbors, local neighborhood groups, and/or the Homeowners' Association
- The most recent Project Issues Report for the project from the Development Services Department

#### PLEASE DO NOT PROVIDE THE FOLLOWING:

- The complete plan set of the project. Complete plan sets take up a lot of memory to distribute and most of the information is not necessary for the Advisory Board's review.
- Plans or exhibits of the interior of the project. Interiors are not reviewed by the Advisory Board.
- Personal contact information of the property owners of the project should not be included, unless they are the "owner/applicant" and they are the designated point of contact

The Advisory Board members are very keen to know that the neighbors in the immediate vicinity have been noticed and their views noted. Community conformity, setbacks, FAR, parking, view corridors, bulk & scale, and articulation are key discussion points on all projects. Action Items will be heard first.

Thank you,

Please return the information requested to no later than a week before the scheduled meeting date:

Melissa Garcia, Senior Planner magarcia@sandiego.gov City Planning Department 619-236-6173

### GENERAL NOTES

1. APPROVAL OF THESE PLANS BY THE CITY ENGINEER DOES NOT AUTHORIZE ANY WORK TO BE PERFORMED UNTIL A PERMIT HAS BEEN ISSUED.

2. UPON ISSUANCE OF A PERMIT, NO WORK WILL BE PERMITTED ON WEEKENDS OR HOLIDAYS UNLESS APPROVED BY TRAFFIC CONTROL PERMIT FROM THE DEVELOPMENT SERVICES DEPARTMENT.

3. THE APPROVAL OF THIS PLAN OR ISSUANCE OF A PERMIT BY THE CITY OF SAN DIEGO DOES NOT AUTHORIZE THE PERMIT HOLDER OR OWNER TO VIOLATE ANY FEDERAL, STATE OR CITY LAWS, ORDINANCES, REGULATIONS, OR POLICIES.

4. IMPORTANT NOTICE: SECTION 4216 OF THE GOVERNMENT CODE REQUIRES A DIG ALERT IDENTIFICATION NUMBER ISSUED BEFORE A ``PERMIT TO EXCAVATE" WILL BE VALID. FOR YOUR DIG ALERT I.D. NUMBER, CALL UNDERGROUND SERVICE ALERT, TOLL FREE (800) 422-4133, TWO DAYS BEFORE YOU DIG.

5. CONTRACTOR SHALL BE RESPONSIBLE FOR POTHOLING AND LOCATING ALL EXISTING UTILITIES THAT CROSS THE PROPOSED TRENCH LINE WHILE MAINTAINING A 1 FOOT VERTICAL CLEARANCE.

6. "PUBLIC IMPROVEMENT SUBJECT TO DESUETUDE OR DAMAGE." IF REPAIR OR REPLACEMENT OF SUCH PUBLIC IMPROVEMENTS IS REQUIRED, CONTRACTOR SHALL OBTAIN THE REQUIRED PERMITS FOR WORK IN THE PUBLIC RIGHT-OF-WAY, SATISFACTORY TO THE PERMIT ISSUING AUTHORITY

7. DEVIATIONS FROM THESE SIGNED PLANS WILL NOT BE ALLOWED UNLESS A CONSTRUCTION CHANGE IS APPROVED BY THE CITY ENGINEER OR THE CHANGE IS REQUIRED BY THE RESIDENT ENGINEER.

8. CONTRACTOR SHALL REPLACE OR REPAIR ALL TRAFFIC SIGNAL LOOPS, CONDUITS, AND LANE STRIPING DAMAGED DURING CONSTRUCTION.

9. PRIOR TO SITE DISTURBANCE, CONTRACTOR SHALL MAKE ARRANGEMENTS FOR A PRECONSTRUCTION MEETING WITH THE CITY OF SAN DIEGO'S RIGHT-OF-WAY INSPECTION TEAM (FIT), (619) 446-5242, FIT\_DSD@SANDIEGO.GOV AT 8525 GIBBS DR., SUITE 200 & 201, SAN DIEGO, CA 92123

10. CONTRACTOR SHALL ONLY PERFORM SITE SURVEY AND UTILITY MARK OUT SERVICES PRIOR TO THE PRECONSTRUCTION MEETING.

11. CONTRACTOR SHALL IMPLEMENT AN EROSION CONTROL PROGRAM DURING THE PROJECT CONSTRUCTION ACTIVITIES. THE PROGRAM SHALL COMPLY WITH ALL APPLICABLE REQUIREMENTS OF THE STATE WATER RESOURCE CONTROL BOARD.

12. CONTRACTOR SHALL HAVE EMERGENCY MATERIAL AND EQUIPMENT ON HAND FOR UNFORESEEN SITUATIONS, SUCH AS DAMAGE TO UNDERGROUND WATER, SEWER, AND STORM DRAIN FACILITIES WHERE FLOW MAY GENERATE EROSION AND SEDIMENT POLLUTION.

13. MANHOLES, VAULTS AND PULL BOX COVERS SHALL BE LABELED WITH THE "NAME OF COMPANY"AND HAVE A SLIP RESISTANT LID WITH A MINIMUM STATIC COEFFICIENT OF FRICTION OF 0.5.

14. AS-BUILT DRAWINGS MUST BE SUBMITTED TO THE RESIDENT ENGINEER PRIOR TO ACCEPTANCE OF THIS PROJECT BY THE CITY OF SAN DIEGO.

15. CONTRACTOR SHALL PROVIDE RED-LINES DRAWINGS IN ACCORDANCE WITH 2-5.4 OF THE WHITEBOOK, "RED-LINES AND RECORD DOCUMENTS."

16. CONTRACTOR SHALL MAINTAIN A MINIMUM OF 1 FOOT VERTICAL SEPARATION TO ALL UTILITIES UNLESS OTHERWISE SPECIFIED ON THE PLANS.

17. CONTRACTOR SHALL REMOVE AND REPLACE ALL UTILITY BOXES SERVING AS HANDHOLES THAT ARE NOT IN "AS-NEW" CONDITION IN PROPOSED SIDEWALK, DAMAGED BOXES, OR THOSE THAT ARE NOT IN COMPLIANCE WITH CURRENT CODE SHALL BE REMOVED AND REPLACED WITH NEW BOXES, INCLUDING WATER, SEWER, TRAFFIC SIGNALS, STREET LIGHTS, DRY UTILITIES-SDG&E, COX, ETC. ALL NEW METAL LIDS SHALL BE SLIP RESISTANT AND INSTALLED FLUSH WITH PROPOSED SIDEWALK GRADE. IF A SLIP RESISTANT METAL LID IS NOT COMMERCIALLY AVAILABLE FOR THAT USE, NEW BOXES AND LIDS SHALL BE INSTALLED

18. CONTRACTOR SHALL INSTALL CITY APPROVED TEMPORARY VIDEO OR RADAR DETECTION WHEN EXISTING TRAFFIC SIGNAL DETECTION SYSTEMS ARE DAMAGED, DISABLED, OR BECOME INEFFECTIVE DUE TO CONSTRUCTION ACTIVITIES FOR A PERIOD OF GIVE (5) OR MORE DAYS, SATISFACTORY TO THE CITY ENGINEER. THE CONTRACTOR SHALL COMPLETELY REMOVE ALL TEMPORARY TRAFFIC SIGNAL DETECTION EQUIPMENT AND RESTORE/INSTALL A CITY APPROVED PERMANENT VEHICLE DETECTION SYSTEM UPON COMPLETION OF CONSTRUCTION, SATISFACTORY TO THE CITY ENGINEER.

19. PRIOR TO CONSTRUCTION, SURVEY MONUMENTS (HORIZONTAL AND VERTICAL) THAT ARE LOCATED IN THE CONSTRUCTION AREA SHALL BE TIED-OUT AND REFERENCED BY A LAND SURVEYOR.

20. UPON COMPLETION OF CONSTRUCTION, ALL DESTROYED SURVEY MONUMENTS ARE REQUIRED TO BE REPLACED, AND A CORNER RECORD OF SURVEY SHALL BE PREPARED AND FILED WITH THE COUNTY SURVEYOR AS REQUIRED BY THE PROFESSIONAL LAND SURVEYOR ACT, SECTION 8771 OF THE BUSINESS AND PROFESSIONS CODE OF THE STATE OF CALIFORNIA.

### **GROUND WATER DISCHARGE NOTES**

ALL GROUND WATER EXTRACTIONS AND SIMILAR WASTE DISCHARGES TO SURFACE WATERS NOT TRIBUTARY TO THE SAN DIEGO BAY ARE PROHIBITED UNTIL IT CAN BE DEMONSTRATED THAT THE OWNER HAS APPLIED AND OBTAINED AUTHORIZATION FROM THE STATE OF CALIFORNIA VIA AN OFFICIAL "ENROLLMENT LETTER" FROM THE REGIONAL WATER QUALITY CONTROL BOARD IN ACCORDANCE WITH THE TERMS, PROVISIONS AND CONDITIONS OF STATE ORDER NO R9-2015-0013 NPDES CAG919003.


2. THE ESTIMATED MAXIMUM DISCHARGE RATES MUST NOT EXCEED THE LIMITS SET IN THE OFFICIAL "ENROLLMENT LETTER" FROM THE REGIONAL BOARD UNLESS PRIOR NOTIFICATION AND SUBSEQUENT AUTHORIZATION HAS BEEN OBTAINED, AND DISCHARGE OPERATIONS MODIFIED TO ACCOMMODATE THE INCREASED RATES.

3. ALL GROUND WATER EXTRACTIONS AND SIMILAR WASTE DISCHARGES TO SURFACE WATERS TRIBUTARY TO THE SAN DIEGO BAY ARE PROHIBITED UNTIL IT CAN BE DEMONSTRATED THAT THE OWNER HAS APPLIED AND OBTAINED AUTHORIZATION FROM THE STATE OF CALIFORNIA VIA AN OFFICIAL "ENROLLMENT LETTER" FROM THE REGIONAL WATER QUALITY CONTROL BOARD IN ACCORDANCE WITH THE TERMS, PROVISIONS AND CONDITIONS OF STATE ORDER NO R9-2015-0013 NPDES NO. CAG919003.


## DECLARATION OF RESPONSIBLE CHARGE

I HEREBY DECLARE THAT I AM THE ENGINEER OF WORK FOR THIS PROJECT. THAT I HAVE EXERCISED RESPONSIBLE CHARGE OVER THE DESIGN OF THE PROJECT AS DEFINED IN SECTION 6703 OF THE BUSINESS AND PROFESSIONS CODE, AND THAT THE DESIGN IS CONSISTENT WITH CURRENT STANDARDS.

I UNDERSTAND THAT THE CHECK OF PROJECT DRAWINGS AND SPECIFICATIONS BY THE CITY OF SAN DIEGO IS CONFINED TO A REVIEW ONLY AND DOES NOT RELIEVE ME. AS ENGINEER OF WORK. OF MY RESPONSIBILITIES FOR PROJECT DESIGN.

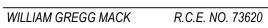

EXP. 12-31-2024

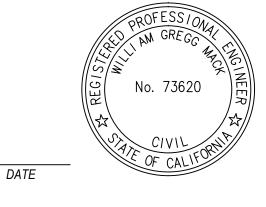



CHANGE	BY	AFFECTED OR ADDED SHEET NUMBERS

NO SCALE

THE PERMITTEE SHALL BE RESPONSIBLE FOR THE COST OF REPLACING ALL SURVEY MONUMENTS DESTROYED BY CONSTRUCTION. IF A VERTICAL CONTROL MONUMENT IS TO BE DISTURBED OR DESTROYED, THE CITY OF SAN DIEGO FIELD SURVEY SECTION SHALL BE NOTIFIED IN WRITING AT LEAST 7 DAYS PRIOR TO DEMOLITION/CONSTRUCTION.

NAMF


PRIOR TO PERMIT ISSUANCE, THE PERMITTEE SHALL RETAIN THE SERVICE OF A PROFESSIONAL LAND SURVEYOR OR CIVIL ENGINEER AUTHORIZED TO PRACTICE LAND SURVEYING WHO WILL BE RESPONSIBLE FOR MONUMENT PRESERVATION AND SHALL PROVIDE A CORNER RECORD OR RECORD OF SURVEY TO THE COUNTY SURVEYOR AS REQUIRED BY THE PROFESSIONAL LAND SURVEYORS ACT, IF APPLICABLE. (SECTION 8771 OF THE BUSINESS AND PROFESSIONS CODE OF THE STATE OF CALIFORNIA)

NO SURVEY MONUMENTS WERE FOUND WITHIN THE LIMITS OF WORK SURVEY MONUMENTS EXISTING IN OR NEAR LIMITS OF WORK WILL BE PROTECTED IN PLACE SURVEY MONUMENTS HAVE BEEN TIED OUT AND A FINAL OR PARCEL MAP WILL BE FILED (NO CORNER RECORD OR RECORD OF SURVEY WILL BE REQUIRED)

OTHER AGENCY SURVEY MONUMENT (CORNER RECORD OR RECORD OF SURVEY MAY NOT BE REQUIRED). AGENCY HAS BEEN NOTIFIED OF POSSIBLE MONUMENT DESTRUCTION AND A LETTER PROVIDED TO CITY A PRE-CONSTRUCTION CORNER RECORD (OR RECORD OF SURVEY) FOR SURVEY MONUMENTS FOUND WITHIN THE LIMITS OF WORK HAS BEEN FILED. CORNER RECORD #\_\_\_\_\_ OR RECORD OF SURVEY #\_\_\_\_\_

P.L.S. NO. 9323 MAXIMILLIAN LEBL

# IMPROVEMENT PLANS FOR: LA JOLLA COMMUNITY ENTRY SIGN

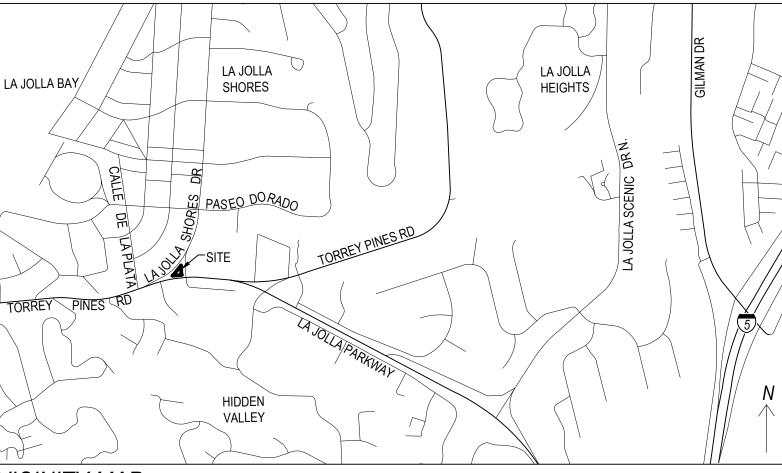

VICINITY MAP

## MONUMENT PRESERVATION CERTIFICATION

THE TYPE OF CONSTRUCTION WILL NOT AFFECT ANY SURVEY MONUMENTS (THIS LINE IS FOR PROJECTS THAT ARE PROPOSING NO DEMOLITION, TRENCHING, ASSOCIATED WITH A CIP, ETC)

I HAVE INSPECTED THE SITE AND DETERMINED THAT:

POST CONSTRUCTION CORNER RECORD (AS-BUILT ITEM)

 POST CONSTRUCTION CORNER RECORD FOR SURVEY MONUMENTS DESTROYED DURING CONSTRUCTION AND REPLACED AFTER CONSTRUCTION.

EXP. 03-31-2025

CORNER RECORD #\_\_\_\_\_ OR RECORD OF SURVEY #\_\_\_

P.L.S. / R.C.E. NO. XXXXX EXP. XX-XX-XX DATE SHEET INDEX DISCIPLINE CODE (DC) GENERAL TITLE SHEET G01 CIVIL GENERAL NOTES G02 TRAFFIC CONTROL TC IMPROVEMENT PLAN C01 SIGN DETAILS C02 **EROSION CONTROL PLAN** C03 TRAFFIC CONTROL PLANS TC01-TC02

## **OWNER/APPLICANT**

THE ROTARY CLUB OF LA JOLLA P.O BOX 525. LA JOLLA. CA 92038 EMAIL:CINDYGOODMAN4@GMAIL.COM PHONE NUMBER: 858-456-2545

## REFERENCE DRAWINGS

SEWER	
WATER	
	5066-D, 6686-D
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	SDGE GIS FACILI

## SITE ADDRESS

CROSS STREETS: TORREY PINES RD & LA JOLLA SHORES DR

## BENCHMARK

CITY OF SAN DIEGO VERTICAL CONTROL BENCHMARK MONUMENT DESCRIPTION: BRASS PLUG LOCATION: TOP OF CURB IN THE NORTHEAST CORNER OF TORREY PINES ROAD AN JOLLA SHORES DR. DATUM: NGVD 29 ELEVATION: 56.28 FEET

### CONSTRUCTION STORM WATER **PROTECTION NOTES**

TOTAL SITE DISTURBANCE AREA (ACRES): 0.0023 WATERSHED: MISSION BEACH-FRONTAL PACIFIC OCEAN

- HYDRAULIC SUB AREA NAME AND NUMBER: SCRIPPS 906.30
- 2. THE PROJECT SHALL COMPLY WITH THE REQUIREMENTS OF THE WPCP ☑ THE PROJECT IS SUBJECT TO MUNICIPAL STORM WATER PERMIT NUMB AND SUBSEQUENT AMENDMENTS ..

□ THE PROJECT IS SUBJECT TO MUNICIPAL STORM WATER PERMIT NUMBE AND CONSTRUCTION GENERAL PERMIT ORDER NUMBER 2009-009-DWQ ORDER 2010-0014 DWQ AND 2012-0006-DWQ

TRADITIONAL: LUP WDID NO:	RISK LEVEL		2 🗆 2 🗆	
WDID NO:				

3. CONSTRUCTION SITE PRIORITY LOW 🗆 ASBS 🖂 HIGH 🗆 MEDIUM 🗆



DATE

DATE



CONSTRUCTION CHANGE							
	APPROVED	DATE	PMT NO.	PRJ NO.			

### WORK TO BE DONE

THE PUBLIC IMPROVEMENTS SHOWN ON THESE PLANS SHALL BE CONSTRUCTED ACCORDING TO THE FOLLOWING STANDARD SPECIFICATIONS AND STANDARD DRAWINGS OF THE CITY OF SAN DIEGO.

	STANDARD SPECIFICATIONS:	
9-21-D	DOCUMENT NO.	DESCRIPTION
LITY MAP	ECPI010122-01	STANDARD SPECIFICATIONS FOR PUBLIC WORKS CONSTRUCTION (GREENBOOK), 2021 EDITION
LITY MAP	ECPI010122-02	CITY OF SAN DIEGO STANDARD SPECIFICATIONS FOR PUBLIC WORKS CONSTRUCTION (WHITEBOOK), 2021 EDITION
	PWPI010119-04	CITYWIDE COMPUTER AIDED DESIGN AND DRAFTING (CADD) STANDARDS, 2018 EDITION
	ECPD032324-07	CALIFORNIA MANUAL OF UNIFORM TRAFFIC CONTROL DEVICES REVISION 8 (CA MUTCD REV8), 2014 EDITION
	ECPD092023-05	CALIFORNIA DEPARTMENT OF TRANSPORTATION (CALTRANS SPECIFICATIONS), 2023 EDITION
	STANDARD DRAWINGS:	
	DOCUMENT NO.	DESCRIPTION
ND LA	ECPI010122-03	CITY OF SAN DIEGO STANDARD DRAWINGS, 2021 EDITION
	ECPD092023-06	CALTRANS STANDARD PLANS, 2023 EDITION

## LEGEND

INSPECTOR

### PROPOSED IMPROVEMENTS

3ER R9-2013-0001	IMPROVEMENT		STANDARD DWGS		SYMBOL	
	PROPOSED COMMUNITY (PER PIMA AGR-0002458)				<del>o o o</del> I	
BER R9-2013-0001 Q AS AMENDED BY						
	EXISTING IMPRO	<u>VEMENTS</u>				
	ITEM					
	EXISTING CURB				4	
	EXISTING PCC			·		
	EXISTING LANDSCAPE					
	EXISTING SEWER MAIN			S	S	
	EXISTING WATER MAIN			W	W	
	EXISTING STORM DRAIN	MAIN		SD	SD	
	EXISTING GAS EXISTING ELECTRIC EXISTING STORM DRAIN EXISTING SEWER MANH EXISTING STORM DRAIN	OLE			G	
	EX. WATER METER EX. ELECTRIC PULLBOX				W E	
	TRAFFIC SIGNAL POLE					
	TRAFFIC SIGNAL LIGHT &	& MAST ARM		- <u>X</u>	<u>8                                    </u>	
	EX. TREE (TO REMAIN)			$\left\langle \right\rangle$		
	RIGHT OF WAY LINE					
	RIGHT OF WAY CENTER	INE				
	EXISTING CONTOUR				238	
	REFERENCED PL SIGN PERMIT: N/A RETAINING WALL PERMIT DISCRETIONARY PERMIT PRIVATE CONTRACT	T: N/A				
	WARNING	TITLE	SHEET FOR:			
	0 1/4 1/2 1					
			LA JOLLA COMMUNIT	'Y EN	TRY SIGN	$\mathbf{I}$
	IF THIS BAR DOES NOT MEASURE 1" THEN DRAWING IS NOT TO SCALE.	I	NTERSECTION OF TORREY PINES R	RD AND LA	A JOLLA SHORE	ES DR
<b>)</b>	DE		ENT SERVICES DEPARTMENT		РМТ NO. 325912	24
	APPROVED:				PRJ NO 110729	92
	FOR CITY	Y ENGINEER	DATE			
	DESCRIPTION	BY	APPROVED	DATE		
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					250 - 1 LAMBERT COO	
	AS BUILTS			[	DRAWING NO.	
	CONTRACTOR	· ·	DATE STARTED			-  G(

DATE COMPLETED

101210-1-D

## **CONSTRUCTION BMP GENERAL NOTES**

PRIOR TO ANY SOIL DISTURBANCE, TEMPORARY EROSION AND SEDIMENT CONTROLSHALL BE INSTALLED BY THE CONTRACTOR OR QUALIFIED PERSON(S) AS INDICATED BELOW:

1. ALL REQUIREMENTS OF THE CITY OF SAN DIEGO "LAND DEVELOPMENT MANUAL, STORM WATER STANDARDS" MUST BE INCORPORATED INTO THE DESIGN AND CONSTRUCTION OF THE PROPOSED GRADING/IMPROVEMENTS CONSISTENT WITH THE APPROVED STORM WATER POLLUTION PREVENTION PLAN (SWPPP) AND/OR WATER POLLUTION CONTROL PLAN (WPCP) FOR CONSTRUCTION LEVEL BMP'S AND. IF APPLICABLE, THE STORM WATER QUALITY MANAGEMENT PLAN (SWQMP) FOR POST CONSTRUCTION TREATMENT CONTROL BMP'S.

2. THE CONTRACTOR SHALL INSTALL AND MAINTAIN ALL STORM DRAIN INLETS. INLET PROTECTION IN THE PUBLIC RIGHT OF WAY MAY BE TEMPORARILY REMOVED WHERE IT IS PRONE TO FLOODING PRIOR TO A RAIN EVENT AND REINSTALLED AFTER RAIN IS OVER.

3. ALL CONSTRUCTION BMPS SHALL BE INSTALLED AND PROPERLY MAINTAINED THROUGHOUT THE DURATION OF CONSTRUCTION.

4. THE CONTRACTOR SHALL ONLY GRADE, INCLUDING CLEARING AND GRUBBING, AREAS FOR WHICH THE CONTRACTOR OR QUALIFIED PERSON CAN PROVIDE EROSION AND SEDIMENT CONTROL MEASURES.

5. THE CONTRACTOR IS RESPONSIBLE FOR ENSURING THAT ALL SUB-CONTRACTORS AND SUPPLIERS ARE AWARE OF ALL STORM WATER QUALITY MEASURES AND IMPLEMENT SUCH MEASURES. FAILURE TO COMPLY WITH THE APPROVED SWPPP/WPCP WILL RESULT IN THE ISSUANCE OF CORRECTION NOTICES. CITATIONS, CIVIL PENALTIES AND/OR STOP WORK NOTICES.

6. THE CONTRACTOR OR QUALIFIED PERSON SHALL BE RESPONSIBLE FOR CLEANUP OF ALL SILT, DEBRIS AND MUD ON AFFECTED AND ADJACENT STREET(S) AND WITHIN STORM DRAIN SYSTEM DUE TO CONSTRUCTION VEHICLES/EQUIPMENT AND CONSTRUCTION ACTIVITY AT THE END OF EACH WORK DAY.

7. THE CONTRACTOR SHALL PROTECT NEW AND EXISTING STORM WATER CONVEYANCE SYSTEMS FROM SEDIMENTATION, CONCRETE RINSE, OR OTHER CONSTRUCTION RELATED DEBRIS AND DISCHARGES WITH THE APPROPRIATE BMPS THAT ARE ACCEPTABLE TO THE ENGINEER AND AS INDICATED IN THE SWPPP/WPCP

8. THE CONTRACTOR OR QUALIFIED CONTACT PERSON SHALL CLEAR DEBRIS, SILT, AND MUD FROM ALL DITCHES AND SWALES PRIOR TO AND WITHIN 3 BUSINESS DAYS AFTER EACH RAIN EVENT OR PRIOR TO THE NEXT RAIN EVENT, WHICHEVER IS SOONER.

9. IF A NON-STORMWATER DISCHARGE LEAVES THE SITE, THE CONTRACTOR SHALL IMMEDIATELY STOP THE ACTIVITY AND REPAIR THE DAMAGES. THE CONTRACTOR SHALL NOTIFY THE CITY RESIDENT ENGINEER OF THE DISCHARGE, PRIOR TO RESUMING CONSTRUCTION ACTIVITY. ANY AND ALL WASTE MATERIAL, SEDIMENT, AND DEBRIS FROM EACH NON-STORMWATER DISCHARGE SHALL BE REMOVED FROM THE STORM DRAIN CONVEYANCE SYSTEM AND PROPERLY DISPOSED OF BY THE CONTRACTOR.

10. EQUIPMENT AND WORKERS FOR EMERGENCY WORK SHALL BE MADE AVAILABLE AT ALL TIMES. ALL NECESSARY MATERIALS SHALL BE STOCKPILED ON SITE AT CONVENIENT LOCATIONS TO FACILITATE RAPID DEPLOYMENT OF CONSTRUCTION BMPS WHEN RAIN IS IMMINENT.

11. THE CONTRACTOR SHALL RESTORE AND MAINTAIN ALL EROSION AND SEDIMENT CONTROL BMPS TO WORKING ORDER YEAR ROUND.

12. THE CONTRACTOR SHALL INSTALL ADDITIONAL EROSION AND SEDIMENT CONTROL MEASURES DUE TO GRADING INACTIVITY OR UNFORESEEN CIRCUMSTANCES TO PREVENT NON-STORM WATER AND SEDIMENT-LADEN DISCHARGES.

13. THE CONTRACTOR SHALL BE RESPONSIBLE AND SHALL TAKE NECESSARY PRECAUTIONS TO PREVENT PUBLIC TRESPASS ONTO AREAS WHERE IMPOUNDED WATERS CREATE A HAZARDOUS CONDITION.

14. ALL EROSION AND SEDIMENT CONTROL MEASURES PROVIDED PER THE APPROVED SWPPP/WPCP SHALL BE INSTALLED AND MAINTAINED. ALL EROSION AND SEDIMENT CONTROL FOR INTERIM CONDITIONS SHALL BE PROPERLY DOCUMENTED AND INSTALLED TO THE SATISFACTION OF THE RESIDENT ENGINEER.

15. UPON NOTIFICATION BY THE RESIDENT ENGINEER, THE CONTRACTOR SHALL ARRANGE FOR MEETINGS DURING OCTOBER 1ST TO APRIL 30TH FOR PROJECT TEAM (GENERAL CONTRACTOR, QUALIFIED PERSON, EROSION CONTROL SUBCONTRACTOR IF ANY, ENGINEER OF WORK, OWNER/DEVELOPER AND THE RESIDENT ENGINEER) TO EVALUATE THE ADEQUACY OF THE EROSION AND SEDIMENT CONTROL MEASURES AND OTHER BMPS RELATIVE TO ANTICIPATED CONSTRUCTION ACTIVITIES.

16. THE CONTRACTOR SHALL CONDUCT VISUAL INSPECTIONS DAILY AND MAINTAIN ALL BMPS AS NEEDED. VISUAL INSPECTIONS AND MAINTENANCE OF ALL BMPS SHALL BE CONDUCTED BEFORE, DURING AND AFTER EVERY RAIN EVENT AND EVERY 24 HOURS DURING ANY PROLONGED RAIN EVENT, THE CONTRACTOR SHALL MAINTAIN AND REPAIR ALL BMPS AS SOON AS POSSIBLE AS SAFETY ALLOWS.

17. CONSTRUCTION ENTRANCE AND EXIT AREA. TEMPORARY CONSTRUCTION ENTRANCE AND EXITS SHALL BE CONSTRUCTED IN ACCORDANCE WITH CASQA FACT SHEET TC-10R CALTRANS FACT SHEET TC-01 TO PREVENT TRACKING OF SEDIMENT AND OTHER POTENTIAL POLLUTANTS ONTO PAVED SURFACES AND TRAVELED WAYS. WIDTH SHALL BE 10' OR THE MINIMUM NECESSARY TO ACCOMMODATE VEHICLES AND EQUIPMENT WITHOUT BY PASSING THE ENTRANCE.

(a) NON-STORMWATER DISCHARGES SHALL BE EFFECTIVELY MANAGED PER THE SAN DIEGO MUNICIPAL CODE CHAPTER 4, ARTICLE 3, DIVISION 3 "STORM WATER MANAGEMENT AND DISCHARGE CONTROL".

## MINIMUM POST-CONSTRUCTION MAINTENANCE PLAN

AT THE COMPLETION OF THE WORK SHOWN, THE FOLLOWING PLAN SHALL BE FOLLOWED TO ENSURE WATER QUALITY CONTROL IS MAINTAINED FOR THE LIFE OF THE PROJECT:

1. STABILIZATION: ALL THE PLANTED SLOPES AND OTHER VEGETATED AREAS SHALL BE INSPECTED PRIOR TO OCTOBER 1 OF EACH YEAR AND AFTER MAJOR RAINFALL EVENTS (MORE THAN <sup>1</sup>/<sub>2</sub> INCH) AND REPAIRED AND REPLANTED AS NEEDED UNTIL A NOTICE OF TERMINATION (NOT) IS FILLED.

2. STRUCTURAL PRACTICES: DESILTING BASINS, DIVERSION DITCHES, DOWNDRAINS, INLETS, OUTLET PROTECTION MEASURES, AND OTHER PERMANENT WATER QUALITY AND SEDIMENT AND EROSION CONTROLS SHALL BE INSPECTED PRIOR TO OCTOBER 1ST OF EACH YEAR AND AFTER MAJOR RAINFALL EVENTS (MORE THAN <sup>1</sup>/<sub>2</sub> INCH). REPAIRS AND REPLACEMENTS SHALL BE MADE AS NEEDED AND RECORDED IN THE MAINTENANCE LOG IN PERPETUITY.


3. OPERATION AND MAINTENANCE, FUNDING: POST-CONSTRUCTION MANAGEMENT MEASURES ARE THE RESPONSIBILITY OF THE DEVELOPER UNTIL THE TRANSFER OF RESPECTIVE SITES TO HOME BUILDERS, INDIVIDUAL OWNERS, HOMEOWNER ASSOCIATIONS, SCHOOL DISTRICTS, OR LOCAL AGENCIES AND/OR GOVERNMENTS AT THAT TIME. THE NEW OWNERS SHALL ASSUME RESPONSIBILITY FOR THEIR RESPECTIVE PORTIONS OF THE DEVELOPMENT.

	AGREEMENT DATA						
APPROVAL TYPE	DESCRIPTION	APPROVAL NO.	DOCUMENT NO.	SEE SHEET NO.			
PIMA	LA JOLLA COMMUNITY ENTRY SIGN	AGR-0002458		4			

STREET DATA TABLE							
STREET NAME	CLASSIFICATION	SPEED (MPH)	ADT (VEHICLES)	R/W (FT)			
LA JOLLA SHORES DR	2-LANE MODIFIED COLLECTOR	30	18,192	150'			
TORREY PINES RD	4-LANE MODIFIED COLLECTOR	35	52,789	184'			



### KEY MAP (1"=40')

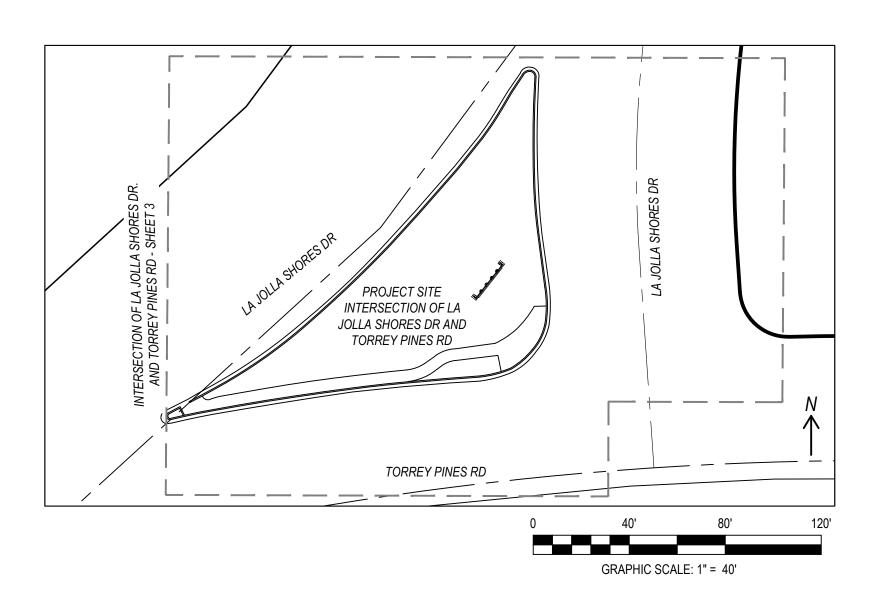

## TRAFFIC CONTROL NOTES (5000 ADT OR MORE

1. VALIDATION: THE TRAFFIC CONTROL PLAN IS NOT VALID UNTIL WORK DATES AND WORK HOURS ARE APPROVED. THE CONTRACTOR SHALL SUBMIT TWO (2) REDUCED COPIES OF TRAFFIC CONTROL PLANS (11"X17") TO THE TRAFFIC CONTROL PERMIT COUNTER, DEVELOPMENT SERVICE DEPARTMENT, 101 ASH STREET, SAN DIEGO. THE CONTRACTOR SHALL OBTAIN A TRAFFIC CONTROL PERMIT A MINIMUM OF TWO (2) WORKING DAYS PRIOR TO STARTING WORK, AND A MINIMUM OF FIVE (5) DAYS IF WORK WILL AFFECT A BUS STOP OR AN EXISTING TRAFFIC SIGNAL, OR IF WORK WILL REQUIRE A ROAD OR ALLEY CLOSURE.

DESCRIPTION

STANDARD SPECIFICATIONS FOR WORKS CONSTRUCTION (GREEN

CITY OF SAN DIEGO STANDARD I FOR PUBLIC WORKS CONSTRUC

CALIFORNIA DEPARTMENT OF TH MANUAL ON UNIFORM TRAFFIC (CA MUTCD REV 6), 2014 EDITION

CONTROL AFFECTING THE AGENCIES LISTED BELOW:

FIRE DEPARTMENT DISPATCH POLICE DEPARTMENT DISPATCH ENVIRONMENTAL SERVICES STREET DIVISION METROPOLITAN TRANSIT SYSTE METROPOLITAN TRANSIT SYSTE METROPOLITAN TRANSIT SYSTE UNDERGROUND SERVICE ALERT U.S. NAVY

SAN DIEGO COUNTY REGIONAL AIRPORT AUTHORITY

THE CONTRACTOR SHALL NOTIFY PROPERTY OWNERS AND TENANTS A MINIMUM OF FIVE (5) WORKING DAYS PRIOR TO CLOSURE OF DRIVEWAYS. THE CONTRACTOR SHALL POST SIGNS NOTIFYING THE PUBLIC A MINIMUM OF FIVE (5) WORKING DAYS PRIOR TO CLOSURE OF STREETS.

PRIOR TO STARTING ANY WORK INVOLVING NIGHTTIME OR WEEKEND HOURS.

6. EXCAVATIONS: EXCEPT WHEN OTHERWISE SHOWN ON THE PLANS, ALL TRENCHES SHALL BE BACKFILLED OR TRENCH-PLATED AT THE END OF EACH WORKDAY. AN ASPHALT RAMP SHALL BE PLACED AROUND EACH TRENCH PLATE TO PREVENT THE PLATE FROM BEING DISLODGED. CONTRACTOR SHALL MONITOR TRENCH PLATES DURING NON-WORKING HOURS TO ENSURE THAT THEY DO NOT BECOME DISLODGED. UPON COMPLETION OF EXCAVATION BACKFILL, THE CONTRACTOR SHALL PROVIDE A SATISFACTORY SURFACE FOR TRAFFIC. WHEN CONSTRUCTION OPERATIONS ARE NOT ACTIVELY IN PROGRESS, THE CONTRACTOR SHALL MAINTAIN ALL TRAVEL LANES, BIKE LANES, AND PEDESTRIAN WALKWAYS IN THE RIGHT-OF-WAY EXCEPT WHEN OTHERWISE SHOWN ON THE PLANS.

CONSTRUCTION OF SUCH WALKWAY.

8. RESTORATION OF ROADWAY: THE CONTRACTOR SHALL REPAIR OR REPLACE ALL EXISTING IMPROVEMENTS WITHIN THE RIGHT-OF-WAY NOT DESIGNATED FOR PERMANENT REMOVAL (TRAFFIC SIGNS, STRIPING, PAVEMENT MARKERS, PAVEMENT MARKINGS, LEGENDS, CURB MARKINGS, LOOP DETECTORS, TRAFFIC SIGNAL EQUIPMENT, ETC.) WHICH ARE DAMAGED OR REMOVED AS A RESULT OF OPERATIONS. REPAIRS AND REPLACEMENTS SHALL BE AT LEAST EQUAL TO EXISTING IMPROVEMENT.

9. PROVISION OF TEMPORARY TRAFFIC SIGNAL DETECTION: THE CONTRACTOR SHALL INSTALL CITY APPROVED TEMPORARY VIDEO OR RADAR DETECTION WHEN EXISTING TRAFFIC SIGNAL DETECTION SYSTEMS ARE DAMAGED, DISABLED, OR BECOME INEFFECTIVE DUE TO CONSTRUCTION ACTIVITIES FOR A PERIOD OF FIVE (5) OR MORE DAYS, SATISFACTORY TO THE CITY ENGINEER. THE CONTRACTOR SHALL COMPLETELY REMOVE ALL TEMPORARY TRAFFIC SIGNAL DETECTION EQUIPMENT AND RESTORE/INSTALL A CITY APPROVED PERMANENT VEHICLE DETECTION SYSTEM UPON COMPLETION OF CONSTRUCTION. SATISFACTORY TO THE CITY ENGINEER.

10. CHANGE IN WORK: THE CITY ENGINEER RESERVES THE RIGHT TO OBSERVE THESE TRAFFIC CONTROL PLANS IN OPERATION AND TO MAKE ANY CHANGES AS FIELD CONDITIONS WARRANT. ANY CHANGES SHALL BE DOCUMENTED AND SUPERSEDE THESE PLANS.



WILLIAM GREGG MACK R.C.E. NO. 73620 EXP. 12-31-2024

DATE

2. CONTRACTOR SHALL NOTIFY THE CITY TRAFFIC ENGINEER AT (858) 495-4742 A MINIMUM OF FIVE (5) WORKING DAYS PRIOR TO ANY CONSTRUCTION WORK AFFECTING TRAFFIC SIGNALS.

3. STANDARDS: THE TRAFFIC CONTROL PLAN SHALL CONFORM TO THE MOST RECENT ADOPTED EDITION OF EACH OF THE FOLLOWING MANUALS:

	<b>EDITION</b>	DOCUMENT NO.
R PUBLIC NBOOK), 2021 EDITION	2021	ECPI010122-01
DRAWINGS CTION, 2021 EDITION	2021	ECPI010122-03
RANSPORTATION CONTROL DEVICES	2014	PWPI060121-10

4. NOTIFICATIONS: THE CONTRACTOR SHALL NOTIFY THE FOLLOWING AGENCIES A MINIMUM OF FIVE (5) WORKING DAYS PRIOR TO ANY EXCAVATION, CONSTRUCTION, OR TRAFFIC


	(STREET OR ALLEY CLOSURE)	(858) 573-1300
H	(STREET OR ALLEY CLOSURE)	(858) 495-7800
	(REFUSE COLLECTION)	(858) 492-5060
	(TRAFFIC SIGNALS)	(619) 527-7500
EM (MTS)	(BUS STOPS)	(619) 238-0100 EXT. 64
EM (MTS)	(TAXI ZONES)	(619) 235-2644
EM (MTS)	(TROLLEY LINES)	(619) 595-4930
Т	(ANY EXCAVATION)	(800) 422-4133
	(32ND ST NAVAL STATION)	(619) 556-1319
AIRPORT	AUTHORITY	(619) 400-2880

THE CONTRACTOR SHALL NOTIFY CONSTRUCTION MANAGEMENT & FIELD SERVICES DIVISION AT (858) 627-3200 AND ARRANGE FOR INSPECTION A MINIMUM OF FIVE (5) WORKING DAYS

5. POSTING PARKING RESTRICTIONS: THE CONTRACTOR SHALL POST TOW-AWAY/NO PARKING SIGNS SEVENTY-TWO (72) HOURS IN ADVANCE OF PARKING REMOVAL. SIGNS SHALL INDICATE SPECIFIC DAYS, DATES AND TIMES OF RESTRICTIONS. PARKING METERS SHALL BE BAGGED WHERE APPLICABLE.

7. COVERED PEDESTRIAN WALKWAY: THE CONTRACTOR SHALL CONTACT CITY RESIDENT ENGINEER AT (619) 627-3200 FOR INSPECTION OF ANY COVERED PEDESTRIAN WALKWAY DURING

	PRIVATE CONTRACT WARNING 0 1/4 1/2 IF THIS BAR DOES NOT MEASURE 1" THEN DRAWING IS NOT TO SCALE.	1 3 5	ERAL NOTES FOR: LA JOLLA COMMU INTERSECTION OF TORREY PIN			
GØ	D		IENT SERVICES DEPARTME	ENT	PMT NO. 3259124	I
	APPROVED: FOR CITY ENGINEER DATE				PRJ NO1107292	2
	DESCRIPTION ORIGINAL	BY PLSA	APPROVED	DATE	1890 - 6 NAD83 COORDI	
					250 - 16 LAMBERT COOR	
	AS BUILTS				DRAWING NO.	G02
	CONTRACTOR		DATE STARTED DATE COMPLETED		101210-2-D	002

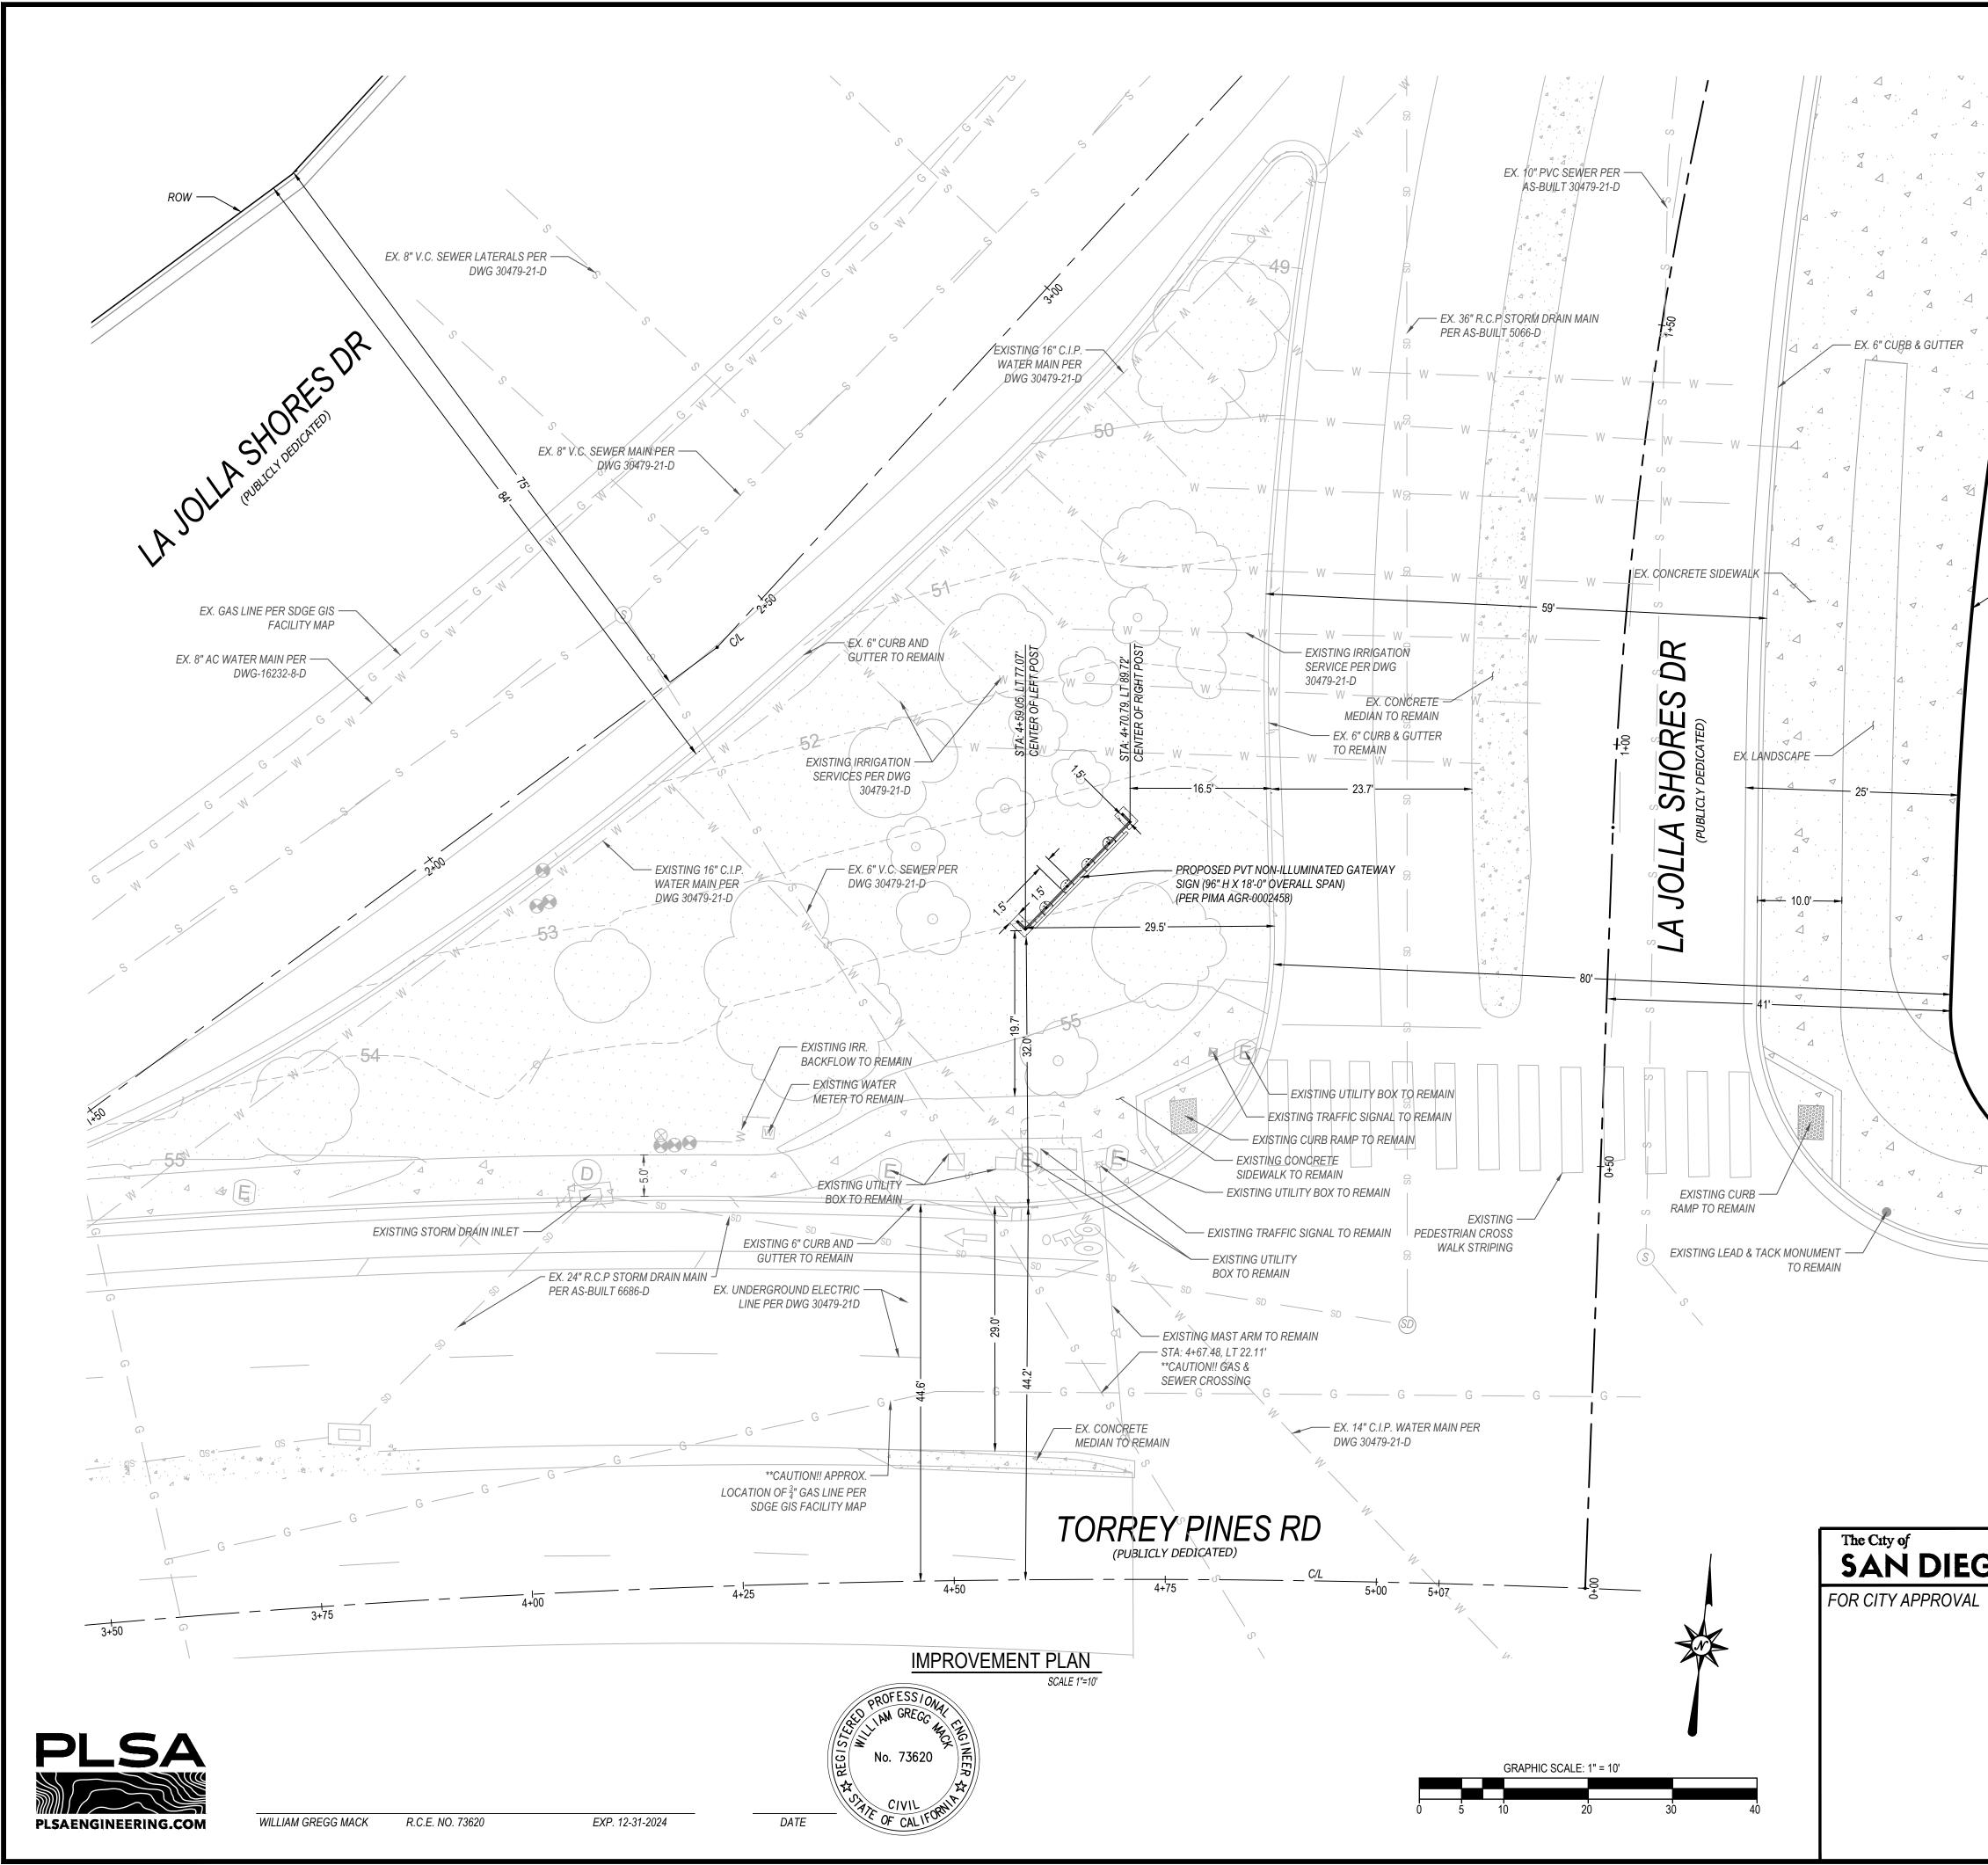

SIGN SCHEDULE								
GROUND	ID	DESCRIPTION/ SIGN COPY	QTY	WIDTH	LENGTH	AREA	illum: Y/N	
SIGNS	A	"WELCOME TO LA JOLLA"	1	6.96'	18'	144 SF.	N	

### CONSTRUCTION NOTES

1. ALL EXISTING TREES ARE TO REMAIN

2. ALL WORK MUST BE SATISFACTORY TO THE RESIDENT ENGINEER

3. PROPOSED SIGN STATIONING AND EXISTING UTILITY CROSSINGS BASED ON

TORREY PINES RD ALIGNMENT AND IS UNIQUE TO THIS PLAN. 4. TORREY PINES ROAD STATIONING STARTS AT THE CENTERLINE INTERSECTION OF TORREY PINES RD AND LA JOLLA SHORES DR.

5. THE APPLICANT SHALL DEMONSTRATE TO THE SATISFACTION OF THE CITY ENGINEER THAT THE PROPOSED COMMUNITY ENTRY SIGN WOULD NOT IMPEDE SIGHT DISTANCE FOR DRIVERS OR PEDESTRIANS.



WARNING

0 1/4 1/2 1

IF THIS BAR DOES

NOT MEASURE 1"

THEN DRAWING IS

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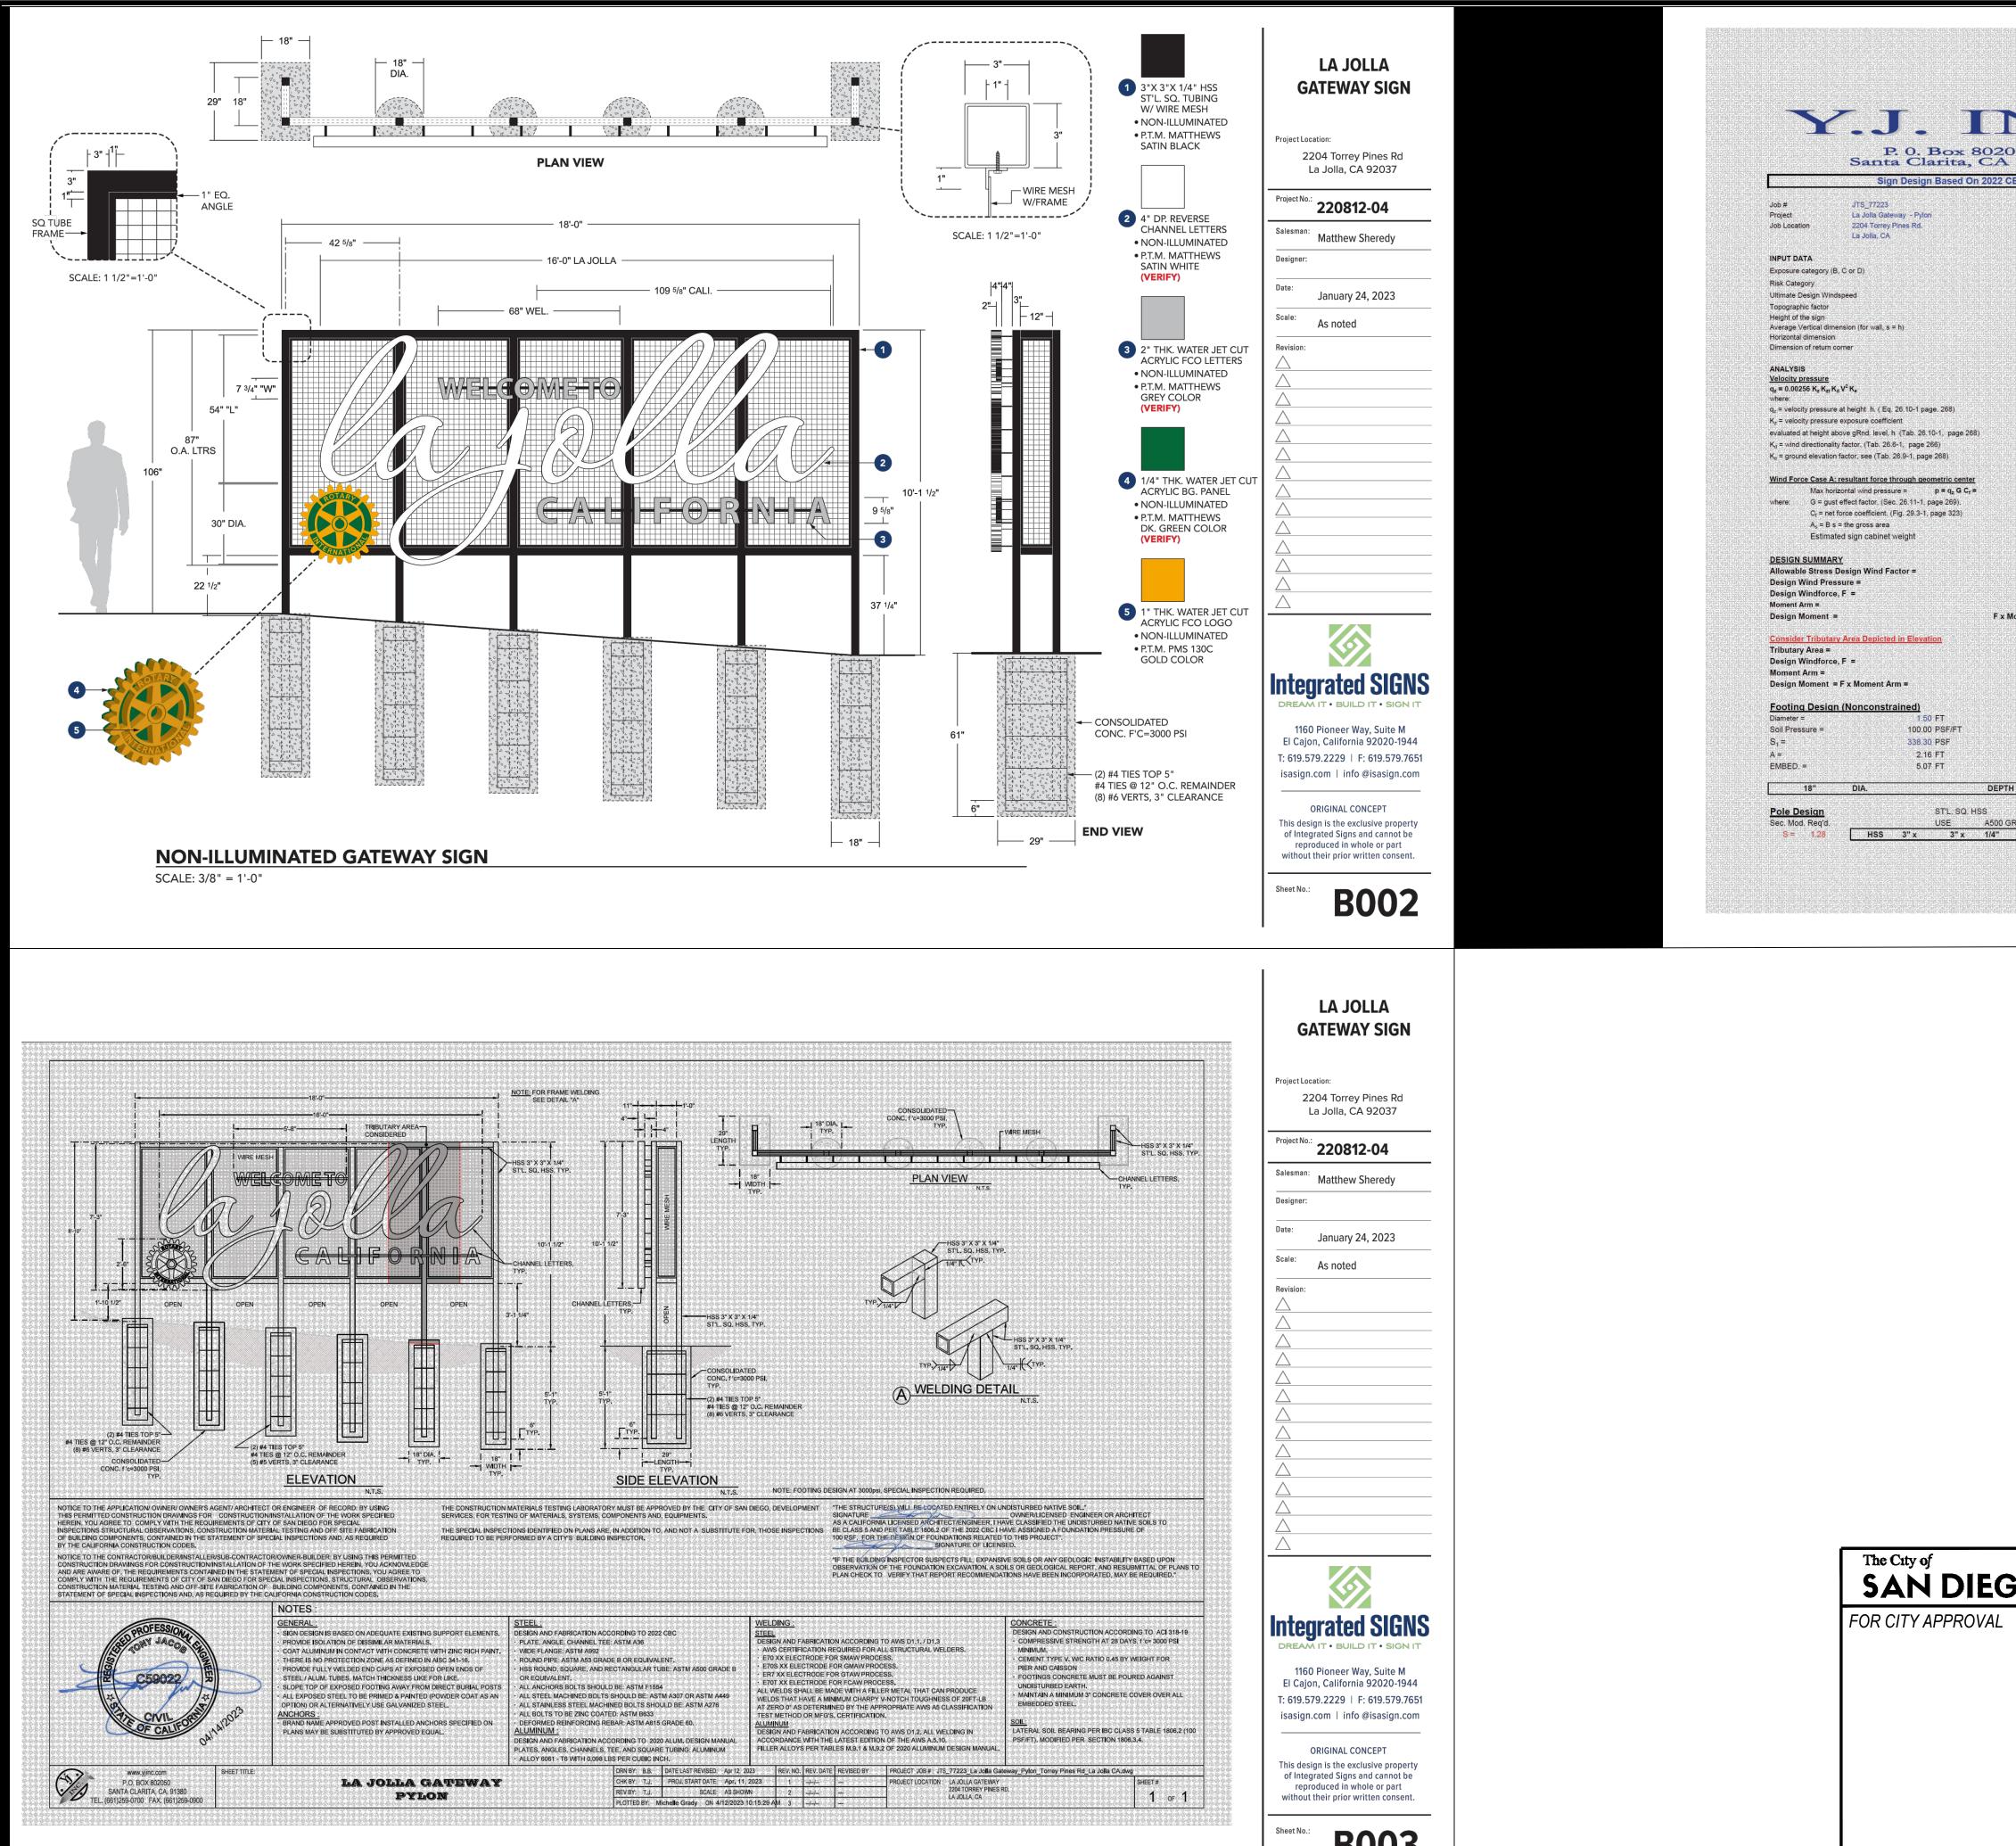
ROW

IMPROVEMENT PLAN FOR:

## LA JOLLA COMMUNITY ENTRY SIGN

INTERSECTION OF TORREY PINES RD AND LA JOLLA SHORES DR


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DEVE	ELOPMENT SE SHEET 3 OF	RVICES DEPARTMEN	Т	PMT NO. 3259124	1
APPROVED: FOR CITY ENG	INEER	DATE		PRJ NO1107292	2
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				1890 - 6 NAD83 COORDI	
				250 - 16	91
				LAMBERT COOR	DINATES
AS BUILTS				DRAWING NO.	C01
CONTRACTOR		DATE STARTED		101210-3-D	
INSPECTOR		DATE COMPLETED			



GA	LA JOLLA ATEWAY SIGN
	<sup>ation:</sup> 104 Torrey Pines Rd a Jolla, CA 92037
Project No.:	220812-04
Salesman:	Matthew Sheredy
Designer:	
Date:	January 24, 2023
Scale:	As noted
1160 El Cajo T: 619.57 isasign.	Pioneer Way, Suite M n, California 92020-1944 '9.2229   F: 619.579.7651 com   info@isasign.com
repro	rated Signs and cannot be oduced in whole or part their prior written consent.

APPROVED:     DATE     PRJ NO     1107292       DESCRIPTION     BY     APPROVED     DATE       ORIGINAL     PLSA     1890 - 6251	WARNING       SIGN DETAILS FOR:         U       LA JOLLA COMMUNITY ENTRY SIGN         IF THIS BAR DOES       INTERSECTION OF TORREY PINES RD AND LA JOLLA SHORES DR         INTERSECTION OF TORREY PINES RD AND LA JOLLA SHORES DR         DEVELOPMENT SERVICES DEPARTMENT         SHEET 4 OF 5 SHEETS         DESCRIPTION         BY         APPROVED         DESCRIPTION         BY         APPROVED         DATE	<b>S C</b> <b>S</b> <b>S</b> <b>S</b> <b>S</b> <b>S</b> <b>S</b> <b>S</b> <b>S</b>	DATE 41				La Jolla   Project Location:   204 Torrey Pines Rd   La Jolla, CA 92037   Project No:   208812-04   Salesman:   Matthew Sheredy   Designer:   Date:   January 24, 2023   Scale:   As noted   Revision:   A   B   California 92020-1944   Calor, California 92020-1944   Recolationa
NOT MEASURE 1" THEN DRAWING IS NOT TO SCALE.       INTERSECTION OF TORREY PINES RD AND LA JOLLA SHORES DR         DEVELOPMENT SERVICES DEPARTMENT SHEET 4 OF 5 SHEETS       PMT NO. 3259124         APPROVED       PMT NO. 1107292         DESCRIPTION       BY       APPROVED       DATE         DESCRIPTION       BY       APPROVED       DATE         ORIGINAL       PLSA       DATE       1890 - 6251	NOT MEASURE 1" THEN DRAWING IS NOT TO SCALE.       INTERSECTION OF TORREY PINES RD AND LA JOLLA SHORES DR         DEVELOPMENT SERVICES DEPARTMENT SHEET 4 OF 5 SHEETS       PMT NO. 3259124         APPROVED:       PMT NO. 1107292         FOR CITY ENGINEER       DATE       PRJ NO 1107292         DESCRIPTION       BY       APPROVED       DATE         ORIGINAL       PLSA       1890 - 6251		WARNING	SIGN	COMMUNI	TYEN	ITRY SIGN
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FOR CITY ENGINEER     DATE       DESCRIPTION     BY       APPROVED     DATE       ORIGINAL     PLSA       1890 - 6251	FOR CITY ENGINEER     DATE       DESCRIPTION     BY       APPROVED     DATE       ORIGINAL     PLSA       1890 - 6251						4407000
ORIGINAL PLSA 1890 - 6251	ORIGINAL PLSA				DATE	DATF	PRJ NO 110/292
	NAD83 COORDINATES						

				250 - 16 LAMBERT COOR	
					DINATES
AS BUILTS				DRAWING NO.	C02
CONTRACTOR		DATE STARTED	 	101210-4-D	

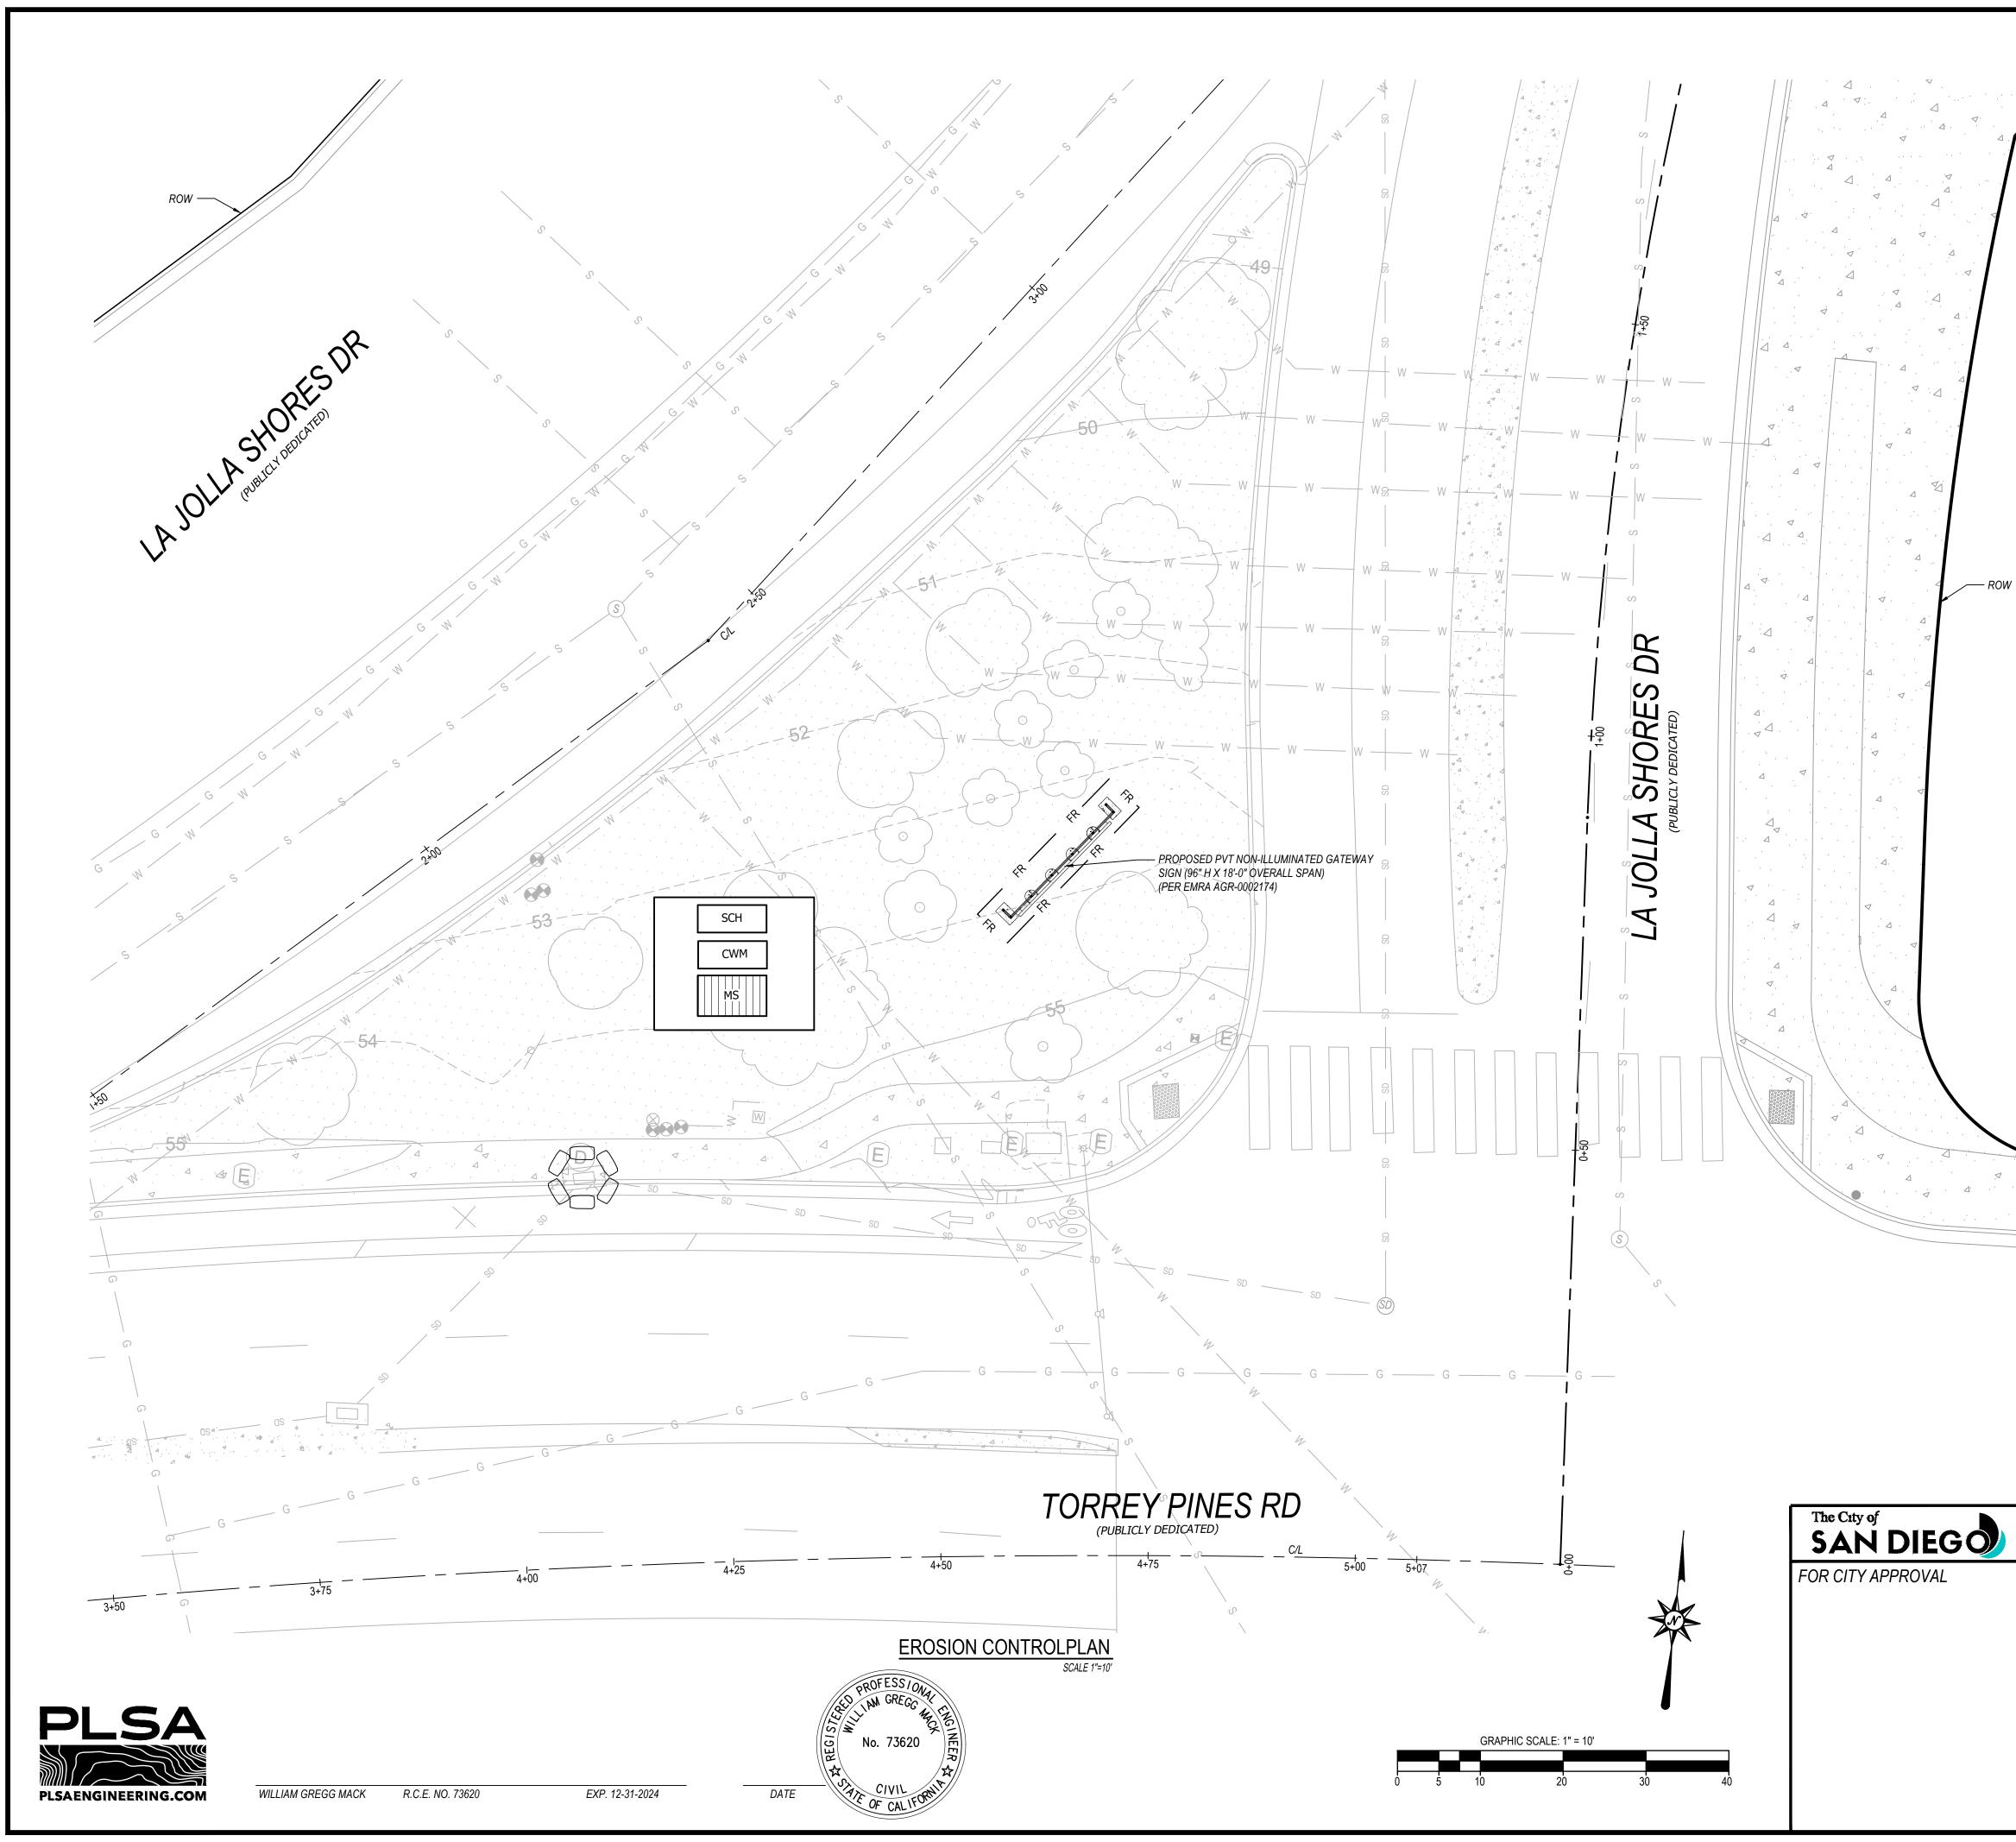

### LEGEND

SCHEDULING PER EC-1


FIBER ROLLS PER SE-5

STORM DRAIN INLET PROTECTION PER SE-10

STABILIZED CONSTRUCTION ENTRANCE PER TC-1

MATERIAL DELIVERY AND STORAGE PER WM-1


CONCRETE WASTE MANAGEMENT PER WM-8

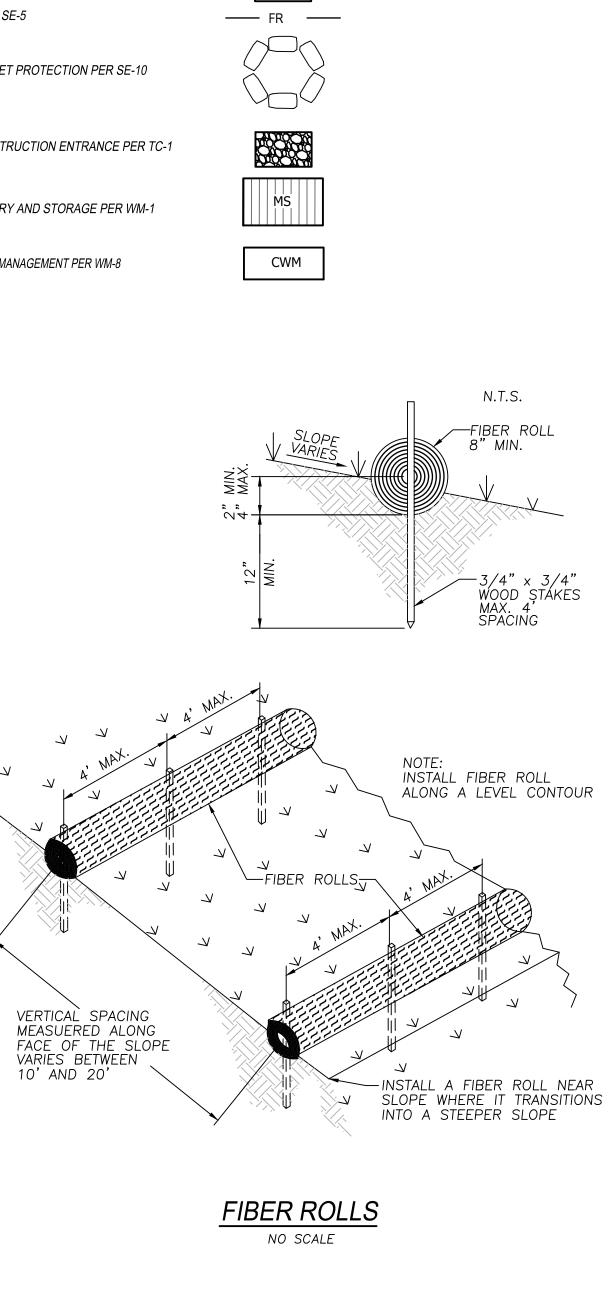

SCH

	PRIVATE CONTRACT						
	WARNING 0 1/4 1/2 1 IF THIS BAR DOES NOT MEASURE 1" THEN DRAWING IS NOT TO SCALE.	EF	EROSION CONTROL PLAN FOR: LA JOLLA COMMUNITY ENTRY SIGN INTERSECTION OF TORREY PINES RD AND LA JOLLA SHORES				
<b>SO</b>	DE	PMT NO. 3259124	:				
	APPROVED: FOR CITY		PRJ NO1107292				
	DESCRIPTION ORIGINAL	<sup>BY</sup> PLSA	APPROVED	DATE	1890 - 6 NAD83 COORDI	-	
					250 - 16 LAMBERT COOR		
	AS BUILTS				DRAWING NO.	C03	
	CONTRACTOR		DATE STARTED DATE COMPLETED		101210-5-D	000	

# **CONSTRUCTION SIGNS:**

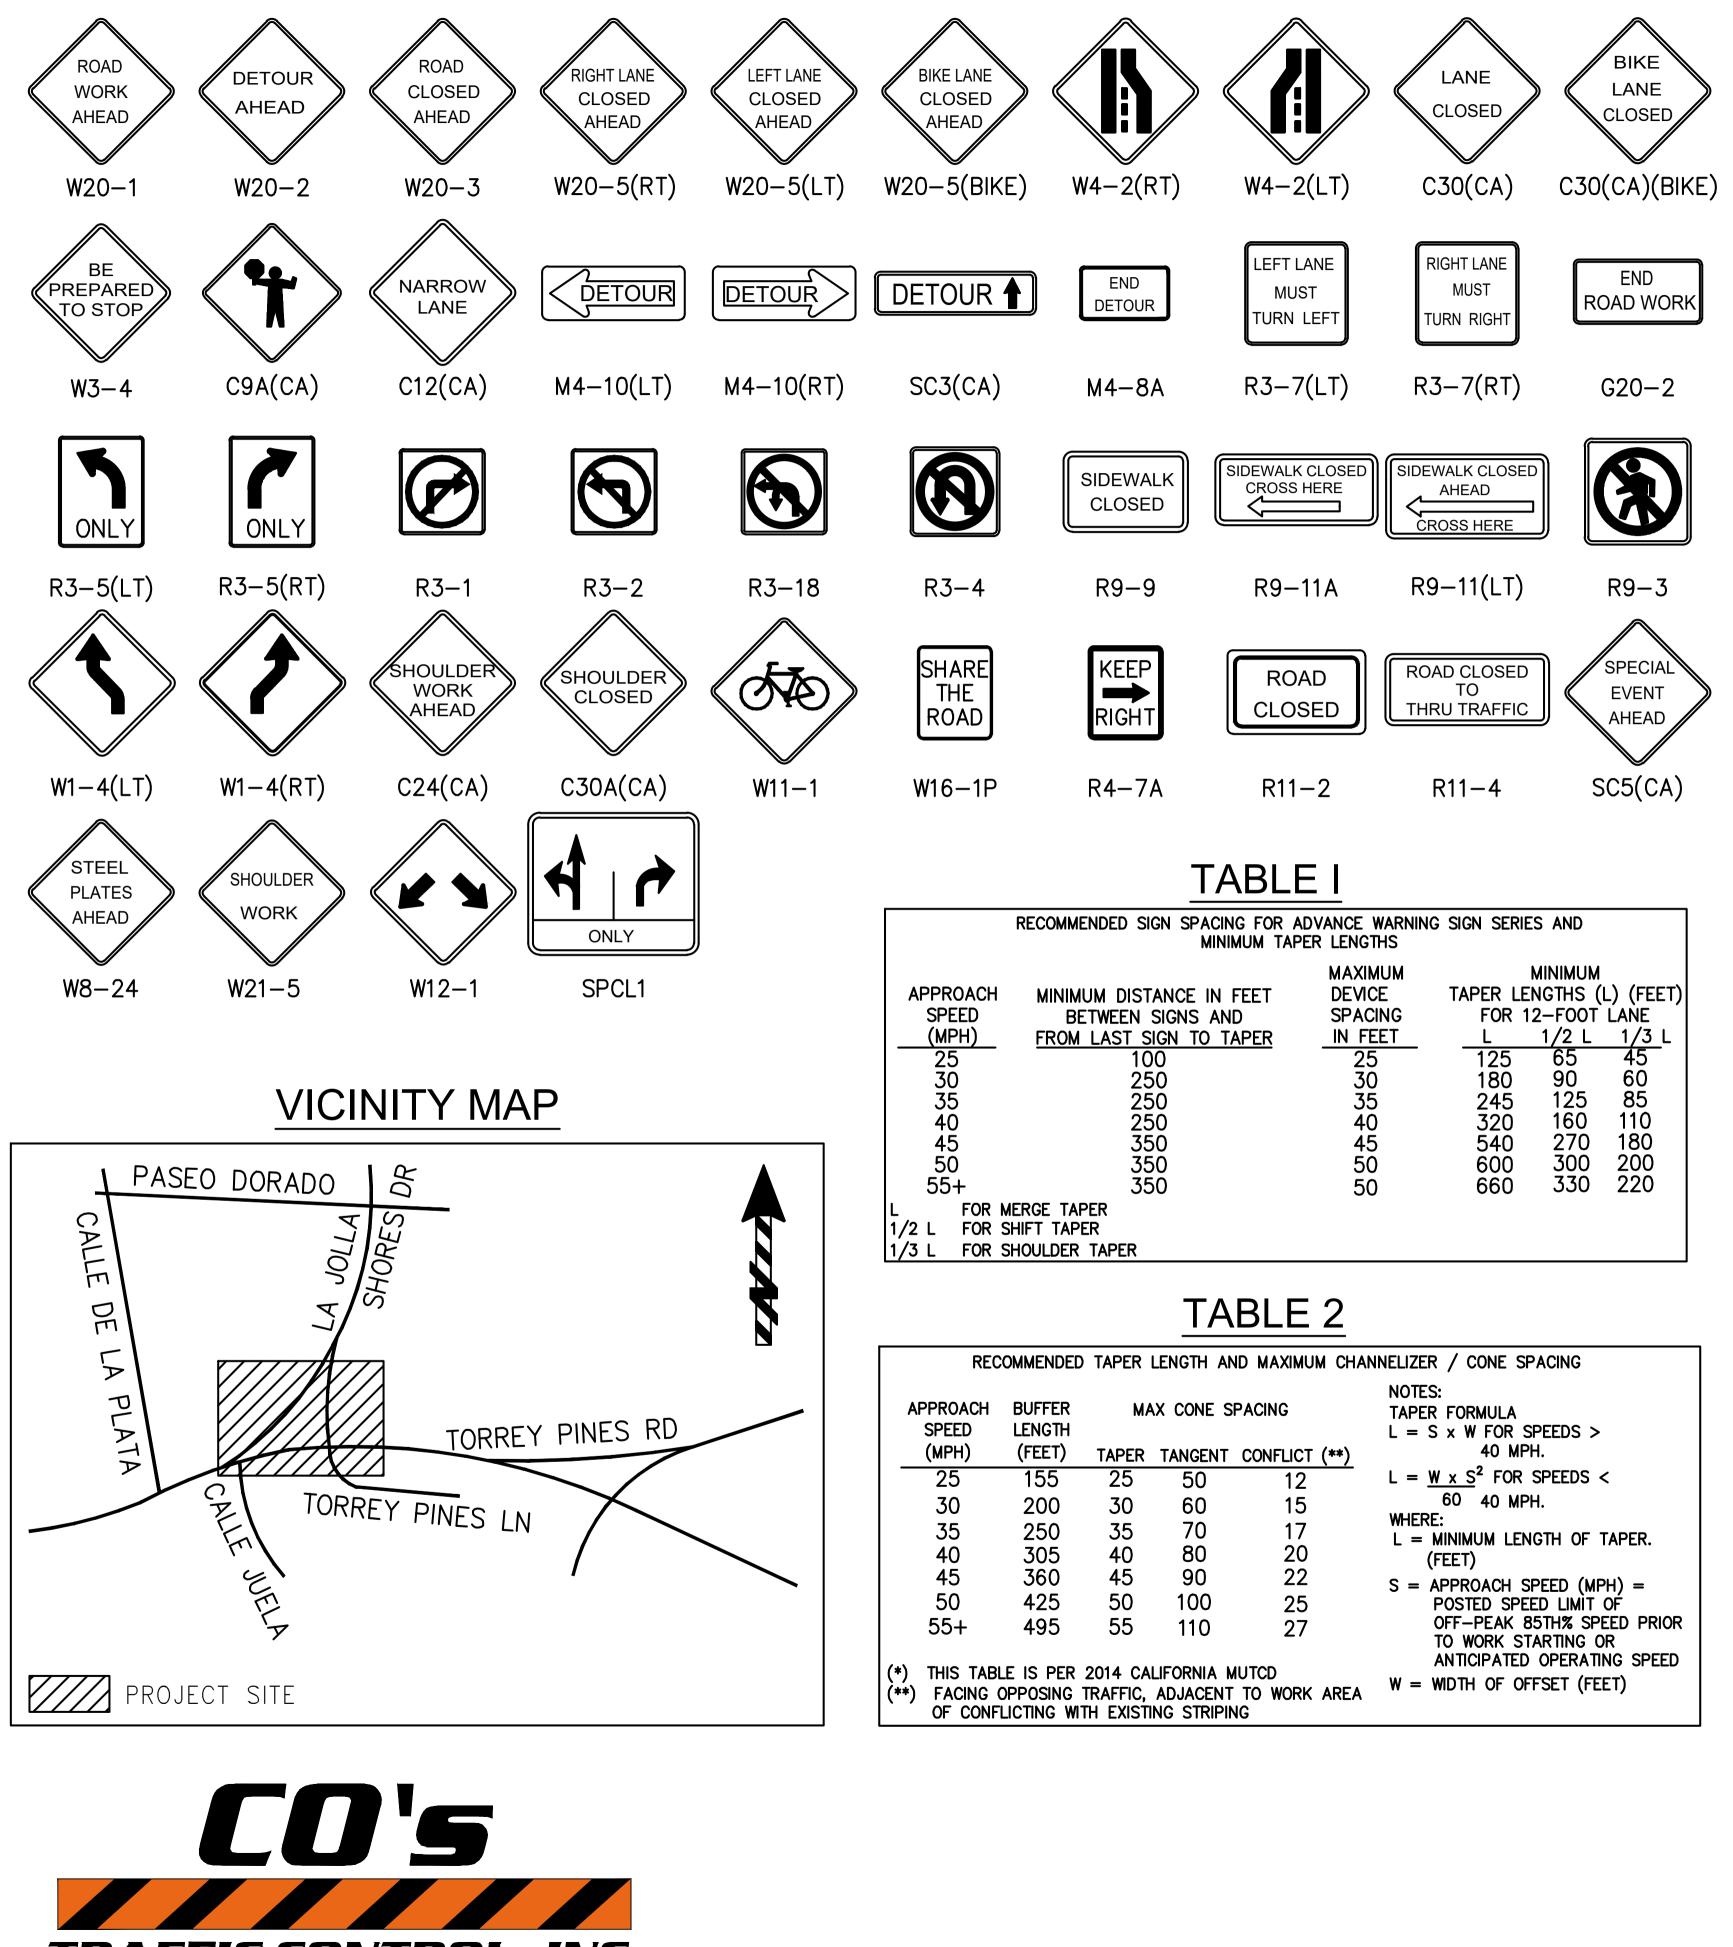



# CITY OF SAN DIEGO TRAFFIC CONTROL NOTES:

SIGN SPACING FOR A MINIMUM TAPI		SIGN SERIE	ES AND	
STANCE IN FEET N SIGNS AND SIGN TO TAPER 100 250 250 250 350 350 350	MAXIMUM DEVICE SPACING IN FEET 25 30 35 40 45 50 50	TAPER LE FOR 1 	MINIMUM NGTHS ( 2-FOOT 1/2 L 65 90 125 160 270 300 330	· · ·

ER	LENGTH AN	ID MAXIMUM CHA	NNELIZER / CONE SPACING
MA	X CONE S	PACING	NOTES: TAPER FORMULA L = S $\times$ W FOR SPEEDS >
ER	TANGENT	CONFLICT (**)	40 MPH.
5	50	12	$L = W \times S^2$ FOR SPEEDS <
)	60	15	60 40 MPH.
5	70	17	WHERE: $L = MINIMUM LENGTH OF TAPER.$
)	80	20	(FEET)
5	90	22	S = APPROACH SPEED (MPH) =
)	100	25	Posted speed limit of
5	110	27	OFF-PEAK 85TH% SPEED PRIOR TO WORK STARTING OR ANTICIPATED OPERATING SPEED
	LIFORNIA M		W - WIDTH OF OFFSET (FEET)
	ADJACENT NG STRIPIN	TO WORK AREA IG	W - WIDTH OF OFFSET (FEET)

- SUPPLEMENT AMENDMENTS AND CITY OF SAN DIEGO SUPPLEMENT AMENDMENTS
- BE SUBMITTED WITH THIS APPLICATION.
- WARRANT.
- TIMES.
- THE POLICE DEPARTMENT.
- 8. CONES AND DELINEATORS SHALL HAVE REFLECTORIZED SLEEVES FOR NIGHT WORK

- 12. EXTENSION MUST BE SUBMITTED AT LEAST TWO WORKING DAYS IN ADVANCE OF PERMIT EXPIRATION.
- OF SUCH WALKWAY.
- EXISTING STRIPING, SIGNING, SIDEWALKS AND BIKE LANES
- 16. THE CONTRACTOR SHALL NOTIFY ALL AFFECTED AGENCIES FIVE WORKING DAYS PRIOR TO STARTING WORK

POLICE DEPARTMENT DISPATCH (619) 531-2000 FIRE DEPARTMENT DISPATCH (858) 573-1300 FIRE BATTALION CHIEF (619) 550-9396 (858) 694-7000 **ENVIRONMENTAL SERVICES** METROPOLITAN TRANSIT SYSTEM (MTS) (BUS STOPS) (619) 238-0100 EXT. 6451 METROPOLITAN TRANSIT SYSTEM (MTS) (TAXI) (619) 595-3086 (619) 557-4520 METROPOLITAN TRANSIT SYSTEM (MTS) (TROLLEY LINES) METROPOLITAN TRANSIT SYSTEM (MTS) (EMERGENCY) (619) 595-4960 FIELD SERVICES DIVISION - TRAFFIC SIGNALS (858) 495-4742 SIGNALS UNDERGROUND SERVICE ALERT (800) 422-4133 **INSPECTION/ CITY RESIDENT ENGINEER** (858) 627-3200

### LEGEND:

- FLASHING BEACON → DIRECTION OF TRAVEL • CONE/DELINEATOR H BARRICADE FLAGGER
- SIGN

- HHH RAILROAD TRACKS
- FLASHING ARROW SIGN
- CMS CHANGEABLE N
- WORK AREA
- (TS) TRAFFIC SIGNAL



1. TRAFFIC CONTROL PLAN SHALL CONFORM TO THE LATEST EDITION OF CITY OF SAN DIEGO STANDARD DRAWINGS, APPENDIX A; THE MANUAL ON UNIFORM TRAFFIC CONTROL DEVICES (MUTCD) AND THE CALIFORNIA SUPPLEMENT AND STANDARD SPECIFICATIONS FOR PUBLIC WORKS CONSTRUCTION, INCLUDING REGIONAL

2. ALL TRAFFIC CONTROL WORKERS ARE REQUIRED TO BE TRAINED, BY A SUPERVISOR, CERTIFIED BY THE AMERICAN TRAFFIC SAFETY SERVICES ASSOCIATION (ATSSA), OR EQUIVALENT, AS REQUIRED BY SECTIONS 6D.03 AND 6E.01 OF THE MUTCD. THE NAME AND CONTACT INFORMATION OF ALL TRAFFIC CONTROL SUBCONTRACTORS SHALL

3. THE CONTRACTOR IS RESPONSIBLE FOR RESTORING THE ROAD BACK TO SATISFACTORY CONDITION INCLUDING. BUT NOT LIMITED TO PAVING. STRIPING. MARKINGS AND TRAFFIC SIGNAL LOOP DETECTORS WITHIN FIVE CALENDAR DAYS OF COMPLETION OF WORK AT THE AFFECTED INTERSECTION OR ROAD SEGMENT

4. THE CITY TRAFFIC ENGINEER RESERVES THE RIGHT TO OBSERVE THESE TRAFFIC CONTROL PLANS IN OPERATION AND TO MAKE ANY CHANGES AS FIELD CONDITIONS

5. TRENCHES SHALL BE BACKFILLED OR STEEL-PLATED DURING NON-WORKING HOURS. STEEL PLATES SHALL HAVE ASPHALTIC CONCRETE BERM ON ALL EDGES. ALL DIRT, DUST AND DEBRIS SHALL BE REMOVED FROM THE STREET AT END OF EACH DAY AND AT THE END OF THE JOB. THE STREET SHALL BE IN DRIVABLE CONDITION AT ALL

6. ANY WORK THAT CREATES AN UNDUE SAFETY RISK OR CREATES SEVERE CONGESTION MAY BE SHUT DOWN BY CITY TRAFFIC ENGINEERS, CITY FIELD INSPECTION OR

7. ALL TRAVEL LANES SHALL BE A MINIMUM OF 12 FEET WIDE AND 14 FEET ADJACENT TO BIKE LANES UNLESS OTHERWISE APPROVED BY THE CITY TRAFFIC ENGINEER

9. IF PARKING IS ALLOWED IN ADVANCE WARNING AREA, ADVANCE WARNING SIGNS SHALL BE MOUNTED ON HIGH-LEVEL DEVICES.

10. THE CONTRACTOR SHALL POST TOW-AWAY/NO PARKING SIGNS 72 HOURS IN ADVANCE AND SHALL TAG THE METERS (WHERE APPLICABLE).


11. TRAFFIC CONTROL PLANS MUST BE SUBMITTED IN PERSON A MINIMUM OF FIVE WORKING DAYS PRIOR TO THE START OF WORK WITHIN THE PUBLIC RIGHT-OF-WAY.

13. WORKDAYS ARE MONDAY THROUGH FRIDAY. NO WORK ON SATURDAYS, SUNDAYS OR HOLIDAYS UNLESS APPROVED AND NOTED IN "COMMENTS."

14. CONTRACTOR SHALL CONTACT CITY RESIDENT ENGINEER AT (858) 627-3200 FOR INSPECTION OF ANY COVERED PEDESTRIAN WALKWAY DURING THE CONSTRUMACTION

15. APPLICANT IS RESPONSIBLE FOR A FULL AND COMPLETE REPRESENTATION OF THE ACTUAL ROAD CONDITIONS SHOWN ON THIS PLAN INCLUDING, BUT NOT LIMITED TO

IESSAGE SIGN	WARNING 0 1/4 1/2 1 IF THIS BAR DOES NOT MEASURE 1" THEN DRAWING IS NOT TO SCALE.		TRAFFIC CONTROL PLAN FOR: LA JOLLA COMMUNITY ENTRY SIGN INTERSECTION OF TORREY PINES RD AND LA JOLLA SHORES DR						
EGO	DEV	PMT NO. <u>325912</u> 4	L						
AL	approved:	ENGINEER	DATE		PRJ NO	2			
	DESCRIPTION	BY	APPROVED	DATE					
	ORIGINAL	СО		1/18/24	1890 — 6:	251			
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					250 – 16 LAMBERT COOR				
	AS BUILTS				DRAWING NO.	TOOA			
	CONTRACTOR		DATE STARTED		101210-TC01-D	1001			
	INSPECTOR		DATE COMPLETED		101210 1001 D				

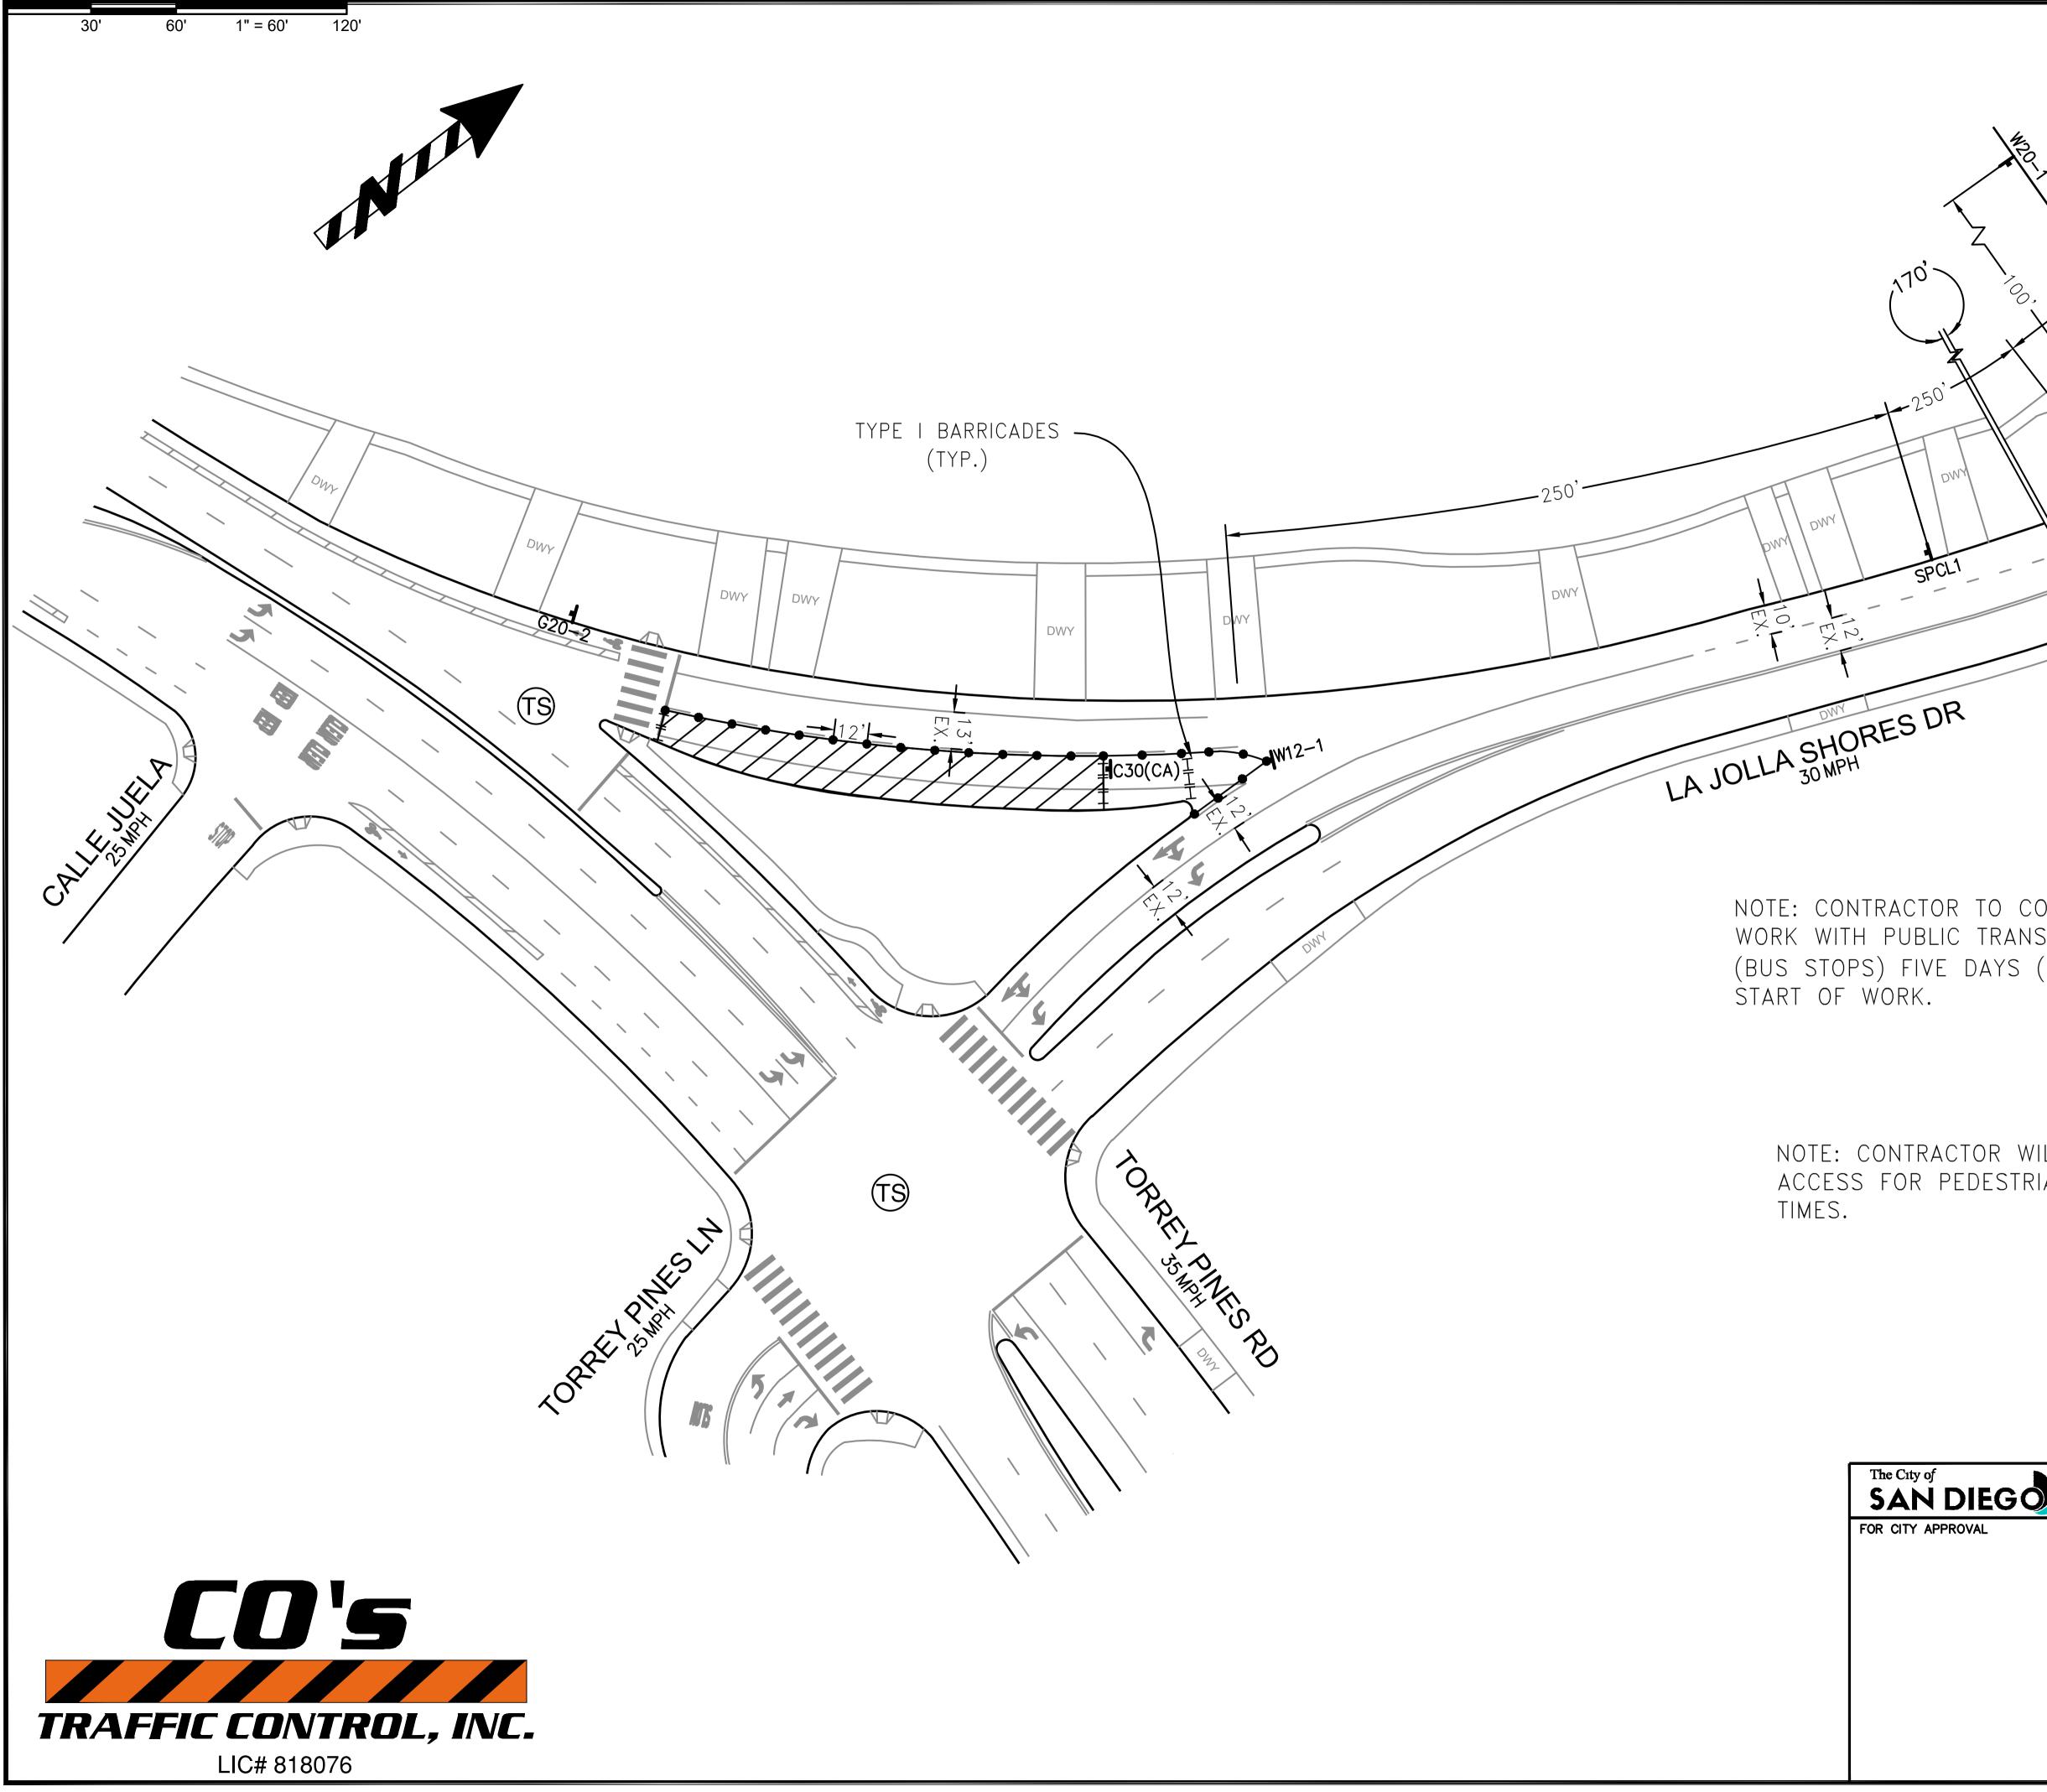

		-250 - CO - 541		G20-1 G2C		
TO COORDINA TRANSPORTAT DAYS (5) PRIC	ION	AC	TE: CONTRACTOR TO PE CESS TO ALL DRIVEWAN _ TIMES			
		ALI	TE: CONTRACTOR TO N L AFFECTED BUSINESSE START OF WORK.			
OR WILL PROVIDE DESTRIANS AT ALL			TE: CONTRACTOR TO NO _ AFFECTED RESIDENTS START OF WORK.			
	WARNING 0 1/4 1/2 1	7	RAFFIC CONTROL PLAN FOR:			
	IF THIS BAR DOES		LA JOLLA COMMUN	IITY E	NTRY SIGN	l
	NOT MEASURE 1" THEN DRAWING IS NOT TO SCALE.		INTERSECTION OF TORREY PINES RE	) AND L	A JOLLA SHORE	S DR
		/ELC	PMENT SERVICES DEPARTMENT SHEET TCO2 OF TCO2 SHEETS		PMT NO. <u>3259124</u>	
/AL	FOR CITY				PRJ NO	
	ORIGINAL	BY CO	APPROVED	DATE 1/18/24	1890 – 6: NAD83 COORDI	
					250 – 16 LAMBERT COOR	
	AS BUILTS		DATE STARTED		DRAWING NO.	TC02
	INSPECTOR				101210-TC02-D	





Project location: La Jolla Gateway sign 2204 Torrey Pines Rd La Jolla, CA Job #: 220812-04


**GATEWAY ENTRY** SCALE: 3/8"=1'-0"



RENDERING



PHOTO SHOWING SLOPE

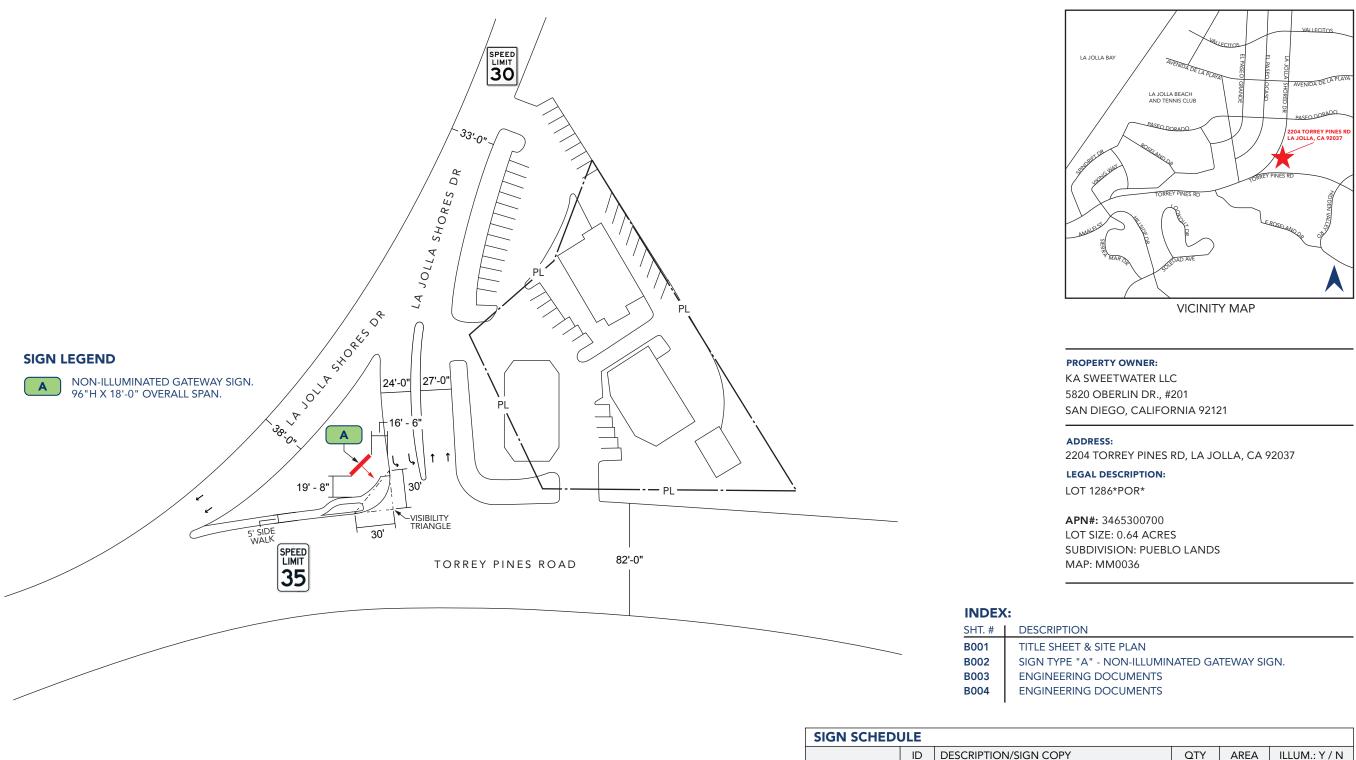

QTY AREA ILLUM.: Y / N 144.0 SF 1 Ν



Project Location:

2204 Torrey Pines Rd La Jolla, CA 92037

#### 220812-04

Salesman: Matthew Sheredy

Designer:

Project No.:

Date: January 24, 2023

1" = 1'-0"

Revision:

Scale:

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1160 Pioneer Way, Suite M El Cajon, California 92020-1944 T: 619.579.2229 | F: 619.579.7651 isasign.com | info@isasign.com

#### ORIGINAL CONCEPT

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Sheet No.:







"A"

GROUND SIGN

NON-ILLUMINATED GATEWAY SIGN

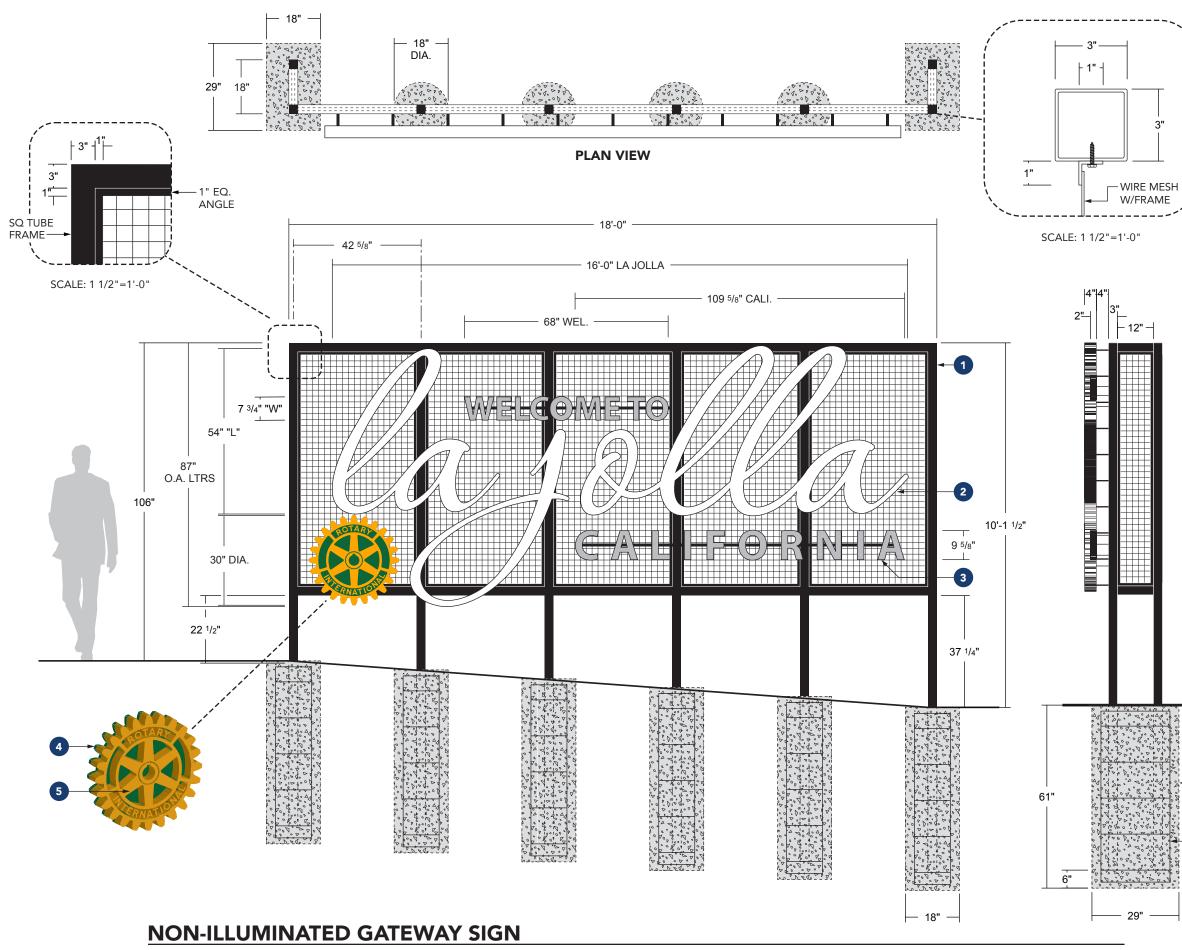

SCALE: 3/8" = 1'-0"

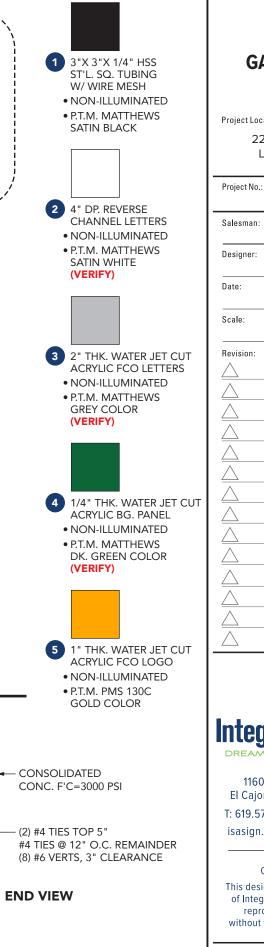

### LA JOLLA **GATEWAY SIGN**

Project Location:

2204 Torrey Pines Rd La Jolla, CA 92037

#### 220812-04

Salesman: Matthew Sheredy

Designer:

Date: January 24, 2023

As noted

Revision:

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**Integrated SIGNS** DREAM IT . BUILD IT . SIGN IT 1160 Pioneer Way, Suite M El Cajon, California 92020-1944


T: 619.579.2229 | F: 619.579.7651 isasign.com | info@isasign.com

#### **ORIGINAL CONCEPT**

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Sheet No.:



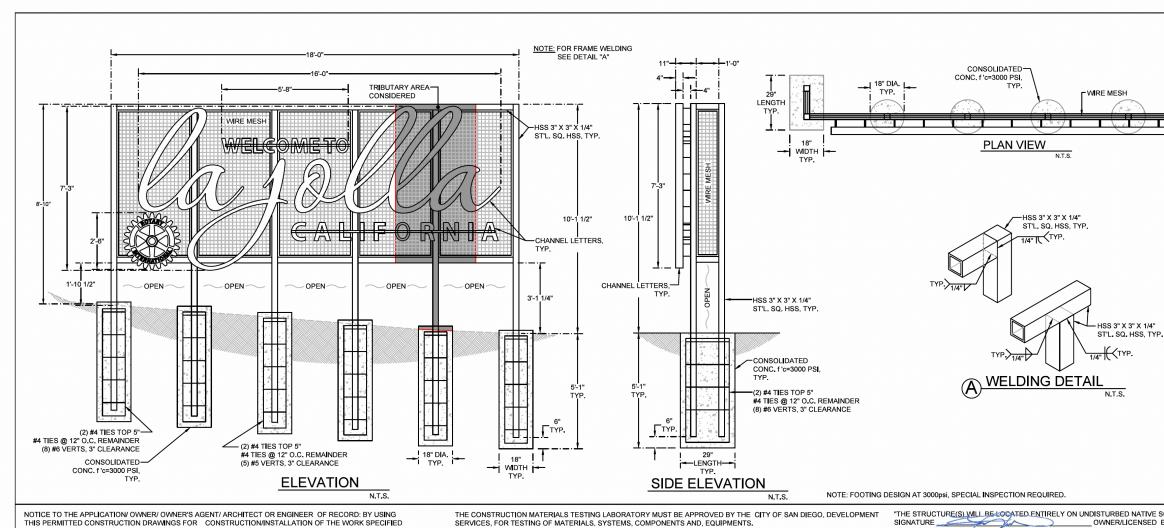

THIS PERMITTED CONSTRUCTION DRAWINGS FOR CONSTRUCTION/INSTALLATION OF THE WORK SPECIFIED HEREIN, YOU AGREE TO COMPLY WITH THE REQUIREMENTS OF CITY OF SAN DIEGO FOR SPECIAL INSPECTIONS STRUCTURAL OBSERVATIONS, CONSTRUCTION MATERIAL TESTING AND OFF SITE FABRICATION OF BUILDING COMPONENTS, CONTAINED IN THE STATEMENT OF SPECIAL INSPECTIONS AND, AS REQUIRED BY THE CALIFORNIA CONSTRUCTION CODES.

NOTICE TO THE CONTRACTOR/BUILDER/INSTALLER/SUB-CONTRACTOR/OWNER-BUILDER: BY USING THIS PERMITTED CONSTRUCTION DRAWINGS FOR CONSTRUCTION/INSTALLATION OF THE WORK SPECIFIED HEREIN, YOU ACKNOWLEDGE AND ARE AWARE OF, THE REQUIREMENTS CONTAINED IN THE STATEMENT OF SPECIAL INSPECTIONS, YOU AGREE TO COMPLY WITH THE REQUIREMENTS OF CITY OF SAN DIEGO FOR SPECIAL INSPECTIONS, STRUCTURAL OBSERVATIONS, CONSTRUCTION MATERIAL TESTING AND OFF-SITE FABRICATION OF BUILDING COMPONENTS, CONTAINED IN THE STATEMENT OF SPECIAL INSPECTIONS AND, AS REQUIRED BY THE CALIFORNIA CONSTRUCTION CODES.

SERVICES, FOR TESTING OF MATERIALS, SYSTEMS, COMPONENTS AND, EQUIPMENTS.

REQUIRED TO BE PERFORMED BY A CITY'S BUILDING INSPECTOR.

SERVICES, FOR TESTING OF MATERIALS, SYSTEMS, COMPONENTS AND, EQUIPMENTS. THE SPECIAL INSPECTIONS IDENTIFIED ON PLANS ARE, IN ADDITION TO, AND NOT A SUBSTITUTE FOR, THOSE INSPECTIONS DECLASS 5 AND PER TABLE 1806.2 OF THE 2022 CBC I HAVE ASSIGNED A FOL DECLASS 5 AND PER TABLE 1806.2 OF THE 2022 CBC I HAVE ASSIGNED A FOL DECLASS 5 AND PER TABLE 1806.2 OF THE 2022 CBC I HAVE ASSIGNED A FOL DECLASS 5 AND PER TABLE 1806.2 OF THE 2022 CBC I HAVE ASSIGNED A FOL DECLASS 5 AND PER TABLE 1806.2 OF THE 2022 CBC I HAVE ASSIGNED A FOL DECLASS 5 AND PER TABLE 1806.2 OF THE 2022 CBC I HAVE ASSIGNED A FOL DECLASS 5 AND PER TABLE 1806.2 OF THE 2022 CBC I HAVE ASSIGNED A FOL DECLASS 5 AND PER TABLE 1806.2 OF THE 2022 CBC I HAVE ASSIGNED A FOL DECLASS 5 AND PER TABLE 1806.2 OF THE 2022 CBC I HAVE ASSIGNED A FOL DECLASS 5 AND PER TABLE 1806.2 OF THE 2022 CBC I HAVE ASSIGNED A FOL DECLASS 5 AND PER TABLE 1806.2 OF THE 2022 CBC I HAVE ASSIGNED A FOL DECLASS 5 AND PER TABLE 1806.2 OF THE 2022 CBC I HAVE ASSIGNED A FOL DECLASS 5 AND PER TABLE 1806.2 OF THE 2022 CBC I HAVE ASSIGNED A FOL DECLASS 5 AND PER TABLE 1806.2 OF THE 2022 CBC I HAVE ASSIGNED A FOL DECLASS 5 AND PER TABLE 1806.2 OF THE 2022 CBC I HAVE ASSIGNED A FOL DECLASS 5 AND PER TABLE 1806.2 OF THE 2022 CBC I HAVE ASSIGNED A FOL DECLASS 5 AND PER TABLE 1806.2 OF THE 2022 CBC I HAVE ASSIGNED A FOL DECLASS 5 AND PER TABLE 1806.2 OF THE 2022 CBC I HAVE ASSIGNED A FOL DECLASS 5 AND PER TABLE 1806.2 OF THE 2022 CBC I HAVE ASSIGNED A FOL DECLASS 5 AND PER TABLE 1806.2 OF THE 2022 CBC I HAVE ASSIGNED A FOL DECLASS 5 AND PER TABLE 1806.2 OF THE 2022 CBC I HAVE ASSIGNED A FOL DECLASS 5 AND PER TABLE 1806.2 OF THE 2022 CBC I HAVE ASSIGNED A FOL DECLASS 5 AND PER TABLE 1806.2 OF THE 2022 CBC I HAVE ASSIGNED A FOL DECLASS 5 AND PER TABLE 1806.2 OF THE 2022 CBC I HAVE ASSIGNED A FOL DECLASS 5 AND PER TABLE 1806.2 OF THE 2022 CBC I HAVE ASSIGNED A FOL DECLASS 5 AND PER TABLE 1806.2 OF THE 2022 CBC I HAVE ASSIGNED A FOL DECLASS 5 AND PER TABLE 1806.2 OF THE 2022 100 PSF. FOR THE BESIGN OF FOUNDATIONS RELATED TO THIS PROJECT". SIGNATURE OF LICENSED.

> "IF THE BUILDING INSPECTOR SUSPECTS FILL, EXPANSIVE SOILS OR ANY GE OBSERVATION OF THE FOUNDATION EXCAVATION, A SOILS OR GEOLOGICAL PLAN CHECK TO VERIFY THAT REPORT RECOMMENDATIONS HAVE BEEN IN

	NOTES :								
C59022	GENERAL:         • SIGN DESIGN IS BASED ON ADEQUATE EXISTING SUPPORT ELEMENTS.         • PROVIDE ISOLATION OF DISSIMILAR MATERIALS.         • COAT ALUMINUM IN CONTACT WITH CONCRETE WITH ZINC RICH PAINT.         • THERE IS NO PROTECTION ZONE AS DEFINED IN AISC 341-16.         • PROVIDE FULLY WELDED END CAPS AT EXPOSED OPEN ENDS OF STEEL / ALUM. TUBES, MATCH THICKNESS LIKE FOR LIKE.         • SLOPE TOP OF EXPOSED FOOTING AWAY FROM DIRECT BURIAL POSTS         • ALL EXPOSED STEEL TO BE PRIMED & PAINTED (POWDER COAT AS AN OPTION) OR ALTERNATIVELY USE GALVANIZED STEEL.         • ANCHORS :         • BRAND NAME APPROVED POST INSTALLED ANCHORS SPECIFIED ON PLANS MAY BE SUBSTITUTED BY APPROVED EQUAL.	STEEL : DESIGN AND FABRICATION ACC • PLATE, ANGLE, CHANNEL TEE • WIDE FLANGE: ASTM A992 • ROUND PIPE: ASTM A53 GRAD • HSS ROUND, SQUARE, AND RE OR EQUIVALENT. • ALL ANCHORS BOLTS SHOULD • ALL STEEL MACHINED BOLTS • ALL STAILESS STEEL MACHIN • ALL BOLTS TO BE ZINC COATE • DEFORMED REINFORCING RE ALLMINUM : DESIGN AND FABRICATION ACC PLATES, ANGLES, CHANNELS, T • ALLOY 6061 - T6 WITH 0.098 LE	ASTM A36 E B OR EQUIVAL ECTANGULAR TU D BE: ASTM F155 SHOULD BE: AST MED BQLTS SHO ED: ASTM B633 BAR: ASTM A615 ORDING TO 202 EE, AND SQUAR IS PER CUBIC IN	ENT. JBE: ASTM A500 GRADE B 4 IM A307 OR ASTM A449 ULD BE: ASTM A276 GRADE 60. 0 ALUM, DESIGN MANUAL E TUBING: ALUMINUM CH.	AWS CERTI     E70 XX ELE     E70 XX ELE     E70 XX EL     ER7 XX ELE     EX70 XX EL     ALL WELDS S     WELDS THAT     AT ZERO 0* A     TEST METHO     ALUMINUM     DESIGN AND     ACCORDANC     FILLER ALLOY	FICATION F CTRODE F ECTRODE CTRODE ECTRODE HALL BE M HAVE A MI S DETERM D OR MFG' FABRICATI E WITH TH (S PER TAI	REQUIRED FOR AL OR SMAW PROCE FOR GMAW PROCE FOR GTAW PROCE FOR FCAW PROCE FOR FCAW PROCE INIMUM CHARPY V INNED BY THE APP 'S, CERTIFICATION ION ACCORDING 1 ION ACCORDING 1 E LATEST EDITION BLES M.9.1 & M.9.2	ESS. SS. SS. ER METAL THAT CAN PRODUCE -NOTCH TOUGHNESS OF 20FT-LB ROPRIATE AWS A5 CLASSIFICATION	CONCRETE : DESIGN AND CONSTR • COMPRESSIVE STR MINIMUM. • CEMENT TYPE V. W PIER AND CAISSON • FOOTINGS CONCRE UNDISTURBED EAR • MAINTAIN A MINIMU EMBEDDED STEEL. SOIL: LATERAL SOIL BEARIN PSF/FT). MODIFIED PE
www.yjinc.com SHEET TITLE:			DRN BY: B.B.	DATE LAST REVISED: Apr 12, 2	023 REV. NO	D. REV. DAT	E REVISED BY	PROJECT JOB #: JTS_77223_La Jolla Gat	eway_Pylon_Torrey Pines F
P.O. BOX 802050 SANTA CLARITA, CA. 91380 TEL (6611259-070) EAX (6611259-0900	la jolla gateway		CHK BY: T.J.	PROJ. START DATE: Apr. 11,		-/-/-	-	PROJECT LOCATION : LA JOLLA GATEWAY 2204 TORREY PINES F	
SANTA CLARITA, CA. 91380 TEL. (661)259-0700 FAX. (661)259-0900	Pylon		REV BY: T.J.	SCALE: AS SHOW		_/_/_	-	LA JOLLA, CA	χD.
P - IEL. (001)205-0700 FAA. (001)209-0900			PLOTTED BY: M	lichelle Grady ON 4/12/2023	10:15:29 AM 3	_/_/_	-		

CHAN TYP.	—HSS 3" X 3" X 1/4" STL. SQ. HSS, TYP. NNEL LETTERS,
Ρ.	
SOIL." ENGINEER OR ARCHI UNDISTURBED NATIVE	
UNDATION PRESSURE	E OF BASED UPON BMITTAL OF PLANS TO
STRUCTION ACCORDI STRENGTH AT 28 DAYS /. W/C RATIO 0.45 BY V ON CRETE MUST BE POUF ARTH. IMUM 3" CONCRETE C EL.	S, f'c= 3000 PSI NEIGHT FOR RED AGAINST
ARING PER IBC CLASS D PER SECTION 1806.3	
nes Rd_La Jolla CA.dwg	SHEET # 1 OF 1
	_ • - •

LA JOLLA GATEWAY SIGN
Project Location: 2204 Torrey Pines Rd La Jolla, CA 92037
Project No.: <b>220812-04</b>
Salesman: Matthew Sheredy
Designer:
Date: January 24, 2023
Scale: As noted
Revision: $\triangle$
Integrated SIGNS

1160 Pioneer Way, Suite M El Cajon, California 92020-1944 T: 619.579.2229 | F: 619.579.7651 isasign.com | info@isasign.com

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Sheet No.:



Y.J. INC.

P. 0. Box 802050 Santa Clarita, CA 91380

Sign Design Based On 2022 CBC

DATE 4/11/2023

TEL: (661) 259-0700 FAX: (661) 259-0900

Job #								
		JTS_77223						
Project		La Jolla Gateway - Pylon						DROFESS/OL
Job Locatio	on	2204 Torrey Pines Rd.					//5	AN JAR
		La Jolla, CA					[]\$	KON
							C C C C C C C C C C C C C C C C C C C	
INPUT DA	ТА							$ \rightarrow $
Exposure of	category (B, C o	or D)		=	С			C59022
Risk Categ				=	П		-	- In
-	esign Windspe	ed	V <sub>ULT</sub>	=	110	MPH	14	C/VIL OF CALIFOR
Topograph			K <sub>zt</sub>	=	1	Flat	103	
Height of th			ĥ	=	10.13	FT		CIVIL
		on (for wall, s = h)	S	=	7.32	FT		OF CALL
Horizontal			В	=	18.00	FT		
Dimension	of return corne	er	Lr	=	1.17	FT		
ANALYSIS	3							
Velocity p								
q <sub>z</sub> = 0.0025	56 K <sub>z</sub> K <sub>zt</sub> K <sub>d</sub> V <sup>2</sup>	Ke		=	22.38	PSF		
where:								
		neight h. ( Eq. 26.10-1 page. 268)						
-		posure coefficient		=	0.85			
		gRnd. level, h (Tab. 26.10-1, page 268	3)					
		ctor. (Tab. 26.6-1, page 266)		=	0.85			
K <sub>e</sub> = ground	d elevation fact	tor, see (Tab. 26.9-1, page 268)		=	1.00			
Wind Fore	e Case Ar rec	ultant force through geometric center						
		tal wind pressure = $p = q_z G C_f$		=	30	PSF		
where:		ect factor. (Sec. 26.11-1, page 269).		=	0.85	1		
		e coefficient. (Fig. 29.3-1, page 323)			1.59	1		
	A <sub>s</sub> = B s = th			=	131.70	FT <sup>2</sup>		
		sign cabinet weight		-	791	LBS.		
						-		
DESIGN S	SUMMARY					_		
Allowable	e Stress Des	ign Wind Factor =			0.60			
Design W	Vind Pressur	e =		).6 x p =		PSF		
	lindfores F	-	18.12	2 x As =		KIPS		
Design W		-			6.41	FT		
Moment A	vrm =	-				-		
Moment A			F x Momen	t Arm =		KIP-FT		
Moment A Design M	arm = Ioment =		F x Momen	nt Arm =		KIP-FT		
Moment A Design M <u>Consider</u>	rm = Ioment  = <u>Tributary A</u> ı	rea Depicted in Elevation	F x Momen	t Arm =	15.30	-		
Moment A Design M <u>Consider</u> Tributary	arm = Ioment  = r <u>Tributary Ar</u> v Area =	rea Depicted in Elevation			25.81			
Moment A Design M <u>Consider</u> Tributary Design W	arm = Ioment = <u>Tributary Ar</u> Area = Vindforce, F	rea Depicted in Elevation		1t Arm = 2 x As =	25.81 0.47	FT <sup>2</sup> KIPS		
Moment A Design M <u>Consider</u> Tributary Design W Moment A	Arm = Noment = Tributary Ar Area = Vindforce, F Arm =	rea Depicted in Elevation			25.81			
Moment A Design M <u>Consider</u> Tributary Design W Moment <i>I</i> Design M	arm = Noment = Tributary Ar Area = Vindforce, F Arm = Noment = F x	rea Depicted in Elevation = < Moment Arm =			25.81 0.47 6.30	FT <sup>2</sup> KIPS FT		
Moment A Design M <u>Consider</u> Tributary Design W Moment <i>J</i> Design M <u>Footing</u>	urm = <u>Tributary Ar</u> Area = Vindforce, F Arm = Ioment = F x <u>1 Design (N</u>	rea Depicted in Elevation = < Moment Arm = lonconstrained)			25.81 0.47 6.30	FT <sup>2</sup> KIPS FT		
Moment A Design M <u>Consider</u> Tributary Design W Moment <i>I</i> Design M <u>Footing</u> Diameter =	arm = Ioment = y Area = Vindforce, F Arm = Ioment = F x <u>I Design (N</u>	rea Depicted in Elevation = < Moment Arm = <u>Ionconstrained)</u> 1.50 FT			25.81 0.47 6.30	FT <sup>2</sup> KIPS FT		
Moment A Design M <u>Consider</u> Tributary Design W Moment <i>I</i> Design M <u>Footing</u> Diameter = Soil Press	arm = Ioment = y Area = Vindforce, F Arm = Ioment = F x <u>I Design (N</u>	rea Depicted in Elevation = < Moment Arm = <u>lonconstrained)</u> 1.50 FT 100.00 PSF/FT			25.81 0.47 6.30	FT <sup>2</sup> KIPS FT		
Moment A Design M <u>Consider</u> Tributary Design W Moment <i>I</i> Design M <u>Footing</u> Diameter = Soil Press S <sub>1</sub> =	arm = Ioment = y Area = Vindforce, F Arm = Ioment = F x <u>I Design (N</u>	rea Depicted in Elevation = & Moment Arm = <u>lonconstrained)</u> 1.50 FT 100.00 PSF/FT 338.30 PSF			25.81 0.47 6.30	FT <sup>2</sup> KIPS FT		
Moment A Design M <u>Consider</u> Tributary Design W Moment <i>I</i> Design M <u>Footing</u> Diameter = Soil Press S <sub>1</sub> = A =	arm = Tributary Ar Area = Vindforce, F Arm = Toment = F x <u>1 Design (N</u> sure =	rea Depicted in Elevation = & Moment Arm = lonconstrained) 1.50 FT 100.00 PSF/FT 338.30 PSF 2.16 FT			25.81 0.47 6.30	FT <sup>2</sup> KIPS FT		
Moment A Design M <u>Consider</u> Tributary Design W Moment <i>I</i> Design M <u>Footing</u> Diameter = Soil Press S <sub>1</sub> =	arm = Tributary Ar Area = Vindforce, F Arm = Toment = F x <u>1 Design (N</u> sure =	rea Depicted in Elevation = & Moment Arm = <u>lonconstrained)</u> 1.50 FT 100.00 PSF/FT 338.30 PSF			25.81 0.47 6.30	FT <sup>2</sup> KIPS FT		
Moment A Design M Consider Tributary Design W Moment A Design M Footing Diameter = Soil Press $S_1 =$ A = EMBED. =	arm = Ioment = r Tributary Ar r Area = Vindforce, F Arm = Ioment = F x 1 Design (N = sure =	rea Depicted in Elevation = ( Moment Arm = Jonconstrained) 1.50 FT 100.00 PSF/FT 338.30 PSF 2.16 FT 5.07 FT	18.12	2 x As =	25.81 0.47 6.30	FT <sup>2</sup> KIPS FT		
Moment A Design M Consider Tributary Design W Moment A Design M Footing Diameter = Soil Press $S_1 =$ A = EMBED. =	arm = Tributary Ar Area = Vindforce, F Arm = Toment = F x <u>1 Design (N</u> sure =	rea Depicted in Elevation = & Moment Arm = lonconstrained) 1.50 FT 100.00 PSF/FT 338.30 PSF 2.16 FT		2 x As =	25.81 0.47 6.30	FT <sup>2</sup> KIPS FT		
Moment A Design M Consider Tributary Design W Moment A Design M Footing Diameter = Soil Press S <sub>1</sub> = A = EMBED.=	arm = Tributary Ar Area = Vindforce, F Arm = Noment = F x Design (N = sure = 18"	rea Depicted in Elevation = ( Moment Arm = Jonconstrained) 1.50 FT 100.00 PSF/FT 338.30 PSF 2.16 FT 5.07 FT	18.12 DEPTH = 5' -	2 x As =	25.81 0.47 6.30	FT <sup>2</sup> KIPS FT		
Moment A Design M Consider Tributary Design W Moment A Design M Footing Diameter = Soil Press $S_1 =$ A = EMBED.=	arm = Tributary Ar Area = Vindforce, F Arm = Noment = F x Design (N = sure = 18"	rea Depicted in Elevation = ( Moment Arm = lonconstrained) 1.50 FT 100.00 PSF/FT 338.30 PSF 2.16 FT 5.07 FT DIA.	18.12 DEPTH = 5' -	2 x As =	= 15.30 25.81 0.47 6.30 2.95	FT <sup>2</sup> KIPS FT		

### LA JOLLA GATEWAY SIGN

Project Location:

2204 Torrey Pines Rd La Jolla, CA 92037

## Project No.: 220812-04

Salesman: Matthew Sheredy

Designer:

Date: January 24, 2023

As noted

Revision:

Scale:

Integrated SIGNS

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