

## THE CITY OF SAN DIEGO M E M O R A N D U M

DATE: April 4, 2024

TO: Elena Pascual, Associate Planner, Planning Department

FROM: Andy Field, Director, Parks and Recreation Department

SUBJECT: Approval of the General Development Plan for Robb Field Community

**Park** 

On February 21, 2024, the Parks and Recreation Board approved the motion unanimously 8-0-0 to recommend approval of the following item[s]:

1. Robb Field Community Park General Development Plan Amendment

Based on the recommendations from the Parks and Recreation Board and as authorized under Council Policy 600–33, the Parks and Recreation Department hereby approves the above listed General Development Plans.

Andy Field, Director

Parks and Recreation Department

April 30, 2024

Date

AF/jg

Attachments: Robb Field Community Park General Development Plan Amendment

cc: Rania Amen, Director and City Engineer, Engineering and Capital Projects Department
Heidi Vonblum, Planning Director, Planning Department
Tom Tomlinson, Assistant Director, Parks and Recreation Department
Jason Grani, Deputy Director, Engineering & Capital Projects Department
Michelle Abella-Shon, Program Manager, Parks and Recreation Department
Kevin Oliver, Project Officer II, Engineering & Capital Projects Department
Juliana Grotzinger, Associate Civil Engineer, Engineering & Capital Projects Department
Mehdi Rashidpour, Assistant Engineer, Engineering & Capital Projects Department
Shamli Tarbell, Landscape Designer, Parks and Recreation Department



\*Striping at synthetic field shown for graphic purposes only. Field area can accomodate soccer, football, rugby, and lacrosse field sizes. Final multi-use striping to be determined in the future. \*\*Existing Handball Courts to remain until new ones are built.

0 50 100

SCALE: 1" = 100'-0"

SCHMIDT DESIGN GROUP

1310 Rosecrans St., Suite G, San Diego, CA 92106 619.236.1462 LIC. CA 2138 | NV 219 | AZ 34139 SCHMIDTDESIGN.COM

out the park TBD by P&R O&M staff	alled at locations throughout	be insta	lance cameras to b	***Surveil										
Y OF SAN DIEGO PARK AND RECREATION [	CITY O			,	ATA FROM AS-BUILT D	`								
		QUANTITY	ITEM	QUANTITY	ITEM	QUANTITY	ITEM	QUANTITY	ITEM			REFERENCE DOCUMENTS	ACTION	DATE
		20 STDS.	SECURITY LTS.	233, 706 SF	PAVED WALKWAYS	9,675 SF	PLAY AREA	66.76 AC.	TOTAL SITE	ACRES: 66.76	COST \$:	RESO. NO. TRANSF. FROM STATE	SITE ACQUIRED	1945
THE CENEDAL DEVELOPMENT DI		14 STDS.	BALLFIELD LTS.	ANE 12,493 SF	MULTI-USE PATH/BIKE L	13,520 SF	MULTI-PURPOSE CT.	51 AC.	IMPROVED AREA	ACRES: 66.76		ORD. NO. 8628 NS	SITE DEDICATED	04.24.1962
THE GENERAL DEVELOPMENT PI		6 STDS.	PICKLEBALL COURT LTS.	rs 275,008 SF	PARKING IMPROVEMEN	73,200 SF	TENNIS CTS.	21.86 AC.	TURF 2		NAME:	RESO. NO.	GDP CONSULTANT HIRED	03-56
		12 STDS.	MULTI-PURPOSE CT. LTS.	843	PARKING STALLS-STD.	5,181 SF	RESTROOMS	8.3 AC.	SYNTHETIC TURF 8		DATE:	PF&R APPROVAL	P&R BOARD APPROVAL	2-70/1-80
ROBB FIEL		8 EA.	BACKSTOPS	LED 26	PARKING STALLS-DISAB	10,606 SF	REC. BLDG.	2.8 AC.	SHRUB BED 2	DRWG. NO. 3757-D	J.O. NO.	CIP NO.	INITIAL DEVELOPMENT	1957
NODD LILL		12 EA.	TENNIS COURTS	7,242 SF	HANDBALL COURT	3,038 SF	TENNIS BLDG.	1.29 AC.	DIRT INFIELDS	DRWG. NO. 5684-D	J.O. NO.	CIP NO.	RESTROOM	2-58
		12 EA.	PICKLEBALL COURTS	19,922.2 LF	LAWN EDGING	1,000 SF	CONCESSION STAND	8.1 AC.	NON-PROGRAMMED AREA	DRWG. NO. 4825-D	J.O. NO.	CIP NO.	PARKING LOT	2-58
COMMUNITY PARK		1 EA.	BATTING CAGES	16 EA.	BLEACHERS					DRWG. NO. 14712-D	J.O. NO. 64983	CIP NO.	IMPROVEMENT PLANS	5-72
		4 EA.	PICNIC TABLES	URF 40, 780 SF	TRACK AT SYNTHETIC T					DRWG. NO. 14927-D	J.O. NO. 64983	CIP NO.	IMPROVEMENT PLANS	9-72
COMM. PLAN AREA: MISSION PARK	COUNCIL DISTRICT NO. 2	2 EA.	ENCLOSED SOCCER FIELDS	CTS 34,678 SF	PADEL/MULTI-PURPOSE					DRWG. NO. 15640-D 16578-D	J.O. NO. 164016 164018	CIP NO.	SPRINKLER SYSTEM TENNIS/HANDBALL COURTS	1-76 5-76 6-85
THOMAS BROTHERS PAGE: PG. 59-6	LAMBERT COORDINATES: 215-1695		REVISION S.M. 11-2-05							DRWG. NO. 20735-D 27426-D	J.O. NO. 118229 112513	CIP NO.	DADIZINIC	6-85

CITY OF SAN DIEGO PARK AND RECREATION DEPARTMENT

THE GENERAL DEVELOPMENT PLAN

# ROBB FIELD

PSD (MB-113) **EXISTING CONDITIONS PARKING COUNT** 

TOTAL PARK AREA = 64 ACRES

NON-PROGRAMMED AREA = 13.6 ACRES

## **NEEDED PARKING BREAKDOWN:**

68 SPOTS = 5 SPOTS PER ACRE OF NON PROGRAMMED

PARK LAND (13.6 ACRES)

240 SPOTS = 30 SPOTS PER SOFTBALL BACKSTOP (8)

24 SPOTS = 12 PARKING SPOTS PER 6 TENNIS COURTS (12 COURTS)

120 SPOTS = 30 SPOTS PER SOCCER FIELD (2 ADULT, 2 YOUTH)

47 SPOTS = 1 SPOT PER 200 SF OF BUILDING (9,417 SF) **499 TOTAL PARKING SPACES REQUIRED** 

## **CURRENT PARKING BREAKDOWN**

PARKING LOT 1 = 131 SPACES (5 ADA REQUIRED, 4 EXISTING)

PARKING LOT 2 = 196 SPACES (6 ADA REQUIRED, 5 EXISTING)

PARKING LOT 3 = 314 SPACES (8 ADA REQUIRED, 8 EXISTING)

PARKING LOT 4 = 12 SPACES (1 ADA REQUIRED, 1 EXISTING)

PARKING LOT 5 = 57 SPACES (3 ADA REQUIRED, 3 PLANNED) **TOTAL SPACES = 710 SPACES** 

### **EXISTING CONDITIONS PARKING COUNTS**

499 PARKING SPACES NEEDED

710 PARKING SPACES PROVIDED 211 PARKING SPACE SURPLUS

(211/30 = 7 ADDITIONAL ACTIVITIES ACCOMMODATED)

## PROPOSED PARKING COUNT

TOTAL PARK SCOPE = 64 ACRES

TOTAL IMPROVEMENT SCOPE AREA = 51 ACRES

NON-PROGRAMMED AREA = 8.1 ACRES

## **BREAKDOWN:**

41 SPOTS = 5 SPOTS PER ACRE OF NON-PROGRAMMED PARK LAND (8.1)

240 SPOTS = 30 SPOTS PER SOFTBALL BACKSTOP (8)

68 SPOTS = 1 SPOT PER 200 SF OF BUILDING (13,650 SF)

36 SPOTS = TWELVE SPOTS PER SIX TENNIS/PADEL COURTS (18 COURTS)

24 SPOTS = TWELVE SPOTS PER SIX PICKLEBALL COURTS (12 COURTS)

120 SPOTS = 30 SPOTS PER SOCCER FIELD (2 ADULT, 2 YOUTH)

30 SPOTS = 15 SPOTS PER ENCLOSED SOCCER COURT (2) **559 TOTAL PARKING SPACES NEEDED** 

## PROPOSED PARKING BREAKDOWN:

PARKING LOT 1 = 101 SPACES (5 ADA)

PARKING LOT 2 = 275 SPACES (7 ADA)

PARKING LOT 3 = 341 SPACES (8 ADA)

PARKING LOT 4 = 12 SPACES (1 ADA)

PARKING LOT 5 = 57 SPACES (3 ADA)

PARKING LOT 6 = 34 SPACES (2 ADA) TOTAL SPACES = 820 SPACES

## PROPOSED PARKING COUNTS

559 PARKING SPACES NEEDED

820 PARKING SPACES PROVIDED 261 PARKING SPACE SURPLUS

(261/30 = 8 ADDITIONAL ACTIVITIES ACCOMMODATED)



**PLANT LEGEND** 

PARKING LOT & ALLEE TREES SUCH AS:

Fraxinus oxycarpa 'Raywood' / Raywood Ash Lophostemon confertus / Brisbane Box



ACCENT TREES (10' OR LARGER PLANTERS)

Platanus mexicana / Mexican Sycamore

Pinus torreyana / Torrey Pine

Tipuana tipu / Tipu Tree

Quercus Ilex / Holm Oak

Quercus agrifolia / Coast Live Oak



FLOWERING TREES:

Bauhinia blakeana / Hong Kong Orchid Tree Lagerstroemia indica\* / Crape Myrtle Tabebuia rosea / Pink Trumpet Tree

\*Limit to areas where there are space constraints.



PLANTING AREAS AND PARKING ISLANDS:

Primarily bark mulch or decomposed granite with accent boulders and groupings of plantings such as:

Abutilon palmeri / Indian Mallow

Agave attenuata / Foxtail Agave

Agave desmettiana 'Variegata' / Variegated Smooth Agave

Artemisia californica / California Sagebrush

Aster chilensis 'Point Saint George' / Point Saint George Aster

Bahiopsis laciniata / San Diego Sunflower

Cercocarpus betuloides / Mountain Mahogany

Chilopsis linearis / Desert Willow

Dasylirion wheeleri / Spoon Yucca

Erigeron glaucus 'Sea Breeze' / Seaside Daisy

Gambelia speciosa / Island Snapdragon

Grindelia stricta venulosa / Grindelia

Heteromeles arbutifolia 'Davis Gold' / Davis Gold Toyon

Hesperaloe parviflora / Red Yucca

Lantana montevidensis / Trailing Lantana

Nolina microcarpa / Beargrass

Rhamnus californica / Coffeeberry

Rhaphiolepis indica / Indian Hawthorn

Salvia clevelandii / Cleveland Sage

Salvia 'Point Sal Spreader' / Point Sal Purple Sage

## BASIN:

Achillea millefolium / Yarrow

Baccharis pilularis 'Pigeon Point' / Dwarf Coyote Brush Plant

Carex praegracilis / Field Sedge

Carex tumulicola / Berkeley Sedge

Iva hayesiana / San Diego Povertyweed

Muhlenbergia rigens / Deer Grass

Populus fremontii / Fremont Cottonwood





Tipuana tipu




Abutilon palmeri



Baccharis pilularis 'Pigeon Point'



Erigeron glaucus 'Sea Breeze'

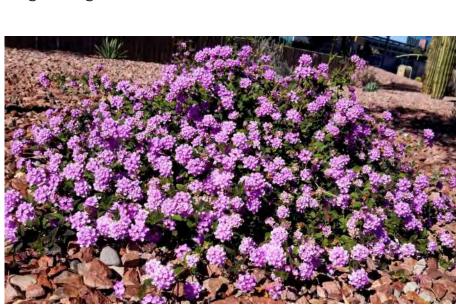

Lantana montevidensis



Carex praegracilis



Quercus Ilex



Bauhinia blakeana



Agave spp



Cercocarpus betuloides



Grindelia stricta venulosa





Iva hayesiana



Platanus mexicana



Lagerstroemia indica






Chilopsis linearis



Heteromeles arbutifolia 'Davis Gold'



Salvia clevelandii

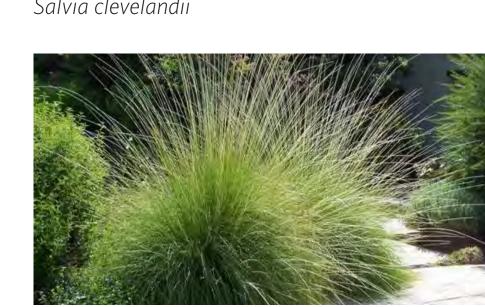

Muhlenbergia rigens

COUNCIL DISTRICT NO. 2

LAMBERT COORDINATES: 215-1695



Pinus torreyana





Aster chilensis 'Point Saint George'



Dasylirion wheeleri



Hesperaloe parviflora



Salvia 'Point Sal Spreader'



Populus fremontii

PRELIMINARY PLANTING RECOMMENDATIONS

THE GENERAL DEVELOPMENT PLAN

CITY OF SAN DIEGO PARK AND RECREATION DEPARTMENT

# ROBB FIELD

COMMUNITY PARK


THOMAS BROTHERS PAGE: PG. 59-B3


COMM. PLAN AREA: MISSION PARK


**PSD SUPPLEMENTAL SHEET NO.: 1 OF 24** 







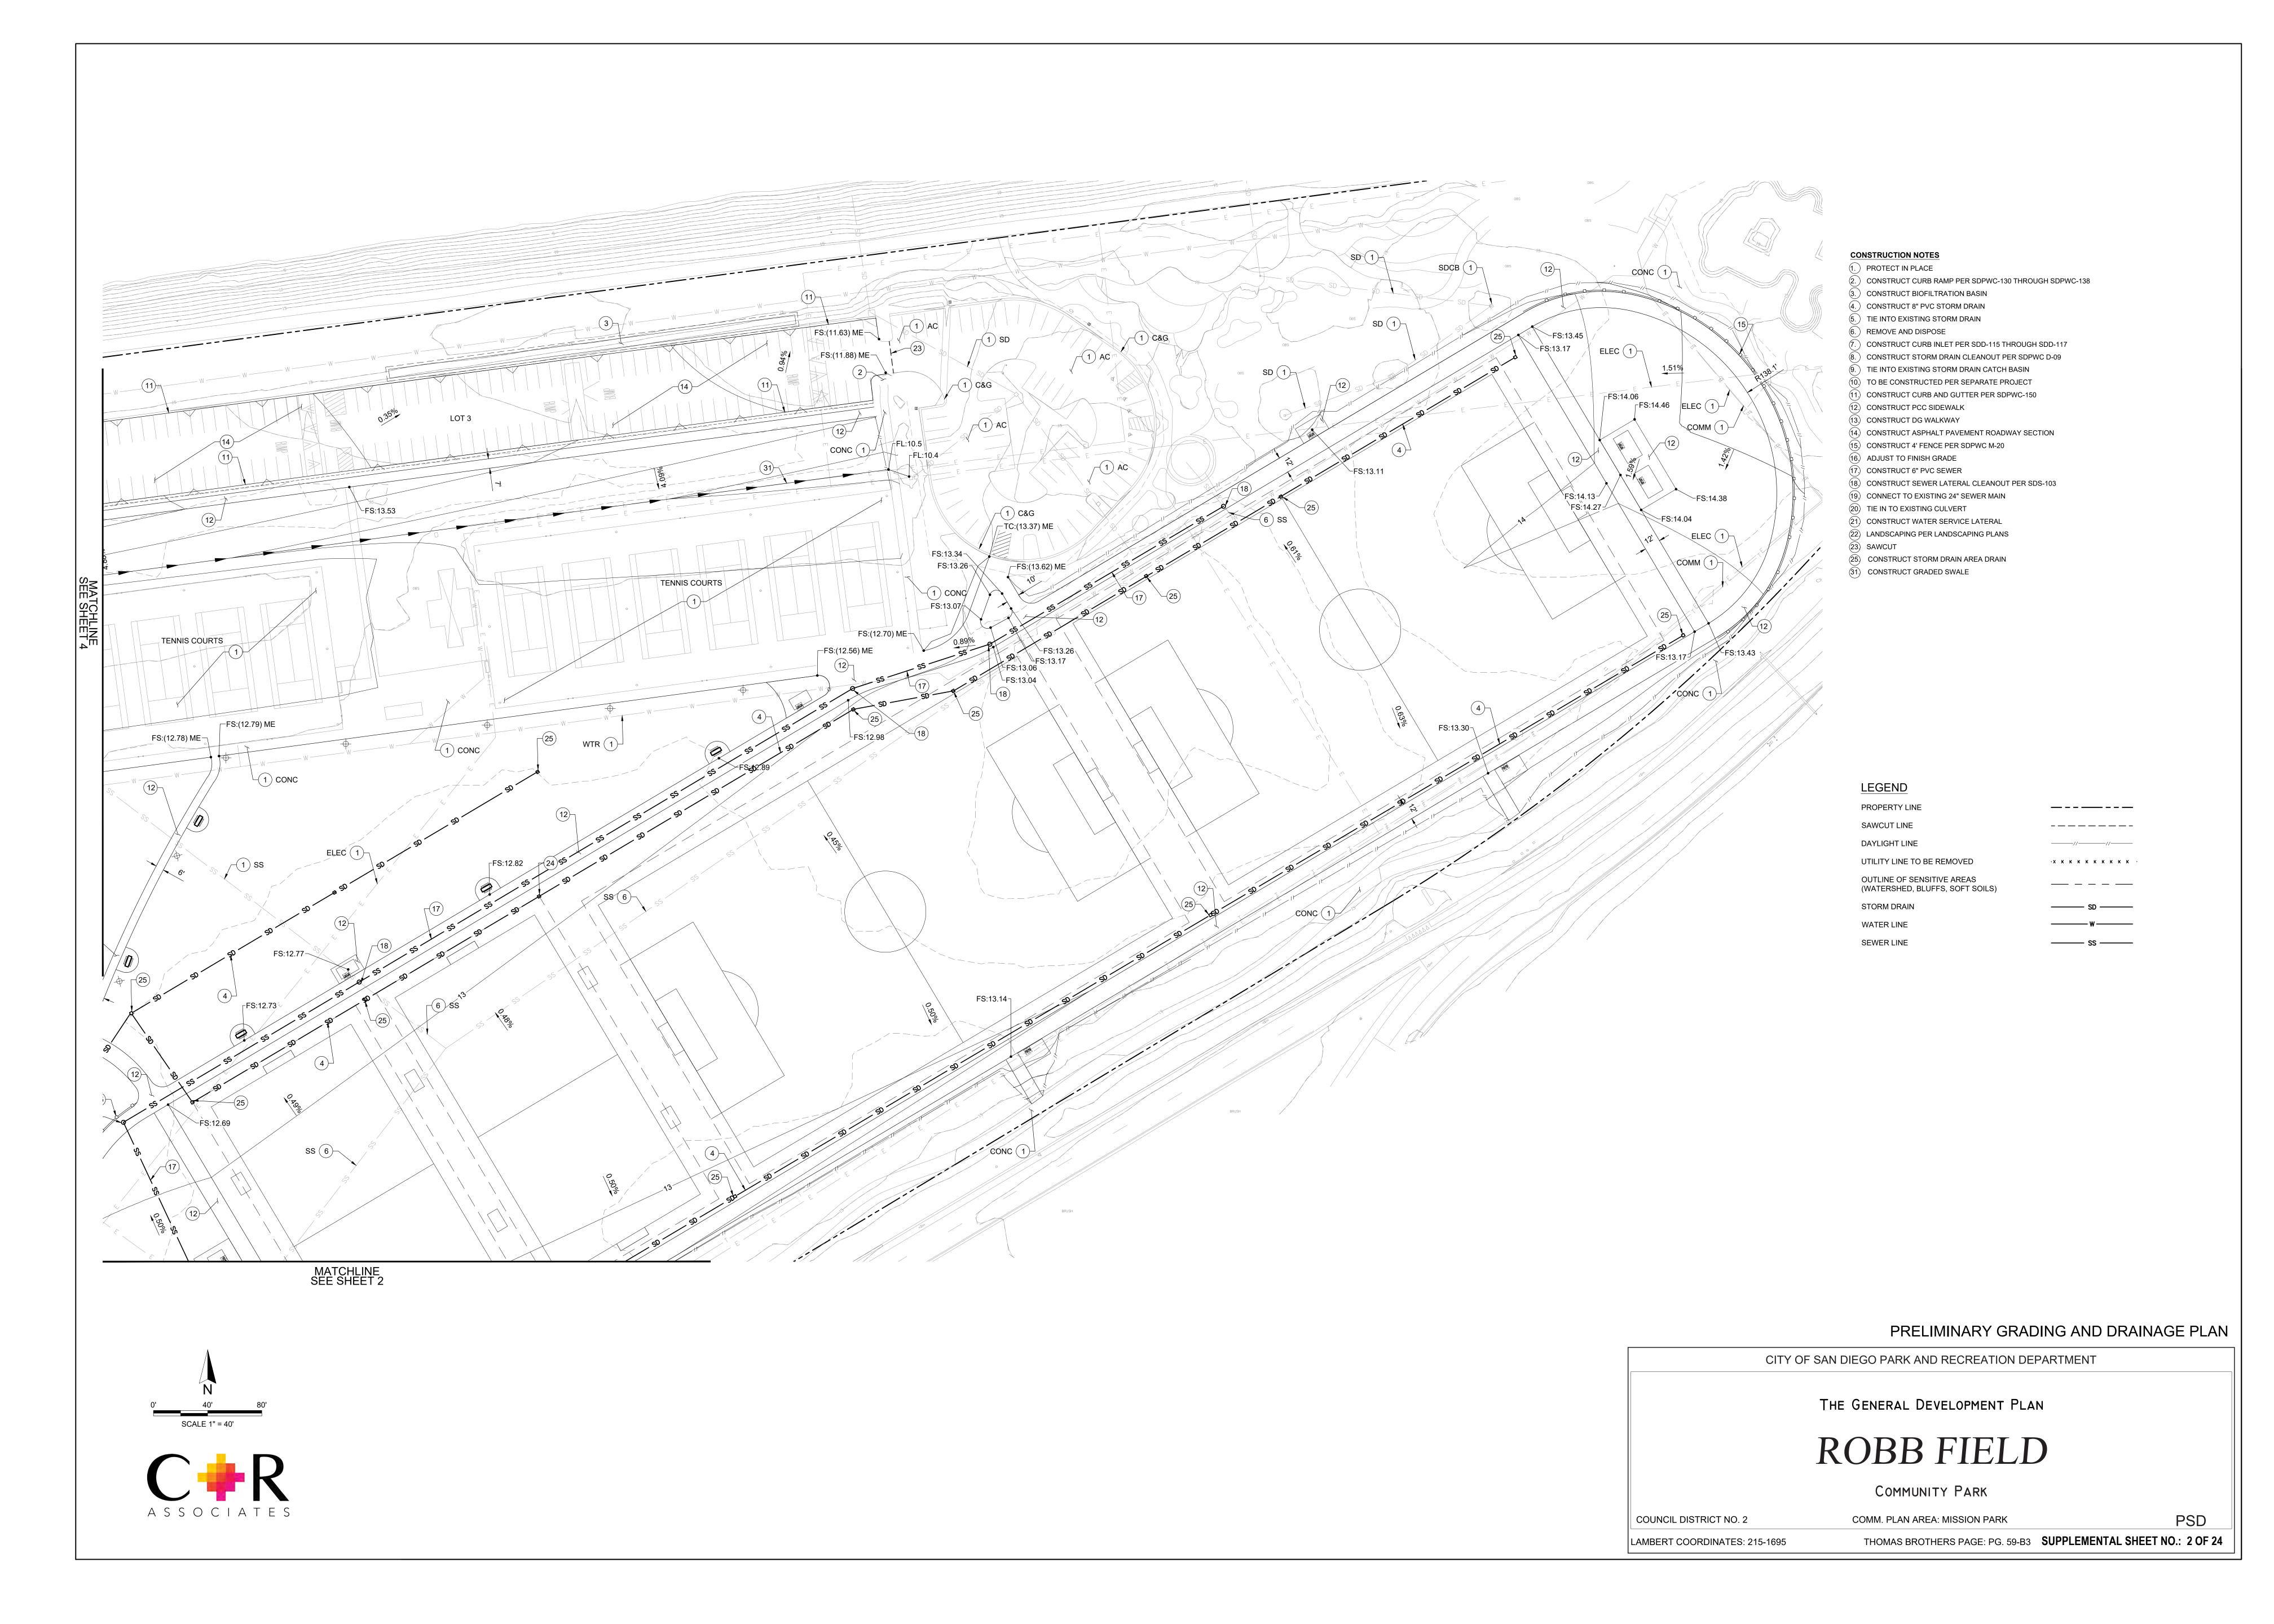

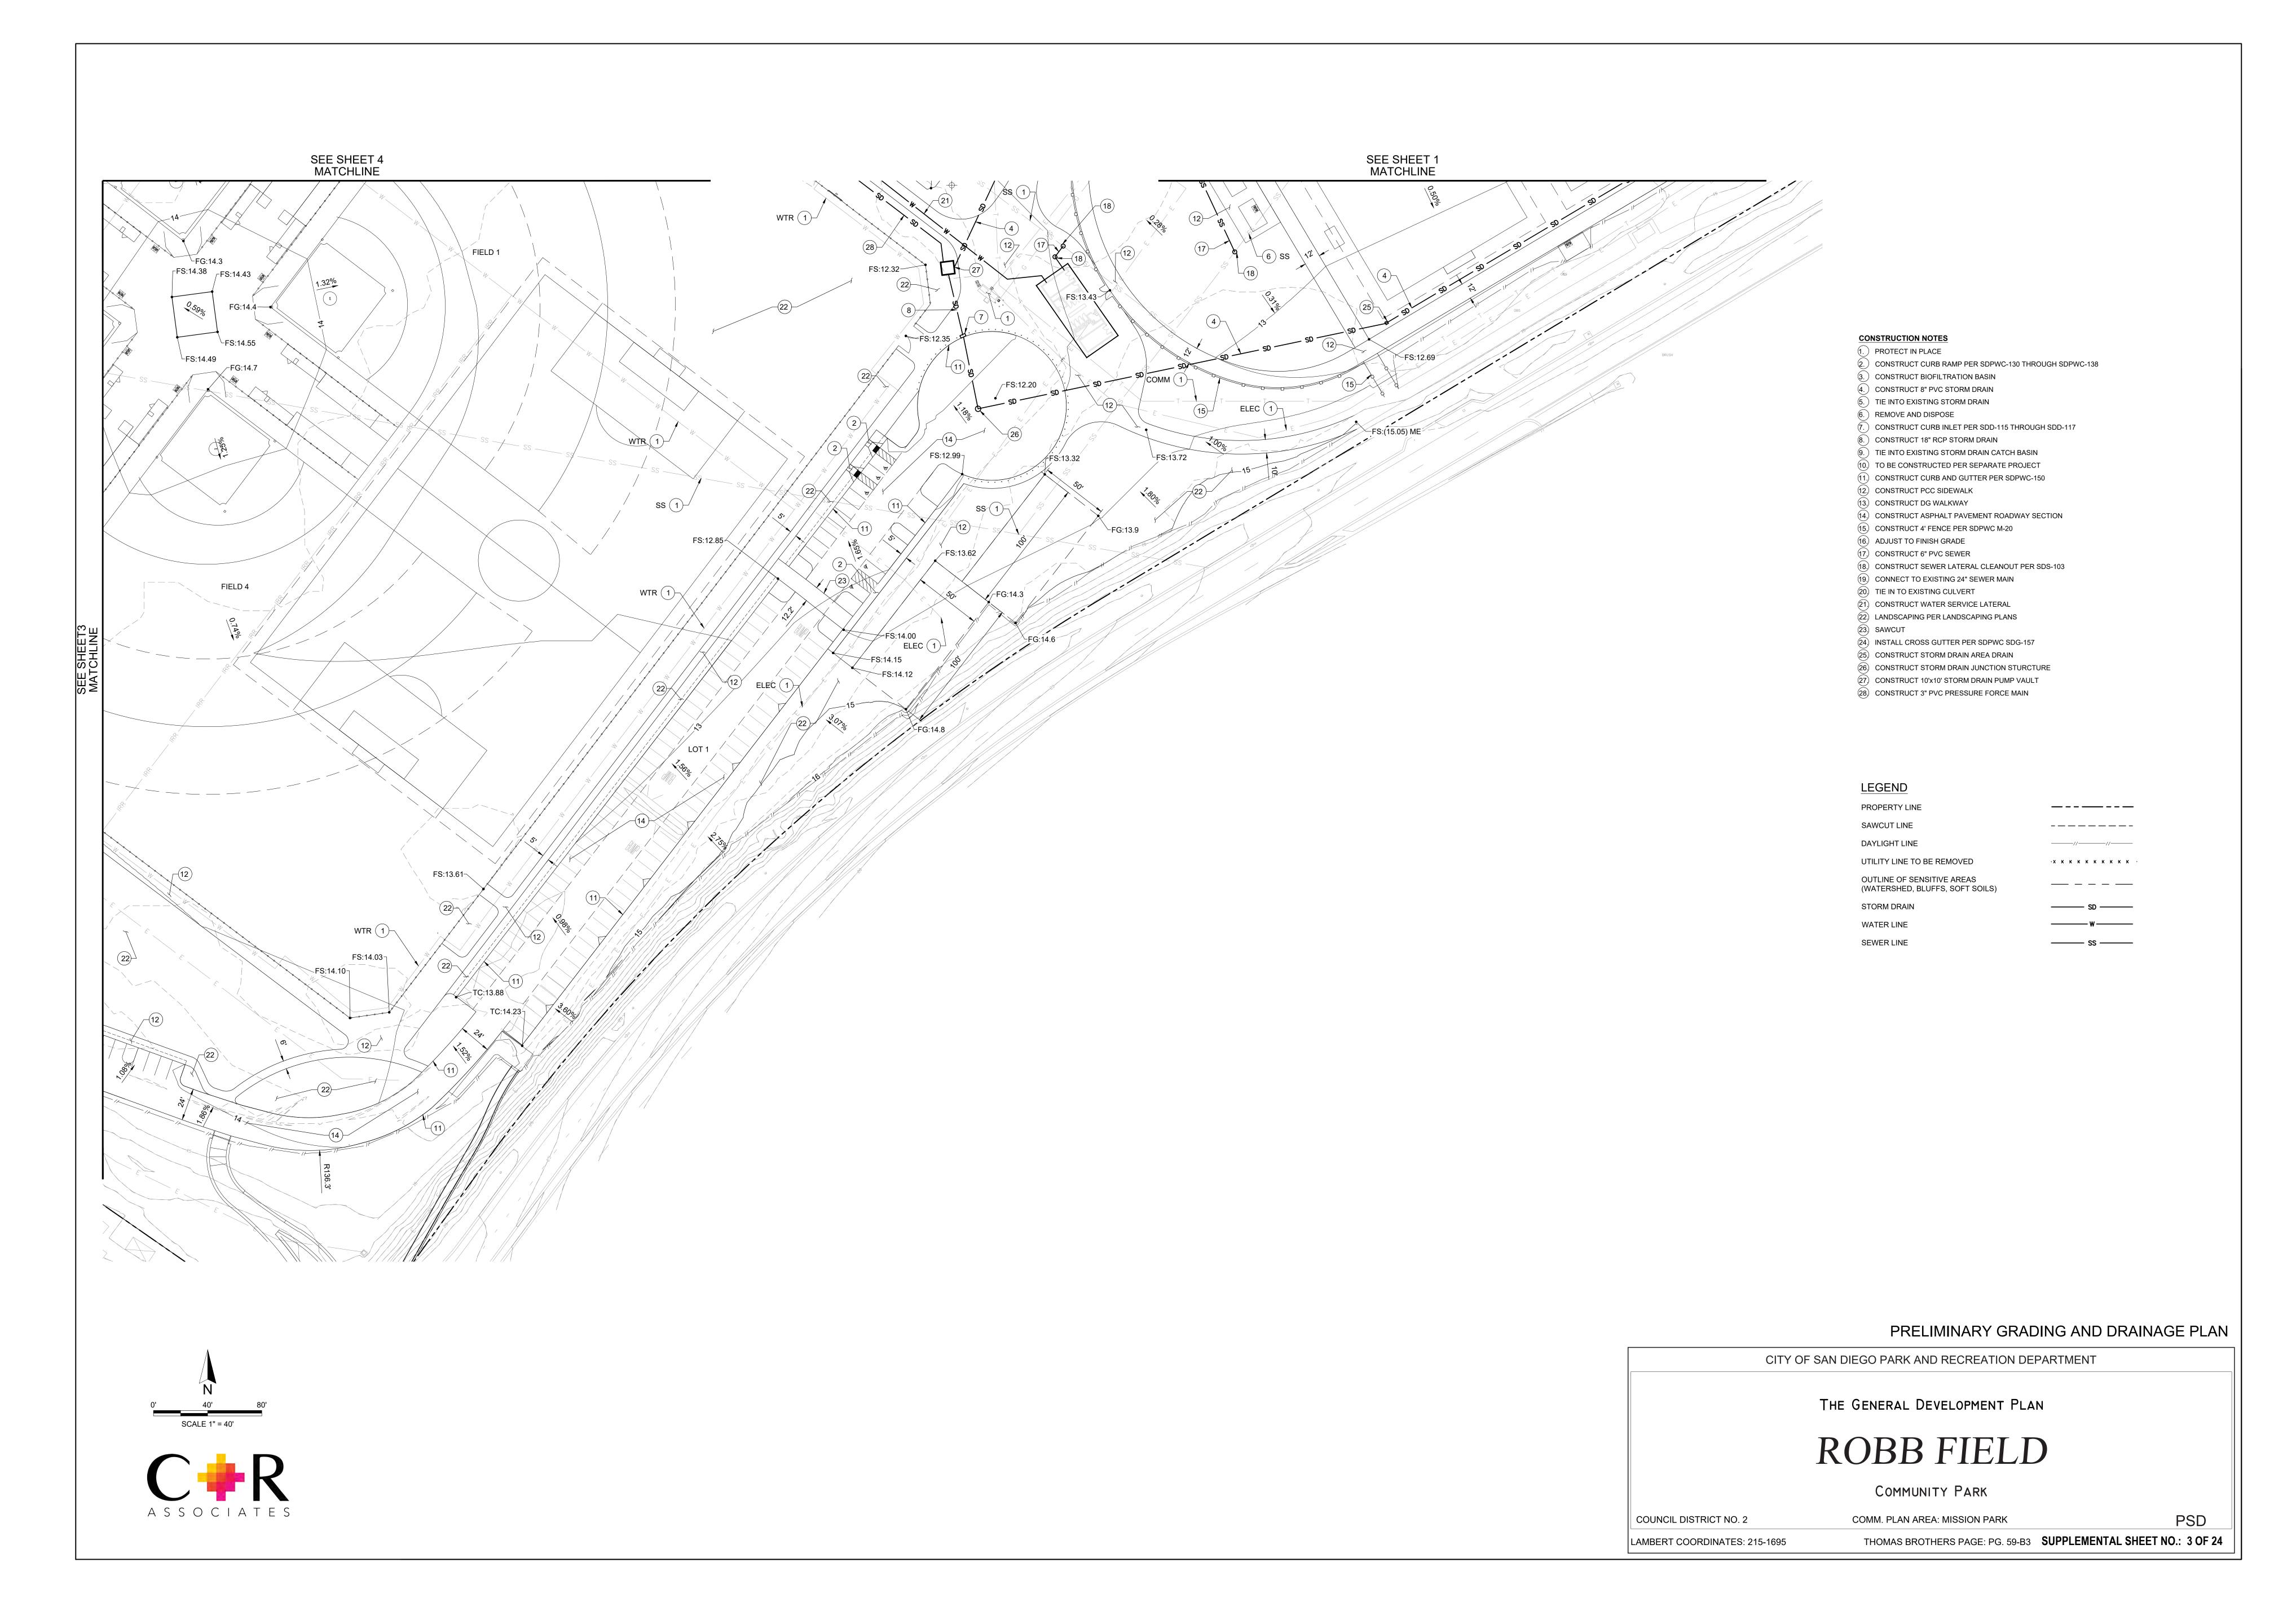

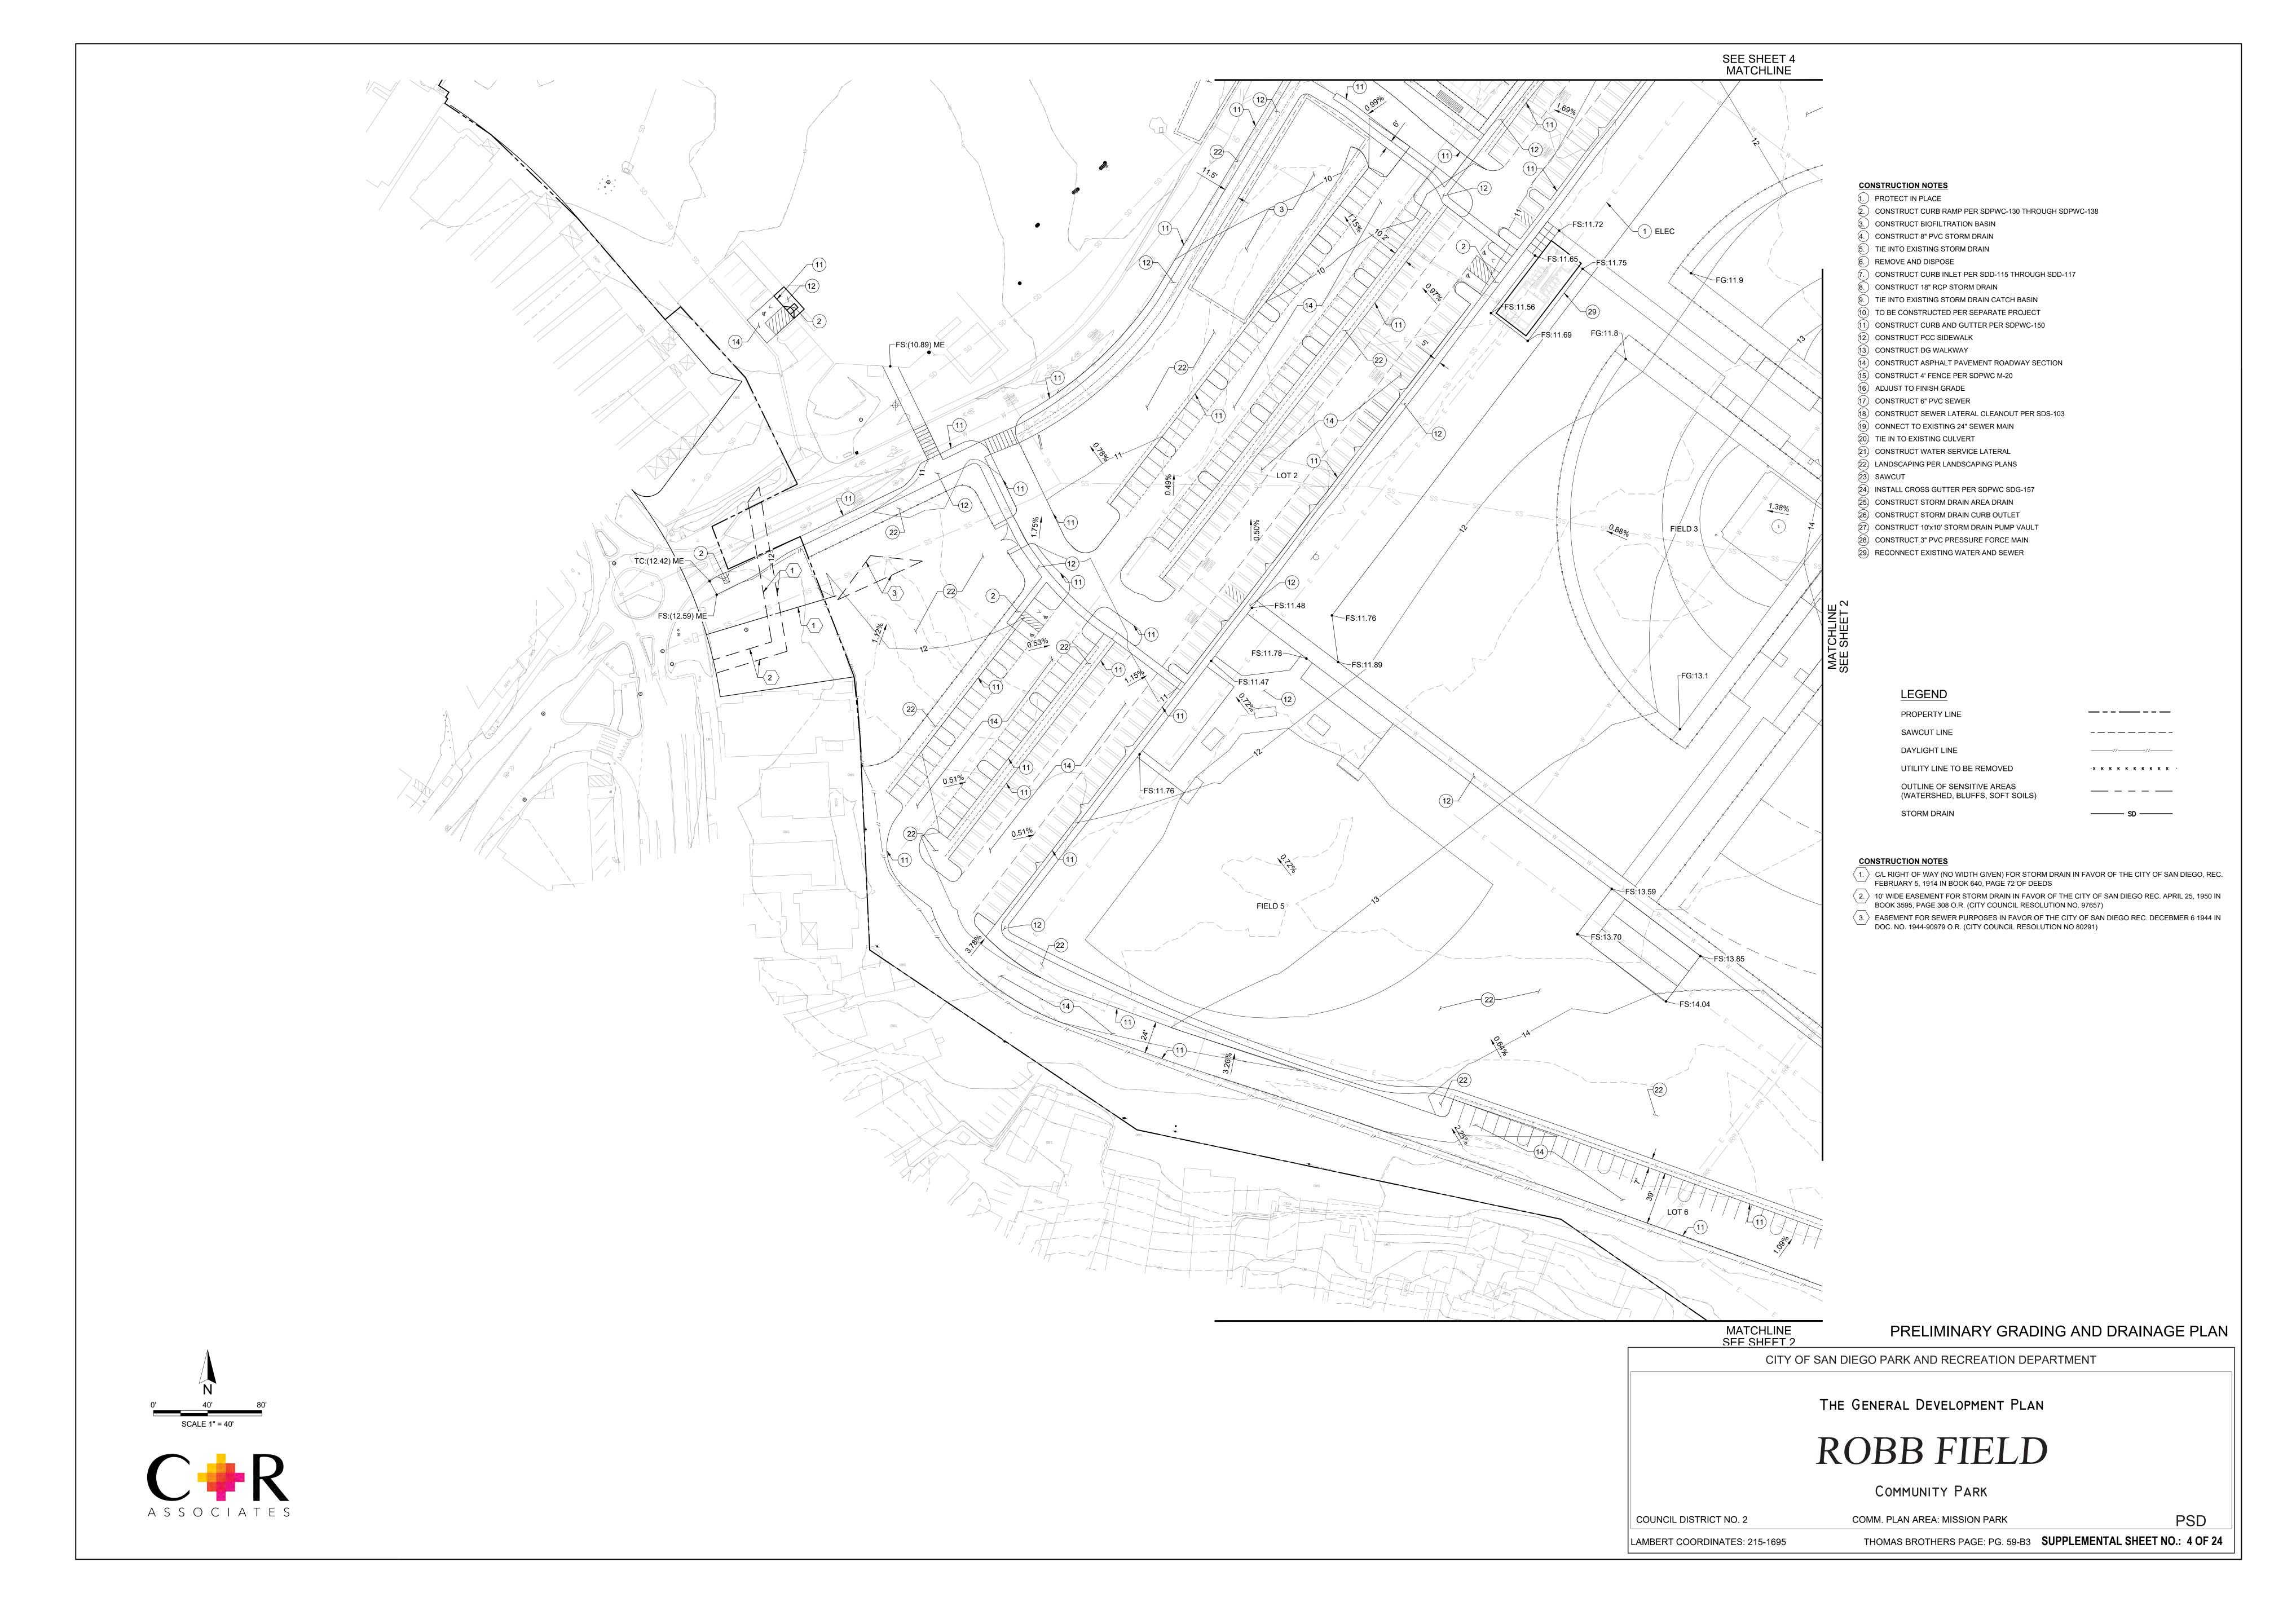

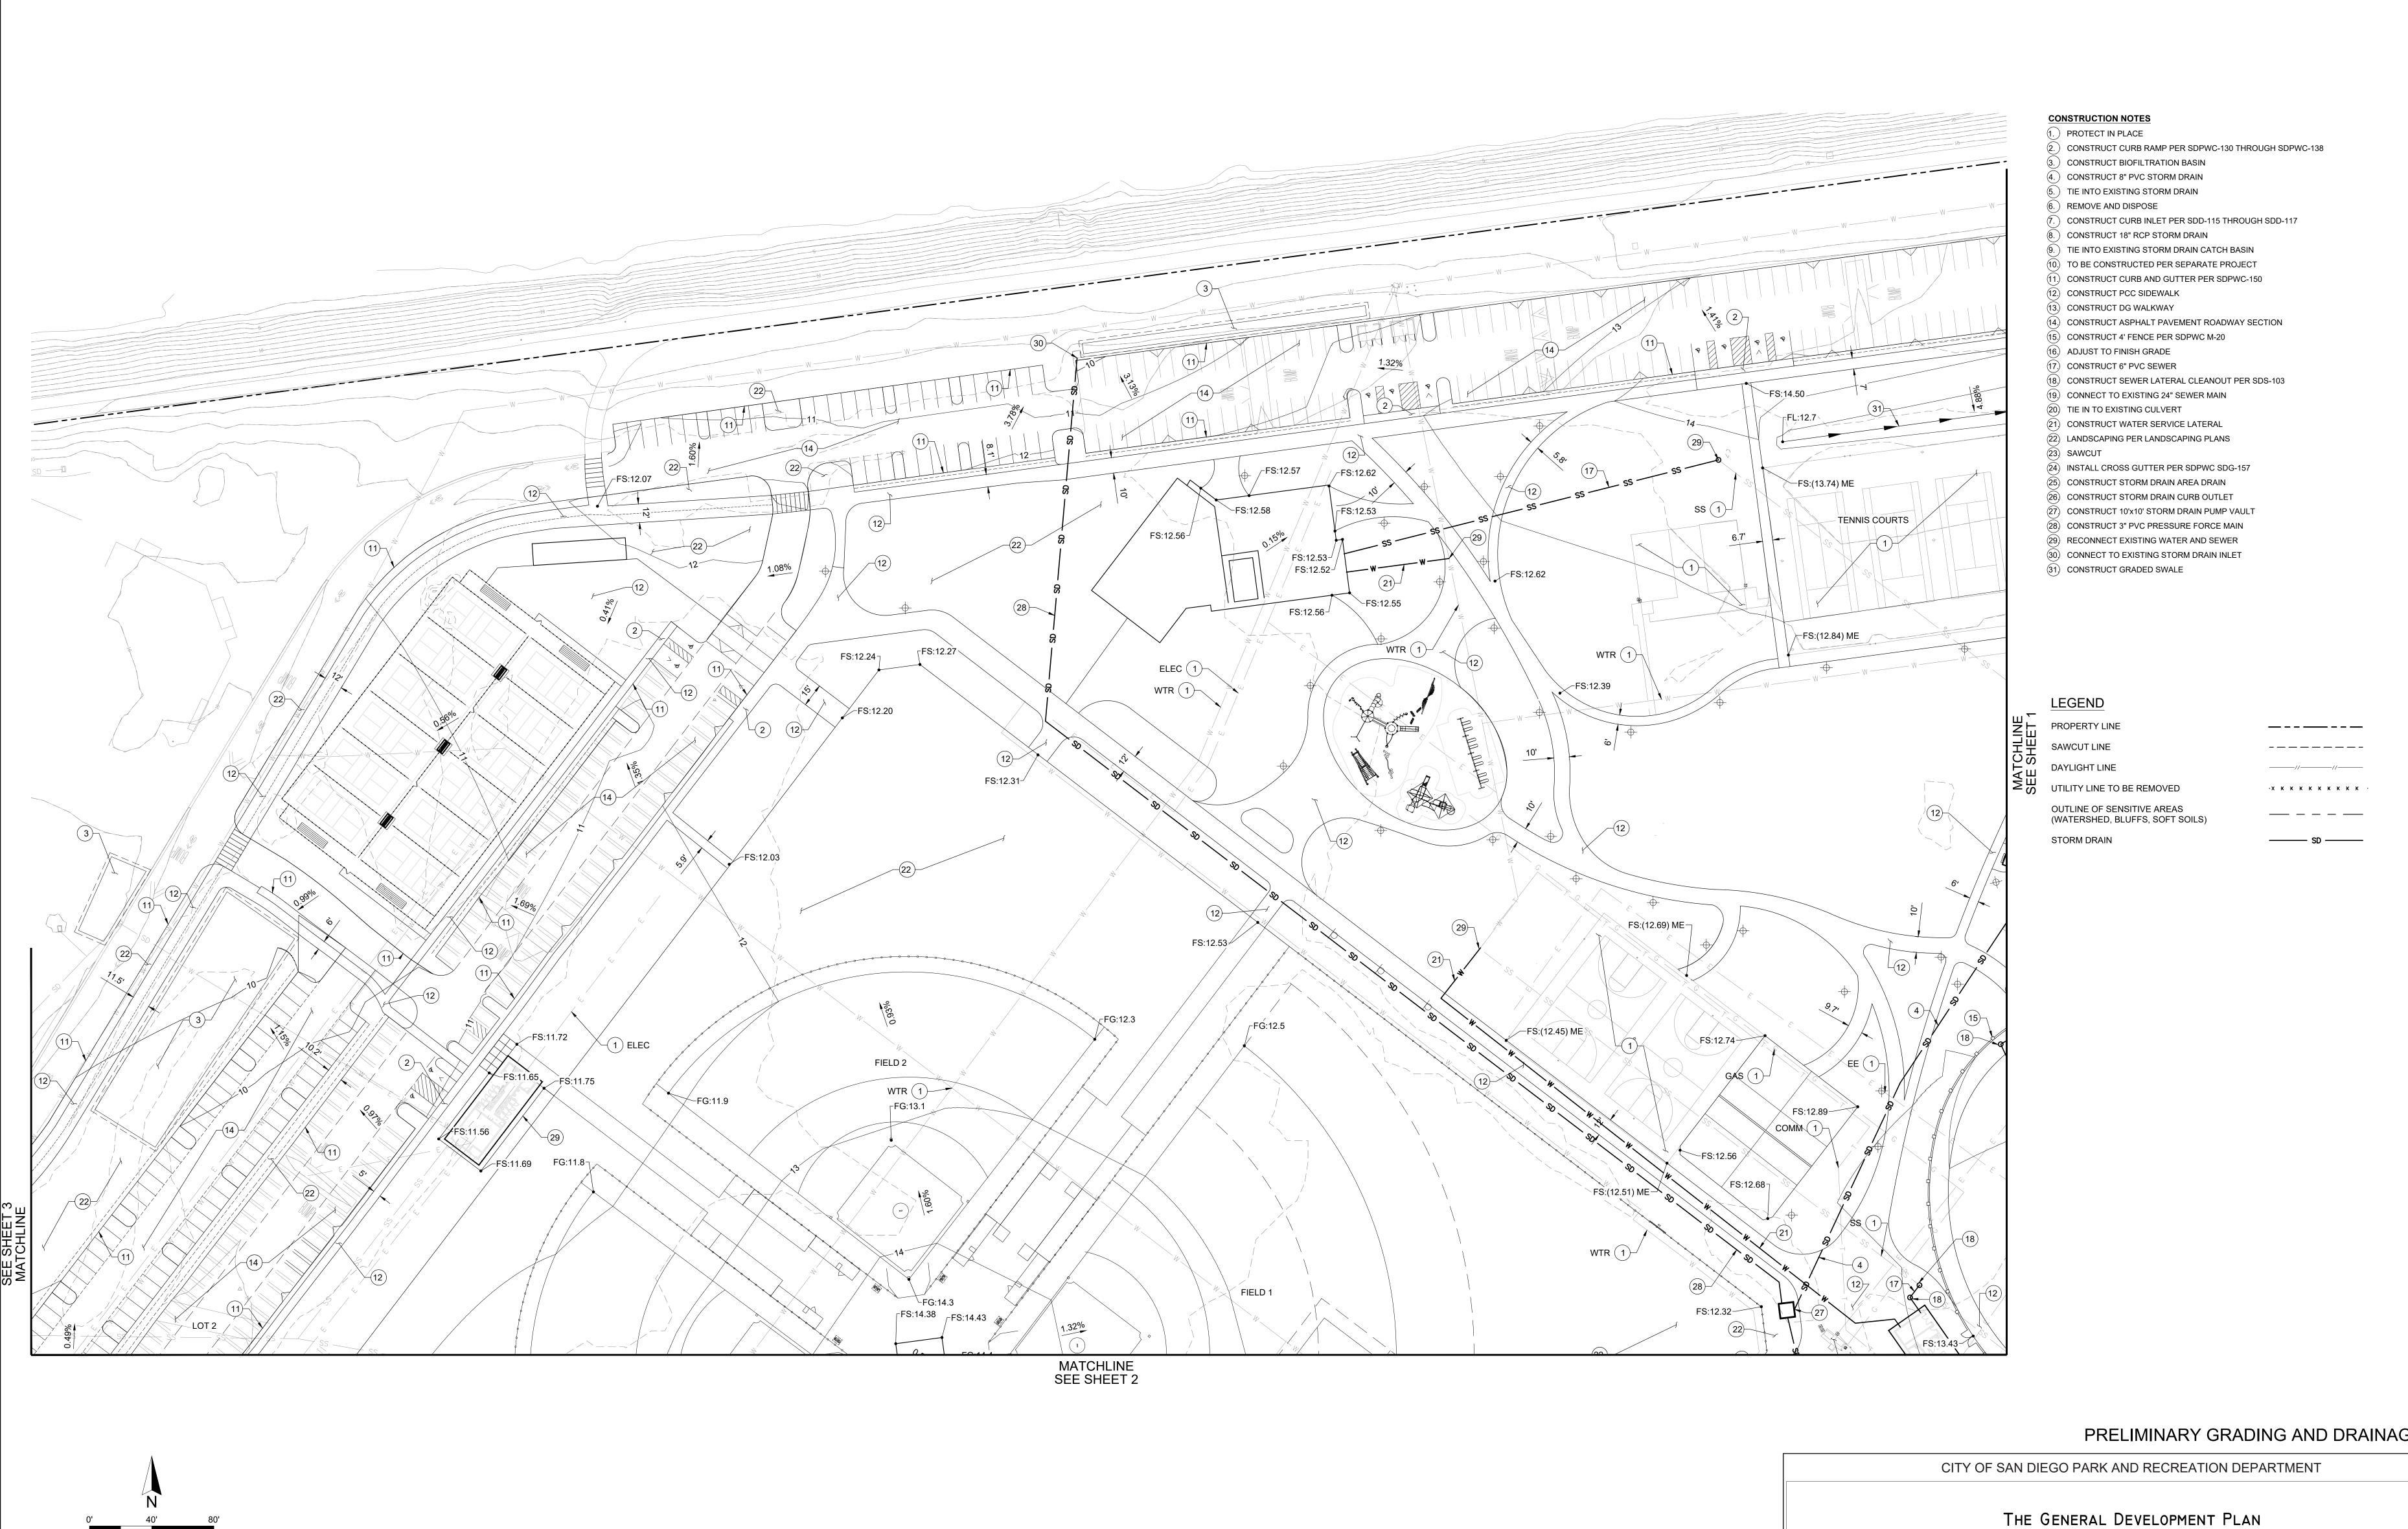

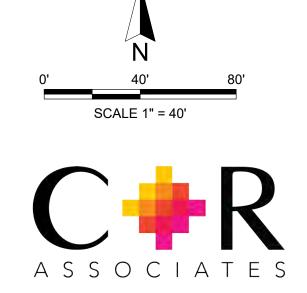

## PRELIMINARY GRADING AND DRAINAGE PLAN

ROBB FIELD

COMMUNITY PARK

COUNCIL DISTRICT NO. 2 COMM. PLAN AREA: MISSION PARK

PSD

LAMBERT COORDINATES: 215-1695

THOMAS BROTHERS PAGE: PG. 59-B3 SUPPLEMENTAL SHEET NO.: 5 OF 24


# PROGRAM LEGEND FITNESS CENTER ADMINISTRATION PUBLIC COMMUNAL RESTROOMS STORAGE/ UTILITIES

OVERHEAD

LINES

ENTRY / EXIT

TOTAL BLDG SF: 7,781 SF

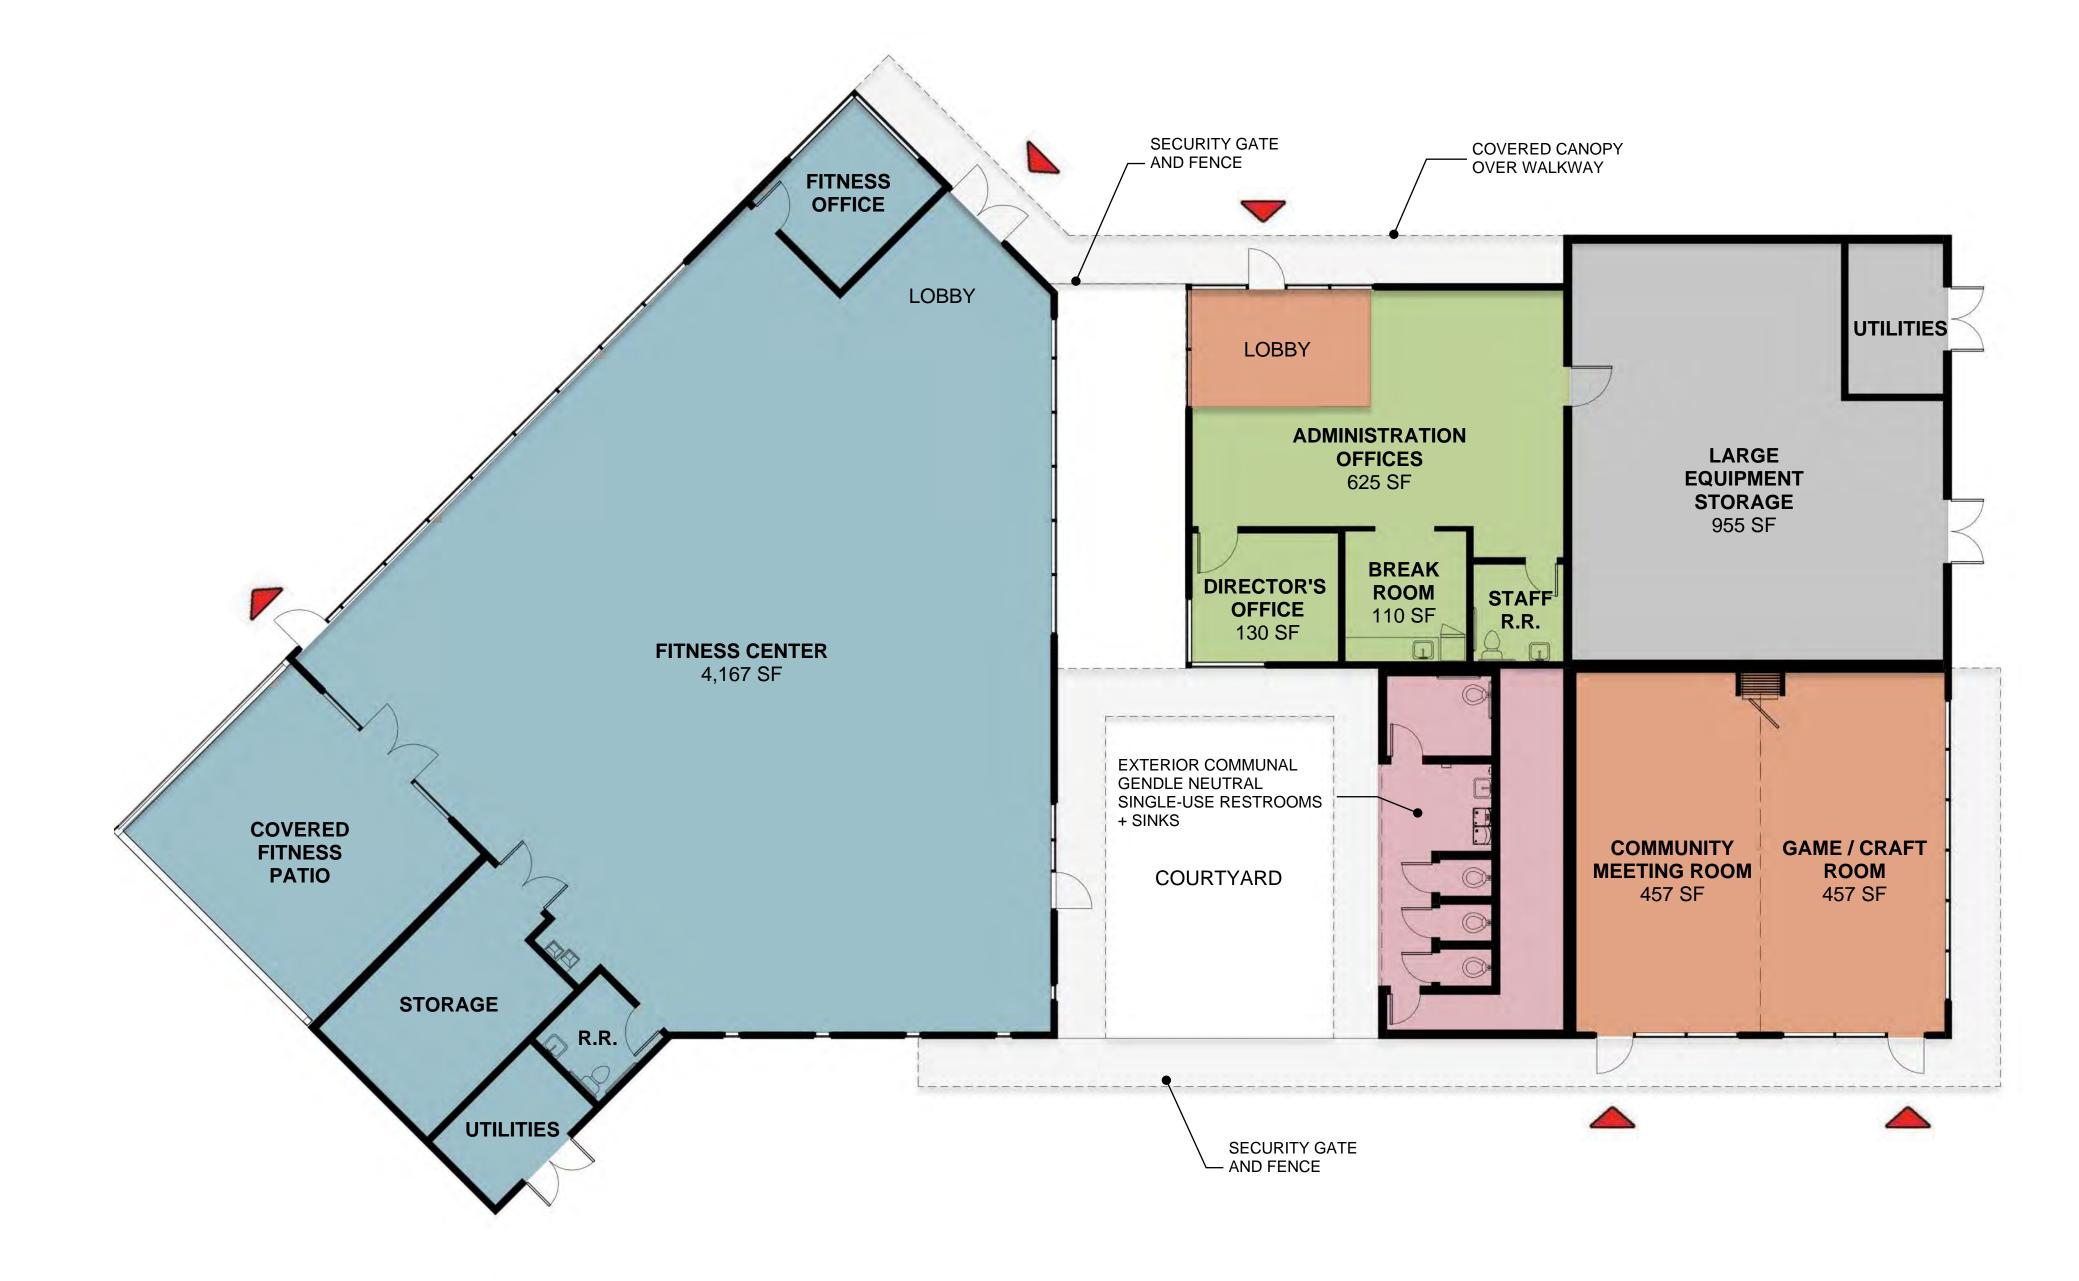

1/8" = 1'-0"



## PRELIMINARY RECREATION CENTER FLOOR PLAN

CITY OF SAN DIEGO PARK AND RECREATION DEPARTMENT

THE GENERAL DEVELOPMENT PLAN

ROBBFIELD

COMMUNITY PARK

COUNCIL DISTRICT NO. 2 COMM. PLAN AREA: MISSION PARK


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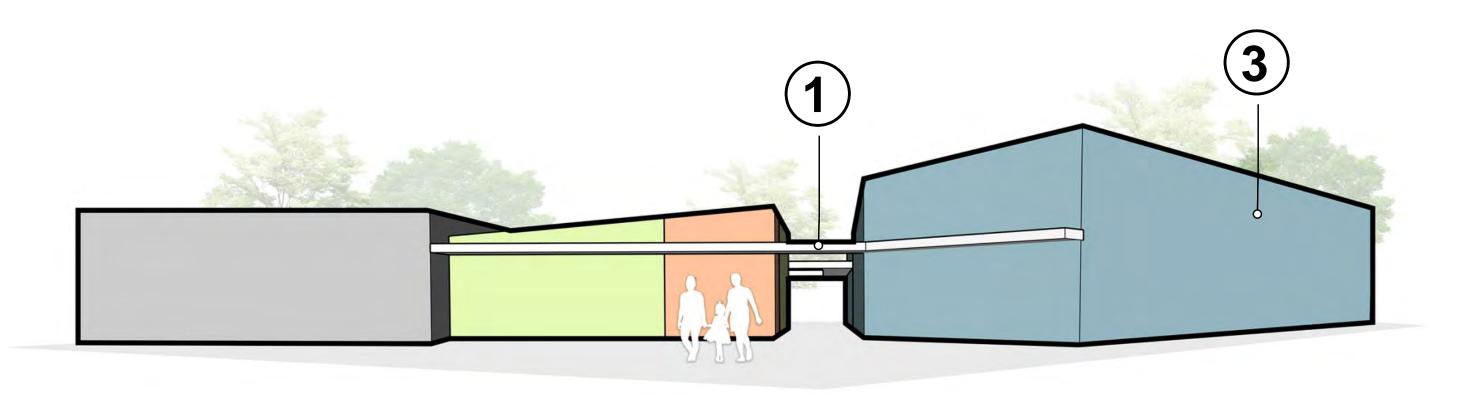
LAMBERT COORDINATES: 215-1695 THOMAS BROTHERS PAGE: PG. 59-B3 SUPPLEMENTAL SHEET NO.: 6 OF 24






TOTAL BLDG SF: 7,781 SF




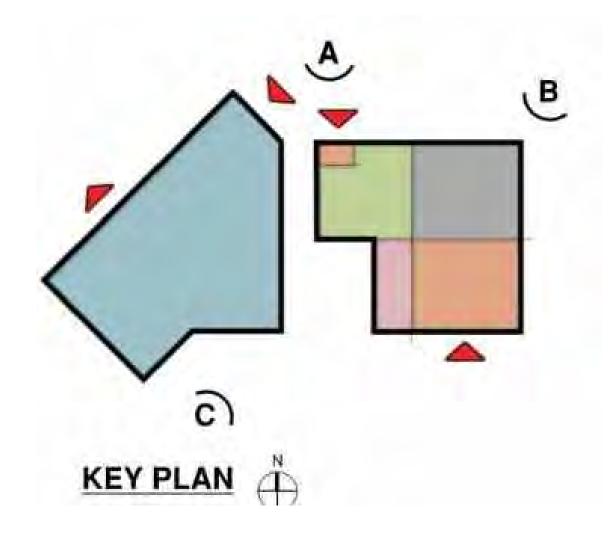

# NORTH PERSPECTIVE

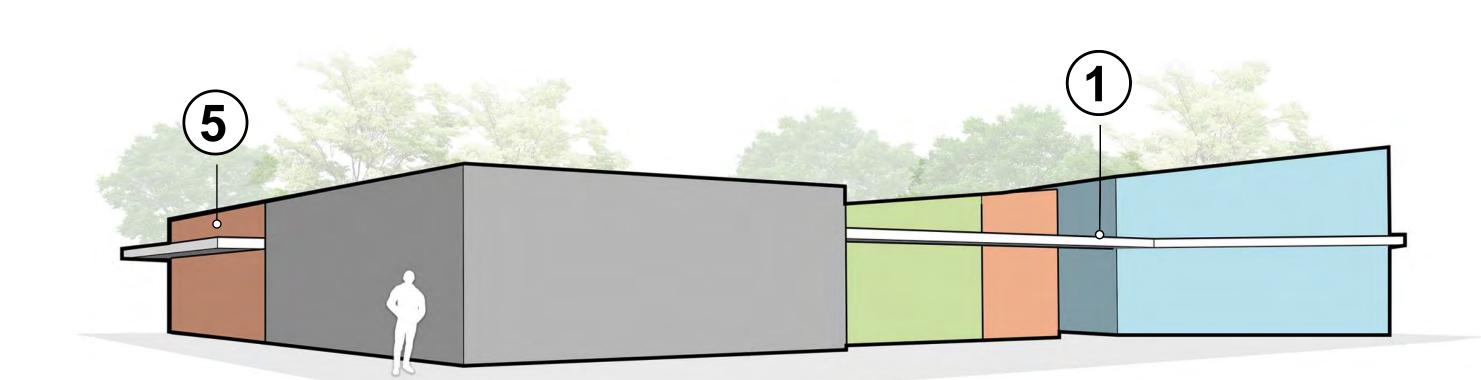

# R NORTHWEST PERSPECTIVE

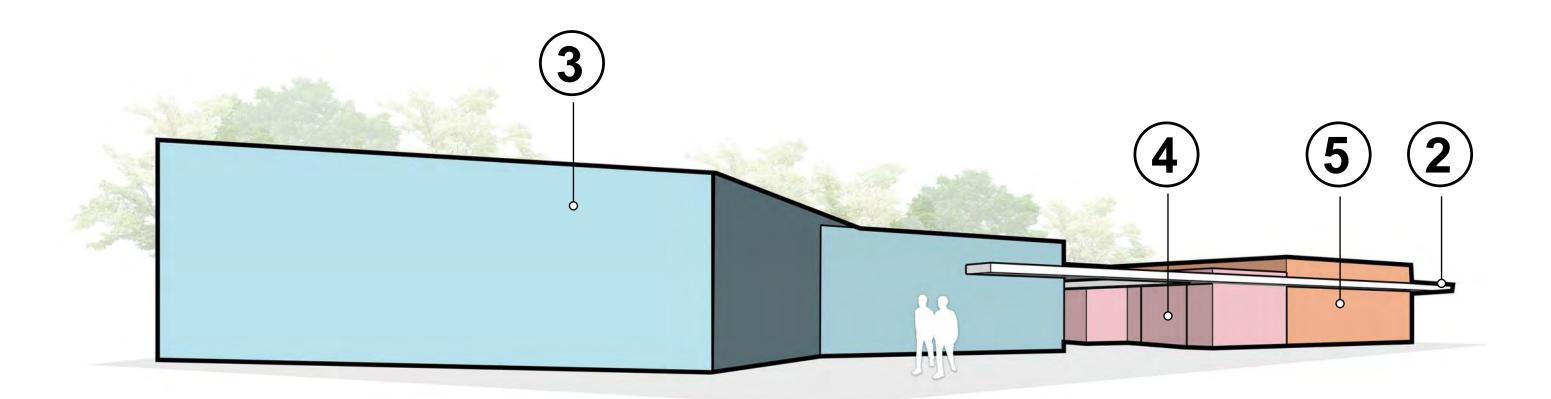


# SOUTHEAST PERSPECTIVE









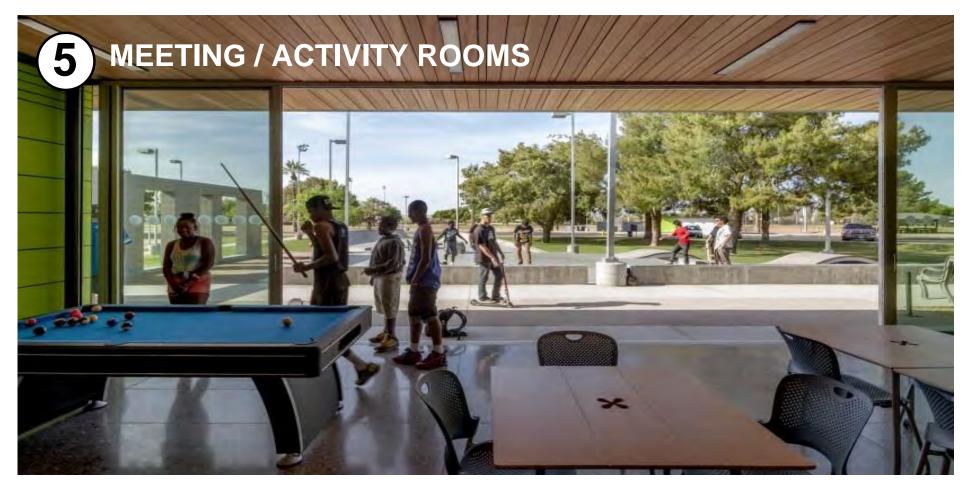

## PRELIMINARY RECREATION CENTER PERSPECTIVES AND INSPIRATION

CITY OF SAN DIEGO PARK AND RECREATION DEPARTMENT

THE GENERAL DEVELOPMENT PLAN

ROBB FIELD

COMMUNITY PARK


COUNCIL DISTRICT NO. 2


LAMBERT COORDINATES: 215-1695


COMM. PLAN AREA: MISSION PARK

THOMAS BROTHERS PAGE: PG. 59-B3 SUPPLEMENTAL SHEET NO.: 7 OF 24

PSD

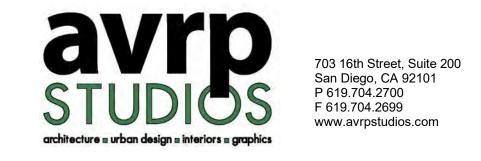

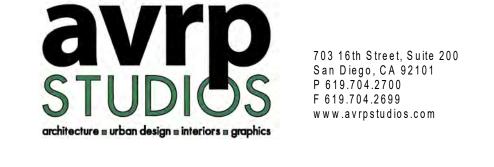

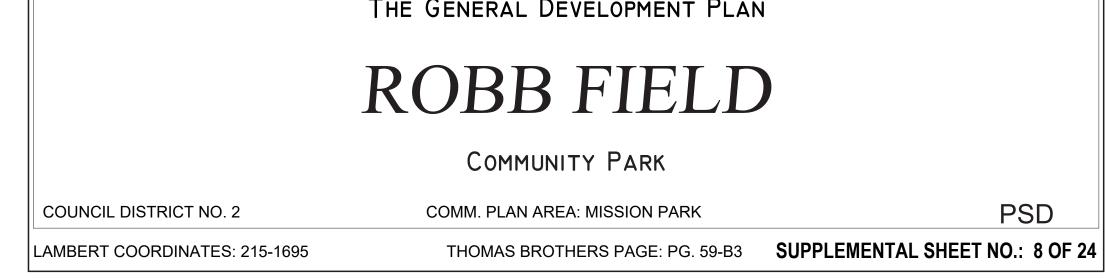

1 COMFORT STATION - FLOOR PLAN 1/4" = 1'-0"

2 ACCESSIBLE RESTROOMS, GENDER NEUTRAL 2 AMBULATORY RESTROOMS, GENDER NEUTRAL 6 STANDARD RESTROOMS, GENDER NEUTRAL 4 EXTERIOR LAVATORIES

TOTALS

COMFORT STATION BUILDING = 1,152 GROSS SQUARE FEET (GSF)

\_\_\_\_\_\_ DRINKING FOUNTAINS AND WATER BOTTLE -FILLING STATION PERC MACHINE 460 SF PERC MACHINE ACCESSIBLE RESTROOM EXTERIOR COMMUNAL SINKS GOLF CART \_ SLIDING GATE ON V-GROOVE TRACK — EYE WASH STATION AMBULATORY STALL ---- ROOF OVERHANG

AMBULATORY

EXTERIOR COMMUNAL SINKS

ACCESSIBLE

# PRELIMINARY PHASE 1 COMFORT STATION FLOOR PLAN

THE GENERAL DEVELOPMENT PLAN


CITY OF SAN DIEGO PARK AND RECREATION DEPARTMENT


\_ SLIDING GATE ON V-GROOVE TRACK


ELECTRICAL

PERC MACHINE



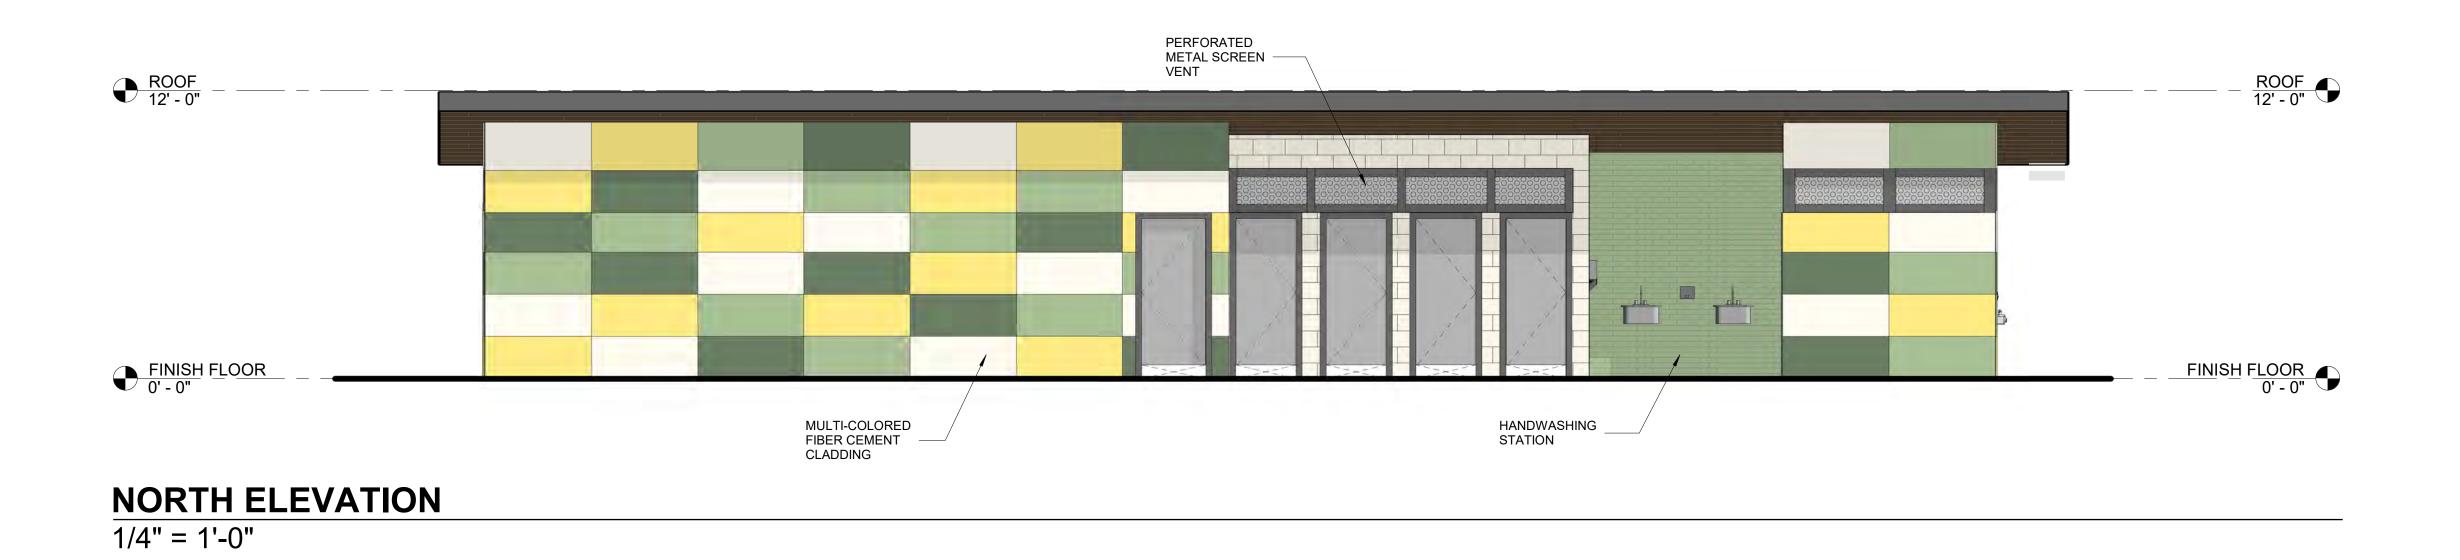

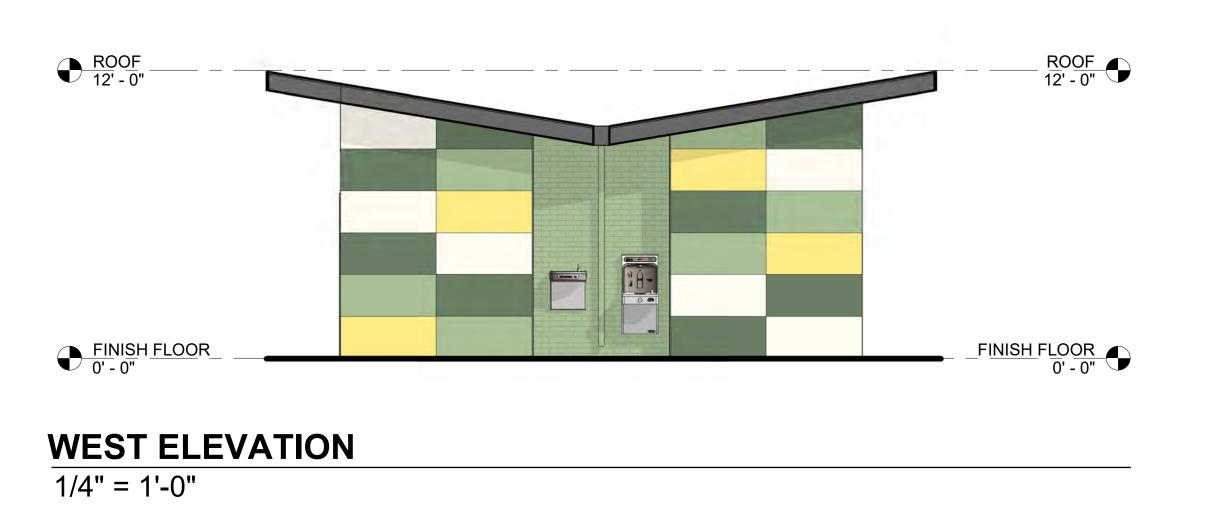

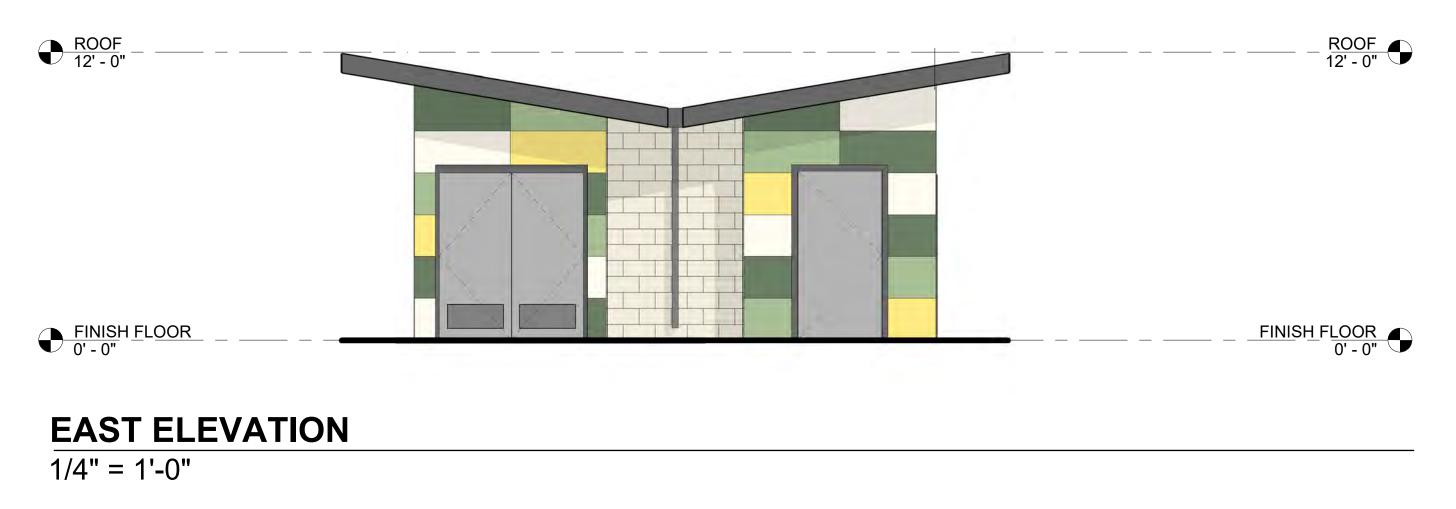

PRELIMINARY PHASE 1 COMFORT STATION ELEVATIONS

CITY OF SAN DIEGO PARK AND RECREATION DEPARTMENT

THE GENERAL DEVELOPMENT PLAN


ROBBFIELD

COMMUNITY PARK

COUNCIL DISTRICT NO. 2 COMM. PLAN AREA: MISSION PARK PSD

LAMBERT COORDINATES: 215-1695 THOMAS BROTHERS PAGE: PG. 59-B3 SUPPLEMENTAL SHEET NO.: 9 OF 24



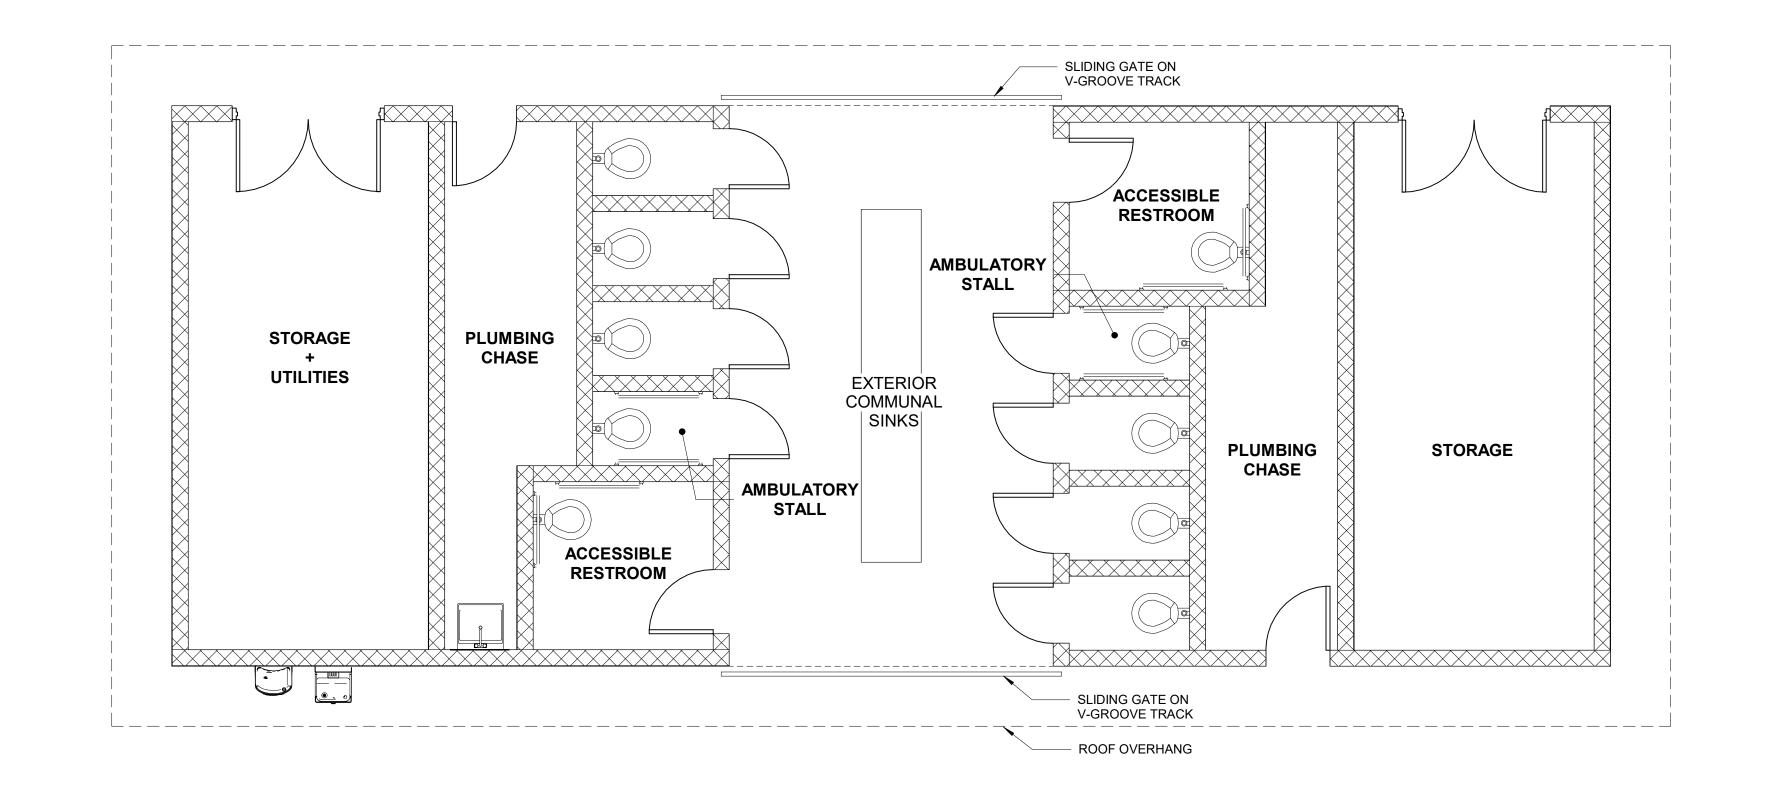

COMFORT STATION BUILDING = 1,152 GROSS SQUARE FEET (GSF)

TOTALS

2 ACCESSIBLE RESTROOMS, GENDER NEUTRAL 2 AMBULATORY RESTROOMS, GENDER NEUTRAL 6 STANDARD RESTROOMS, GENDER NEUTRAL 4 EXTERIOR LAVATORIES

1) COMFORT STATION - FLOOR PLAN 1/4" = 1'-0"



## PRELIMINARY PHASE 2 COMFORT STATION FLOOR PLAN

THE GENERAL DEVELOPMENT PLAN


ROBB FIELD

CITY OF SAN DIEGO PARK AND RECREATION DEPARTMENT

COMMUNITY PARK


COUNCIL DISTRICT NO. 2 COMM. PLAN AREA: MISSION PARK PSD


LAMBERT COORDINATES: 215-1695 THOMAS BROTHERS PAGE: PG. 59-B3 SUPPLEMENTAL SHEET NO.: 10 OF 24

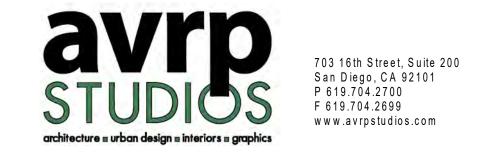






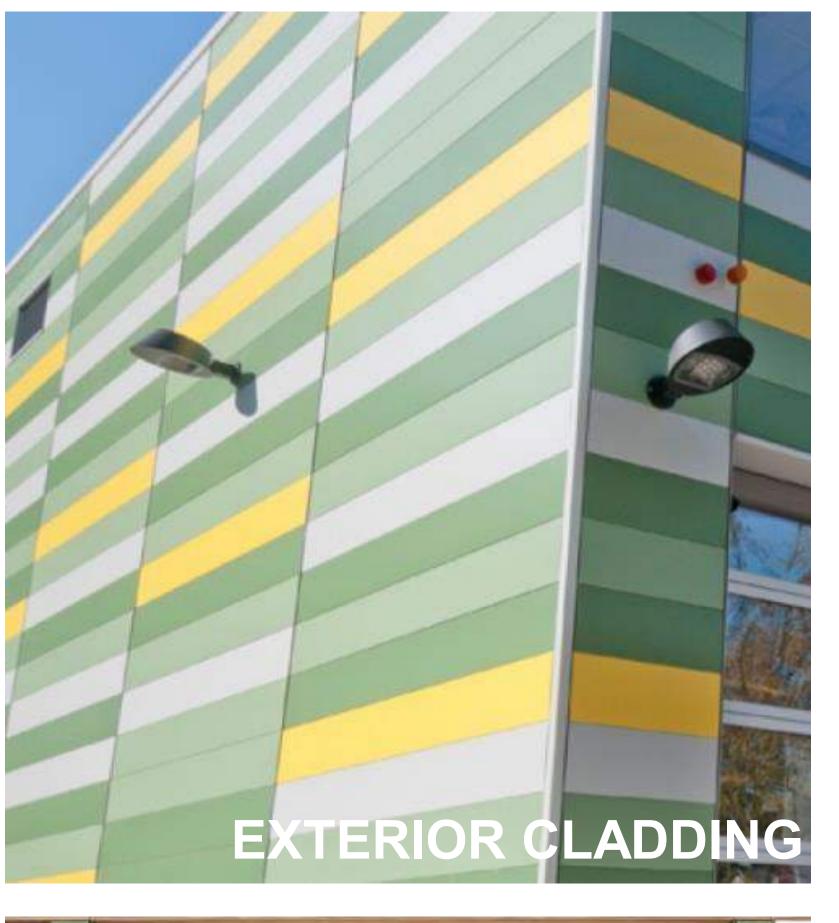

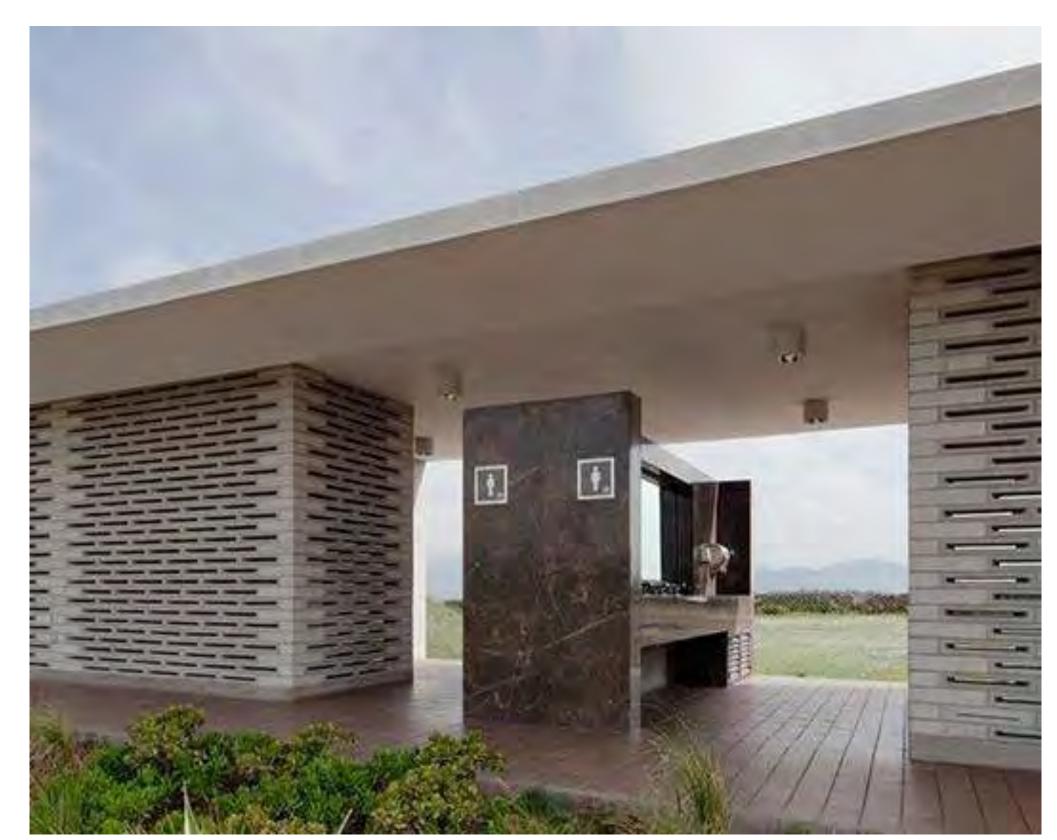

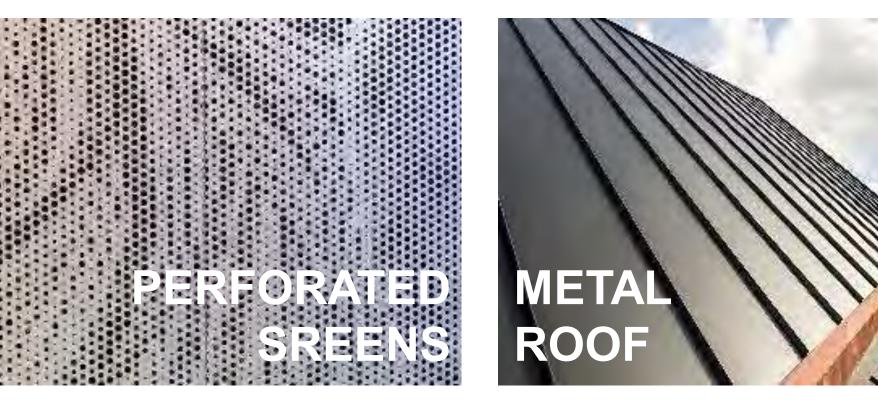







CITY OF SAN DIEGO PARK AND RECREATION DEPARTMENT

THE GENERAL DEVELOPMENT PLAN


ROBB FIELD

COMMUNITY PARK

COUNCIL DISTRICT NO. 2 COMM. PLAN AREA: MISSION PARK PSD

LAMBERT COORDINATES: 215-1695 THOMAS BROTHERS PAGE: PG. 59-B3 SUPPLEMENTAL SHEET NO.: 11 OF 24



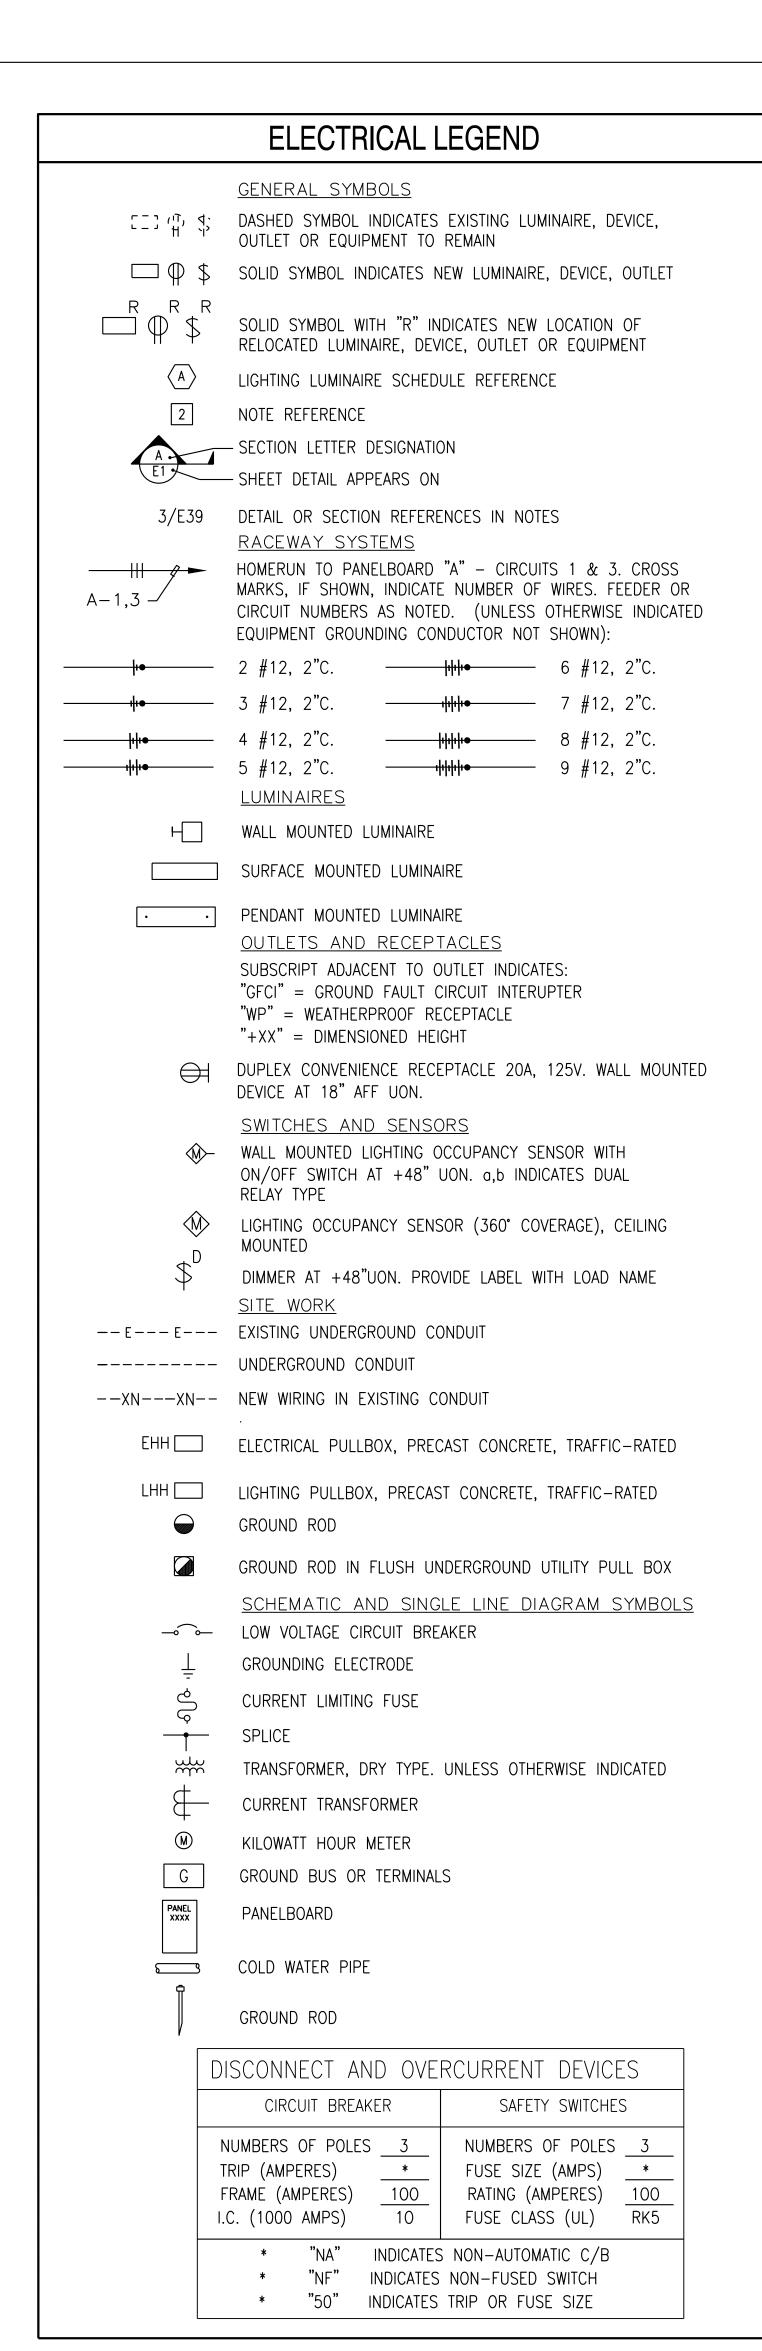

ELECTRICAL ABBREVIATIONS  ADDREW  DESCRIPTION  DESCRIPTION					
ABBREV	DESCRIPTION	ABBREV	DESCRIPTION		
А	AMPERE	LHH	LIGHTING HANDHOLE		
AC	ALTERNATING CURRENT	LTG	LIGHTING		
AF	AMP FRAME	MAX	MAXIMUM		
AFF	ABOVE FINISHED FLOOR	MIN	MINIMUM		
AT	AMP TRIP	MOCP	MAXIMUM OVERCURRENT PROTECTION		
AWG	AMERICAN WIRE GAUGE	MTS	MANUAL RECOGNIZED TESTING LABORATORY		
ВС	BARE COPPER CONDUCTER	NRTL	NATIONALLY RECOGNIZED TESTING LABORATORY		
С	CONDUIT	NTS	NOT TO SCALE		
CEC	CALIFORNIA ELECTRICAL CODE	Р	POLE		
C.O.	CONDUIT ONLY	PVC	POLYVINYL CHLORIDE		
CONC	CONCRETE	SCH	SCHEDULE		
CU	COPPER	SDG&E	SAN DIEGO GAS & ELECTRIC COMPANY		
(E)	EXISTING TO REMAIN	SEC	SECONDARY		
ЕНН	ELECTRIC METALLIC TUBING	THHN	THERMOPLASTIC HIGH HEAT RESISTANT NYLON COATED WIRE		
EMT	ELECTRIC METALLIC TUBING	THWN	THERMOPLASTIC HIGH WATER RESISTANT NYLON COATED WIRE		
G	GROUND OR GENERATOR	TRANSF	TRANSFORMER		
GALV	GALVANIZED	TYP	TYPICAL		
GND	GROUNDED	UG	UNDERGROUND		
JB	JUNCTION BOX	UON	UNLESS OTHERWISE NOTED		
KCM	1000 CIRCULAR MILS	V	VOLT		
KVA	KILOVOLT AMPERER	VA	VOLTAMPERE		
KVAR	KILOVOT AMPERES, REACTIVE	WM	WATTMETER		
KW	KILOWATT	WP	WEATHERPROOF		
KWH	KILOWATT HOUR	XFMR	TRANSFORMER		
L	LOAD				

BBREV	DESCRIPTION	ABBREV	DESCRIPTION
Α	AMPERE	LHH	LIGHTING HANDHOLE
AC	ALTERNATING CURRENT	LTG	LIGHTING
AF	AMP FRAME	MAX	MAXIMUM
AFF	ABOVE FINISHED FLOOR	MIN	MINIMUM
AT	AMP TRIP	MOCP	MAXIMUM OVERCURRENT PROTECTION
AWG	AMERICAN WIRE GAUGE	MTS	MANUAL RECOGNIZED TESTING LABORATORY
BC	BARE COPPER CONDUCTER	NRTL	NATIONALLY RECOGNIZED TESTING LABORATORY
С	CONDUIT	NTS	NOT TO SCALE
CEC	CALIFORNIA ELECTRICAL CODE	Р	POLE
C.O.	CONDUIT ONLY	PVC	POLYVINYL CHLORIDE
CONC	CONCRETE	SCH	SCHEDULE
CU	COPPER	SDG&E	SAN DIEGO GAS & ELECTRIC COMPANY
(E)	EXISTING TO REMAIN	SEC	SECONDARY
ЕНН	ELECTRIC METALLIC TUBING	THHN	THERMOPLASTIC HIGH HEAT RESISTANT NYLON COATED WIRE
EMT	ELECTRIC METALLIC TUBING	THWN	THERMOPLASTIC HIGH WATER RESISTAN' NYLON COATED WIRE
G	GROUND OR GENERATOR	TRANSF	TRANSFORMER
GALV	GALVANIZED	TYP	TYPICAL
GND	GROUNDED	UG	UNDERGROUND
JB	JUNCTION BOX	UON	UNLESS OTHERWISE NOTED
KCM	1000 CIRCULAR MILS	V	VOLT
KVA	KILOVOLT AMPERER	VA	VOLTAMPERE
KVAR	KILOVOT AMPERES, REACTIVE	WM	WATTMETER
KW	KILOWATT	WP	WEATHERPROOF
KWH	KILOWATT HOUR	XFMR	TRANSFORMER
L	LOAD		

## **ELECTRICAL GENERAL NOTES** THE FOLLOWING GENERAL NOTES APPLY TO ALL ELECTRICAL DRAWINGS.

- INSTALLATION OF ELECTRICAL MATERIAL MUST CONFORM WITH LOCAL REGULATIONS AND THE 2022 CALIFORNIA ELECTRICAL CODE (CEC), PUBLIC WORKS 2021 GREEN BOOK AND WHITE BOOK, WHITE BOOK AND OTHER GOVERNING CODES AND ORDINANCES.
- ALL ELECTRICAL EQUIPMENT MUST BE NRTL LABELED.
- THE CONTRACTOR MUST VISIT THE SITE INCLUDING ALL AREAS INDICATED ON THE DRAWINGS. THEY MUST THOROUGHLY FAMILIARIZE THEMSELVES WITH THE EXISTING CONDITIONS AND BY SUBMITTING A BID ACCEPTS CONDITIONS UNDER WHICH THEY WILL BE REQUIRED TO PERFORM THEIR WORK.
- IT WILL BE THE ELECTRICAL CONTRACTOR'S RESPONSIBILITY TO OBTAIN A COMPLETE SET OF DRAWINGS AND SPECIFICATIONS. THEY MUST CHECK THE DRAWINGS OF THE OTHER TRADES AND WILL CAREFULLY READ THE ENTIRE SPECIFICATIONS AND DETERMINE THEIR RESPONSIBILITIES. FAILURE TO DO SO WILL NOT RELEASE THE CONTRACTOR FROM DOING THE WORK IN COMPLETE ACCORDANCE WITH THE DRAWINGS AND SPECIFICATIONS.
- THE CONTRACTOR MUST COORDINATE THEIR WORK WITH OTHER TRADES AT THE SITE. ANY COST TO ROUTE CONDUIT OTHER THAN AS SHOWN ON THE PLANS SHALL BE INCURRED BY THE CONTRACTOR.
- WHEREVER A DISCREPANCY IN QUANTITY OR SIZE OF CONDUIT, WIRE, EQUIPMENT DEVICES, CIRCUIT BREAKERS, TRANSFORMERS, GROUND FAULT PROTECTION SYSTEM, ETC. (ALL MATERIALS) ARISES ON THE DRAWINGS AND/OR SPECIFICATIONS, THE CONTRACTOR WILL BE RESPONSIBLE FOR PROVIDING AND INSTALLING ALL MATERIAL AND SERVICES REQUIRED BY THE STRICTEST CONDITIONS NOTED ON DRAWINGS AND/OR IN THE SPECIFICATIONS TO ENSURE COMPLETE AND OPERABLE SYSTEMS TO THE SATISFACTION OF THE RESIDENT
- ALL CONDUIT SIZES ARE BASED ON COPPER CONDUCTORS WITH THHN/THWN-2 INSULATION UNLESS OTHERWISE NOTED. ALL CONDUCTORS SHALL BE COPPER #12 AWG MINIMUM SIZE, TYPE THHN/THWN-2 THERMOPLASTIC, 600 VOLT, 75 DEGREES CELSIUS WET AND 90 DEGREES CELSIUS DRY AND UL LISTED UNLESS NOTED OTHERWISE. CONDUCTORS #12 AWG AND LARGER SHALL BE STRANDED.
- MINIMUM CONDUIT SIZE FOR ALL UNDERGROUND INSTALLATION SHALL BE 2" UNLESS OTHERWISE NOTED.
- . PROVIDE PROPERLY SIZED LUGS AT ALL CIRCUIT BREAKER PANELS, FOR THE CONDUCTORS SHOWN TO CONNECT TO THESE LUGS.
- INSTALL ALL EXTERIOR MOUNTED ELECTRICAL EQUIPMENT IN WEATHERPROOF, NEMA 3R ENCLOSURES.
- SEPARATE INSULATED EQUIPMENT GROUNDING CONDUCTOR, SIZED PER CEC TABLE 250.122. SHALL BE PROVIDED, INSTALLED IN THE SAME CONDUIT AS THE CIRCUIT CONDUCTORS. FOR ALL FEEDER AND BRANCH CIRCUITS.
- 3. THE SEISMIC BRACING AND ANCHORAGE OF ELECTRICAL CONDUITS, BUS DUCT, WIREWAY AND CABLE TRAY SHALL BE IN ACCORDANCE WITH THE "GUIDELINE FOR SEISMIC RESTRAINTS OF MECHANICAL SYSTEMS AND PLUMBING PIPING SYSTEMS", PUBLISHED BY SMACNA AND PPIC.
- 4. ALL ELECTRICAL EQUIPMENT MUST BE BRACED OR ANCHORED TO RESIST A HORIZONTAL FORCE ACTING IN ANY DIRECTION USING THE FOLLOWING CRITERIA:

FIXED EQUIPMENT ON GRADE 20% OF OPERATING WEIGHT FIXED EQUIPMENT ON STRUCTURE 30% OF OPERATING WEIGHT EMERGENCY POWER & COMMUNICATION 50% OF OPERATING WEIGHT EQUIPMENT ON GRADE EMERGENCY POWER & COMMUNICATION EQUIPMENT ON STRUCTURE 75% OF OPERATING WEIGHT

FOR FLEXIBLY MOUNTED EQUIPMENT USED FOUR (4) TIMES THE ABOVE VALUES, AND FOR SIMULTANEOUS VERTICAL FORCE USE ONE-THIRD (1/3) TIMES THE HORIZONTAL FORCE. WHERE ANCHORAGE DETAILS ARE NOT SHOWN ON THE DRAWINGS THE FIELD INSTALLATION WILL BE SUBJECT TO THE APPROVAL OF THE CITY RESIDENT ENGINEER. WHERE ANCHORAGE IS INDICATED ON THE CONTRACT DOCUMENTS REVIEWED BY RESIDENT ENGINEER, ANCHORAGE SHALL BE AS PER THE CONTRACT DOCUMENTS.

ALL ELECTRICAL MATERIALS AND EQUIPMENT MUST BE NEW AND MUST BE LISTED BY UNDERWRITER'S LABORATORIES (UL) AND BEAR THEIR LABEL, OR LISTED AND CERTIFIED BY A NATIONALLY RECOGNIZED TESTING AUTHORITY WHERE UL DOES NOT HAVE A LISTING. CUSTOM MADE EQUIPMENT MUST HAVE COMPLETE TEST DATA SUBMITTED BY THE MANUFACTURER ATTESTING TO ITS SAFETY. IN ADDITION, THE MATERIALS, EQUIPMENT, AND INSTALLATION MUST COMPLY WITH THE REQUIREMENTS OF THE FOLLOWING:

AMERICAN SOCIETY OF TESTING MATERIALS (ASTM) INSULATED POWER CABLE ENGINEERS ASSOCIATION (IPCEA) NATIONAL ELECTRICAL MANUFACTURERS ASSOCIATION (NEMA) AMERICAN STANDARD ASSOCIATION (ASSA) NATIONAL FIRE PROTECTION AGENCY (NFPA) AMERICAN NATIONAL STANDARD INSTITUTE (ANSI) CALIFORNIA ELECTRICAL CODE (CEC) CALIFORNIA CODE OF REGULATIONS TITLE 24 (CCR) INSTITUTE OF ELECTRICAL AND ELECTRONIC ENGINEERS (IEEE) ALL LOCAL CODES HAVING JURISDICTION

WHERE THE CODES HAVE DIFFERENT LEVELS OF REQUIREMENTS, THE MOST STRINGENT RULE WILL APPLY.

- AFTER ALL REQUIREMENTS OF THE SPECIFICATIONS AND/OR THE DRAWINGS HAVE BEEN FULLY COMPLETED. REPRESENTATIVES OF THE CITY/RESIDENT ENGINEER WILL INSPECT THE WORK. THE CONTRACTOR MUST PROVIDE COMPETENT PERSONNEL TO DEMONSTRATE THE OPERATION OF ANY ITEM OR SYSTEM TO THE FULL SATISFACTION OF EACH REPRESENTATIVE. FINAL ACCEPTANCE OF THE WORK WILL BE MADE BY THE RESIDENT ENGINEER AFTER RECEIPT OF APPROVAL AND RECOMMENDATION OF ACCEPTANCE FROM EACH CITY REPRESENTATIVE.
- EXACT METHOD AND LOCATION OF CONDUIT PENETRATION AND OPENINGS IN CONCRETE WALLS OR FLOORS OR STRUCTURAL STEEL MEMBERS MUST BE AS DIRECTED BY THE STRUCTURAL ENGINEER. PERFORM CORING. SAWCUTTING. PATCHING. AND REFINISHING OF EXISTING WALLS AND SURFACES WHEREVER IT IS NECESSARY TO PENETRATE. OPENINGS MUST BE SEALED IN AN APPROVED METHOD TO MATCH EXISTING SEALED CONDITION OF THE PARTICULAR WALL, FLOOR. EXACT METHOD AND LOCATIONS OF CONDUIT PENETRATIONS AND OPENINGS IN CONCRETE WALLS OR FLOORS SHALL BE UL APPROVED.
- STRAIGHT FEEDER. BRANCH CIRCUIT. AND CONDUIT RUNS MUST BE PROVIDED WITH SUFFICIENT PULL BOXES OR JUNCTION BOXES TO LIMIT THE MAXIMUM LENGTH OF ANY SINGLE CABLE PULL TO 100 FEET. PULL BOXES SHALL BE SIZED PER CODE OR AS INDICATED ON DRAWINGS. LOCATIONS MUST BE DETERMINED IN THE FIELD OR AS INDICATED ON THE DRAWINGS.

## **ELECTRICAL GENERAL NOTES**

- 19. DRAWINGS ARE DIAGRAMMATIC ONLY. ROUTING OF RACEWAYS MUST BE AT THE OPTION OF THE CONTRACTOR UNLESS OTHERWISE NOTED AND MUST BE COORDINATED WITH OTHER SECTIONS. DO NOT SCALE THE ELECTRICAL DRAWINGS FOR LOCATIONS OF ANY ELECTRICAL ARCHITECTURAL, STRUCTURAL, CIVIL, OR MECHANICAL ITEMS OR FEATURES.
- 20. BX AND MC CABLES MUST NOT BE USED AND ARE NOT ACCEPTABLE.
- 121. SHARING OF NEUTRAL WIRES AND USE OF MULTIWIRE BRANCH CIRCUIT ARE PROHIBITED. ONE NEUTRAL CONDUCTOR MUST BE PROVIDED FOR EVERY NEW NON-MULTIWIRE CIRCUIT.
- 22. ALL RACEWAYS MUST INCLUDE A FULL SIZE GREEN INSULATED EQUIPMENT GROUND WIRE TERMINATED AT EACH OUTLET BOX, DEVICE ENCLOSURE, ETC. AND CONNECTED BACK AT THE PANEL, SWITCHBOARD, OR CABINET ON THE APPROPRIATE GROUND BUS.
- 23. FLAT WIRING MUST NOT BE USED.
- 124. PROVIDE WIRE MARKER ON EACH CONDUCTOR IN ELECTRICAL PANEL, PULL BOX, POLE MOUNTED LUMINAIRE, HANDHOLE, OUTLET, AND JUNCTION BOX, IF MORE THAN ONE NEUTRAL IS PRESENT, MARK EACH RELATED CIRCUIT AND PANEL NUMBER.
- 25. CONTRACTOR TO PROVIDE ALL TITLE 24 ACCEPTANCE TEST AND FORMS TO COMPLY WITH TITLE 24.
- 26. ALL WIRING INSIDE THE BUILDING WILL BE IN EMT CONDUIT.
- 27. ALL EMT CONNECTOR, COUPLING, AND OTHER FITTINGS WILL BE NON-CAST STEEL COMPRESSION TYPE.
- 128. FLEXIBLE STEEL CONDUIT IS ALLOWED ONLY ON MOTOR CONNECTION AND FIXTURE TAILS, AND NOT OVER 6 FEET IN LENGTH.
- 29. ANY EXPOSE WIRING DEVICE BOX WILL BE IN CAST IRON ONLY. NO CAST ALUMINUM.
- \$\begin{align\*} \] 30. ANY EXPOSED LIGHT FIXTURE JUNCTION BOX WILL BE CAST IRON ONLY. NO CAST ALUMINUM.
- 31. JUNCTION BOX SIZES WILL BE AT LEAST 4" SQUARE BY 1-1/8" DEEP.
- 32. ALL EXISTING SPORTS LIGHTING AND ASSOCIATED WIRING/CONTROLS IS OUT OF SCOPE, IS TO REMAIN IN PLACE AND OPERATIONAL UNLESS OTHERWISE NOTED.

PRELIMINARY LIGHTING AND ELECTRICAL PLANS

CITY OF SAN DIEGO PARK AND RECREATION DEPARTMENT

THE GENERAL DEVELOPMENT PLAN

ROBB FIELD

COMMUNITY PARK

COUNCIL DISTRICT NO. 2 COMM. PLAN AREA: MISSION PARK THOMAS BROTHERS PAGE: PG. 59-B3 SUPPLEMENTAL SHEET NO.: 12 OF 24

LAMBERT COORDINATES: 215-1695

BSE PROJECT NO. 21-0017-1016

BSE ENGINEERING, INC.

9903 BUSINESSPARK AVE, SUITE #104

OPTION	CALLOUT	SYMBOL	LAMP	DESCRIPTION	MODEL	
OPTION 1	A1a	•—□	57W LED 4000K 7119 LUMENS	AREA AND SITE LUMINAIRE ARM MOUNTED WITH DIE-CAST ALUMINUM HOUSING AND HEAT SINK.	COOPER LIGHTING SOLUTIONS GALN-SA4D-840-U-T4W OR EQUAL	
OPTION 1	A1b	•—□	57W LED 4000K 7119 LUMENS	AREA AND SITE LUMINAIRE ARM MOUNTED WITH DIE-CAST ALUMINUM HOUSING AND HEAT SINK.	COOPER LIGHTING SOLUTIONS GALN-SA4D-840-U-T3R OR EQUAL	PARKIN LOT LIGHTIN
OPTION 2	A2	⊶□	50W LED 4000K 7000 LUMENS	LOW PROFILE LED AREA/SITE LUMINAIRE RATED FOR HIGH VIBRATION APPLICATIONS IN DIE-CAST HOUSEING.	BEACON PRODUCTS VP-3-160L-50-4K8 -4W-BC OR EQUAL	
OPTION 3	A3	<b>⊶</b> □	168W LED 4000K 8000 LUMENS	PARKING LOT/AREA LED LIGHT FIXTURE WITH LOW PROFILE HOUSEING.	NLS LIGHTING NV-2-T4-80L-7-40K OR EQUAL	
OPTION 4	A4	••	149W LED 4800K 17915 LUMENS	HEAVY DUTY CAST LED ROADWAY LUMINAIRE WITH POLUESTER POWDER COAT PAINT FINISH.	COOOPER LIGHTING SOLUTIONS LD-RL-T3-E06-E OR EQUAL	ROADW
OPTION 5	A5	•	90W LED 4800K 10998 LUMENS	LED AREA/SITE/ROADWAY LIGHT WITH POLYESTER POWDER COAT FINISH.	COOOPER LIGHTING SOLUTIONS VRDN-CO2-D-UNV-T3 OR EQUAL	
OPTION 6	A6	••	95W LED 4800K 12000 LUMENS	ROADWAY LUMINAIRE.	CREE LIGHTING XSPMD-D-HT-3ME-12L- 30K7-UL OR EQUAL	
OPTION 1	B1		(1) 80W LED 4000K 7800 LUMENS	LED WALKWAY LIGHT WITH ACRYLIC LENS WITH DIE-CAT ALUMINUM HOUSING.	AMERICAN ELECTRIC LIGHTING 245L-P303-40K-R3-AY OR EQUAL	WALKW
OPTION 2	B2		75W LED 4000K 8767 LUMENS	LUMNISCENT LED POLE LIGHT WITH CAST ALUMINUM HOUSING AND ASYMMETRICAL DISTRIBUTION.	HOLOPHANE LUMINAIR GSLF3-P40-40K-MVOLT -ASY-NPT OR EQUAL	LIGHTII
OPTION 3	B3		80W LED 4000K 9000 LUMENS	LED POLE LIGHT WITH LOW COPPER ALUMINUM ALLOY DIE-CASTING WITH ACRYLIC LENS.	KIM LIGHTING UR20-68L-80-4K8-3 OR EQUAL	
OPTION 1	C1		21W LED 4000K 2747 LUMENS	4FT LED SURFACE MOUNTED STRIP LIGHT.	META 4SNLED-LD5-26SL-UNV -L840-CD1-U OR EQUAL	
OPTION 2	C2		LED 3000K MIN. 2782 LUMENS			
OPTION 1	C3		25W LED 4000K 3111 LUMENS	4FT LED SURFACE MOUNTED STRIP LIGHT.	CORE RZL-NL-30L-8-40-D -UNV-STD OR EQUAL	CEILIN
OPTION 2	C4	0	25W LED 4000K 3094 LUMENS	10" VANDAL RESISTANT DOWNLIGHT.	SPITZER DF-10-25W-CC-BK	-
OPTION 1	C5	0	20W LED 4000K 2200 LUMENS	11" VANDAL RESISTANT DOWNLIGHT.	COOPER LIGHTING SOLUTIONS T-R-B-11-LD4-20W-40- CL-BK-UNV-ED-C1	
OPTION 1	M1	$\nabla \nabla \nabla$		SPORTS LIGHTING		1 +
		6				SPOR LIGHTI

1 LUMINAIRE SCHEDULE
NO SCALE



BATHROOM LIGHTING - FIXTURE TYPE C4



BATHROOM LIGHTING - FIXTURE TYPE C5



PARKING LOT LIGHTING - FIXTURE TYPE A1



PARKING LOT LIGHTING - FIXTURE TYPE A3 (ALTERNATE)




ROADWAY LIGHTING – FIXTURE TYPE A4




ROADWAY LIGHTING - FIXTURE TYPE A5 (ALTERNATE)

POLE OPTION



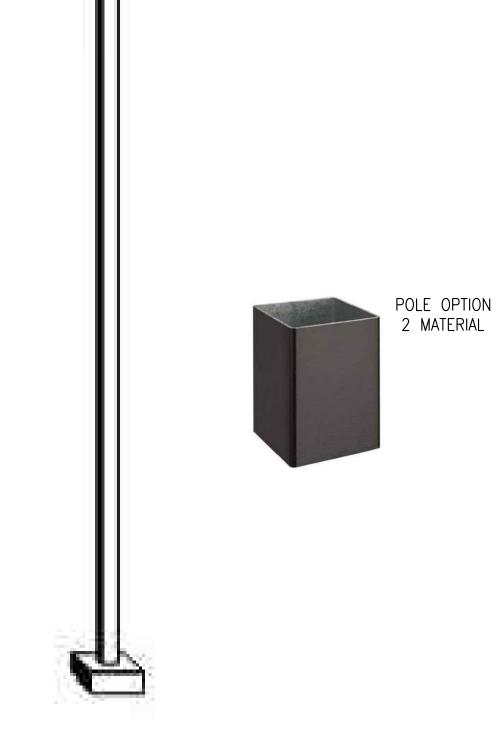

\*POLES WILL BE OF CONCRETE OR ALUMINUM MATERIAL

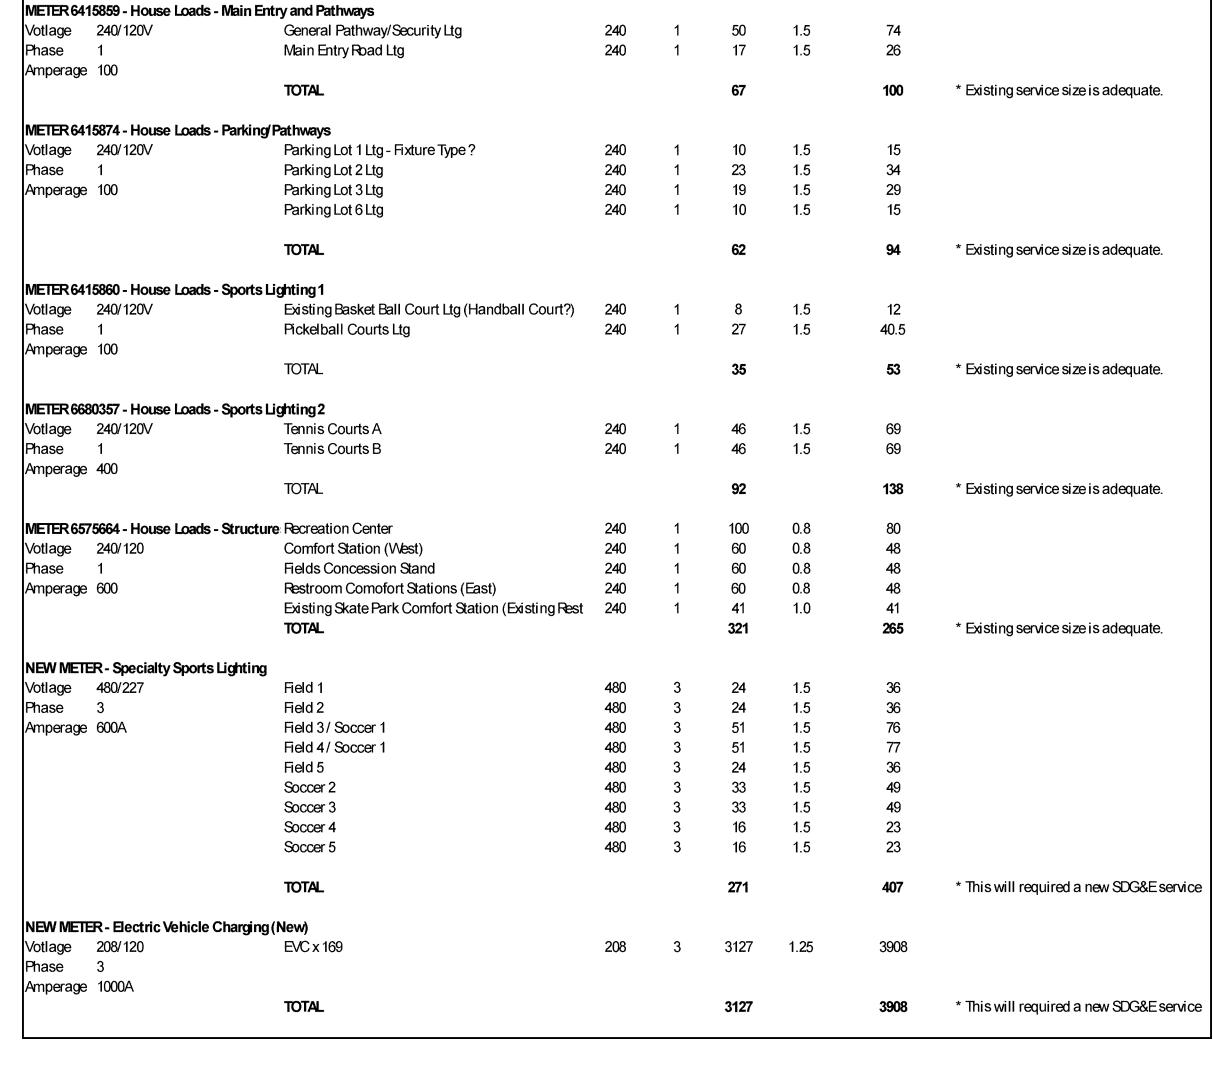

Voltage Phase Amps Diversity Amps w/ Diversity

# 2 LOAD SUMMARY NO SCALE



ROBB FIELD - ELECTRICAL LOAD SUMMARY

Proposed Load





WALKWAY LIGHTING — FIXTURE TYPE B2 (ALTERNATE)



WALKWAY LIGHTING — FIXTURE TYPE B3 (ALTERNATE)







CEILING LIGHTING - FIXTURE

TYPE C3 (ALTERNATE)



E CEILING LIGHTING - FIXTURE
TYPE C2
PRELIMINARY LIGHTING AND ELECTRICAL PLANS

CITY OF SAN DIEGO PARK AND RECREATION DEPARTMENT


THE GENERAL DEVELOPMENT PLAN


ROBB FIELD

COMMUNITY PARK

COMM. PLAN AREA: MISSION PARK COUNCIL DISTRICT NO. 2 THOMAS BROTHERS PAGE: PG. 59-B3 SUPPLEMENTAL SHEET NO.: 13 OF 24 LAMBERT COORDINATES: 215-1695



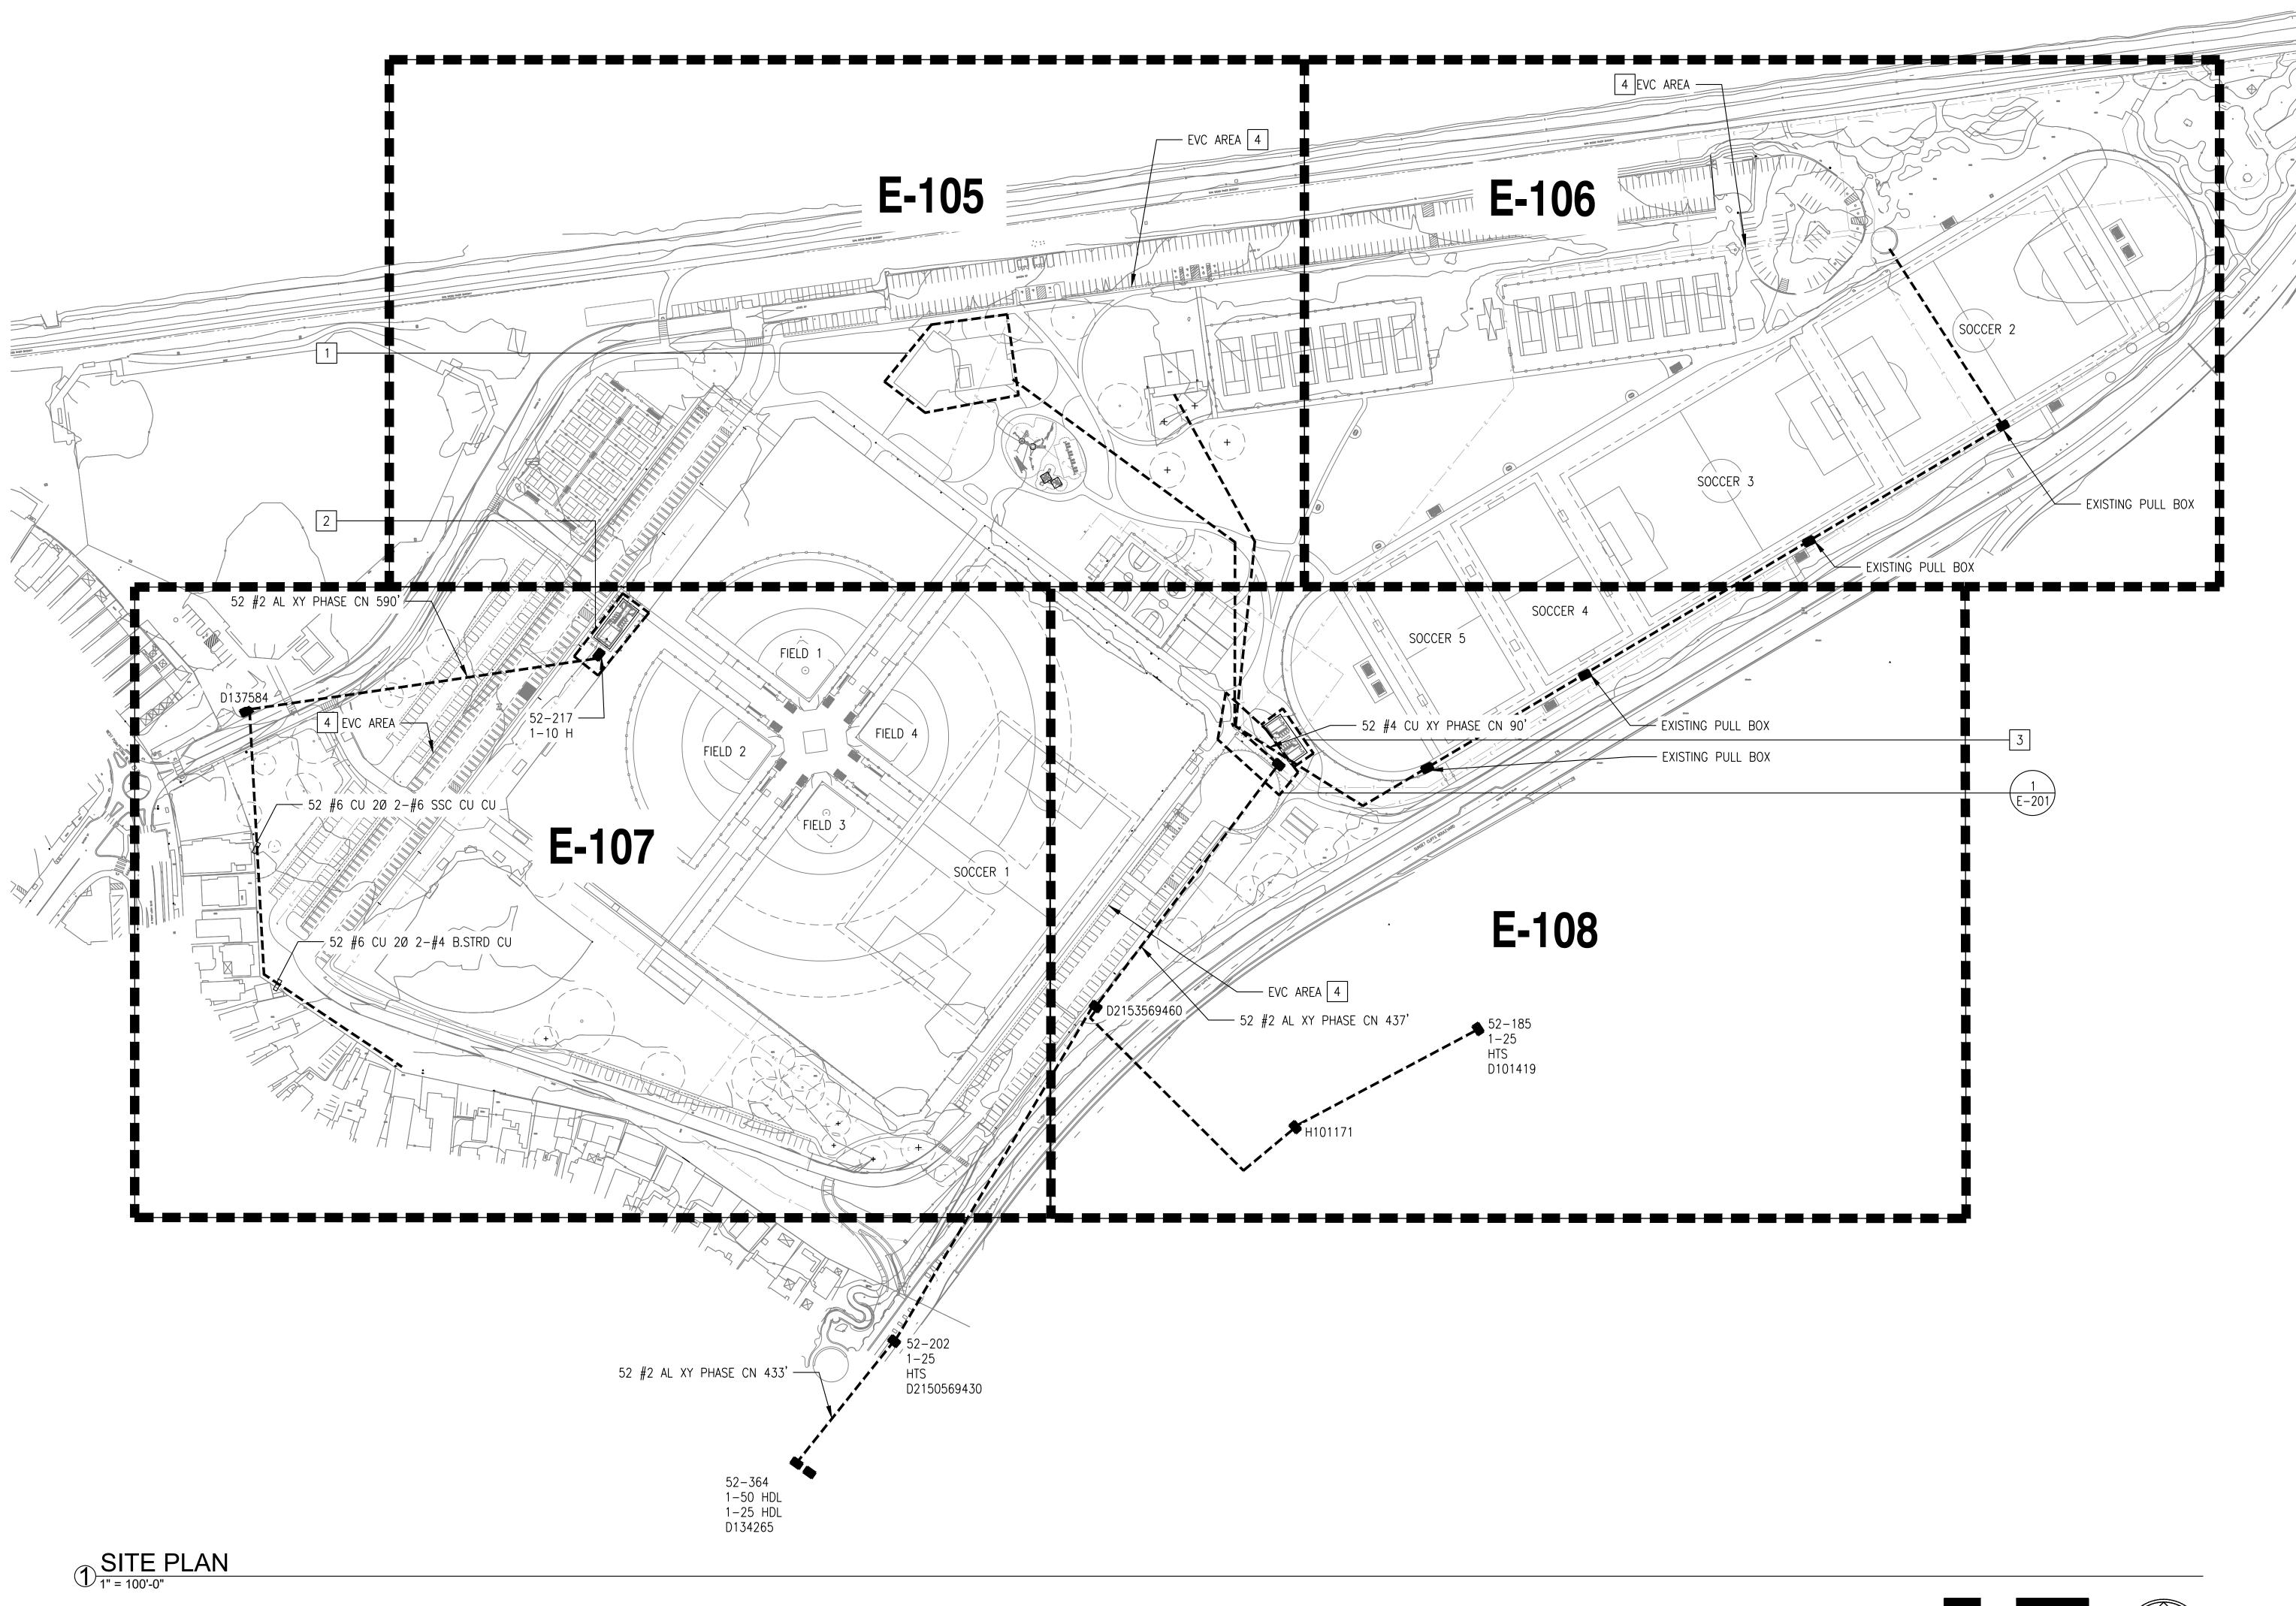

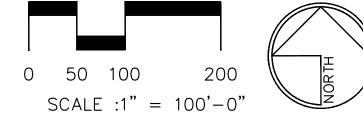

PRELIMINARY LIGHTING AND ELECTRICAL PLANS

THE GENERAL DEVELOPMENT PLAN

ROBB FIELD

CITY OF SAN DIEGO PARK AND RECREATION DEPARTMENT

**KEYNOTES**:

PROVIDE LIGHTING, LIGHT SWITCHES, MOTION SENSORS, AND GFCI DUPLEX RECEPTACLES WITHIN STRUCTURE. PROVIDE A MINIMUM OF 40 LIGHT FIXTURES, 15 LIGHT SWITCHES AND MOTION SENSORS, AND 30 GFCI DUPLEX RECEPTACLES.

PROVIDE LIGHTING, LIGHT SWITCHES, MOTION SENSORS, AND GFCI DUPLEX RECEPTACLES WITHIN STRUCTURE. PROVIDE A

MINIMUM OF 24 LIGHT FIXTURES, 4 LIGHT SWITCHES AND MOTION SENSORS, AND 10 GFCI DUPLEX RECEPTACLES.

PROVIDE LIGHTING, LIGHT SWITCHES, MOTION SENSORS, AND

GFCI DUPLEX RECEPTACLES WITHIN STRUCTURE. PROVIDE A

MINIMUM OF 20 LIGHT FIXTURES, 6 LIGHT SWITCHES AND MOTION SENSORS, AND 10 GFCI DUPLEX RECEPTACLES.

PROVIDE POWER TO 169 ELECTRIC VEHICLE CHARGING STATIONS (EVCS) ON SITE. EXACT QUANTITY OF EVCS PER


"AREA" TO BE DÉTERMINED.

COMMUNITY PARK

COUNCIL DISTRICT NO. 2 COMM. PLAN AREA: MISSION PARK PSD

LAMBERT COORDINATES: 215-1695 THOMAS BROTHERS PAGE: PG. 59-B3 SUPPLEMENTAL SHEET NO.: 14 OF 24



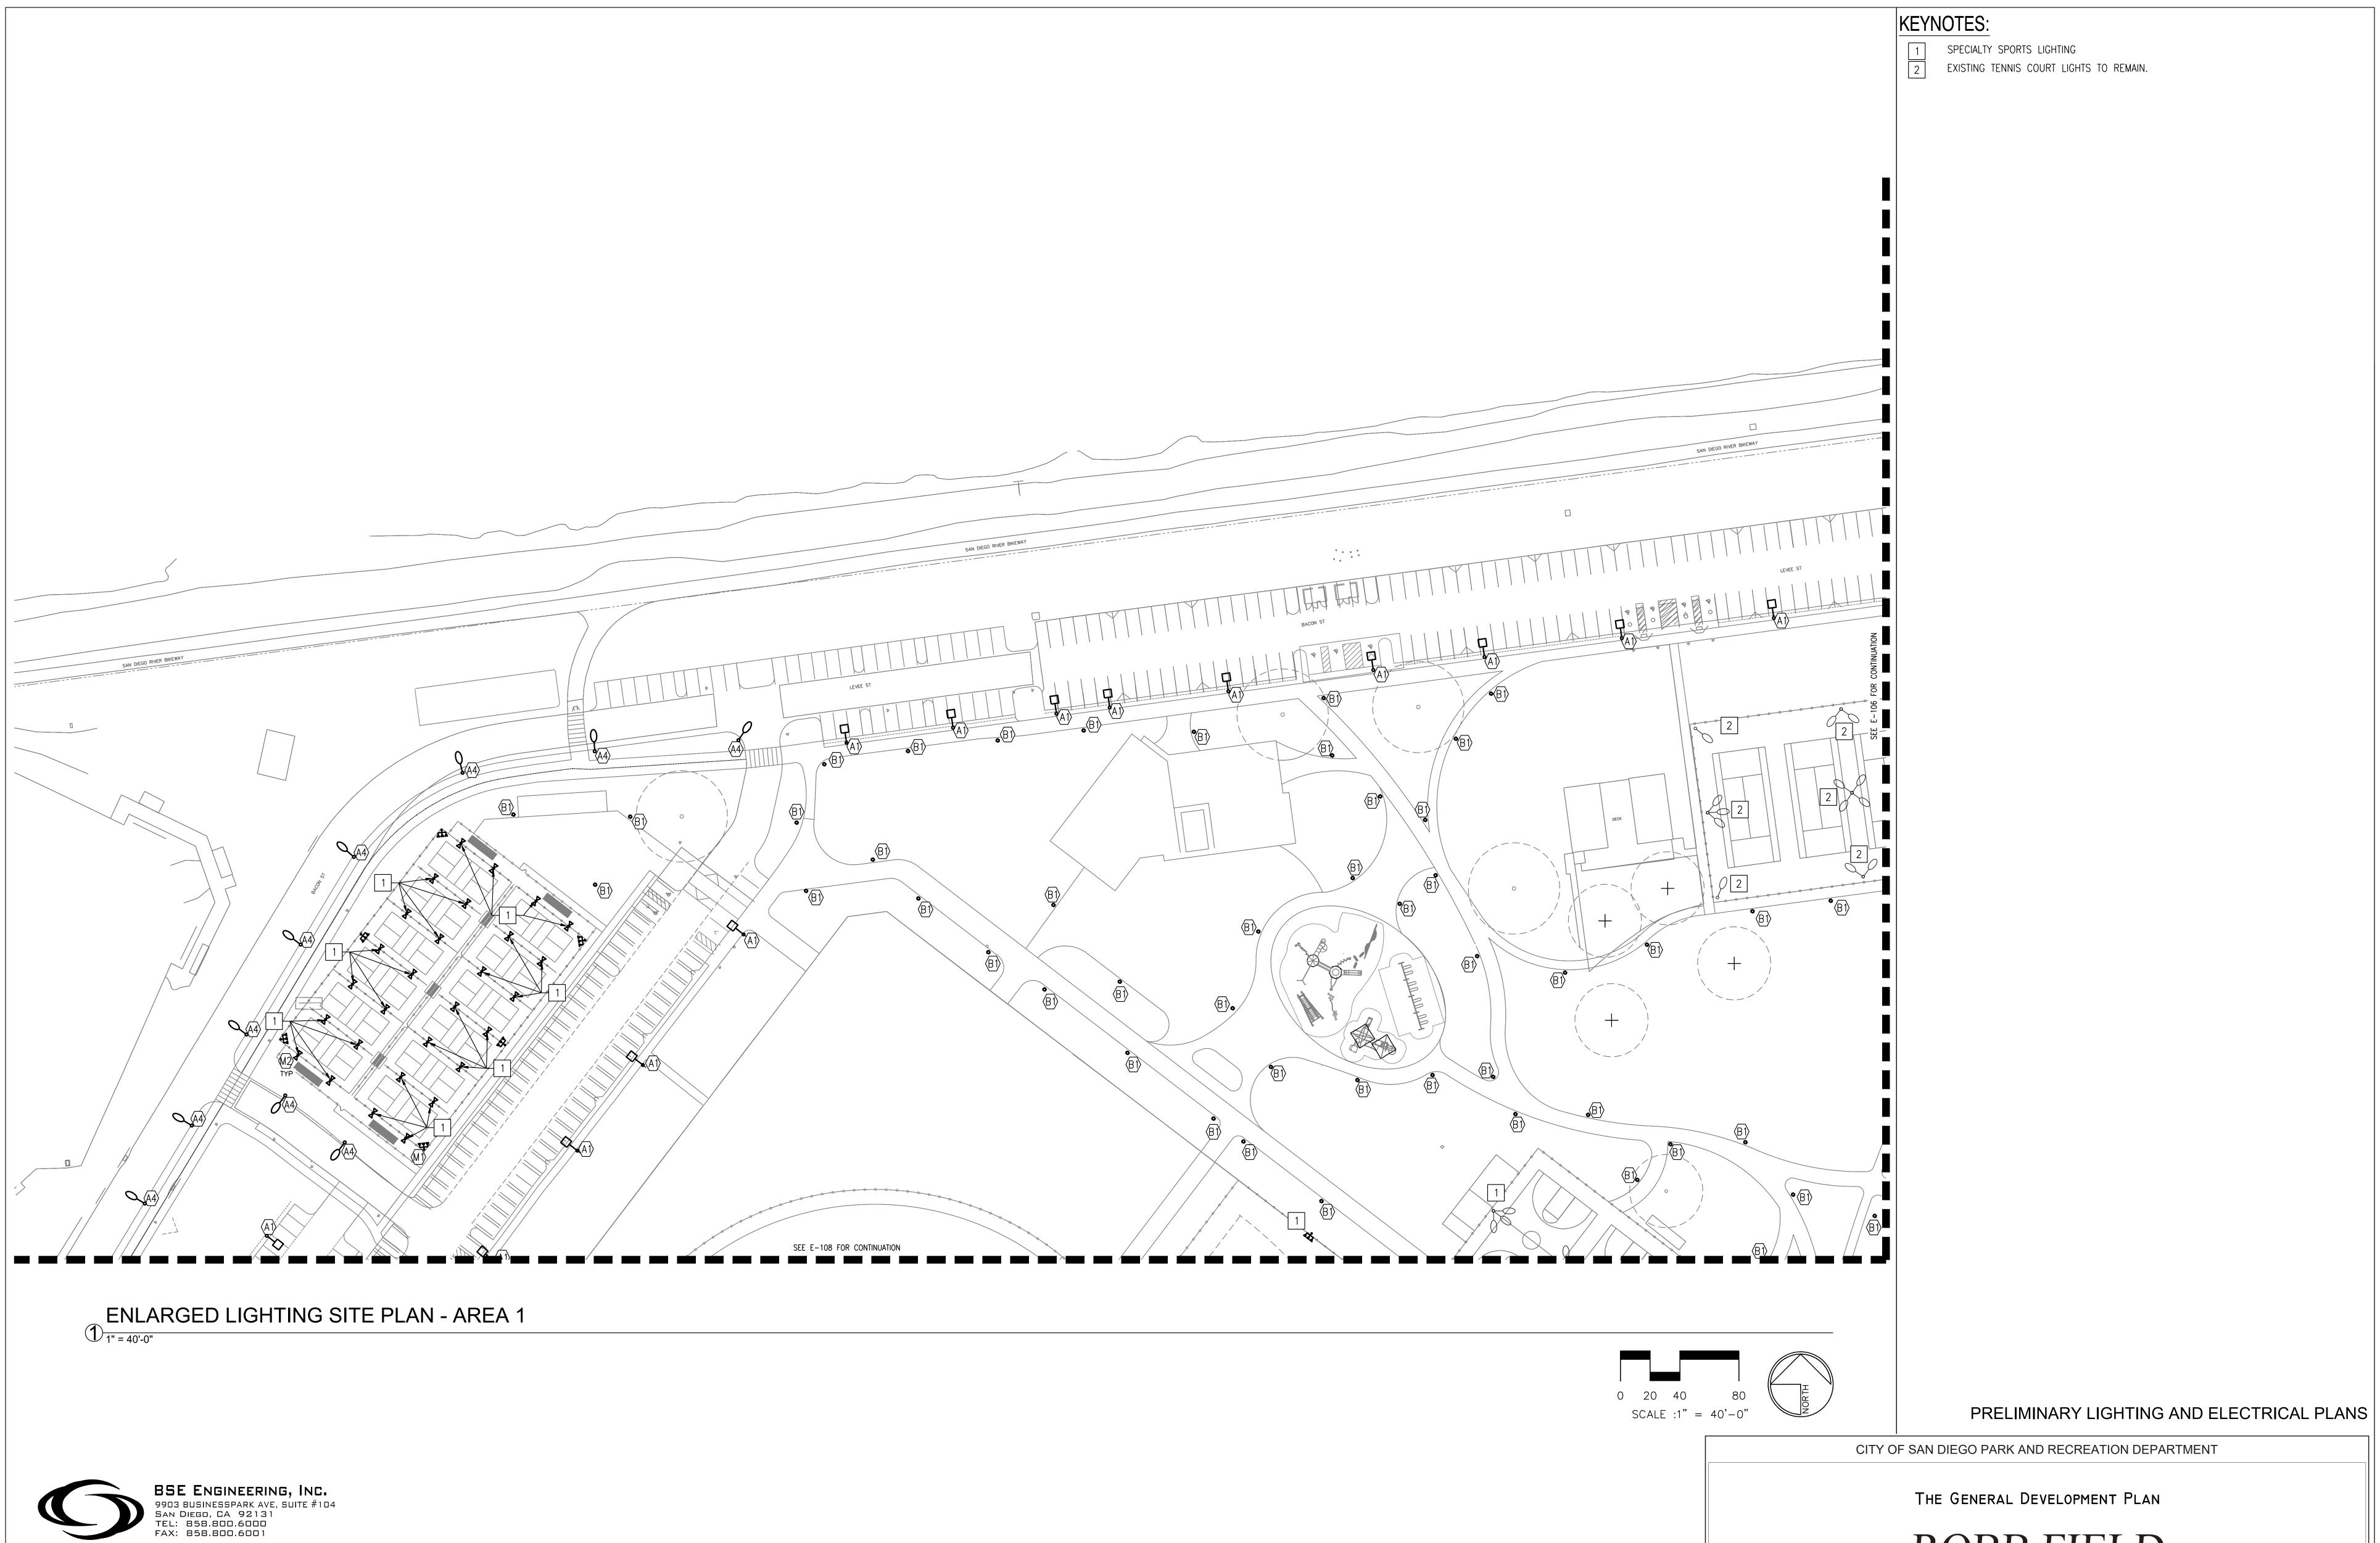

BSE PROJECT NO. 21-0017-1016

THE GENERAL DEVELOPMENT PLAN

ROBBFIELD

COMMUNITY PARK

COUNCIL DISTRICT NO. 2


COMM. PLAN AREA: MISSION PARK


PSD

LAMBERT COORDINATES: 215-1695

THOMAS BROTHERS PAGE: PG. 59-B3

SUPPLEMENTAL SHEET NO.: 15 OF 24

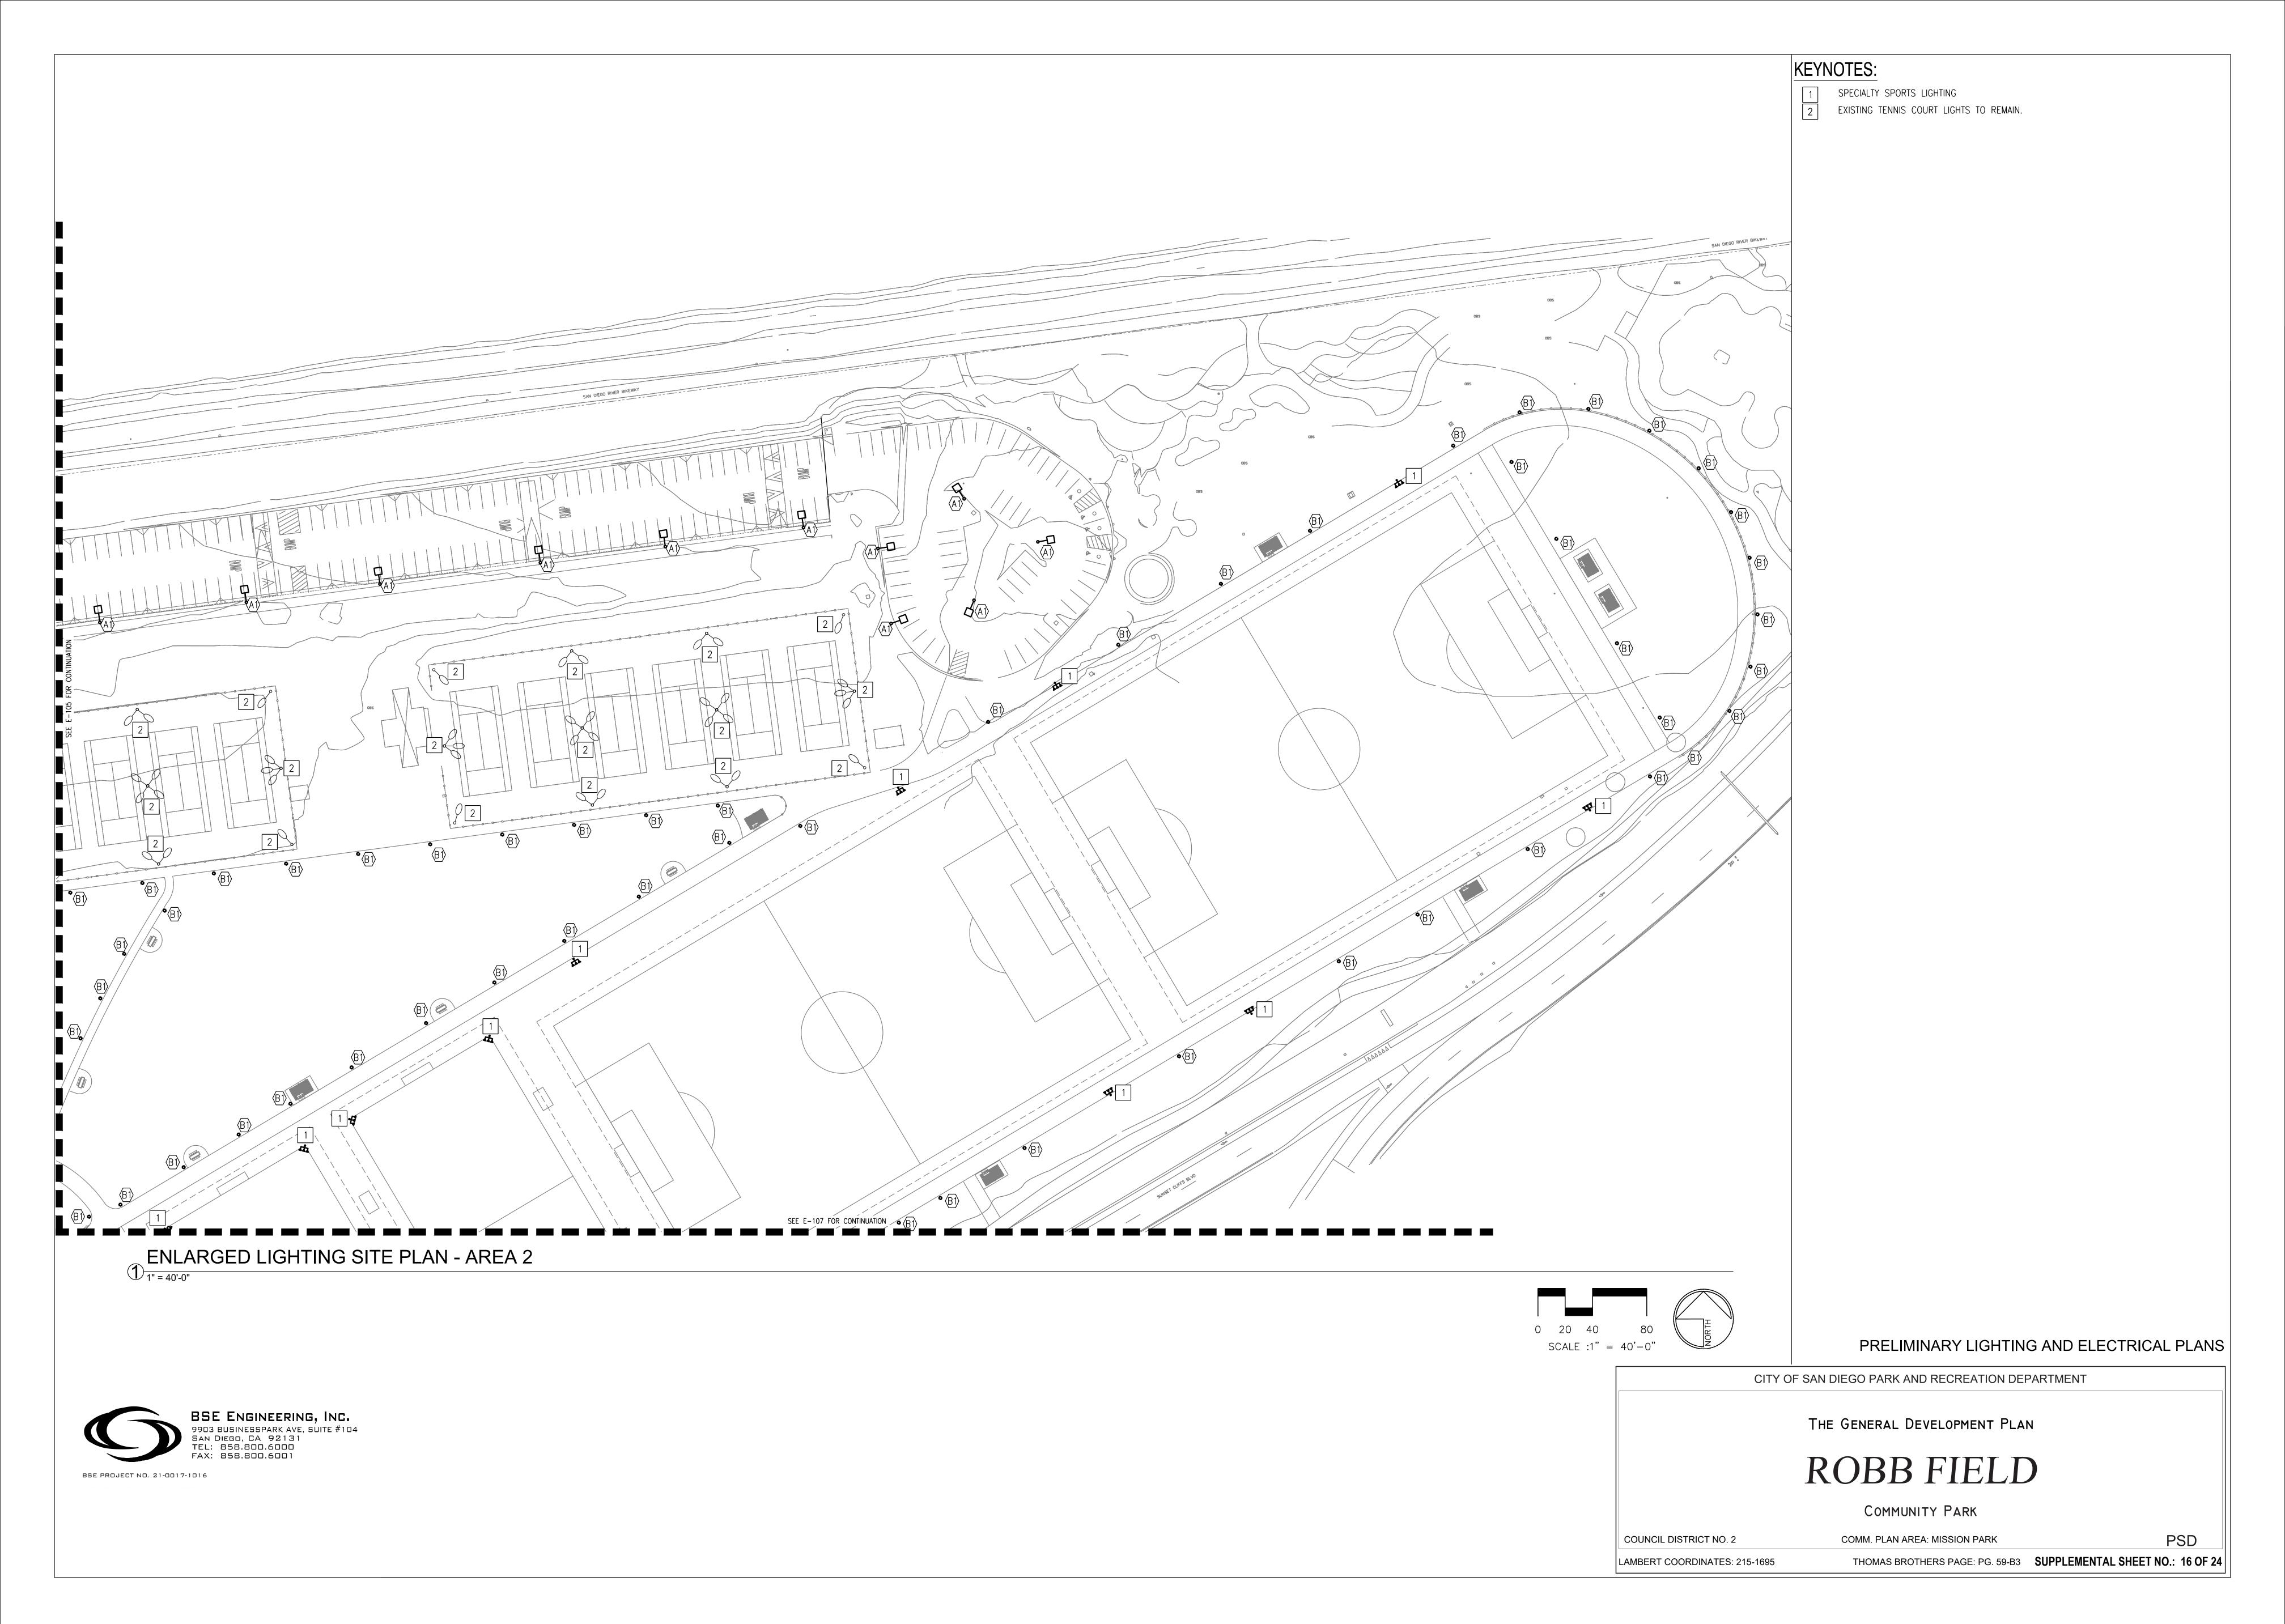

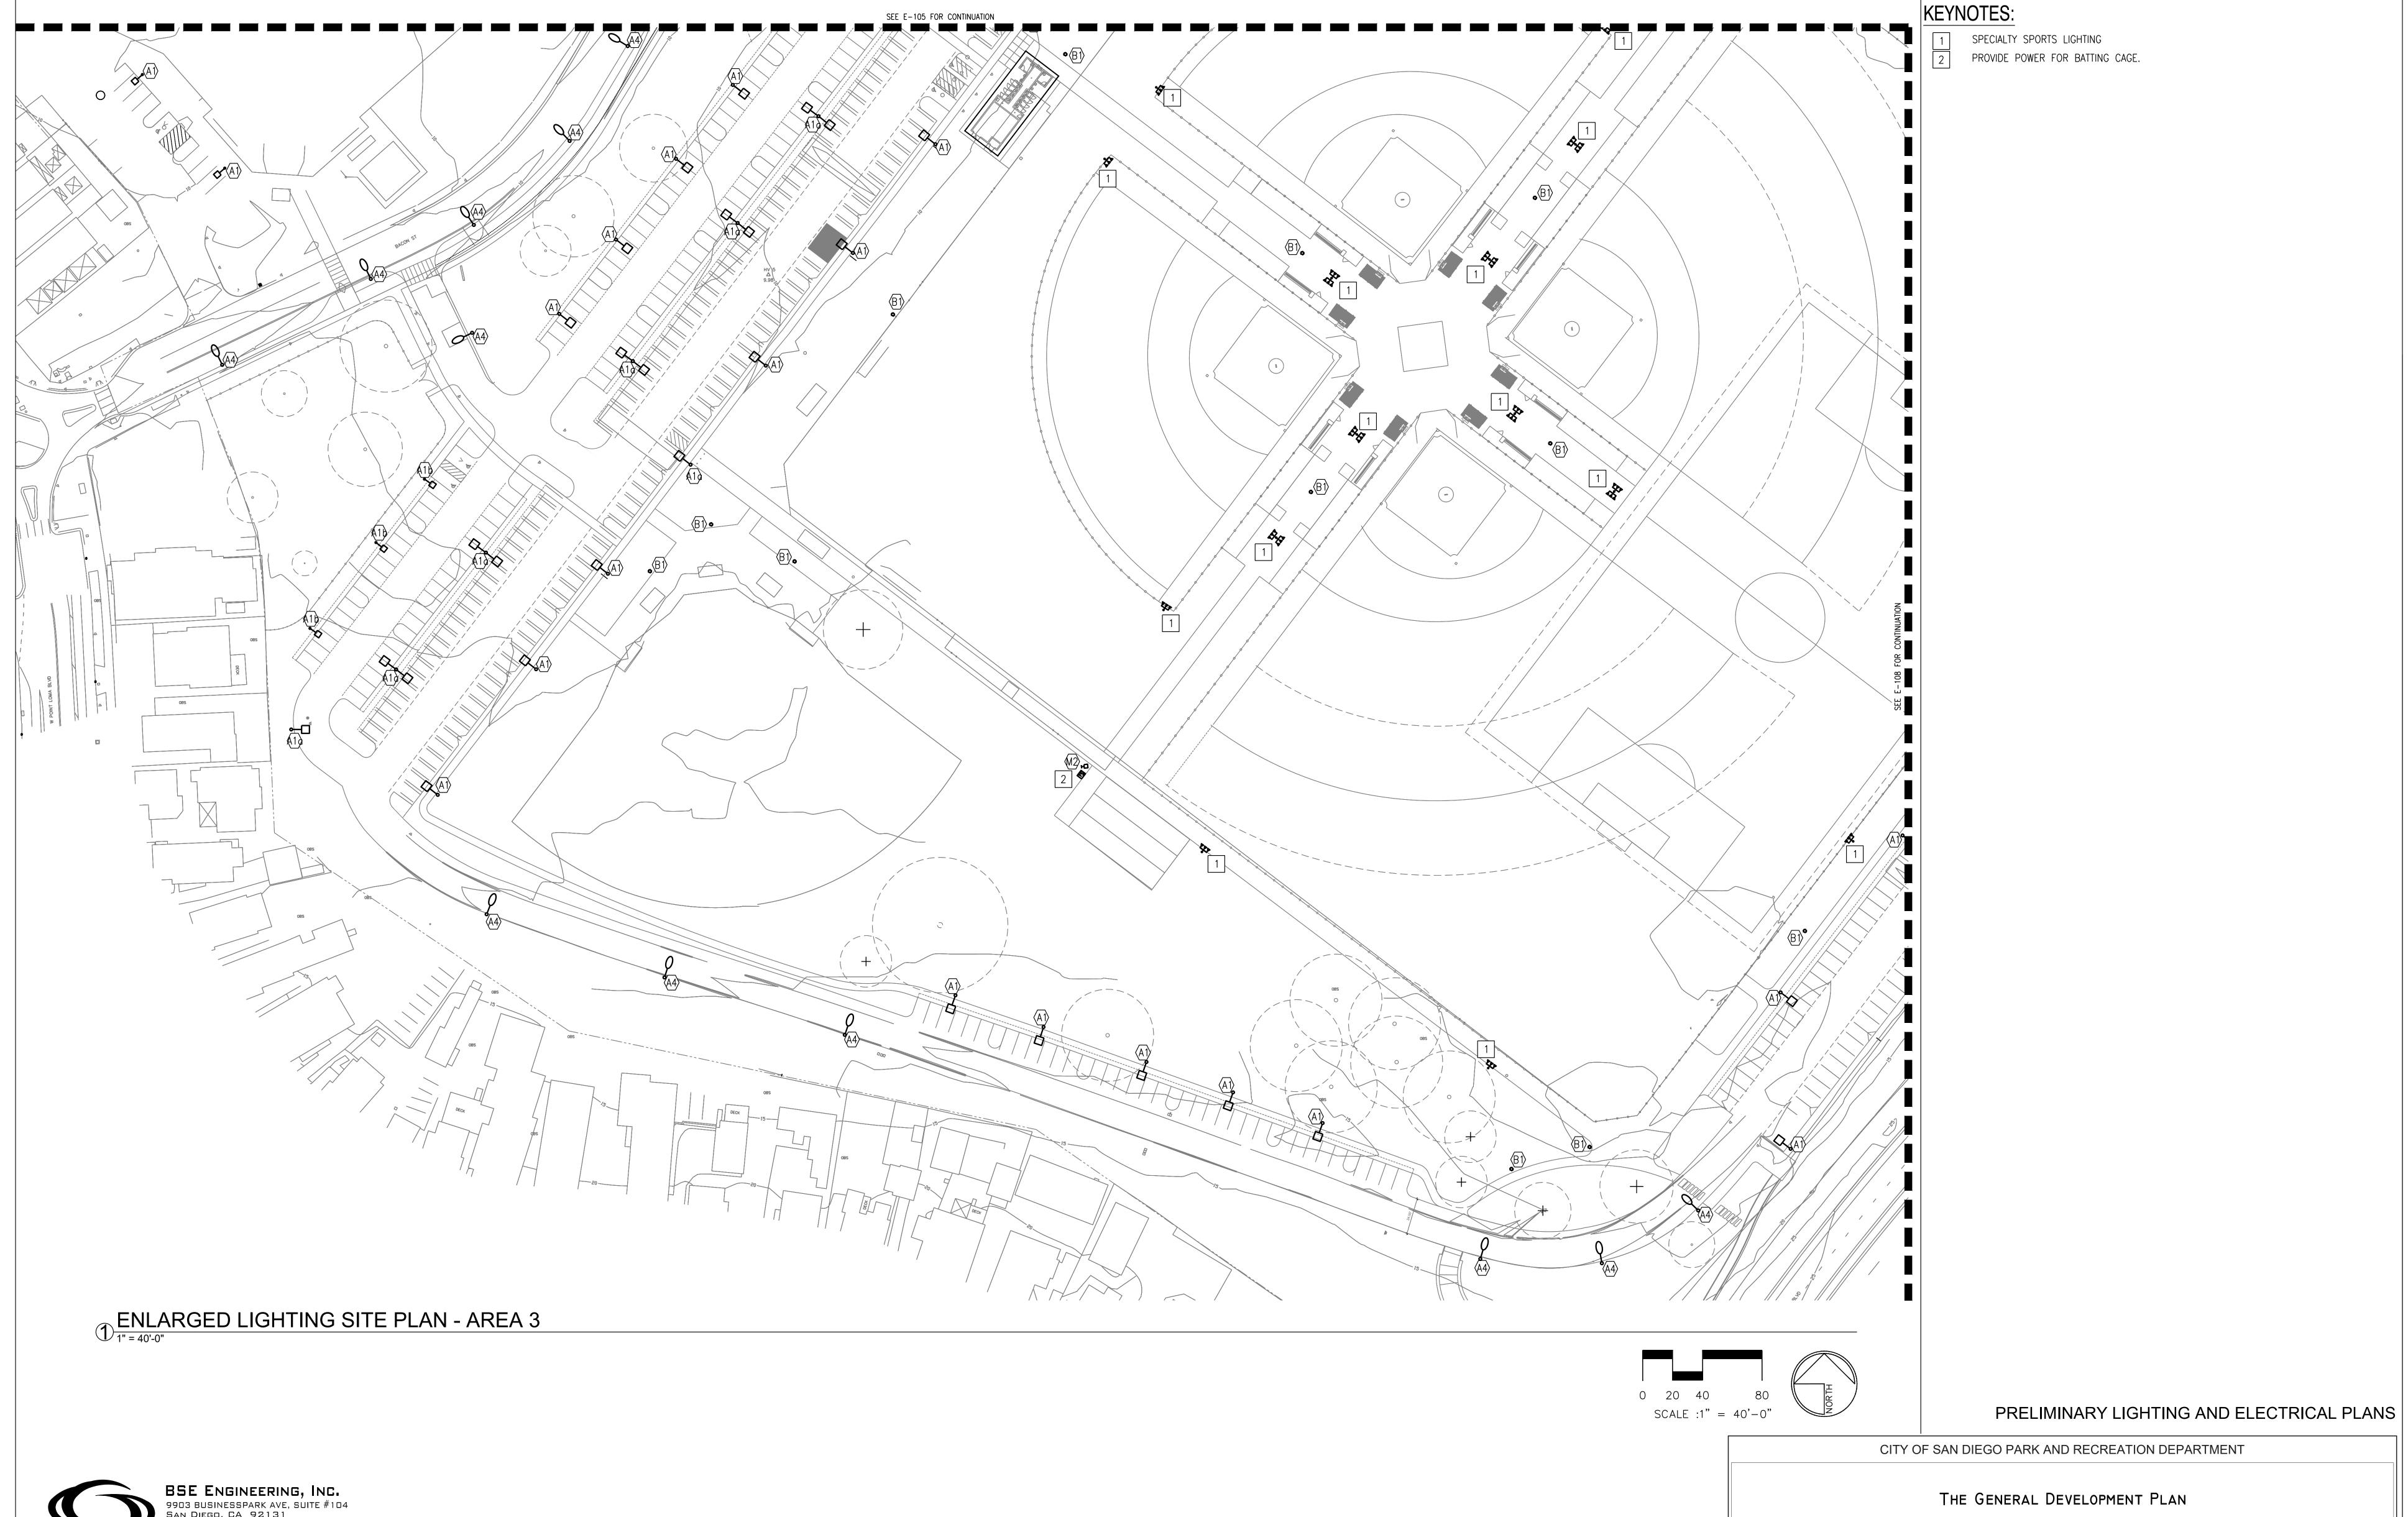



CITY OF SAN DIEGO PARK AND RECREATION DEPARTMENT

THE GENERAL DEVELOPMENT PLAN

ROBBFIELD

COMMUNITY PARK

COUNCIL DISTRICT NO. 2


COMM. PLAN AREA: MISSION PARK

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LAMBERT COORDINATES: 215-1695

THOMAS BROTHERS PAGE: PG. 59-B3

SUPPLEMENTAL SHEET NO.: 17 OF 24

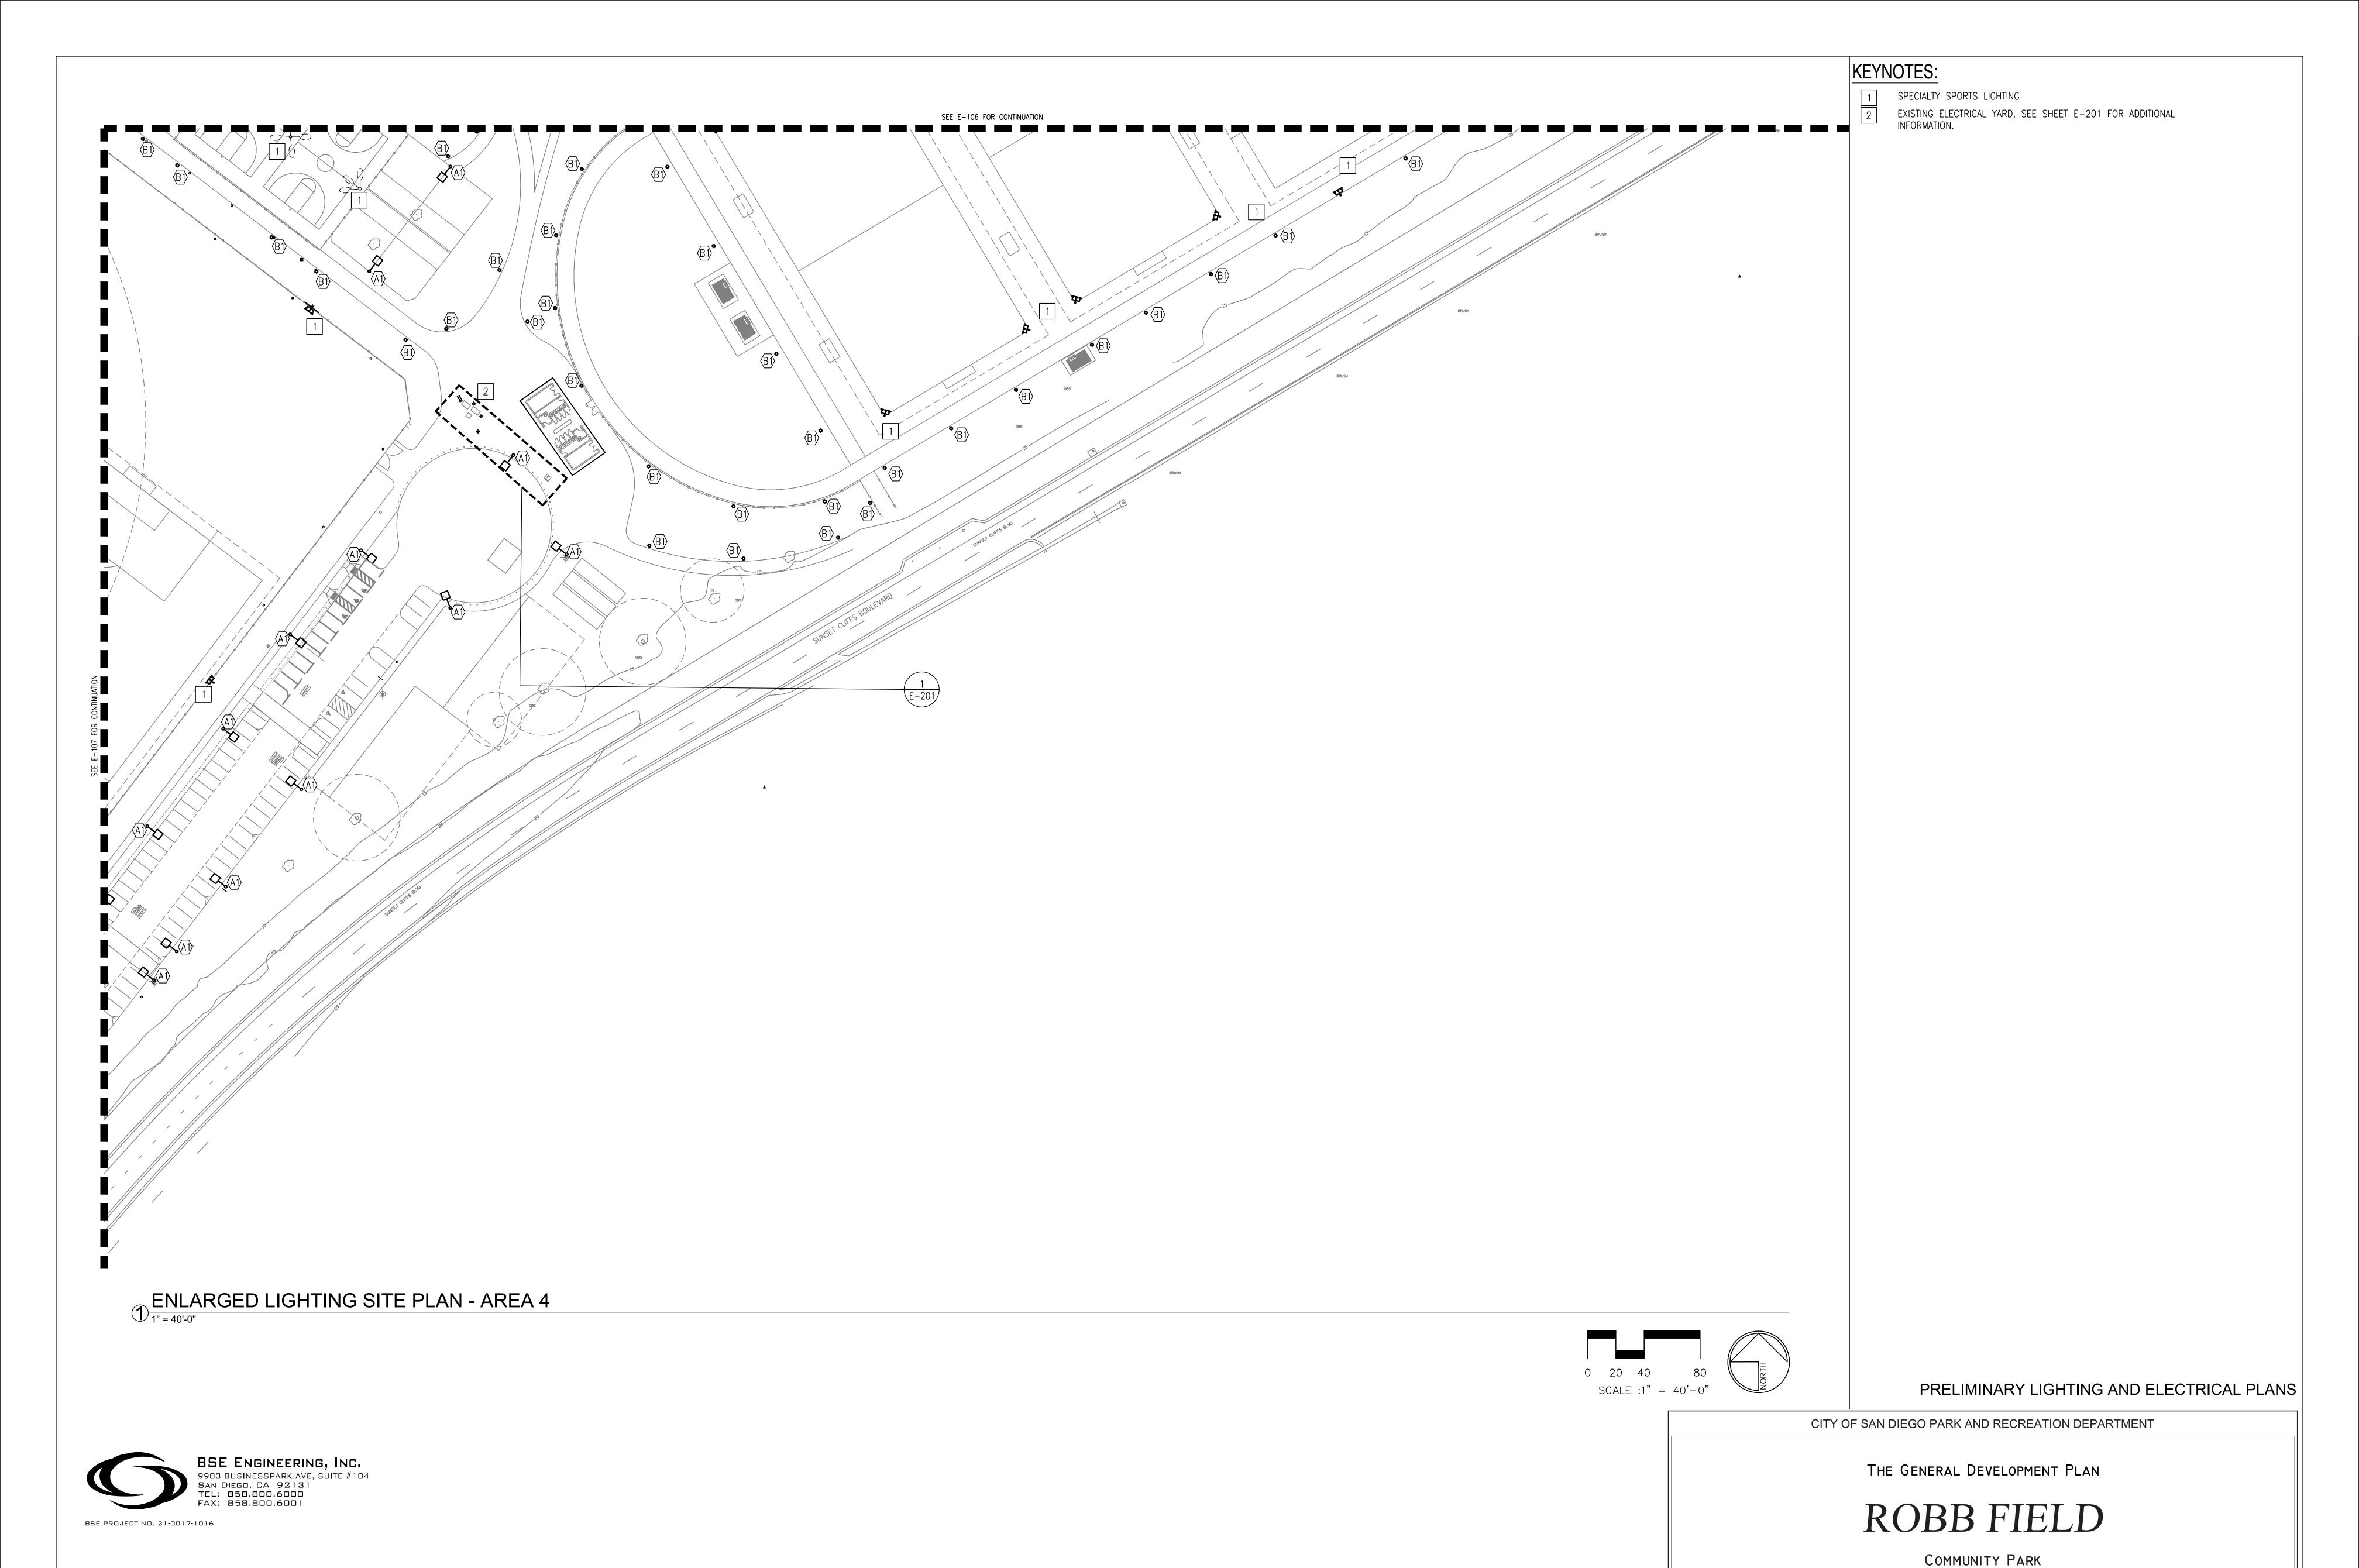


COUNCIL DISTRICT NO. 2


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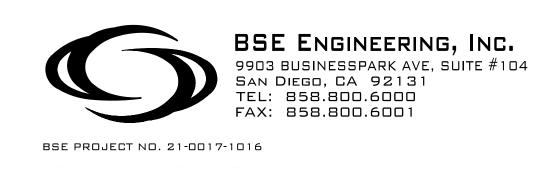
THOMAS BROTHERS PAGE: PG. 59-B3 SUPPLEMENTAL SHEET NO.: 18 OF 24



1 ENLARGED SITE PLAN - SWITCHBOARD

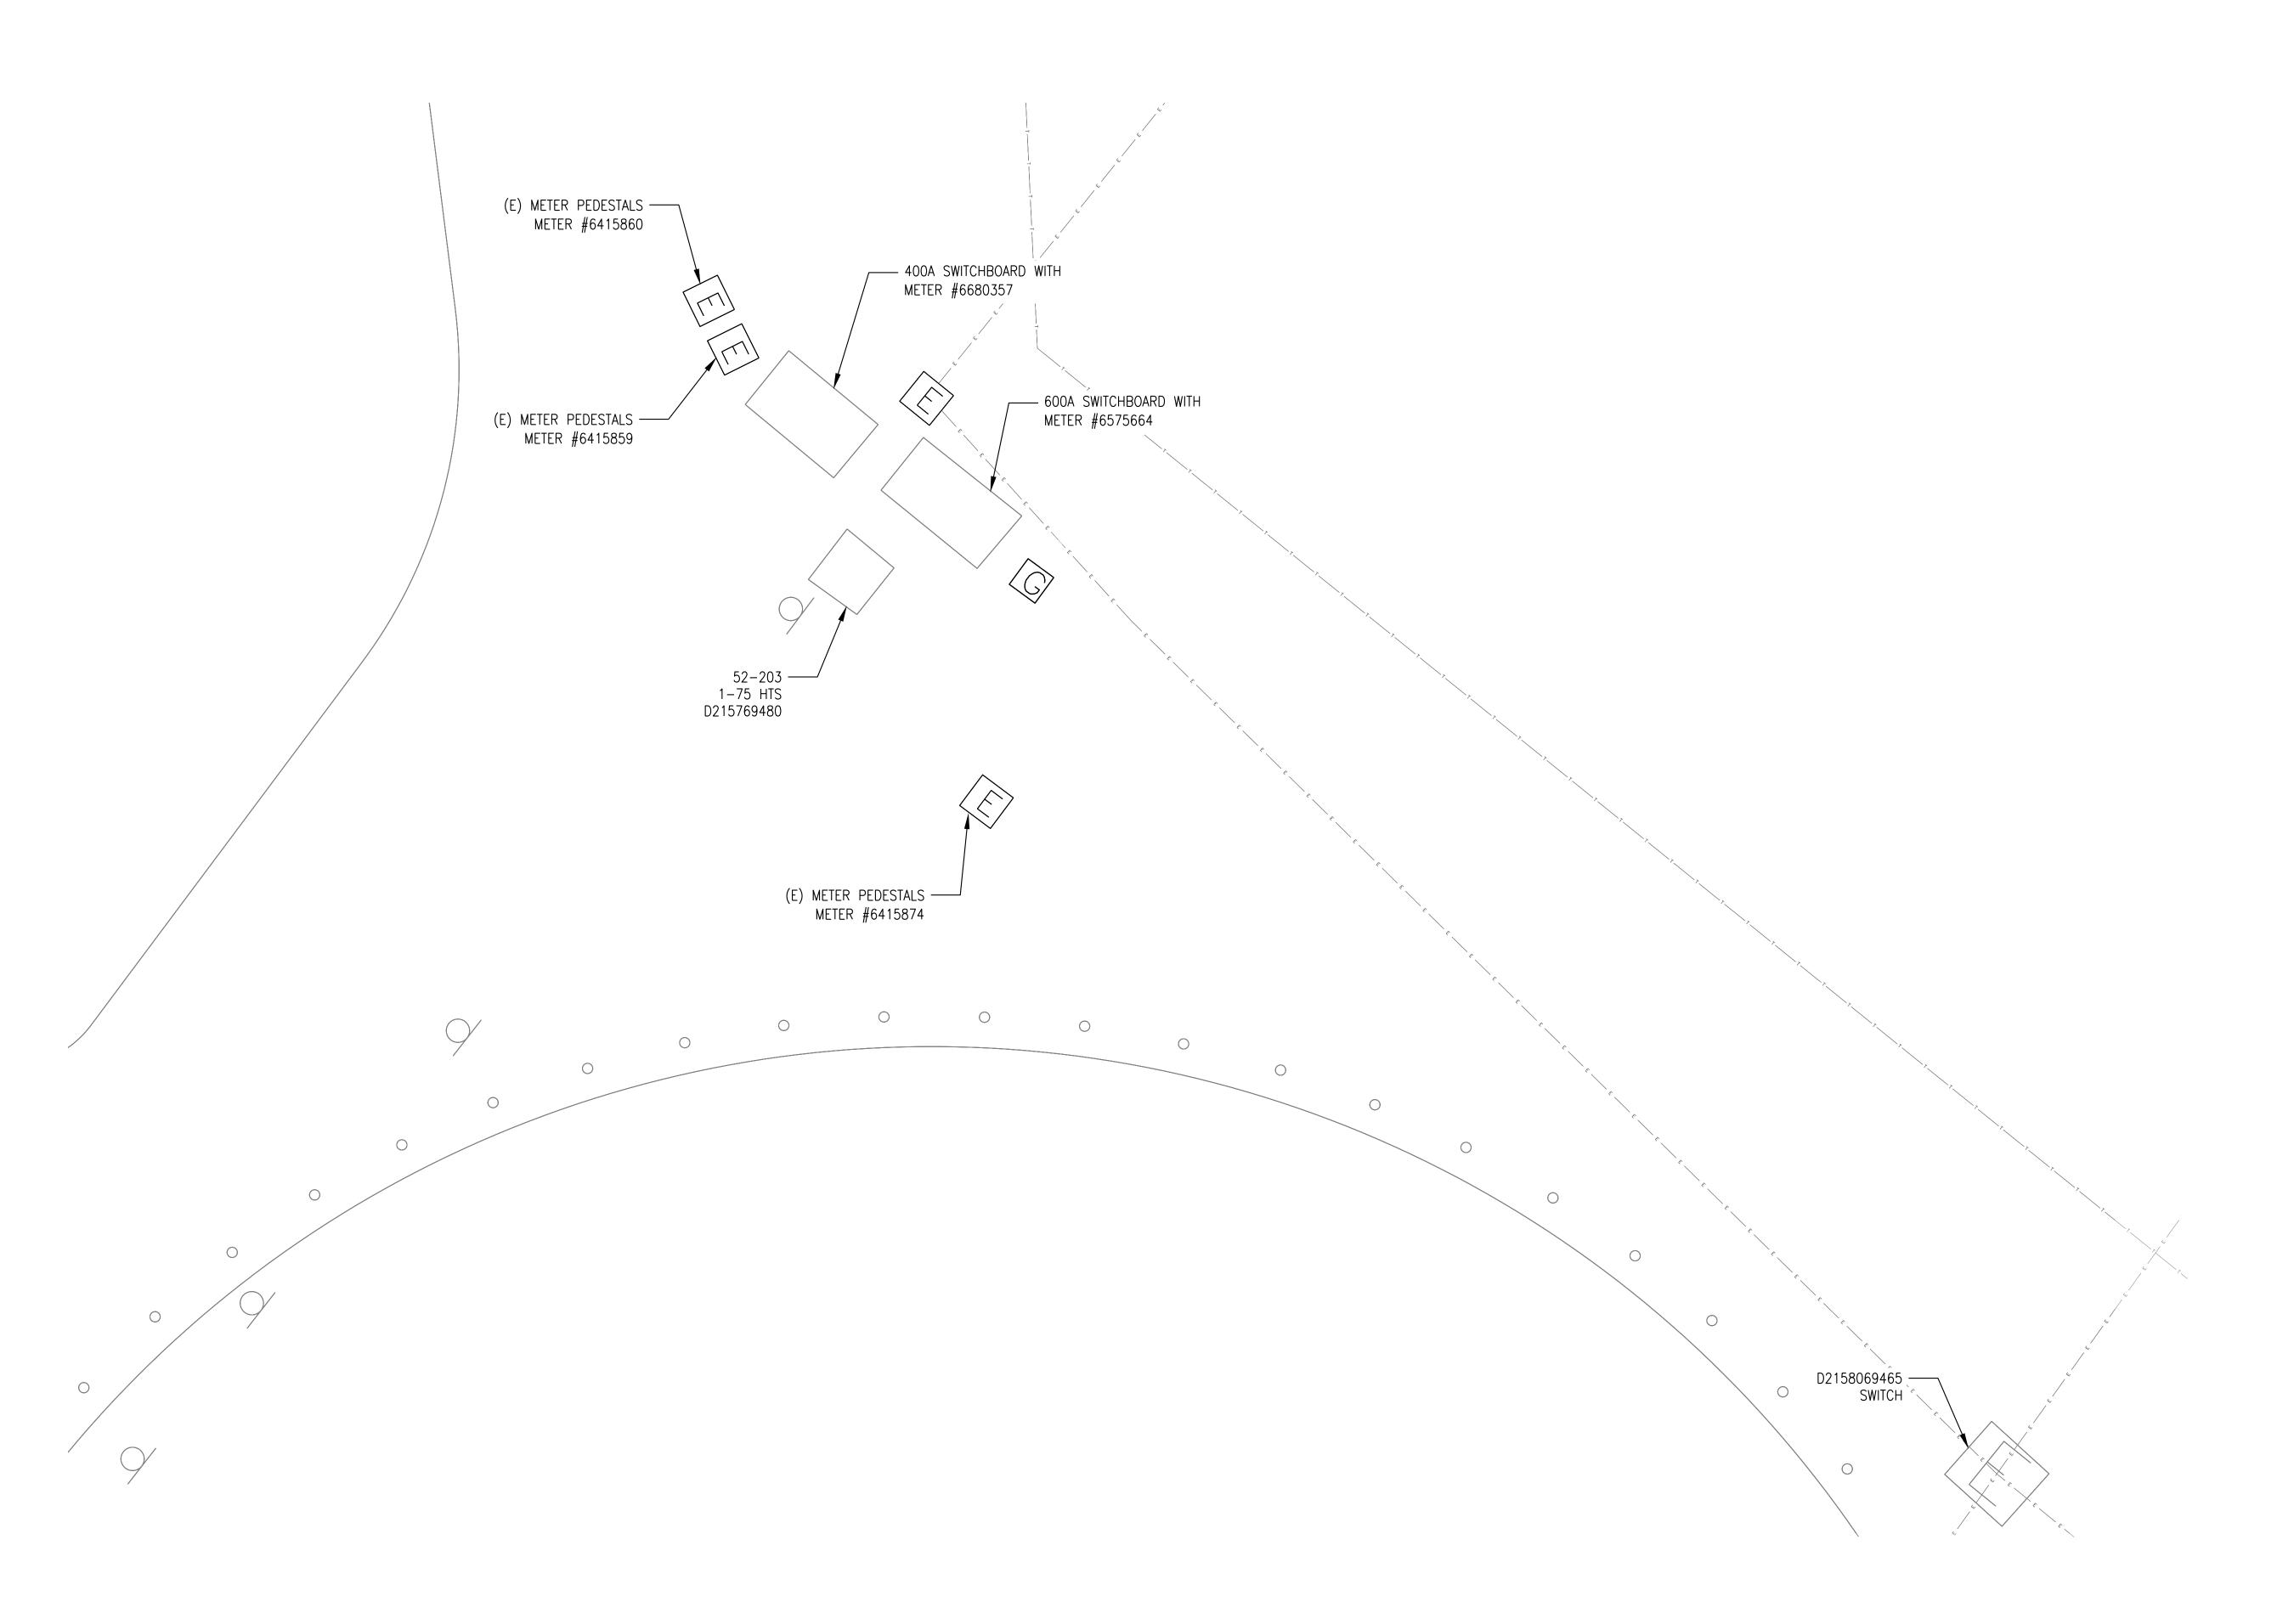

PRELIMINARY LIGHTING AND ELECTRICAL PLANS

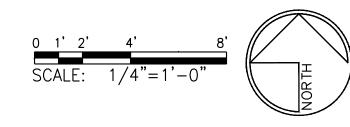

CITY OF SAN DIEGO PARK AND RECREATION DEPARTMENT

THE GENERAL DEVELOPMENT PLAN

ROBBFIELD

COMMUNITY PARK

COUNCIL DISTRICT NO. 2


COMM. PLAN AREA: MISSION PARK

PSD


LAMBERT COORDINATES: 215-1695


THOMAS BROTHERS PAGE: PG. 59-B3

SUPPLEMENTAL SHEET NO.: 19 OF 24

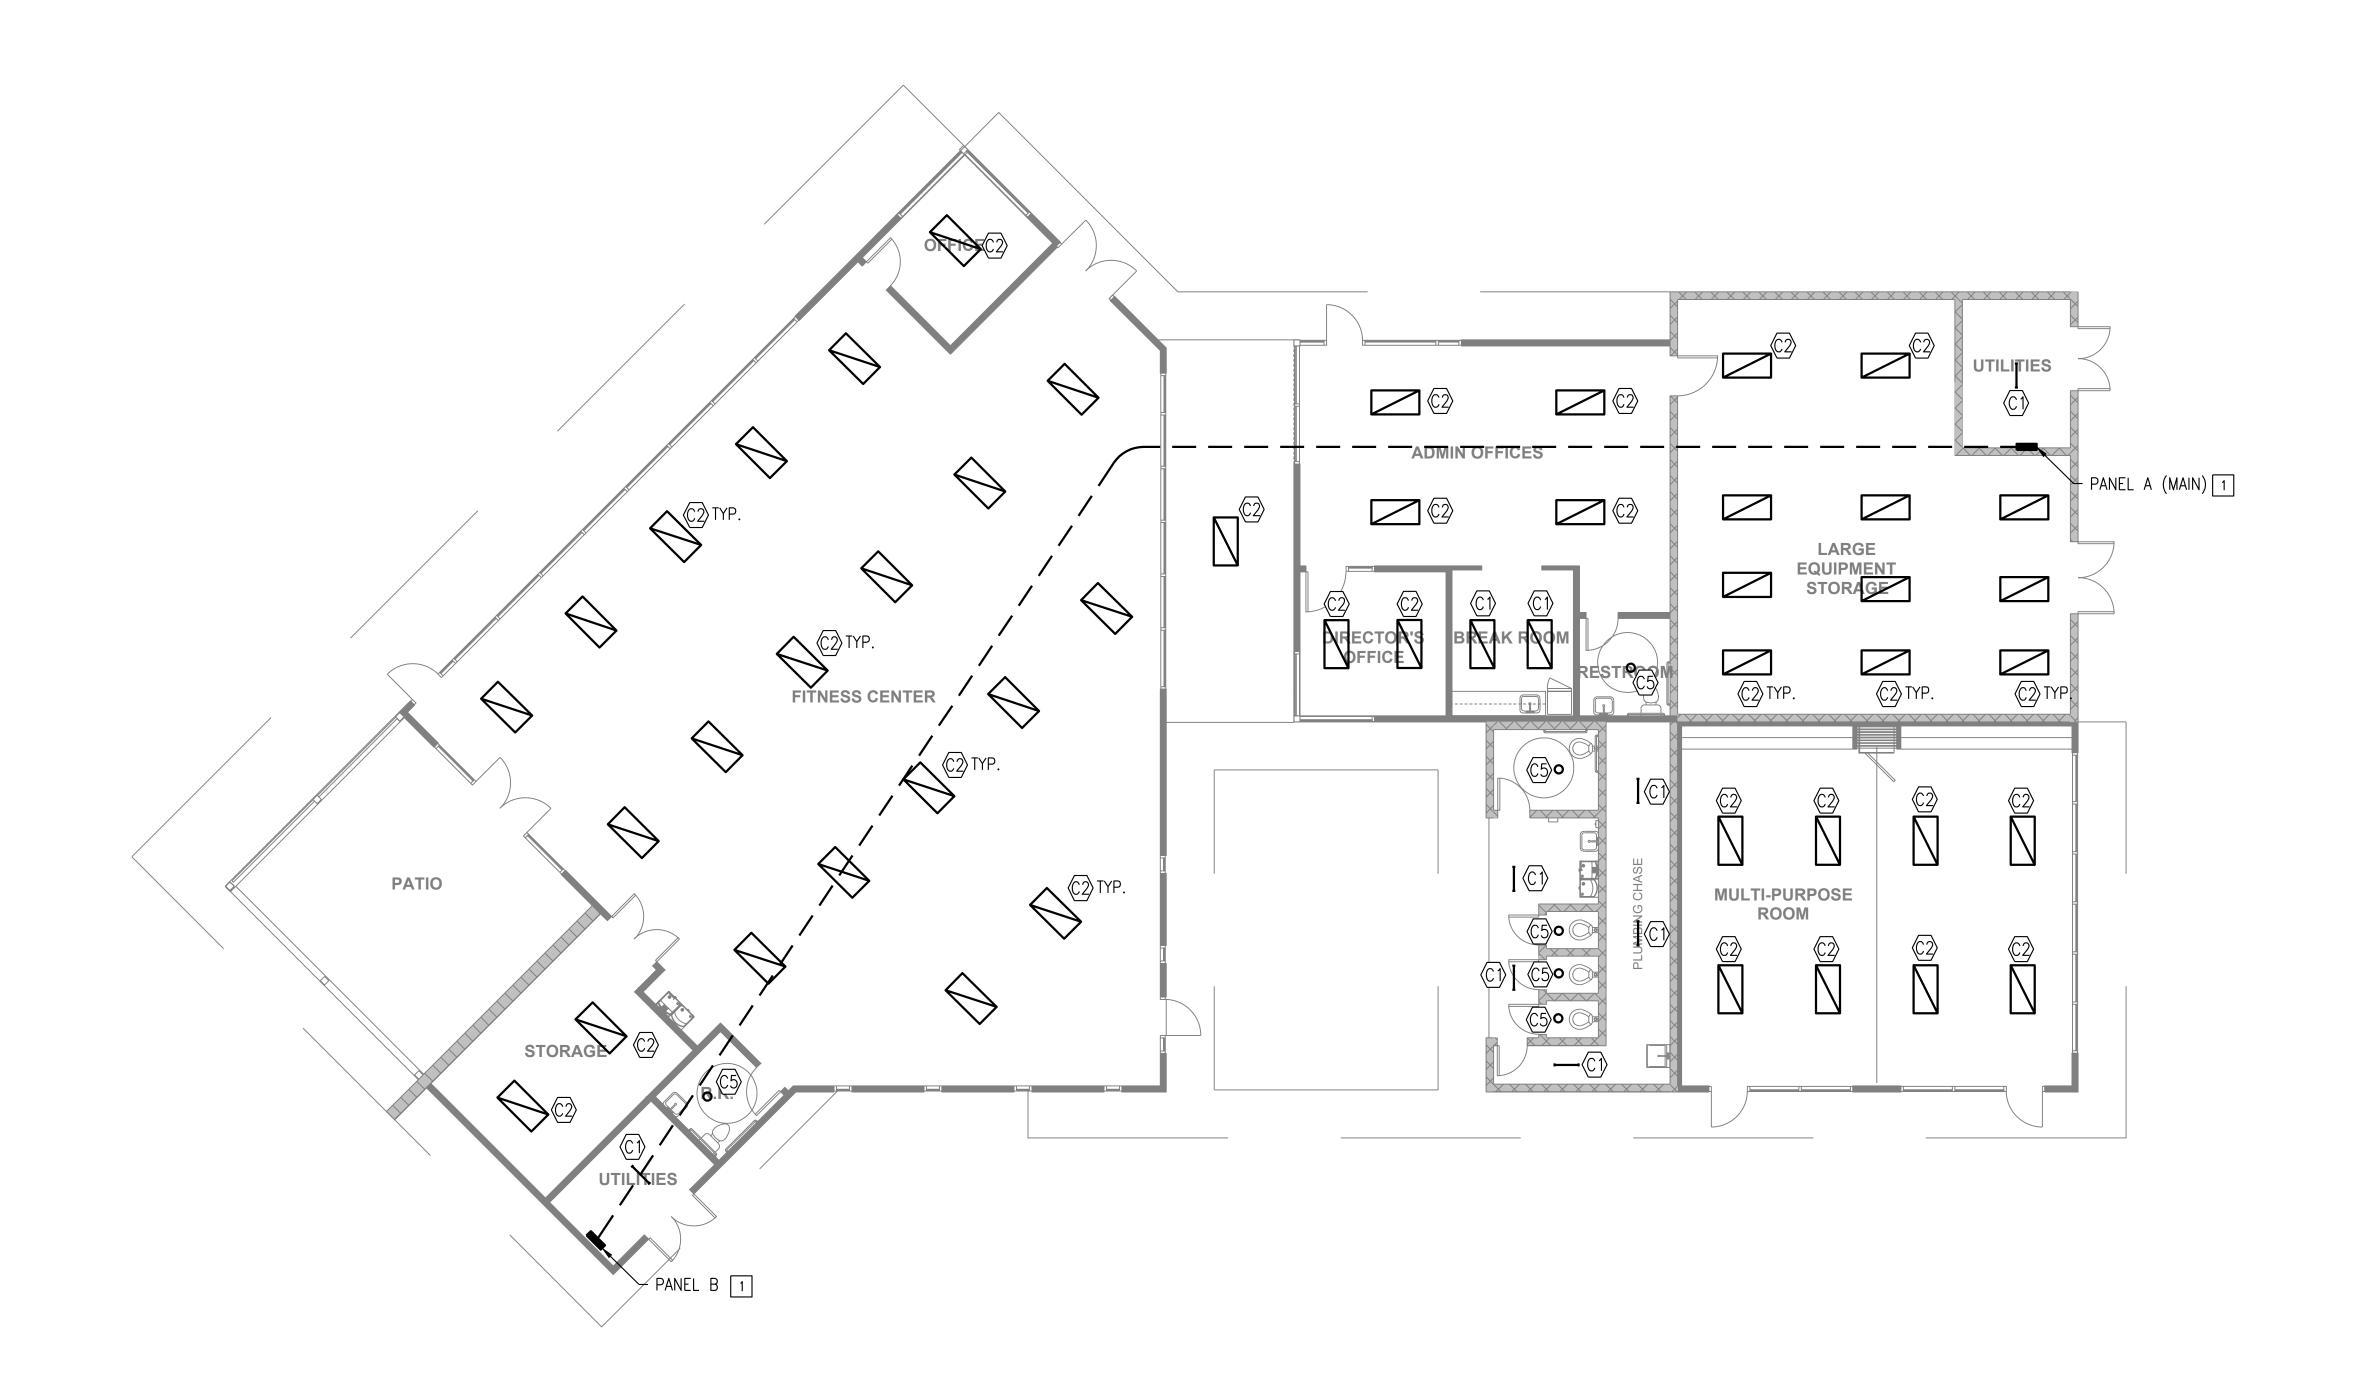

1/8" = 1'-0" ELECTRICAL FLOOR PLAN - RECREATION CENTER - NEW

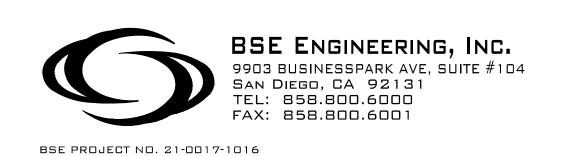

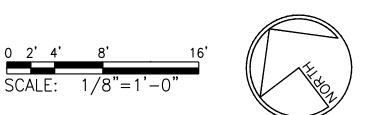

PRELIMINARY LIGHTING AND ELECTRICAL PLANS

CITY OF SAN DIEGO PARK AND RECREATION DEPARTMENT

GENERAL NOTES:

KEY NOTES:

1. PROVIDE ALL NEW LIGHTING, LIGHTING CONTROLS, ELECTRICAL

1 PROVIDE (1) NEW 208/120V, 200A, 3PH, 4W ELECTRICAL

PROVIDE (1) NEW 208/120V, 100A, 3PH, 4W ELECTRICAL PANELBOARD SUB-FED FROM PANEL A.

DEVICES AND PANELS WITHIN/EXTERIOR MOUNTED TO BUILDING.

PANELBOARD WITH 100A/3P BREAKER TO SUB-FEED PANEL B.


THE GENERAL DEVELOPMENT PLAN

ROBB FIELD


COMMUNITY PARK

COUNCIL DISTRICT NO. 2 COMM. PLAN AREA: MISSION PARK PSD

LAMBERT COORDINATES: 215-1695 THOMAS BROTHERS PAGE: PG. 59-B3 SUPPLEMENTAL SHEET NO.: 20 OF 24

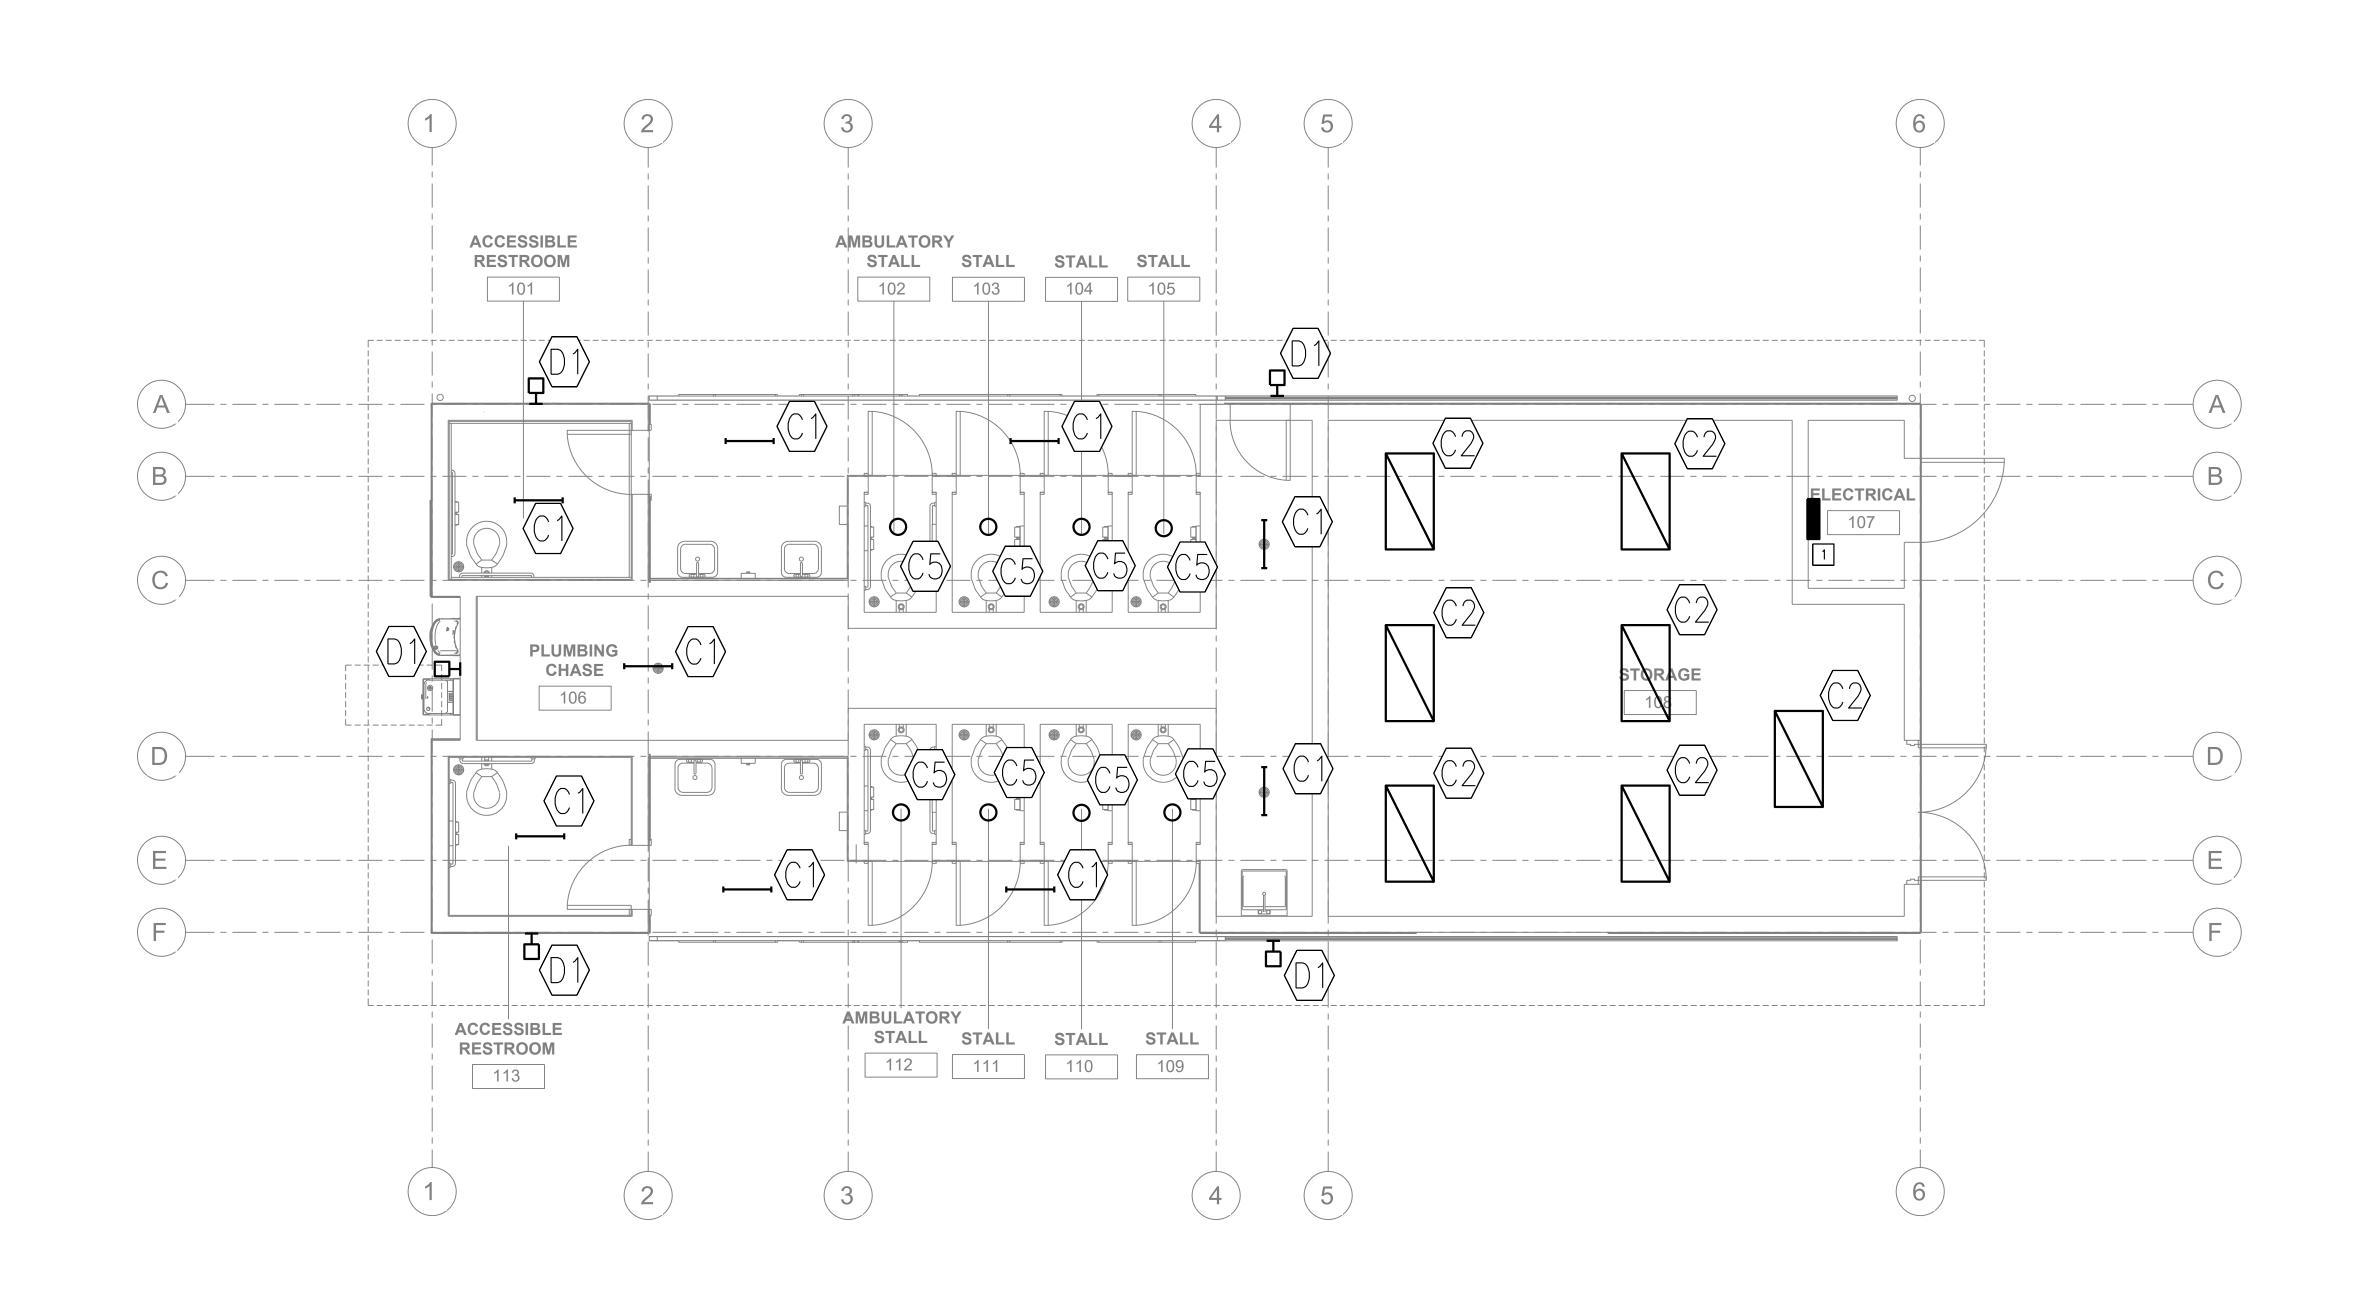

ELECTRICAL FLOOR PLAN - PHASE 1 - COMFORT STATION

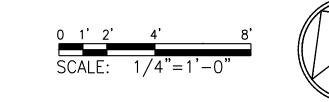

PRELIMINARY LIGHTING AND ELECTRICAL PLANS

CITY OF SAN DIEGO PARK AND RECREATION DEPARTMENT

GENERAL NOTES:

KEY NOTES:

PROVIDE NEW SINGLE POINT ELECTRICAL CONNECTION TO NEW COMFORT STATION PANEL (100A).


THE GENERAL DEVELOPMENT PLAN


ROBB FIELD

COMMUNITY PARK


COUNCIL DISTRICT NO. 2 COMM. PLAN AREA: MISSION PARK PSD


LAMBERT COORDINATES: 215-1695 THOMAS BROTHERS PAGE: PG. 59-B3 SUPPLEMENTAL SHEET NO.: 21 OF 24

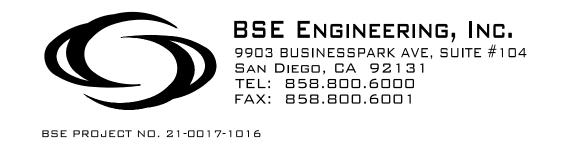

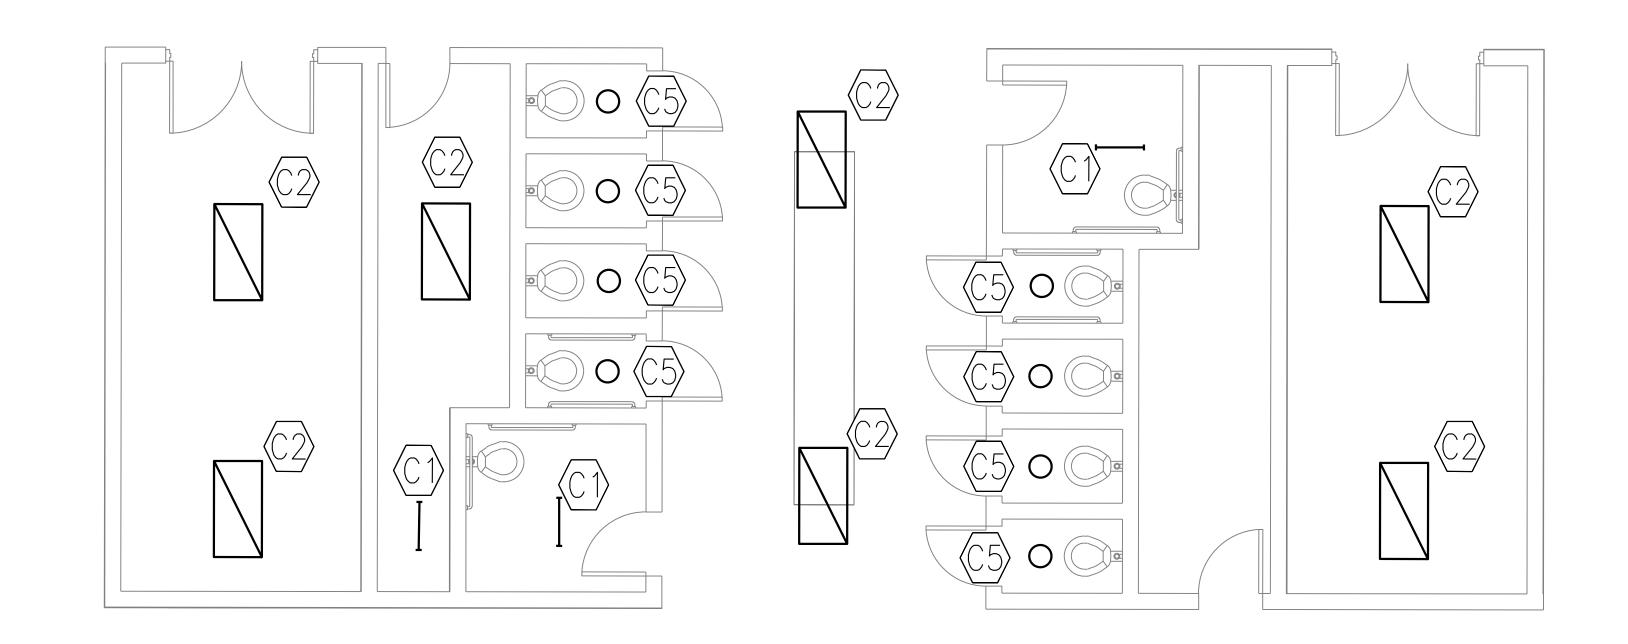

ELECTRICAL FLOOR PLAN - PHASE 2 - COMFORT STATION

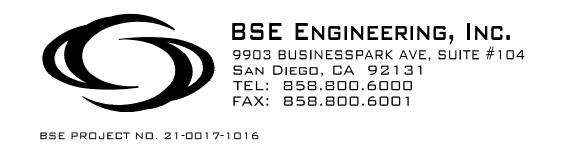

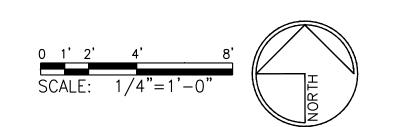

PRELIMINARY LIGHTING AND ELECTRICAL PLANS

CITY OF SAN DIEGO PARK AND RECREATION DEPARTMENT

THE GENERAL DEVELOPMENT PLAN

ROBBFIELD

COMMUNITY PARK

COUNCIL DISTRICT NO. 2

COMM. PLAN AREA: MISSION PARK

PSD

LAMBERT COORDINATES: 215-1695

THOMAS BROTHERS PAGE: PG. 59-B3

SUPPLEMENTAL SHEET NO.: 22 OF 24

GENERAL NOTES:

KEY NOTES:







EXISTING PANEL HP1



EXISTING PANEL HP1 LIGHTING CONTROLS



EXISTING PANEL HP2



EXISTING EXTERIOR UTILITY
AND DISTRIBUTION EQUIPMENT

5 BACK OF EAST GEAR

PRELIMINARY LIGHTING AND ELECTRICAL PLANS


CITY OF SAN DIEGO PARK AND RECREATION DEPARTMENT


THE GENERAL DEVELOPMENT PLAN

ROBB FIELD

COMMUNITY PARK

COUNCIL DISTRICT NO. 2 COMM. PLAN AREA: MISSION PARK THOMAS BROTHERS PAGE: PG. 59-B3 SUPPLEMENTAL SHEET NO.: 23 OF 24 LAMBERT COORDINATES: 215-1695

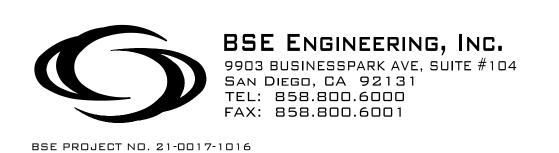

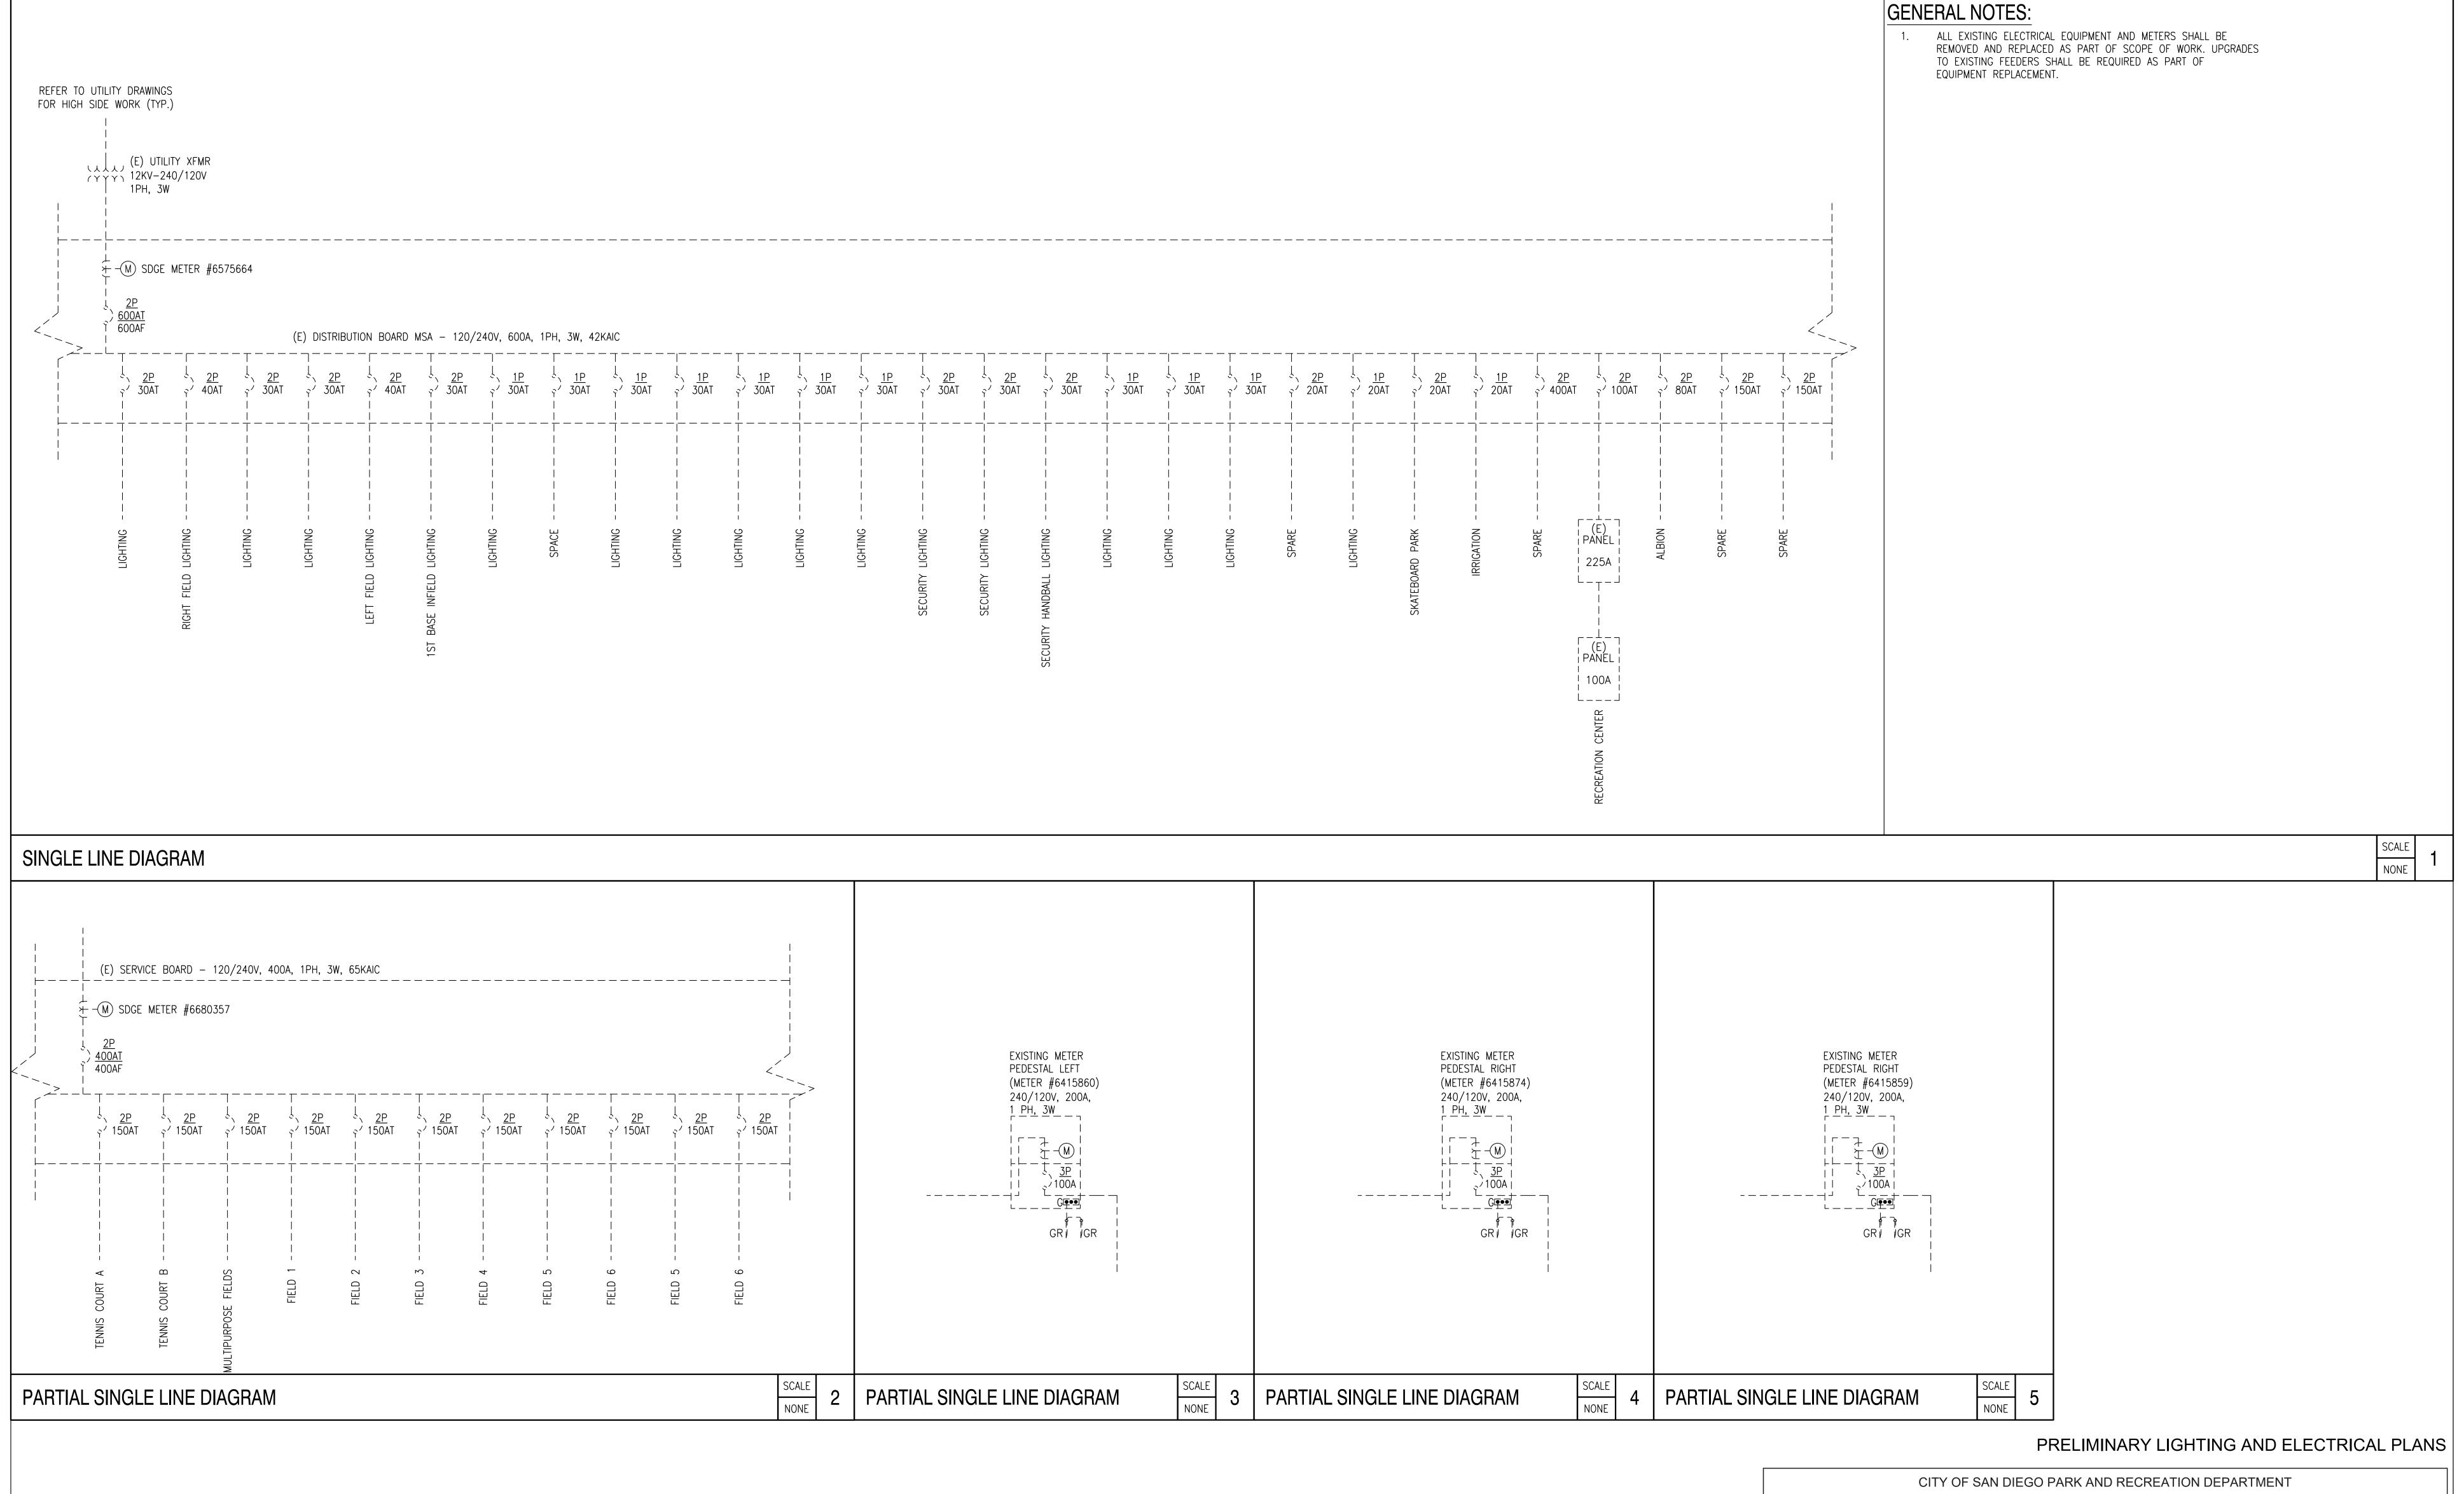

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SAN DIEGO, CA 92131
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BSE PROJECT NO. 21-0017-1016

