

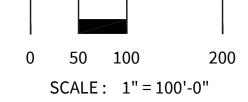
THE CITY OF SAN DIEGO M E M O R A N D U M

	April 4, 2024	
TO:	Elena Pascual, Associate Planne	r, Planning Department
FROM:	Andy Field, Director, Parks and	Recreation Department
SUBJECT:	Approval of the General Develop Park	ment Plan for Robb Field Community
	, 2024, the Parks and Recreation Board end approval of the following item[s]:	approved the motion unanimously 8-
1. Robb Fie	eld Community Park General Developm	ent Plan Amendment
under Council F	commendations from the Parks and Re Policy 600-33, the Parks and Recreation neral Development Plans.	
	ector eation Department	Date
Parks and Recre		Date
Parks and Recre AF/jg		
Parks and Recre AF/jg Attachments: F	eation Department	evelopment Plan Amendment
Parks and Recre AF/jg Attachments: F cc: Jason Gr	eation Department Robb Field Community Park General De	evelopment Plan Amendment apital Projects Department
Parks and Recre AF/jg Attachments: F cc: Jason Gr Kevin Oliver, Pr Juliana Grotzing	eation Department Robb Field Community Park General Decention & Cani, Deputy Director, Engineering & Capital	evelopment Plan Amendment apital Projects Department
Parks and Recre AF/jg Attachments: F cc: Jason Gr Kevin Oliver, Pr Juliana Grotzing Department Mehdi Rashidpo	eation Department Robb Field Community Park General Decention & Cani, Deputy Director, Engineering & Capital	evelopment Plan Amendment apital Projects Department Projects Department Ianager, Engineering & Capital Projects
AF/jg Attachments: F cc: Jason Gr Kevin Oliver, Pr Juliana Grotzing Department Mehdi Rashidpo Department	eation Department Robb Field Community Park General Decenies, Deputy Director, Engineering & Capital ger, Associate Civil Engineer-Project M	evelopment Plan Amendment apital Projects Department Projects Department Ianager, Engineering & Capital Projects eer, Engineering & Capital Projects


Heidi Vonblum, Planning Director, Planning Department



*Striping at synthetic field shown for graphic purposes only. Field area can accomodate soccer, football, rugby, and lacrosse field sizes. Final multi-use striping to be determined in the future. **Existing Handball Courts to remain until new ones are built.



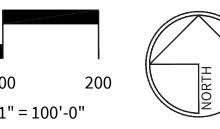***Surveillance cameras to be installed at locations throughout the park TBD by P&R O&M staff





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							IMPROVEMENTS S	JMMARY (DA	ATA FROM AS-BUILT DRA	AWINGS)		
DATE	ACTION	REFERENCE DOCUMENTS			ITEM	QUANTIT	_ITEM	QUANTITY	ITEM	QUANTITY	ITEM	QUANTITY
1945	SITE ACQUIRED	RESO. NO. TRANSF. FROM STATE	COST \$:	ACRES: 66.76	TOTAL SITE	66.76 AC	. PLAY AREA	9,675 SF	PAVED WALKWAYS	233, 706 SF	SECURITY LTS.	20 STDS.
04.24.1962	SITE DEDICATED	ORD. NO. 8628 NS		ACRES: 66.76	IMPROVED AREA	51 AC	. MULTI-PURPOSE CT.	13,520 SF	MULTI-USE PATH/BIKE LAN	IE 12,493 SF	BALLFIELD LTS.	14 STDS.
03-56	GDP CONSULTANT HIRED	RESO. NO.	NAME:		TURF	21.86 AC	TENNIS CTS.	73,200 SF	PARKING IMPROVEMENTS	275,008 SF	PICKLEBALL COURT LTS.	6 STDS.
2-70/1-80	P&R BOARD APPROVAL	PF&R APPROVAL	DATE:		SYNTHETIC TURF	8.3 AC	RESTROOMS	5,181 SF	PARKING STALLS-STD.	843	MULTI-PURPOSE CT. LTS.	12 STDS.
1957	INITIAL DEVELOPMENT	CIP NO.	J.O. NO.	DRWG. NO. 3757-D	SHRUB BED	2.8 AC	REC. BLDG.	10,606 SF	PARKING STALLS-DISABLE	D 26	BACKSTOPS	8 EA.
2-58	RESTROOM	CIP NO.	J.O. NO.	DRWG. NO. 5684-D	DIRT INFIELDS	1.29 AC	. TENNIS BLDG.	3,038 SF	HANDBALL COURT	7,242 SF	TENNIS COURTS	12 EA.
2-58	PARKING LOT	CIP NO.	J.O. NO.	DRWG. NO. 4825-D	NON-PROGRAMMED AREA	A 8.1 AC	. CONCESSION STAND	1,000 SF	LAWN EDGING	19,922.2 LF	PICKLEBALL COURTS	12 EA.
5-72	IMPROVEMENT PLANS	CIP NO.	J.O. NO. 64983	DRWG. NO. 14712-D					BLEACHERS	16 EA.	BATTING CAGES	1 EA.
9-72	IMPROVEMENT PLANS	CIP NO.	J.O. NO. 64983	DRWG. NO. 14927-D					TRACK AT SYNTHETIC TUP	RF 40, 780 SF	PICNIC TABLES	4 EA.
1-76 5-76	SPRINKLER SYSTEM TENNIS/HANDBALL COURTS	CIP NO.	J.O. NO. 164016 164018	DRWG. NO. 15640-D 16578-D					PADEL/MULTI-PURPOSE C	TS 34,678 SF	ENCLOSED SOCCER FIELDS	S 2 EA.
6-85	PARKING RESTROOM	CIP NO.	J.O. NO. 118229 112513	DRWG. NO. 20735-D 27426-D							REVISION S.M. 11-2-05	

CITY OF SAN DIEGO PARK AND RECREATION DEPARTMENT

THE GENERAL DEVELOPMENT PLAN

ROBB FIELD

COMMUNITY PARK

COUNCIL DISTRICT NO. 2 COMM. PLAN AREA: MISSION PARK LAMBERT COORDINATES: 215-1695 THOMAS BROTHERS PAGE: PG. 59-B3

PSD (MB-113) **EXISTING CONDITIONS PARKING COUNT**

TOTAL PARK AREA = 64 ACRES

NON-PROGRAMMED AREA = 13.6 ACRES

NEEDED PARKING BREAKDOWN:

68 SPOTS = 5 SPOTS PER ACRE OF NON PROGRAMMED

PARK LAND (13.6 ACRES)

240 SPOTS = 30 SPOTS PER SOFTBALL BACKSTOP (8)

24 SPOTS = 12 PARKING SPOTS PER 6 TENNIS COURTS (12 COURTS)

120 SPOTS = 30 SPOTS PER SOCCER FIELD (2 ADULT, 2 YOUTH)

47 SPOTS = 1 SPOT PER 200 SF OF BUILDING (9,417 SF) **499 TOTAL PARKING SPACES REQUIRED**

CURRENT PARKING BREAKDOWN

PARKING LOT 1 = 131 SPACES (5 ADA REQUIRED, 4 EXISTING)

PARKING LOT 2 = 196 SPACES (6 ADA REQUIRED, 5 EXISTING)

PARKING LOT 3 = 314 SPACES (8 ADA REQUIRED, 8 EXISTING)

PARKING LOT 4 = 12 SPACES (1 ADA REQUIRED, 1 EXISTING)

PARKING LOT 5 = 57 SPACES (3 ADA REQUIRED, 3 PLANNED) **TOTAL SPACES = 710 SPACES**

EXISTING CONDITIONS PARKING COUNTS

499 PARKING SPACES NEEDED

710 PARKING SPACES PROVIDED 211 PARKING SPACE SURPLUS

(211/30 = 7 ADDITIONAL ACTIVITIES ACCOMMODATED)

PROPOSED PARKING COUNT

TOTAL PARK SCOPE = 64 ACRES

TOTAL IMPROVEMENT SCOPE AREA = 51 ACRES

NON-PROGRAMMED AREA = 8.1 ACRES

BREAKDOWN:

41 SPOTS = 5 SPOTS PER ACRE OF NON-PROGRAMMED PARK LAND (8.1)

240 SPOTS = 30 SPOTS PER SOFTBALL BACKSTOP (8)

68 SPOTS = 1 SPOT PER 200 SF OF BUILDING (13,650 SF)

36 SPOTS = TWELVE SPOTS PER SIX TENNIS/PADEL COURTS (18 COURTS)

24 SPOTS = TWELVE SPOTS PER SIX PICKLEBALL COURTS (12 COURTS)

120 SPOTS = 30 SPOTS PER SOCCER FIELD (2 ADULT, 2 YOUTH)

30 SPOTS = 15 SPOTS PER ENCLOSED SOCCER COURT (2) **559 TOTAL PARKING SPACES NEEDED**

PROPOSED PARKING BREAKDOWN:

PARKING LOT 1 = 101 SPACES (5 ADA)

PARKING LOT 2 = 275 SPACES (7 ADA)

PARKING LOT 3 = 341 SPACES (8 ADA)

PARKING LOT 4 = 12 SPACES (1 ADA)

PARKING LOT 5 = 57 SPACES (3 ADA)

PARKING LOT 6 = 34 SPACES (2 ADA) TOTAL SPACES = 820 SPACES

PROPOSED PARKING COUNTS

559 PARKING SPACES NEEDED

820 PARKING SPACES PROVIDED

261 PARKING SPACE SURPLUS

(261/30 = 8 ADDITIONAL ACTIVITIES ACCOMMODATED)



PARKING LOT & ALLEE TREES SUCH AS:

Fraxinus oxycarpa 'Raywood' / Raywood Ash Lophostemon confertus / Brisbane Box Quercus Ilex / Holm Oak



ACCENT TREES (10' OR LARGER PLANTERS)

Platanus mexicana / Mexican Sycamore

Pinus torreyana / Torrey Pine

Tipuana tipu / Tipu Tree Quercus agrifolia / Coast Live Oak

FLOWERING TREES:

Bauhinia blakeana / Hong Kong Orchid Tree

Lagerstroemia indica* / Crape Myrtle

Tabebuia rosea / Pink Trumpet Tree

*Limit to areas where there are space constraints.

PLANTING AREAS AND PARKING ISLANDS:

Primarily bark mulch or decomposed granite with

accent boulders and groupings of plantings such as:

Abutilon palmeri / Indian Mallow

Agave attenuata / Foxtail Agave

Agave desmettiana 'Variegata' / Variegated Smooth Agave

Artemisia californica / California Sagebrush

Aster chilensis 'Point Saint George' / Point Saint George Aster

Bahiopsis laciniata / San Diego Sunflower

Cercocarpus betuloides / Mountain Mahogany

Chilopsis linearis / Desert Willow

Dasylirion wheeleri / Spoon Yucca

Erigeron glaucus 'Sea Breeze' / Seaside Daisy

Gambelia speciosa / Island Snapdragon

Grindelia stricta venulosa / Grindelia

Heteromeles arbutifolia 'Davis Gold' / Davis Gold Toyon

Hesperaloe parviflora / Red Yucca

Lantana montevidensis / Trailing Lantana

Nolina microcarpa / Beargrass

Rhamnus californica / Coffeeberry

Rhaphiolepis indica / Indian Hawthorn

Salvia clevelandii / Cleveland Sage

Salvia 'Point Sal Spreader' / Point Sal Purple Sage

BASIN:

Achillea millefolium / Yarrow

Baccharis pilularis 'Pigeon Point' / Dwarf Coyote Brush Plant

Carex praegracilis / Field Sedge

Carex tumulicola / Berkeley Sedge

Iva hayesiana / San Diego Povertyweed

Populus fremontii / Fremont Cottonwood

Muhlenbergia rigens / Deer Grass

Carex praegracilis





Tipuana tipu



Abutilon palmeri



Baccharis pilularis 'Pigeon Point'



Erigeron glaucus 'Sea Breeze'



Lantana montevidensis







Bauhinia blakeana



Agave spp



Cercocarpus betuloides



Grindelia stricta venulosa





Iva hayesiana



Platanus mexicana



Lagerstroemia indica





Chilopsis linearis



Heteromeles arbutifolia 'Davis Gold'



Salvia clevelandii



Muhlenbergia rigens



Pinus torreyana





Aster chilensis 'Point Saint George'



Dasylirion wheeleri



Hesperaloe parviflora



Salvia 'Point Sal Spreader'



PRELIMINARY PLANTING RECOMMENDATIONS

ROBB FIELD

CITY OF SAN DIEGO PARK AND RECREATION DEPARTMENT

THE GENERAL DEVELOPMENT PLAN

COMMUNITY PARK

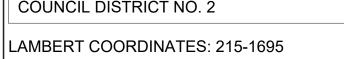
COUNCIL DISTRICT NO. 2

COMM. PLAN AREA: MISSION PARK

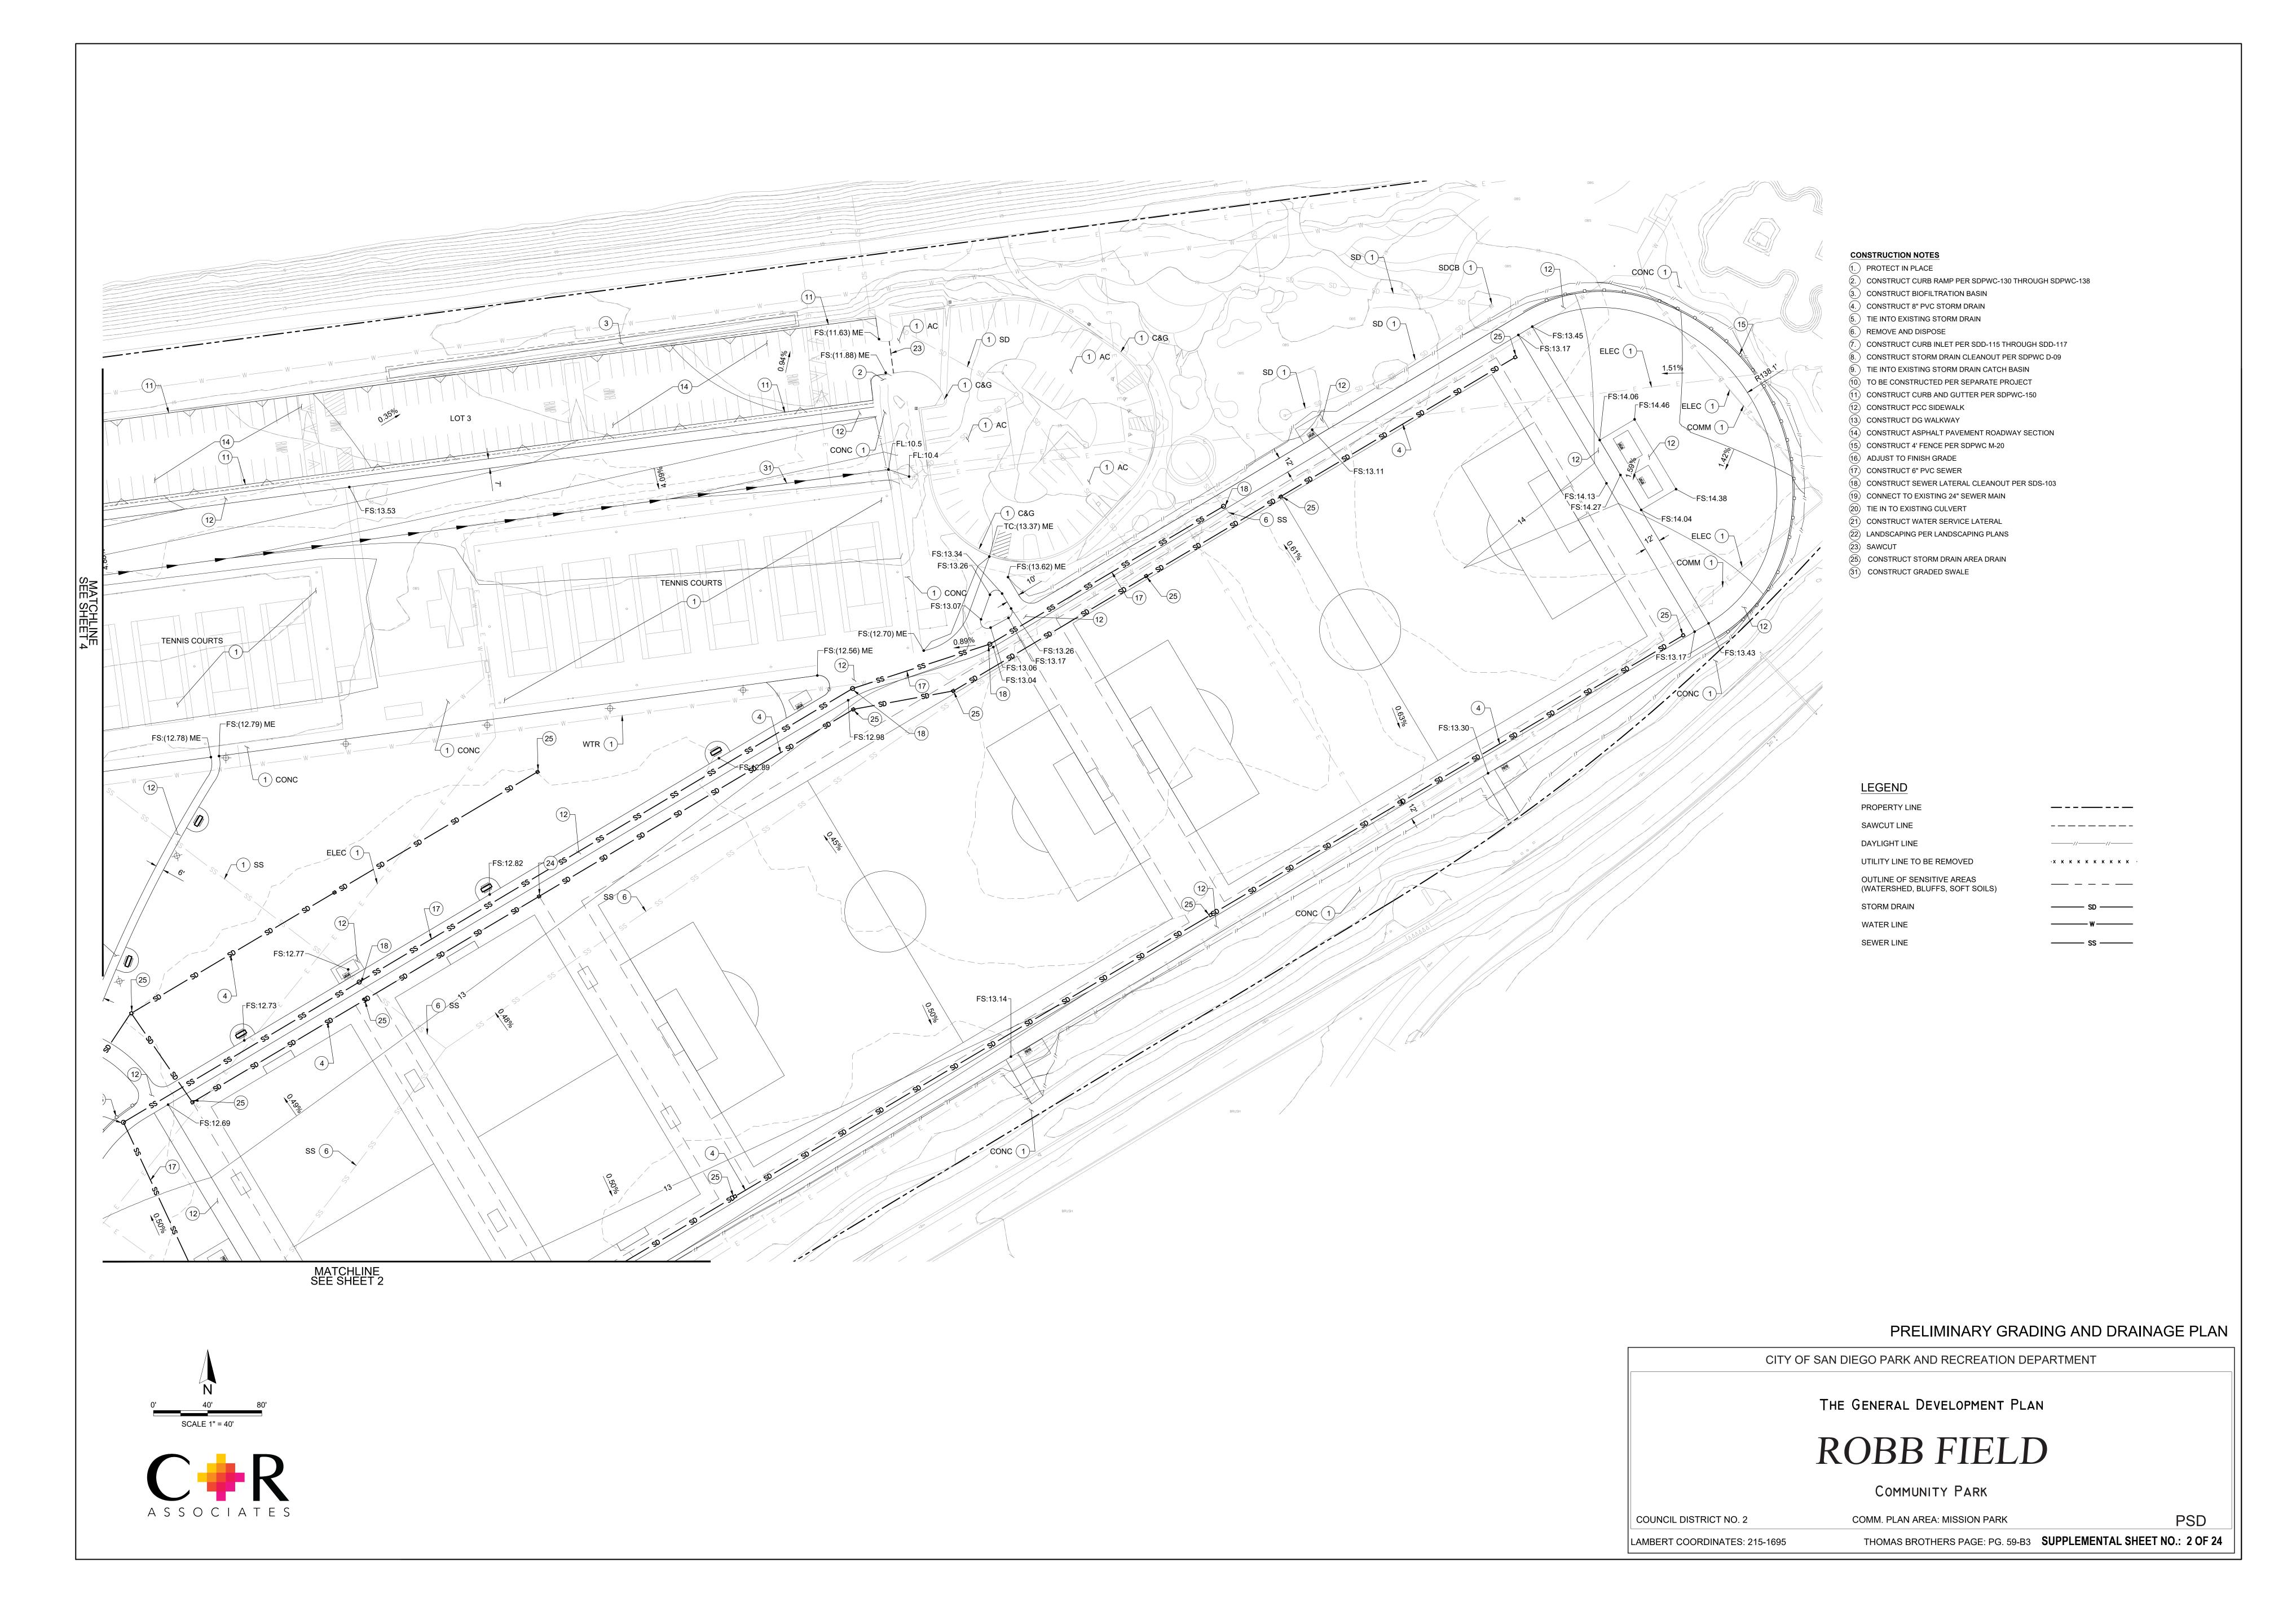
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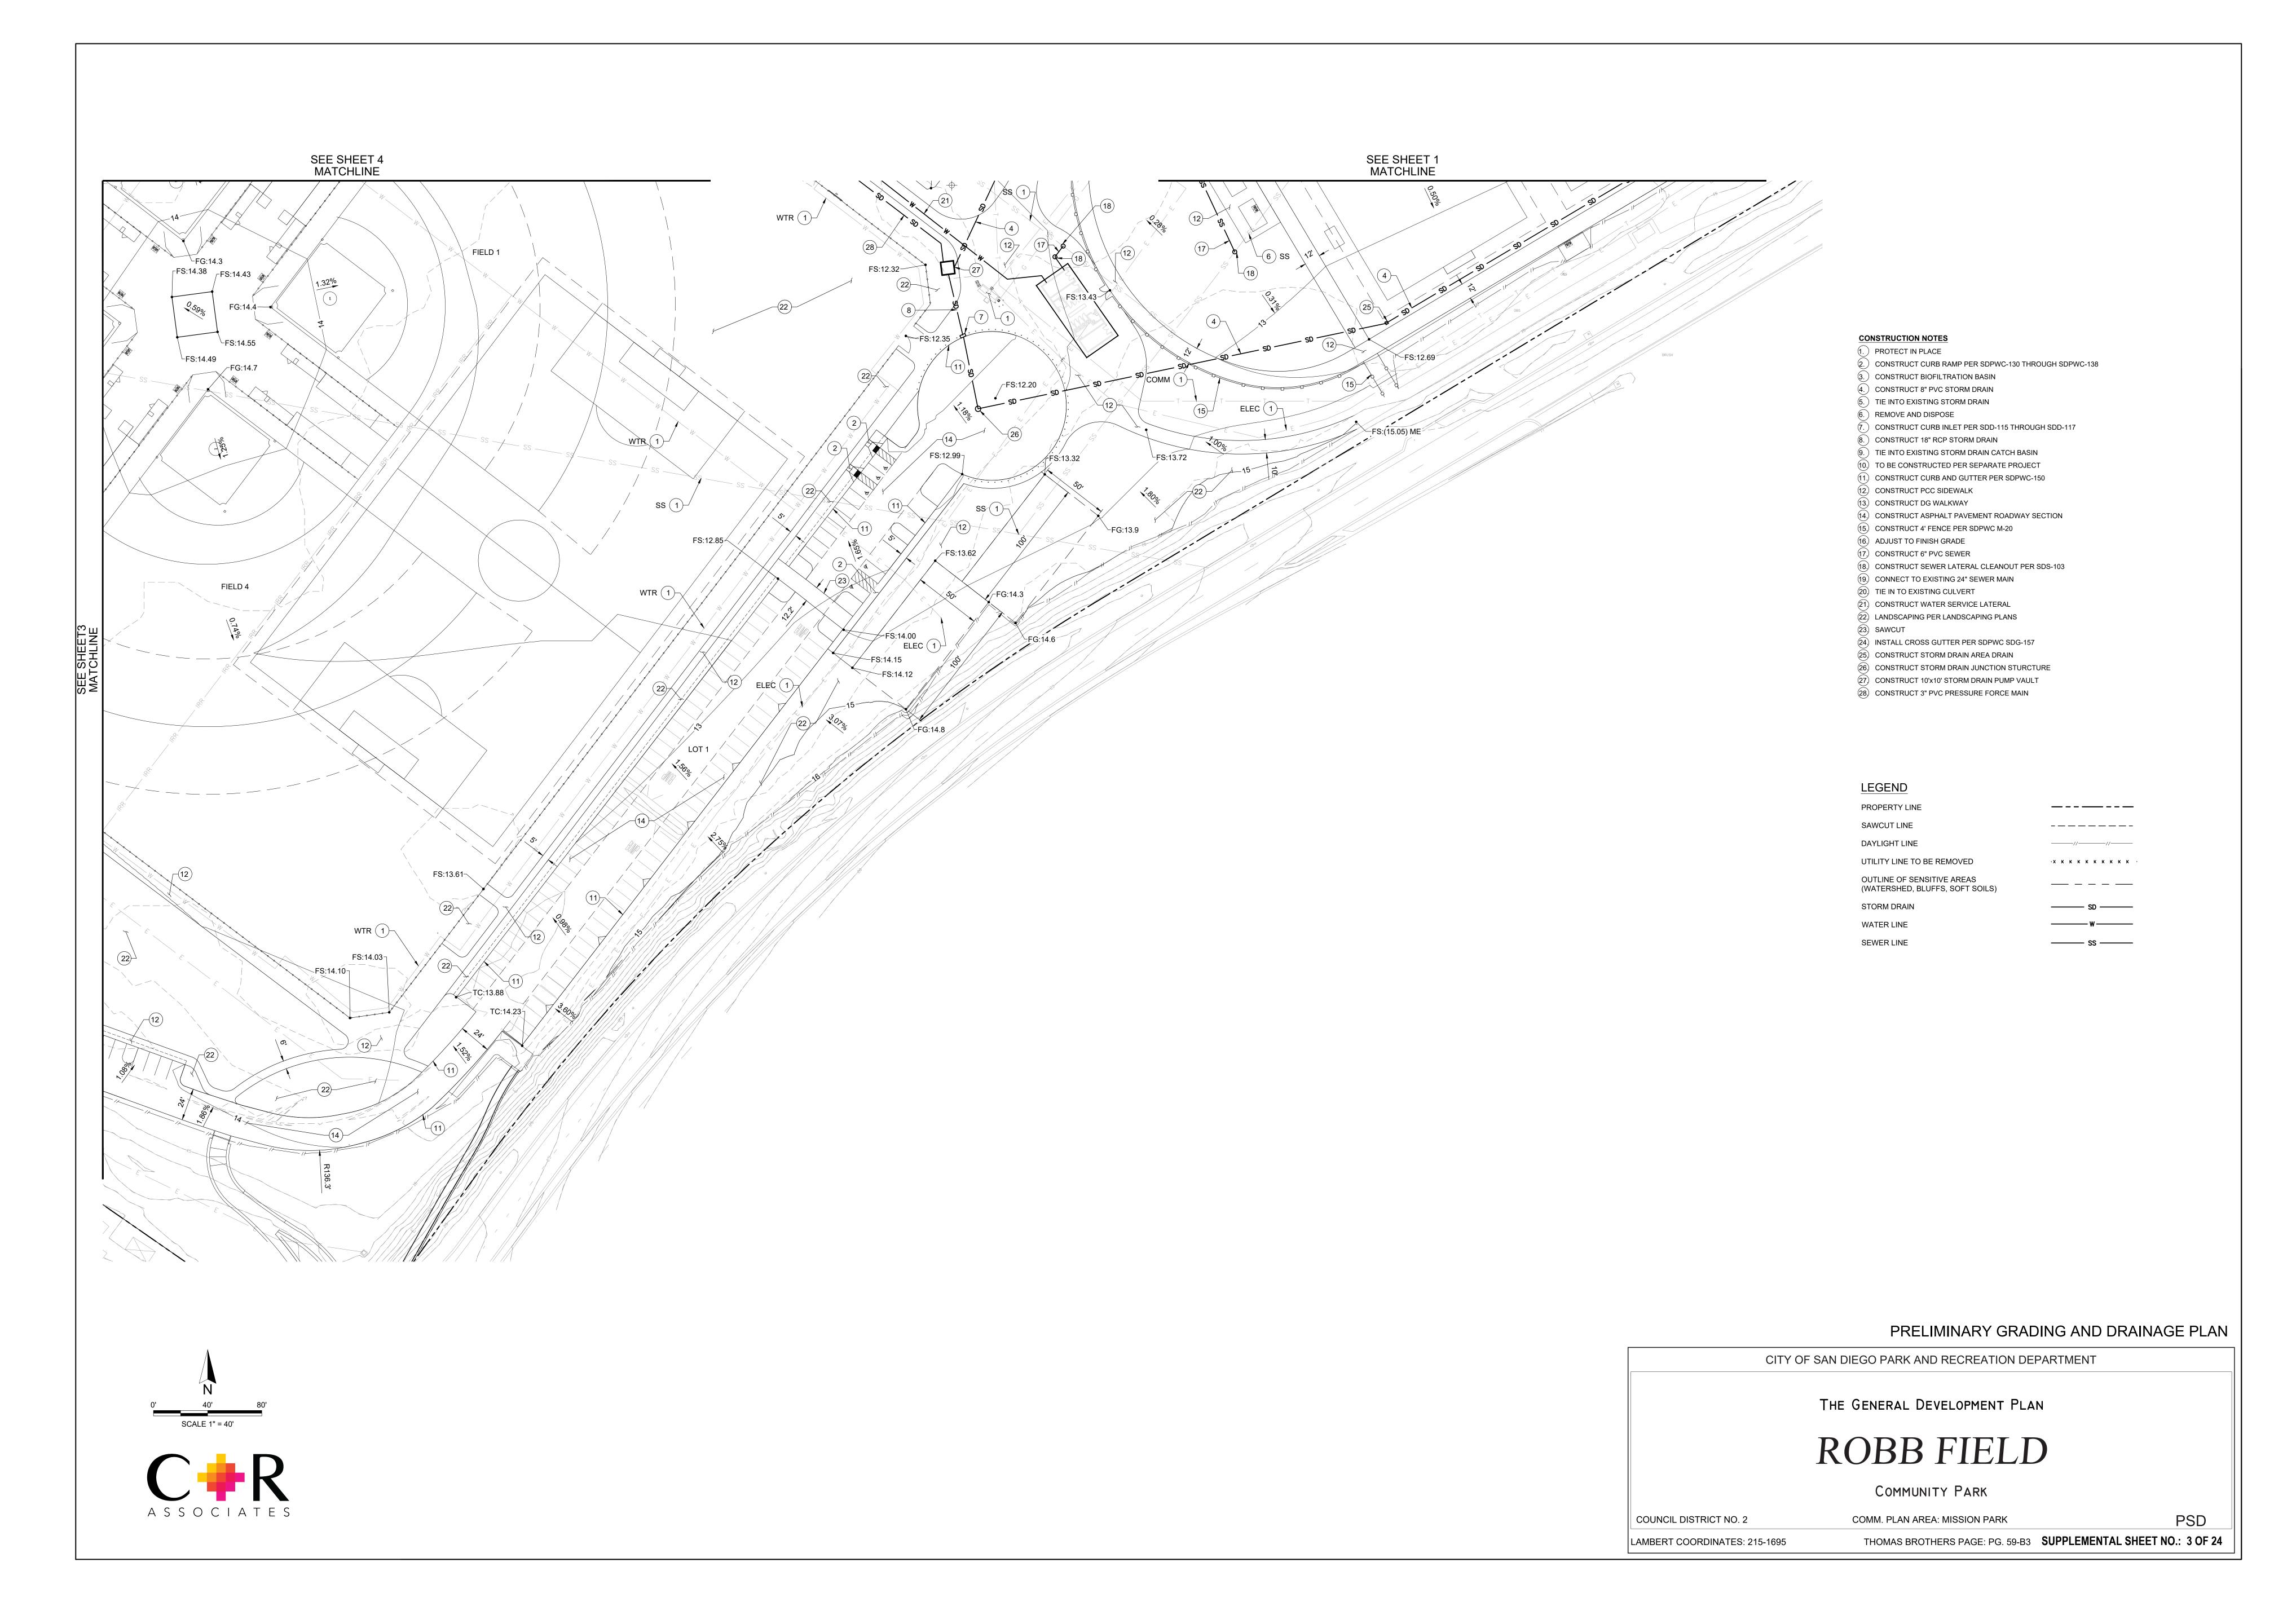


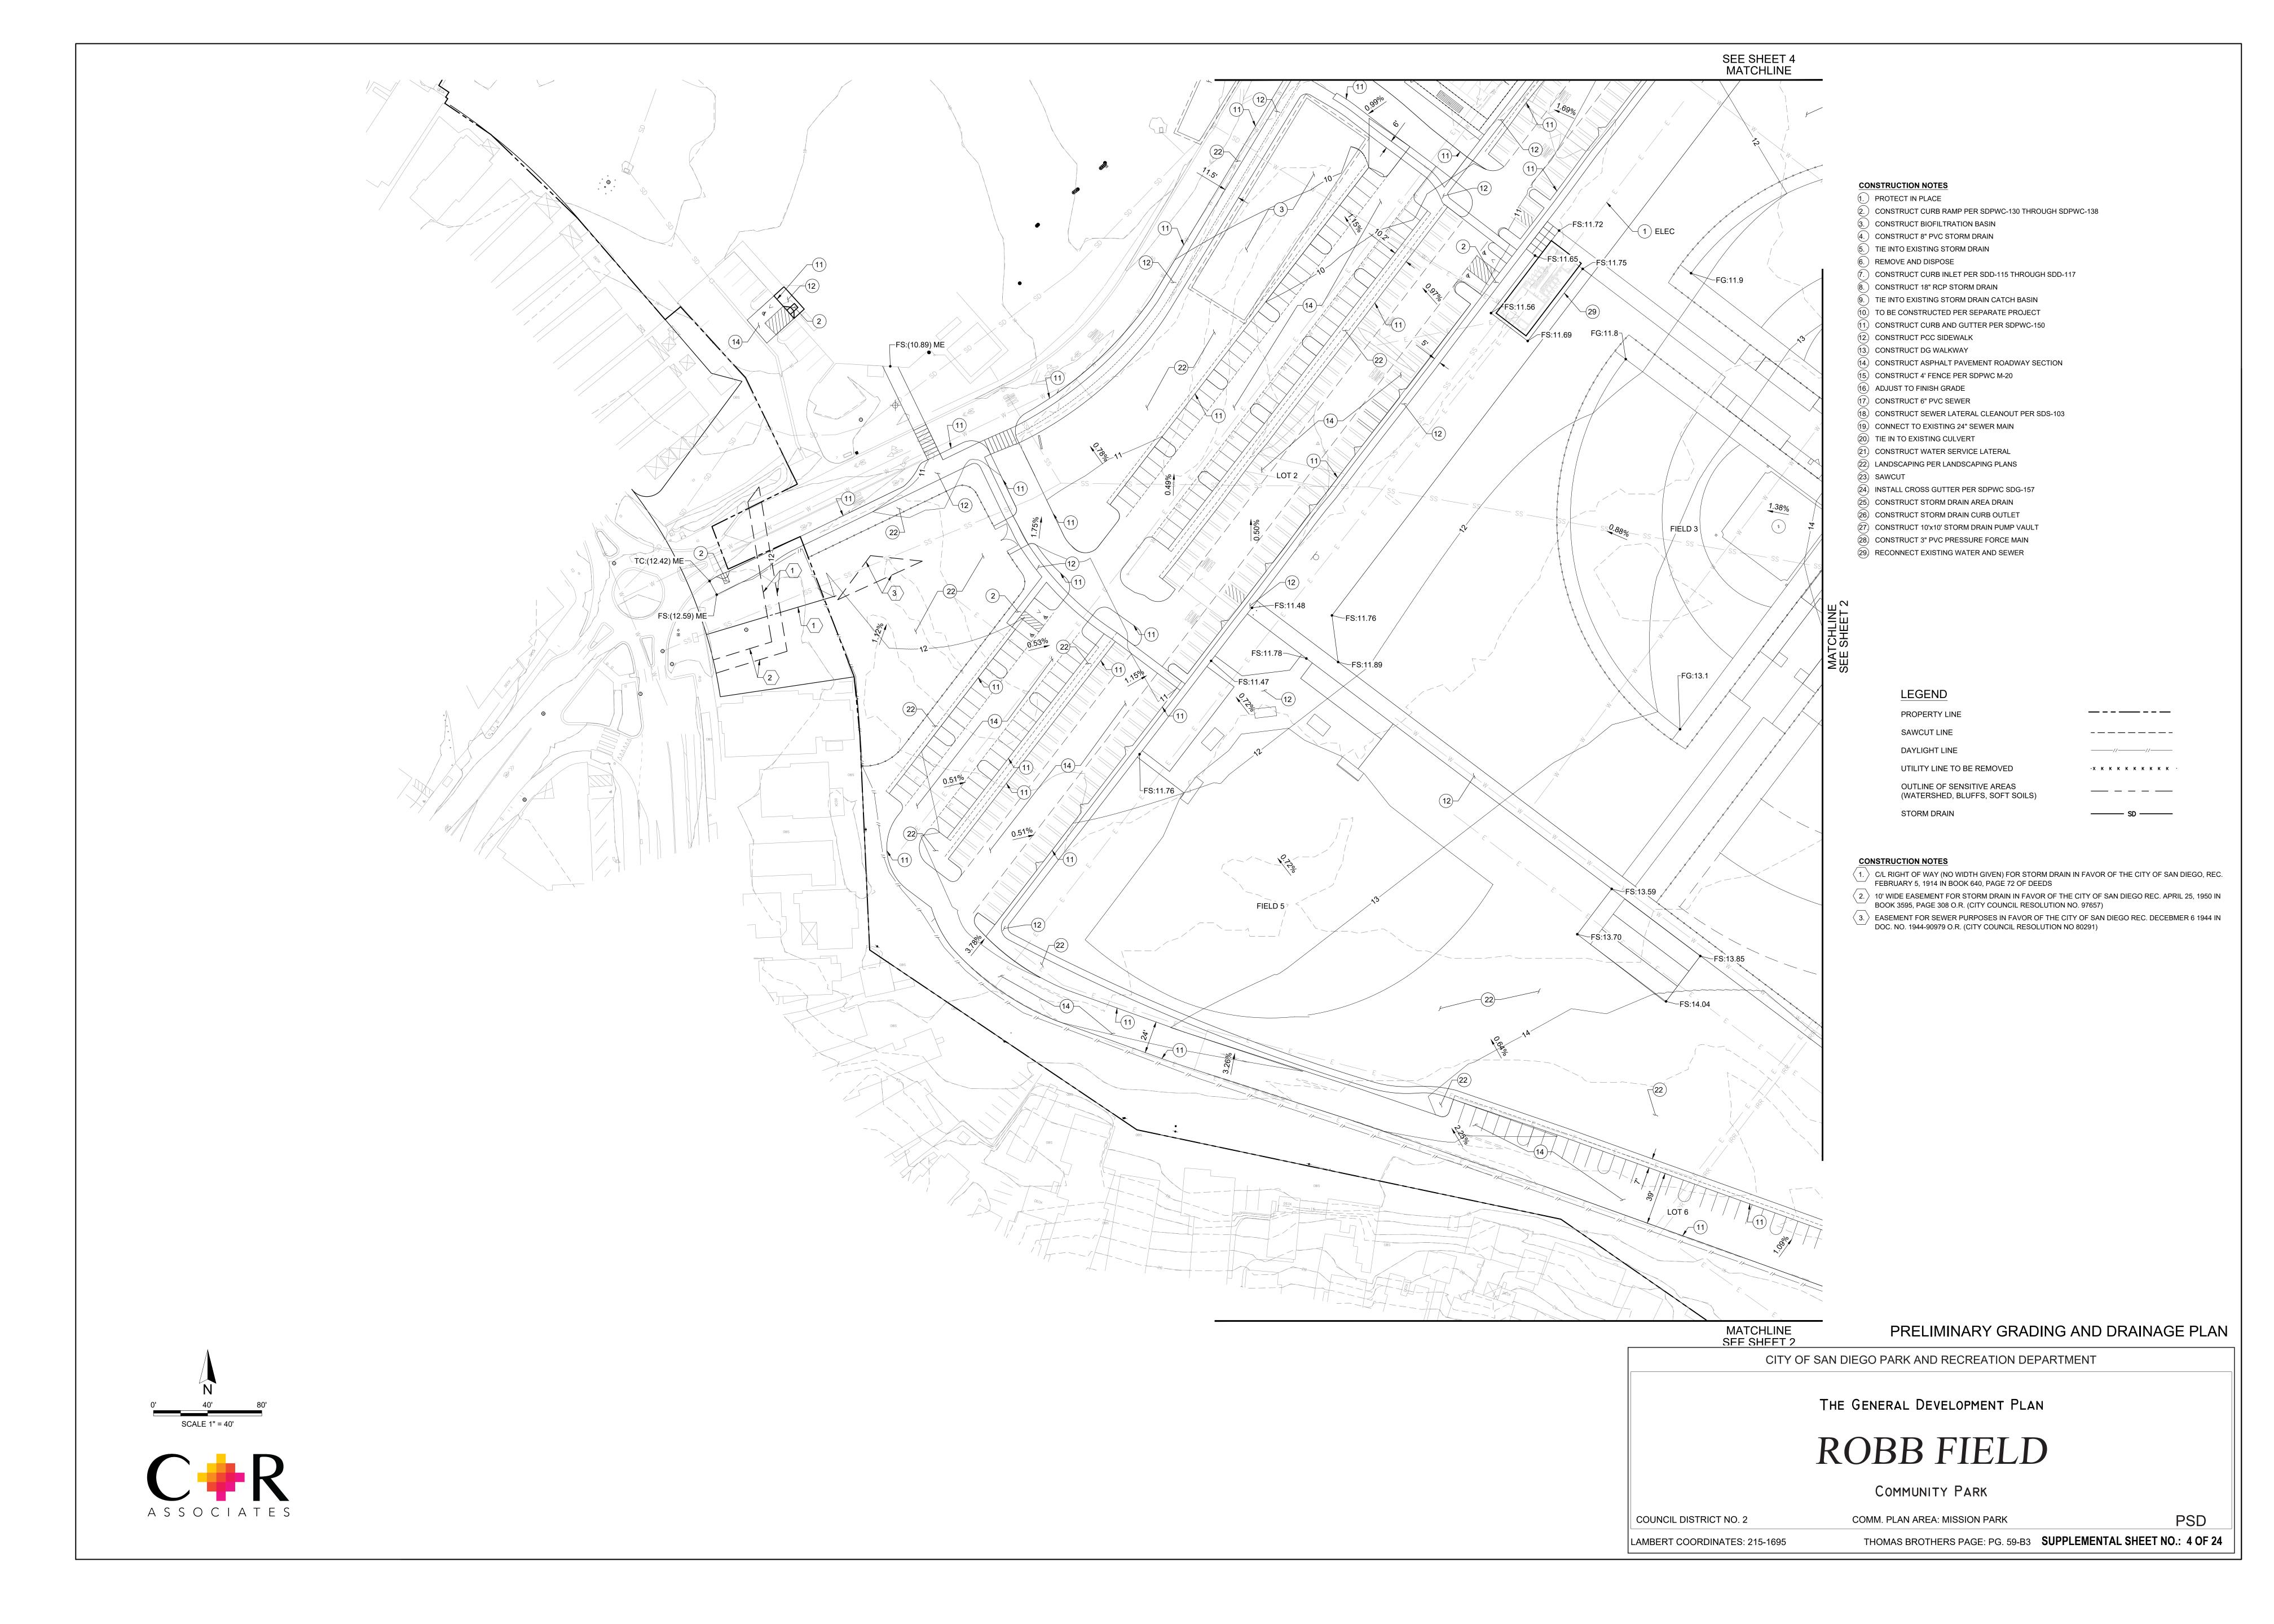
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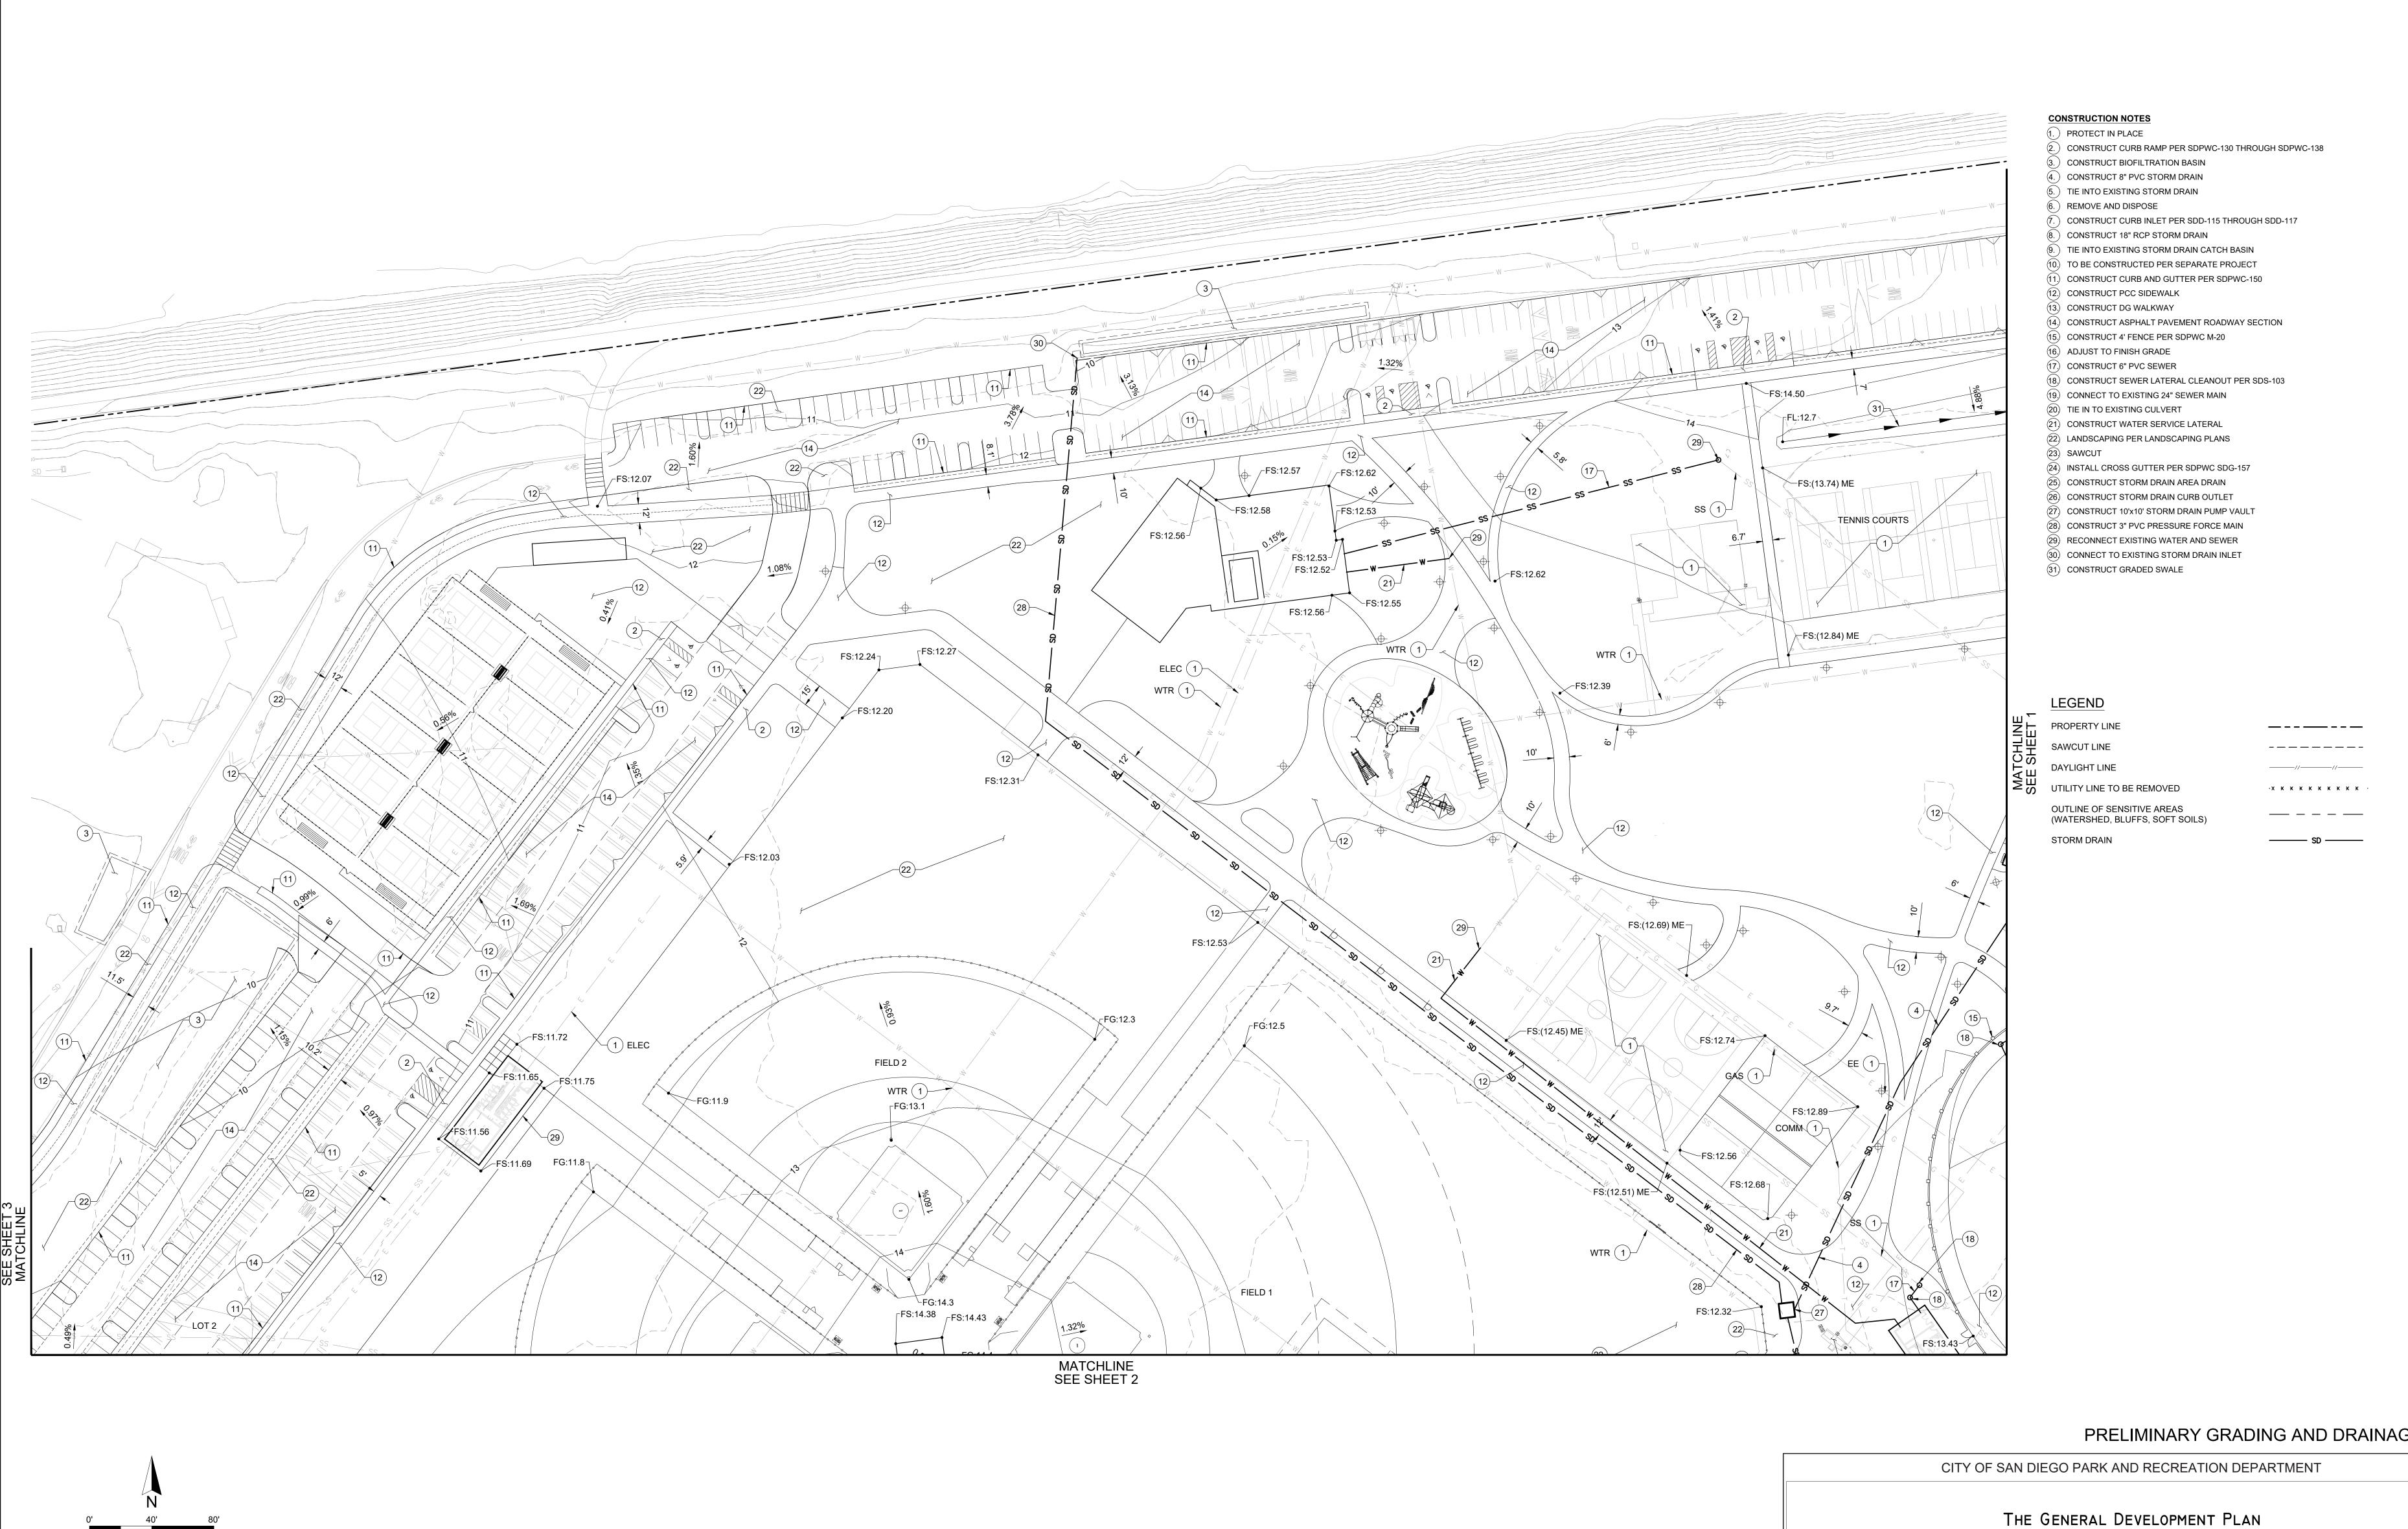


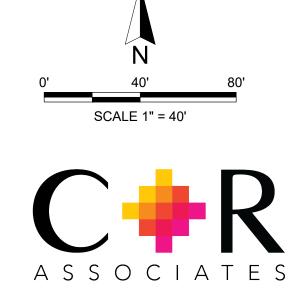
SUPPLEMENTAL SHEET NO.: 1 OF 24 THOMAS BROTHERS PAGE: PG. 59-B3











PRELIMINARY GRADING AND DRAINAGE PLAN

ROBB FIELD

COMMUNITY PARK

COUNCIL DISTRICT NO. 2 COMM. PLAN AREA: MISSION PARK

PSD

LAMBERT COORDINATES: 215-1695

THOMAS BROTHERS PAGE: PG. 59-B3 SUPPLEMENTAL SHEET NO.: 5 OF 24

PROGRAM LEGEND

FITNESS CENTER

ADMINISTRATION

PUBLIC

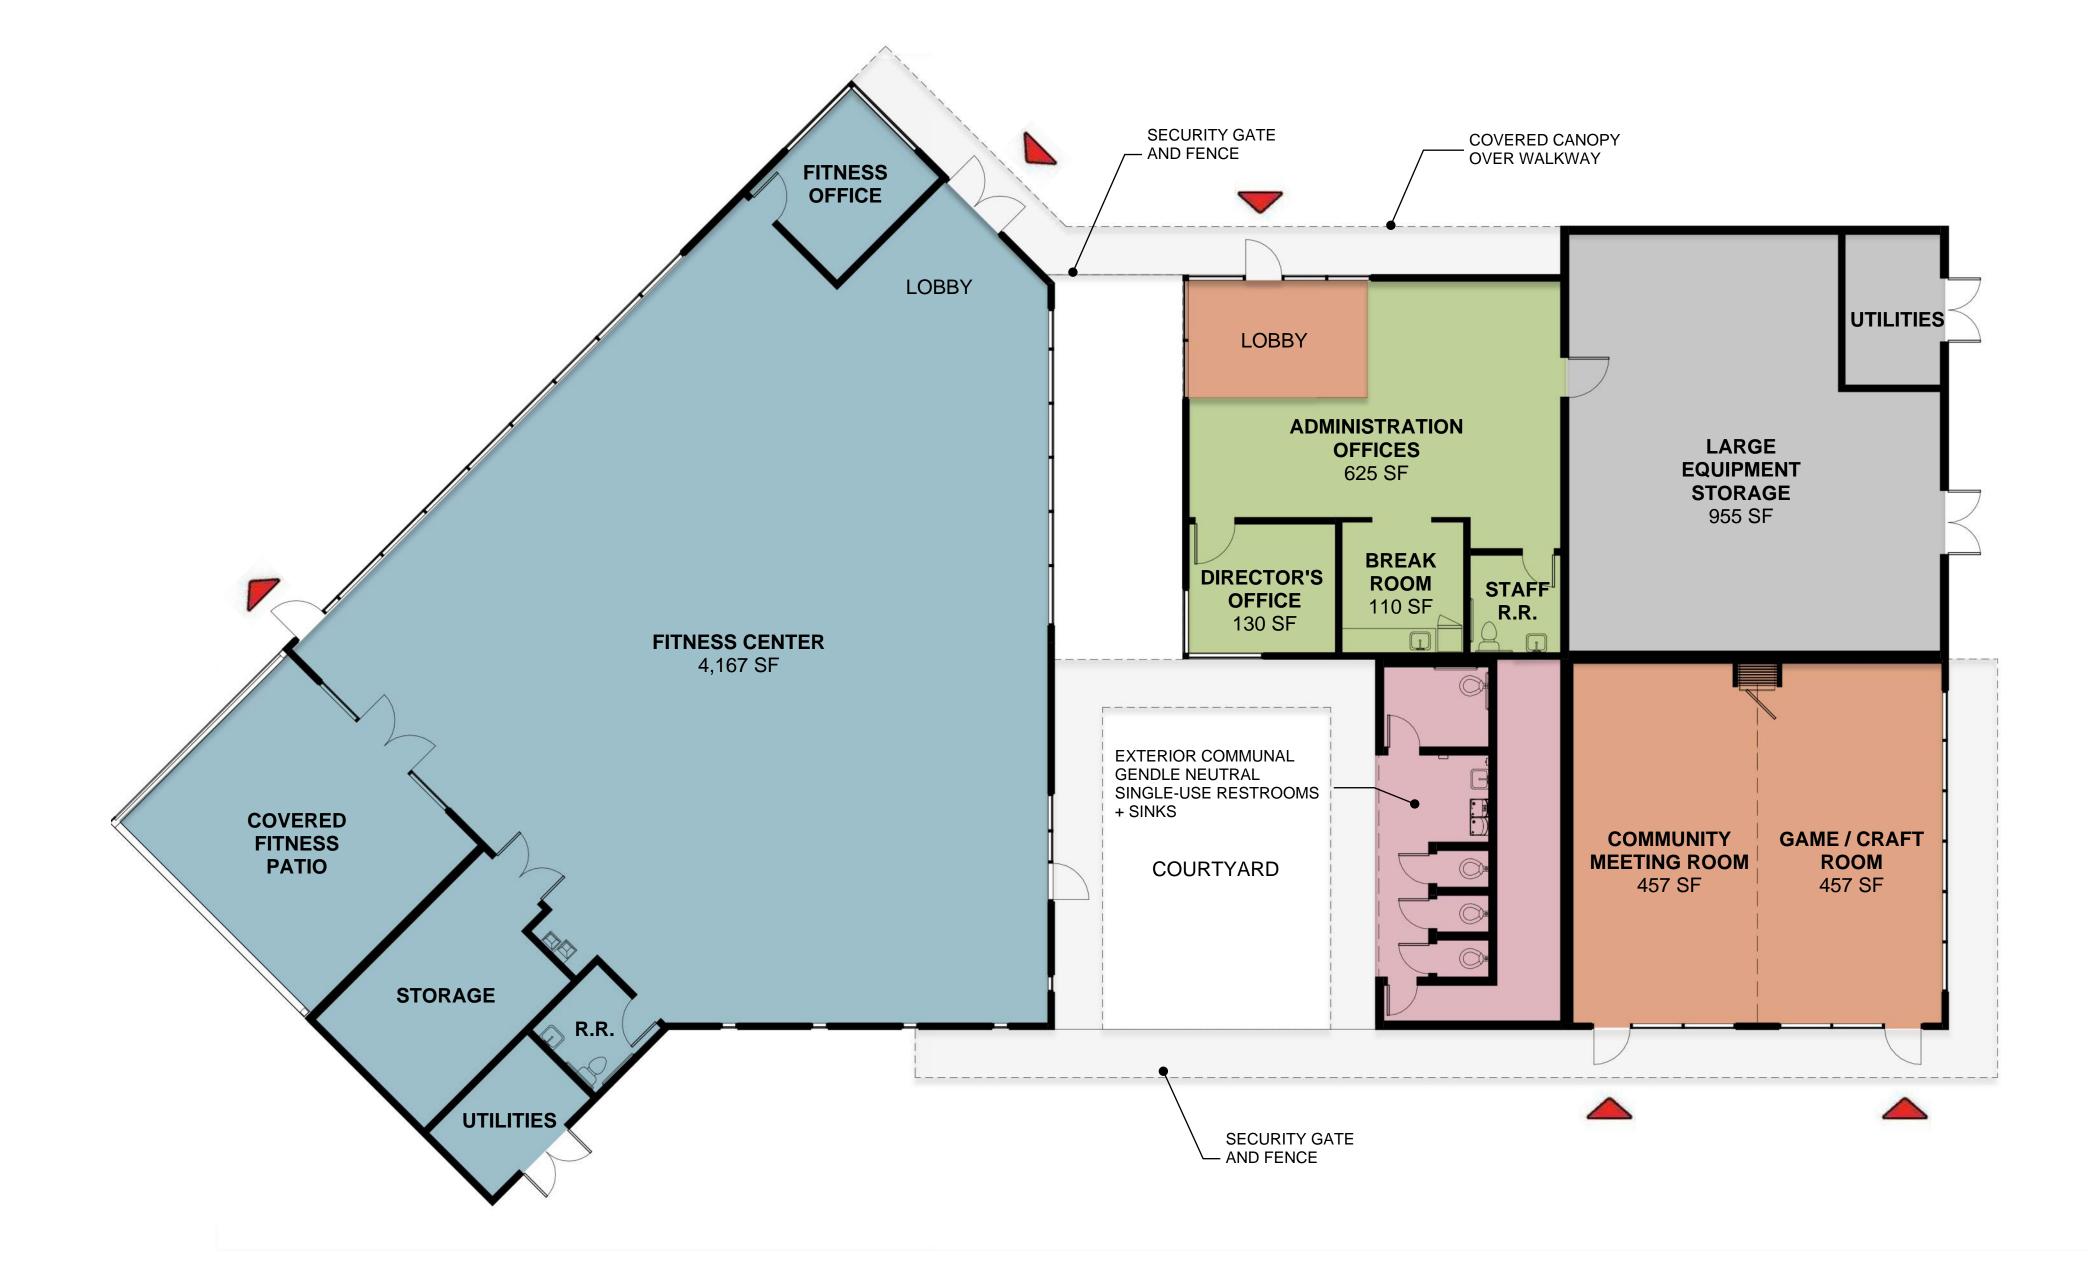
COMMUNAL RESTROOMS

STORAGE/ UTILITIES

> OVERHEAD LINES

ENTRY / EXIT

TOTAL BLDG SF: 7,781 SF



1 RECREATION CENTER - FLOOR PLAN 1/8" = 1'-0"



PRELIMINARY RECREATION CENTER FLOOR PLAN

THOMAS BROTHERS PAGE: PG. 59-B3 SUPPLEMENTAL SHEET NO.: 6 OF 24

THE GENERAL DEVELOPMENT PLAN ROBB FIELD

COMMUNITY PARK

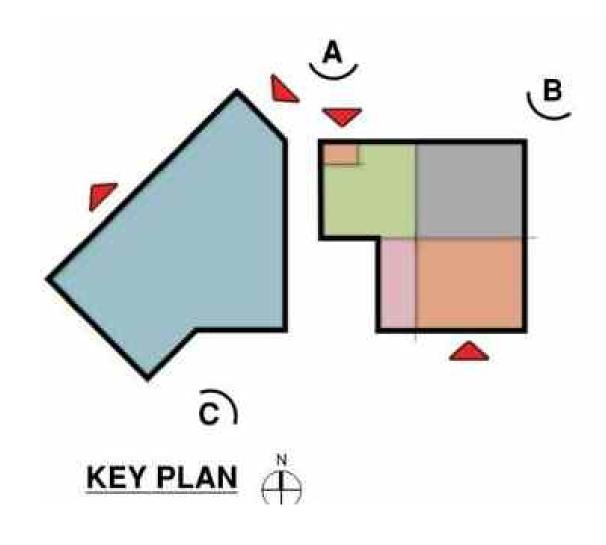
CITY OF SAN DIEGO PARK AND RECREATION DEPARTMENT

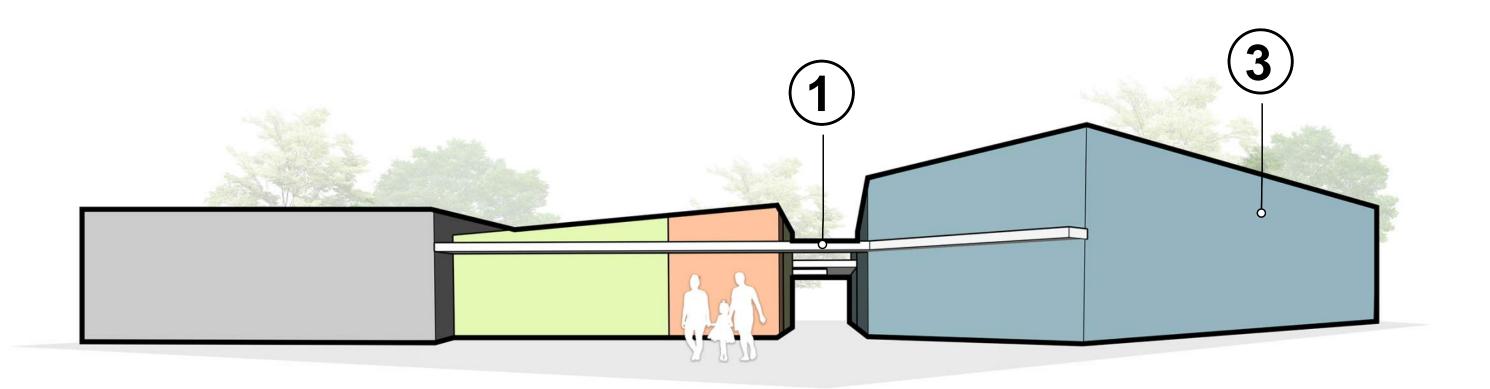
COUNCIL DISTRICT NO. 2 LAMBERT COORDINATES: 215-1695 COMM. PLAN AREA: MISSION PARK






TOTAL BLDG SF: 7,781 SF







NORTH PERSPECTIVE

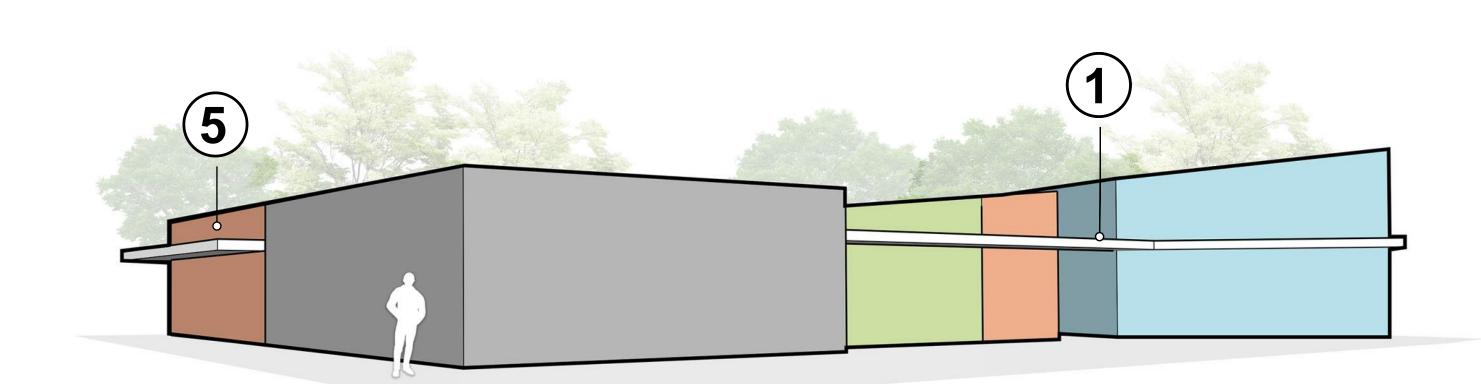

NORTHWEST PERSPECTIVE

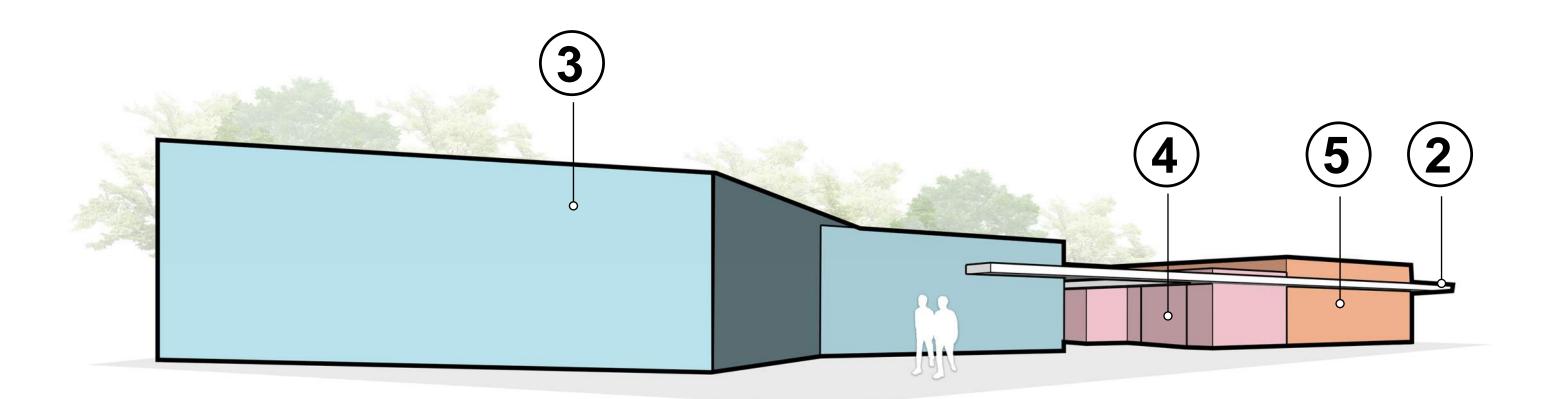


SOUTHEAST PERSPECTIVE

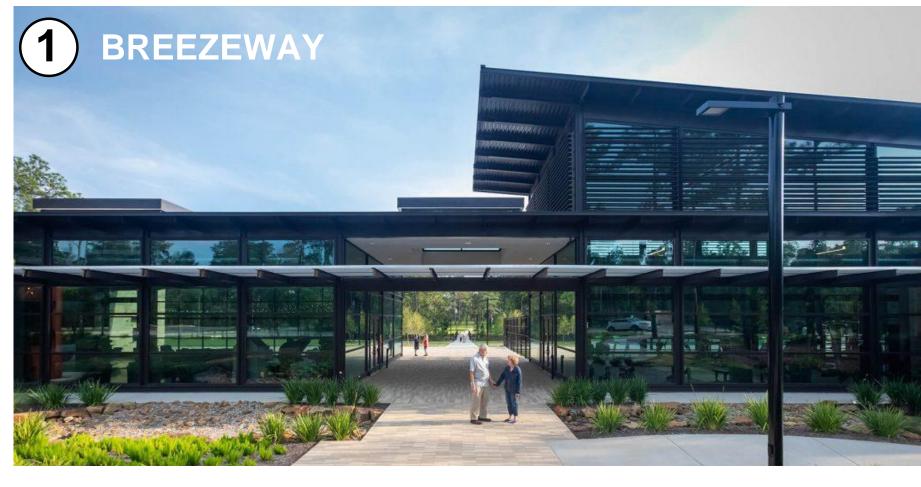





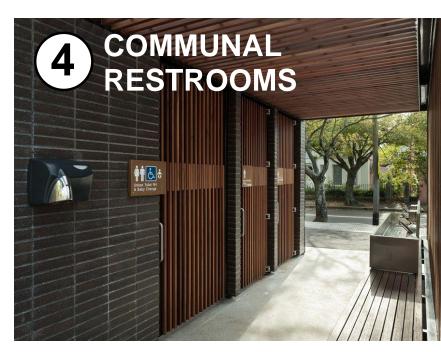



PRELIMINARY RECREATION CENTER PERSPECTIVES AND INSPIRATION

CITY OF SAN DIEGO PARK AND RECREATION DEPARTMENT

THE GENERAL DEVELOPMENT PLAN

ROBB FIELD

COMMUNITY PARK

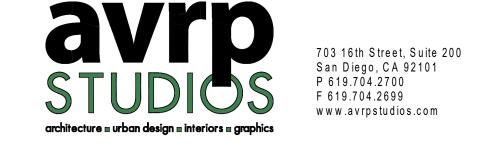
LAMBERT COORDINATES: 215-1695

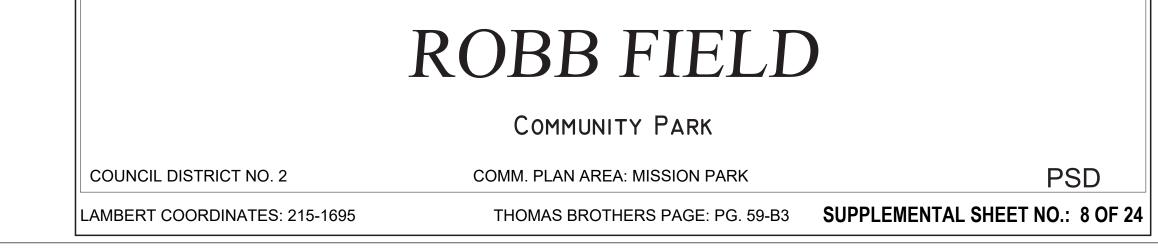
COMM. PLAN AREA: MISSION PARK



COUNCIL DISTRICT NO. 2

THOMAS BROTHERS PAGE: PG. 59-B3 SUPPLEMENTAL SHEET NO.: 7 OF 24





PRELIMINARY PHASE 1 COMFORT STATION FLOOR PLAN

THE GENERAL DEVELOPMENT PLAN

CITY OF SAN DIEGO PARK AND RECREATION DEPARTMENT

1 COMFORT STATION - FLOOR PLAN 1/4" = 1'-0"

TOTALS 2 ACCESSIBLE RESTROOMS, GENDER NEUTRAL 2 AMBULATORY RESTROOMS, GENDER NEUTRAL 6 STANDARD RESTROOMS, GENDER NEUTRAL 4 EXTERIOR LAVATORIES

COMFORT STATION BUILDING = 1,152 GROSS SQUARE FEET (GSF)

DRINKING FOUNTAINS AND WATER BOTTLE -FILLING STATION PERC MACHINE ACCESSIBLE RESTROOM EXTERIOR COMMUNAL SINKS

EXTERIOR COMMUNAL SINKS ACCESSIBLE PERC MACHINE

AMBULATORY

AMBULATORY STALL

_ SLIDING GATE ON V-GROOVE TRACK

460 SF

_ SLIDING GATE ON V-GROOVE TRACK

---- ROOF OVERHANG

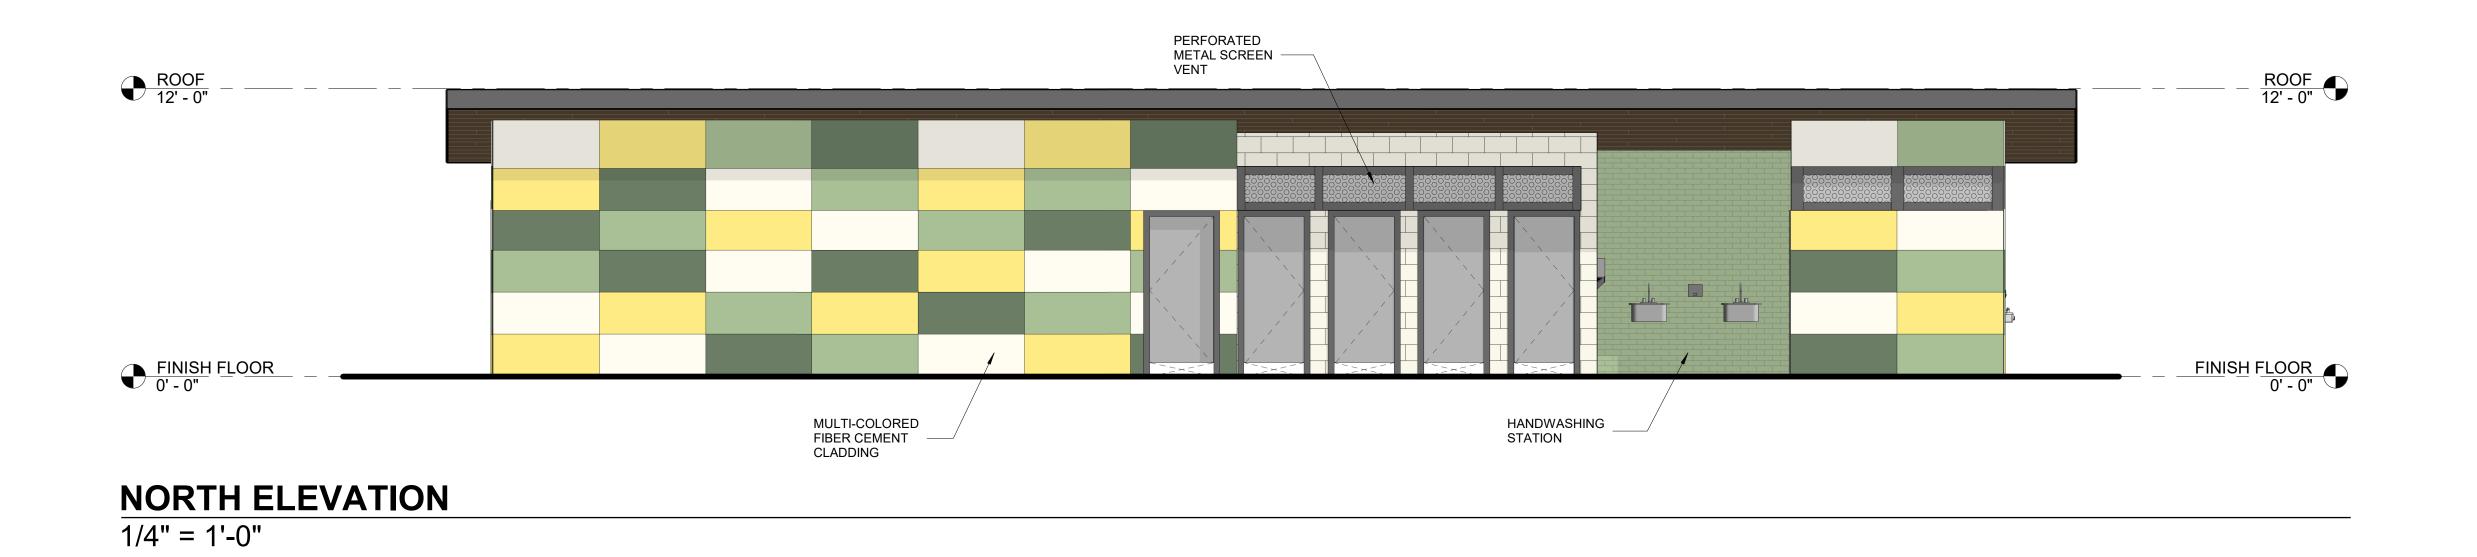
PERC MACHINE

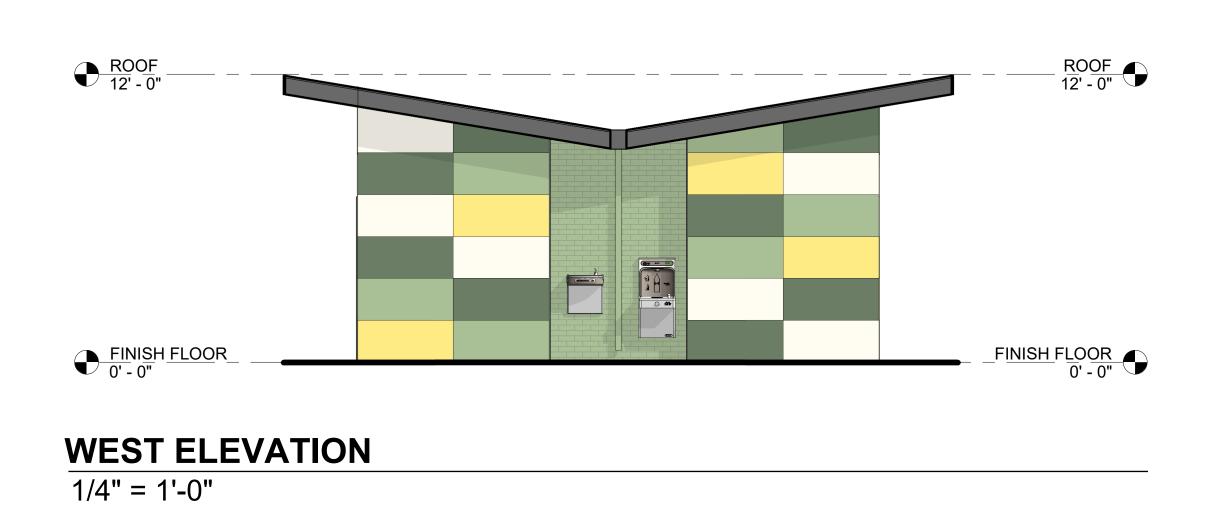
GOLF CART

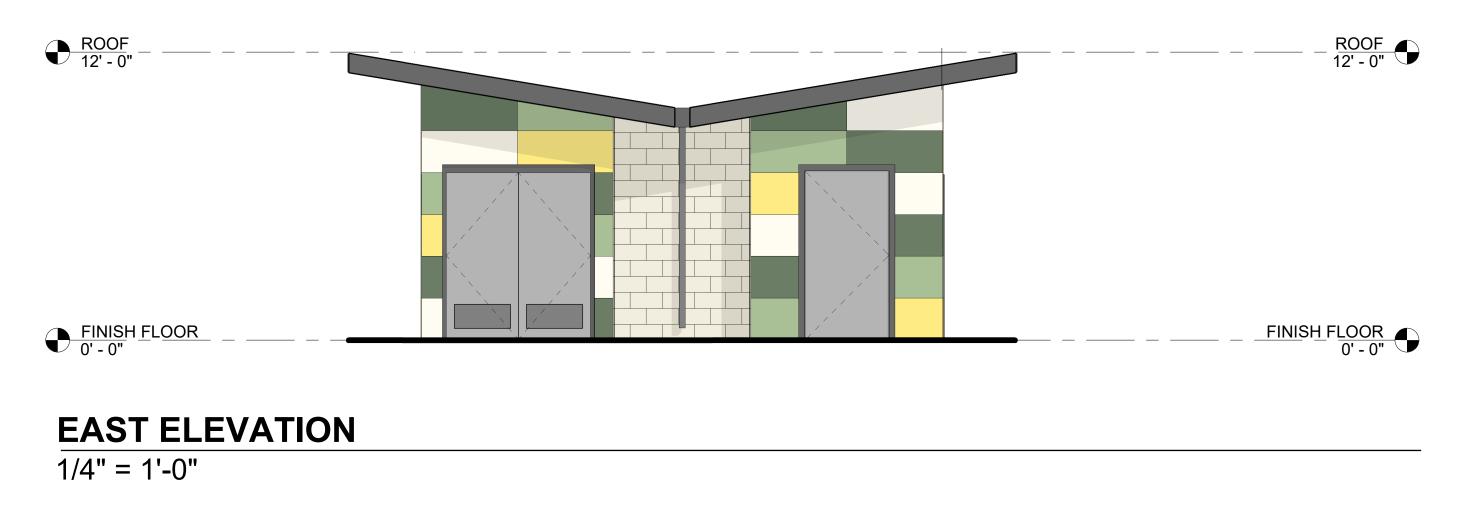
— EYE WASH STATION

ELECTRICAL









PRELIMINARY PHASE 1 COMFORT STATION ELEVATIONS

CITY OF SAN DIEGO PARK AND RECREATION DEPARTMENT

THE GENERAL DEVELOPMENT PLAN

ROBBFIELD

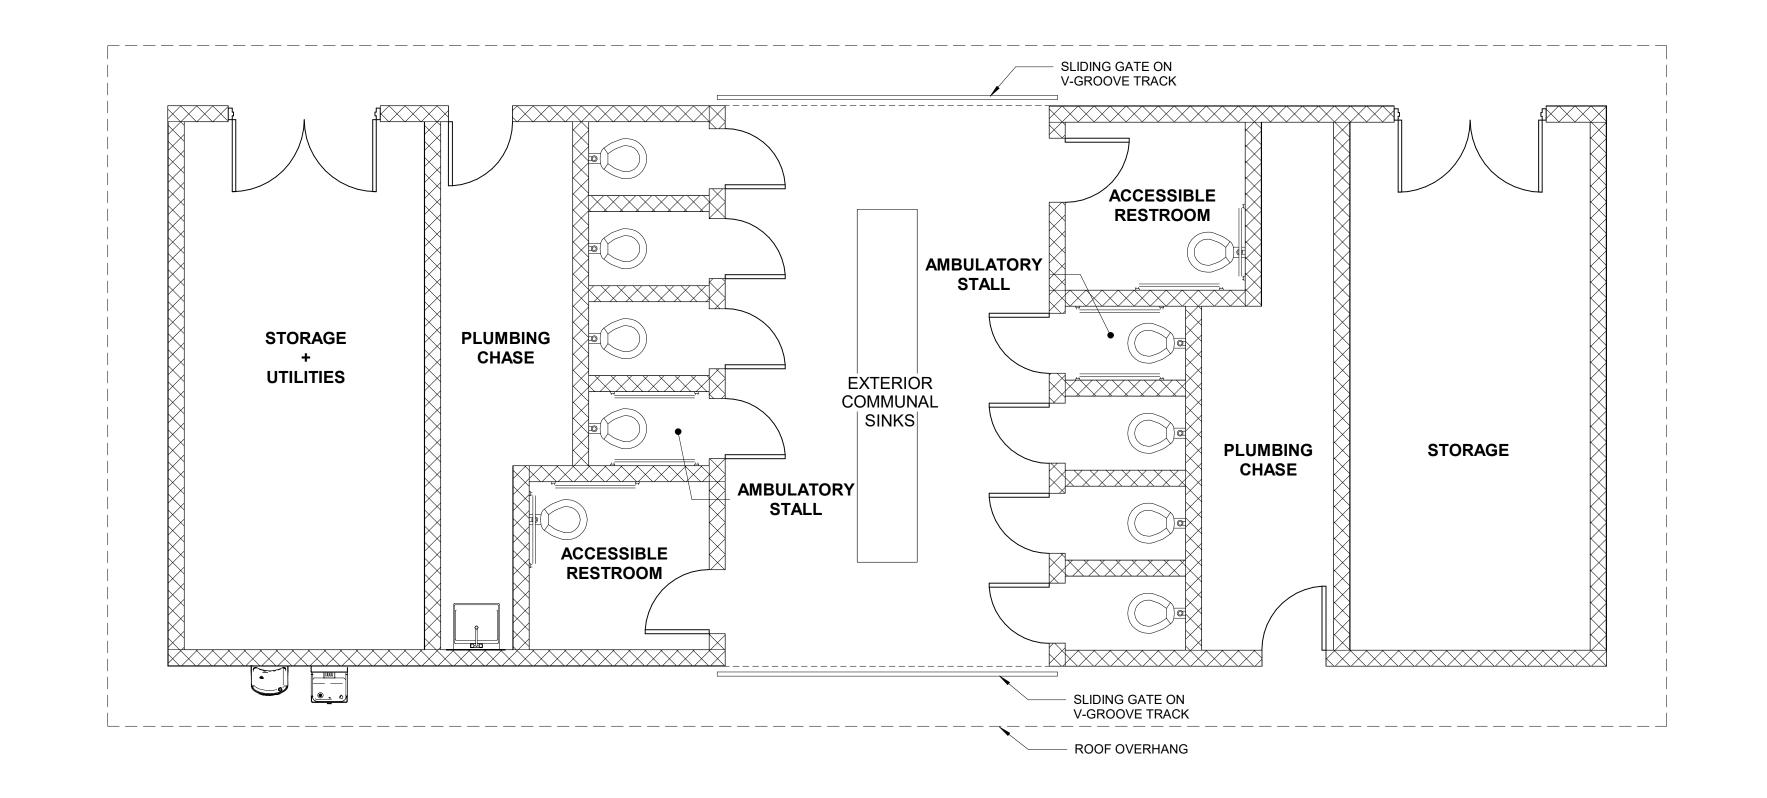
COMMUNITY PARK

COUNCIL DISTRICT NO. 2 COMM. PLAN AREA: MISSION PARK

PSD

LAMBERT COORDINATES: 215-1695 THOMAS BROTHERS PAGE: PG. 59-B3 SUPPLEMENTAL SHEET NO.: 9 OF 24





COMFORT STATION BUILDING = 1,152 GROSS SQUARE FEET (GSF)

TOTALS

2 ACCESSIBLE RESTROOMS, GENDER NEUTRAL 2 AMBULATORY RESTROOMS, GENDER NEUTRAL 6 STANDARD RESTROOMS, GENDER NEUTRAL 4 EXTERIOR LAVATORIES

1) COMFORT STATION - FLOOR PLAN 1/4" = 1'-0"



PRELIMINARY PHASE 2 COMFORT STATION FLOOR PLAN

CITY OF SAN DIEGO PARK AND RECREATION DEPARTMENT

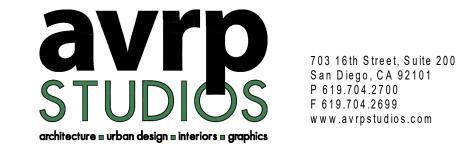
THE GENERAL DEVELOPMENT PLAN

ROBB FIELD

COMMUNITY PARK

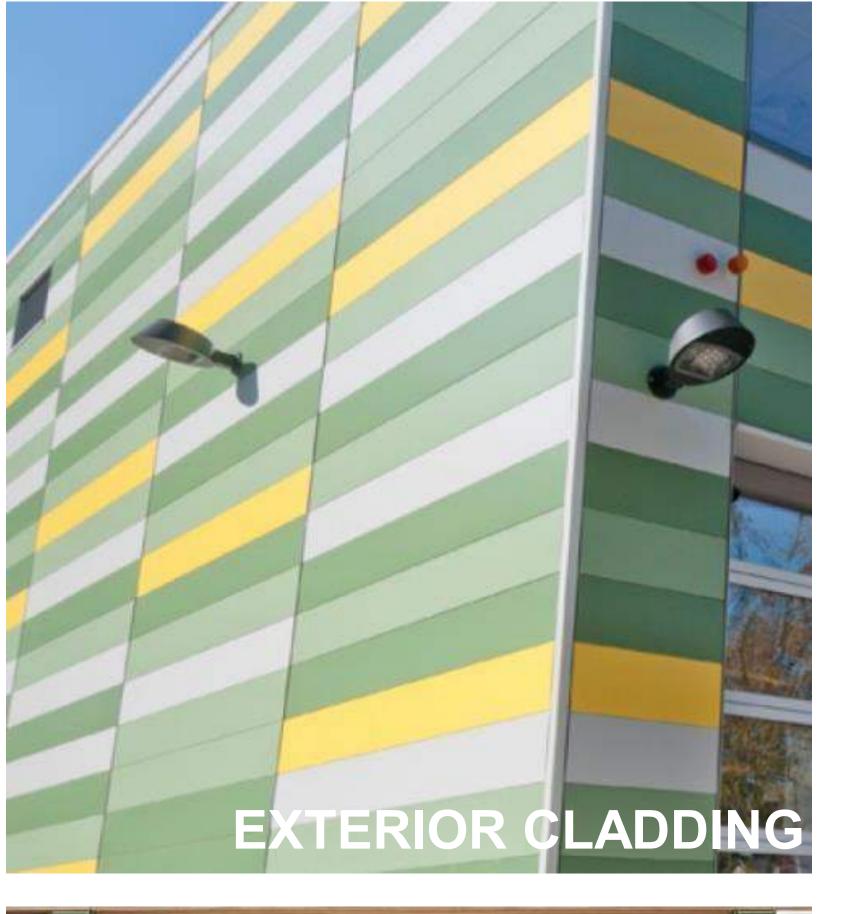
COUNCIL DISTRICT NO. 2 COMM. PLAN AREA: MISSION PARK PSD

LAMBERT COORDINATES: 215-1695 THOMAS BROTHERS PAGE: PG. 59-B3 SUPPLEMENTAL SHEET NO.: 10 OF 24

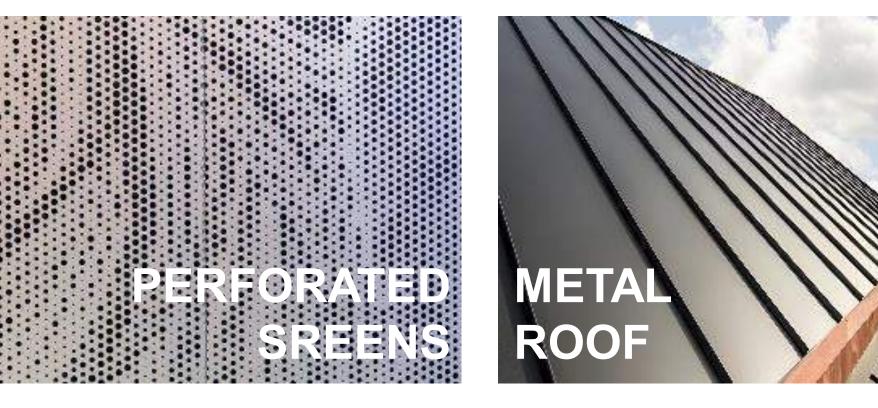


















CITY OF SAN DIEGO PARK AND RECREATION DEPARTMENT

THE GENERAL DEVELOPMENT PLAN

ROBB FIELD

COMMUNITY PARK

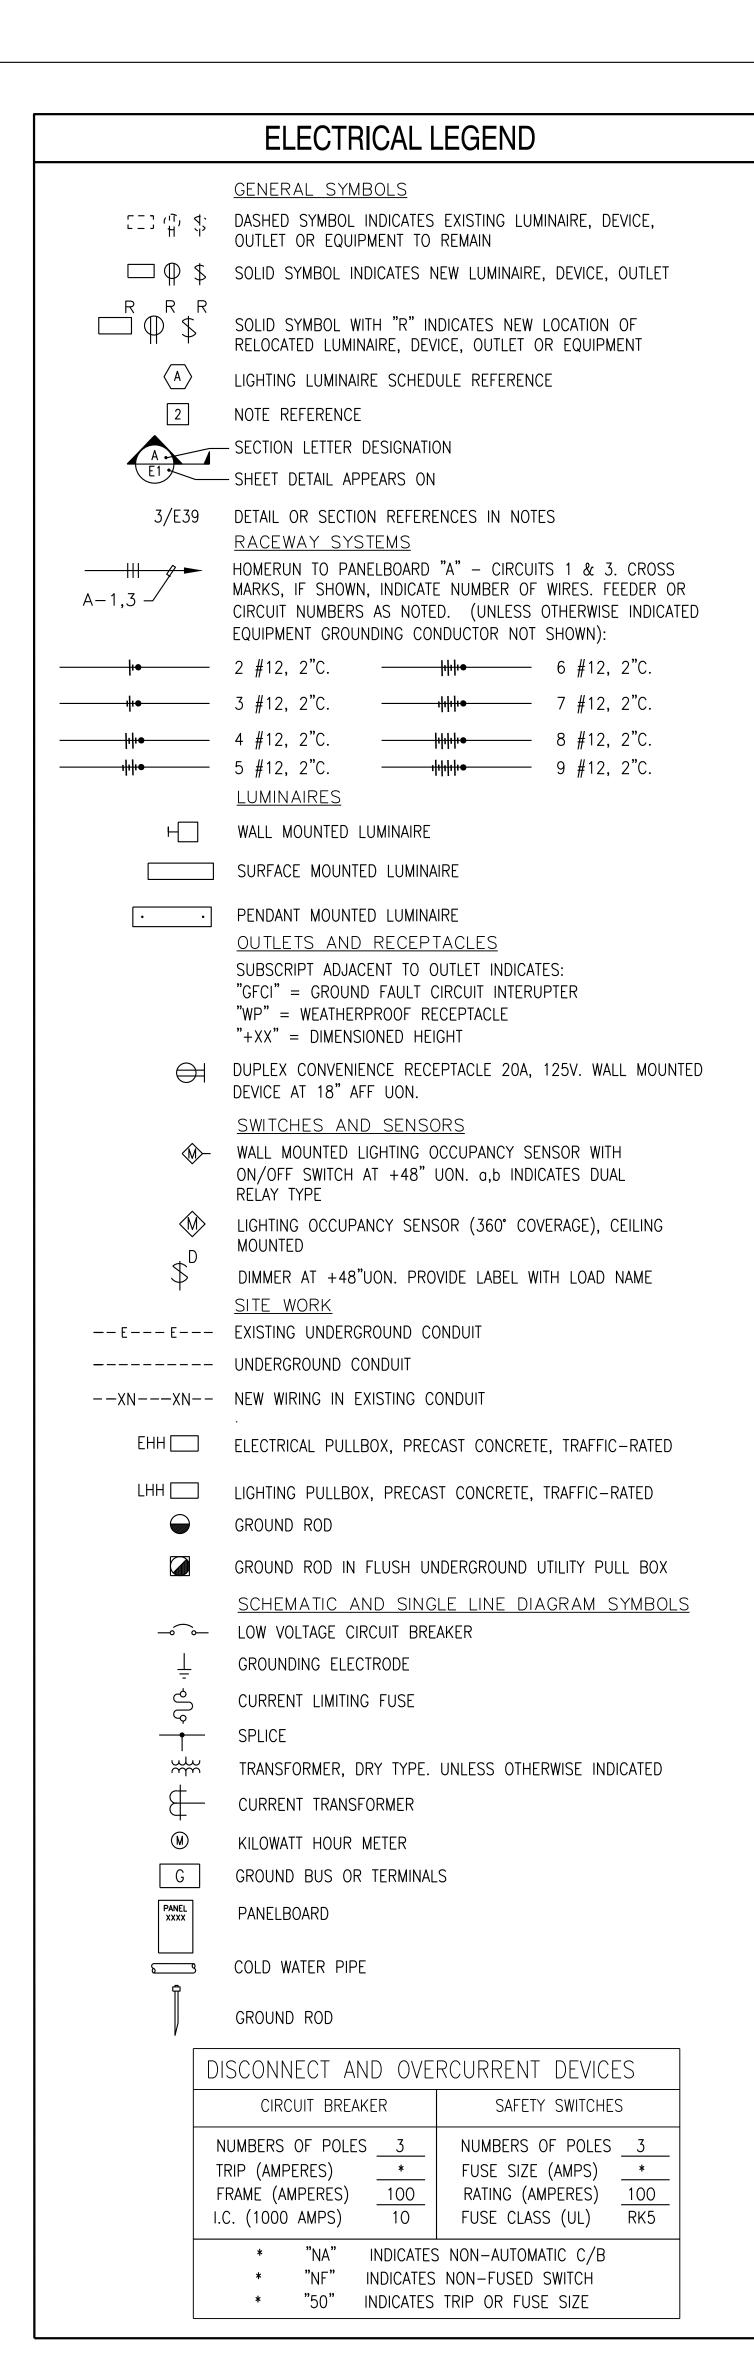
COUNCIL DISTRICT NO. 2

LAMBERT COORDINATES: 215-1695

COMM. PLAN AREA: MISSION PARK

THOMAS BROTHERS PAGE: PG. 59-B3 SUPPLEMENTAL SHEET NO.: 11 OF 24





ABBREV	DESCRIPTION	ABBREV	DESCRIPTION
Α	AMPERE	LHH	LIGHTING HANDHOLE
AC	ALTERNATING CURRENT	LTG	LIGHTING
AF	AMP FRAME	MAX	MAXIMUM
AFF	ABOVE FINISHED FLOOR	MIN	MINIMUM
АТ	AMP TRIP	MOCP	MAXIMUM OVERCURRENT PROTECTION
AWG	AMERICAN WIRE GAUGE	MTS	MANUAL RECOGNIZED TESTING LABORATORY
ВС	BARE COPPER CONDUCTER	NRTL	NATIONALLY RECOGNIZED TESTING LABORATORY
С	CONDUIT	NTS	NOT TO SCALE
CEC	CALIFORNIA ELECTRICAL CODE	Р	POLE
C.O.	CONDUIT ONLY	PVC	POLYVINYL CHLORIDE
CONC	CONCRETE	SCH	SCHEDULE
CU	COPPER	SDG&E	SAN DIEGO GAS & ELECTRIC COMPANY
(E)	EXISTING TO REMAIN	SEC	SECONDARY
ЕНН	ELECTRIC METALLIC TUBING	THHN	THERMOPLASTIC HIGH HEAT RESISTANT NYLON COATED WIRE
EMT	ELECTRIC METALLIC TUBING	THWN	THERMOPLASTIC HIGH WATER RESISTANT NYLON COATED WIRE
G	GROUND OR GENERATOR	TRANSF	TRANSFORMER
GALV	GALVANIZED	TYP	TYPICAL
GND	GROUNDED	UG	UNDERGROUND
JB	JUNCTION BOX	UON	UNLESS OTHERWISE NOTED
KCM	1000 CIRCULAR MILS	V	VOLT
KVA	KILOVOLT AMPERER	VA	VOLTAMPERE
KVAR	KILOVOT AMPERES, REACTIVE	WM	WATTMETER
KW	KILOWATT	WP	WEATHERPROOF
KWH	KILOWATT HOUR	XFMR	TRANSFORMER
L	LOAD		

ELECTRICAL GENERAL NOTES

- THE FOLLOWING GENERAL NOTES APPLY TO ALL ELECTRICAL DRAWINGS.
- INSTALLATION OF ELECTRICAL MATERIAL MUST CONFORM WITH LOCAL REGULATIONS AND THE 2022 CALIFORNIA ELECTRICAL CODE (CEC), PUBLIC WORKS 2021 GREEN BOOK AND WHITE BOOK, WHITE BOOK AND OTHER GOVERNING CODES AND ORDINANCES.
- ALL ELECTRICAL EQUIPMENT MUST BE NRTL LABELED.
- THE CONTRACTOR MUST VISIT THE SITE INCLUDING ALL AREAS INDICATED ON THE DRAWINGS. THEY MUST THOROUGHLY FAMILIARIZE THEMSELVES WITH THE EXISTING CONDITIONS AND BY SUBMITTING A BID ACCEPTS CONDITIONS UNDER WHICH THEY WILL BE REQUIRED TO PERFORM THEIR WORK.
- IT WILL BE THE ELECTRICAL CONTRACTOR'S RESPONSIBILITY TO OBTAIN A COMPLETE SET OF DRAWINGS AND SPECIFICATIONS. THEY MUST CHECK THE DRAWINGS OF THE OTHER TRADES AND WILL CAREFULLY READ THE ENTIRE SPECIFICATIONS AND DETERMINE THEIR RESPONSIBILITIES. FAILURE TO DO SO WILL NOT RELEASE THE CONTRACTOR FROM DOING THE WORK IN COMPLETE ACCORDANCE WITH THE DRAWINGS AND SPECIFICATIONS.
- THE CONTRACTOR MUST COORDINATE THEIR WORK WITH OTHER TRADES AT THE SITE. ANY COST TO ROUTE CONDUIT OTHER THAN AS SHOWN ON THE PLANS SHALL BE INCURRED BY THE CONTRACTOR.
- WHEREVER A DISCREPANCY IN QUANTITY OR SIZE OF CONDUIT, WIRE, EQUIPMENT DEVICES, CIRCUIT BREAKERS, TRANSFORMERS, GROUND FAULT PROTECTION SYSTEM, ETC. (ALL MATERIALS) ARISES ON THE DRAWINGS AND/OR SPECIFICATIONS, THE CONTRACTOR WILL BE RESPONSIBLE FOR PROVIDING AND INSTALLING ALL MATERIAL AND SERVICES REQUIRED BY THE STRICTEST CONDITIONS NOTED ON DRAWINGS AND/OR IN THE SPECIFICATIONS TO ENSURE COMPLETE AND OPERABLE SYSTEMS TO THE SATISFACTION OF THE RESIDENT
- ALL CONDUIT SIZES ARE BASED ON COPPER CONDUCTORS WITH THHN/THWN-2 INSULATION UNLESS OTHERWISE NOTED. ALL CONDUCTORS SHALL BE COPPER #12 AWG MINIMUM SIZE, TYPE THHN/THWN-2 THERMOPLASTIC, 600 VOLT, 75 DEGREES CELSIUS WET AND 90 DEGREES CELSIUS DRY AND UL LISTED UNLESS NOTED OTHERWISE. CONDUCTORS #12 AWG AND LARGER SHALL BE STRANDED.
- MINIMUM CONDUIT SIZE FOR ALL UNDERGROUND INSTALLATION SHALL BE 2" UNLESS OTHERWISE NOTED.
- . PROVIDE PROPERLY SIZED LUGS AT ALL CIRCUIT BREAKER PANELS, FOR THE CONDUCTORS SHOWN TO CONNECT TO THESE LUGS.
- INSTALL ALL EXTERIOR MOUNTED ELECTRICAL EQUIPMENT IN WEATHERPROOF, NEMA 3R ENCLOSURES.
- SEPARATE INSULATED EQUIPMENT GROUNDING CONDUCTOR, SIZED PER CEC TABLE 250.122. SHALL BE PROVIDED, INSTALLED IN THE SAME CONDUIT AS THE CIRCUIT CONDUCTORS. FOR ALL FEEDER AND BRANCH CIRCUITS.
- 3. THE SEISMIC BRACING AND ANCHORAGE OF ELECTRICAL CONDUITS, BUS DUCT, WIREWAY AND CABLE TRAY SHALL BE IN ACCORDANCE WITH THE "GUIDELINE FOR SEISMIC RESTRAINTS OF MECHANICAL SYSTEMS AND PLUMBING PIPING SYSTEMS", PUBLISHED BY SMACNA AND PPIC.
- 4. ALL ELECTRICAL EQUIPMENT MUST BE BRACED OR ANCHORED TO RESIST A HORIZONTAL FORCE ACTING IN ANY DIRECTION USING THE FOLLOWING CRITERIA:

FIXED EQUIPMENT ON GRADE 20% OF OPERATING WEIGHT FIXED EQUIPMENT ON STRUCTURE 30% OF OPERATING WEIGHT EMERGENCY POWER & COMMUNICATION 50% OF OPERATING WEIGHT EQUIPMENT ON GRADE EMERGENCY POWER & COMMUNICATION EQUIPMENT ON STRUCTURE 75% OF OPERATING WEIGHT

FOR FLEXIBLY MOUNTED EQUIPMENT USED FOUR (4) TIMES THE ABOVE VALUES, AND FOR SIMULTANEOUS VERTICAL FORCE USE ONE-THIRD (1/3) TIMES THE HORIZONTAL FORCE. WHERE ANCHORAGE DETAILS ARE NOT SHOWN ON THE DRAWINGS THE FIELD INSTALLATION WILL BE SUBJECT TO THE APPROVAL OF THE CITY RESIDENT ENGINEER. WHERE ANCHORAGE IS INDICATED ON THE CONTRACT DOCUMENTS REVIEWED BY RESIDENT ENGINEER, ANCHORAGE SHALL BE AS PER THE CONTRACT DOCUMENTS.

ALL ELECTRICAL MATERIALS AND EQUIPMENT MUST BE NEW AND MUST BE LISTED BY UNDERWRITER'S LABORATORIES (UL) AND BEAR THEIR LABEL, OR LISTED AND CERTIFIED BY A NATIONALLY RECOGNIZED TESTING AUTHORITY WHERE UL DOES NOT HAVE A LISTING. CUSTOM MADE EQUIPMENT MUST HAVE COMPLETE TEST DATA SUBMITTED BY THE MANUFACTURER ATTESTING TO ITS SAFETY. IN ADDITION, THE MATERIALS, EQUIPMENT, AND INSTALLATION MUST COMPLY WITH THE REQUIREMENTS OF THE FOLLOWING:

AMERICAN SOCIETY OF TESTING MATERIALS (ASTM) INSULATED POWER CABLE ENGINEERS ASSOCIATION (IPCEA) NATIONAL ELECTRICAL MANUFACTURERS ASSOCIATION (NEMA) AMERICAN STANDARD ASSOCIATION (ASSA) NATIONAL FIRE PROTECTION AGENCY (NFPA) AMERICAN NATIONAL STANDARD INSTITUTE (ANSI) CALIFORNIA ELECTRICAL CODE (CEC) CALIFORNIA CODE OF REGULATIONS TITLE 24 (CCR) INSTITUTE OF ELECTRICAL AND ELECTRONIC ENGINEERS (IEEE) ALL LOCAL CODES HAVING JURISDICTION

WHERE THE CODES HAVE DIFFERENT LEVELS OF REQUIREMENTS, THE MOST STRINGENT RULE WILL APPLY.

- AFTER ALL REQUIREMENTS OF THE SPECIFICATIONS AND/OR THE DRAWINGS HAVE BEEN FULLY COMPLETED. REPRESENTATIVES OF THE CITY/RESIDENT ENGINEER WILL INSPECT THE WORK. THE CONTRACTOR MUST PROVIDE COMPETENT PERSONNEL TO DEMONSTRATE THE OPERATION OF ANY ITEM OR SYSTEM TO THE FULL SATISFACTION OF EACH REPRESENTATIVE. FINAL ACCEPTANCE OF THE WORK WILL BE MADE BY THE RESIDENT ENGINEER AFTER RECEIPT OF APPROVAL AND RECOMMENDATION OF ACCEPTANCE FROM EACH CITY REPRESENTATIVE.
- EXACT METHOD AND LOCATION OF CONDUIT PENETRATION AND OPENINGS IN CONCRETE WALLS OR FLOORS OR STRUCTURAL STEEL MEMBERS MUST BE AS DIRECTED BY THE STRUCTURAL ENGINEER. PERFORM CORING. SAWCUTTING. PATCHING. AND REFINISHING OF EXISTING WALLS AND SURFACES WHEREVER IT IS NECESSARY TO PENETRATE. OPENINGS MUST BE SEALED IN AN APPROVED METHOD TO MATCH EXISTING SEALED CONDITION OF THE PARTICULAR WALL, FLOOR. EXACT METHOD AND LOCATIONS OF CONDUIT PENETRATIONS AND OPENINGS IN CONCRETE WALLS OR FLOORS SHALL BE UL APPROVED.
- STRAIGHT FEEDER. BRANCH CIRCUIT. AND CONDUIT RUNS MUST BE PROVIDED WITH SUFFICIENT PULL BOXES OR JUNCTION BOXES TO LIMIT THE MAXIMUM LENGTH OF ANY SINGLE CABLE PULL TO 100 FEET. PULL BOXES SHALL BE SIZED PER CODE OR AS INDICATED ON DRAWINGS. LOCATIONS MUST BE DETERMINED IN THE FIELD OR AS INDICATED ON THE DRAWINGS.

ELECTRICAL GENERAL NOTES

- 19. DRAWINGS ARE DIAGRAMMATIC ONLY. ROUTING OF RACEWAYS MUST BE AT THE OPTION OF THE CONTRACTOR UNLESS OTHERWISE NOTED AND MUST BE COORDINATED WITH OTHER SECTIONS. DO NOT SCALE THE ELECTRICAL DRAWINGS FOR LOCATIONS OF ANY ELECTRICAL ARCHITECTURAL, STRUCTURAL, CIVIL, OR MECHANICAL ITEMS OR FEATURES.
- 20. BX AND MC CABLES MUST NOT BE USED AND ARE NOT ACCEPTABLE.
- 121. SHARING OF NEUTRAL WIRES AND USE OF MULTIWIRE BRANCH CIRCUIT ARE PROHIBITED. ONE NEUTRAL CONDUCTOR MUST BE PROVIDED FOR EVERY NEW NON-MULTIWIRE CIRCUIT.
- 22. ALL RACEWAYS MUST INCLUDE A FULL SIZE GREEN INSULATED EQUIPMENT GROUND WIRE TERMINATED AT EACH OUTLET BOX, DEVICE ENCLOSURE, ETC. AND CONNECTED BACK AT THE PANEL, SWITCHBOARD, OR CABINET ON THE APPROPRIATE GROUND BUS.
- 23. FLAT WIRING MUST NOT BE USED.
- 124. PROVIDE WIRE MARKER ON EACH CONDUCTOR IN ELECTRICAL PANEL, PULL BOX, POLE MOUNTED LUMINAIRE, HANDHOLE, OUTLET, AND JUNCTION BOX, IF MORE THAN ONE NEUTRAL IS PRESENT, MARK EACH RELATED CIRCUIT AND PANEL NUMBER.
- 25. CONTRACTOR TO PROVIDE ALL TITLE 24 ACCEPTANCE TEST AND FORMS TO COMPLY WITH TITLE 24.
- 26. ALL WIRING INSIDE THE BUILDING WILL BE IN EMT CONDUIT.
- 27. ALL EMT CONNECTOR, COUPLING, AND OTHER FITTINGS WILL BE NON-CAST STEEL COMPRESSION TYPE.
- 28. FLEXIBLE STEEL CONDUIT IS ALLOWED ONLY ON MOTOR CONNECTION AND FIXTURE TAILS, AND NOT OVER 6 FEET IN LENGTH.
- 29. ANY EXPOSE WIRING DEVICE BOX WILL BE IN CAST IRON ONLY. NO CAST ALUMINUM.
- \$\begin{align*} \] 30. ANY EXPOSED LIGHT FIXTURE JUNCTION BOX WILL BE CAST IRON ONLY. NO CAST ALUMINUM.
- 31. JUNCTION BOX SIZES WILL BE AT LEAST 4" SQUARE BY 1-1/8" DEEP.
- 32. ALL EXISTING SPORTS LIGHTING AND ASSOCIATED WIRING/CONTROLS IS OUT OF SCOPE, IS TO REMAIN IN PLACE AND OPERATIONAL UNLESS OTHERWISE NOTED.

PRELIMINARY LIGHTING AND ELECTRICAL PLANS

CITY OF SAN DIEGO PARK AND RECREATION DEPARTMENT

THE GENERAL DEVELOPMENT PLAN

ROBB FIELD

COMMUNITY PARK

COUNCIL DISTRICT NO. 2 COMM. PLAN AREA: MISSION PARK THOMAS BROTHERS PAGE: PG. 59-B3 SUPPLEMENTAL SHEET NO.: 12 OF 24 LAMBERT COORDINATES: 215-1695

BSE ENGINEERING, INC. 9903 BUSINESSPARK AVE, SUITE #104

BSE PROJECT NO. 21-0017-1016

OPTION	CALLOUT	SYMBOL	LAMP	DESCRIPTION	MODEL	
OPTION 1	A1a	•-□	57W LED 4000K 7119 LUMENS	AREA AND SITE LUMINAIRE ARM MOUNTED WITH DIE-CAST ALUMINUM HOUSING AND HEAT SINK.	COOPER LIGHTING SOLUTIONS GALN-SA4D-840-U-T4W OR EQUAL	
OPTION 1	A1b	•—□	57W LED 4000K 7119 LUMENS	AREA AND SITE LUMINAIRE ARM MOUNTED WITH DIE-CAST ALUMINUM HOUSING AND HEAT SINK.	COOPER LIGHTING SOLUTIONS GALN-SA4D-840-U-T3R OR EQUAL	PARKIN LOT LIGHTIN
OPTION 2	A2	⊶□	50W LED 4000K 7000 LUMENS	LOW PROFILE LED AREA/SITE LUMINAIRE RATED FOR HIGH VIBRATION APPLICATIONS IN DIE-CAST HOUSEING.	BEACON PRODUCTS VP-3-160L-50-4K8 -4W-BC OR EQUAL	
OPTION 3	A3	⊶□	168W LED 4000K 8000 LUMENS	PARKING LOT/AREA LED LIGHT FIXTURE WITH LOW PROFILE HOUSEING.	NLS LIGHTING NV-2-T4-80L-7-40K OR EQUAL	
OPTION 4	A4	••	149W LED 4800K 17915 LUMENS	HEAVY DUTY CAST LED ROADWAY LUMINAIRE WITH POLUESTER POWDER COAT PAINT FINISH.	COOOPER LIGHTING SOLUTIONS LD-RL-T3-E06-E OR EQUAL	ROADW
OPTION 5	A5	•	90W LED 4800K 10998 LUMENS	LED AREA/SITE/ROADWAY LIGHT WITH POLYESTER POWDER COAT FINISH.	COOOPER LIGHTING SOLUTIONS VRDN-C02-D-UNV-T3 OR EQUAL	
OPTION 6	A6	••	95W LED 4800K 12000 LUMENS	ROADWAY LUMINAIRE.	CREE LIGHTING XSPMD-D-HT-3ME-12L- 30K7-UL OR EQUAL	
OPTION 1	B1		(1) 80W LED 4000K 7800 LUMENS	LED WALKWAY LIGHT WITH ACRYLIC LENS WITH DIE-CAT ALUMINUM HOUSING.	AMERICAN ELECTRIC LIGHTING 245L-P303-40K-R3-AY OR EQUAL	 WALKW
OPTION 2	B2		75W LED 4000K 8767 LUMENS	LUMNISCENT LED POLE LIGHT WITH CAST ALUMINUM HOUSING AND ASYMMETRICAL DISTRIBUTION.	HOLOPHANE LUMINAIR GSLF3-P40-40K-MVOLT -ASY-NPT OR EQUAL	LIGHTII
OPTION 3	B3		80W LED 4000K 9000 LUMENS	LED POLE LIGHT WITH LOW COPPER ALUMINUM ALLOY DIE-CASTING WITH ACRYLIC LENS.	KIM LIGHTING UR20-68L-80-4K8-3 OR EQUAL	
OPTION 1	C1		21W LED 4000K 2747 LUMENS	4FT LED SURFACE MOUNTED STRIP LIGHT.	META 4SNLED-LD5-26SL-UNV -L840-CD1-U OR EQUAL	
OPTION 2	C2		LED 3000K MIN. 2782 LUMENS			
OPTION 1	C3		25W LED 4000K 3111 LUMENS	4FT LED SURFACE MOUNTED STRIP LIGHT.	CORE RZL-NL-30L-8-40-D -UNV-STD OR EQUAL	CEILIN LIGHTII
OPTION 2	C4	0	25W LED 4000K 3094 LUMENS	10" VANDAL RESISTANT DOWNLIGHT.	SPITZER DF-10-25W-CC-BK	
OPTION 1	C5	0	20W LED 4000K 2200 LUMENS	11" VANDAL RESISTANT DOWNLIGHT.	COOPER LIGHTING SOLUTIONS T-R-B-11-LD4-20W-40- CL-BK-UNV-ED-C1	
OPTION 1	M1	YYY		SPORTS LIGHTING		1 +
	M2	6	(1) 900W	SPORTS COURT FLOOD LIGHT		SPOR LIGHTI

1 LUMINAIRE SCHEDULE
NO SCALE



BATHROOM LIGHTING - FIXTURE TYPE C4



BATHROOM LIGHTING - FIXTURE TYPE C5



TYPE A1

PARKING LOT LIGHTING - FIXTURE



PARKING LOT LIGHTING - FIXTURE TYPE A3 (ALTERNATE)



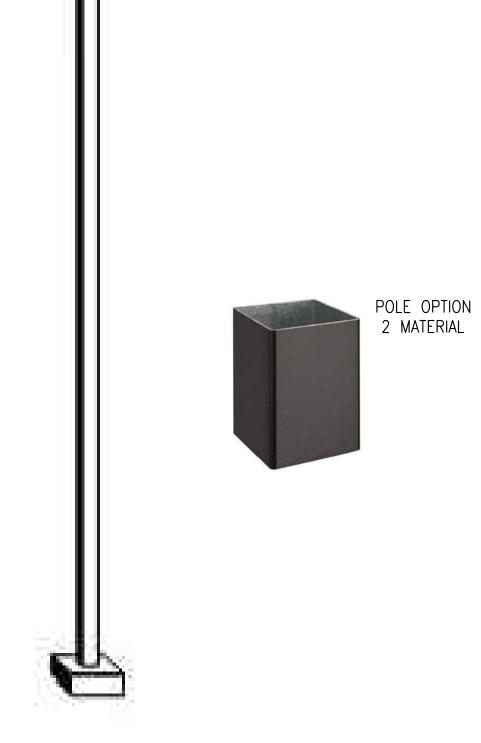
ROADWAY LIGHTING – FIXTURE TYPE A4




ROADWAY LIGHTING - FIXTURE TYPE A5 (ALTERNATE)

POLE OPTION





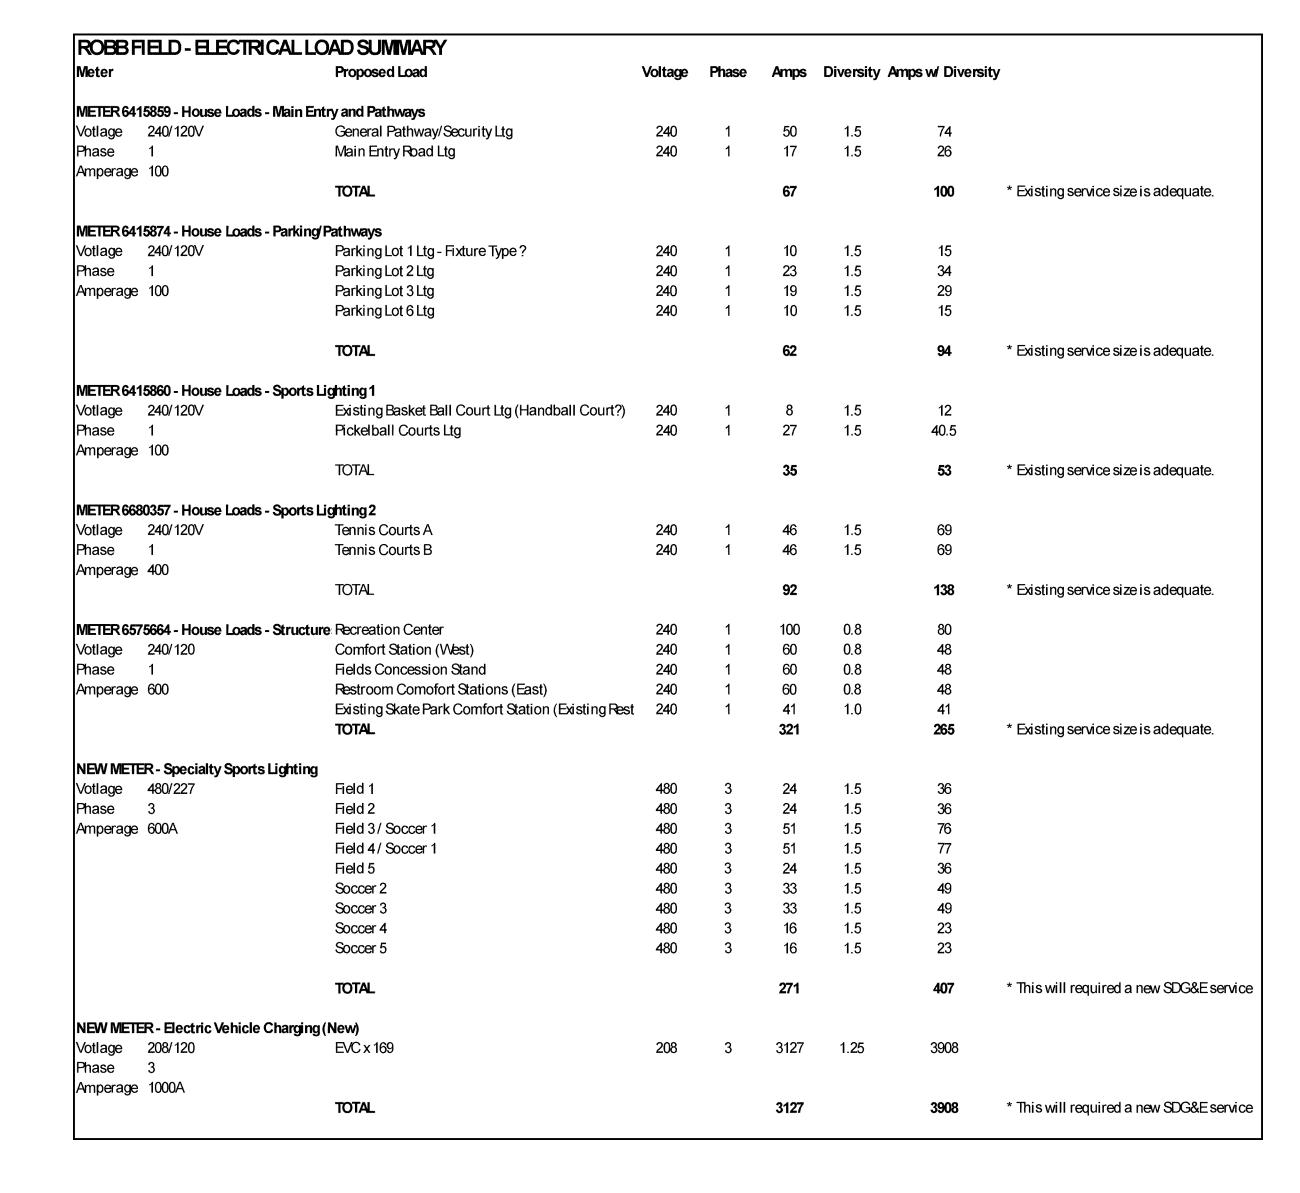*POLES WILL BE OF CONCRETE OR ALUMINUM MATERIAL



2 LOAD SUMMARY NO SCALE







WALKWAY LIGHTING — FIXTURE TYPE B3 (ALTERNATE)





WALKWAY LIGHTING — FIXTURE TYPE B2 (ALTERNATE)



CEILING LIGHTING — FIXTURE TYPE C1

CEILING LIGHTING - FIXTURE TYPE C3 (ALTERNATE)

E CEILING LIGHTING - FIXTURE
TYPE C2
PRELIMINARY LIGHTING AND ELECTRICAL PLANS

CITY OF SAN DIEGO PARK AND RECREATION DEPARTMENT

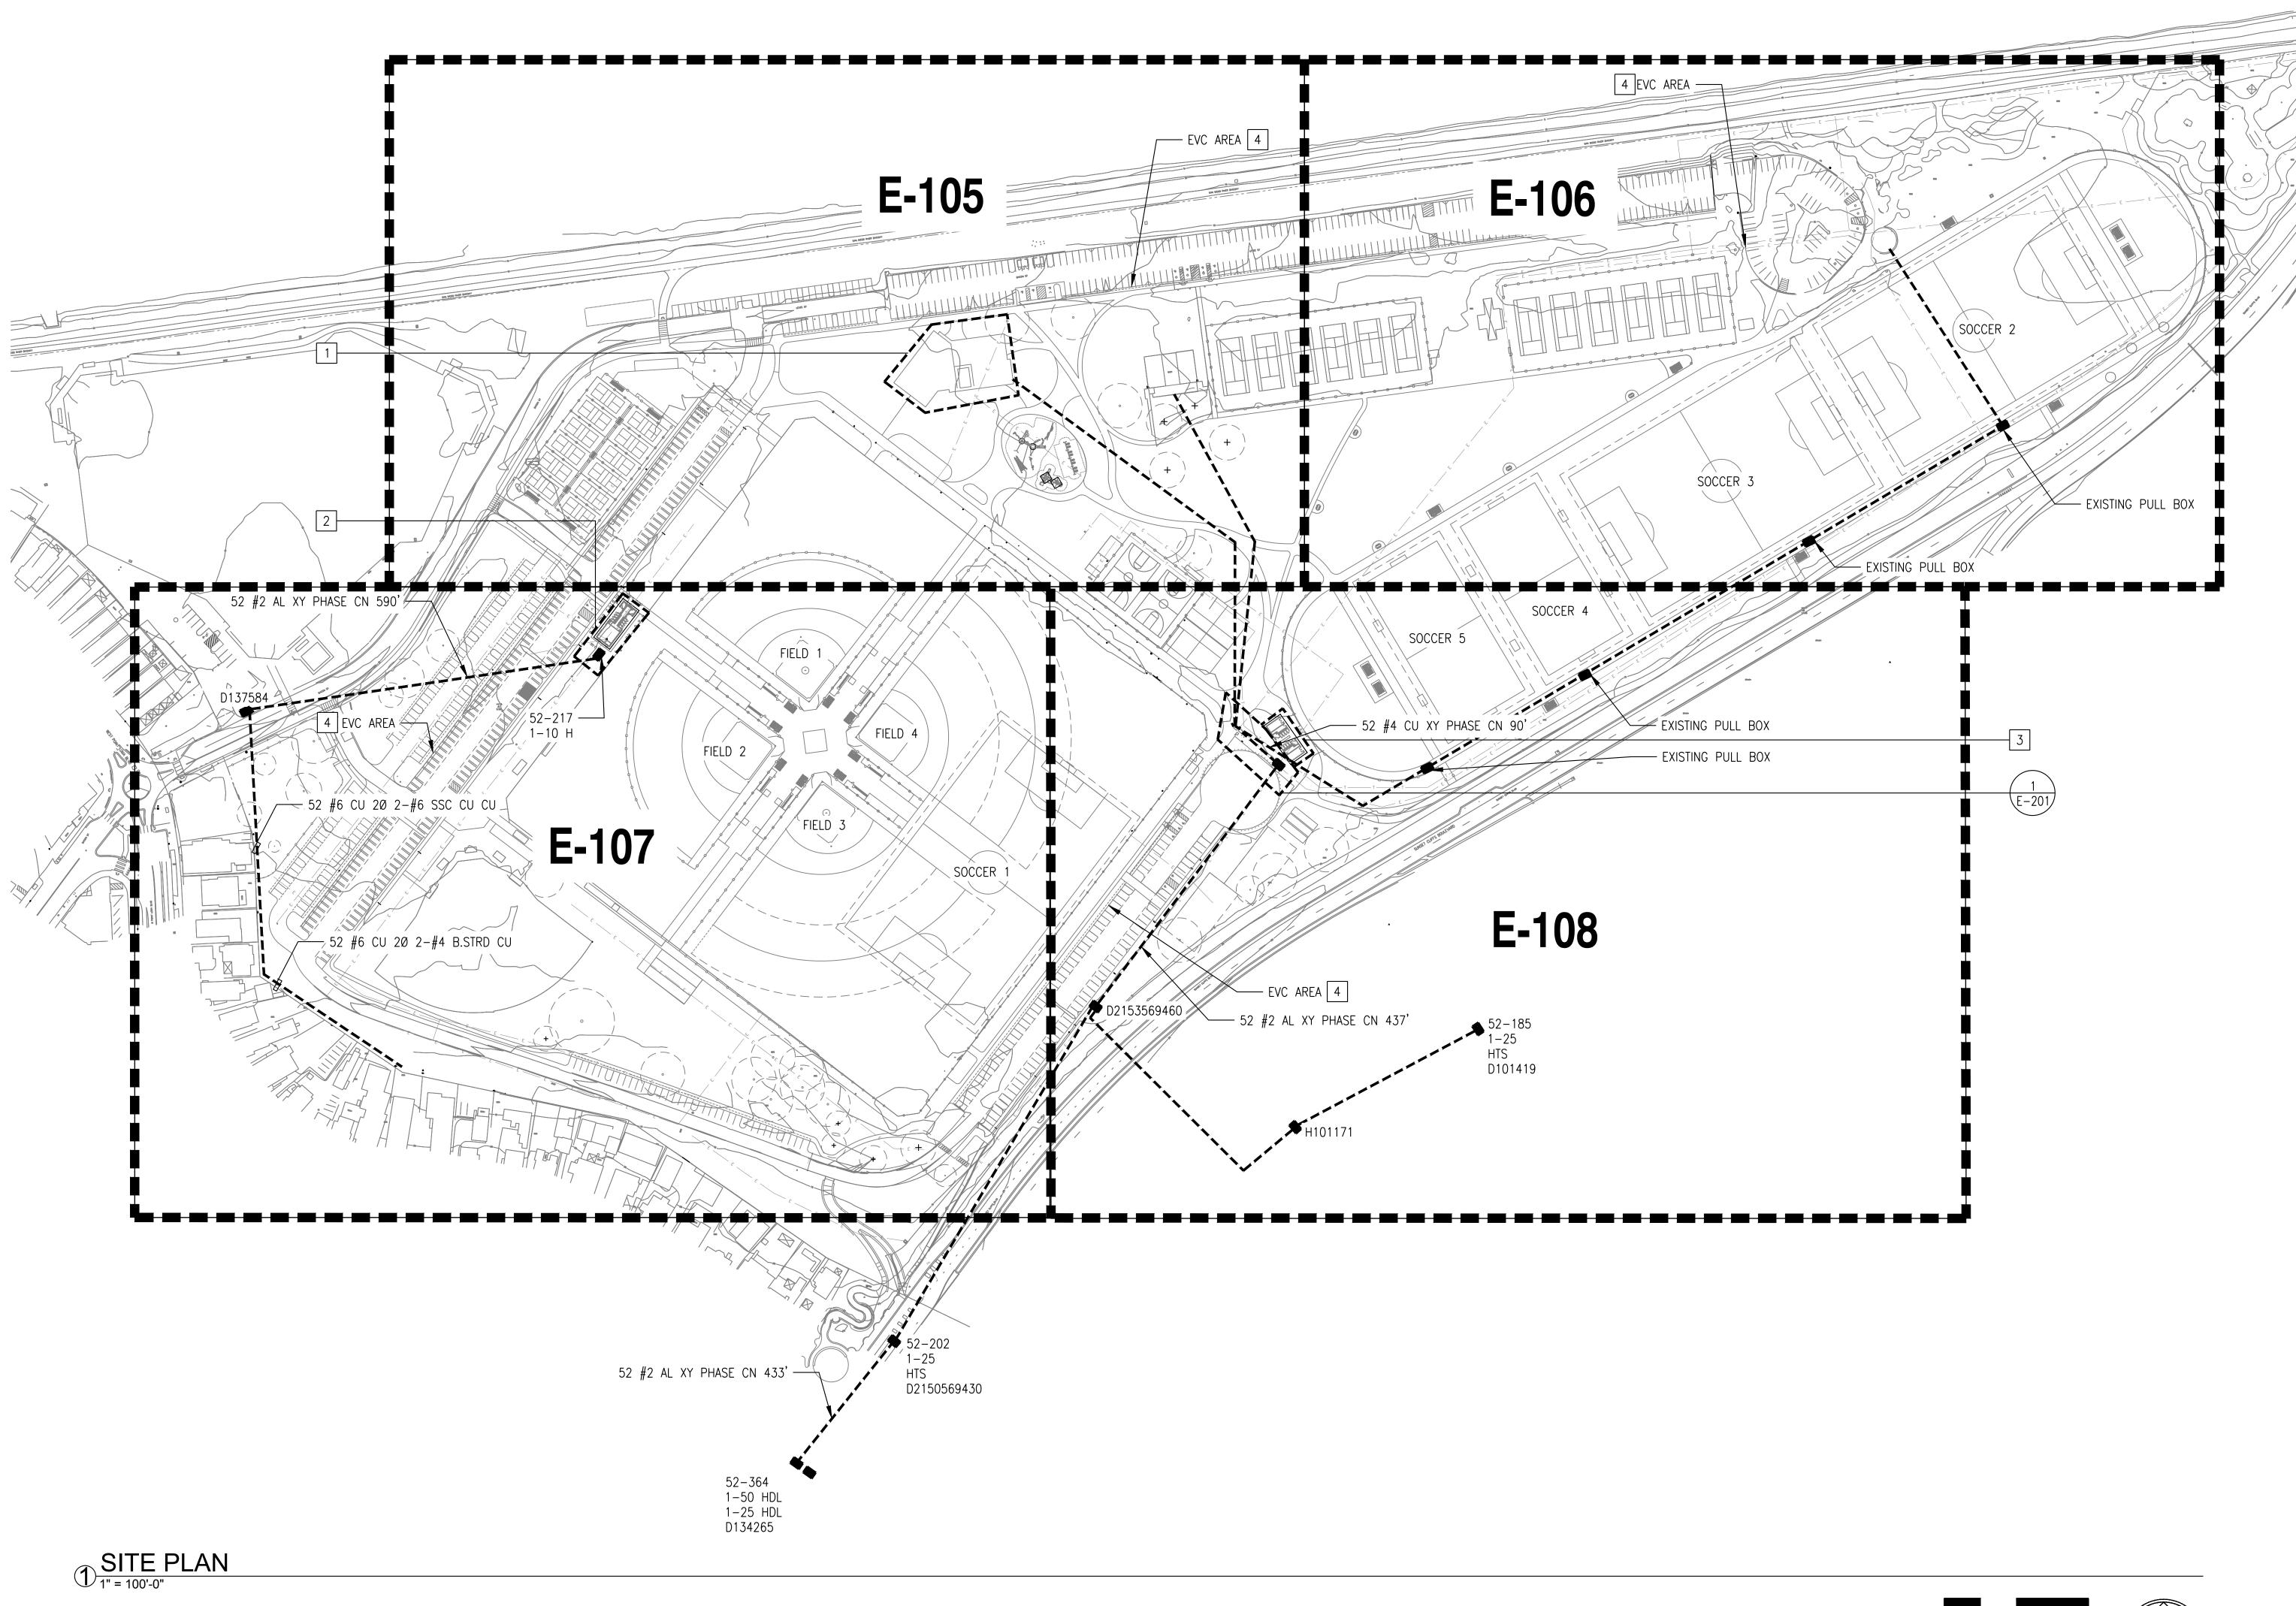
THE GENERAL DEVELOPMENT PLAN

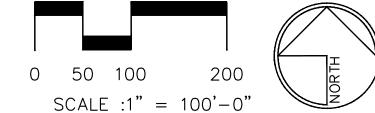
ROBB FIELD

COMMUNITY PARK

COMM. PLAN AREA: MISSION PARK COUNCIL DISTRICT NO. 2 THOMAS BROTHERS PAGE: PG. 59-B3 SUPPLEMENTAL SHEET NO.: 13 OF 24 LAMBERT COORDINATES: 215-1695







PRELIMINARY LIGHTING AND ELECTRICAL PLANS

THE GENERAL DEVELOPMENT PLAN

ROBB FIELD

CITY OF SAN DIEGO PARK AND RECREATION DEPARTMENT

KEYNOTES:

PROVIDE LIGHTING, LIGHT SWITCHES, MOTION SENSORS, AND GFCI DUPLEX RECEPTACLES WITHIN STRUCTURE. PROVIDE A MINIMUM OF 40 LIGHT FIXTURES, 15 LIGHT SWITCHES AND MOTION SENSORS, AND 30 GFCI DUPLEX RECEPTACLES.

PROVIDE LIGHTING, LIGHT SWITCHES, MOTION SENSORS, AND GFCI DUPLEX RECEPTACLES WITHIN STRUCTURE. PROVIDE A

MINIMUM OF 24 LIGHT FIXTURES, 4 LIGHT SWITCHES AND MOTION SENSORS, AND 10 GFCI DUPLEX RECEPTACLES.

PROVIDE LIGHTING, LIGHT SWITCHES, MOTION SENSORS, AND

GFCI DUPLEX RECEPTACLES WITHIN STRUCTURE. PROVIDE A

MINIMUM OF 20 LIGHT FIXTURES, 6 LIGHT SWITCHES AND MOTION SENSORS, AND 10 GFCI DUPLEX RECEPTACLES.

PROVIDE POWER TO 169 ELECTRIC VEHICLE CHARGING STATIONS (EVCS) ON SITE. EXACT QUANTITY OF EVCS PER

"AREA" TO BE DÉTERMINED.

COMMUNITY PARK

COUNCIL DISTRICT NO. 2

COMM. PLAN AREA: MISSION PARK


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LAMBERT COORDINATES: 215-1695

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SUPPLEMENTAL SHEET NO.: 14 OF 24





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CITY OF SAN DIEGO PARK AND RECREATION DEPARTMENT

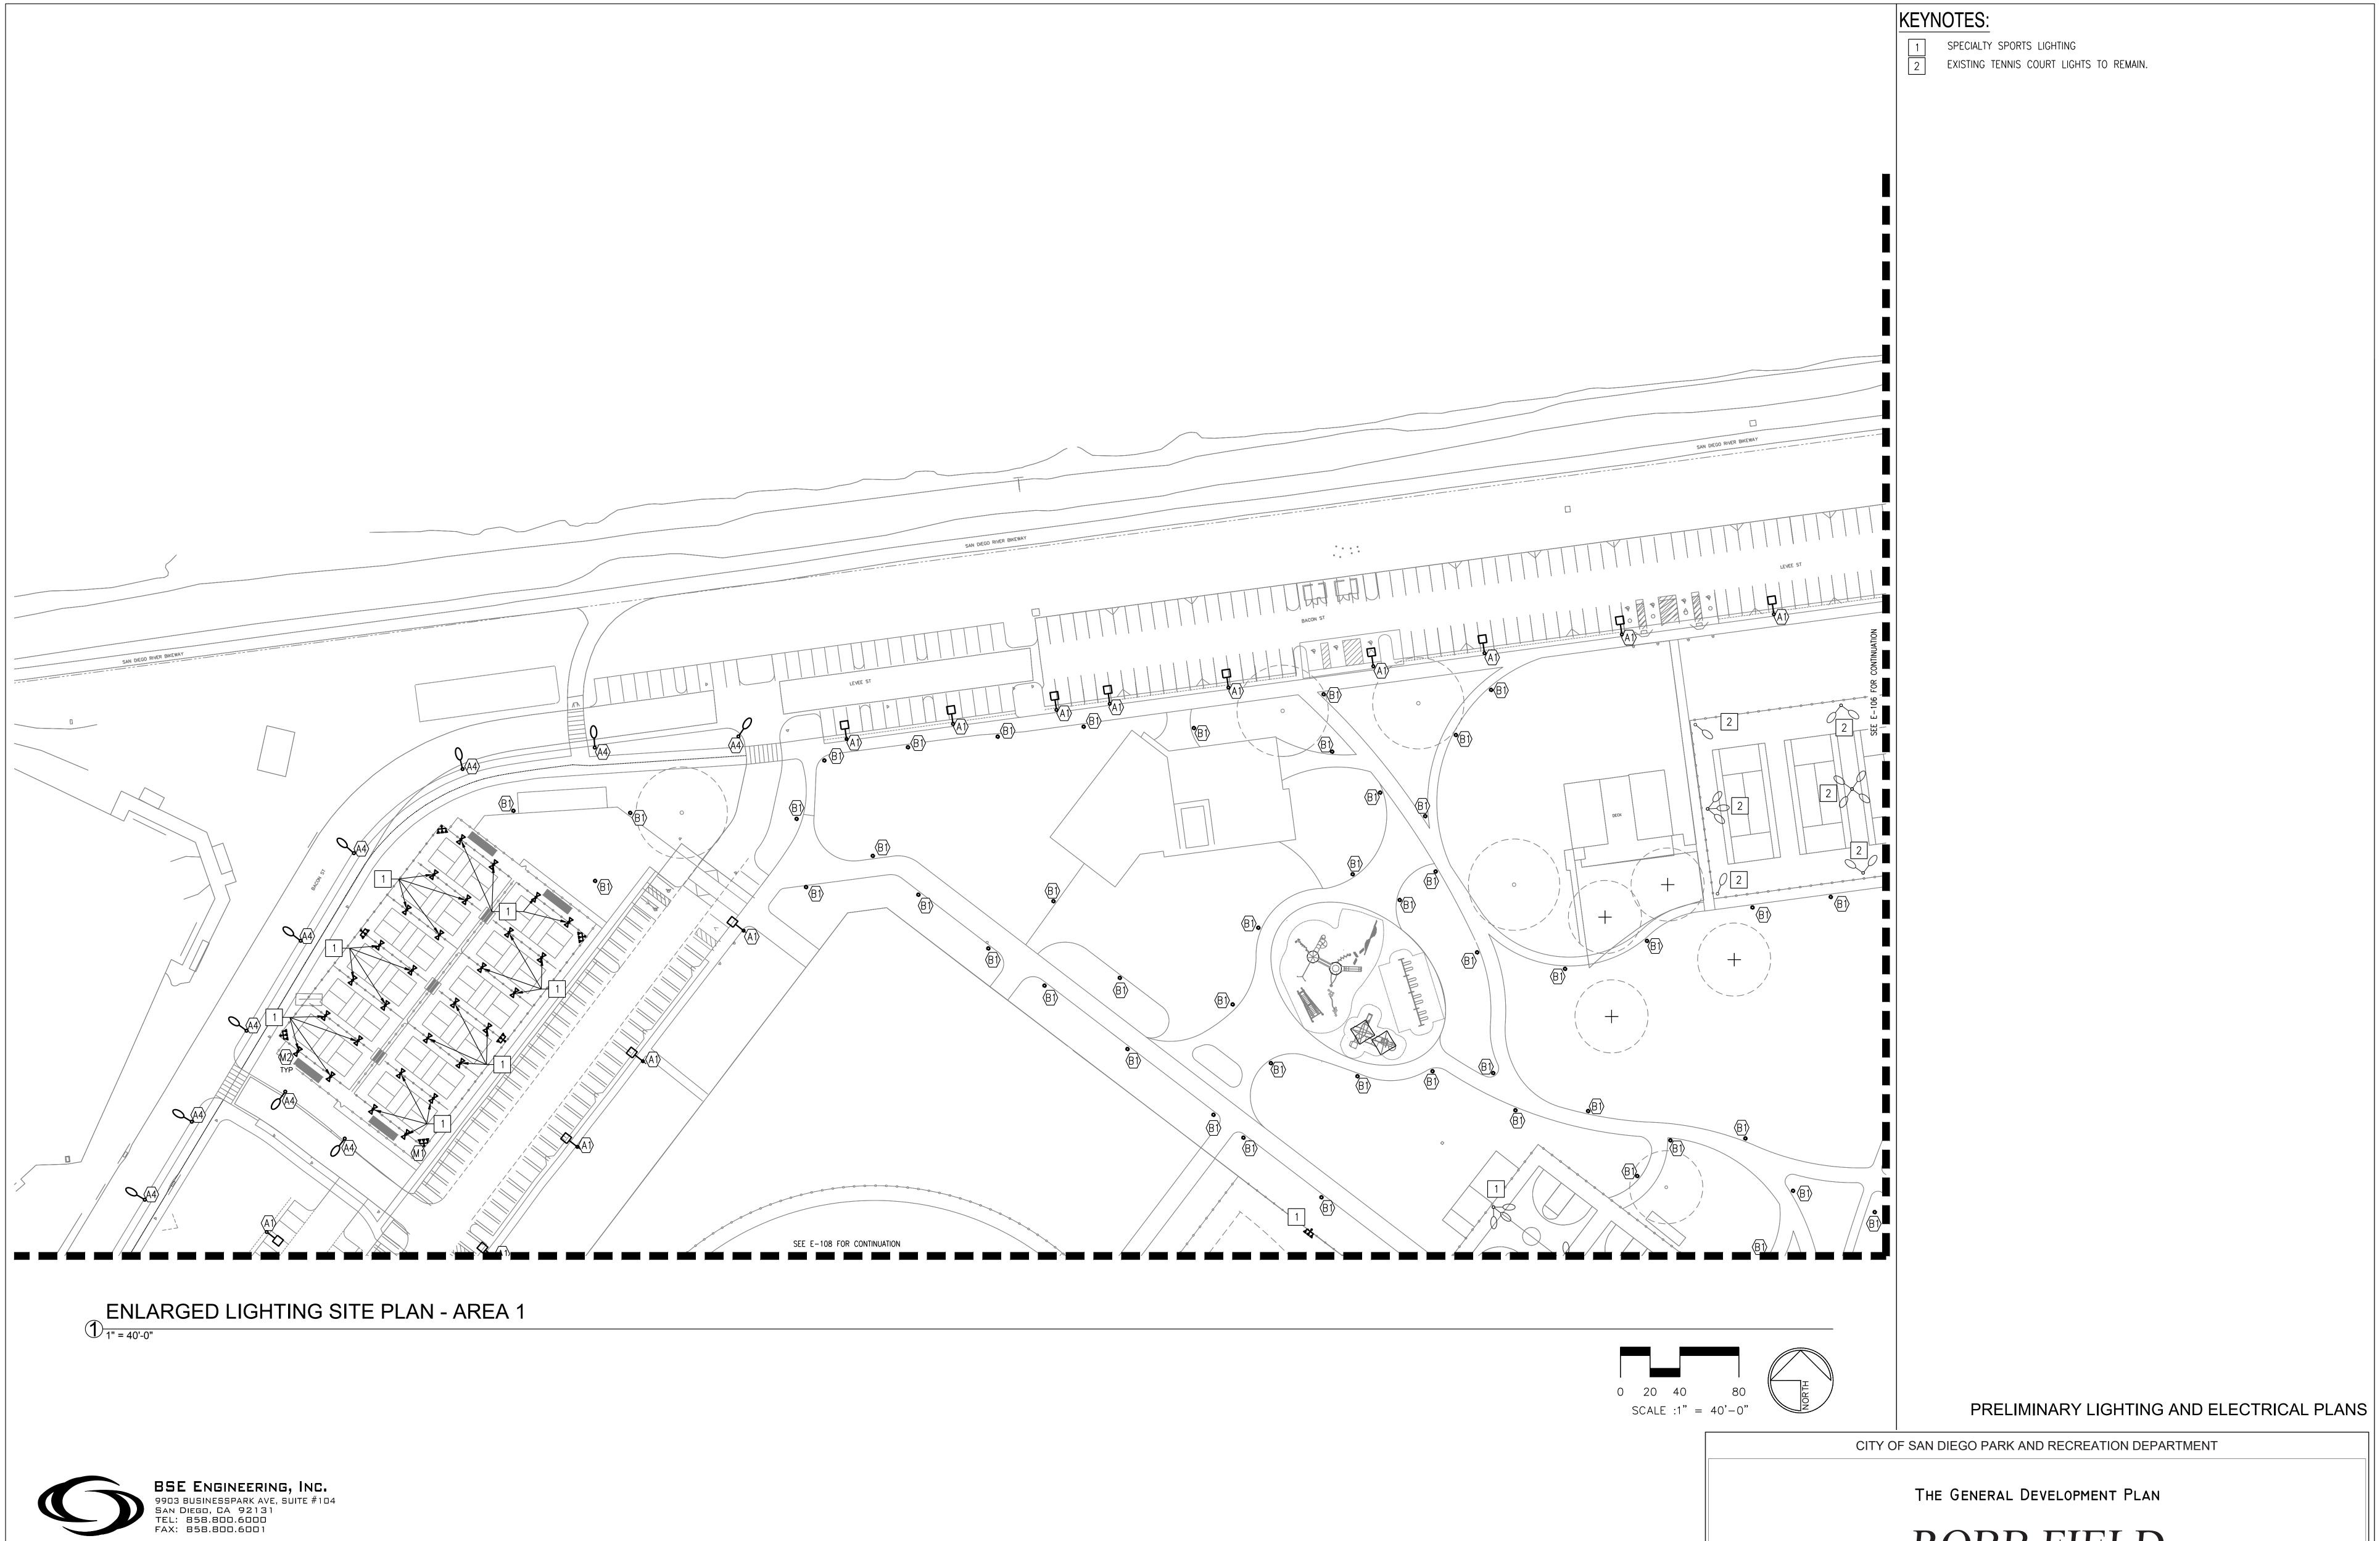THE GENERAL DEVELOPMENT PLAN

ROBBFIELD

COMMUNITY PARK

COUNCIL DISTRICT NO. 2

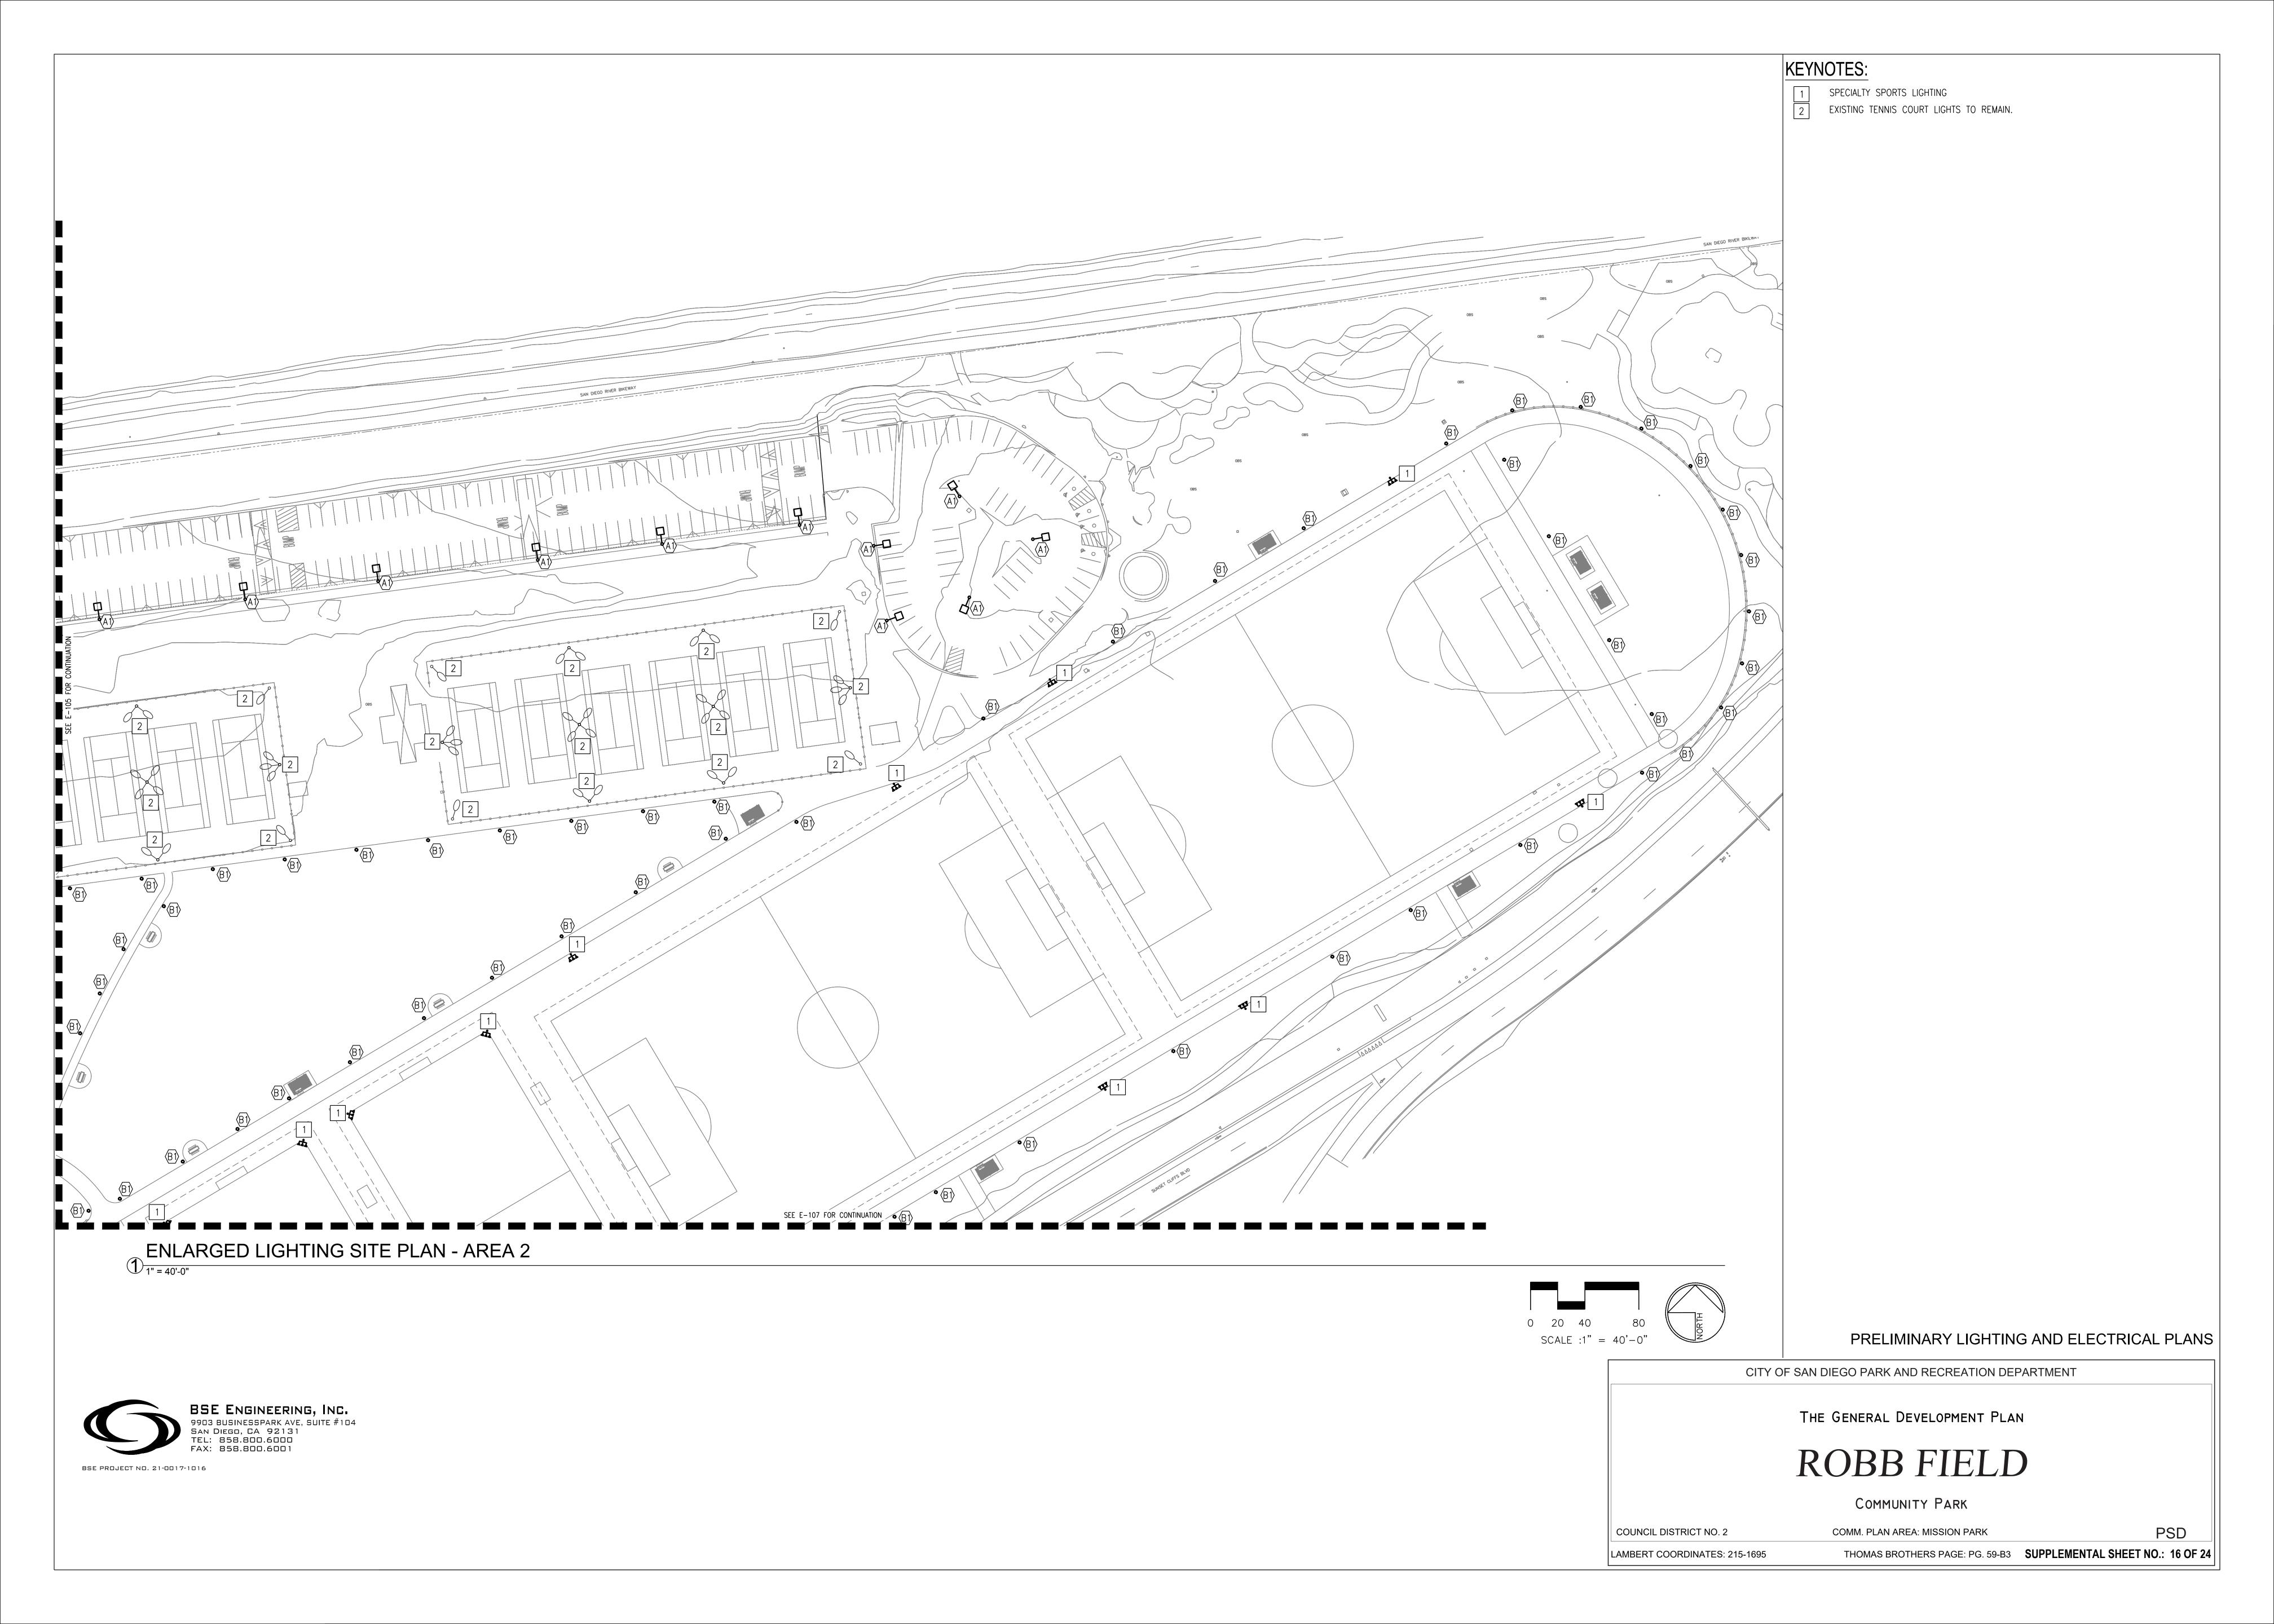
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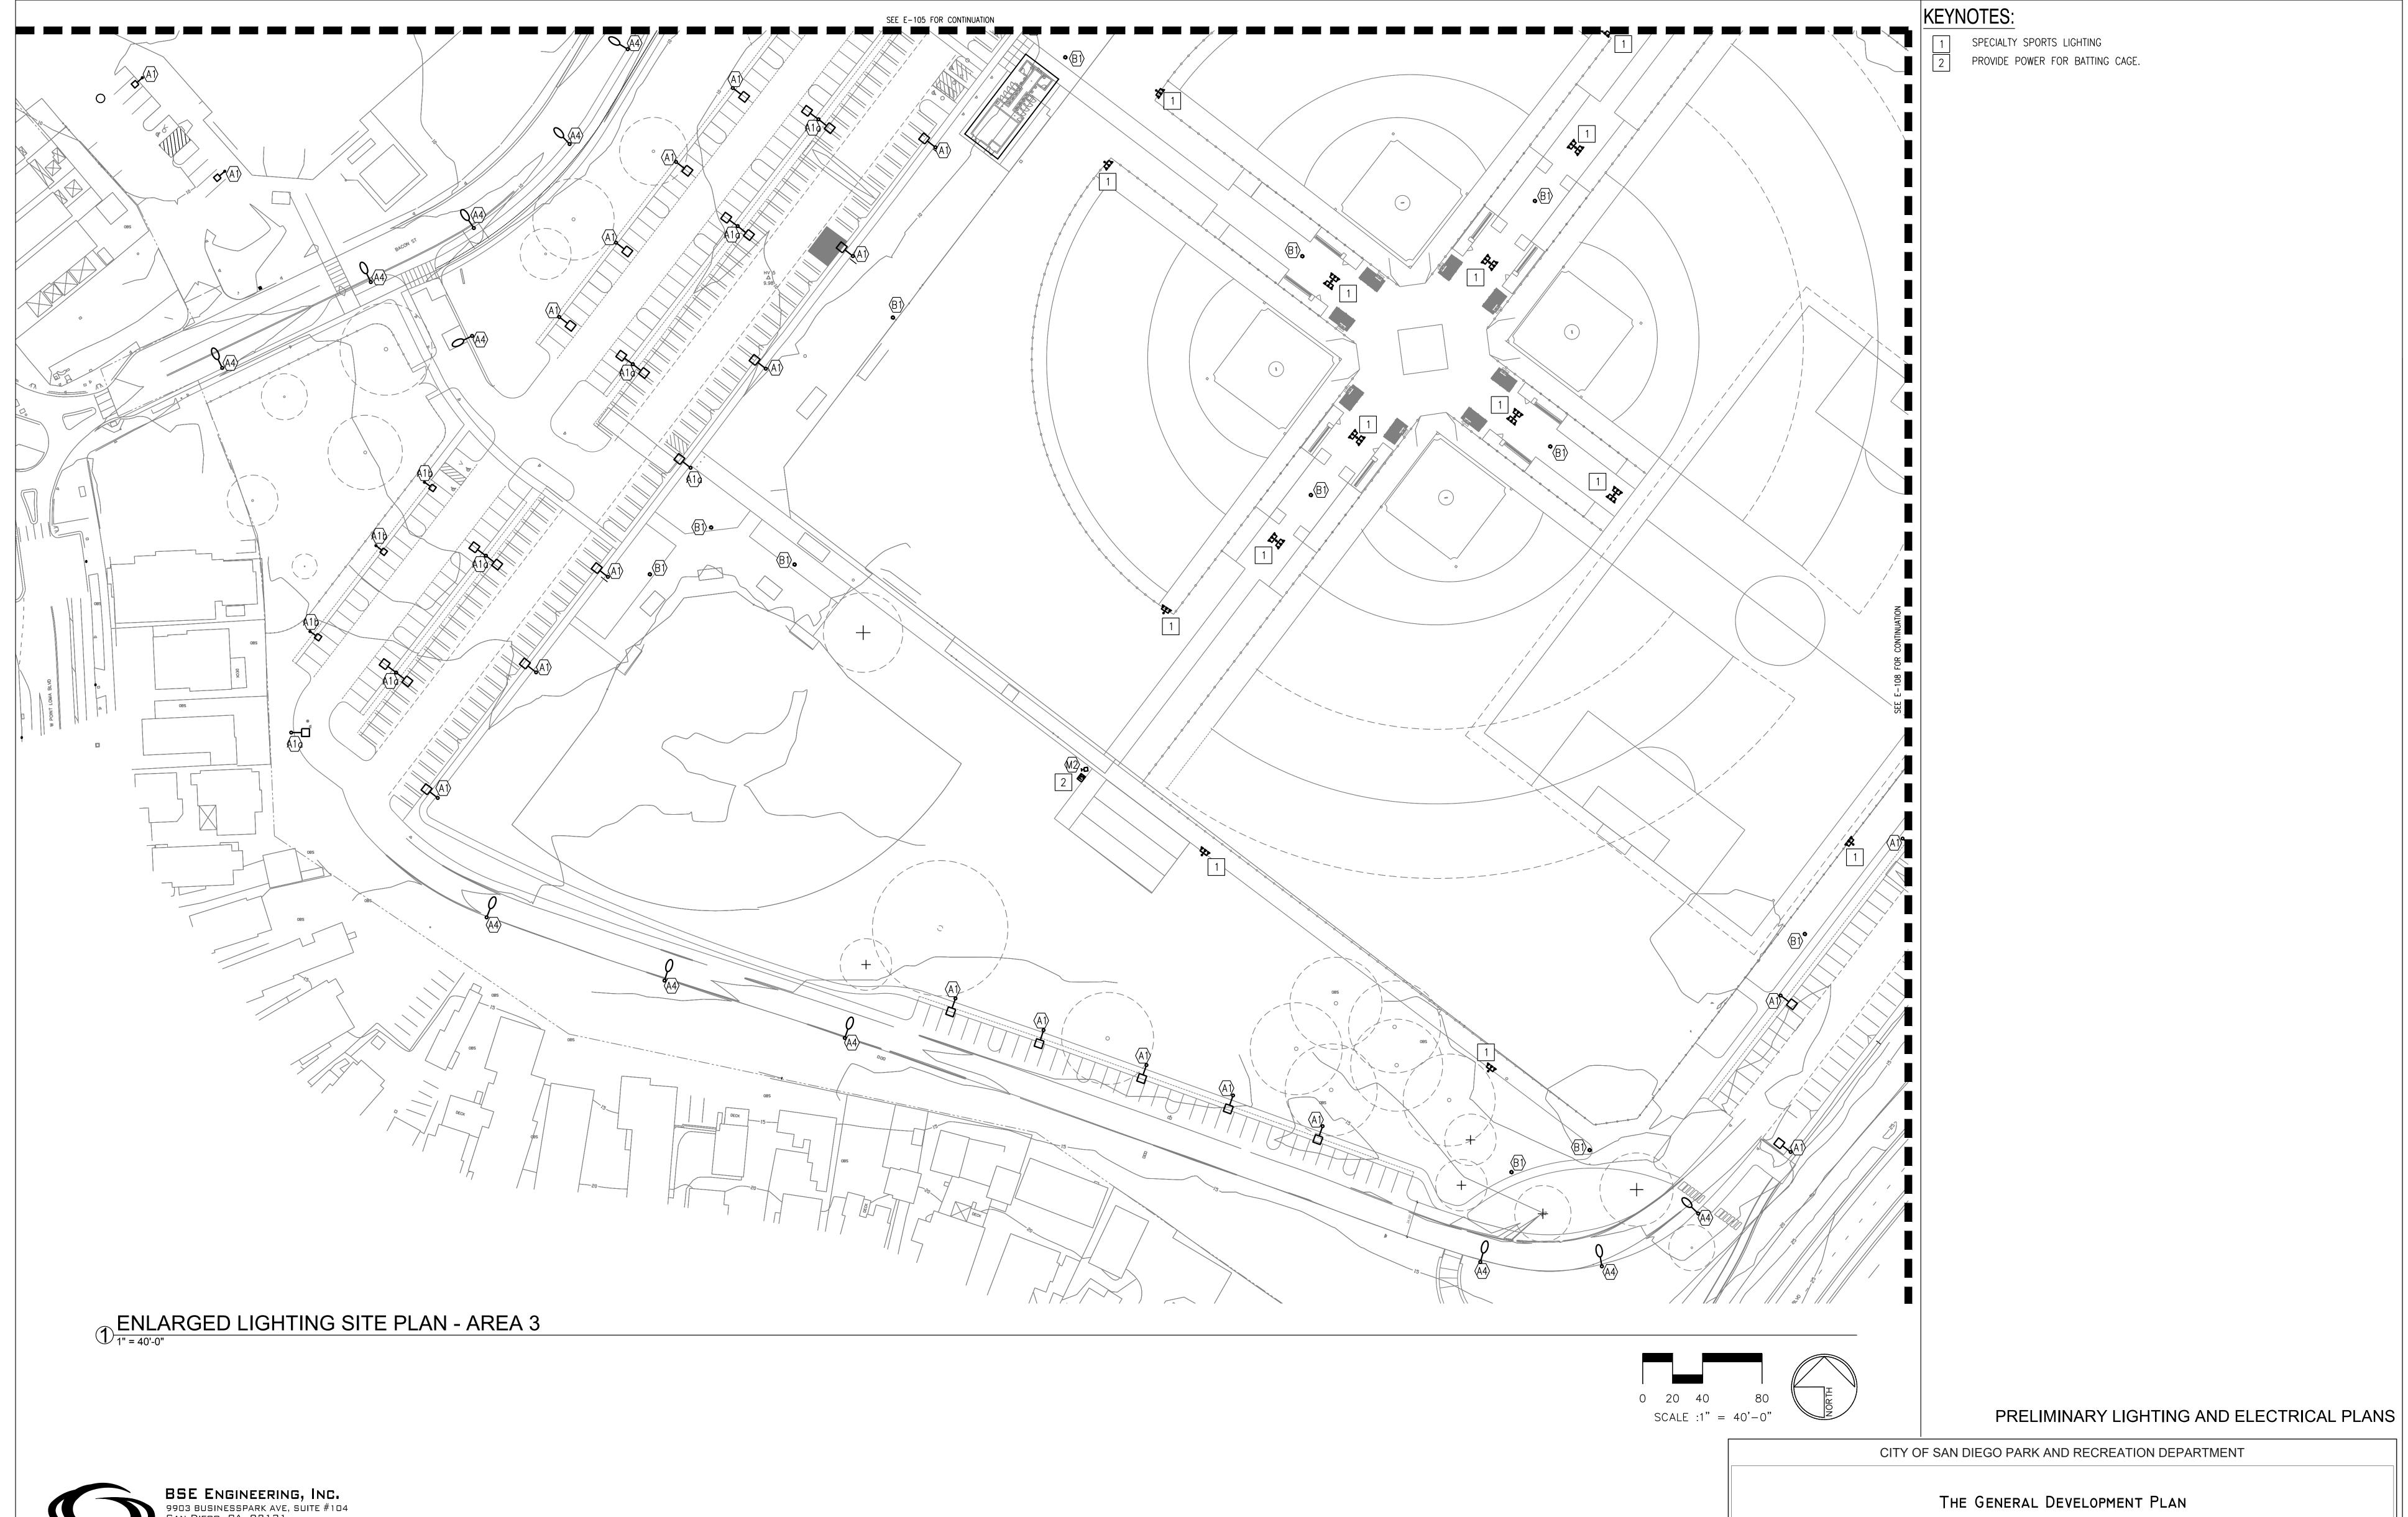
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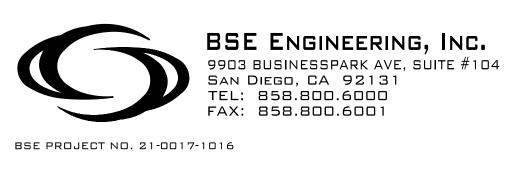
LAMBERT COORDINATES: 215-1695

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CITY OF SAN DIEGO PARK AND RECREATION DEPARTMENT

THE GENERAL DEVELOPMENT PLAN

ROBBFIELD

COMMUNITY PARK

COUNCIL DISTRICT NO. 2

COMM. PLAN AREA: MISSION PARK


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LAMBERT COORDINATES: 215-1695

PRELIMINARY LIGHTING AND ELECTRICAL PLANS

COUNCIL DISTRICT NO. 2

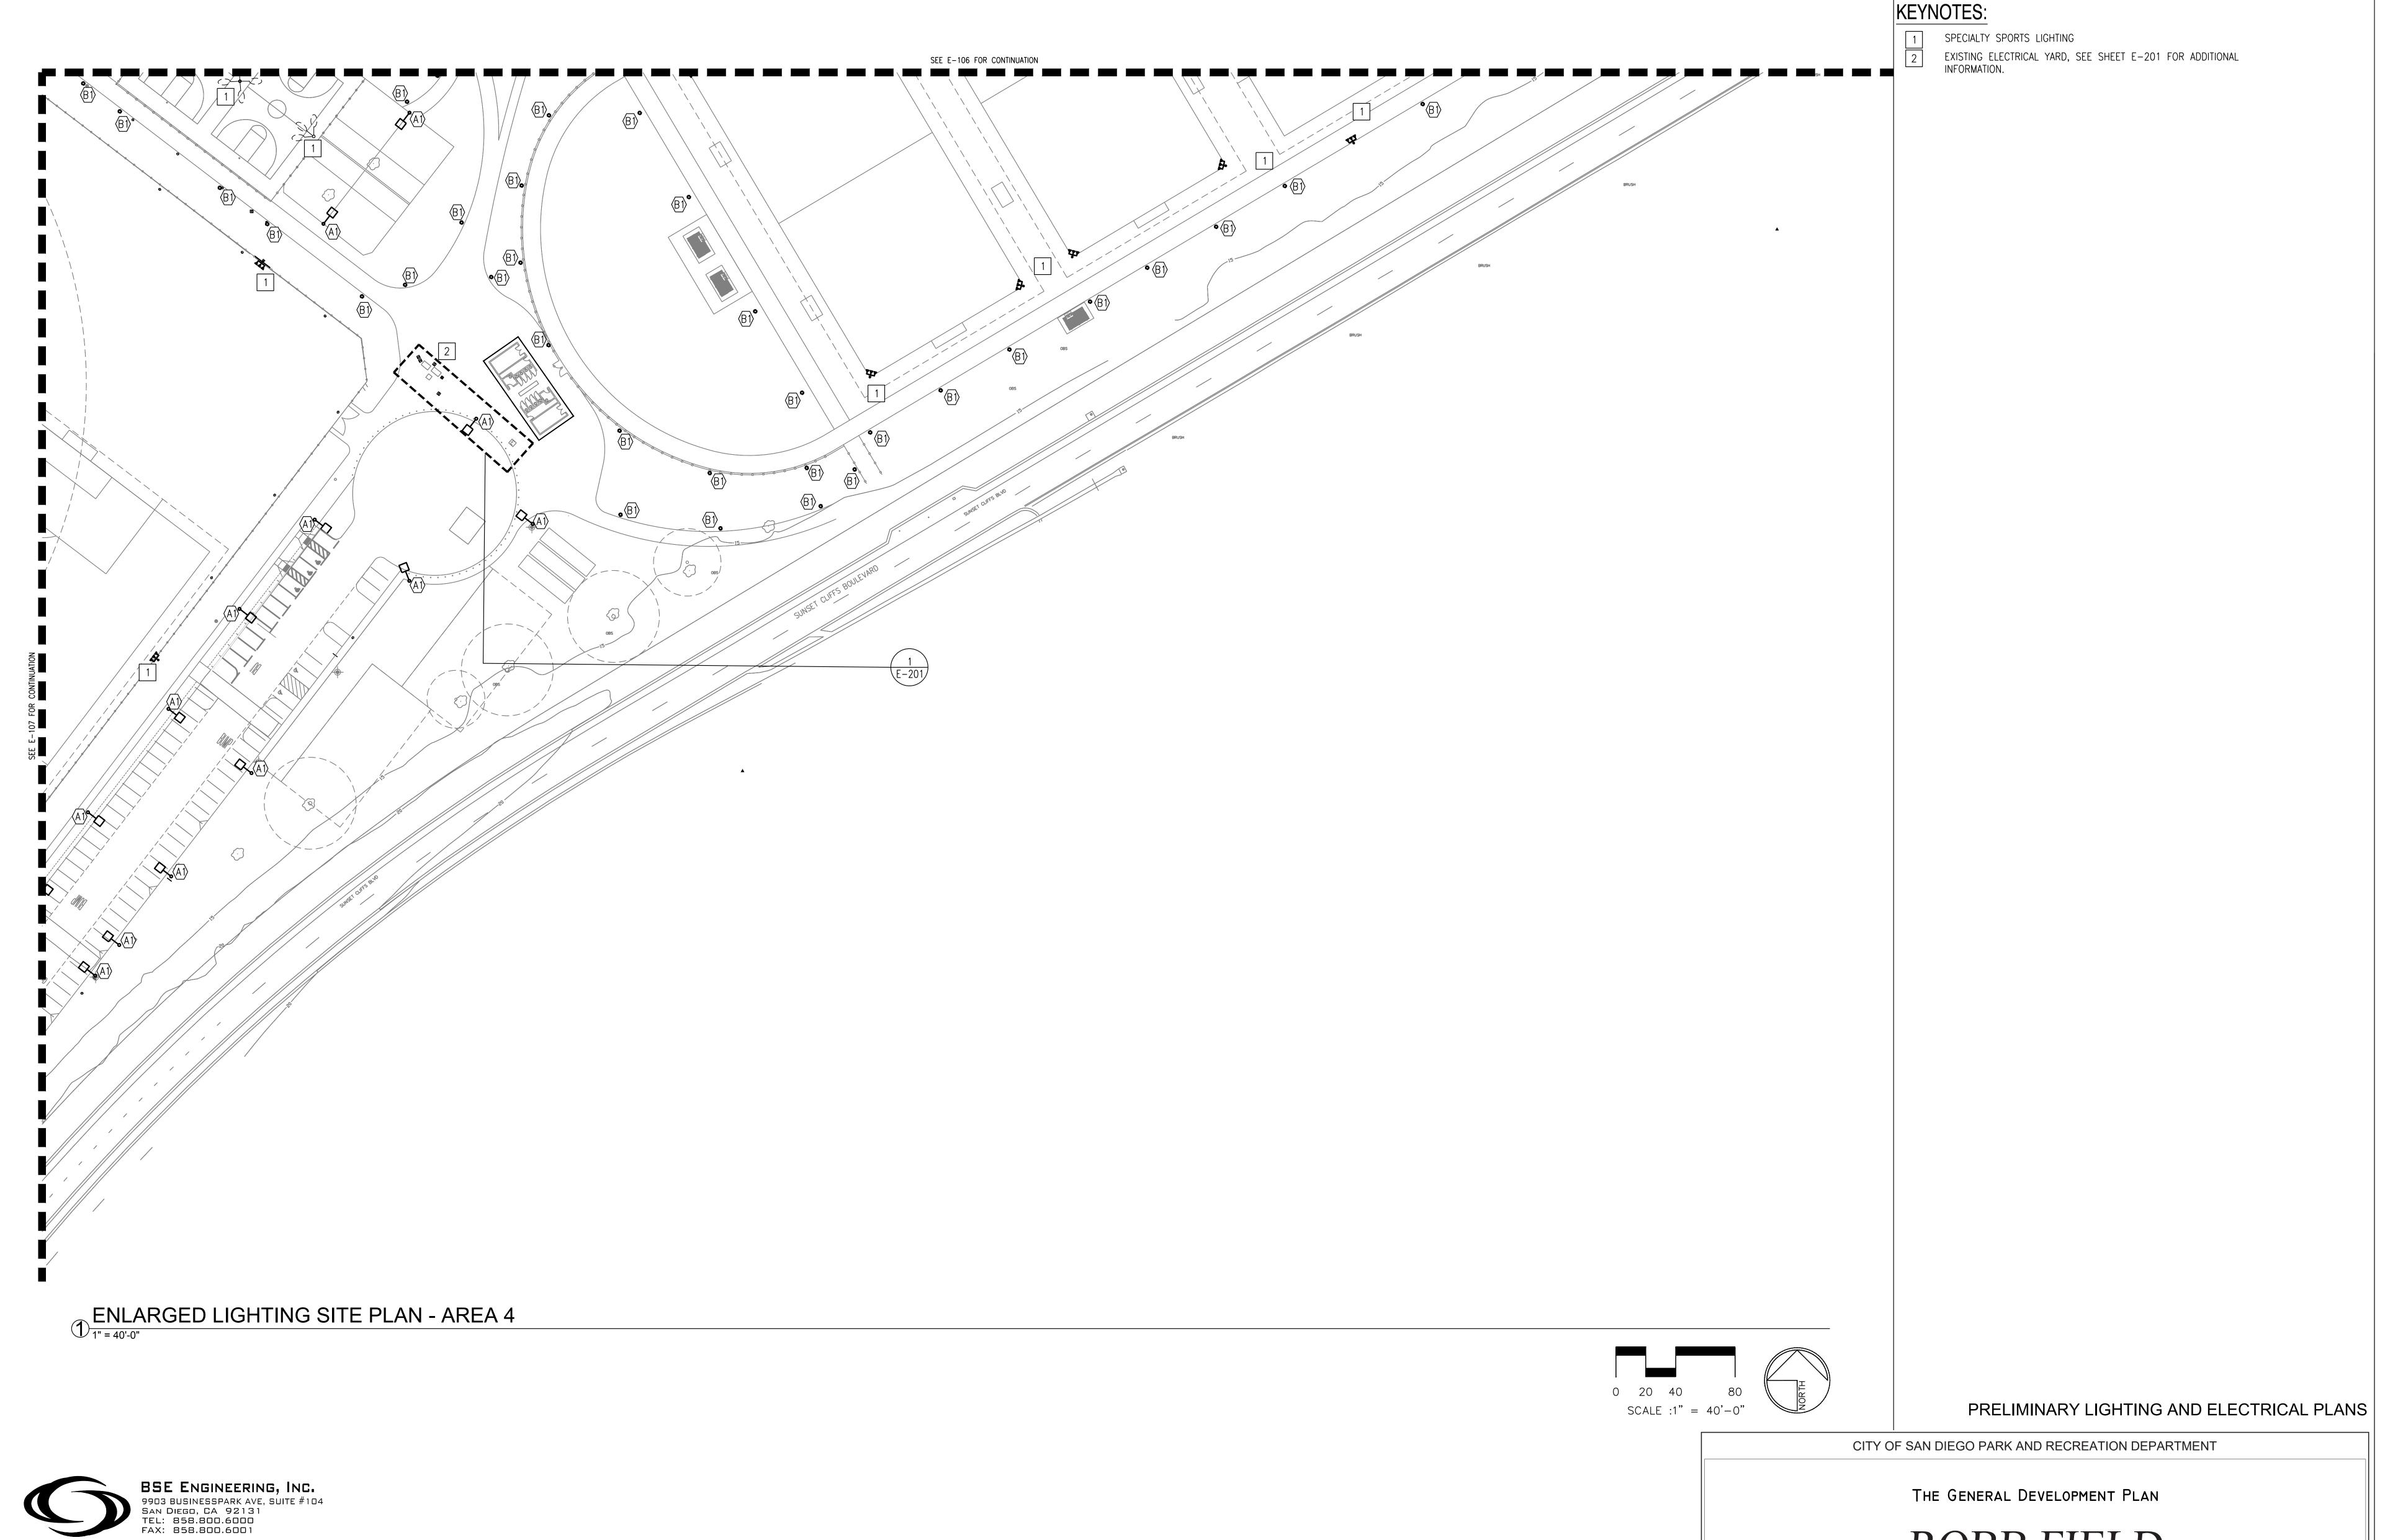PRELIMINARY LIGHTING AND ELECTRICAL PLANS



BSE PROJECT NO. 21-0017-1016

ROBBFIELD

COMMUNITY PARK

COUNCIL DISTRICT NO. 2

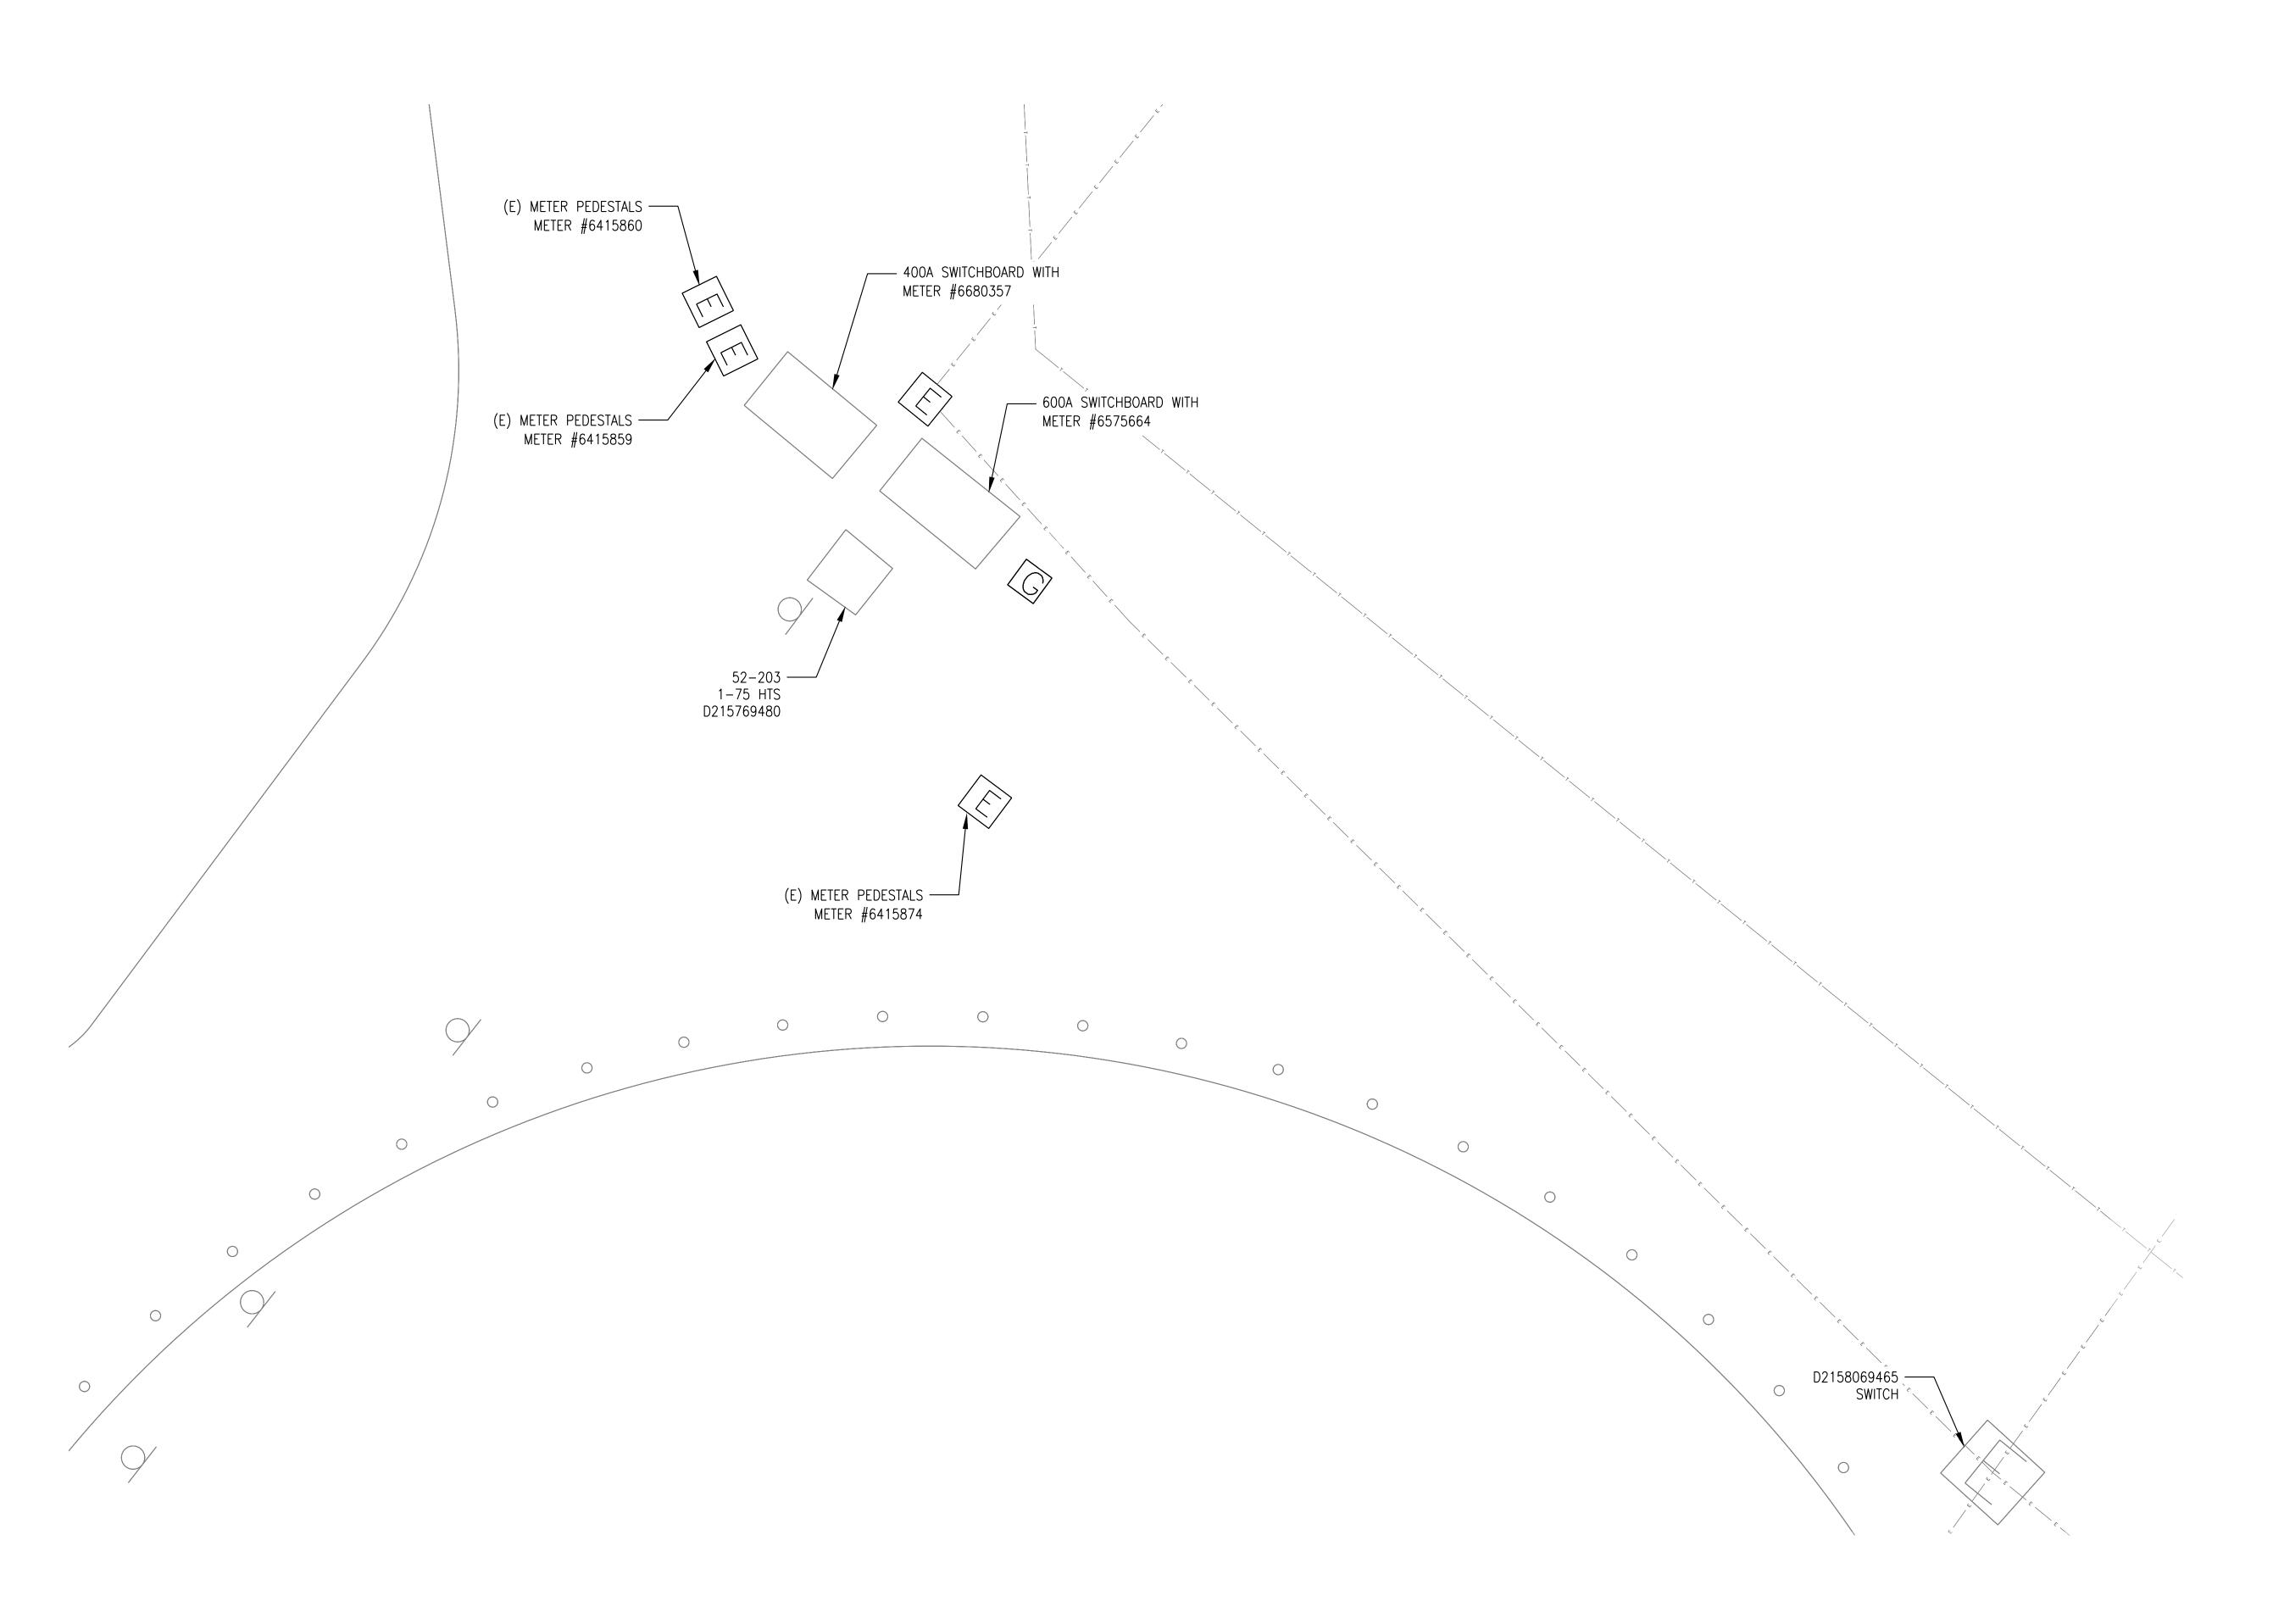
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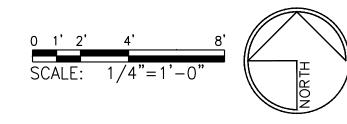
LAMBERT COORDINATES: 215-1695

THOMAS BROTHERS PAGE: PG. 59-B3

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1 ENLARGED SITE PLAN - SWITCHBOARD



PRELIMINARY LIGHTING AND ELECTRICAL PLANS



CITY OF SAN DIEGO PARK AND RECREATION DEPARTMENT

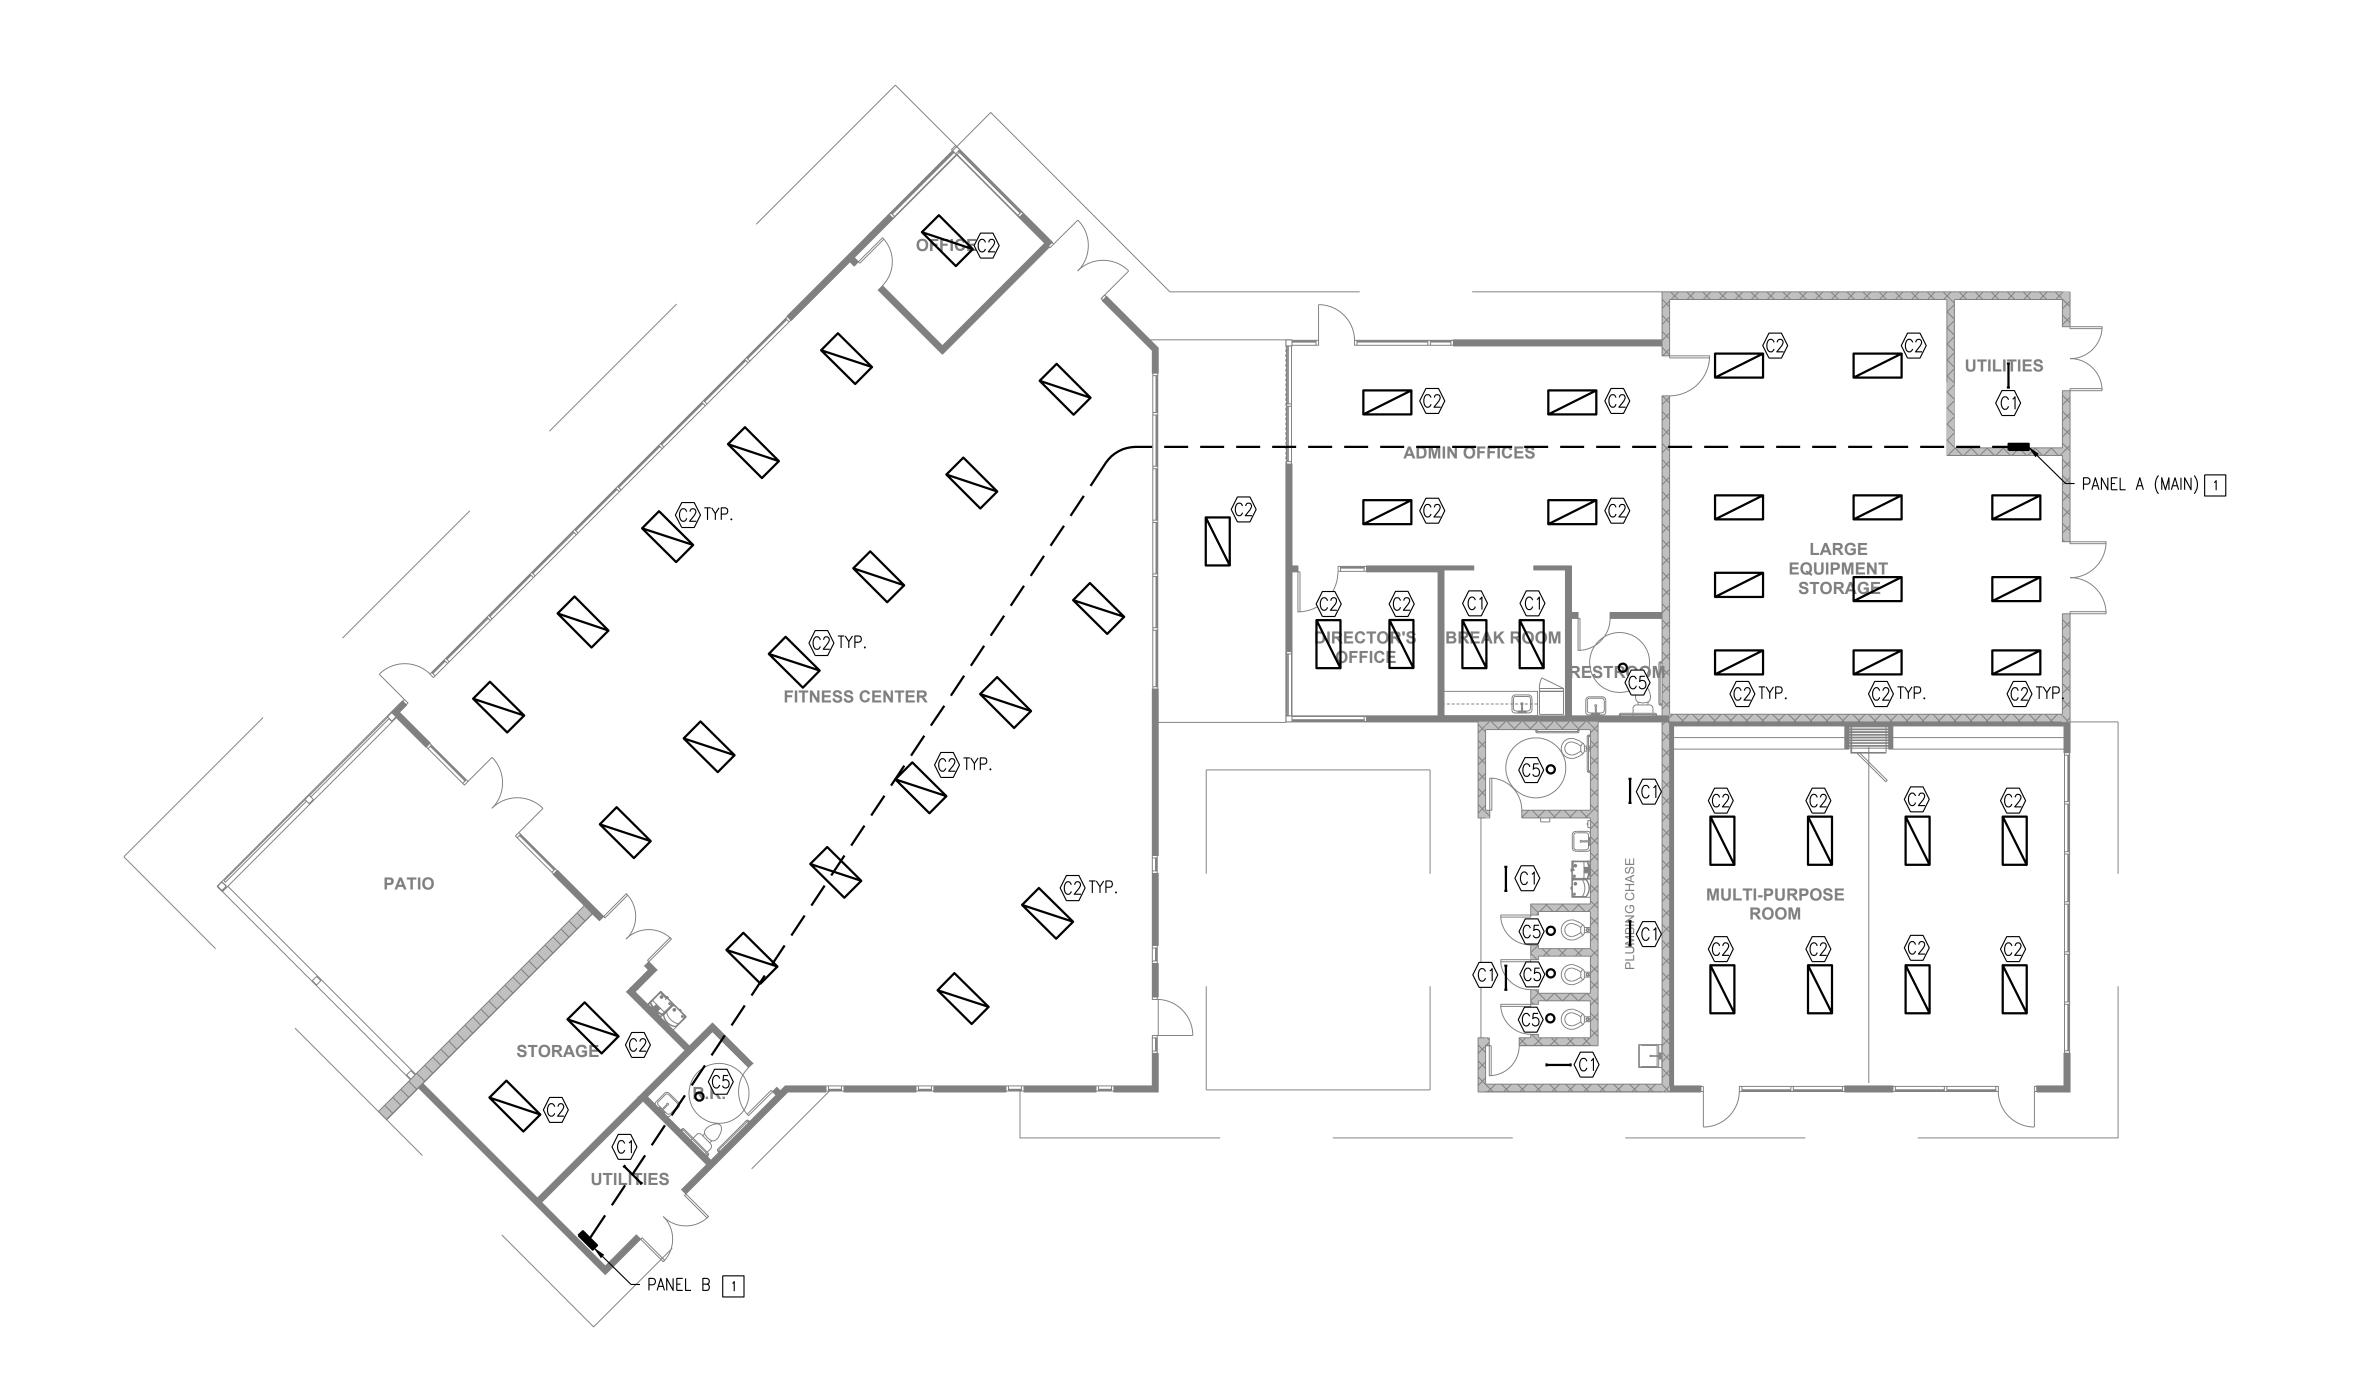
THE GENERAL DEVELOPMENT PLAN

ROBBFIELD

COMMUNITY PARK


COUNCIL DISTRICT NO. 2 COMM. PLAN AREA: MISSION PARK PSD

LAMBERT COORDINATES: 215-1695 THOMAS BROTHERS PAGE: PG. 59-B3 SUPPLEMENTAL SHEET NO.: 19 OF 24



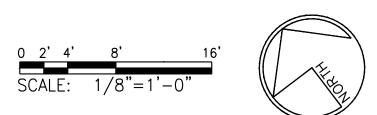1/8" = 1'-0" ELECTRICAL FLOOR PLAN - RECREATION CENTER - NEW





PRELIMINARY LIGHTING AND ELECTRICAL PLANS

CITY OF SAN DIEGO PARK AND RECREATION DEPARTMENT

GENERAL NOTES:

KEY NOTES:

1. PROVIDE ALL NEW LIGHTING, LIGHTING CONTROLS, ELECTRICAL

1 PROVIDE (1) NEW 208/120V, 200A, 3PH, 4W ELECTRICAL

PROVIDE (1) NEW 208/120V, 100A, 3PH, 4W ELECTRICAL PANELBOARD SUB-FED FROM PANEL A.

DEVICES AND PANELS WITHIN/EXTERIOR MOUNTED TO BUILDING.

PANELBOARD WITH 100A/3P BREAKER TO SUB-FEED PANEL B.

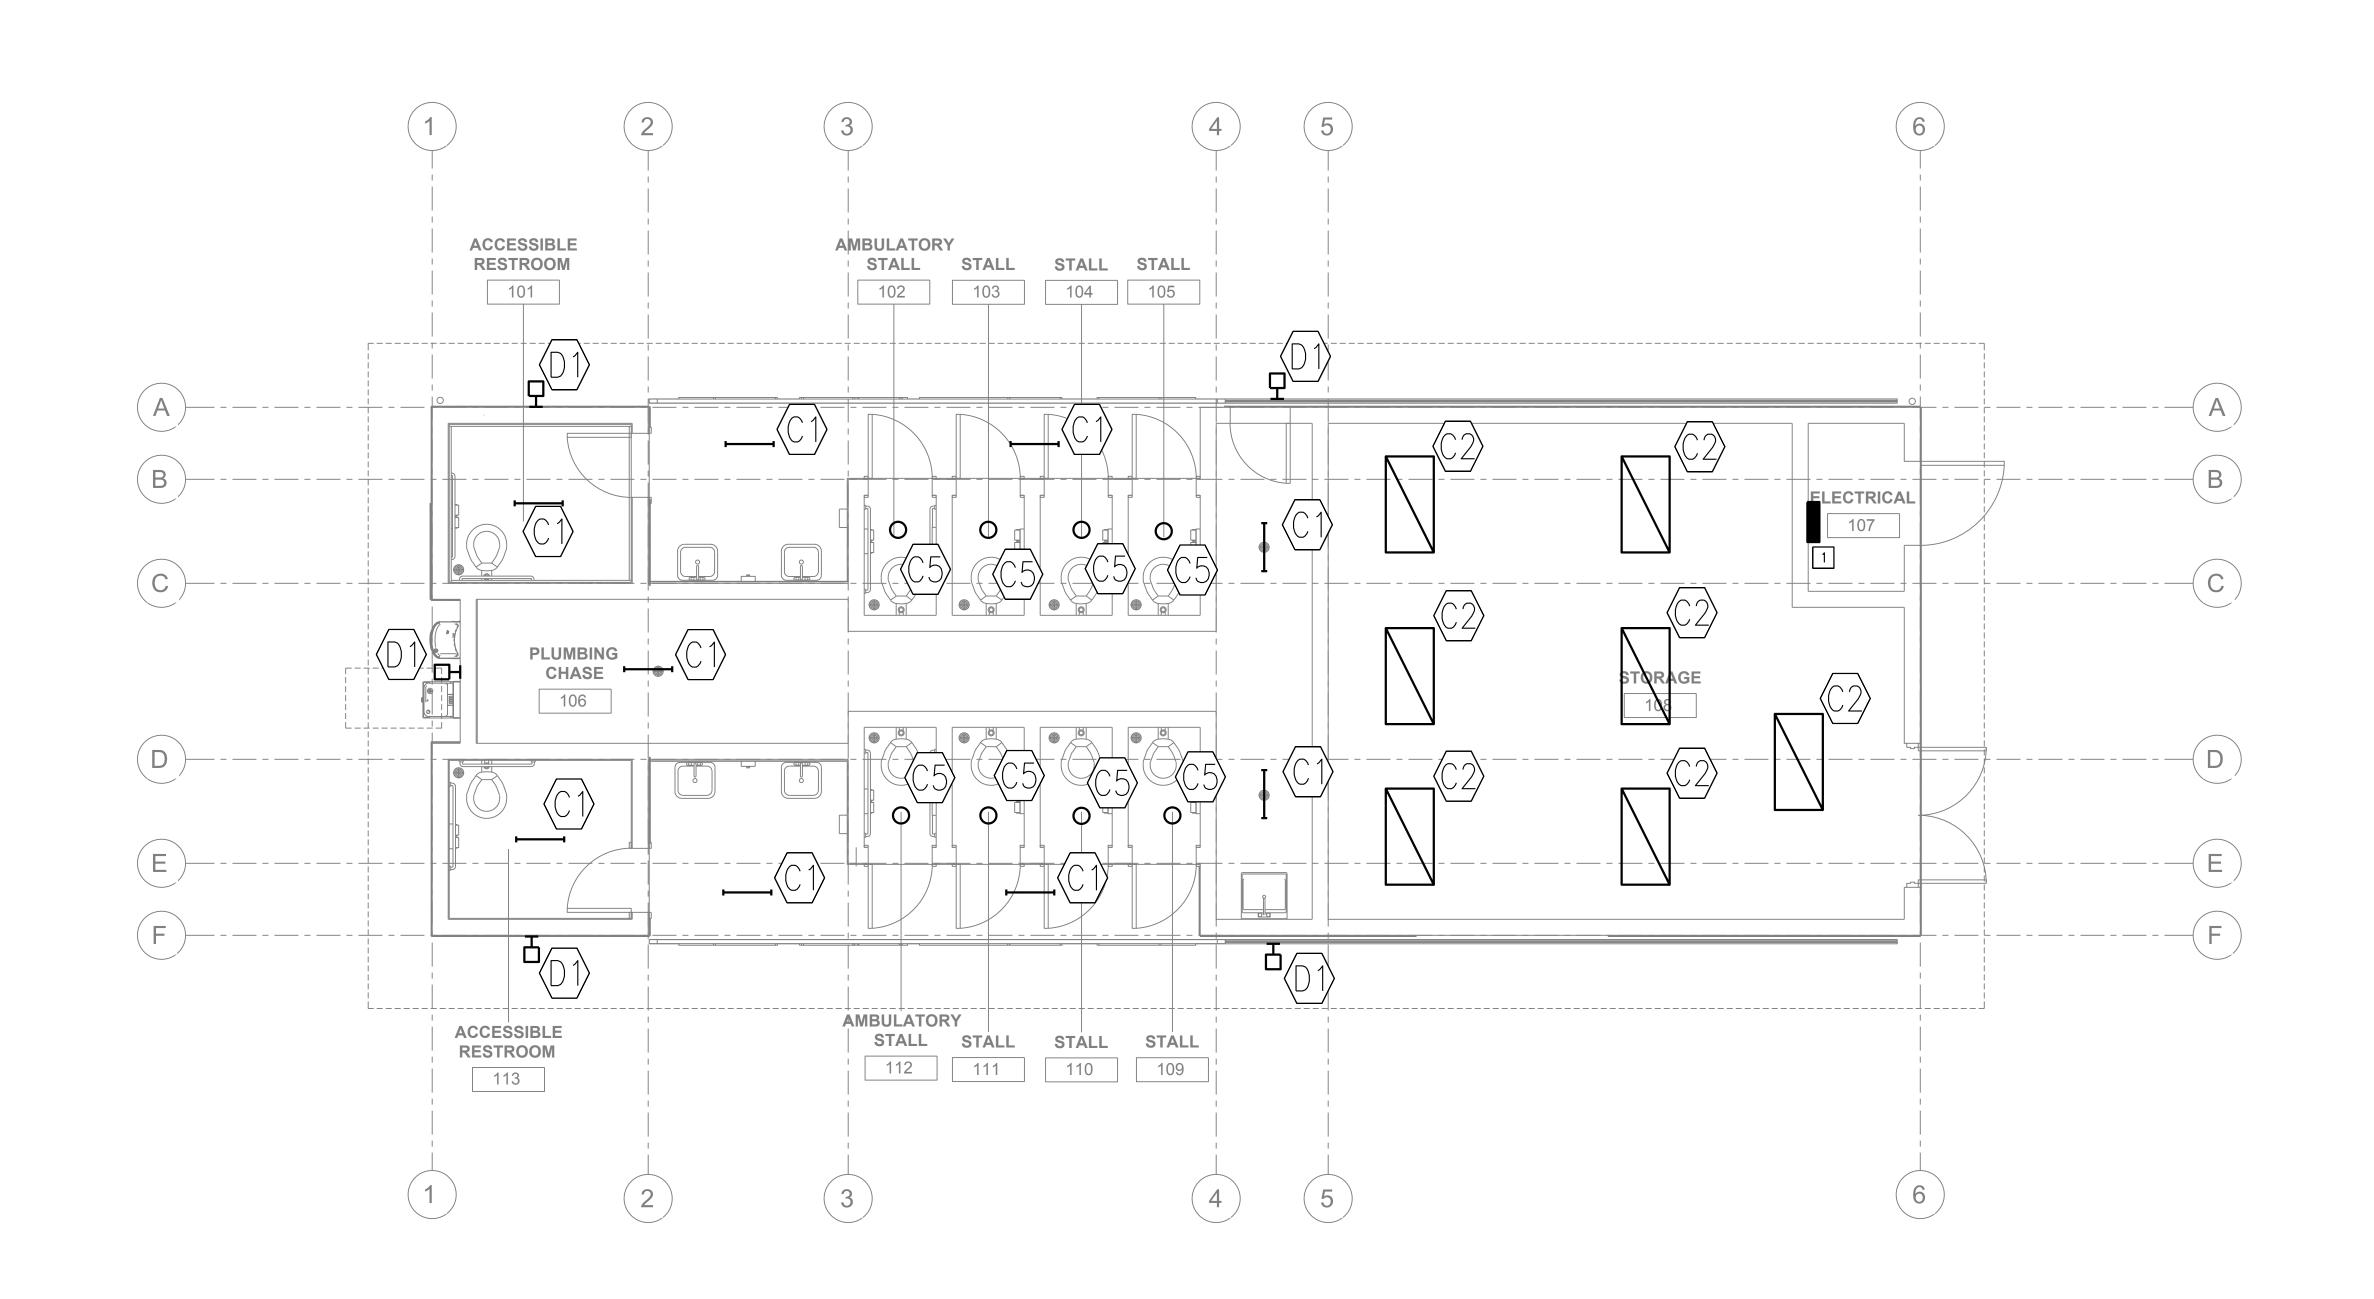
THE GENERAL DEVELOPMENT PLAN

ROBB FIELD

COMMUNITY PARK

COUNCIL DISTRICT NO. 2 COMM. PLAN AREA: MISSION PARK PSD

LAMBERT COORDINATES: 215-1695 THOMAS BROTHERS PAGE: PG. 59-B3 SUPPLEMENTAL SHEET NO.: 20 OF 24




GENERAL NOTES:

KEY NOTES:

PROVIDE NEW SINGLE POINT ELECTRICAL CONNECTION TO NEW COMFORT STATION PANEL (100A).

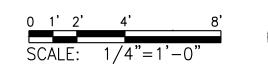ELECTRICAL FLOOR PLAN - PHASE 1 - COMFORT STATION





PRELIMINARY LIGHTING AND ELECTRICAL PLANS

CITY OF SAN DIEGO PARK AND RECREATION DEPARTMENT

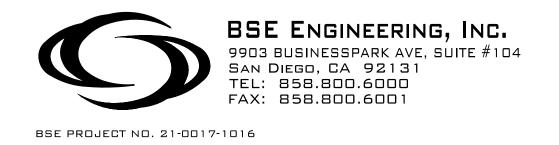
THE GENERAL DEVELOPMENT PLAN

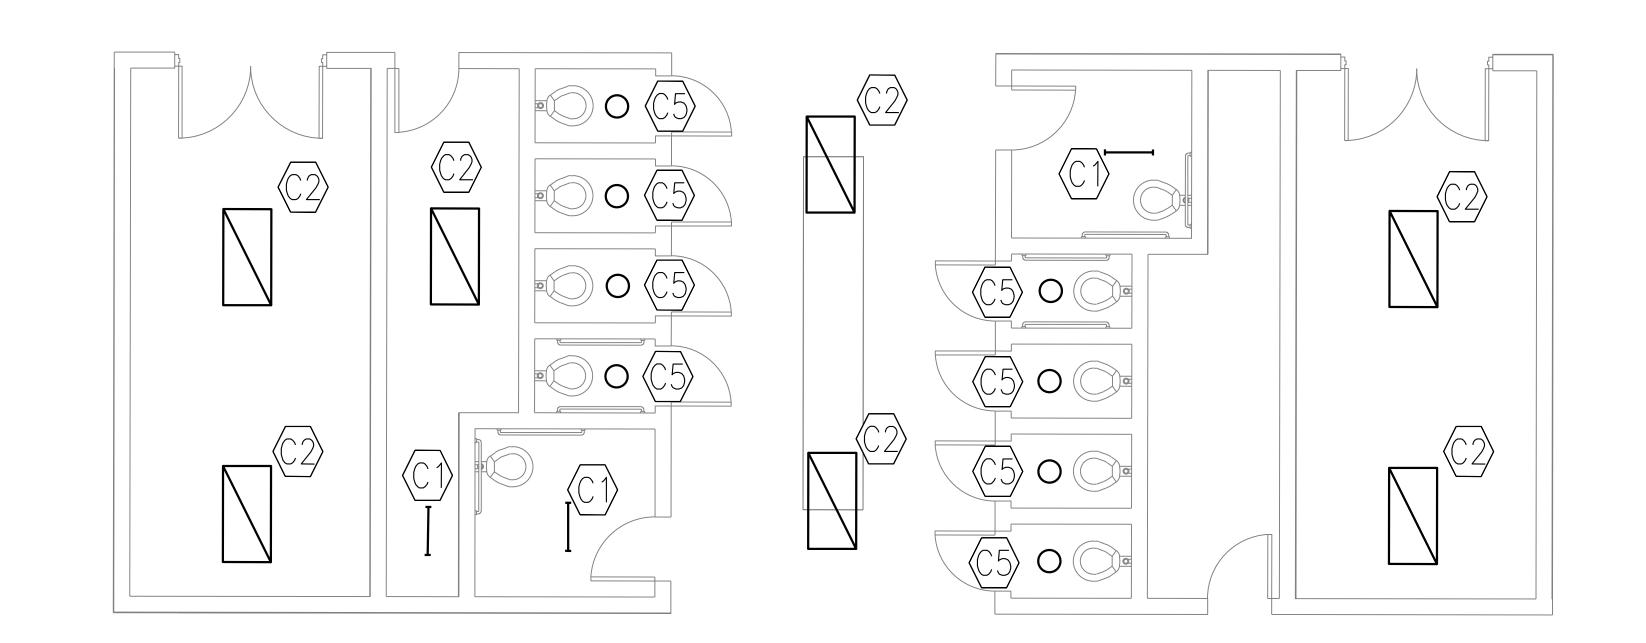
ROBB FIELD

COMMUNITY PARK

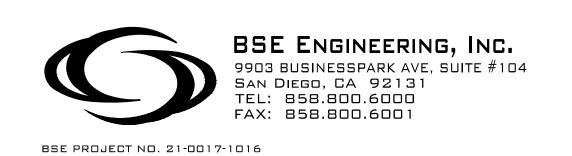
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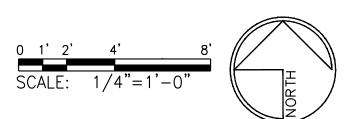
LAMBERT COORDINATES: 215-1695 THOMAS BROTHERS PAGE: PG. 59-B3 SUPPLEMENTAL SHEET NO.: 21 OF 24





ELECTRICAL FLOOR PLAN - PHASE 2 - COMFORT STATION





PRELIMINARY LIGHTING AND ELECTRICAL PLANS

CITY OF SAN DIEGO PARK AND RECREATION DEPARTMENT THE GENERAL DEVELOPMENT PLAN ROBB FIELD COMMUNITY PARK COUNCIL DISTRICT NO. 2 COMM. PLAN AREA: MISSION PARK THOMAS BROTHERS PAGE: PG. 59-B3 SUPPLEMENTAL SHEET NO.: 22 OF 24 LAMBERT COORDINATES: 215-1695

GENERAL NOTES:

KEY NOTES:







EXISTING PANEL HP1



EXISTING PANEL HP1 LIGHTING CONTROLS



EXISTING PANEL HP2

SCALE 4



EXISTING EXTERIOR UTILITY
AND DISTRIBUTION EQUIPMENT



5 BACK OF EAST GEAR

NONE



PRELIMINARY LIGHTING AND ELECTRICAL PLANS

CITY OF SAN DIEGO PARK AND RECREATION DEPARTMENT


THE GENERAL DEVELOPMENT PLAN

ROBB FIELD

COMMUNITY PARK


COUNCIL DISTRICT NO. 2 COMM. PLAN AREA: MISSION PARK PSD

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SAN DIEGO, CA 92131
TEL: 858.800.6000
FAX: 858.800.6001

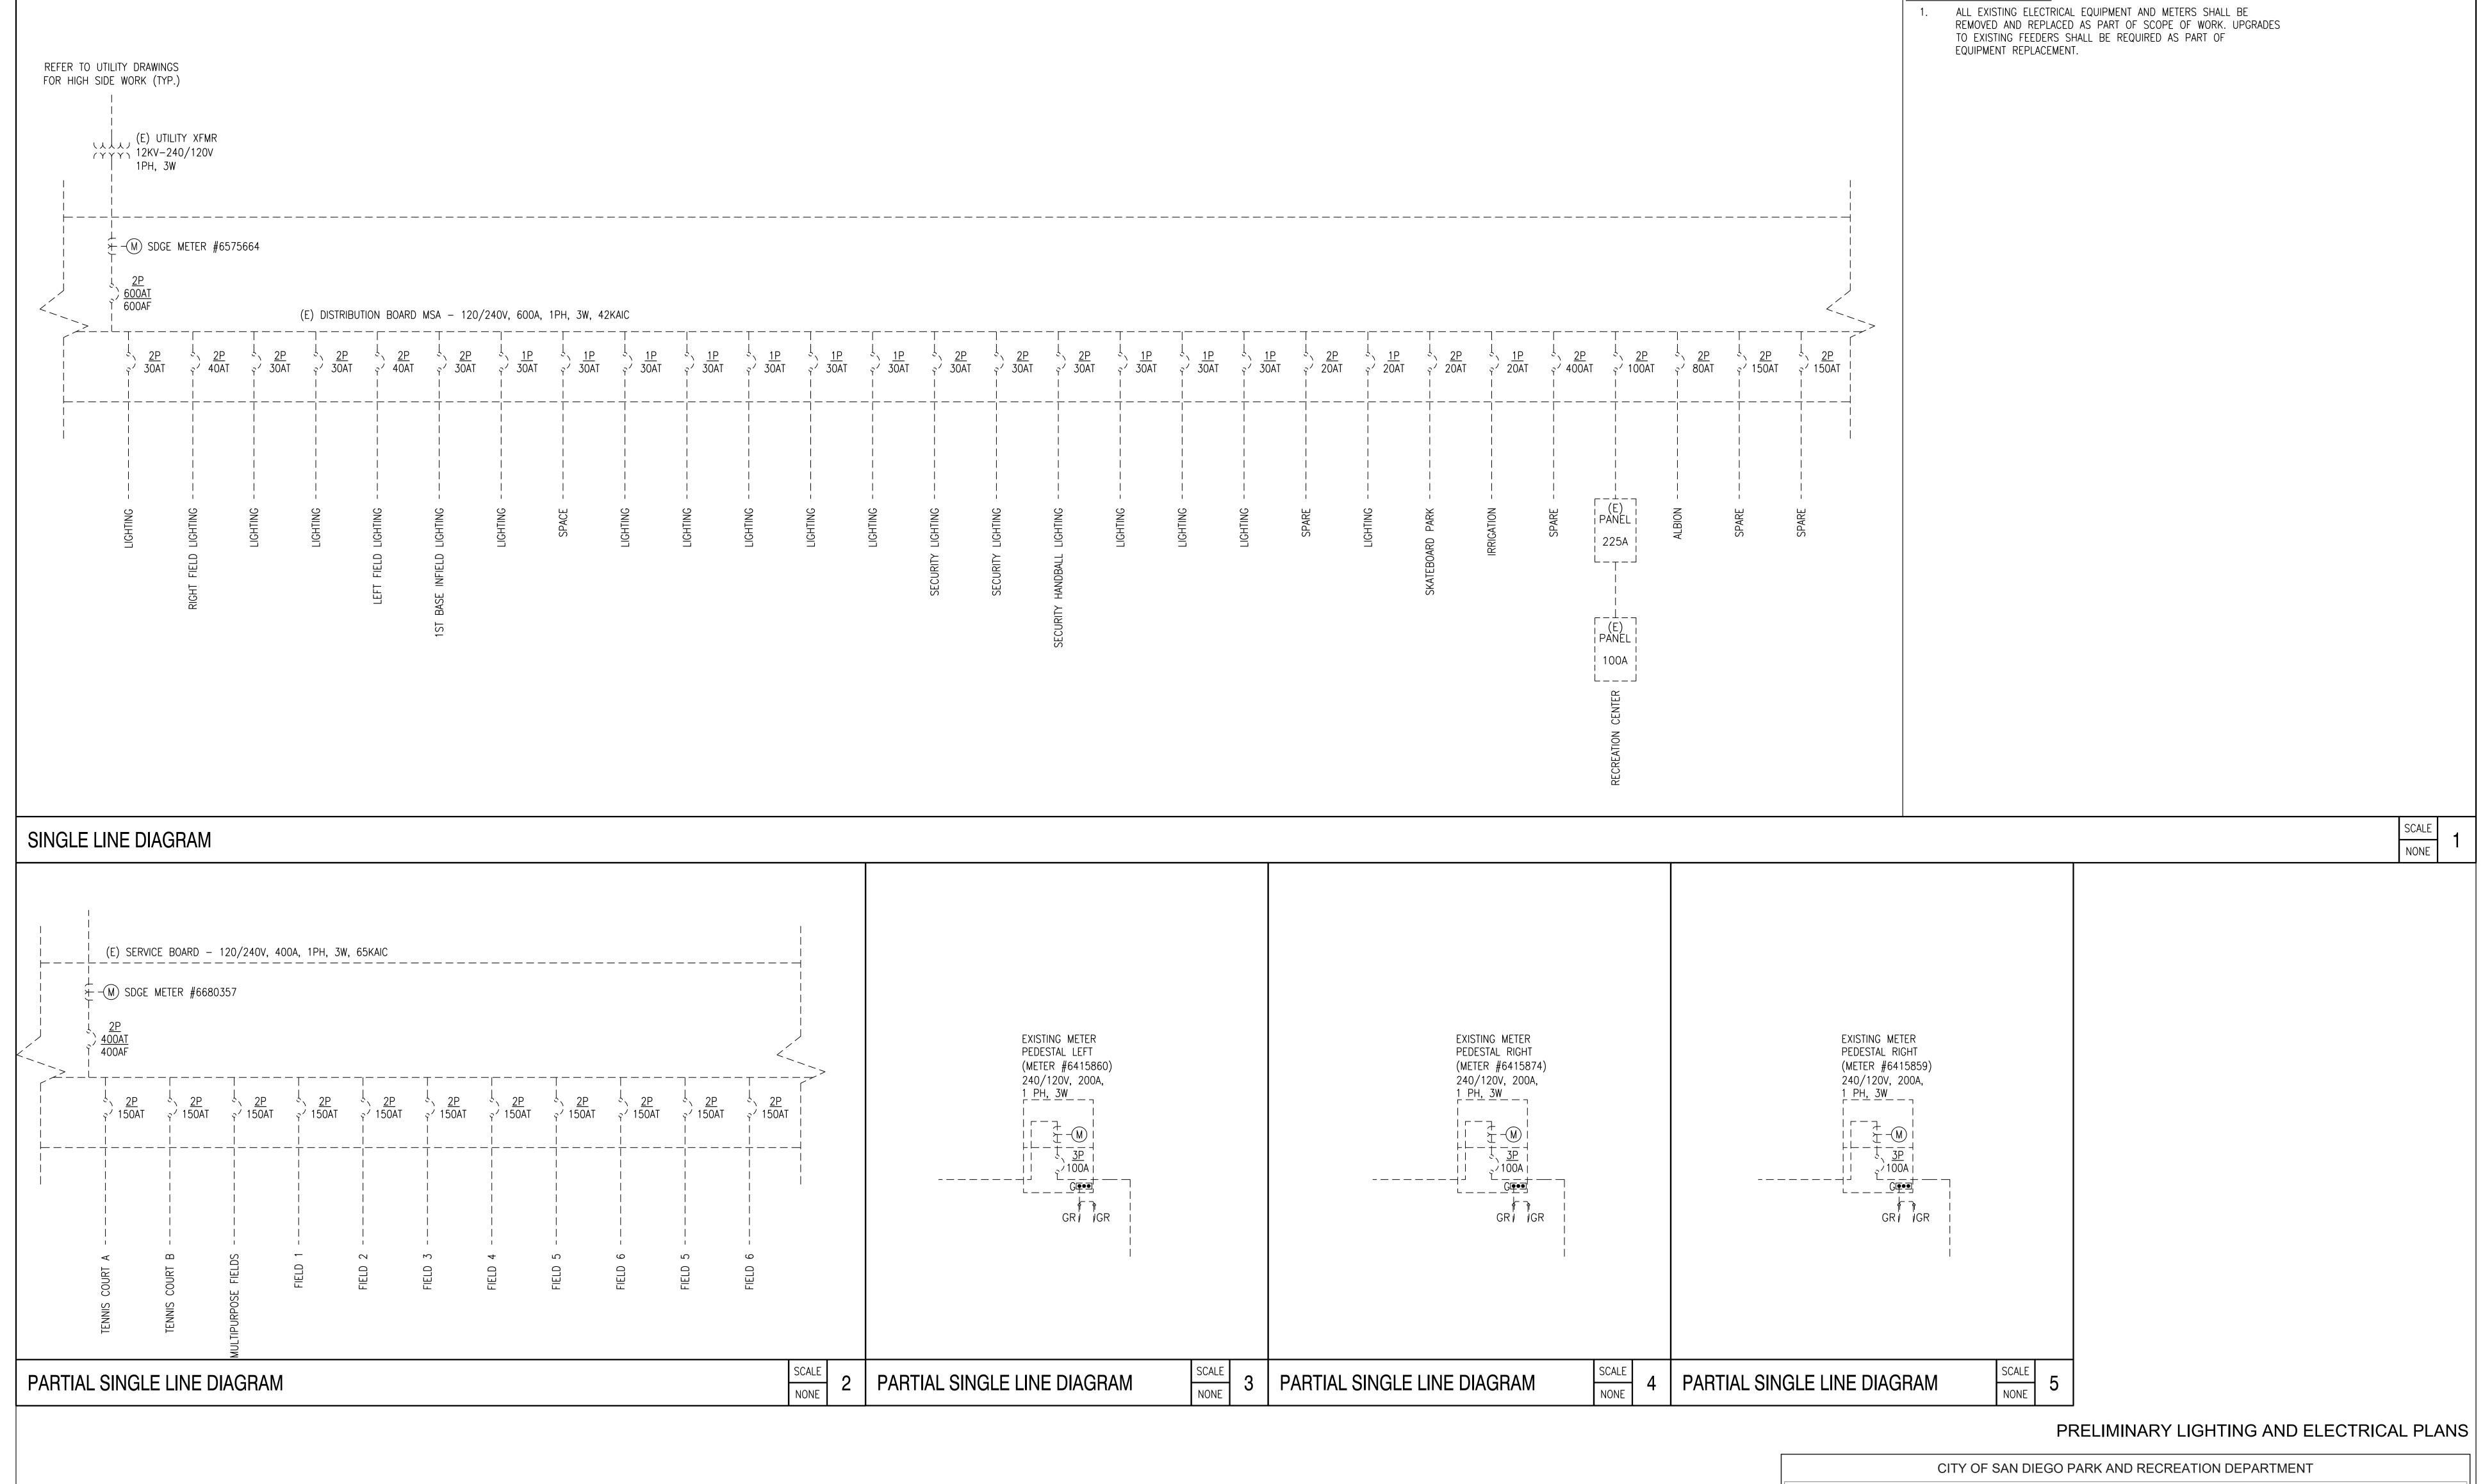BSE PROJECT NO. 21-0017-1016



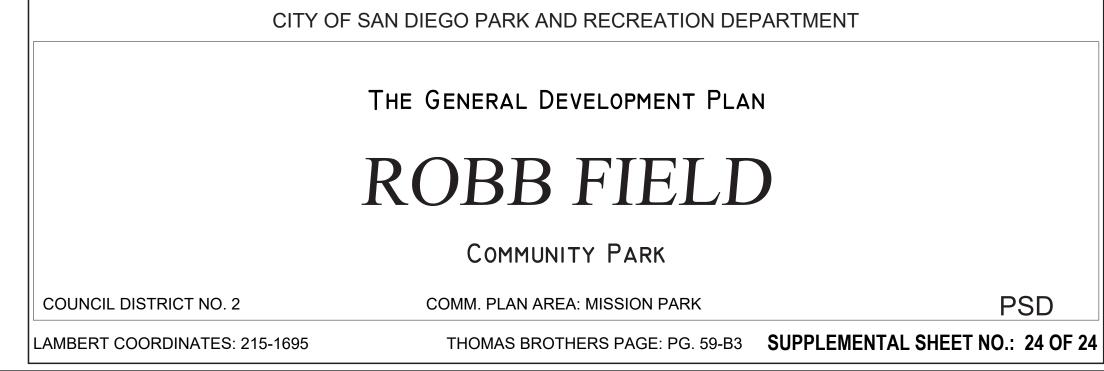GENERAL NOTES: