La Jolla Shores Planned District Advisory Board Online Virtual Meeting

Please provide the following information on this form for calendaring your project on an upcoming La Jolla Shores Planned District Advisory Board meeting.

For Action Items

- Project PTS number from Development Services and project name (only submitted projects can be heard as action items): 670715
- Address and APN(s): 7946 Paseo Del Ocaso, APN: 346-503-11
- Project contact name, phone, e-mail: <u>Joshua Kordasiewicz, Axon Architecture, 619-208-3222, josh@axonarch.com</u>
- Project description: Remodel single family residence, second story master suite addition with 2 story addition at rear of property that includes quest quarters
- In addition, provide the following:
 - o lot size: <u>5,423 SF</u>
 - o existing structure square footage and FAR (if applicable): 2,011 SF, .36 FAR
 - o proposed square footage and FAR: 3,605 SF, .66 FAR
 - o existing and proposed setbacks on all sides:
 - 1. Proposed: South Side Yard: 0'-0", North Side Yard: 4'-6", Front: 15'-2", Rear: 9'-5"
 - 2. Existing: South Side Yard: 0'-0", North Side Yard: 9'-3", Front: 20'-2", Rear: 9'-5"
 - o height if greater than 1-story (above ground): <u>28'-10"</u>

For Information Items

• Project name (Unsubmitted projects can be informational items if the development								
	seeking comments and direction from the Trustees on the concept):							
•	Address and APN(s):							
•	Project contact name, phone, e-mail:							
•	Project description:							
•	In addition to the project description, please provide the following:							
	o lot size:							
	 existing structure square footage and FAR (if applicable): 							
	o proposed square footage and FAR:							
	 existing and proposed setbacks on all sides: 							
	 height if greater than 1-story (above ground): 							
•	Project aspect(s) that the applicant team is seeking Trustee direction on. (community character							
	aesthetics, design features, etc.):							

Exhibits and other materials to provide:

Exhibits and other project-related presentation materials (e.g. site plan, elevations, exhibits showing addition/remodel areas, etc.) although not required, are extremely helpful in informing the Advisory Board's review and understanding of a project. The following exhibits and materials are recommended and if provided by the applicant, will be attached to the agenda and posted to the City's website for view by the public:

- All exhibits should be sized to 8 ½" X 11" format
- Exhibits, which can contain the following:
 - A. A site plan showing the street, the property line on all sides, the setbacks on all sides, and the setbacks from the property lines to the neighboring building;

(CONTINUED ON THE NEXT PAGE)

- B. Elevations for all sides;
- C. If the proposal is for a remodel, a clear delineation of what part of the proposed structure is new construction
- D. If the proposal is for a building with more than one story, show:
 - how the upper story sits on the story beneath it (setback of the upper story from the lower story);
 - > the distance from the proposed upper story to comparable stories of the neighboring buildings; and
 - > the height of neighboring buildings compared to the proposed structure's height.
- Any surveys that indicate similarities in floor area or architectural style in the surrounding neighborhood
- Any communications from adjacent neighbors, local neighborhood groups, and/or the Homeowners' Association

Meeting Presentation – *updated 8/31/20*

Due to COVID-19, the La Jolla Shores Planned District Advisory Group meetings will be conducted as online virtual meetings utilizing the Zoom application. Staff will provide all applicants, as well as the public instructions for logging in and participating in the meeting.

For the meeting, the applicant should provide a concise powerpoint presentation on their project or simply present the exhibits provided for the agenda distribution as their presentation. During the meeting, staff will allow the applicant to become the presenter so that they may share their screen and run their presentation.

PLEASE DO NOT PROVIDE THE FOLLOWING:

- The complete plan set of the project. Complete plan sets take up a lot of memory to distribute and most of the information is not necessary for the Advisory Board's review.
- Plans or exhibits of the interior of the project. Interiors are not reviewed by the Advisory Board.
- Personal contact information of the property owners of the project should not be included, unless they are the "owner/applicant" and they are the designated point of contact

The Trustees are very keen to know that the neighbors in the immediate vicinity have been noticed and their views noted. Community conformity, setbacks, FAR, parking, view corridors, bulk & scale, and articulation are key discussion points on all projects. Action Items will be heard first.

Thank you,


Please return the information requested to:

Marlon I. Pangilinan Senior Planner Planning Department 9485 Aero Drive MS 413 San Diego CA 92123 619-235-5293 www.sandiego.gov/planning

	FRONT SETBACK	REAR SETBACK	LEFT SIDEYARD	RIGHT SIDEYARD	HOUSE SQ FT.	LOT SIZE	FAR
7985 Calle De La Plata	15'-0"	10'-0"	15'-0"	15'-0"	1,994 SF	7,706 SF	0.26
7975 Calle De La Plata	15'-0"	10'-0"	5'-0"	5'-0"	4,546 SF	7,206 SF	0.63
7935 El Paseo Grande	18'-0"	20'-0"	0'-0"	4'-0"	1,538 SF	6,239 SF	0.24
7927 El Paseo Grande	15'-2"	4'-0"	4'-0"	4'-0"	3,903 SF	6,300 SF	0.62
7921 El Paseo Grande	20'-0"	0'-0"	3'-0"	8'-0"	1,908 SF	6,334 SF	0.3
7911 El Paseo Grande	17'-0"	6'-0"	12'-0"	6'-0"	3,283 SF	6,642 SF	0.49
7905 El Paseo Grande	18'-0"	3'-0"	15'-0"	12'-0"	2,751 SF	9,638 SF	0.28
7906 Paseo Del Ocaso	15'-0"	15'-0"	3'-0"	3'-0"	1,298 SF	4,983 SF	0.26
7916 Paseo Del Ocaso	15'-0"	3'-0"	3'-0"	3'-0"	2,688 SF	5,302 SF	0.5
7926 Paseo Del Ocaso	17'-0"	5'-0"	3'-0"	4'-0"	1,905 SF	5,097 SF	0.37
7936 Paseo Del Ocaso	20'-0"	4'-0"	4'-0"	3'-0"	1,956 SF	5,046 SF	0.38
7946 Paseo Del Ocaso	15'-0"	9'-5"	0'-0"	4'-6"	3,606.3 SF	5,422.5 SF	0.66
7956 Paseo Del Ocaso	15'-0"	15'-0"	4'-0"	4'-0"	3,268 SF	6,000 SF	0.6
7964 Paseo Del Ocaso	20'-0'	4'-0"	4'-0"	4'-0"	2,300 SF	5,420 SF	0.42
7974 Paseo Del Ocaso	20'-0"	24'-0"	4'-0"	2'-0"	3,652 SF	5,492 SF	0.66
7975 Paseo Del Ocaso	18'-0"	15'-0"	8'-0"	4'-0"	1,986 SF	7,307 SF	0.27
7967 Paseo Del Ocaso	17'-0"	10'-0"	4'-0"	4'-0"	1,971 SF	7,419 SF	0.26
7959 Paseo Del Ocaso	18'-0"	0'-0"	2'-0"	5'-0"	2,192 SF	7,697 SF	0.28
7951 Paseo Del Ocaso	15'-0"	10'-0"	2'-0"	3'-0"	1,799 SF	7,488 SF	0.24
7941 Paseo Del Ocaso	12'-0"	2'-0"	3'-0"	5'-0"	1,515 SF	7,646 SF	0.19
7931 Paseo Del Ocaso	15'-0"	5'-0"	2'-0"	12'-0"	2,542 SF	7,303 SF	0.34
7921 Paseo Del Ocaso	20'-0"	15'-0"	3'-0"	3'-0"	2,258 SF	7,399 SF	0.3
7911 Paseo Del Ocaso	20'-0"	15'-0"	6'-0"	10'-0"	1,256 SF	7,246 SF	0.17
7905 Paseo Del Ocaso	15'-0"	15'-0"	5'-0"	4'-0"	1,856 SF	7,293 SF	0.25
7964 La Jolla Shores Drive	40'-0"	30'-0"	5'-0"	3'-0"	2,470 SF	7,201 SF	0.34
7958 La Jolla Shores Drive	30'-0"	30'-0"	5'-0"	3'-0"	2,601 SF	7,449 SF	0.35
7950 La Jolla Shores Drive	20'-0"	6'-0"	4'-0"	12'-0"	1,169 SF	6,960 SF	0.16
7944 La Jolla Shores Drive	20'-0"	10'-0"	10'-0"	3'-0"	1,437 SF	7,200 SF	0.2
7940 La Jolla Shores Drive	10'-0"	5'-0"	2'-0"	5'-0"	2,673 SF	7,204 SF	0.37
7934 La Jolla Shores Drive	10'-0"	20'-0"	4'-0"	4'-0"	2,161 SF	7,238 SF	0.29
7928 La Jolla Shores Drive	20'-0"	30'-0"	4'-0"	4'-0"	1,631 SF	7,505 SF	0.21
7924 La Jolla Shores Drive	20'-0"	30'-0"	5'-0"	4'-0"	1,260 SF	7,585 SF	0.16
7920 La Jolla Shores Drive	20'-0"	40'-0"	6'-0"	12'-0"	1,943 SF	7,745 SF	0.25

GALLAGHER RESIDENCE

7946 PASEO DEL OCASO **LA JOLLA, CA 92037**

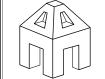


ARCHITECTURE


4344 ROBBINS STREET SAN DIEGO, CA 92122

CONTACT: JOSHUA J KORDASIEWICZ

619-208-3222 JOSH@AXONARCH.COM

Cycle Issues Cycle Issues 17779 # 25 are 17779 # 2	OOM.	
LEAG COSTA 122 Find Animal, San Diago, CA SPETITH SERVICE AND SERV		
Project More #275		
For Park Plance (1987) 1 1 1 1 1 1 1 1 1 1 1 1 1 1 1 1 1 1 1		
ACCHITECTURAL Cycle Type: 6 Noticitie Space: Enter Statistic A-1.1 STE PLAN A-2.0 DEMOLITION PLAN A-2.1 PROPOSED FIRST FLOOR PLAN Not Enter Statistic Space: Enter Statistic A-2.1 PROPOSED FIRST FLOOR PLAN Labracian Space: Enter Statistic S		1
Reviewer: Stance, Solder (1973-284-548) (1973-284-5		
Nature Control		
A-2.2 PROPOSED SECOND FLOOR PLAN 8427 HOVENWEEP CT A-4.1 PROPOSED ROOF PLAN A-4.1 PROPOSED ROOF PLAN		
SAN DIEGO, CA 92129 A-5.1 PROPOSED ELEVATIONS		
A-5.2 PROPOSED ELEVATIONS A-5.3 PROPOSED ELEVATIONS A-5.3 PROPOSED ELEVATIONS		
The property located of PAS Page 19 and 19 a		l H
The property imputed in Patter Greater (1998) and the Patter Great		EN.
Respond (New house) — re-evaluation for eligibility under hood designation criteria. SAN DIEGO, CA 92120 A-6.1 PROPOSED SECTIONS During this movie buildings are evaluated for eligibility under hood designation criteria. The designation criteria. BRIAN KATZ A-6.2 PROPOSED SECTIONS		E Sec
His juminera and finding in information of the property of the		33.50
H 3 Many information requesting the review process can be found in Information that states 560: 619-995-9773		RESIDE vel Ocas 92037
Interviews and Reging and Anti-American Anti		∥
is not the Buy propriet with the purposed of the transport plant of the Propriet Delta Service (Conference on the Conference on the Confer		ER seo
or Accent (Register) (New Install)		HE Pass
If City you'll decommon, but in a policytical page in the control industrial resource and was also and the control industrial resource and the second industrial resource and the second industrial resource and processes may provide only the processes of the page and only represent address response to the second industrial resource and the second industrial reso		
8 6. Lossificace(i) if the prospected project in rest convenient with the Standards, the applicant may represent project or present an instance report that provide any other project programs in a final form that substance in the Standards report that provide any other project projec		
SCO (Informational Only, No Plagueses or Action (Informational Only, No Plagueses or Action (Informational Only, No Plagueses or Action (Informational Only) (Informational On	OPE OF WORK 01	
AUDICESS. 7940 PASCO DEL CICASO		
LA JOLLA, CA 92037 Legisla end dawn der man der best dawn der gerinden frestund an einer redevokating organization restaurat an einer redevokating organization redevokation redevokating organization redevokating organization redevoka	TY OF SAN DIEGO, STATE	
A.P.N.: 346-503-11		
YEAR BUILT: 1918 TYPE OF CONSTRUCTION: V-B, NON-SPRINKLERED		PHASE
OCCUPANCY: R-3/U		CONSTRUCTION DO
NUMBER OF STORIES: SINGLE STORY SINGLE FAMILY RESIDENCE		REVISIONS
APPLICABLE CODES: 2013 CALIFORNIA RESIDENTIAL CODE, WHICH ADDPTS THE 2016 IRC APPLICABLE CODES: 2015 CALIFORNIA RESIDENTIAL CODE, WHICH ADDPTS THE 2016 IRC APPLICABLE CODES: 2015 CALIFORNIA RESIDENTIAL CODE, WHICH ADDPTS THE 20	C, 2016 UMC, 2016 UPC	2019-08-04 PROJECT ST 2019-09-06 OWNER MI
PROJECT TEAM 04 The counter the property is not eligible for designation. The joint have not been started by Plan-Historic staff. Too		2019-12-05 OWNER RE 2020-02-12 OWNER M
20163: 13700-37	BUODITY ADEA	2020-02-19 OWNER RE
PLANNED DISTRICT: LA JOLLA SHORES PLANNED DISTRICT	RIORITT AREA	2020-05-07 OWNER R 2020-06-19 OWNER R
PASEO DORADO GEO. CATEGORY: 52		2020-09-02 CITY SUBM
HEIGHT LIMIT: 30'-0"		2020-11-6 CITY SUBM 2021-01-18 TO COMM
SETBACKS: LEFT SIDEYARD: 0'-0" (EXISTING)		DRAWN BY CHEC
RIGHT SIDE/ARD: 41-6" FEDUT. 31-20		AB/JK
PROJECT SITE PROJECT SITE REAR: 9'-5" (EXISTING)		The drawings, arrangements, annotation presentations as indicated on these dra
PARKING: EXISTING PROPOSED		property of Axon Architecture, Inc. On authorship of these documents are ret
		entirety. Reproduction, publication or re-use by
		whole or part, without written permis Architecture, Inc. is prohibited. Use of the authorized for the sole purpose of the
PROPOSED FAR: .66 SF PROPOSED AREA: 3,606.3 SF		location specified in the title block a construction or use for any other
		The signed and stamped hard copies or signature of the Architect of Record are Instruments of Service and are the or
AREA: EXISTING 2,010.2 SF		Instruments of Service and are the o documents of record. Any modification from these drawings or accompanying
		without the written consent of Axon Arci prohibited. Use of these drawings of
	TOTAL 3,217 SF	specifications shall constitute the acce these restrictions.
TORREY PINES ROAD PROPOSED ADU TOTAL AREA OF ADDITION	TOTAL AREA	PROJECT NO. 19
388 SF 1,547 SF	3,605 SF	JANUARY 18, 20
EXISTING GARAGE PROPOSED GARAGE 229.6 SF 223.5 SF		SHEET TITLE TITLE SHEET
PROPOSED DECK 362.3 SF		SHEET NO.
selectin regarding the Part-Habour review, please call fielding Station at 2011; 254-6545. Project Marc 473761 Cyclin. 8		
SER V 5E 503.36 O = TRANSIT STOPS		A-0.1
HISTORICAL CLEARANCE 06 VICINITY MAP 05 SHEET INDEX 03 PROJECT IN	NFORMATION 02	SHEET: OF

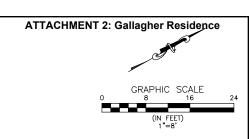

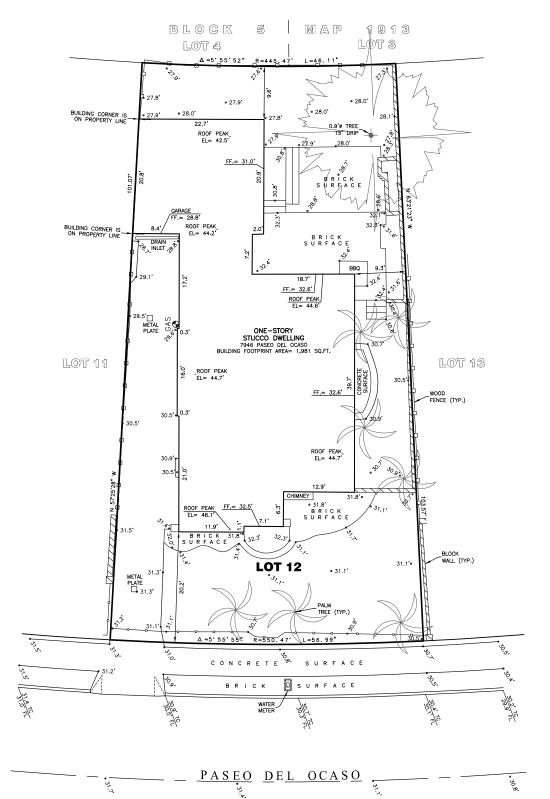

BENCH MARK: CITY OF SAN DIEGO VERTICAL CONTROL SOUTHEAST BRASS PLUG AT PASCO DEL OCASO AND CALLE DE LA PLATA ELEVATION= 35.851' DATUM: MEAN SEA LEVEL

LEGAL DESCRIPTION:
LOT 12 OF BLOCK 5 IN THE CITY OF SAN DIEGO, COUNTY OF SAN DIEGO, STATE OF
CALIFORNIA ACCORDING TO MAP THERE NO. 1913 FILED IN THE OFFICE OF THE
COUNTY RECORDER OF SAN DIEGO COUNTY ON JUNE 3, 1926 OF OFFICIAL RECORDS.




Mathew Sawyer MATHEW S. SAWYER, P.L.S. 87


TOPOGRAPHICAL SURVEY

For the exclusive use of
ELLEN M. GALLAGHER REVOCABLE TRUST 7-31-06
7946 PASEO DEL OCASO
LA JOLLA, CALIFORNIA 92037


Sawyer Land Surveying, Inc. 8427 Hovenweep Ct., San Diego, California 92129 (858) 692-6922, EMAIL: msawyerpls@yahoo.com

	Date: 6-25-2020	Revised:		Revised:		
	Scale: 1"=8'	Drawn by: M.S.S.		Sheet 1 of 1		
739	Drawing: 7946PaseoDelOcasoTS.dwg			A.P.N.: 346-503-11-00		

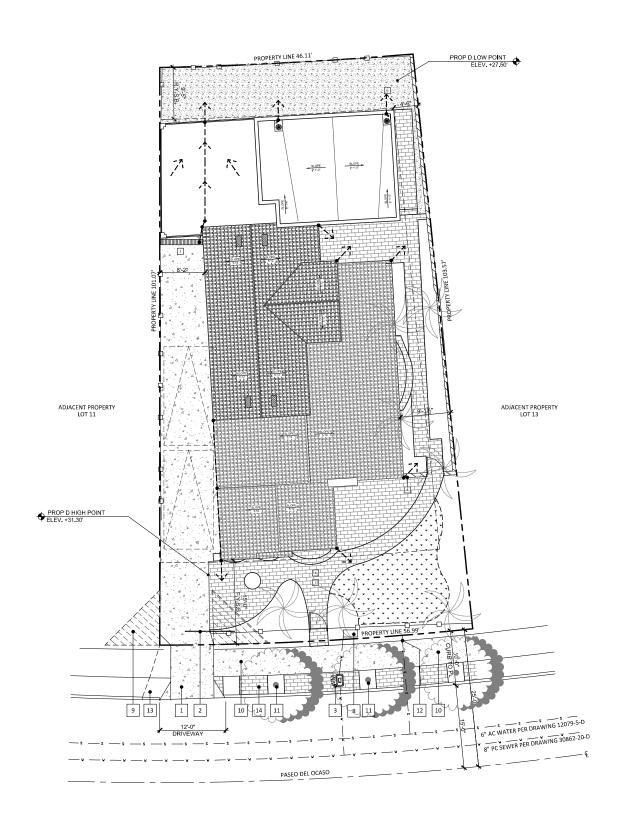

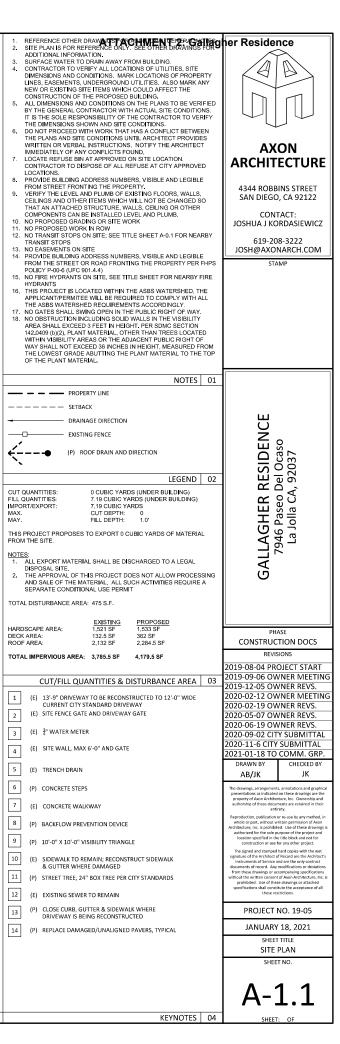

SITE PLAN | SCALE: 1/8" = 1'-0" | 05

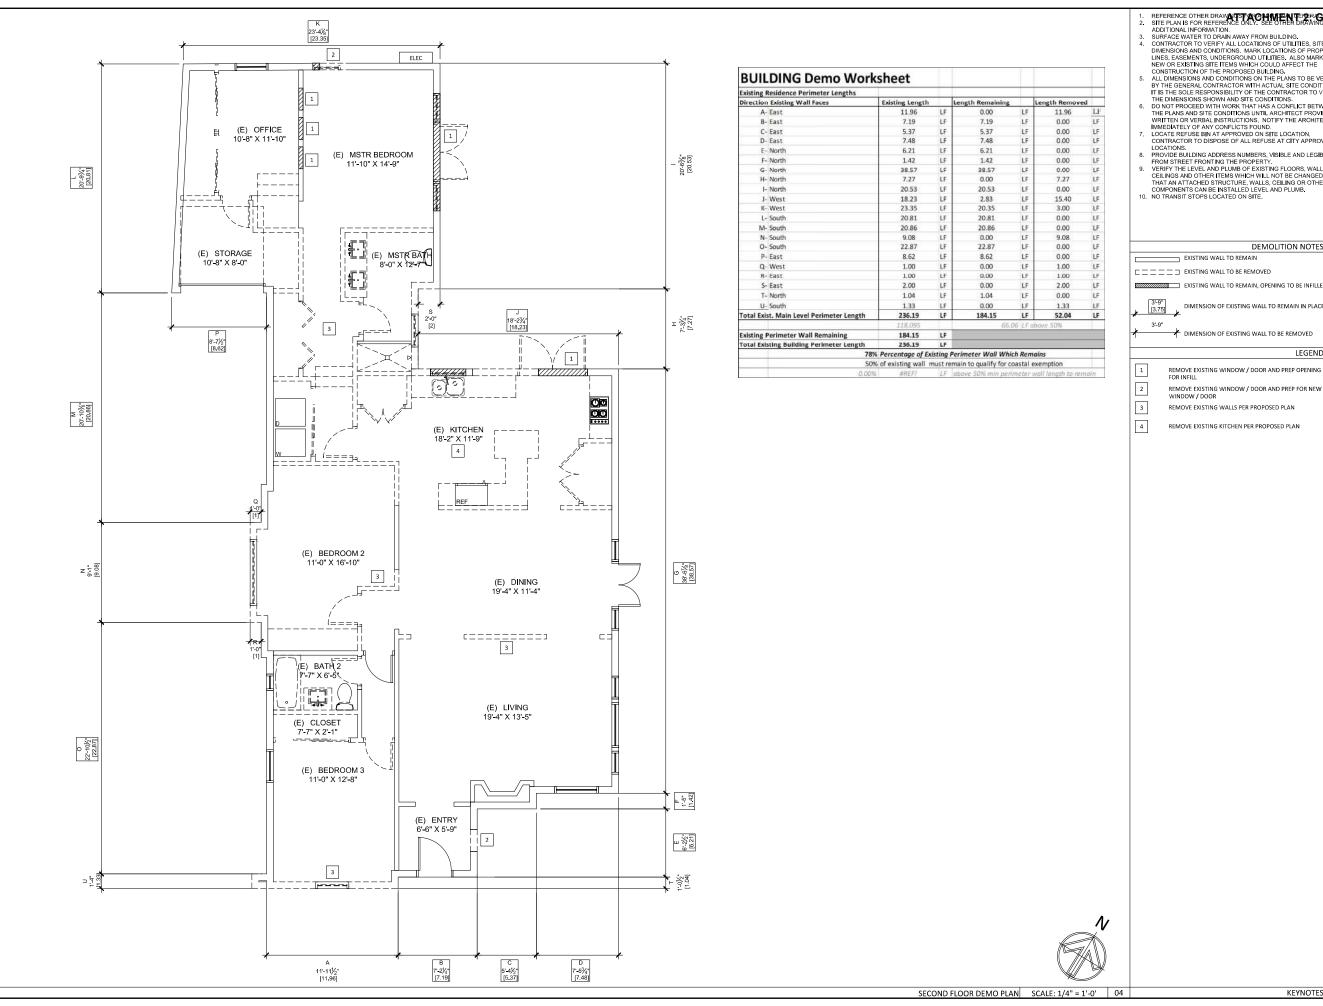

REFERENCE OTHER DRAWAUTTA CHART NEEDER CHIESE

SITE PLAN IS FOR REFERENCE ONLY. SEE OTHER DRAWINGS FOR ADDITIONAL INFORMATION

SURFACE WATER TO DRAW AY FROM BUILDING.

CONTRACTOR TO VERIFY ALL LOCATIONS OF UTILITIES, SITE DIMENSIONS AND CONDITIONS. MARK LOCATIONS OF PROPERTY LINES, EASEMENTS, UNDERGROUND UTILITIES, ALSO MARK ANY NEW OR EXISTING SITE THEM WHICH COULD AFFECT THE CONSTRUCTION OF THE PROPOSED BUILDING.

ALL DIMENSIONS AND CONDITIONS ON THE PLANS TO BE VERIFIED BY THE GENERAL CONTRACTOR WITH ACTUAL SITE CONDITIONS. IT IS THE SOLE RESPONSIBILITY OF THE CONTRACTOR TO VERIFY THE DIMENSIONS SHOWN AND SITE CONDITIONS.

DO NOT PROCEDE WITH WORK THAT HAS A CONFLICT BETWEEN THE PLANS AND SITE CONDITIONS UNTIL ACCONTRACTOR TO VERIFY WHITTEN OR VERBAL INSTRUCTIONS. MOTIFY THE ARCHITECT INMEDIATELY OF ANY CONFLICTS FOUND.

LOCATE REFUSE BIN AT APPROVED ON SITE LOCATION. CONTRACTOR TO PROVED CONTRACTOR TO THE PROPERTY.

VERIFY THE LEVEL AND PLUMB OF EXISTING FLOORS, WALLS, CEILINGS AND OTHER TERM WHICH WILL NOT BE CHANGED SO THAT AN ATTACHED STRUCTURE, WALLS, CEILINGS AND OTHER TERMS WHICH WILL NOT BE CHANGED SO THAT AN ATTACHED STRUCTURE, WALLS, CEILINGS OR OTHER COMPONENTS CAN BE INSTRUCTURE, WALLS, CEILINGS OR OTHER COMPONENTS CAN BE INSTRUCT ON SITE. REFERENCE OTHER DRAWNUS FACHMENTE OF GAILED OF RESIDENCE SITE PLAN IS FOR REFERENCE ONLY. SEE OTHER DRAWINGS FOR 4 **AXON** ARCHITECTURE 4344 ROBBINS STREET SAN DIEGO, CA 92122 JOSHUA J KORDASIEWICZ 619-208-3222 JOSH@AXONARCH.COM DEMOLITION NOTES 01 → EXISTING WALL TO REMAIN □□□□□□ EXISTING WALL TO BE REMOVED EXISTING WALL TO REMAIN, OPENING TO BE INFILLED DIMENSION OF EXISTING WALL TO REMAIN IN PLACE DIMENSION OF EXISTING WALL TO BE REMOVED

LEGEND 02

GALLAGHER RESIDENCE 7946 Paseo Del Ocaso La Jolla CA, 92037

CONSTRUCTION DOCS

2019-08-04 PROJECT START 2019-09-06 OWNER MEETING 2019-12-05 OWNER REVS. 2020-02-12 OWNER MEETING 2020-02-19 OWNER REVS. 2020-05-07 OWNER REVS. 2020-06-19 OWNER REVS. 2020-09-02 CITY SUBMITTAL 2020-11-6 CITY SUBMITTAL


AB/JK

PROJECT NO. 19-05

JANUARY 18, 2021

PROPOSED DEMO PLAN

KEYNOTES 03

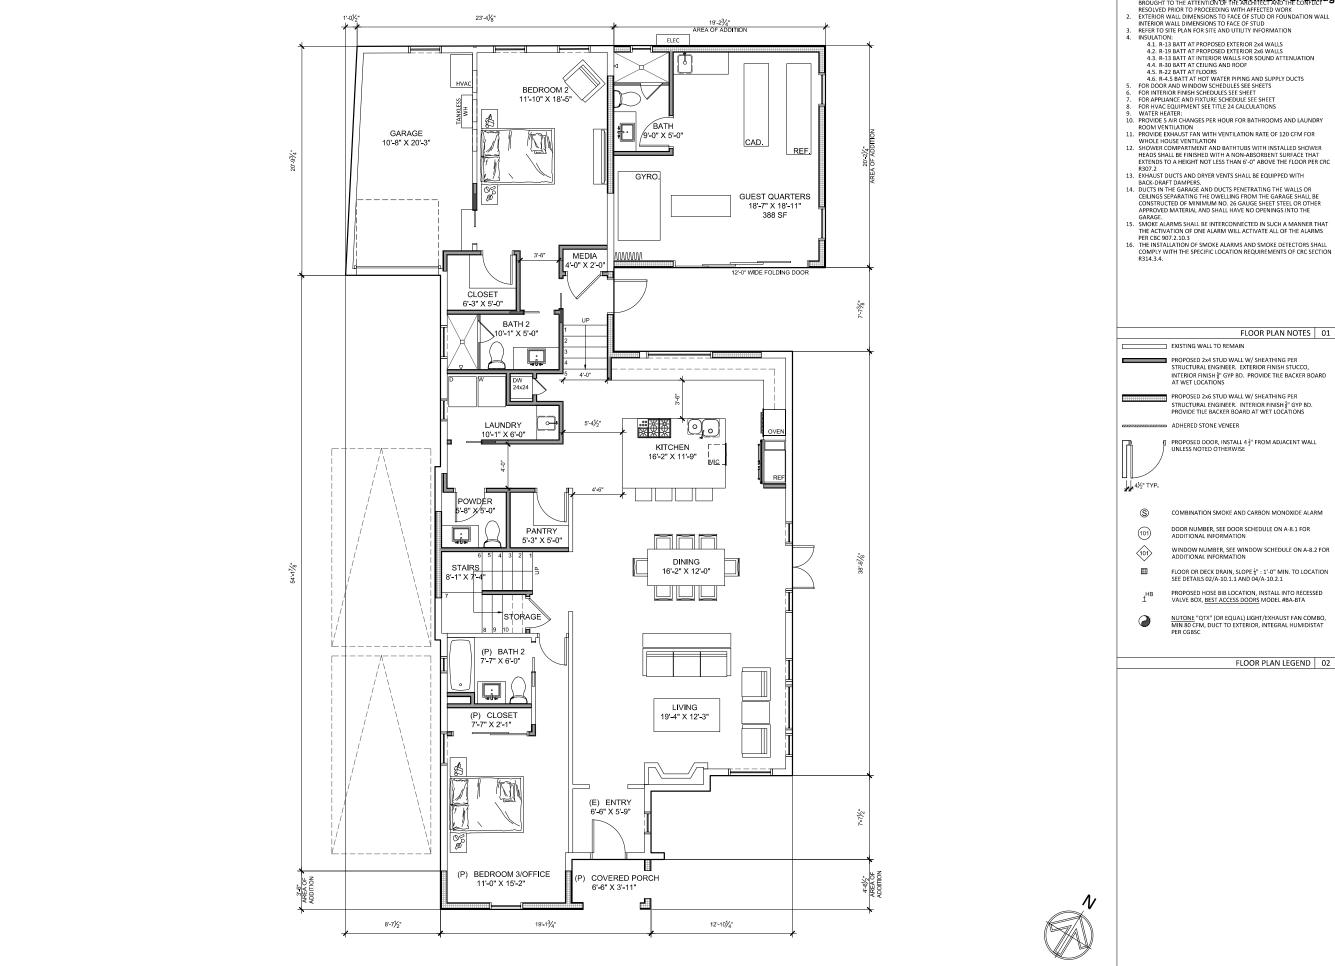

ALL DIMENSIONS TO BE FIELD THE ARCHITECT AND THE CONFLICT
BROUGHT TO THE ATTENTION OF THE ARCHITECT AND THE CONFLICT

BROUGHT TO THE ATTENTION OF THE ARCHITECT AND THE CONFLICT RESOLVED PRIOR TO PROCEEDING WITH AFFECTED WORK EXTERIOR WALL DIMENSIONS TO FACE OF STUD OR FOUNDATION WALL INTERIOR WALL DIMENSIONS TO FACE OF STUD

REFER TO SITE PLAN FOR SITE AND UTILITY INFORMATION



AXON ARCHITECTURE

4344 ROBBINS STREET SAN DIEGO, CA 92122

CONTACT: JOSHUA J KORDASIEWICZ

619-208-3222 JOSH@AXONARCH.COM

FLOOR PLAN NOTES 01

PROPOSED 2x4 STUD WALL W/ SHEATHING PER STRUCTURAL ENGINEER. EXTERIOR FINISH STUCCO, INTERIOR FINISH §" GYP BD. PROVIDE TILE BACKER BOARD AT WET LOCATIONS

PROPOSED 2x6 STUD WALL W/ SHEATHING PER STRUCTURAL ENGINEER. INTERIOR FINISH $\frac{5}{8}$ " GYP BD. PROVIDE TILE BACKER BOARD AT WET LOCATIONS



COMBINATION SMOKE AND CARBON MONOXIDE ALARM

FLOOR OR DECK DRAIN, SLOPE $\frac{1}{4}":1^{\rm L}\!\!-\!\!0"$ MIN. TO LOCATION SEE DETAILS 02/A-10.1.1 AND 04/A-10.2.1

PROPOSED HOSE BIB LOCATION, INSTALL INTO RECESSED VALVE BOX, BEST ACCESS DOORS MODEL #BA-BTA

NUTONE "QTX" (OR EQUAL) LIGHT/EXHAUST FAN COMBO, MIN 80 CFM, DUCT TO EXTERIOR, INTEGRAL HUMIDISTAT

FLOOR PLAN LEGEND 02

GALLAGHER RESIDENCE 7946 Paseo Del Ocaso La Jolla CA, 92037

CONSTRUCTION DOCS 2019-08-04 PROJECT START

019-09-06 OWNER MEETING 2019-12-05 OWNER REVS. 2020-02-12 OWNER MEETING 2020-02-19 OWNER REVS. 020-05-07 OWNER REVS. 2020-06-19 OWNER REVS. 2020-09-02 CITY SUBMITTAL

2020-11-6 CITY SUBMITTAL


2021-01-18 TO COMM. GRP. AB/JK

PROJECT NO. 19-05

JANUARY 18, 2021

FIRST FLOOR PLAN

PROPOSED FIRST FLOOR PLAN | SCALE: 1/4" = 1'-0' | 04 FLOOR PLAN KEYNOTES 03

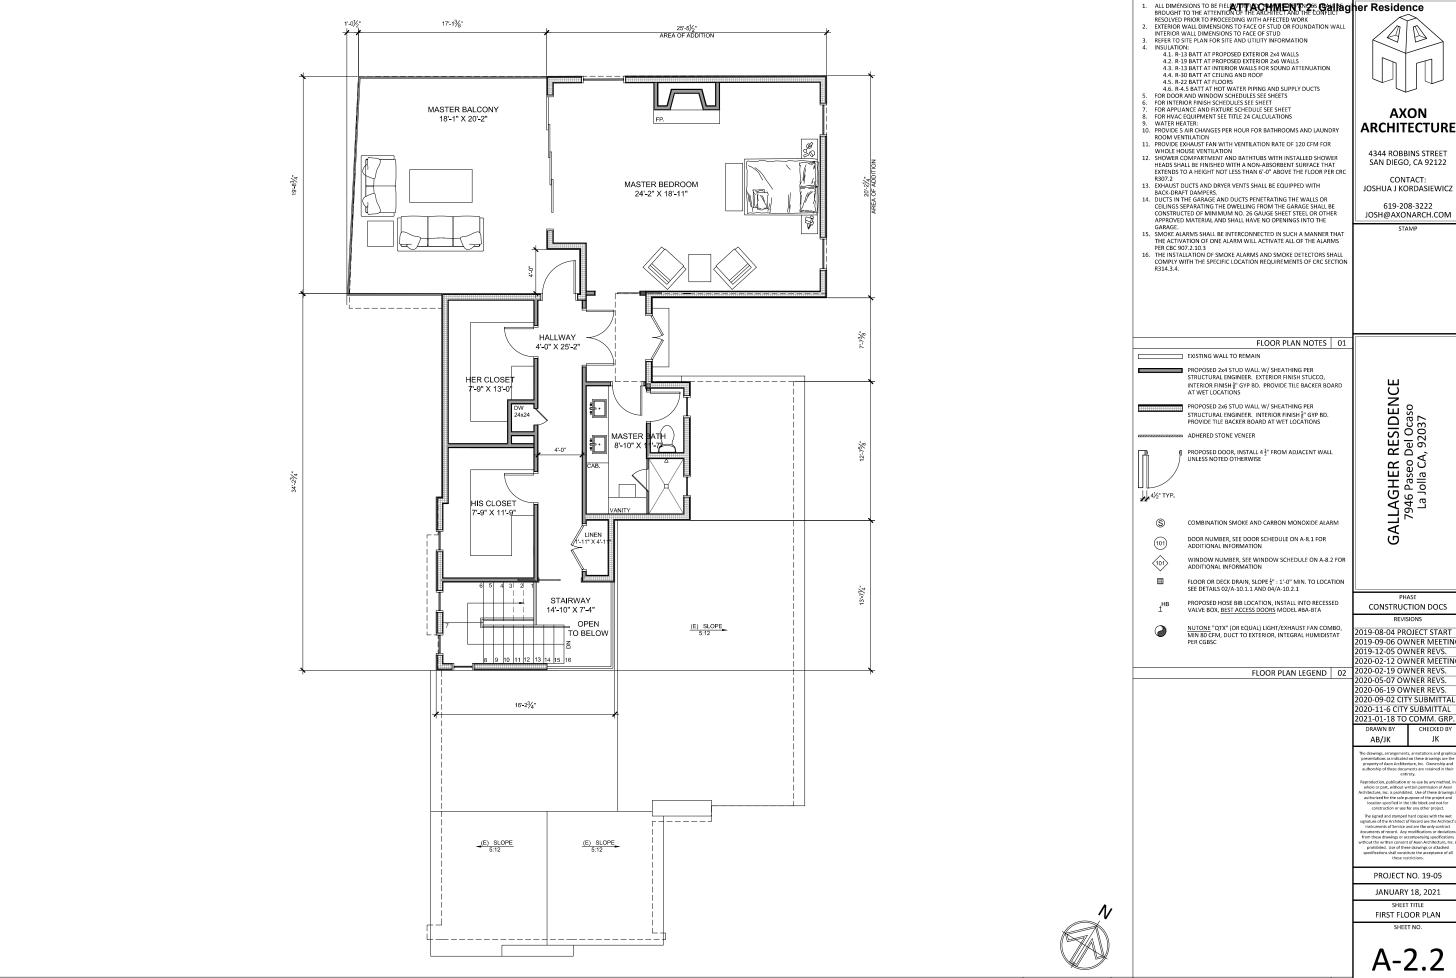

4

AXON ARCHITECTURE

4344 ROBBINS STREET SAN DIEGO, CA 92122

CONTACT: JOSHUA J KORDASIEWICZ

619-208-3222

JOSH@AXONARCH.COM

GALLAGHER RESIDENCE 7946 Paseo Del Ocaso La Jolla CA, 92037

PHASE

CONSTRUCTION DOCS

2019-08-04 PROJECT START

019-09-06 OWNER MEETING 2019-12-05 OWNER REVS. 2020-02-12 OWNER MEETING 2020-02-19 OWNER REVS. 020-05-07 OWNER REVS. 2020-06-19 OWNER REVS.

2020-09-02 CITY SUBMITTAL 2020-11-6 CITY SUBMITTAL


AB/JK

PROJECT NO. 19-05

JANUARY 18, 2021

FIRST FLOOR PLAN

PROPOSED SECOND FLOOR PLAN | SCALE: 1/4" = 1'-0' | 04 FLOOR PLAN KEYNOTES 03

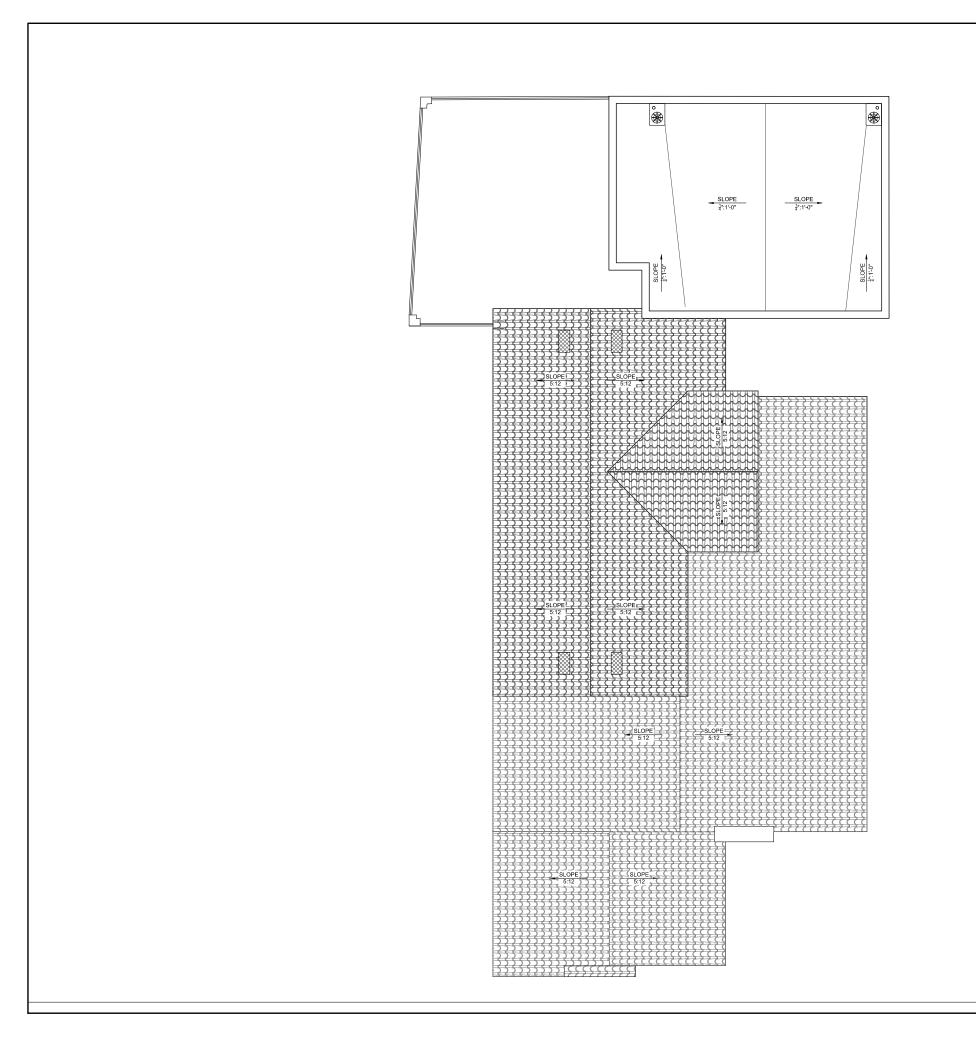

ROOFING UNDERLAYMENT SACTE ALCEMINE NE 20 GATTAGE RESIDENCE SHELD" BY WR GRACE, ESR-1677, OR WINTER GUARD HT BY ALCEMINE OF RESIDENCE SHELD' BY WIN GRACE, ESK-1677, OR "WINNER GOARD HI" BY CERTAINTEED CORP, ESK-1492. INSTALL PER MANUFACTURER'S INSTRUCTIONS. INSTALL A #40 FIBERGLASS REINFORCED FELT SHEET OVER ROOF MEMBRANE. ALSO SEE NOTE #12. COUNTER-SLOPES, ½? PER 1-20 (MINIMUM) TOWARDS DRAINS CREATED USING G-26 (LATEX - CEMENT) E-LOORING UNDERLAYMENT

BY CROSSFIELD PRODUCTS CORP.
ROOF DRIP EDGE, METAL FLASHING, PANEL CLIPS AND COUNTER

ROOP DRIP EDGE, ME LAL FLASHING, PANEL CLIPS AND COUNTER FLASHING, TO BE 16 OZ COPPER UNLESS OTHERWISE NOTED, SOLDER OR SEAL ALL SEAMS, HEM ALL SEAMS, HE AL

SURFACE WATERPROOFINS: MEMBRANE WATERPROOFINS SHALL BE JIFFY SEAL 140/00 BY PROTECTO WRAP, ESR-1127. EXTEND MEMBRANE A MINIMUM OF BELOW EDG OF PARAPET, EACH SIDE. PROVIDE A MINIMUM END LAP OF 4" OVER ADJOINING MEMBRANE SHEETS. WHERE MEMBRANE ABUT'S VERTICAL SURFACES, THE MEMBRANE SHALL EXTEND 5" UP SURFACE, AND BE OVERLAPPED BY BUILDING WRAP.

ROOF GUTTERS SHALL BE PROVIDED WITH THE MEANS TO PREVENT THE ACCUMULATION OF LEAVES AND DEBRIS IN THE GUTTER. ALL ROOF GUTTERS AND DOWNSPOUTS SHALL BE CONSTRUCTED OF NON-COMBUSTIBLE MATERIALS.

DRIP EDGE FLASHING USED AT THE FREE EDGES OF ROOFING MATERIALS SHALL BE NOT LESS THAN 0.019 (#26 GALVANIZED SHEET GAUGE) CORROSON-RESISTANT METAL INSTALLED OVER A MIN. 36"-WIDE UNDERLAYMENT CONSISTING OF ONE LAYER OF NO. C) AS SHALL BE NOT LESS THAN 10.019 (#26 GALVANIZED SHEET GAUGE) CORROSON-RESISTANT METAL INSTALLED OVER A MIN. 36"-WIDE UNDERLAYMENT CONSISTING OF ONE LAYER OF NO. 72 AS STANCES SHANING FOR MIN. 36"-WIDE UNDERLAYMENT CONSISTING OF ONE LAYER OF NO. 72 AS STANCES SHANING AND SHAPE FUNNING THE FULL LENGTH

ONE LAYER OF NO. 72 ASTM CAP SHEET RUNNING THE FULL LENGTH OF THE VALLEY. ENCLOSED RAFTER ASSEMBLIES NOT REQUIRED TO BE VENTED

ENCLOSED NAT IEAR ASSEMBLES NOT REQUIRED TO BE VENTED PER CRC RR06.5.

THE ENTIRE ROOF SHALL BE COVERED WITH A FIRE-RETARDANT ROOF COVERING THAT IS AT LEAST CLASS 'A WHEN THE AREA OF THE ADDITION TO THE EXISTING BUILDING IS MORE THAN TWENTY-FIVE PERCENT (25%) OF THE ORIGINAL FLOOR AREA OF THE BUILDING ISDMC 149.0902(A)(2)].

ASPHALT SHINGLES TO BE OWENS CORNING 'DURATION', COLOR TO BE SANDSTONE. SHINGLES ARE CLASS 'A' PER UL REPORT ER-2.45°2.11

ER-245-9.1 FOR ROOF SLOPES FROM TWO UNITS VERTICAL IN 12 UNITS HORIZONTAL (2-12), UP TO FOUR UNITS VERTICAL IN 12 UNITS HORIZONTAL (4-12), UNDEDLAYMENT SHALL BE TWO LAYERS APPLIED IN THE FOLLOWING MANNER WARNEY FROM THE STATE OF THE PROPERTY OF THE PROPE BE TWO LAYERS APPLIED IN THE FOLLOWING MANDER: APPLY A 19NCH STRP OF UNDERLAYMENT FELT PARALLEL TO AND STARTING AT THE EAVES. STARTING AT THE EAVE. STARTING AT THE EAVE. APPLY 36-NCH-WIDS SHEETS OF UNDERLAYMENT, OVERLAPPING SUCCESSIVE SHEETS 19 INCHES. DISTORTIONS IN THE UNDERLAYMENT SHALL NOT INTERFERE WITH THE ABILITY OF THE SHINGLES TO SEAL. 4

AXON ARCHITECTURE

4344 ROBBINS STREET SAN DIEGO, CA 92122

CONTACT:

JOSHUA J KORDASIEWICZ

619-208-3222 JOSH@AXONARCH.COM

FLOOR PLAN NOTES 01

DIRECTION OF ROOF SLOPE FOR DRAINAGE



ROOF DRAIN PER ROOF NOTES

DECK DRAIN, SLOPE TOWARD 2% MIN.

GALLAGHER RESIDENCE 7946 Paseo Del Ocaso La Jolla CA, 92037

PHASE

CONSTRUCTION DOCS

REVISIONS 2019-08-04 PROJECT START 2019-09-06 OWNER MEETING 2019-12-05 OWNER REVS.

FLOOR PLAN LEGEND 02

2020-02-12 OWNER MEETING 2020-02-19 OWNER REVS. 020-05-07 OWNER REVS. 2020-06-19 OWNER REVS. 2020-09-02 CITY SUBMITTAL 2020-11-6 CITY SUBMITTAL 2021-01-18 TO COMM. GRP.

AB/JK

JK

PROJECT NO. 19-05

JANUARY 18, 2021

ROOF PLAN SHEET NO.

PROPOSED ROOF PLAN SCALE: 1/4" = 1'-0' 04

ROOF PLAN KEYNOTES 03

