La Jolla Shores Planned District Advisory Board La Jolla Recreation Center 615 Prospect Street, La Jolla CA 92037

Please provide the following information on this form for calendaring your project on an upcoming La Jolla Shores Planned District Advisory Board meeting.

For Information Items

- Project name (Unsubmitted projects can be informational items if the development team is seeking comments and direction from the Trustees on the concept):
- Address and APN(s):
- Project contact name, phone, e-mail:
- Project description:
- In addition to the project description, please provide the following:

 - existing structure square footage and FAR (if applicable): _____
 - proposed square footage and FAR:
 - existing and proposed setbacks on all sides: _____
 - height if greater than 1-story (above ground):
- Project aspect(s) that the applicant team is seeking Trustee direction on. (community character, aesthetics, design features, etc.):

For Action Items

- Project PTS number from Development Services and project name (only submitted projects can be heard as action items): **623331**
- Address and APN(s): 8204 Prestwick Drive APN # 346-333-02-00
- Project contact name, phone, e-mail: Matin Taraz / 858-775-0505 / mtaraz@san.rr.com

Project description: Remodeling of and addition to an existing one-story single family residence with an attached garage. The project adds a single car garage and a bedroom while rearranging some of the existing spaces and includes a new roof.

- _
- In addition, provide the following:
 - lot size: 0.49 acres _____
 - existing structure square footage and FAR (if applicable): **3,768 SF / 0.18 FAR**
 - proposed square footage and FAR: 4,458 SF / 0.21 FAR _____
 - existing and proposed setbacks on all sides:
 - EXIST.= 14.5'F/124'R/9'R/10'L PROP.=14.5'F/124'R/9'R/8'L
 - height if greater than 1-story (above ground): One Story 17'-2"

Exhibits and other materials to provide:

Please provide the following which will be attached to the agenda and posted to the City's website for view by the public:

- Exhibits (e.g. site plan, elevations, exhibits showing addition/remodel areas, etc.)
- Any surveys that indicate similarities in floor area or architectural style in the surrounding neighborhood
- Any communications from adjacent neighbors, local neighborhood groups, and/or the Homeowners' Association

(CONTINUED ON THE NEXT PAGE)

PLEASE DO NOT PROVIDE THE FOLLOWING:

- The complete plan set of the project. Complete plan sets take up a lot of memory to distribute and most of the information is not necessary for the Advisory Board's review.
- Plans or exhibits of the interior of the project. Interiors are not reviewed by the Advisory Board.
- Personal contact information of the property owners of the project should not be included, unless they are the "owner/applicant" and they are the designated point of contact

The Trustees are very keen to know that the neighbors in the immediate vicinity have been noticed and their views noted. Community conformity, setbacks, FAR, parking, view corridors, bulk & scale, and articulation are key discussion points on all projects.

Thank you,

Marlon I. Pangilinan Senior Planner Planning Department 9485 Aero Drive MS 413 San Diego CA 92123 619-235-5293 www.sandiego.gov/planning

ARCHITECTURAL COMMITTEE

Prestwick Estates Unit Number 1 8422 Prestwick Drive La Jolla, California 92037 (858) 551-1651

July 10, 2018

Mr. and Mrs. Castagnola 8204 Prestwick Drive La Jolla, CA 92037

Dear Mr. and Mrs. Castagnola,

We have reviewed your submitted architectural plans. We are able to approve these

plans as proposed.

Best wishes, Joseph B. Patterson

Mr. and Mrs. Louis Castagnola, Jr. 8204 Prestwick Drive La Jolla, California 92037 Telephone 858 246-7399 Facsimile 858 246-7366 Email: lcastagnola@att.net

November 29, 2018

Mr. Joseph B Patterson Architectural Committee Prestwick Estates 16740 Monte Hermoso Drive Pacific Palisades, CA 90272

RE: Architectural Plans 8204 Prestwick Dr. La Jolla, CA 92037

Dear Mr. Patterson:

This letter is to confirm our telephone conversation regarding the height of the project for the above referenced address. You stated that the Prestwick Estates Architectural Committee did not have a problem if the height of the roof as submitted in the architectural plans approved on July 10, 2018 was raised by 8 to 12 inches.

Sincerely yours,


Louis Castagnola, Jr.


Acknowledged and Agreed


Patterson

Dated:

ORIGINAL SUBMITTAL

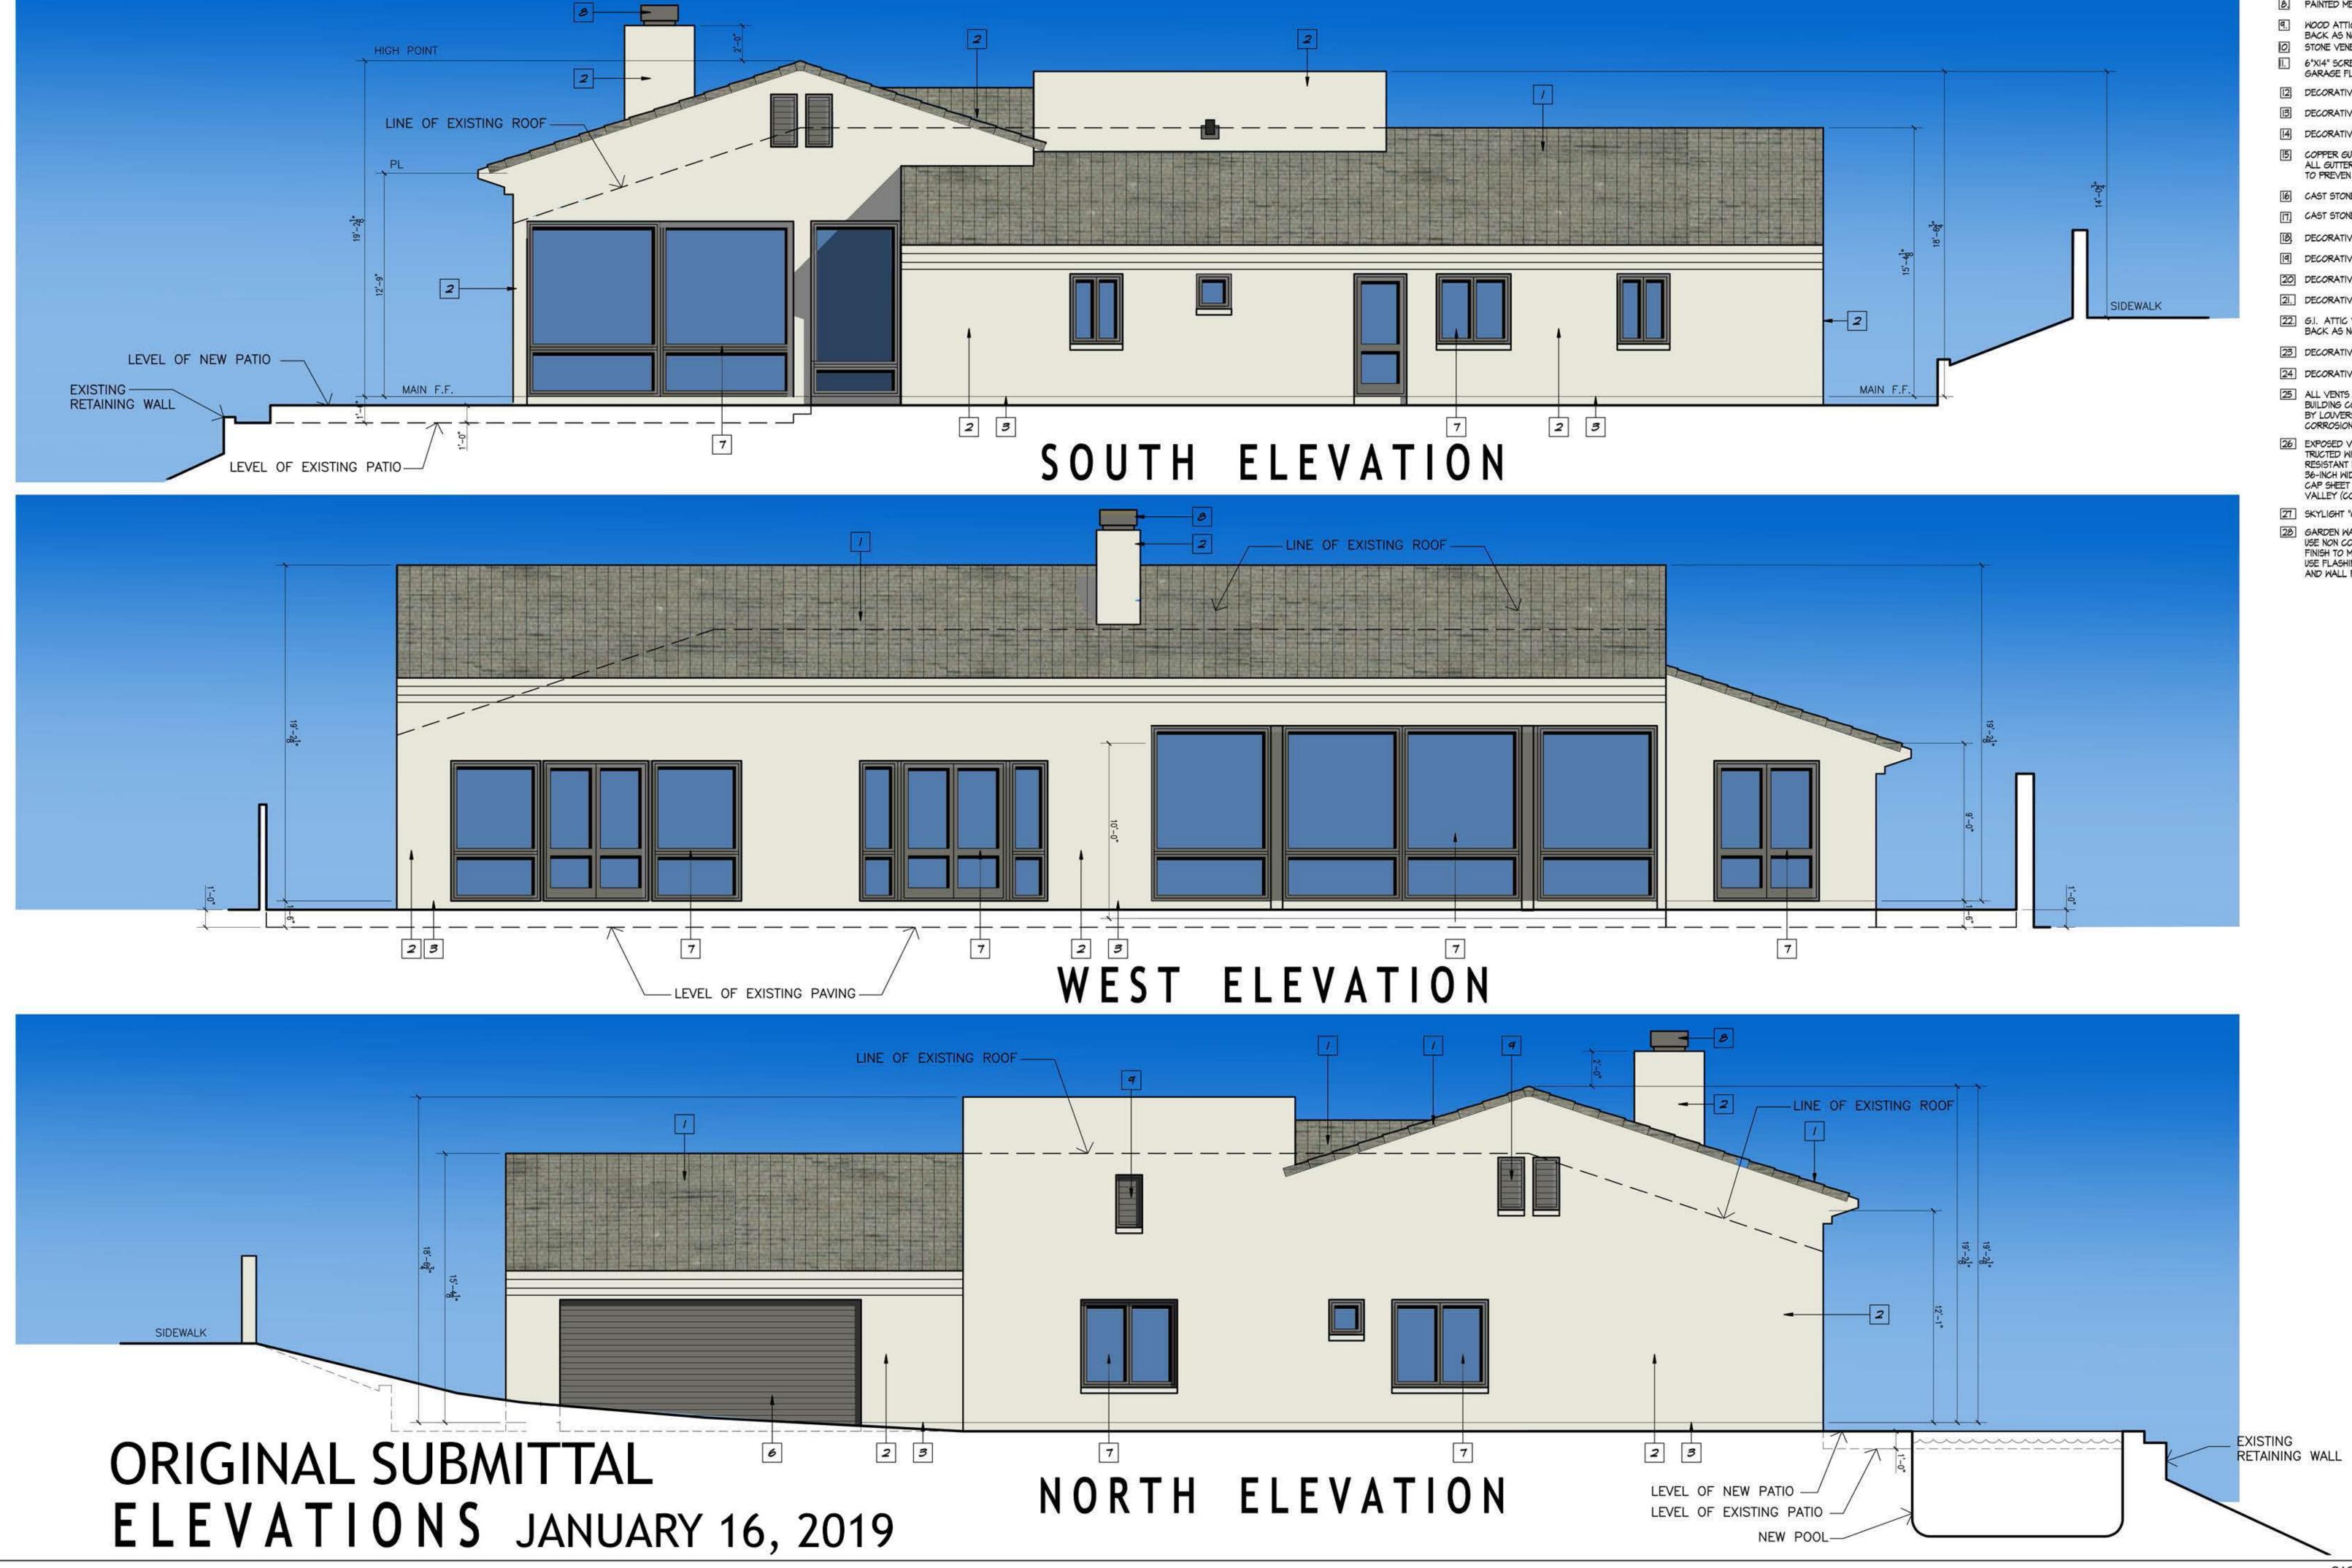

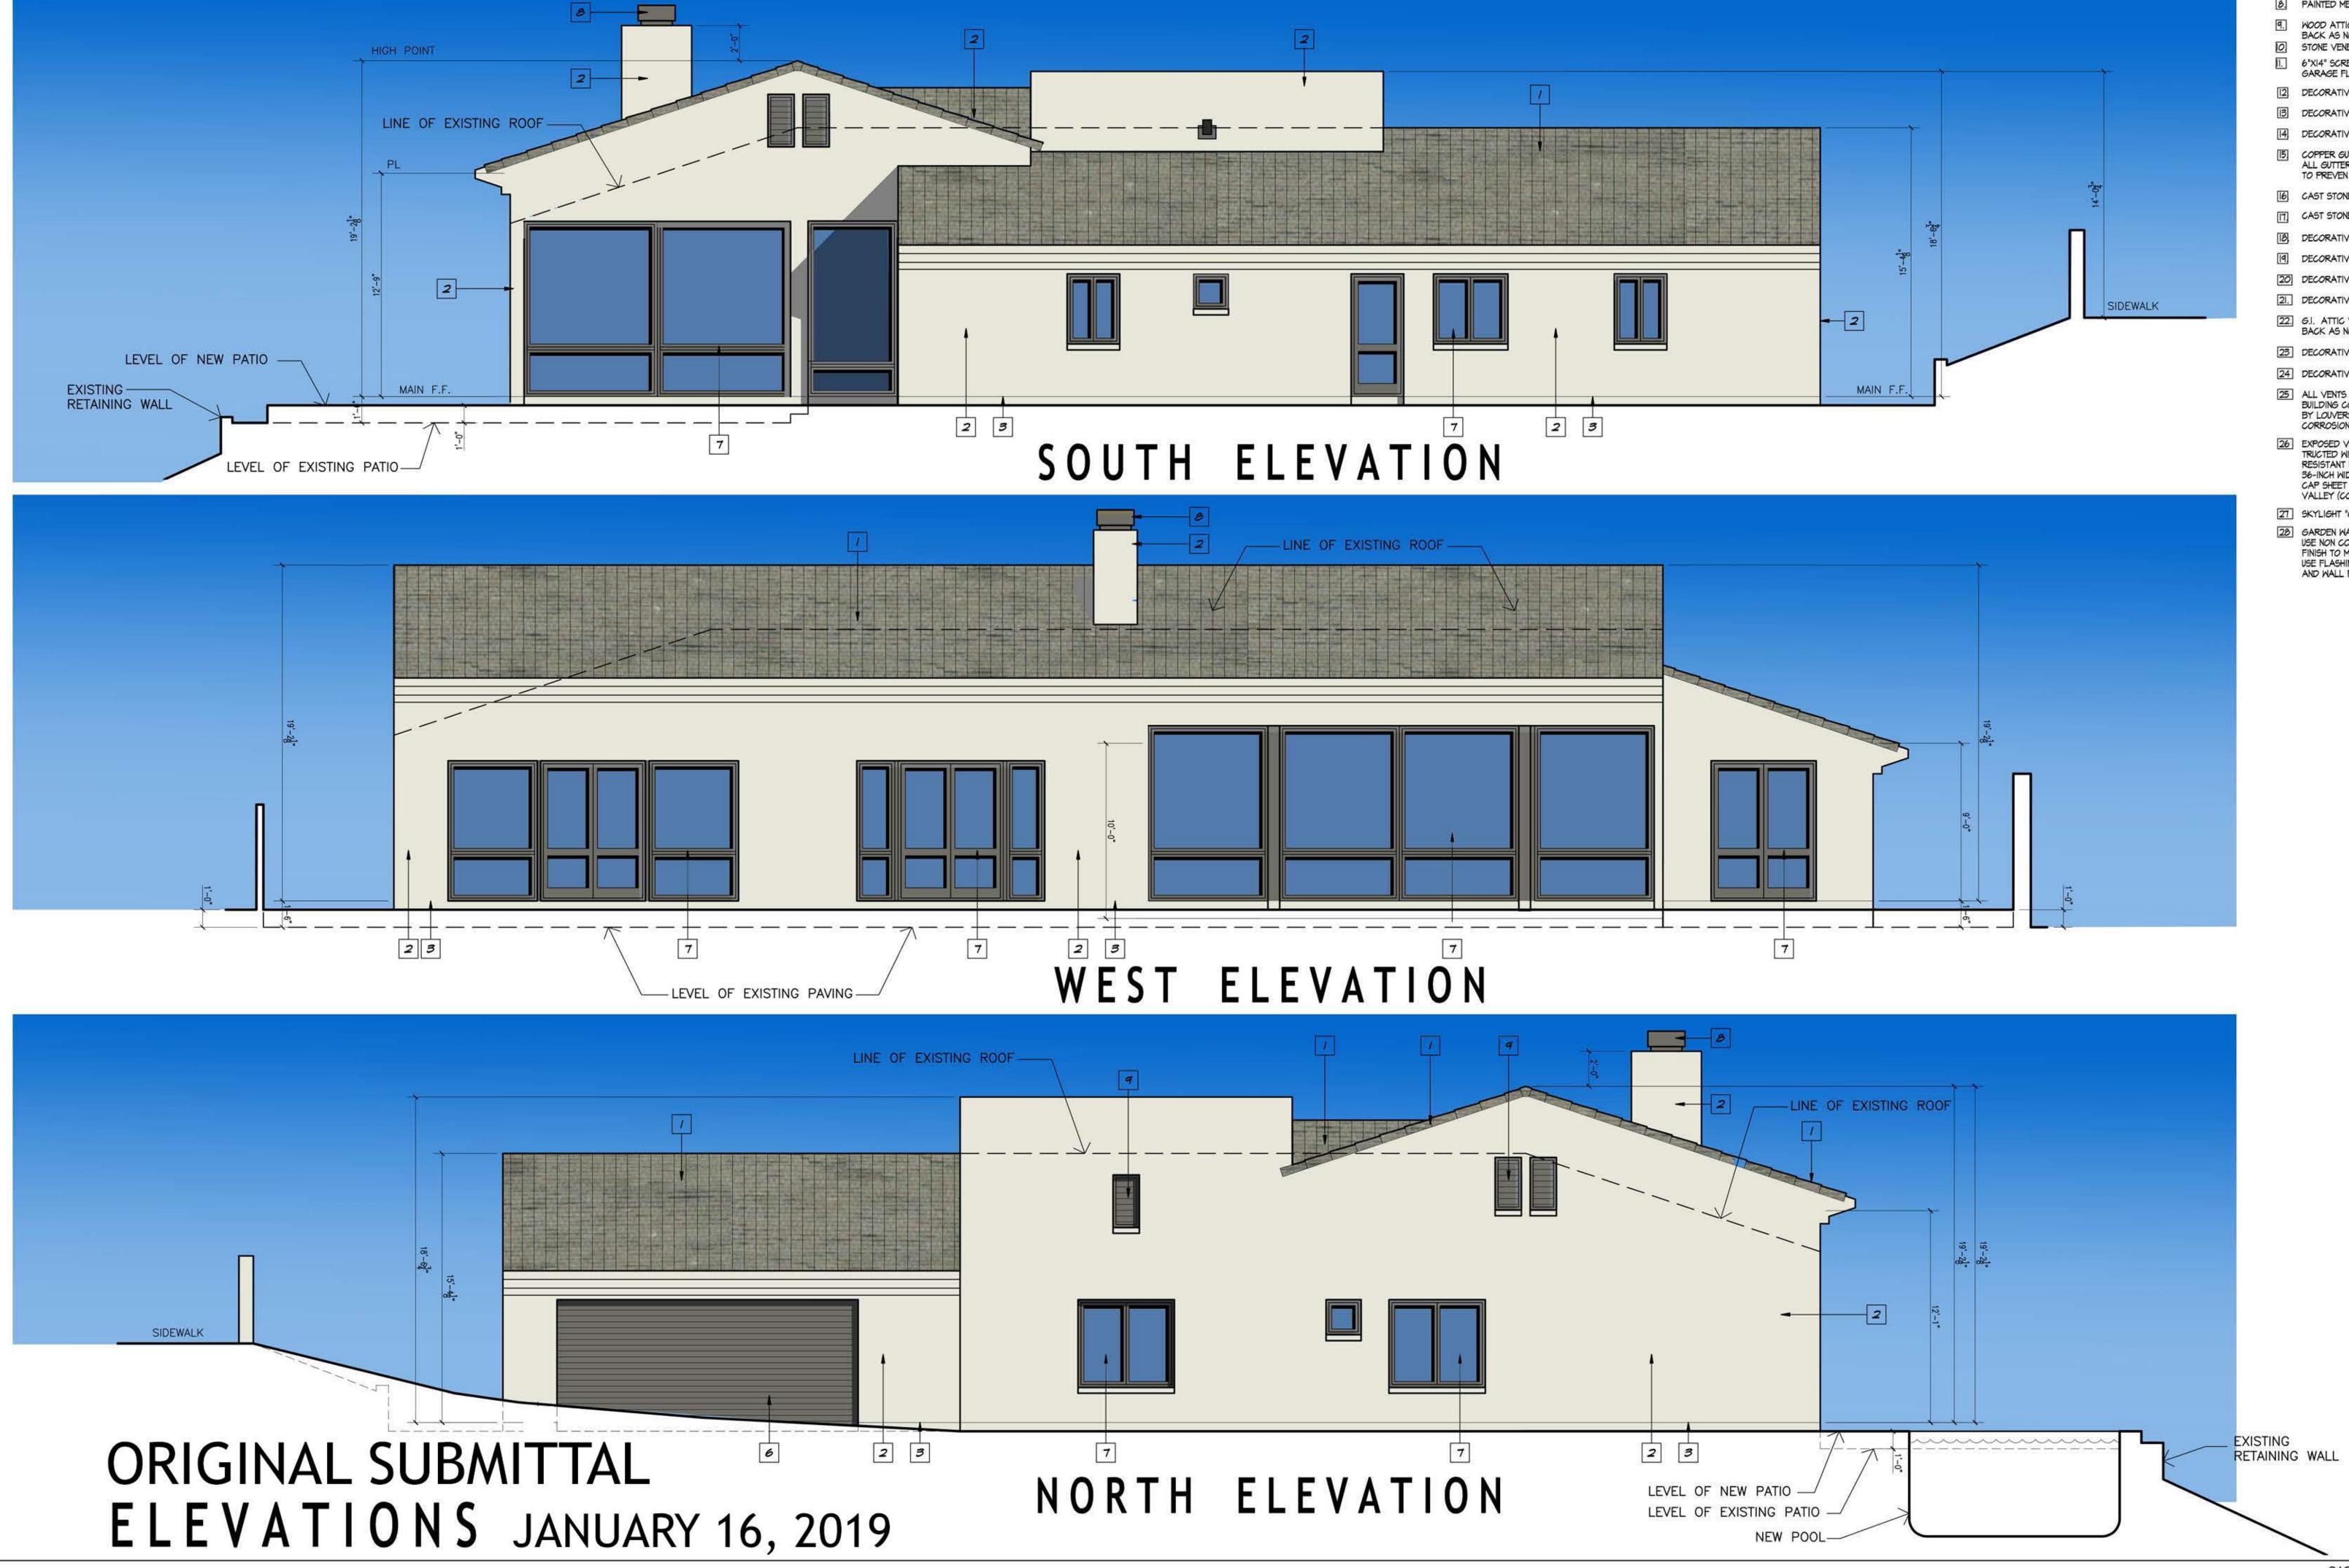


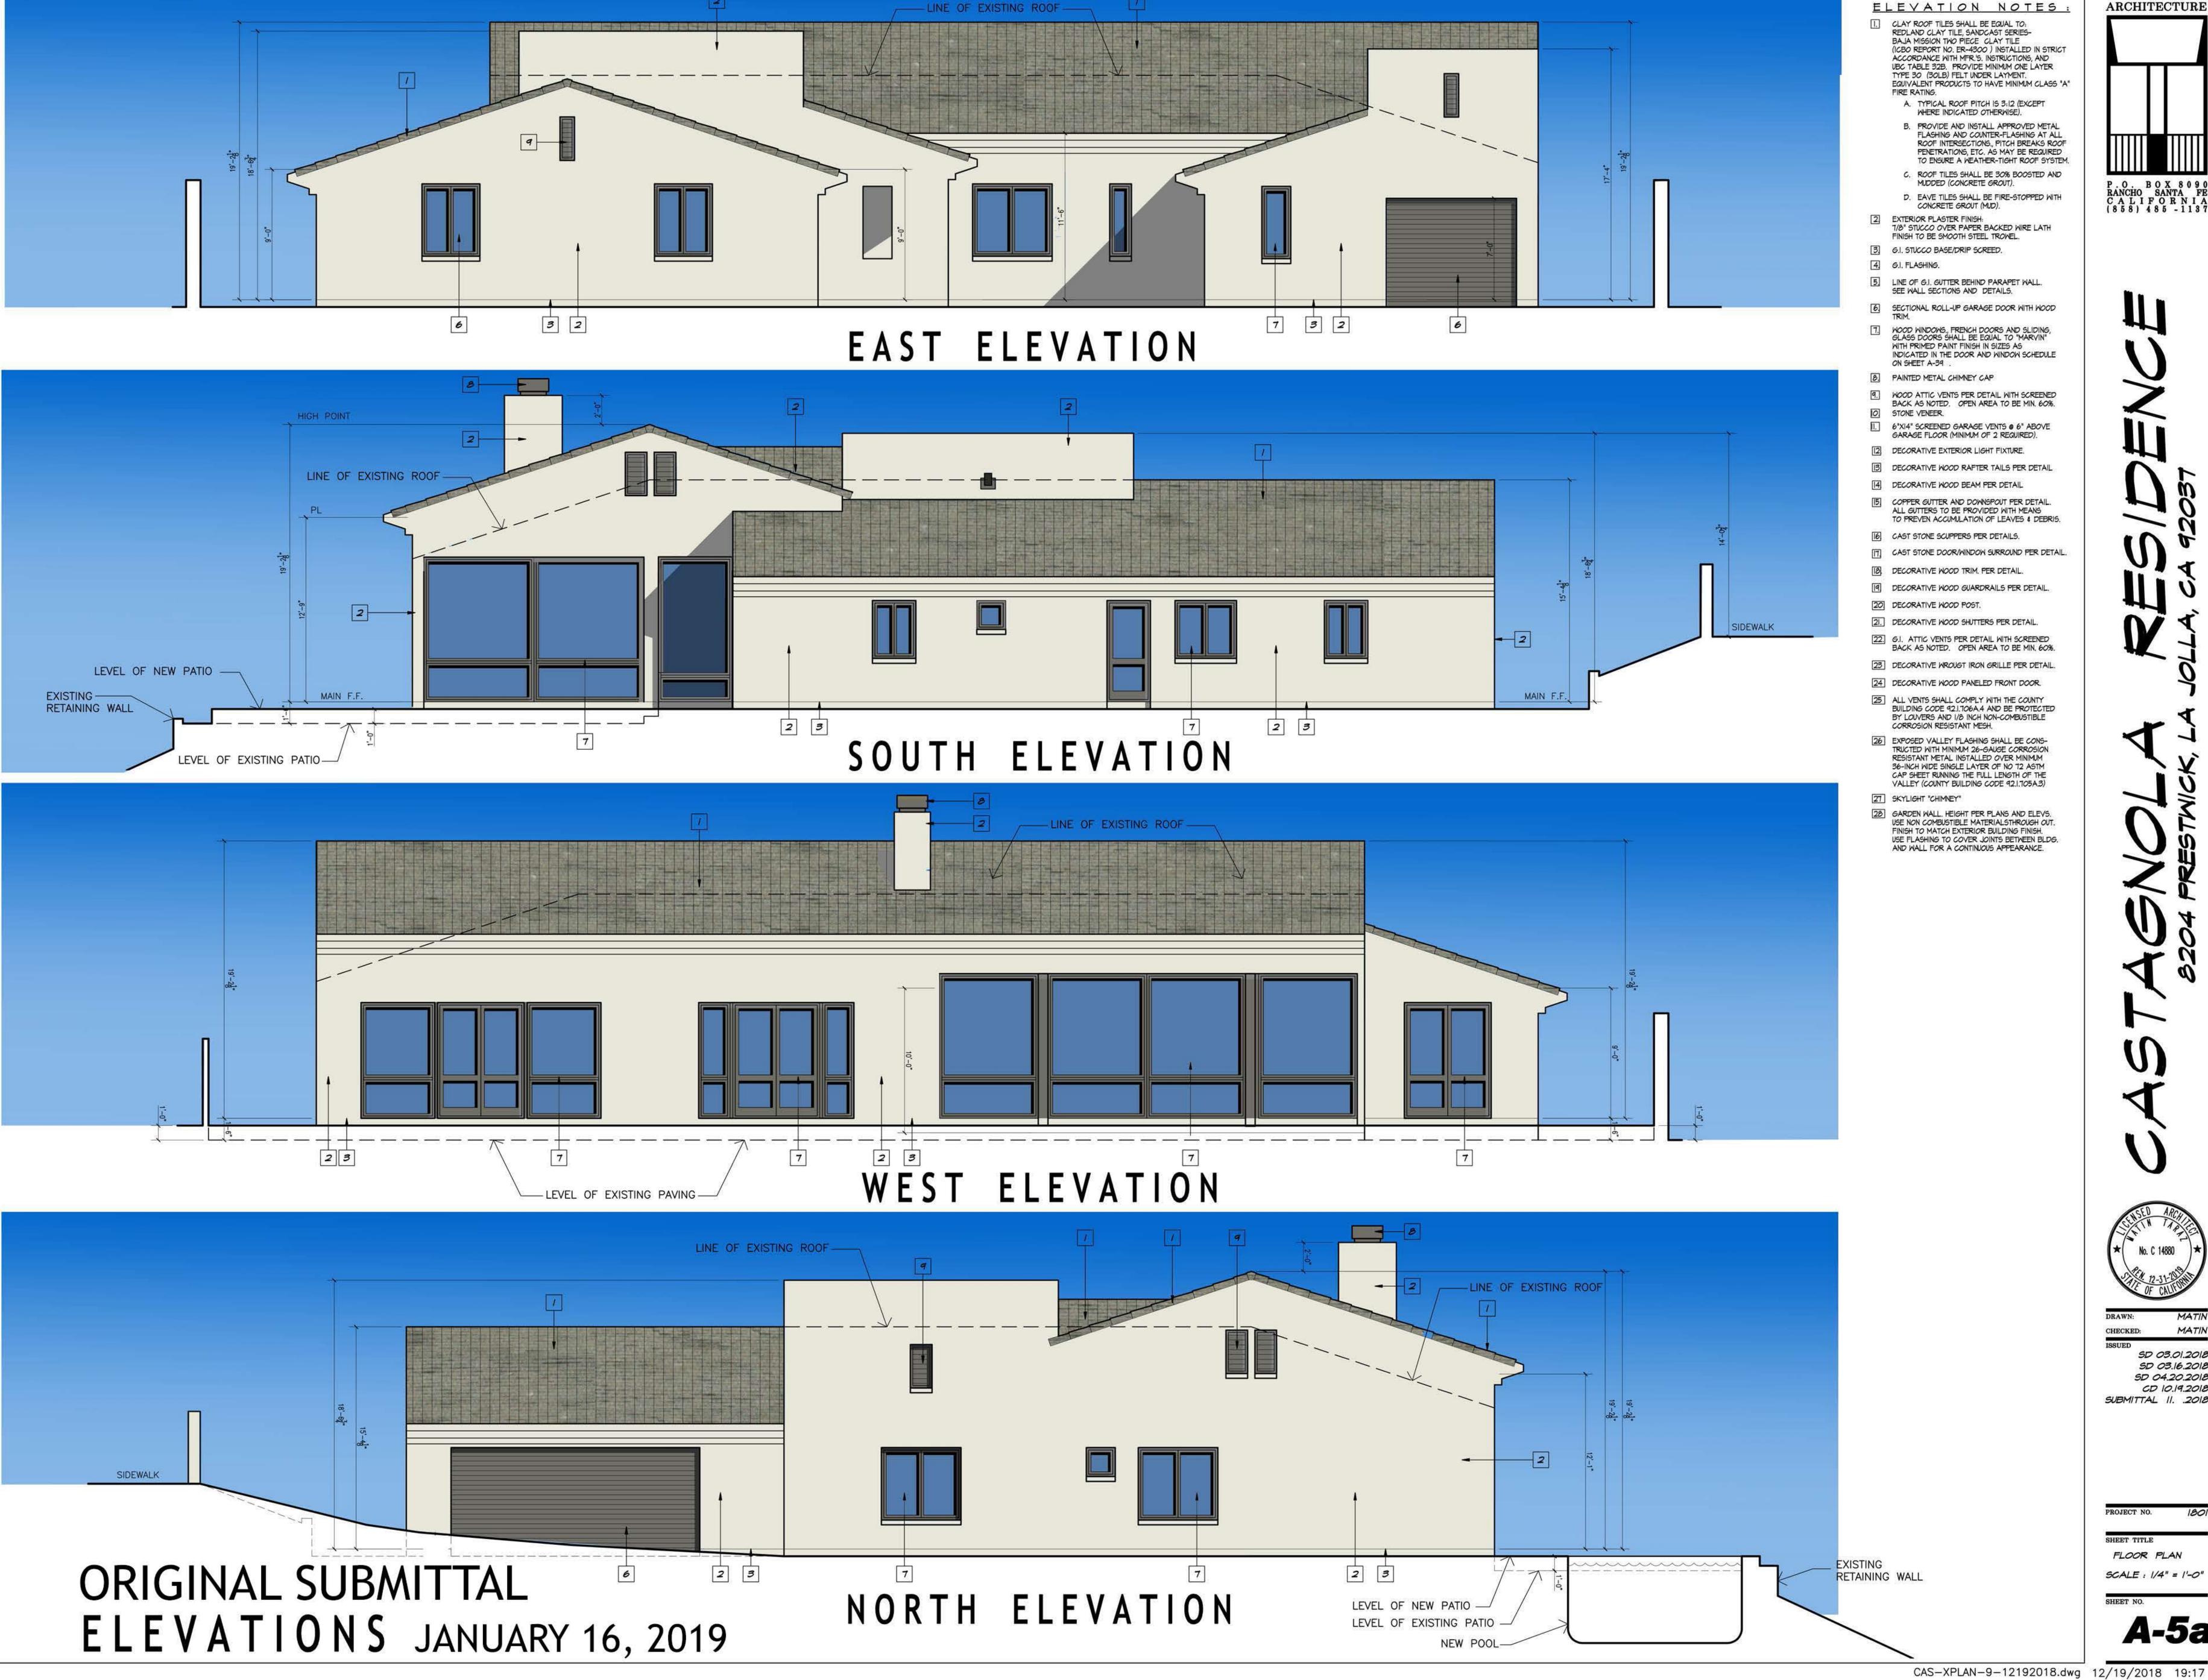



(ICBO REPORT NO. ER-4300) INSTALLED IN STRICT EQUIVALENT PRODUCTS TO HAVE MINIMUM CLASS "A" B. PROVIDE AND INSTALL APPROVED METAL FLASHING AND COUNTER-FLASHING AT ALL ROOF INTERSECTIONS., PITCH BREAKS ROOF PENETRATIONS, ETC. AS MAY BE REQUIRED

TO ENSURE A WEATHER-TIGHT ROOF SYSTEM C. ROOF TILES SHALL BE 30% BOOSTED AND D. EAVE TILES SHALL BE FIRE-STOPPED WITH

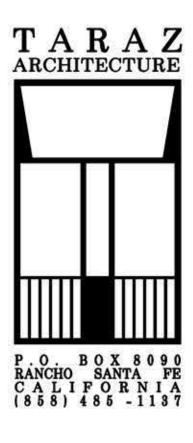



No. C 14880 DRAWN: CHECKED: MATIN ISSUED SD 03.01.2018 SD 03.16.2018 SD 04.20.2018 CD 10.19.2018 SUBMITTAL II. .2018 PROJECT NO FLOOR PLAN SCALE : 1/4" = 1'-0 SHEET NO. A-5a

STORM WATER BEST MANAGEMENT PRACTICES

THIS PROJECT SHALL COMPLY WITH ALL REQUIREMENTS OF THE STATE PERMIT; CALIFORNIA REGIONAL WATER QUALITY CONTROL BOARD, SAN DIEGO, ORDER NO. R8-2007-001, NPDES, THE CITY OF SAN DIEGO LAND DEVELOPMENT CODE, AND STORM WATER STANDARDS MANUAL.

- 1. THE CONTRACTOR SHALL BE RESPONSIBLE FOR CLEANUP OF ALL SILT AND MUD ON ADJACENT STREETS DUE TO CONSTRUCTION VEHICLES OR ANY OTHER CONSTRUCTION ACTIVITY AT THE END OF EACH WORK DAY OR AFTER A STORM EVENT THAT CAUSES A BREECH IN INSTALLED CONSTRUCTION BMPS WHICH MAY COMPROMISE STORM WATER QUALITY WITHIN ANY STREET.
- 2. ALL STOCKPILES OF SOILS AND/OR BUILDING MATERIALS THAT ARE INTENDED TO BE LEFT FOR A PERIOD GREATER THAN SEVEN CALENDAR DAYS ARE TO BE COVERED. ALL REMOVABLE BMP DEVICES SHALL BE IN PLACE AT THE END OF EACH WORKING DAY WHEN FIVE DAY RAIN PROBABILITY FORECAST EXCEEDS 40%.
- 3. A CONCRETE WASHOUT SHALL BE PROVIDED ON ALL PROJECTS WHICH PROPOSE THE CONSTRUCTION OF AN CONCRETE IMPROVEMENTS WHICH ARE TO BE POURED IN PLACE ON SITE.
- 4. THE CONTRACTOR SHALL RESTORE ALL EROSION/CNTRO; DEVICES TO WORKING ORDER AFTER EACH RUN-OFF-PRODUCING RAINFALL OR AFTER ANY MATERIAL BREECH IN EFFECTIVENESS.
- 5. ALL SLOPES THAT WERE TREATED OR DISTURBED BY CONSTRUCTION ACTIVITY MUST BE PROTECTED AGAINST EROSION AND SEDIMENT TRANSPORT AT ALL TIMES.
- 6. THE STORAGE OF ALL CONSTRUCTION MATERIALS AND EQUIPMENT MUST BE PROTECTED AGAINST ANY POTENTIAL RELEASE OF POLLUTANTS INTO THE ENVIRONMENT.

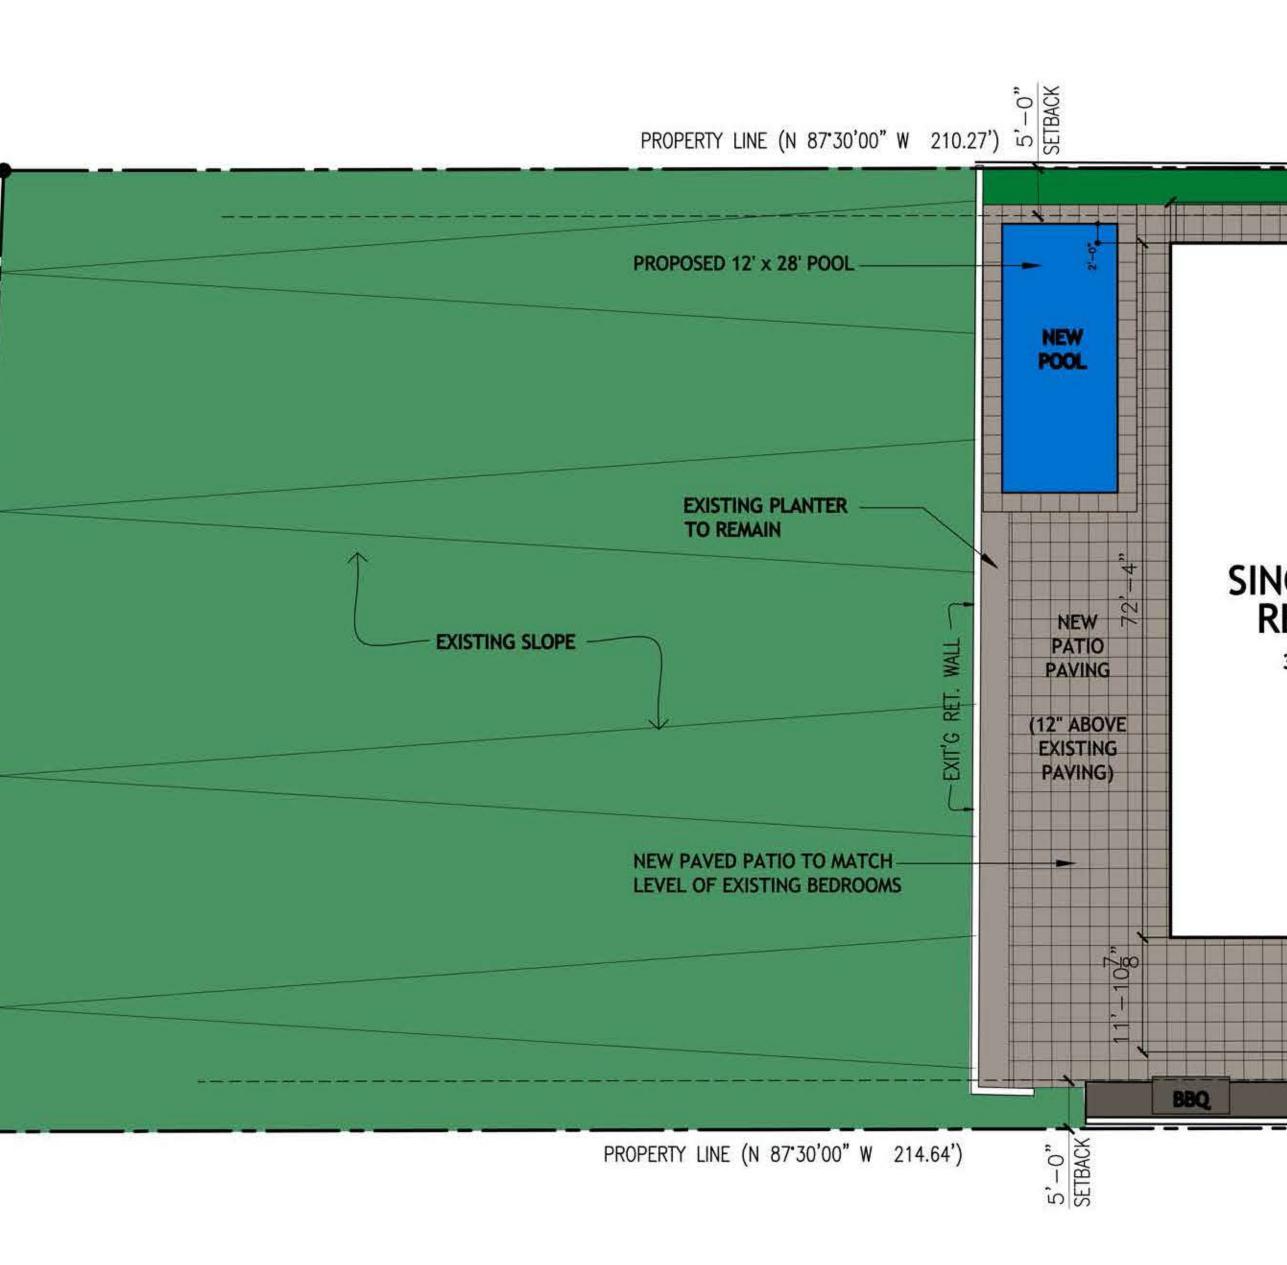

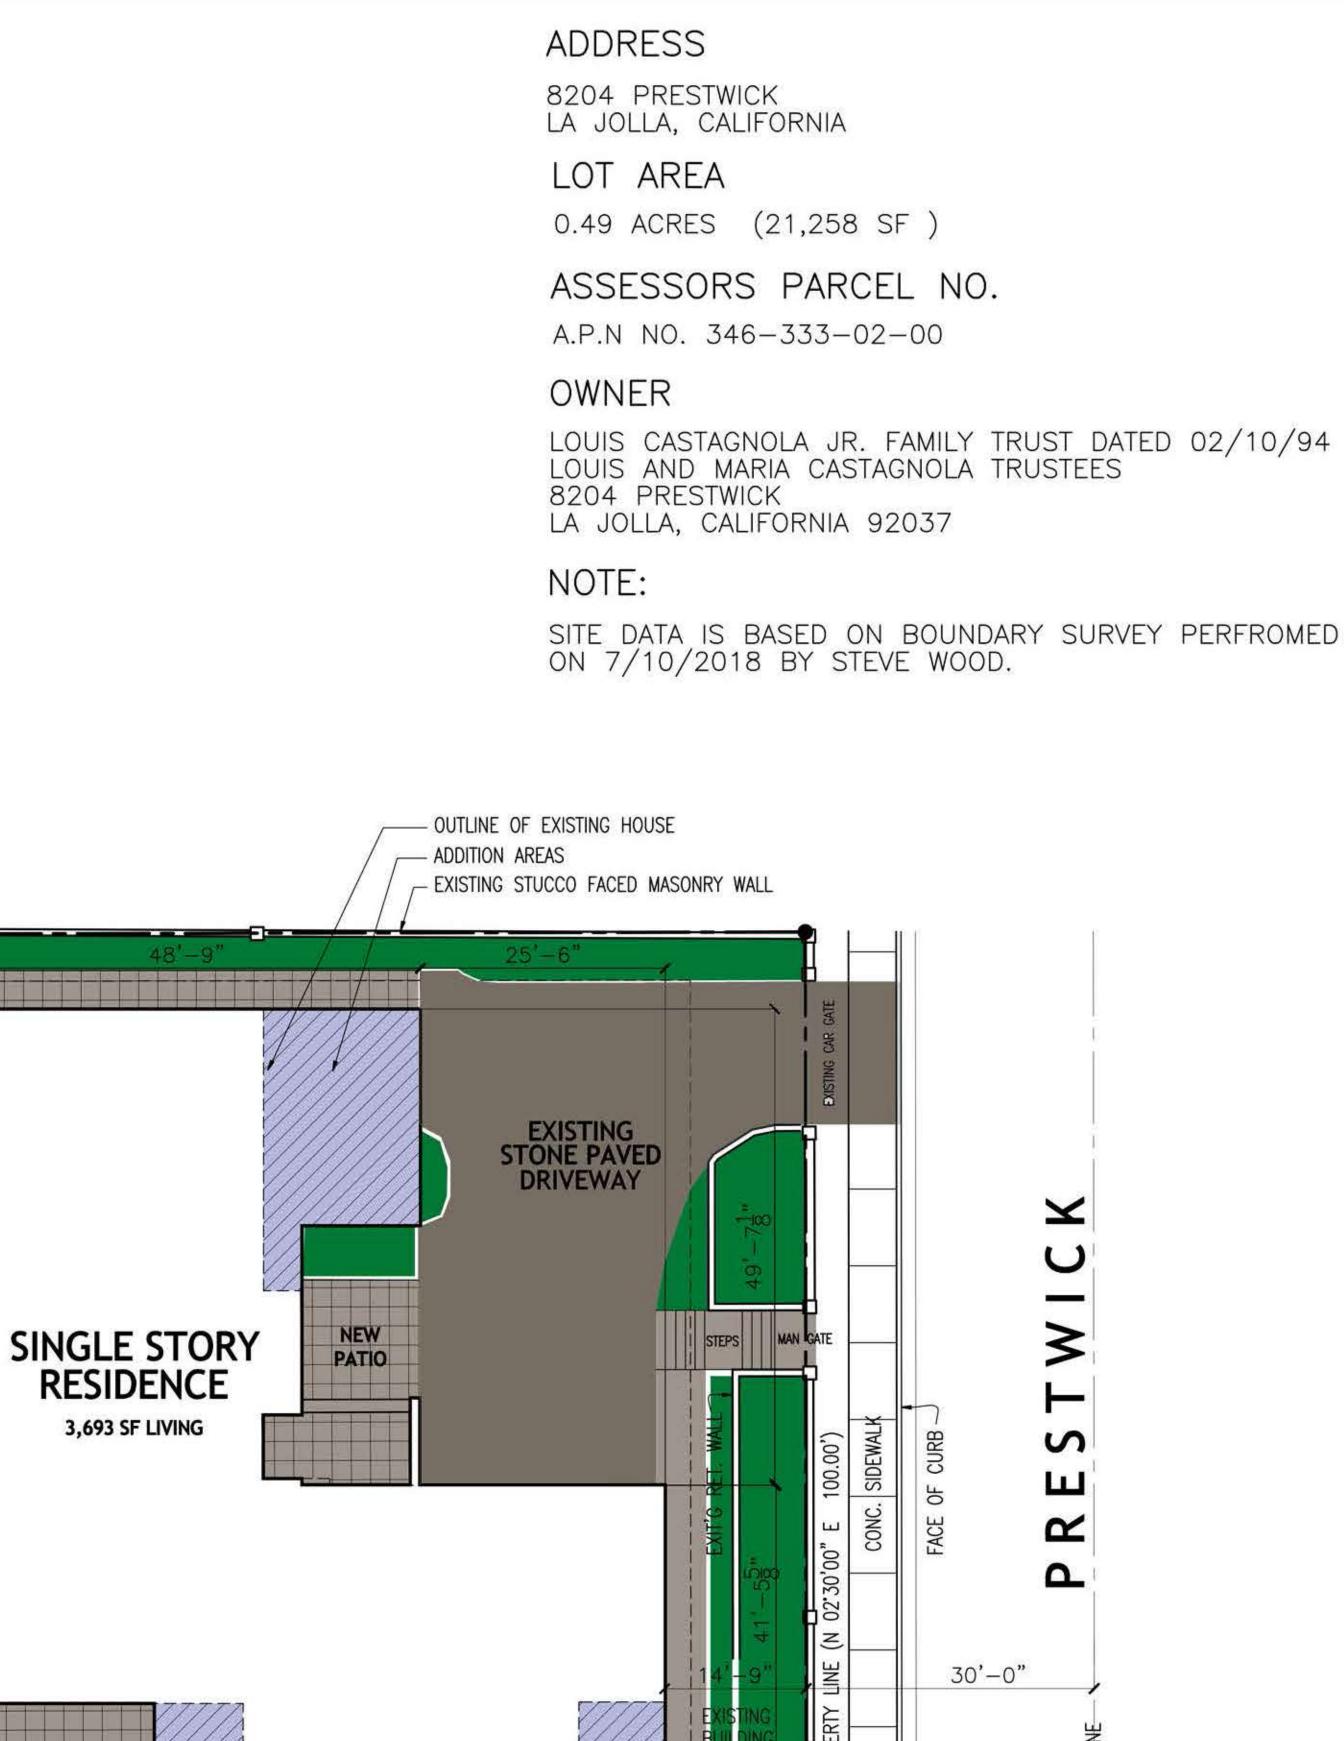

SITE PLAN TABULATIONS : FLOOR AREA SUMMARY

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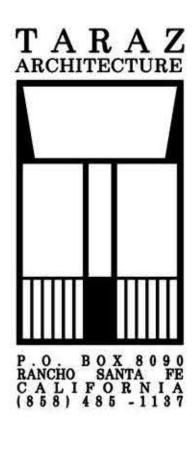
PLAN NORTH	SIT	E	PLA
TOTALS	3,768 SF	690 SF	4,458 SF
GARAGE: ATTACHED	480 SF	285 SF	765 SF
MAIN HOUSE LIVING AREA	3,288 SF	405 SF	3,693 SF
	EXISTING TO REMAIN	PROPOSED ADDED NEW	TOTAL

- ADDITION AREAS

- OUTLINE OF EXISTING HOUSE

OUTILNE OF PROPOSED ADDITION

EXISTING STUCCO FACED MASONRY WALL




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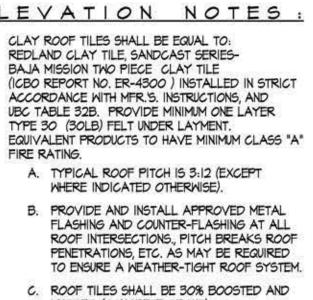
PLAN

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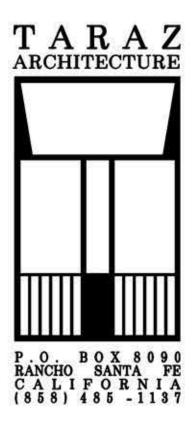
SHEET NO. A-0

SCALE : 1"= 10'-0"



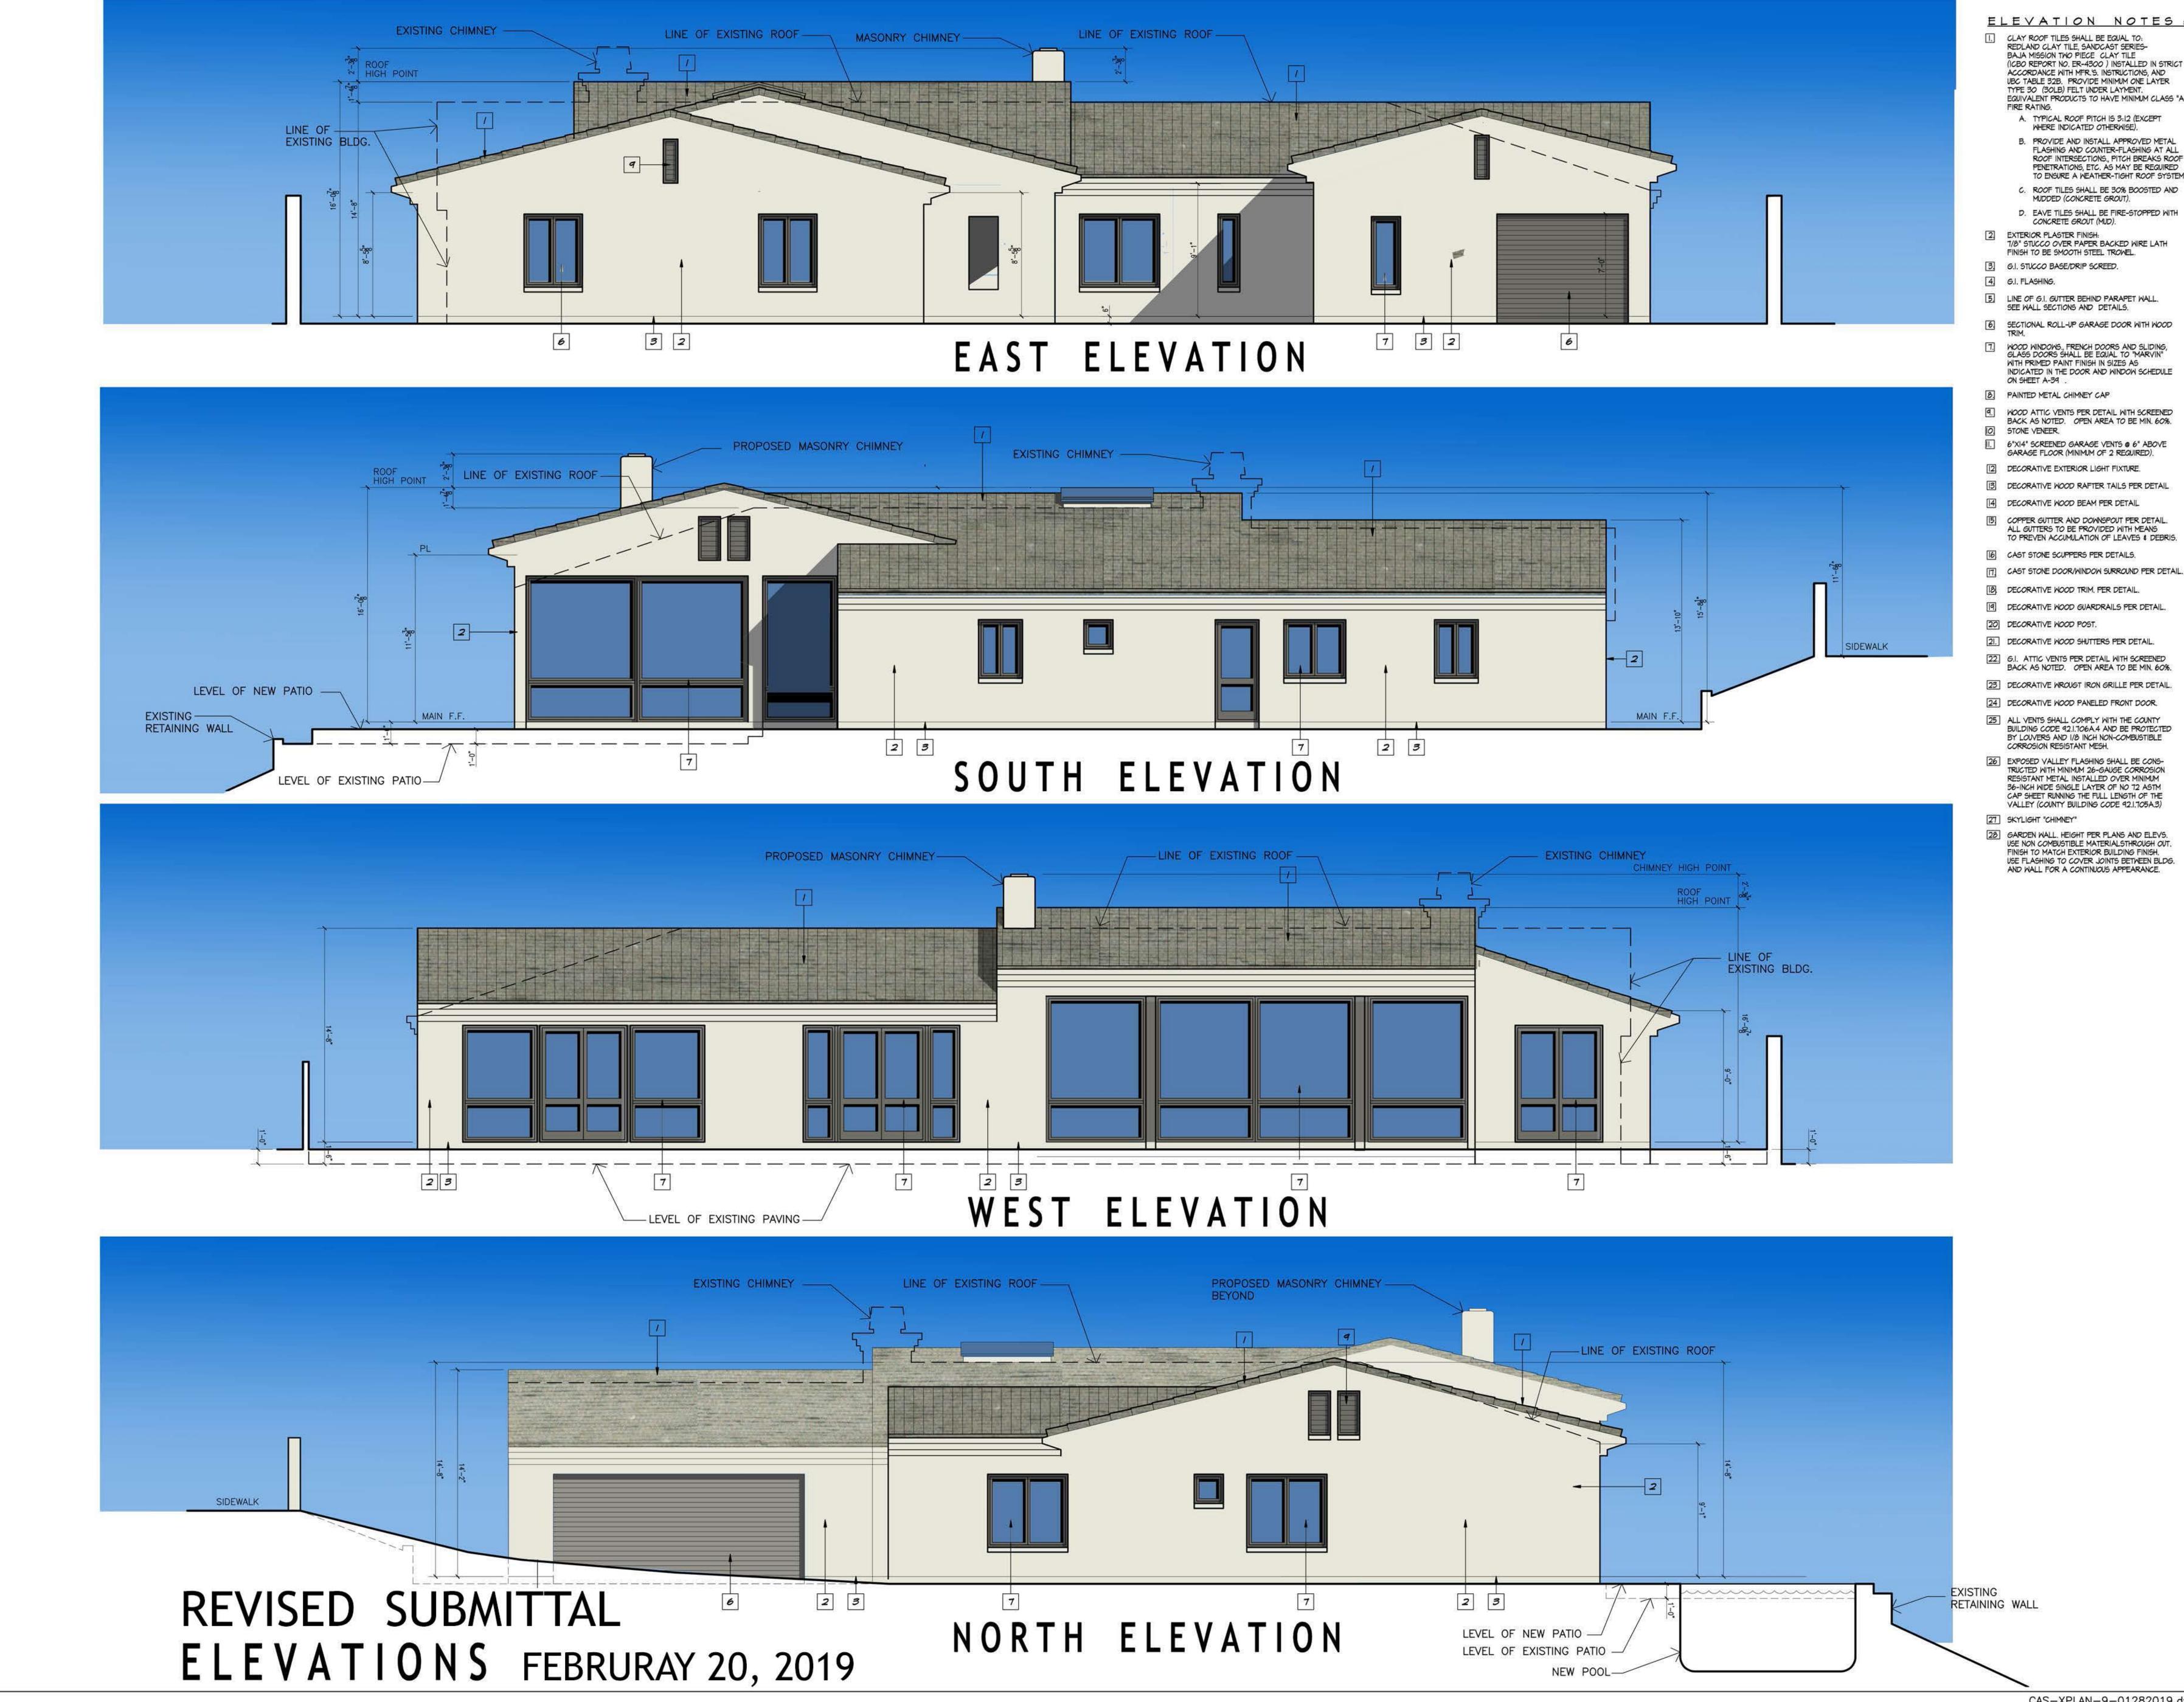


C. ROOF TILES SHALL BE 30% BOOSTED AND D. EAVE TILES SHALL BE FIRE-STOPPED WITH



No. C 14880 DRAWN: CHECKED: MATIN ISSUED SD 03.01.2018 SD 03.16.2018 SD 04.20.2018 CD 10.19.2018 SUBMITTAL II. .2018 ELEVATIONS SCALE : 1/4" = 1'-0 SHEET NO.

A-5a

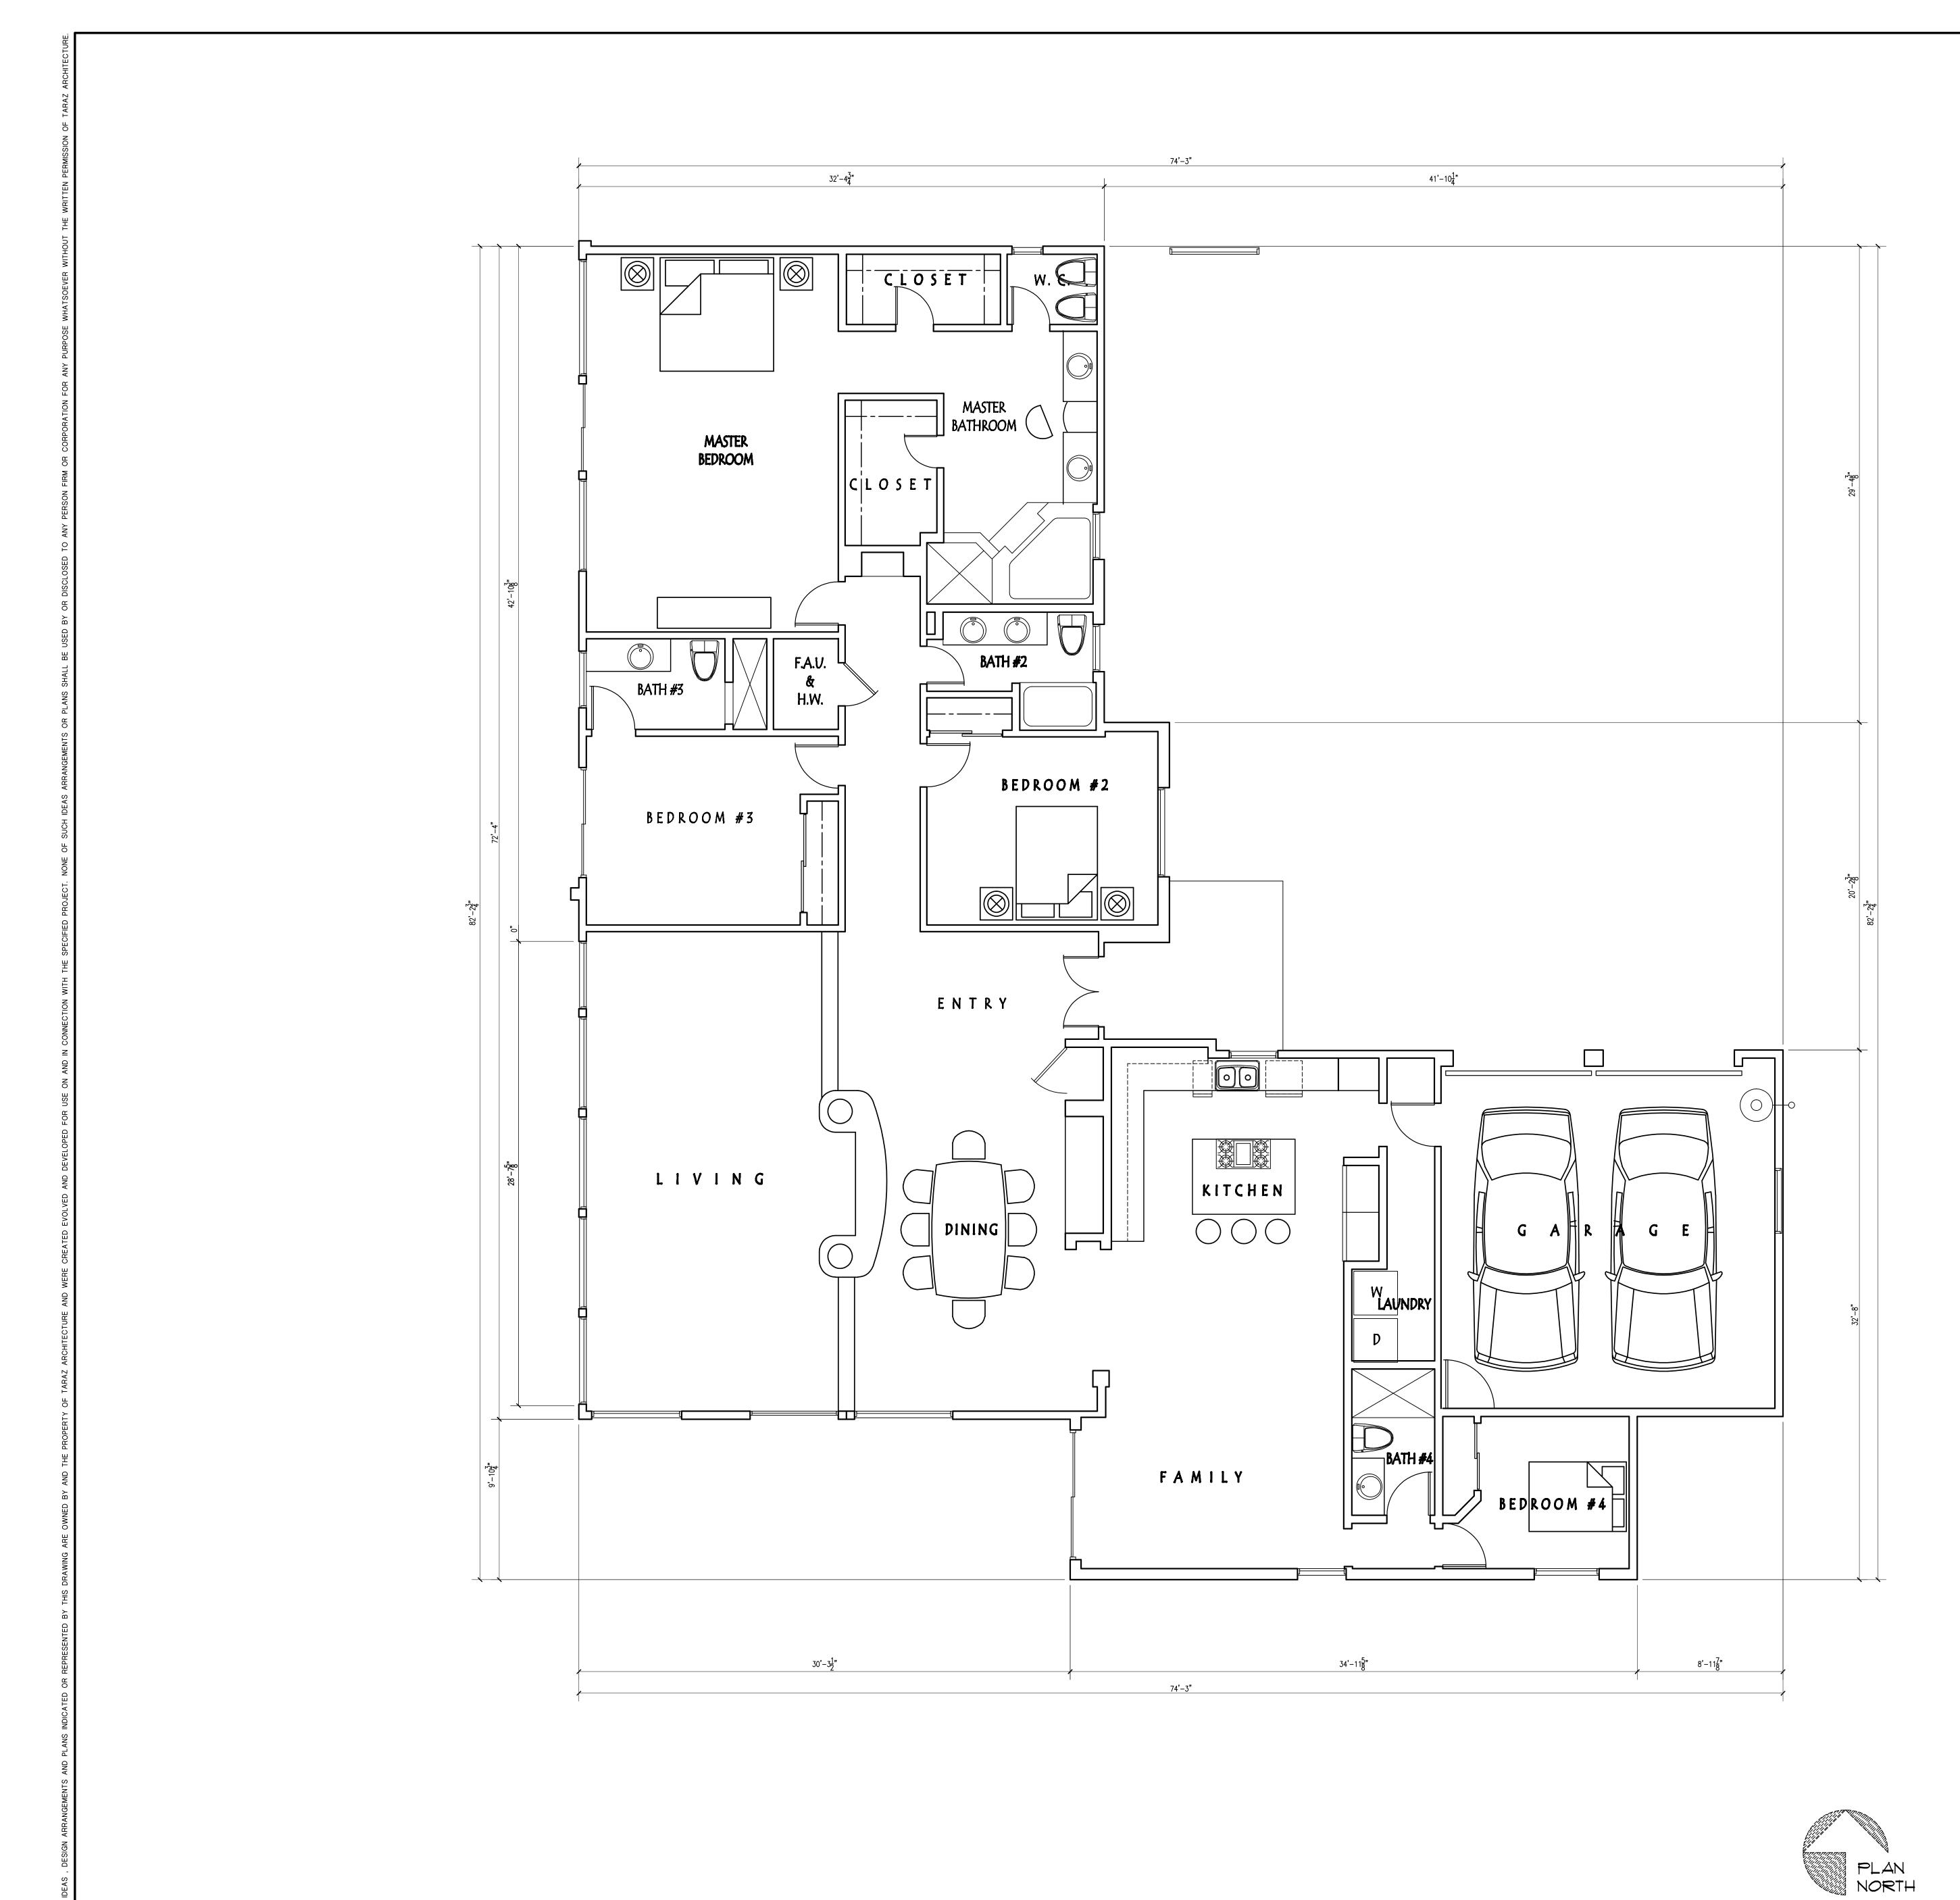




TARAZ ARCHITECTURE Ш P.O. BOX 8090 RANCHO SANTA FE CALIFORNIA (858) 485 - 1137 MATIN CHECKED: MAT/N ISSUED SD 03.01.2018 SD 03.16.2018 SD 04.20.2018 CD 10.19.2018 SUBMITTAL 11. .2018 PROJECT NO. SHEET TITLE EXIST. FLOOR PLAN SHEET NO.



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FLOOR PLAN NOTES

- 00. COMPLIANCE: THESE PLANS AND ALL WORK SHALL COMPLY WITH THE "CALIFORNIA BUILDING STANDARDS CODE" FOUND IN THE STATE OF CALIFORNIA TITLE 24 CCR AS AMENDED AND ADOPTED BY THE COUNTY OF SAN DIEGO.
- KITCHEN SINK : 42" W X 22" D TWO COMPARTMENT ENAMELED CAST IRON MODEL WITH ONE 3/4 H.P. GARBAGE DISPOSAL ON SWITCHED 110V. OUTLET FAUCET FLOW SHALL BE 1.80 GALLONS PER MIN. OR LESS.
- DISHWASHER : 24" WIDE x 23" DEEP "FISCHER & PAYKEL" TWO DRAWER MODEL. W/ 110V OUTLET AND SURFACE MOUNT AIR GAP. 3. TRASH COMPACTOR : PROVIDE 110V. OUTLET.
- 4. REFRIGERATOR / FREEZER : 36" W × 24" D (ONE EACH) BUILT-IN UNITS BY "SUB-ZERO" w/ 1/4" COPPER WATER LINE FOR ICE MAKER. PROVIDE CONNECTION IN RECESSED WALL BOX W/ VALVE.
- 5. GAS COOKTOP & OVEN : 36" WIDE BUILT-IN MODEL Y "VIKING" W/ 36" WIDE EXHAUST HOOD & VENT TO THE EXTERIOR.
- 6. UNDER-COUNTER REFRIGERATOR : 24" WIDE UNIT. 7. DOUBLE OVEN COMBINATION : 30" WIDE BUILT-IN ELECTRIC DOUBLE OVEN BY "VIKING". 8. MICROWAVE OVEN UNIT. BUILT-IN MODEL.
- 9. BUILT-IN CABINETS : PER INTERIOR DESIGN ELEVATIONS.
- 10. "PREP" SINK : 33" WIDE x 22" DEEP SHOWER HEADS AND FAUCETS: ALL SHALL BE OF "FLOW RESTRICTIVE" DESIGN (2.0 GPM MAX. FLOW FOR SHOWER HEADS, 1.5 GPM MAX. FLOW FOR FAUCETS) AS APPROVED BY THE CALIFORNIA ENERGY COMMISSION. SHOWER HEADS TO BE
- ROUGHED-IN @ 6'-8" ABOVE FINISH FLOOR. 12. ULTRA LOW FLUSH TOILETS : SHALL USE 1.28 GALLONS PER FLUSH OR LESS. MAINTAIN MINIMUM 30" CLEAR WIDTH (15" FROM CENTER LINE) AND 24" CLEARANCE IN FRONT OF
- ALL WATER CLOSETS. 13. FIBERGLASS WHIRLPOOL/TUB UNIT: (DIMENSION: 66"LX48"WX19.5"D U.O.N.). PROVIDE WHIRLPOOL MODEL WITH ROUGH-INS FOR ELECTRICAL CONNECTIONS AS REQUIRED AND EQUIPMENT ACCESS IN CONCEALED LOCATION AS ACCEPTABLE TO OWNER AND ARCHITECT.
- 14. COMBINATION TUB/SHOWER : (SIZE: PER PLAN). 15. SEPARATE SHOWER PAN: (SIZE: PER PLAN) WITH CERAMIC TILE WALL SURROUNDS PER INTERIOR DESIGN DRAWINGS. PROVIDE "CLEAR" SHATTER-PROOF GLASS ENCLOSURE IN POLISHED BRASS FRAME. CERAMIC TILE SHOWER PAN CONSTRUCTED PER "HANDBOOK FOR CERAMIC TILE INSTALLATION", METHOD #B414-89, PUBLISHED
- BY THE TILE COUNCIL OF AMERICA. 16. CERAMIC TILE OVER 2 LAYERS "WATER-RESISTANT" GYPSUM WALLBOARD OR FULL MORTAR BED W/ BULL-NOSE TRIM EDGES. PROVIDE MATCHING RECESSED SOAP DISH/GRAB-BAR UNIT. CERAMIC TILE TO BE FULL HEIGHT.
- 17. MEDICINE CABINET : 36" HIGH BUILT-IN MODEL W/ MIRRORED WALL. MODEL NO. 264R BY "NUTONE". SEE INTERIOR ELEVATIONS. 18. CLOTHES DRYER : PROVIDE 110V/220V
- OUTLETS AND FUEL GAS CONNECTION W/ VALVE. DRYER VENT TO EXTERIOR TO BE MIN. 4" IN DIAMETER W/ WEATHER PROOF OUTLET. (NOTE: WHERE VENT EXTENDS VERTICAL THROUGH ROOF PROVIDE ACCESSIBLE SHEET METAL "CLEAN-OUT" DEVICE AT BOTTOM OF VENT).
- 19. CLOTHES WASHER : PROVIDE HOT & COLD WATER SUPPLY AND WASTE IN RECESSED WAL BOX. (NOTE: WHERE WALL BOX OCCURS IN "FIRE-RATED" WALL, BOX MUST BE METAL AND AS APPROVED BY GOVERNING AGENCY FOR SUCH INSTALLATION.) PROVIDE AREA FLOOR DRAIN AS INDICATED.
- 20. LAUNDRY SINK : 32" WIDE × 22" DEEP 21. IRONING BOARD : BUILT-IN FLUSH MOUNTED "NUTONE" MODEL NO. AVC-40. SEE INTERIOR ELEVATIONS.
- 22. SHOWER STEAM GENERATOR: PROVIDE P&T VALVE DISCHARGE LINE TO THE EXTERIOR. 23. WATER HEATER : AS APPROVED BY THE CALIFORNIA ENERGY COMMISION :

UNIT "A" : 50 GAL. CAPACITY

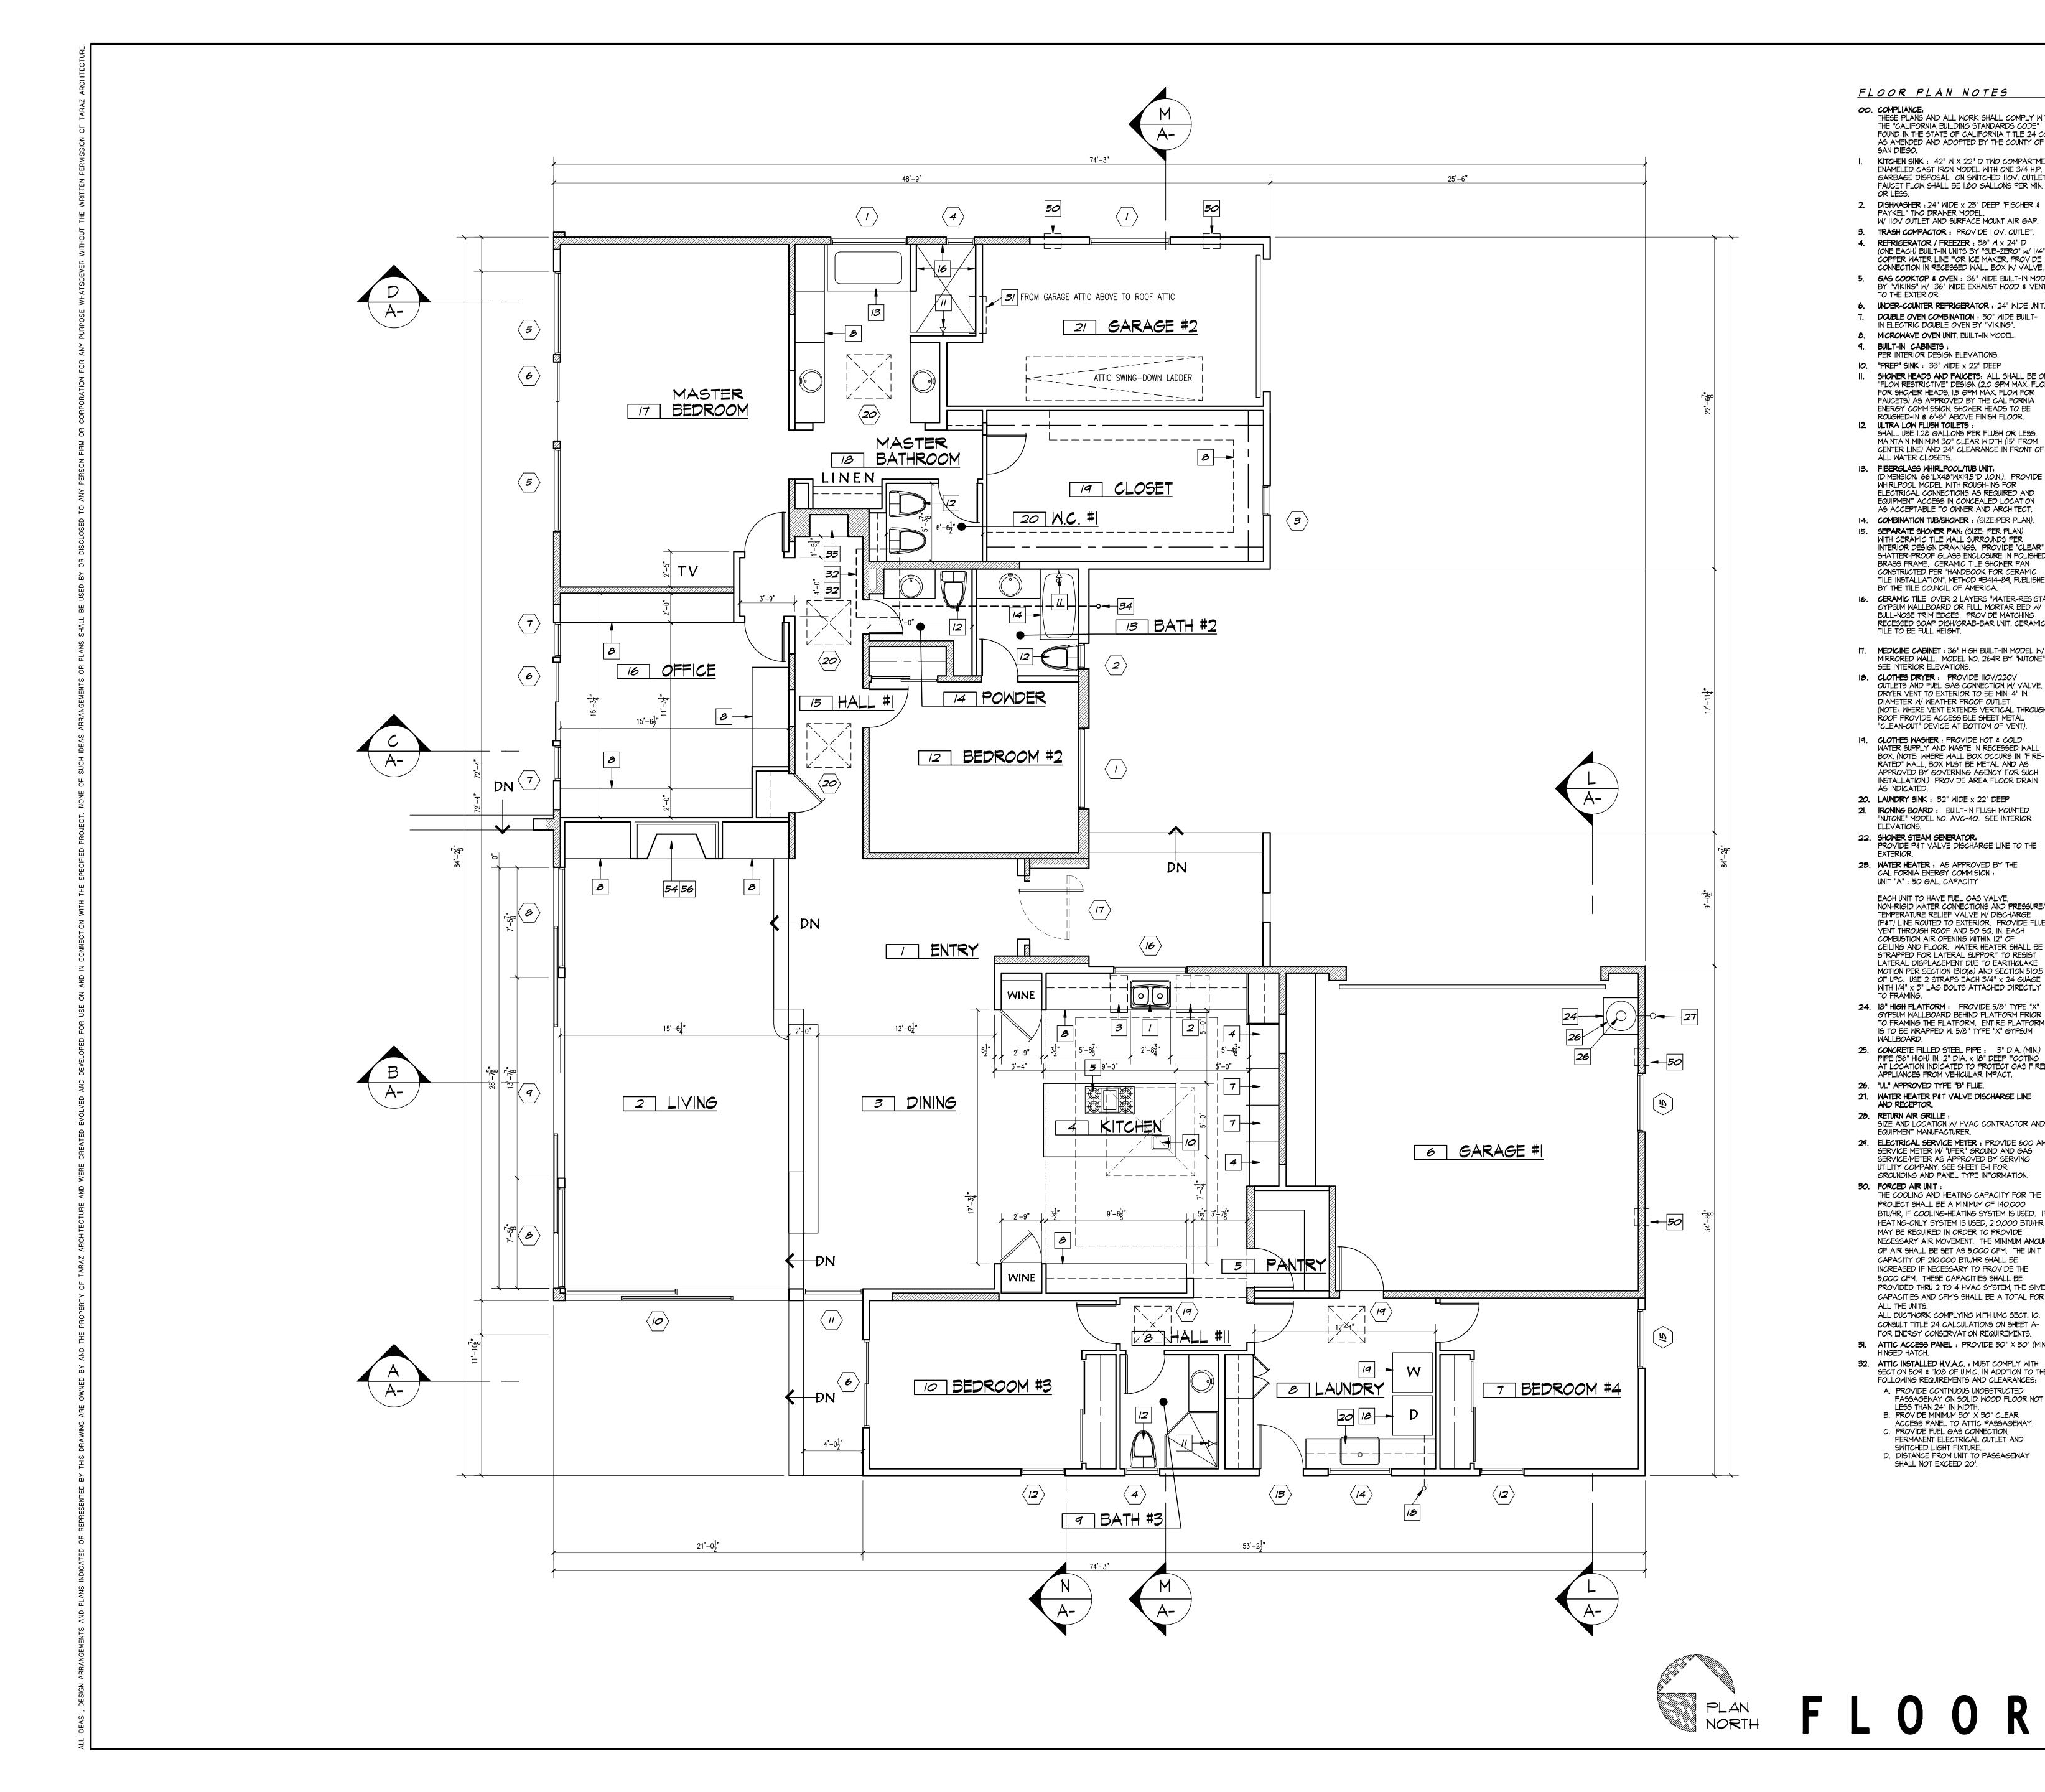
- EACH UNIT TO HAVE FUEL GAS VALVE, NON-RIGID WATER CONNECTIONS AND PRESSURE/ TEMPERATURE RELIEF VALVE W/ DISCHARGE (P&T) LINE ROUTED TO EXTERIOR. PROVIDE FLUE VENT THROUGH ROOF AND 50 SQ. IN. EACH COMBUSTION AIR OPENING WITHIN 12" OF CEILING AND FLOOR. WATER HEATER SHALL BE STRAPPED FOR LATERAL SUPPORT TO RESIST LATERAL DISPLACEMENT DUE TO EARTHQUAKE MOTION PER SECTION 1310(e) AND SECTION 510.5 OF UPC. USE 2 STRAPS EACH 3/4" x 24 GUAGE WITH 1/4" x 3" LAG BOLTS ATTACHED DIRECTLY TO FRAMING.
- 24. 18" HIGH PLATFORM : PROVIDE 5/8" TYPE "X" GYPSUM WALLBOARD BEHIND PLATFORM PRIOR O FRAMING THE PLATFORM. ENTIRE PLATFORM IS TO BE WRAPPED W. 5/8" TYPE "X" GYPSUM WALLBOARD.
- 25. CONCRETE FILLED STEEL PIPE : 3" DIA. (MIN.) PIPE (36" HIGH) IN 12" DIA. X 18" DEEP FOOTING AT LOCATION INDICATED TO PROTECT GAS FIRED APPLIANCES FROM VEHICULAR IMPACT. 26. "UL" APPROVED TYPE "B" FLUE.
- 27. WATER HEATER P&T VALVE DISCHARGE LINE AND RECEPTOR. 28. RETURN AIR GRILLE : SIZE AND LOCATION W/ HVAC CONTRACTOR AND
- EQUIPMENT MANUFACTURER. 29. ELECTRICAL SERVICE METER : PROVIDE 600 AMP. SERVICE METER W/ "UFER" GROUND AND GAS SERVICE/METER AS APPROVED BY SERVING TILITY COMPANY. SEE SHEET E-I FOR
- GROUNDING AND PANEL TYPE INFORMATION. 30. FORCED AIR UNIT : THE COOLING AND HEATING CAPACITY FOR THE PROJECT SHALL BE A MINIMUM OF 140,000 BTU/HR, IF COOLING-HEATING SYSTEM IS USED. IF HEATING-ONLY SYSTEM IS USED, 210,000 BTU/HR MAY BE REQUIRED IN ORDER TO PROVIDE NECESSARY AIR MOVEMENT. THE MINIMUM AMOUNT OF AIR SHALL BE SET AS 5,000 CFM. THE UNIT CAPACITY OF 210,000 BTU/HR SHALL BE INCREASED IF NECESSARY TO PROVIDE THE 5,000 CFM. THESE CAPACITIES SHALL BE PROVIDED THRU 2 TO 4 HVAC SYSTEM, THE GIVEN CAPACITIES AND CFM'S SHALL BE A TOTAL FOR ALL THE UNITS. ALL DUCTWORK COMPLYING WITH UMC SECT. 10.
- CONSULT TITLE 24 CALCULATIONS ON SHEET A-FOR ENERGY CONSERVATION REQUIREMENTS. 31. ATTIC ACCESS PANEL : PROVIDE 30" X 30" (MIN.) HINGED HATCH. 32. ATTIC INSTALLED H.V.A.C. : MUST COMPLY WITH
- SECTION 509 \$ 708 OF U.M.C. IN ADDITION TO THE FOLLOWING REQUIREMENTS AND CLEARANCES: A. PROVIDE CONTINUOUS UNOBSTRUCTED PASSAGEWAY ON SOLID WOOD FLOOR NOT LESS THAN 24" IN WIDTH.
- B. PROVIDE MINIMUM 30" X 30" CLEAR ACCESS PANEL TO ATTIC PASSAGEWAY. C. PROVIDE FUEL GAS CONNECTION,
- PERMANENT ELECTRICAL OUTLET AND SWITCHED LIGHT FIXTURE. D. DISTANCE FROM UNIT TO PASSAGEWAY
- SHALL NOT EXCEED 20'.

- 33. FORCED AIR UNITS SHALL COMPLY WITH THE PROVISIONS OF CHAPTER 6 OF THE UMC: A. PROVIDE ONE OPENING WITHIN 12" OF THE TOP OF THE ENCLOSURE PER SECTION 602(a).
- B. COMBUSTION AIR DUCTS SHALL NOT BE INSTALLED SO AS TO REQUIRE OPENINGS IN OR PENETRATIONS THROUGH CONSTRUCTION WHERE FIRE DAMPERS ARE REQUIRED PER SECTION 602(B).
- C. PROVIDE COMBUSTION AIR DUCT FOR ALL INTERIOR FORCED AIR UNITS. D. THE NET FREE AREA OF OPENINGS, DUCTS OR PLENUMS SHALL BE AS SPECIFIED IN TABLE 6-A. WHEN GRILLES, SCREENS OR LOUVRES ARE INSTALLED, ONLY THE FREE AREA THROUGH GRILLES, SCREENS OR LOUVRES
- SHALL BE USED IN CALCULATING THE SIZE OF THE OPENING PER SEC. 602(C) AND 606(A). H.V.A.C. UNIT CONDENSATE WATER LINE. ROUTE PIPING IN CEILING JOIST SPACE FROM A.C. UNIT TO AN APPROVED PLUMBING FIXTURE. SECONDARY LINE SHOULD EXTEND TO BUILDING
- EXTERIOR. THEN DOWN THE STUD WALL AND DISCHARGE AT GROUND LEVEL INTO A DRY WELL. 35. GYPSUM WALLBOARD FORMED "NICHE" :
- SEE INTERIOR DESIGN DRAWINGS. 36. PARAPET/GUARDRAIL : 42" HIGH (MIN.) SHALL HAVE NO OPENINGS NO LARGER THAN 3-1/2".
- 37. SOUND INSULATED WALL : PROVIDE SOUND ATTENUATION INSULATION FOR PLUMBING WALL.
- 38. STEEL FRAMED WALL : PROVIDE NON-COMBUSTIBLE CONSTRUCTION BEHIND BBQ. 39. USABLE SPACE UNDER STAIRS : ALL SURFACES SHALL BE COVERED WITH 5/8" TYPE "X" GYPSUM WALLBOARD.
- 40. HOSE BIB : PROVIDE PERMANENT VACCUM BREAKERS FOR ALL HOSE BIBS. GARAGE WALLS AND CEILINGS ARE REQUIRED TO BE OF ONE HOUR FIRE RESISTIVE CONSTRUCTION ON THE GARAGE SIDE OF WALLS AND CEILINGS
- COMMON TO THE DWELLING, PER TABLE 5-B, SECTION 503(d). A. PROVIDE ONE LAYER OF TYPE 'X' GYP. BOARD ON THE GARAGE WALLS AND POST CONTINIOUS FROM FLOOR TO ROOF SHEATHING.
- B. PROVIDE TWO LAYERS OF TYPE 'X' GYP. BOARD ON THE GARAGE CEILING. 42. ALL STRUCTURAL ELEMENTS SUPPORTING FLOOR ABOVE GARAGE, INCLUDING WALLS AND POSTS SUPPORTING FLOOR JOISTS MUST HAVE ONE HOUR FIRE-RESISTIVE PROTECTION ON THE GARAGE
- SIDE PER SECTION 503(b). 43. ALL WINDOWS & FRENCH DOORS AND SKYLIGHTS TO COMPLY WITH THE FOLLOWING REQUIREMENTS A. BE CERTIFIED AS TO THEIR OVERALL
- U-VALUES AS TESTED IN ACCORDANCE WITH TH "NFRC" PROCEDURE, OR A DE-FAULT TABLE CONTAINED IN THE DESIGN MANUAL B. HAVE A TEMPORARY LABEL, NOT TO BE
- REMOVED BEFORE INSPECTION BY THE BUILDING DEPARTMENT, LISTING THE CERTIFIED U-VALUE IN THE DESIGN MANUAL. C. HAVE A PERMANENT LABEL, LISTING THE U-VALUE, CERTIFYING ORGANIZATION AND
- RATING PROCEDURE. 44. ALL INSULATION MUST BE CERTIFIED AS COMPLY-ING WITH THE "CALIFORNIA QUALITY SATNDARDS FOR INSULATING MATERIALS". 45. ALL DRAIN LINES TO SLOPE MIN. 1/4" PER FOOT.
- 46. ALL JOINTS AND OPENINGS IN THE BUILDING ENVELOPE SHALL BE CAULKED, GASKETED, WEATHERSTRIPPED OR OTHERWISE SEALED TO LIMIT INFILTRATION AND EXFILTRATION. 47. AN INSTALLATION CERTIFICATE IS REQUIRED TO BE POSTED AT THE BUILDING SITE PRIOR TO THE ISSUANCE OF THE OCCUPANCY PERMIT.
- 48. 1-3/8" SOLID CORE, SELF-CLOSING DOOR : PROVIDE DOOR W/ THRESHOLD AND FULL WEATHERSTRIPPING AT DOORWAY TO GARAGE DOOR TO BE 20 MINUTE FIRE PROTECTION RATED. 49. CENTRAL VACCUM SYSTEM.
- 50. SCREENED VENTS : SIZE: 6"XI4" AT 6" ABOVE GARAGE FLOOR. (MIN. 2 REQUIRED) 51. "PONY - WALL" : TO HEIGHT INDICATED ON FLOOR PLAN OR INTERIOR DESIGN DRAWINGS. DRYWALL WITH "BULLNOSE - RADIUS" FINISH UNLESS OTHERWISE NOTED OR DETAILED ON INTERIOR DESIGN DRAWINGS.
- 52. BALCONY SCUPPERS : PROVIDE FLOOR DRAINS PER "DEX-O-TEX" DETAILS. BALCONY WATERPROOFING : EQUAL TODEX-O-TEX "ELASTATEX 500" PROMENADE ROOF DECK
- SURFACING AS MANUFACTURED BY CROSSFIELD PRODUCTS CORP. OR EQUAL . INSTALLED OVER FLOOR SHEATHING PER MANUFACTURER'S INSTRUCTIONS. PROVIDE FLASHING AND SUB-STRATE PER MANUFACTURERS APPROVED AND SUPPLIED DETAILS.
- 54. MASONRY FIREPLACE: W REMOVABLE GAS KEY, CLOSABLE TIGHT FITTING GLASS DOORS, OUTSIDE COMBUSTION AIR WHEN LOCATED ON EXTERIOR WALL, AND A READILY ACCESSIBLE, OPERABLE AND TIGHT FITTING DAMPER. UNLESS OTHERWISE INDICATED ON THE DRAWINGS OR REQUIRED BY CODE. PROVIDE APPROVED HEARTH EXTENSION MIN. 18" DEEP AND 12" BEYOND FIREPLACE OPENING ON EACH SIDE. SEE INTERIOR
- DESIGN DRAWINGS FOR INSTALLATION HEIGHT AND SURROUND MATERIAL AND DESIGN. 55. THE HIGHEST POINT OF THE ROOF, EQUIPMENT OR ANY VENT, PIPE, ANTENNA OR OTHER PROJECTION, SHALL NOT EXCEED 30 ABOVE GRADE.
- 56. ALL FIREPLACES WGAS LOG LIGHTERS SHALL HAVE THE FLUE DAMPER PERMANENTLY FIXED IN THE OPEN POSITION AND FIREPLACES WITH L.P LOG LIGHTERS ARE TO HAVE NO "PIT" OR "SUMP" CONFIGURATION. 57. BARBEQUE UNIT
- 48" WIDE STAINLESS STEEL GAS MODEL INSTALLED PER MANUFACTURER INSTRUCTIONS AND DETAILS. UNIT TO BE "DSC" BRAND MODEL NO. 48D. MIN. CLEARANCES TO BE 3" TO NON-COMBUSTABLE AND 12" IN THE REAR AND 36" ABOVE COOKING SURFACE TO COMBUSTABLE.
- 58. PROVIDE AND INSTALL FULLY AUTOMATIC FIRE SPRINKLER SYSTEM APPROVED BY DISTRICT FIRE MARSHALL HAVING JURISDICTION OVER THIS PROJECT.
- 59. PROVIDE PAINTED LOUVERED DOOR WITH MINIMUM 100 SQUARE INCHES OF OPEN AREA. 60. PROJECT TO USE LIQUID PROPANE GAS (LPG). 61. THIS BUILDING IS TO COMPLY WITH THE COUNTY OF

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SAN DIEGO OUTDOOR LIGHTING ORDINANCE.




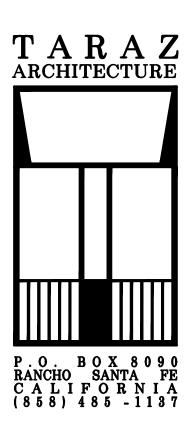

D No. C 14880 DRAWN: CHECKED: MATIN ISSUEL SD 03.01.2018 SD 03.16.2018 SD 04.20.2018 CD 10.19.2018 SUBMITTAL II. .2018

SCALE : 1/4" = 1'-0" 08/15/2018 19:17

FLOOR PLAN

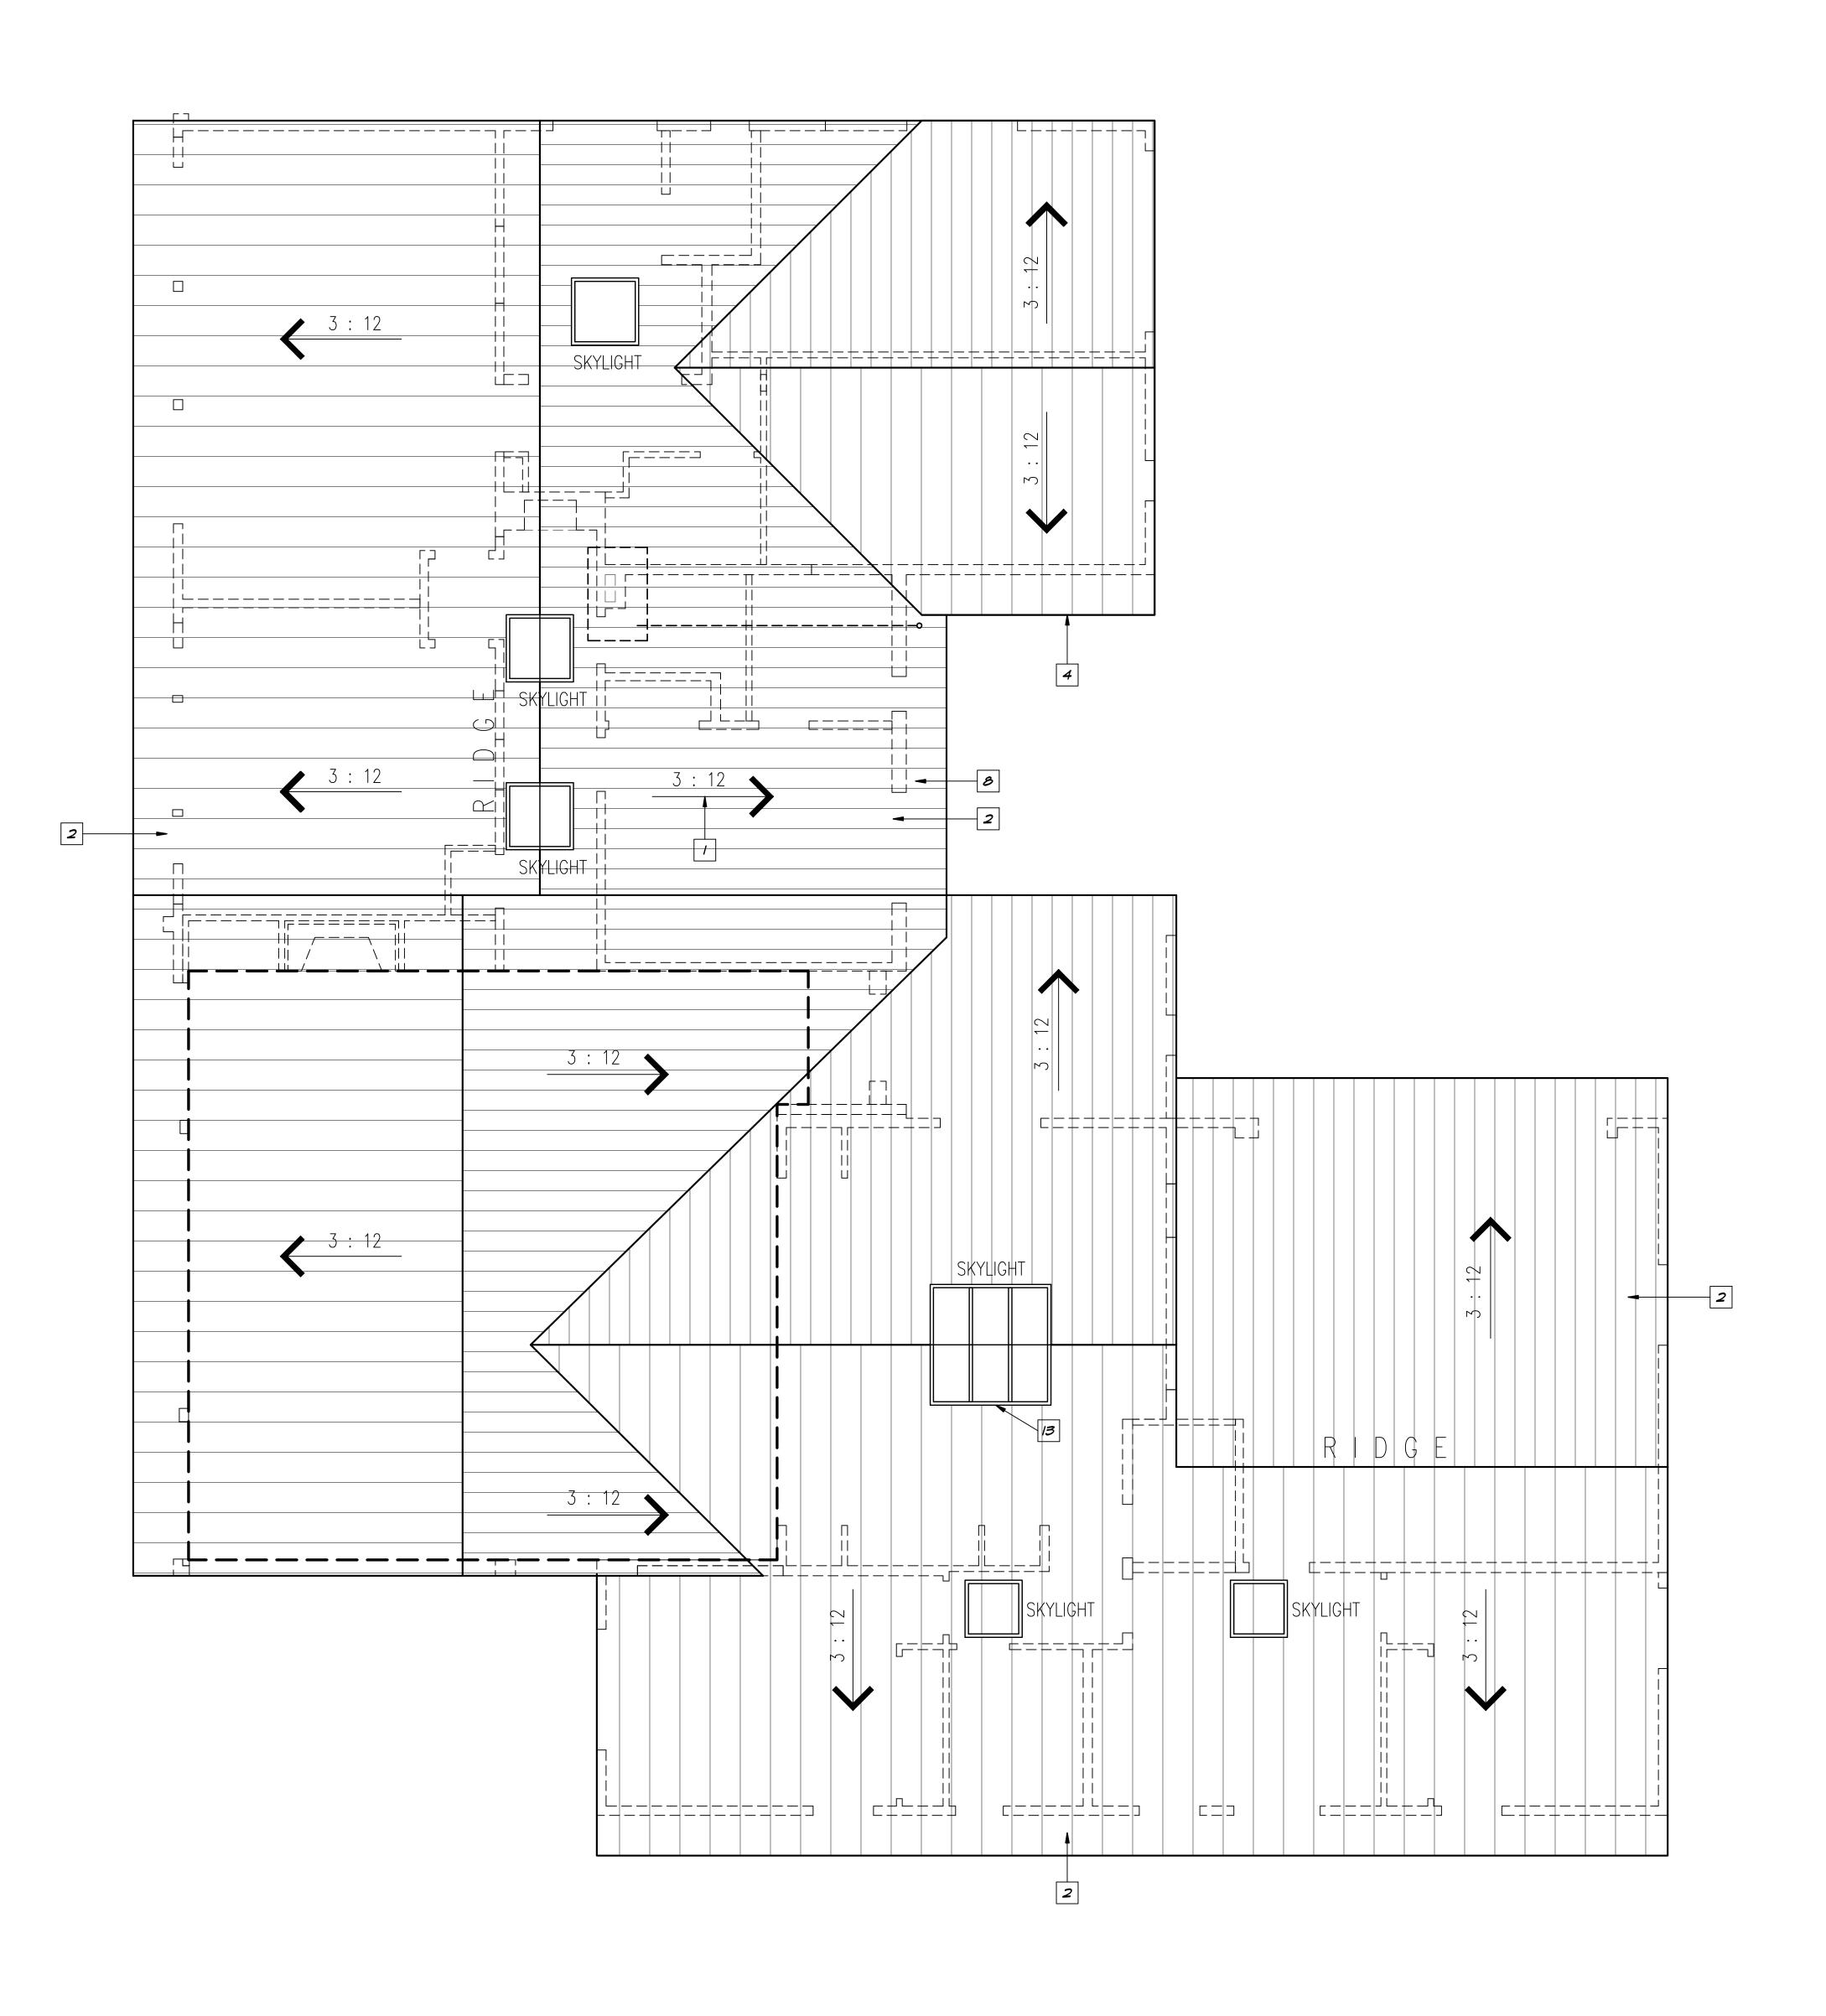


ROOF PLAN NOTES : I. ROOF SLOPE GRADIENT. 3 : 12 (TYP. U.O.N.)


- 2. ROOFING MATERIAL PER EXTERIOR ELEVATIONS.
- 3. EXTERIOR STUCCO FINISH PER EXTERIOR ELEVATIONS
- 4. ROOF PARAPET PER EXTERIOR ELEVATIONS. G.I. GUTTER AND FLASHING PER DETAIL. SLOPE MIMIMUM I/B" PER FOOT TOWARDS DOWNSPOUT (DS) AND OVERFLOW (OF).
- CRICKET FRAMED OVER CONTINUOUS ROOF SHEATHING. SLOPE TO BE MINIMUM 1:12.
- FLAT STUCCO SURFACES TO SLOPE MINIMUM 1/2" PER FOOT IN THE DIRECTION OF ARROW.
- 8. LINE OF EXTERIOR WALL BELOW SOFFIT OR ROOF.
- 9. G.I. ATTIC VENTS PER DETAIL WITH SCREENED BACK AS NOTED. OPEN AREA TO BE MIN. 60%.
- IO. CHIMNEY STACK PER EXTERIOR ELEVATIONS. II. CURB MOUNTED SKYLIGHT. ALSO SEE FLOOR PLAN. SEE ROOF PLAN FOR LOCATION, WINDOW SCHEDULE FOR SIZE AND ROOF FRAMING PLAN FOR FRAMING INFORMATION. SKYLIGHTS EQUAL TO BRISTOLITE (ICBO #2469) WITH DUAL GLAZED "LOW WHITE" (WTL) LOW PROFILE DOME WITH TEMPERED GLASS.
- 12. ROOF DRAIN & OVERFLOW PER DETAIL. DIRECT PIPING TO EXTERIOR WALL THEN DOWN TO GRADE. CONNECT TO STORM DRAIN SYSTEM. OVERFLOW DRAINS SHALL BE CONNECTED TO DRAIN LINES INDEPENDENT OF FROM THE ROOF DRAINS.
- 13. ROOF SCUPPER & RAIN WATER LEADER CONNECT LEADER
- TO STORM DRAIN SYSTEM. 14. ATTIC VENTILATION: PREVENT INTRUSION OF FLAME AND EMBER INTO THE ATTIC.(EMBER RESISTANT "ER" APPROVED MODELS ONLY)
- 15. SKYLIGHT PER WINDOW SCHEDULE.

16. FUTURE SOLAR AREA (MIN. 250 SF)



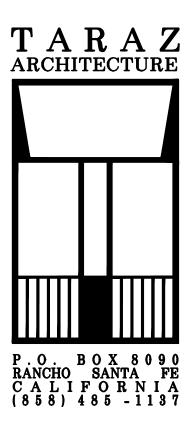

DRAWN: MATIN CHECKED: ISSUE SD 03.01.2018 SD 03.16.2018 SD 04.20.2018 CD 10.19.2018 SUBMITTAL 11. .2018

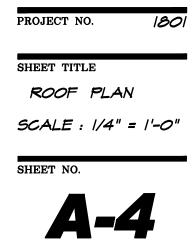



CAS-XPLAN-9-10192018.dwg 02/06/2019 19:17

Mr. and Mrs. Louis Castagnola, Jr. 8204 Prestwick Drive La Jolla, California 92037 Telephone 858 246-7399 Facsimile 858 246-7366 Email: lcastagnola@att.net

February 11, 2019

Dear Neighbors:

My wife and I, Louis and Maria Castagnola, residing at 8204 Prestwick Drive, have a remodeling project that will be coming before the La Jolla Shores Planned District Advisory Board on February 20, 2019, at 11:00am at the La Jolla Recreation Center, 615 Prospect St., La Jolla, CA 92037.

It is our opinion that the proposed project should be considered for approval with Minor/Process 1 designation. The east/street elevation of the proposed remodeled house will change very little from the current house.

We would be more than happy to show you our plans prior to the LJSPDAB meeting on February 20, 2019 with the hope that you would lend support for our project. Please do not hesitate to contact us if you would like to see the remodeling plans or if you have any questions or comments about the project.

Sincerely yours,

Castagnola

Louis Castagnola, Jr. Maria Castagnola

Distribution List – Property owners within 300 feet of 8204 Prestwick Drive

Mr. and Mrs. Michael Kagnoff 8244 Prestwick Dr.

Mr. and Mrs. David Groce 8243 Prestwick Dr.

Mr. and Mrs. Larry Herschfield 8230 Prestwick Dr. P.O. Box 7202 Rancho Santa Fe, CA 92067

Mr. and Mrs. Bill Strum 8229 Prestwick Dr.

Mr. and Mrs. Joseph Patterson 8216 Prestwick Dr. 16740 Monte Hermoso Dr. Pacific Palisades, CA 90272

Mr. and Mrs. Raymond Beuligmann 8215 Prestwick Dr.

Mrs. Juanita Meyer 8201 Prestwick Dr.

Mr. and Mrs. Ortmann 8195 Prestwick Dr.

Mr. and Mrs. George Hunt 8182 Prestwick Dr.

Berchtold Family Trust 8185 Prestwick Dr.

De Coppel Maria Eugenia Gutierrez 8194 Prestwick Dr.

Dr. and Mrs. Bijan Razi 8172 Prestwick Dr.

Ms. Delores Donavan 2586 Calle del Oro

Neighbor 2572 Calle del Oro

Neighbor 2552 Calle del Oro