#### La Jolla Shores Planned District Advisory Board La Jolla Recreation Center 615 Prospect Street, La Jolla CA 92037

Please provide the following information on this form for calendaring your project on an upcoming La Jolla Shores Planned District Advisory Board meeting.

For I	<pre>Information Items   Project name (Unsubmitted projects can be informational items if the   development team is seeking comments and direction from the Trustees on   the concept):</pre>
•	Address and APN(s):
•	Project contact name, phone, e-mail:
•	Project description:
•	In addition to the project description, please provide the following:  o lot size:  o existing structure square footage and FAR (if applicable):  o proposed square footage and FAR:  o existing and proposed setbacks on all sides:  o height if greater than 1-story (above ground):  Project aspect(s) that the applicant team is seeking Trustee direction on. (community character, aesthetics, design features, etc.):
For /	Action Items  Project PTS number from Development Services and project name (only submitted projects can be heard as action items): 634880Bush Residence
•	Address and APN(s): 7194 St. Louis Terrace APN#346-454-06-00
•	Project contact name, phone, e-mail: <pre>Architect, Mark D. Lyon (858)459-1171 info@mdla.net</pre>
•	Project description: <u>Proposed 499 sqft. to 2<sup>nd</sup> floor.</u> <u>Proposed 342 sqft. 3<sup>rd</sup> floor roof deck</u> <u>Proposed 1<sup>st</sup> floor interior remodel of 1,247 sqft.</u>
•	<pre>In addition, provide the following:     o lot size: 4,189 sqft.     o existing structure square footage and FAR (if applicable): 2,673     o proposed square footage and FAR: 499</pre>

- height if greater than 1-story (above ground): 30'-6"

#### Exhibits and other materials to provide:

Please provide the following which will be attached to the agenda and posted to the City's website for view by the public:

- Exhibits (e.g. site plan, elevations, exhibits showing addition/remodel areas, etc.)
- Any surveys that indicate similarities in floor area or architectural style in the surrounding neighborhood
- Any communications from adjacent neighbors, local neighborhood groups, and/or the Homeowners' Association

#### (CONTINUED ON THE NEXT PAGE)

#### PLEASE DO NOT PROVIDE THE FOLLOWING:

- The complete plan set of the project. Complete plan sets take up a lot of memory to distribute and most of the information is not necessary for the Advisory Board's review.
- Plans or exhibits of the interior of the project. Interiors are not reviewed by the Advisory Board.
- Personal contact information of the property owners of the project should not be included, unless they are the "owner/applicant" and they are the designated point of contact

The Trustees are very keen to know that the neighbors in the immediate vicinity have been noticed and their views noted. Community conformity, setbacks, FAR, parking, view corridors, bulk & scale, and articulation are key discussion points on all projects.

Thank you,

Marlon I. Pangilinan Senior Planner Planning Department 9485 Aero Drive MS 413 San Diego CA 92123 619-235-5293 www.sandiego.gov/planning

#### STORM WATER QUALITY NOTES CONSTRUCTION BMP'S:


THIS PROJECT SHALL COMPLY WITH ALL CURRENT REQUIREMENTS OF THE STATE PERMIT; CALIFORNIA REGIONAL QUALITY CONTROL BOARD (SDRWQCB), SAN DIEGO MUNICIPAL STORM WATER PERMIT, THE CITY OF SAN DIEGO LAND DEVELOPMENT CODE, AND THE STORM WATER STANDARDS MANUAL.


#### NOTES BELOW REPRESENT KEY MINIMUM REQUIREMENTS FOR BMP'S.

- . ALL REQUIREMENTS OF THE CITY OF SAN DIEGO "STORM WATER STANDARDS MANUAL" MUST BE INCORPORATED INTO THE DESIGN AND CONSTRUCTION OF THE PROPOSED GRADING/IMPROVEMENTS CONSISTENT WITH THE APPROVED STORM WATER POLLUTION PREVENTION PLAN (SWPPP) AND/OR WATER POLLUTION CONTROL PLAN (WPCP) FOR CONSTRUCTION LEVEL BMPS AND, IF APPLICABLE, THE STORM WATER QUALITY MANAGEMENT PLAN (SWQMP) FOR POST-CONSTRUCTION BMPS.
- 2. THE CONTRACTOR SHALL INSTALL AND MAINTAIN ALL STORM DRAIN INLET PROTECTION. INLET PROTECTION IN THE PUBLIC RIGHT-OF-WAY MUST BE TEMPORARILY REMOVED PRIOR TO A RAIN EVENT TO ENSURE NO FLOODING OCCURS AND REINSTALLED AFTER RAIN IS OVER.
- 3. ALL CONSTRUCTION BMPS SHALL BE INSTALLED AND PROPERLY MAINTAINED THROUGHOUT THE DURATION OF CONSTRUCTION.
- 4. THE CONTRACTOR SHALL ONLY GRADE, INCLUDING CLEARING AND GRUBBING, AREAS FOR WHICH THE CONTRACTOR OR QUALIFIED CONTACT PERSON CAN PROVIDE EROSION AND SEDIMENT CONTROL
- 5. THE CONTRACTOR IS RESPONSIBLE FOR ENSURING THAT ALL SUB-CONTRACTORS AND SUPPLIERS ARE AWARE OF ALL STORM WATER BMPS AND IMPLEMENT SUCH MEASURES. FAILURE TO COMPLY WITH THE APPROVED SWPPP/WPCP WILL RESULT IN THE ISSUANCE OF CORRECTION NOTICE, CITATIONS, CIVIL

PENALTIES, AND/OR STOP WORK NOTICE.

- 6. THE CONTRACTOR OR QUALIFIED CONTACT PERSON SHALL BE RESPONSIBLE FOR CLEANUP OF ALL DEBRIS, SILT, AND MUD ON AFFECTED AND ADJACENT STREET(S) AND WITHIN STORM DRAIN SYSTEM DUE TO CONSTRUCTION VEHICLES/EQUIPTMENT AND CONSTRUCTION ACTIVITY AT HE END OF EACH WORK DAY.
- . THE CONTRACTOR SHALL PROTECT NEW AND EXISTING STORM WATER CONVEYANCE SYSTEMS FROM SEDIMENTATION, CONCRETE RINSE, OR OTHER CONSTRUCTION-RELATED DEBRIS AND DISCHARGES WITH THE APPROPRIATE BMPS THAT ARE ACCEPTABLE TO THE CITY RESIDENT ENGINEER AND AS INDICATED IN THE SWPPP/WPCP
- 8. THE CONTRACTOR OR QUALIFIED CONTACT PERSON SHALL CLEAR DEBRIS, SILT, AND MUD FROM ALL DITCHED AND SWALES PRIOR TO AND WITHIN 3 BUSINESS DAYS AFTER EACH RAIN EVENT OR PRIOR TO THE NEXT RAIN EVENT, WHICHEVER IS SOONER.
- 9. IF A NON-STORM WATER DISCHARGE LEAVES THE SITE, THE CONTRACTOR SHALL IMMEDIATELY STOP THE ACTIVITY AND REPAIR THE DAMAGES. THE CONTRACTOR SHALL NOTIFY THE CITY RESIDENT ENGINEER OF THE DISCHARGE, PRIOR TO RESUMING CONSTRUCTION ACTIVITY. ANY AND ALL WASTE MATERIAL, SEDIMENT, AND DEBRIS FROM EACH NON-STORM WATER DISCHARGE SHALL BE REMOVED FROM THE STORM DRAIN CONVEYANCE SYSTEM AND PROPERLY DISPOSED OF BY THE CONTRACTOR.
- IO. EQUIPMENT AND WORKERS FOR EMERGENCY WORK SHALL BE MADE AVAILABLE AT ALL TIMES. ALL NECESSARY MATERIALS SHALL BE STOCKPILED ONSITE AT CONVENIENT LOCATIONS TO FACILITATE RAPID DEPLOYMENT OF CONSTRUCTION BMPS WHEN RAIN IS IMMINENT.
- I. THE CONTRACTOR SHALL RESTORE AND MAINTAIN ALL EROSION AND SEDIMENT CONTROL BMPS TO WORKING ORDER YEAR-ROUND.
- 12. THE CONTRACTOR SHALL INSTALL ADDITIONAL EROSION AND SEDIMENT CONTROL MEASURES DUE TO UNFORESEEN CIRCUMSTANCES TO PREVENT NON-STORM WATER AND SEDIMENT-LADEN DISCHARGES.
- 13. THE CONTRACTOR SHALL BE RESPONSIBLE AND SHALL TAKE NECESSARY PRECAUTIONS TO PREVENT PUBLIC TRESPASS ONTO AREAS WHERE IMPOUNDED WATERS CREATE A HAZARDOUS CONDITION.
- 14. ALL EROSION AND SEDIMENT CONTROL MEASURES PROVIDED PER THE APPROVED SWPPP/WPCP SHALL BE INSTALLED AND MAINTAINED. ALL EROSION AND SEDIMENT CONTROLS FOR INTERIM CONDITIONS SHALL BE PROPERLY DOCUMENTED AND INSTALLED TO THE SATISFACTION OF THE CITY RESIDENT ENGINEER.
- 15. AS NECESSARY, THE CITY RESIDENT ENGINEER SHALL SCHEDULE MEETINGS FOR THE PROJECT TEAM (GENERAL CONTRACTOR, QUALIFIED CONTACT PERSON, EROSION CONTROL SUBCONTRACTOR IF ANY, ENGINEER OF WORK, OWNER/DEVELOPER, AND THE CITY RESIDENT ENGINEER) TO EVALUATE THE ADEQUACY OF THE EROSION AND SEDIMENT CONTROL MEASURES AND OTHER BMPS RELATIVE TO ANTICIPATED CONSTRUCTION ACTIVITIES.
- 16. THE CONTRACTOR OR QUALIFIED CONTACT PERSON SHALL CONDUCT VISUAL INSPECTIONS AND MAINTAIN ALL BMPS DAILY AND AS NEEDED. VISUAL INSPECTIONS AND MAINTENANCE OF ALL BMPS SHALL BE CONDUCTED BEFORE, DURING, AND AFTER EVERY RAIN EVENT AND EVERY 24 HOURS DURING ANY PROLONGED RAIN EVENT. THE CONTRACTOR SHALL MAINTAIN AND REPAIR ALL BMPS AS SOON AS POSSIBLE AS SAFETY ALLOWS.
- I. <u>CONSTRUCTION ENTRANCE AND EXIT AREA.</u> TEMPORARY CONSTRUCTION ENTRANCE AND EXITS SHALL BE CONSTRUCTED IN ACCORDANCE WITH CASOA FACT SHEET TC-IOR CALTRANS FACT SHEET TC-OI TO PREVENT TRACKING OF SEDIMENT AND OTHER POTENTIAL POLLUTANTS ONTO PAVED SURFACES AND TRAVELED WAYS. WIDTH SHALL BE 10' OR THE MINIMUM NECESSARY TO ACCOMMODATE VEHICLES AND EQUIPMENT WITHOUT BY-PASSING THE ENTRANCE. (a) NON-STORM WATER DISCHARGE SHALL BE EFFECTIVELY MANAGED PER THE SAN DIEGO MUNICIPAL CODE CHAPTER 4, ARTICLE 3, DIVISION 3 "STORM WATER MANAGEMENT AND DISCHARGE CONTROL".

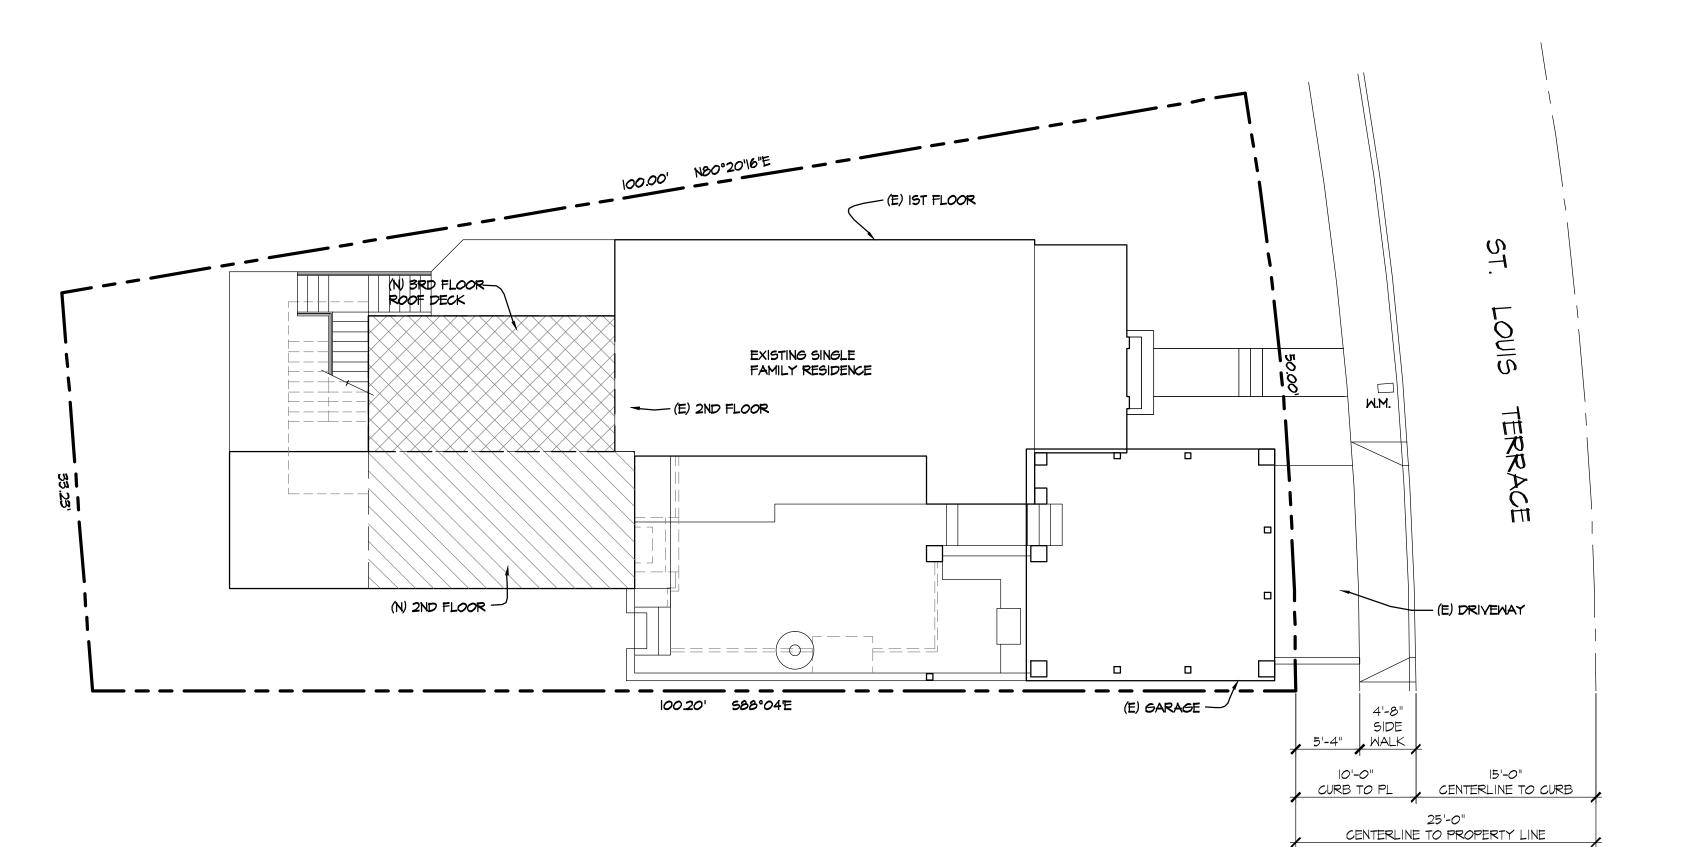

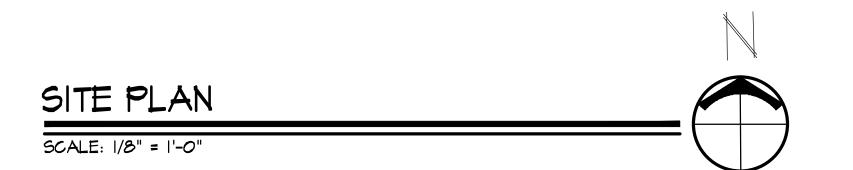

#### IMPERVIOUS AREA \$ EARTHWORK QUANTITIES

TOTAL DISTURBANCE AREA: \_\_\_ SQ. FT. EXISTING AMOUNT OF IMPERVIOUS AREA: \_\_\_ SQ. FT. PROPOSED AMOUNT OF IMPERVIOUS AREA: \_\_\_ SQ. FT. TOTAL IMPERVIOUS AREA: \_\_\_ SQ. FT.

EARTHWORK QUANTITIES: CUT QUANTITIES: O CYD FILL QUANTITIES: O CYD IMPORT/EXPORT: O CYD MAX. CUT DEPTH: O FT


THIS PROJECT PROPOSES TO EXPORT O CUBIC YARDS OF MATERIAL FROM THIS SITE. ALL EXPORT MATERIAL SHALL BE DISCHARGED TO A LEGAL DISPOSAL SITEE IN ACCORDANCE WITH THE 2015 GREENBOOK AND SUPPLEMENTAL AMMENDMENTS. THE APPROYAL OF THIS PROJECT DOES NOT ALLOW PROCESSING AND SAL OF THE MATERIAL, ALL SUCH ACTIVITIES REQUIRE A SEPARATE

IF THE BUILDING INSPECTOR SUSPECTS FILL, EXPANSIVE SOILS OR ANY GEOLOGIC INSTABILITY BASED UPON OBSERVATION OF THE FOUNDATION EXCAVATION, A SOILS OR GEOLOGICAL REPORT, AND RESUBMITTAL OF PLANS TO PLAN CHECK TO VERIFY THAT REPORT

#### NOTES

- FHPS POLICY P-00-6 (UFC 901.4.4)
- THIS PROJECT MUST COMPLY WITH THE MUNICIPAL CODE REQUIREMENTS FOR MAXIMUM HEIGHT OF THE STRUCTURE NOT TO EXCEED 30 FEET (SDMC, SECTIONS 131.0444 AND 132.0505) HIGHEST POINT ON ROOF EQUIPMENT, PIPE, VENT, ANTENNA OR OTHER PROJECTION SHALL NOT EXCEED 30 FEET ABOVE GRADE.
- EXISTING SITE DRAINAGE PATTERN TO REMAIN. NO ADDITIONAL RUNOFF TO PUBLIC RIGHT OF WAY
- FALL EXCESSIVELY ON ADJACENT PROPERTIES.
- STRUCTURES, UNPLANTED RECREATIONAL AREAS, WALKS AND DRIVEWAYS SHALL BE LANDSCAPED AND MAY INCLUDE NATIVE MATERIALS, AND IN NO CASE SHALL THIS LANDSCAPED AREA BE LESS THAN 30 PERCENT OF THE TOTAL PARCEL AREA
- STORM WATER FROM DOWNSPOUTS AND IMPERVIOUS AREAS MUST BE ROUTED TO EITHER LANDSCAPE AREAS OR PLANTER BOXES PRIOR TO REACHING THE PUBLIC DRAIN SYSTEM.

### SITE LEGEND

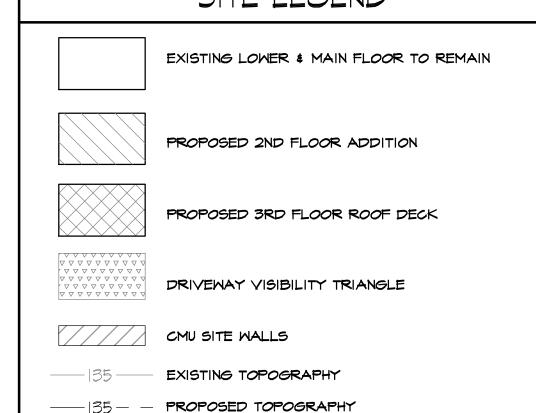

MM

WATER METER




MAX. FILL DEPTH: O FT

CONDITIONAL USE PERMIT.

RECOMMENDATIONS HAVE BEEN INCORPORATED, MAY BE REQUIRED.

- PROVIDE BUILDING ADDRESS NUMBERS VISIBLE AND LEGIBLE FRONT THE STREET OR ROAD FRONTING THE PROPERTY PER
- LIGHTING SHALL BE UNOBTRUSIVE AND SHIELDED SO AS NOT TO
- 5. ALL OF THE PROPERTY NOT USED OR OCCUPIED BY

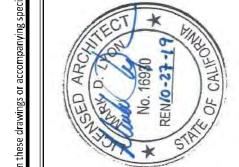

| <u>~</u> ~

REVISIONS:

SUBMITTAL DATE: 04/16/2019


CONSTRUCTION DOCUMENTS PROJECT NUMBER:


REVIEWED BY:

DRAWN BY: KLT / KJL

> PROPOSED SITE PLAN

04/15/2019

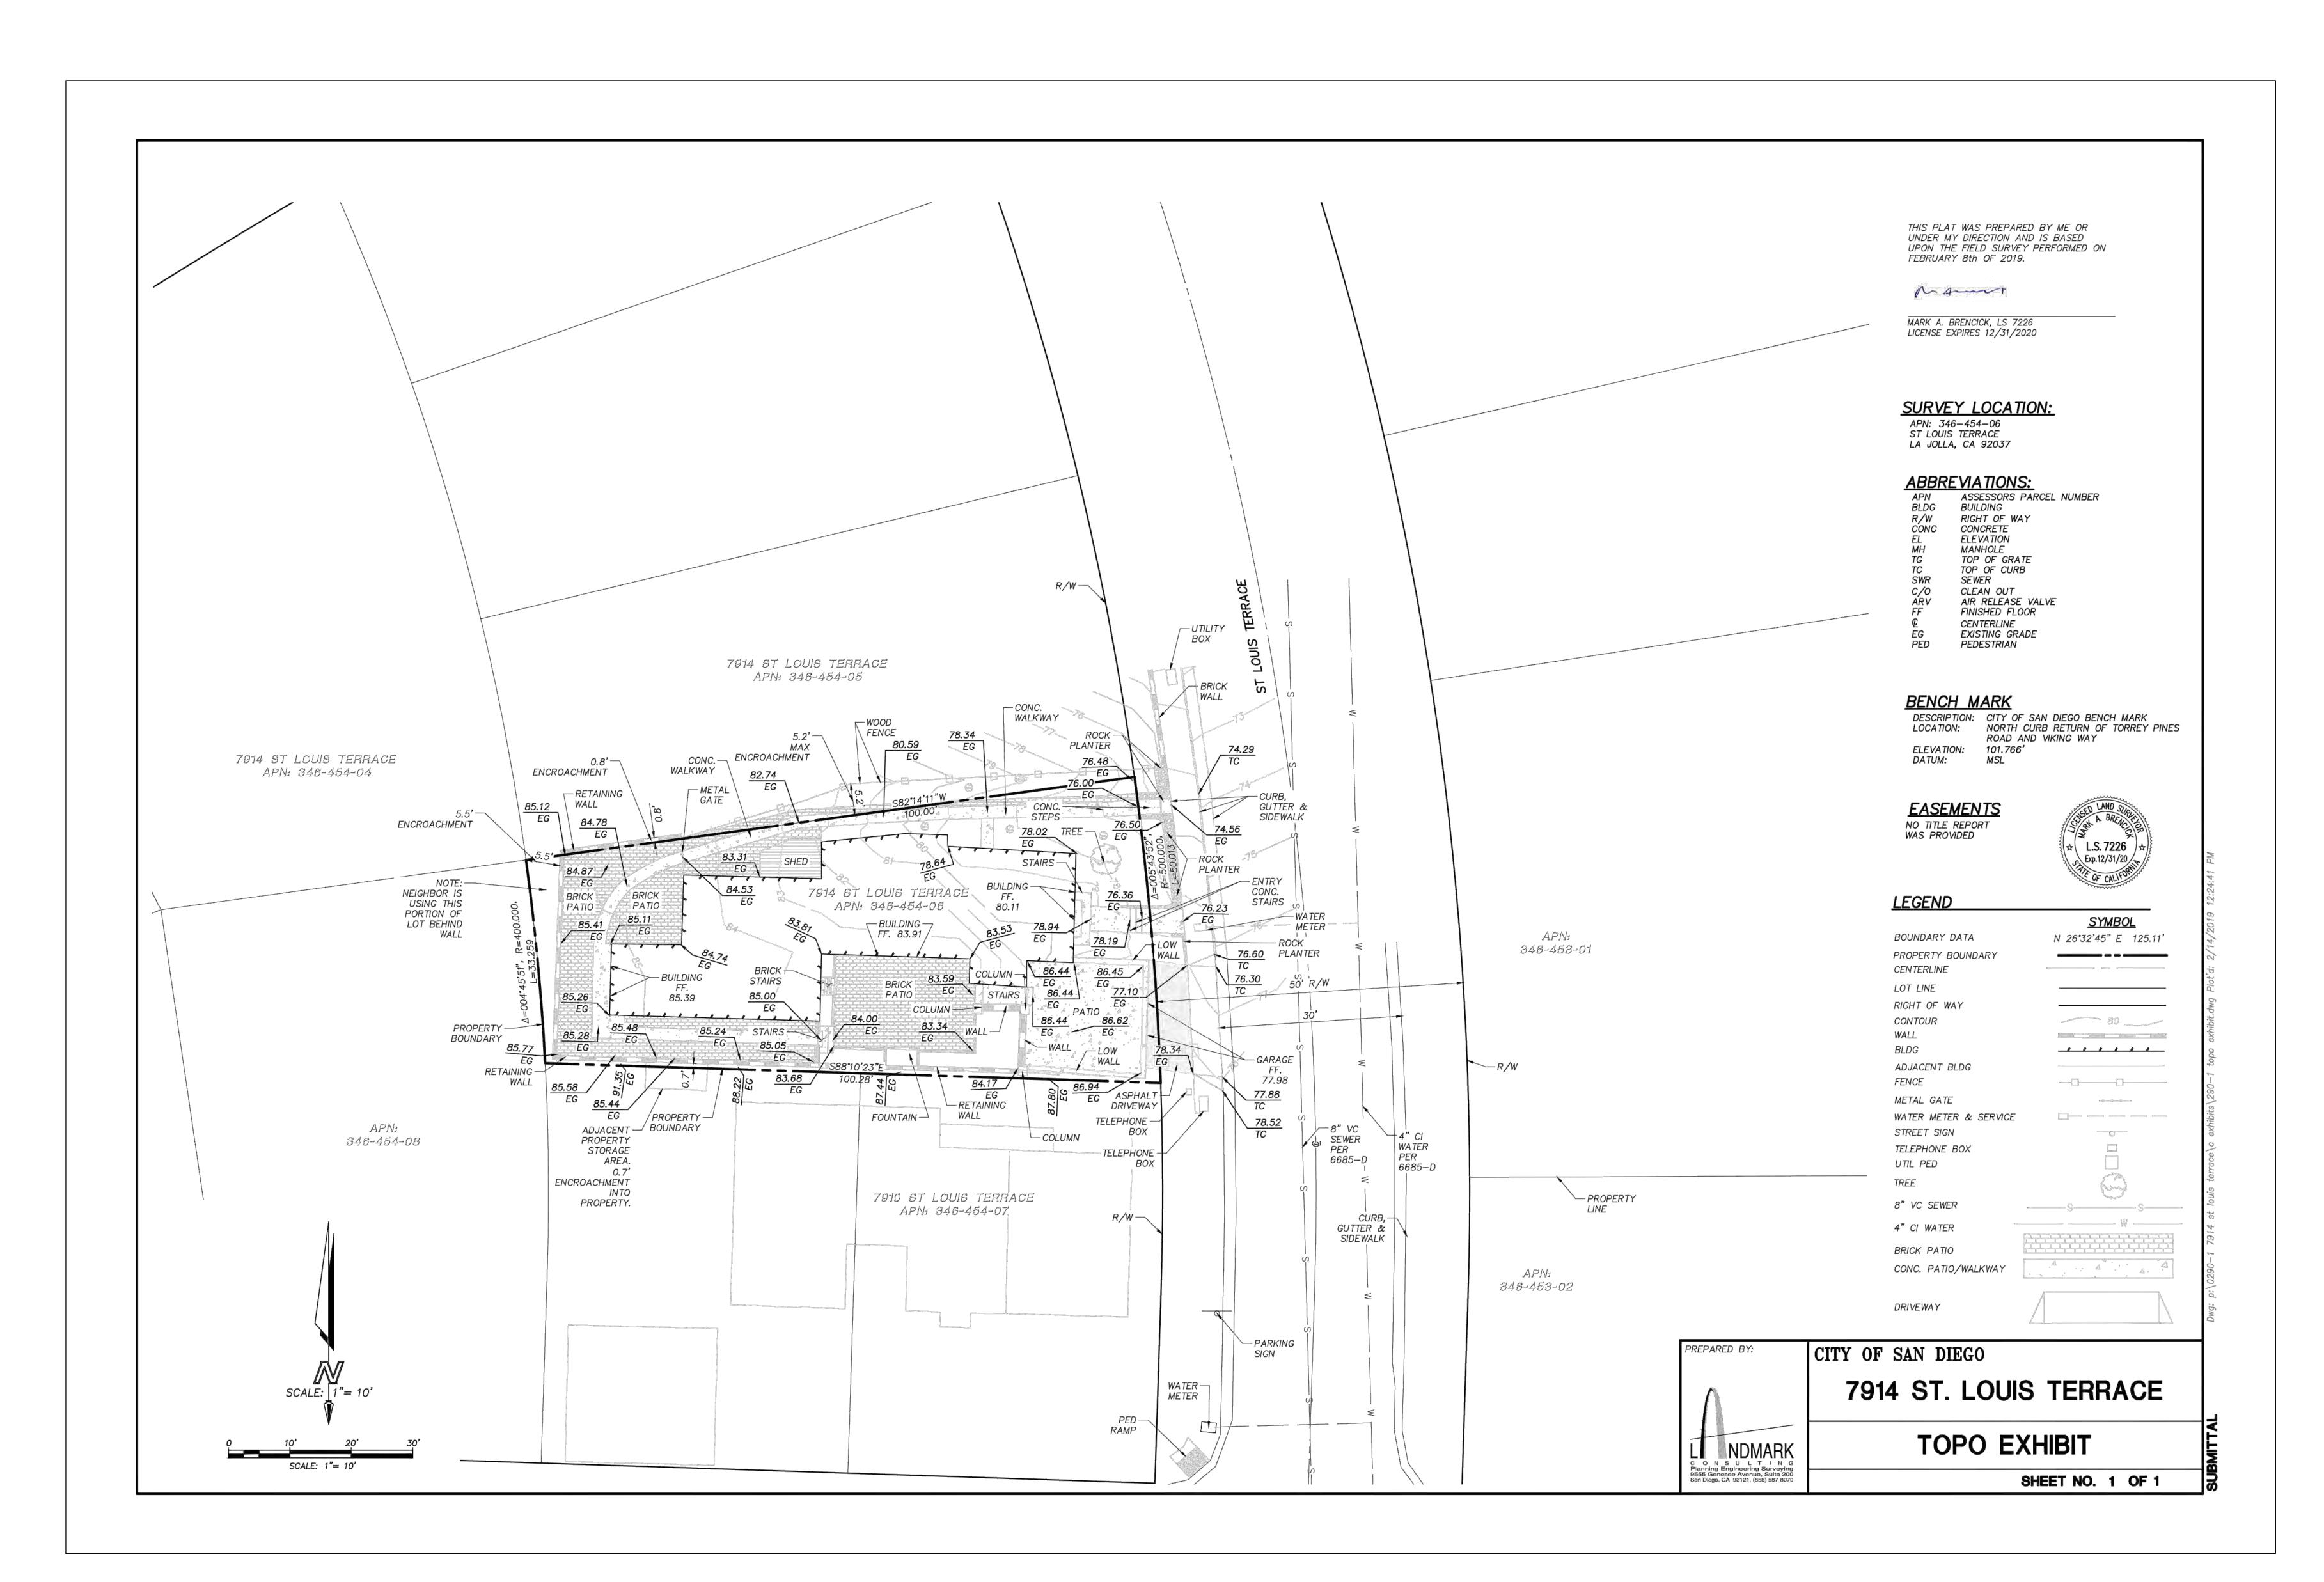

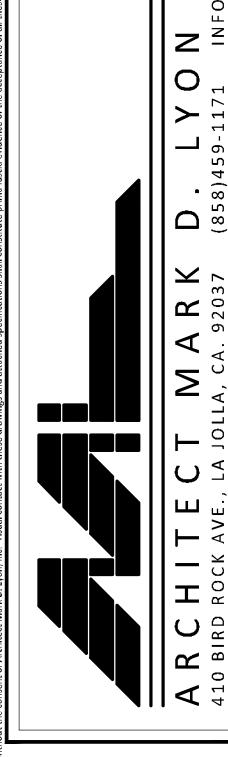



RESIDENCE 14 ST. LOUIS TERRACE A JOLLA, CA 92037

REVISIONS:

SUBMITTIAL DATE:

O4/16/2019

PHASE:

CONSTRUCTION DOCUMENTS

PROJECT NUMBER:

BROUGHOUTON DOCUMENTS

TOPOGRAPHIC SURVEY SHEET NO:


C|.|

KLT / KJL

04/15/2019

# BUSH RESIDENCE

## A CUSTOM RESIDENTIAL CONSTRUCTION DOCUMENTS PACKAGE

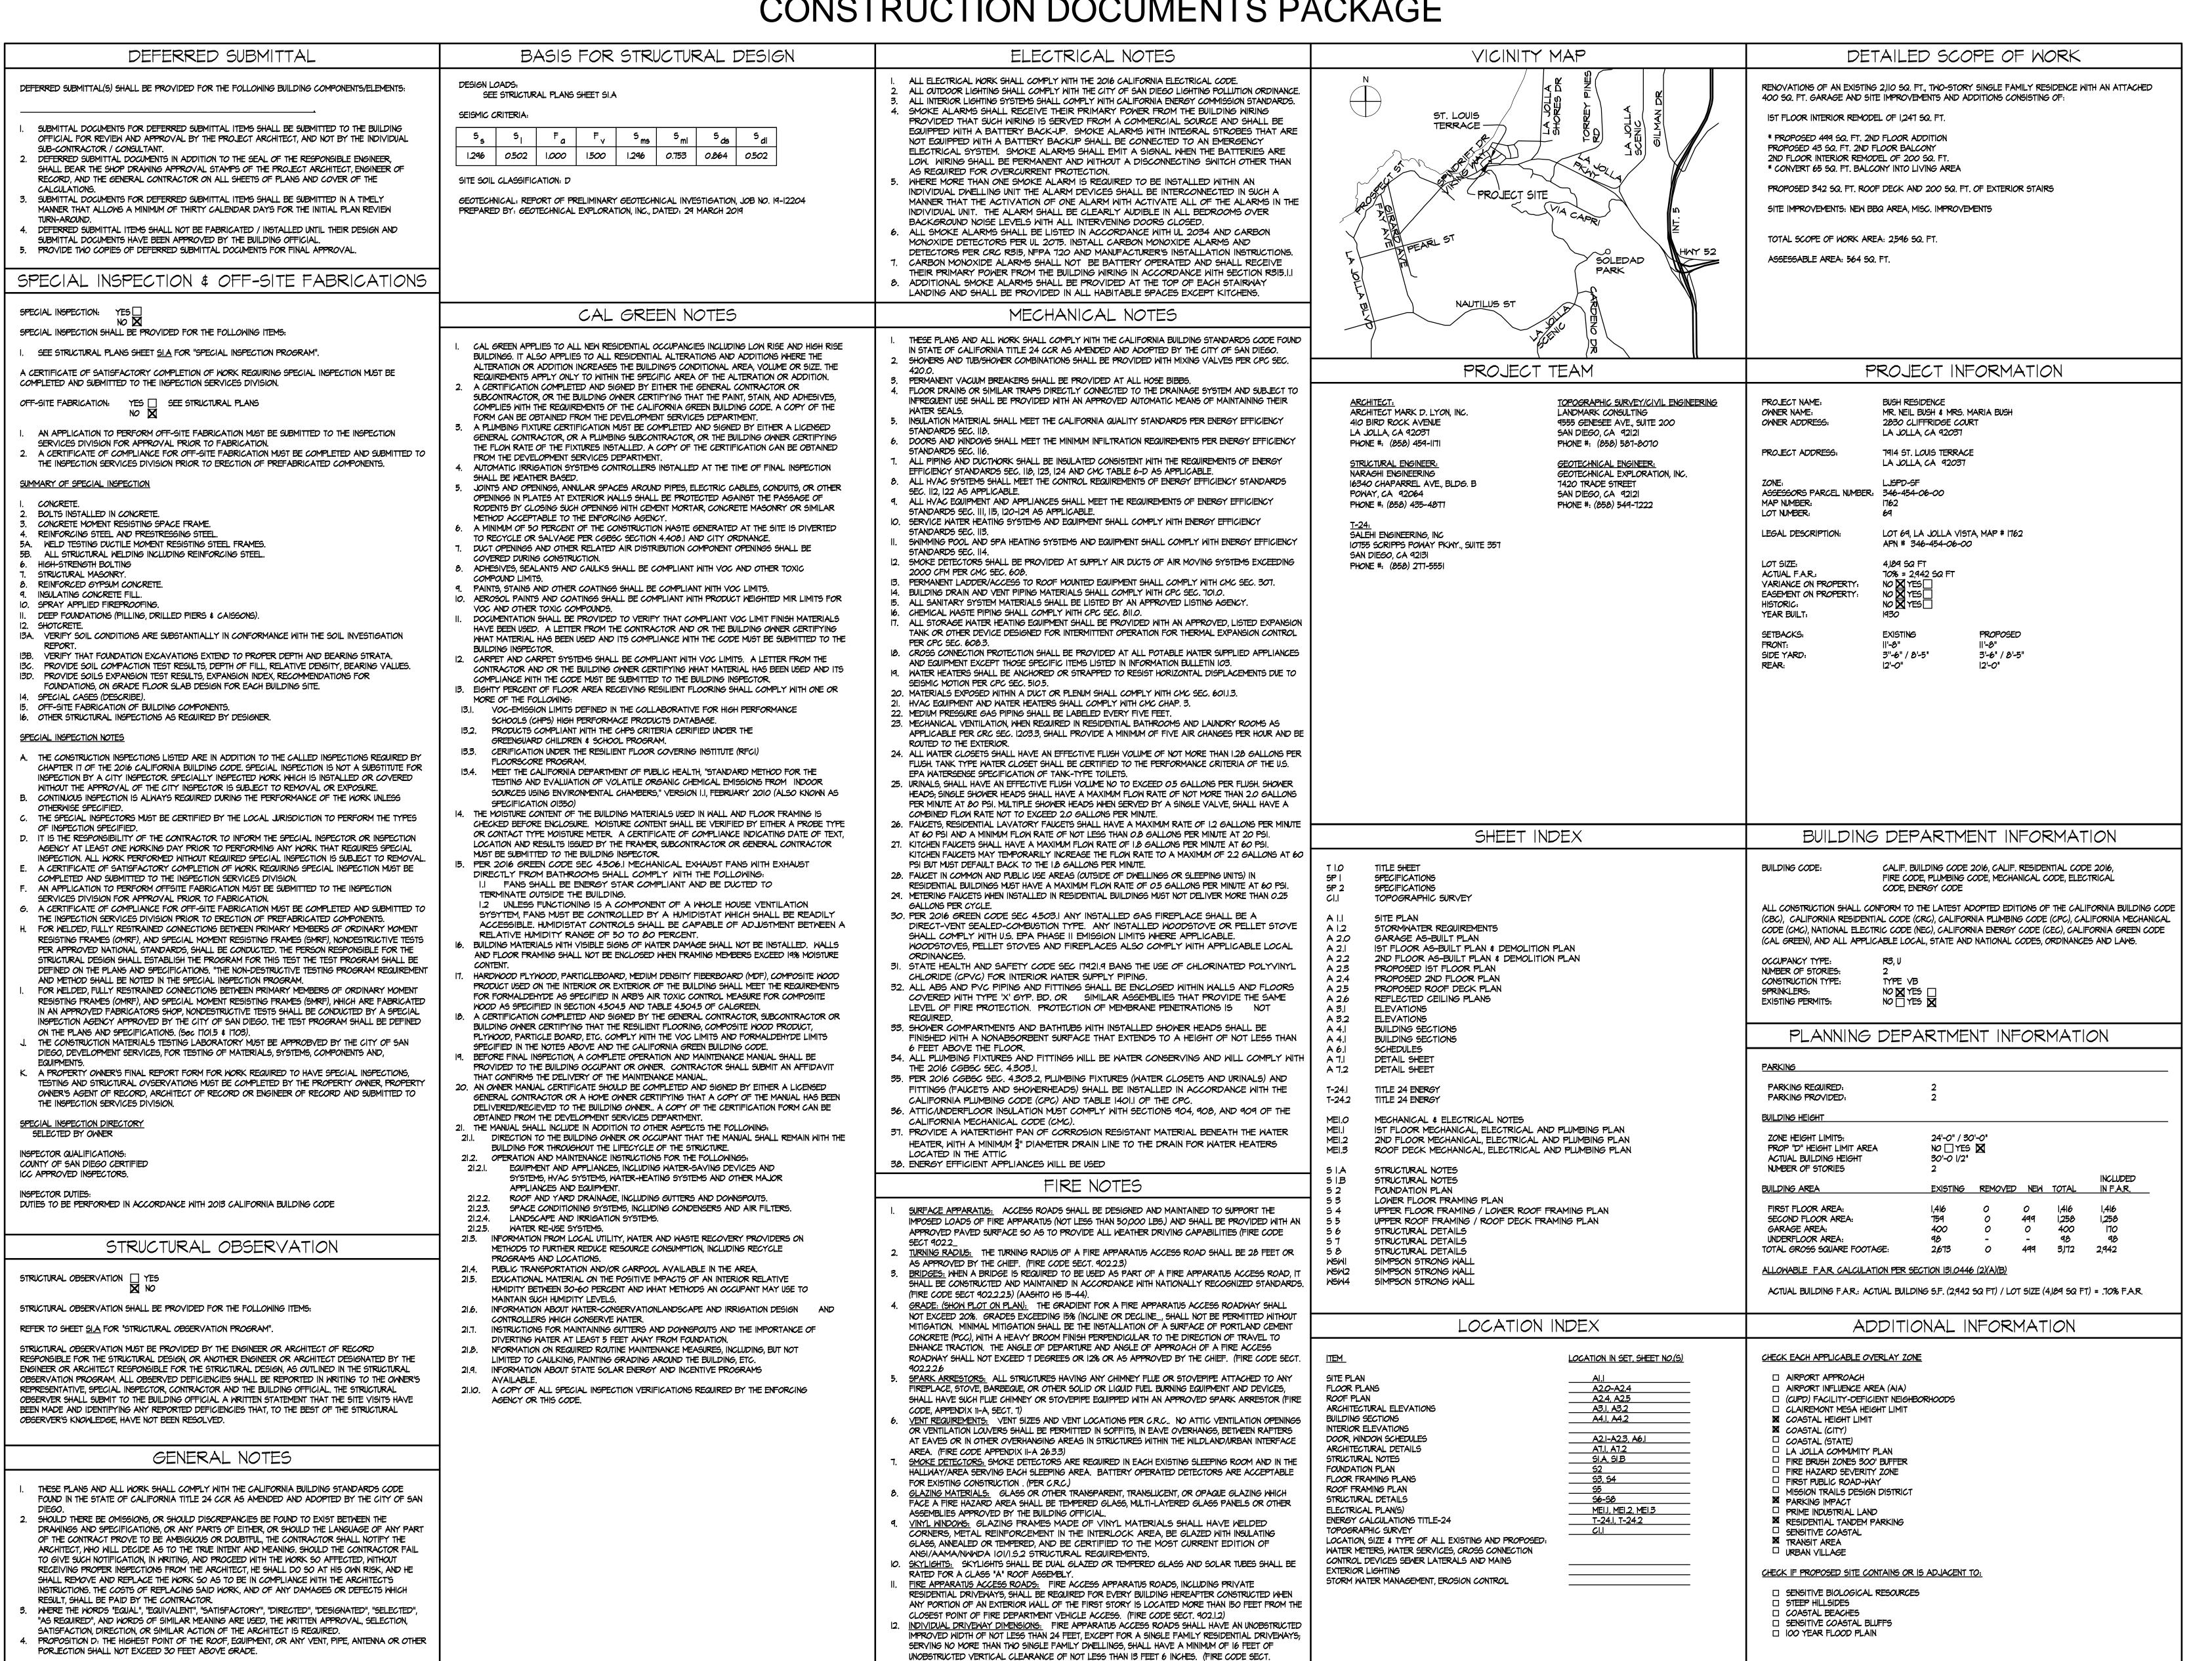

902.2.2.1)



ST. LOUIS 'JOLLA, CA

CONSTRUCTION DOCUMENTS


**REVIEWED BY** 

DRAWN BY: KLT / KJL

04/15/2019

SHEET TITLE:

SHEET NO:

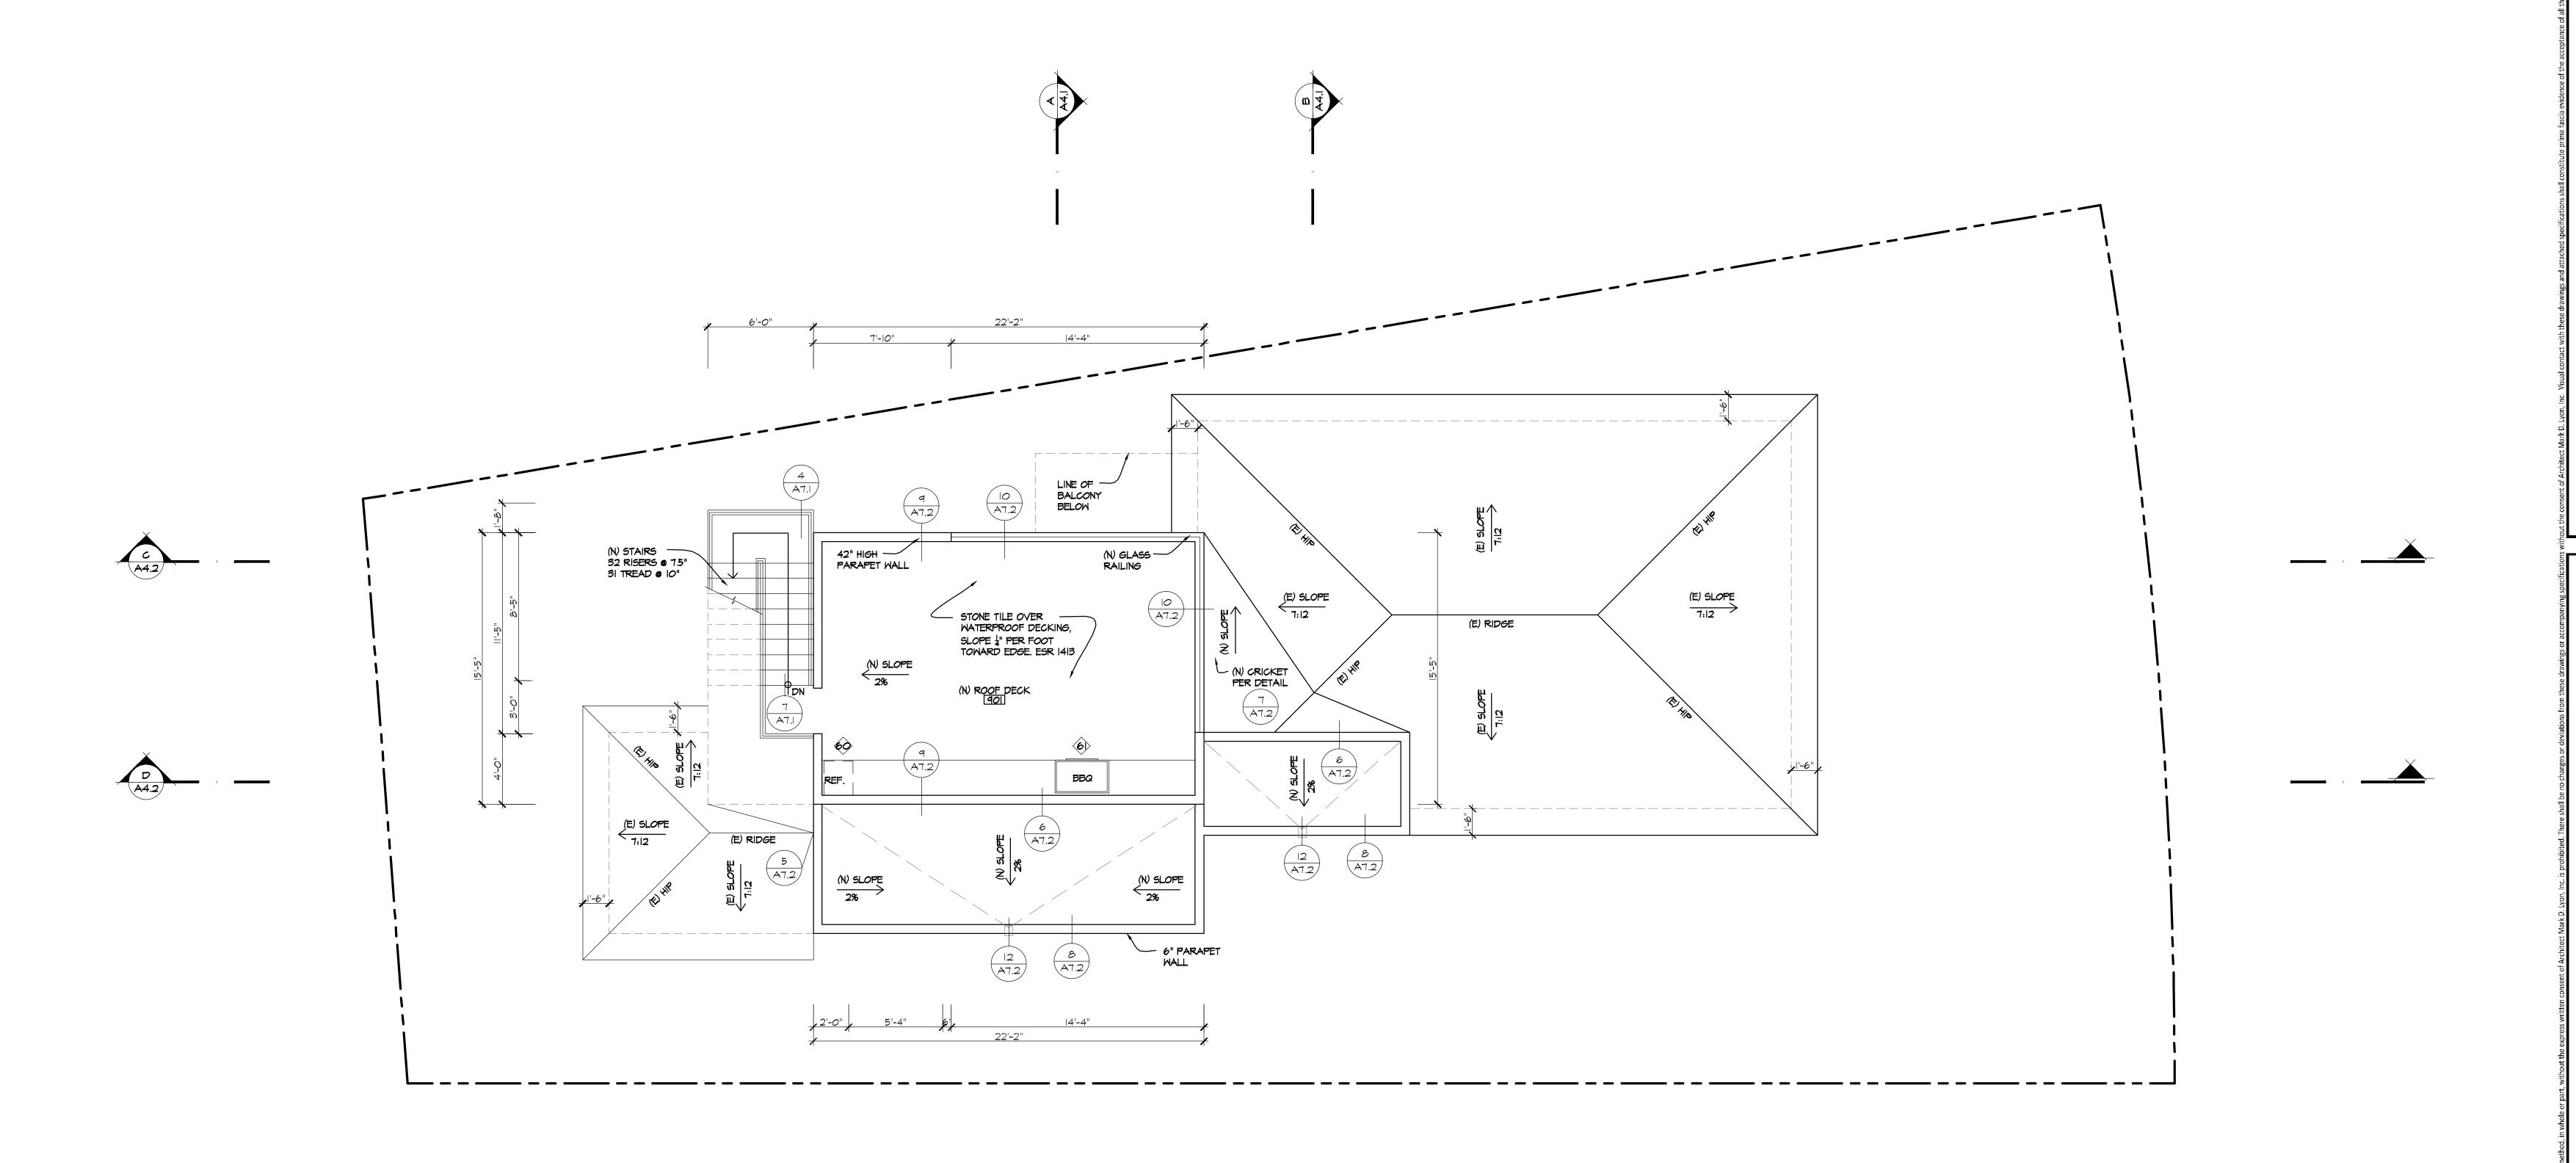

PROPOSED ROOF DECK

SCALE: 1/4"=1'-0"

<u>NOTE</u>

I.) THE HIGHEST POINT OF THE ROOF, EQUIPMENT, OR ANY VENT, PIPE, ANTENNA OR OTHER PROJECTION, SHALL NOT EXCEED SO' ABOVE GRADE.

2.) THE MAXIMUM STRUCTURE HEIGHT IN THE COASTAL OVERLAY ZONE CANNOT EXCEED 30 FEET IN HEIGHT PER SDMC SEC 131.0444 \$ 132.0505

MATERIAL SPECIFICATIONS:

GAF (OR EQUAL): MEDIUM WEIGHT ASPHALT COMPOSITION SHINGLES, COLOR BLEND BY OWNER OVER 30# ORGANIC FELT UNDERLAYMENT. PROVIDE STARTER COURSE/STRIP ICC-ES REPORT # ESR-1475. CLASS 'A' ROOFING. 40-YEAR MINIMUM WARRANTY.

GUTTERS: CONCORD SHEET METAL (OR EQUAL): COPPER RAIN GUTTERS WORLD GUTTER SYSTEM 6" HALF ROUND, 16 OZ. OR BETTER. ALL LEADERHEAD TO BE 16 OZ. STAR OUTLET 6" GUTTER. DOWNSPOUTS SHALL BE 4"Ø 18 OZ. WITH 4" MODERNE STRAPS AT 8'-0" O.C. VERTICAL.

JCCO: EXPO STUCCO (OR EQUAL): EXTERIOR COLOR COAT OVER PORTLAND CEMENT PLASTER, SEE SHEET SP.2 FOR SPECS. TEXTURE TO BE SANTA BARBARA FINISH OR PER OWNER'S SELECTION. COLOR PER OWNER.

GUARDRAIL: GLASS GUARDRAIL TO BE SELECTED BY OWNER

ARCHITECT MARK D.

A RENIO-27-19

RENIO-27-19

\*\* RENIO-27-19

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RESIDENCE
914 ST. LOUIS TERRACE

REVISIONS:

IBMITTAL DATE:

04/16/2019 PHASE:

CONSTRUCTION DOCUMENTS

PROJECT NUMBER:

REVIEWED BY:

DRAWN BY:
KLT / KJL

04/15/2019 SHEET TITLE:

PROPOSED ROOF DECK SHEET NO:

A2.5