<u>Roberts Addition / Remodel</u> La Jolla Shores Planned District Advisory Board La Jolla Recreation Center 615 Prospect Street, La Jolla CA 92037

Action Items Project number: # 613642 Name: Roberts Addition & Remodel Address: 7333 Via Capri La Jolla CA 92037 APN: 352-323-03-00

Project contact name: Manuel De La Torre 619 730-6484 e-mail: <u>delatorredesignstudio@gmail.com</u>

Project Description: Addition 102 sq. ft. to (E) Home, addition of 332 sq. ft. to (E) garage, addition of a 308 sq. ft. attached patio cover, and addition of a 432 sq. ft. detached deck and it stairs at back yard.

Use: Single Family Home **Proposed use:** Single Family Home Year built: 1966 Lot size: 14,100 sq. ft. Existing structure: 2,358 sq. ft. Proposed areas: Home Addition: 102 sq. ft. Garage Addition: 332 sq. ft. Detached Deck: 432 sq. ft. Stairs for new Deck: 139 sq. ft.

Existing height: one story Proposed height: one story

This Project has been presented to uphill neighbor as a curtesy to protect any of their existing views.

Roberts Addition

1.5 BATH, TV ROOM, GARAGE REMODEL NEW TRELLIS & DECK ADDITION

7333 VIA CAPRI LA JOLLA CA. 92037

THE CONSTRUCTION DOCUMENTS ARE INTENDED TO BE A "BUILDERS SET" OF PLANS THAT THE OWNER/CONTRACTOR SHALL RELY UPON FOR BIDDING AND CONSTRUCTION OF THE PROJECT. HOWEVER, THE CONSTRUCTION DOCUMENTS ARE NOT INTENDED TO DEPICT EACH AND EVERY DETAIL AND/OR CONDITION THAT MAY OCCUR DURING THE COURSE OF CONSTRUCTION. THE OWNER SHALL RELY UPON THE EXPERTISE OF THE GENERAL CONTRACTOR AND SUBCONTRACTORS FOR THE COMPLETE AND PROPER INSTALLATION OF MATERIALS AND PRODUCTS IN ACCORDANCE WITH INDUSTRY STANDARDS, MANUFACTURER'S RECOMMENDATIONS, AND ICBO APPROVALS, ETC.

ABBREVIATIONS

												RESIDE
A.C.I.	AMERICAN CONCRETE	C.S.I.	CONSTRUCTION SPECIFICATION	FIN FLR FIN GRD	FINISH FLOOR FINISH GRADE	JST.	JOIST LAMINATED PLASTIC	PR PREFAB	PAIR PREFABRICATED	TEL TF	TELEPHONE TOP OF FOOTING	CODE CODE,
ADDN'L.	ADDITIONAL		INSTITUTE	FL	FLOW LINE	LAW PLAS	LAUNDRY	PREFAB	POUNDS PER	TG	TOP OF FOOTING	CALIFO
ADJ	ADJACENT	СТ	CERAMIC TILE	FLASH'G	FLASHING	LAV	LAVATORY	1 51	SQUARE INCH	T& G	TOUNGE & GROOVE	STAND
A.I.A.	AMERICAN INSTITUTE	CTR	CENTER	FL BM	FLOOR BEAM	LB	POUND	PSF	POUNDS PER	THK	THICK	ADOPT
	OF ARCHITECTS	Q.	CENTER LINE	FLR	FLOOR	LIN	LINEN		SQUARE FOOT	THRESH	THRESHOLD	THE C
A.I.S.C.	AMERICAN INSTITUTE OF	CU FT	CUBIS FEET	FLUOR	FLUORESCENT	LIV RM	LIVING ROOM	PTD	PAINT (ED)	THRU	THROUGH	ALL W
	STEEL CONSTRUCTION	CU IN	CUBIC INCH	F.N.	FIELD NAIL	L.T.	LAUNDRY TRAY	PTDF	PRESSURE TREATED	T.S.	TUBE STEEL COLUMN	REQUIE
ALUM	ALUMINUM	CU YD	CUBIC YARD	FND	FOUNDATION	LUM CLG	LUMINOUS CEILING		DOUGLAS FIR	TŴ TYP	TOP OF WALL TYPICAL	ORDINA
APRV'D ARCH	APPROVED ARCHITECTURAL	DD	DECK DRAIN	FOB FOC	FACE OF BEAM	LW CONC	LIGHTWEIGHT CONC	RAD	RADIUS		UNIFORM BUILDING	on birth
A.S.T.M.	AMERICAN INSTITUTE FOR	D	DRYER	FOC	FACE OF CONCRETE FACE OF MASONRY	MAS MAT'I	MASONRY MATERIAI	RAFT	RAFTER	U.B.C.	CODE	
A.S. I.W.	TESTING MATERIALS	DBL	DOUBLE	FOS	FACE OF STUD	MATL	MAXIMUM	RAG	RETURN AIR GRILL ROOF DRAIN	U.O.N.	UNLESS OTHERWISE	
AUTO	AUTOMATIC	DET	DETAIL	FR	FRENCH	MB	MACHINE BOLT	RD RDWD	REDWOOD	0.0.14.	NOTED	
AVE	AVENUE	D.F	DOUGLAS FIR	FT	FOOT. FEET	MC	MACHINE BOLT MEDICINE CABINET	REF	REFRIGERATOR	VB	VAPOR BARRIER	
BATH	BATHROOM	DIAM	DIAMETER	FTG	FOOTING	MECH	MECHANICAL	REINE	REINFORCE (D) (ING)	VERT	VERTICAL	
BD	BOARD	DIM DIN RM	DIMENSION DINING ROOM	GA	GAUGE	MEMB	MEMBRANE	REQ'D	REQUIRED	VEST	VESTIBULE	IF THE
BEDRM	BEDROOM	DIN RM DN	DOWN	GALV	GALVANIZED	MFR	MANUFACTURE (D)	RM	ROOM	VG	VERTICAL GRAIN	OR ANY
BLDG	BUILDING BLOCK	DP&S	DOUBLE POLE	GB	GLASS BLOCK	MID	MIDDLE	RÓ	ROUGH OPENING	VNL	VINYL	THE FO
BLK BLKG	BLOCKING	Dras	AND SHELF	GFI	GROUND FAULT	MIN MISC	MINIMUM MISCELLANEOUS	R.S.	RESAWN	VT	VINYL TILE	AND RE
BM	BEAM	DR	DOOR		INTERRUPTER GALVANIZED IRON	MISC	MOUNTED	S	SINK	VTR VTW	VENT THRU ROOF VENT THRU WALL	REPORT
B.M.	BENCH MARK	DS	DOWN SPOUT	G.I.	GLASS	MTL	METAL	SCHED	SCHEDULE	Ŵ	WASHER	REQUIR
B.N.	BOUNDRY NAILING	DWG	DRAWING	GL GB	GLASS GLASS BLOCK	(N)	NEW	SECT	SECTION	w/	WITH	
BOTT	BOTTOM	D₩LS	DOWELS			NAR GRD	NATURAL GRADE	SHTG	SHEATHING	ŵć	WATER CLOSET	THE ST
BTU	BRITISH THERMAL UNIT	EA	EACH	GLB	GLUE LAMINATED BM. GRADE	NIC	NOT IN CONTRACT	SHR SIM	SHOWER SIMILAR	ŴĎ	WOOD	UNDISTU
BS	BOUNDRY STUD	E.G.	EXISTING GRADE	GRD GRD BM	GRADE BEAM	(NP)	EXISTING NON	S&P	SHELF & POLE	Ŵ.F.	WIDE FLANGE	
CAB	CABINET	EJ ELEC	EXPANSION JOINT ELECTRIC (AL)	GYP	GYPSUM	(11)	PERMITTED WORK	SP	SHEAR PANEL	W/H	WATER HEATER	
CARP	CARPET CEMENT	ELEC	ELEVATION	GYP BD	GYPSUM BOARD	NTS	NOT TO SCALE	SPEC	SPECIFICATION (S)	WI WP	WROUGHT IRON WATER PROOF	ARCHITE
CEM CJ	CONSTRUCTION JOINT	E.N.	EDGE NAIL	HB	HOSE BIBB	0.C.	ON CENTER	SQ	SQUARE	WSCT	WAINSCOAT	ARCHITE
C.J.	CEILING JOIST	ENGR	ENGINEER	HD	HOLDOWN	OD	OUTSIDE DIAMETER	SS	SELECT STRUCTURAL	WT	WEIGHT	
CLG	CEILING	EQ	EQUAL	HDR	HEADER	0.F. 0.H.	OVER FLOW DRAIN OPPOSITE HAND	STD	STANDARD	ŴŴF	WELDED WIRE FABRIC	
CLKG	CAULKING	EQUIP	EQUIPMENT	HGR	HANGER	OPNG	OPPOSITE HAND OPENING	STL	STEEL		MEEBEB MILE FRENTS	
CLOS	CLOSET	EXIST'G	EXISTING (E)	HM	HOLLOW METAL	PERF	PERFORATE (D)	STOR STRUCT	STORAGE STRUCTURAL			
CLR	CLEAR	EXT	EXTERIOR	HORIZ HR CONC	HORIZONTAL HARD ROCK	PG	PAD GRADE	S.V.	SHEET VINYL			
C.O.	CLEAN OUT	FAU FD	FORCED AIR UNIT	HR CONC	CONCRETE	PL	PLATE LINE	SYM	SYMMETRICAL			
COL	COLUMN	FD F.G.	FLOOR DRAIN FUEL GAS	нт	HEIGHT	PL.	PROPERTY LINE	TB	TOP OF BEAM			
CONC	CONCRETE	FIX GL.	FIXED GLASS	IN	INCH / INFORMATION	PLAS	PLASTER	T&B	TOP AND BOTTOM			
CONST	CONSTRUCTION	FHS	FLATHEAD SCREW	INFO	INFORMATION	PLUMB PLYWD	PLUMBING	T.O.C.	TOP OF CURB			
CONT CP	CONTINUOUS CONCRETE PIPE	FIN	FINISH (ED)	INSUL	INSULATE (D) (ION)	PLYWD PNL	PLYWOOD PANEL	TC	TRASH COMPACTOR			
0	CONCILE LIFE			INT	INTERIOR		1 ANEL					

PLANNING DEPT. TABULATION	
TOTAL LOT AREA = 0.32 ACRES = 14.100 SQ FT	0
TOTAL EXISTING RESIDENTIAL AREA	
EXISTING HOME = $2,358$ SQ.FT. (N) ADDITION = 102 SQ.FT. (N) ATTACHED PATIO COVER = 308 SQ.FT. NEW HOME AREA = $2,768$ SQ.FT.	G
NEW DETACHED DECK = 432 SQ.FT. STAIRS TO DECK = 139 SQ.FT. (E) GARAGE = 440 SQ.FT. (N) ADDITION TO GARAGE = 332 SQ.FT.	A P LI
2,790 X 100/14,100 = 19.78 % N TOTAL LOT COVERAGE	A Z
OTHER AREAS (E) LANDSCAPED = 6,722 SQ.FT. (E) HARDSCAPE = 2,411 SQ.FT. (E) DRIVEWAY = 1,598 SQ.FT. "YEAR BUILT 1966 "	T` O' L' (f
PLAN CHECK	L < N
2PIEASE RECYCLE DEMOLITION & CONSTRUCTION WASTE, ASK ABOUT P 3 CONTRACTOR SHALL COMPLY WITH ALL OSHA REQUIREMENTS. 4IF THE INSPECTOR SUSPECTS EXPANSIVE SOLL THEN, THE OWNER SHA 5 CONTRACTOR TO VERIFY EXISTING DIMENSIONS PRIOR TO COMMENCEME NECESSARY TO ACCOMMODATE WALL FINISHES & EXISTING CONDITIONS IT IS UNDERSTOOD THAT PLANS FOR THE PROJECT HAVE, AT THIS TIME, E REGULATIONS, AND THAT THE PROJECT AS A WHOLE HAS BEEN APPROVED "(CUSTOM STEEL STAIRCASE)" "WE UNDERSTAND THAT WE WILL NOT BE AUTHORIZED ANY INSPECTION OF APPROVAL OF PLANS AND OR CALCULATIONS FOR THOSE DEFERRED ITEMS	BEEN D BY
VICINITY MAP	
RUE DE ANNE RUE DE ANNE SITE SITE NILS CODES IN EFFECT	AR SI SI SI SI SI SI SI SI SI SI SI SI SI
THIS PROJECT WILL COMPLY WITH 2016 EDITION OF THE CALIFORNIA BUILDING STANDARDS CODES, 2016 CALIFORNIA RESIDENTIAL CODE (CRC), 2016 CALIFORNIA MECHANICAL CODE (BASED ON 2009 UMC), 2016 CALIFORNIA PLUMBING CODE, 2016 CALIFORNIA LECTRICAL CODE AND 2016 CALIFORNIA FIRE CODE, 2016 CALIFORNIA GREEN BUILDING STANDARDS CODE, 2016 CALIFORNIA ENERGY CODE, AS ADOPTED AND AMENDED BY THE STATE OF CALIFORNIA AND THE CITY OF SAN DIEGO	AD OP EXI
THE OTT OF SAM DIEGO	BA

ALL WORK AND MATERIALS SHALL COMPLY WITH THE REQUIREMENTS OF THESE CODES AND ALL APPLICABLE LOCAL ORDINANCES.


NOTES


IF THE BUILDING INSPECTOR SUSPECTS FILL, EXPANSIVE SOILS OR ANY GEOLOGIC INSTABILITY BASED UPON OBSERVATION OF THE FOUNDATION EXCAVATION, A SOILS OR GEOLOGICAL REPORT, AND RESUBMITTAL OF PLANS TO PLAN CHECK TO VERIFY THAT REPORT RECOMMENDATIONS HAVE BEEN INCORPORATED, MAY BE REQUIRED.


THE STRUCTURE(S) WILL BE LOCATED ENTIRELY ON UNDISTURBED NATIVE SOIL

OWNER / LICENSED ENGINEER OR CHITECT.

PROJECT I	NFORMATION	APPLICANT ONL'	<i>(</i>	
OWNER	EARL & FABIOLA ROBERTS 7333 VIA CAPRI LA JOLLA SAN DIEGO CA 92037 MANUEL DE LA TORRE 707 EASTSHORE TER UNIT 25 CHULA VISTA CA., 91913 delateracionactudigement			
GOVERNING AGENCIES	delatorredesignstudio@gmail.com o . 619 . 730 . 6484 SAN DIEGO		del	
PROJECT ADDRESS LEGAL DESCRIPTION A.P.N. ZONE TYPE OF CONSTRUCTION OCUPANCY GROUP	7333 VIA CAPRI LA JOLLA CA 92037 LOT 62 TR3926 352–323–03–00 LJSPD – SF V–B R–3/U		atorredesignstudio@gmoil	
LOT AREA (E) HOME FULLY SPRINKLED	0.32 ACRES NO	II.com		
NOTES			De La Torre	
I TO THE PROPERTY LINE & NO SSIBLE DUMP SITES. BE REQUIRED TO PROVIDE AN T OF ANY WORK, CONTRACTO EN REVIEWED FOR COMPLIANCE BY THE CITY, WITH THE EXCEPT THE DEFERRED ITEMS PROPOSED	Chula Vista CA 91913 delatorredeginstudio@ymail.com 619,730.6484 REVISIONS A			
SHEF	ET INDEX	Δ		
SHEET NO. DESCRIP		Δ		
SHEET A-T TITLE SH SHEET A-00 SITE PLAN SHEET A-01 EXISTING F SHEET A-02 NEW FLOOI SHEET A-03 SHEET A-04 NORTH K NORTH	WEST ELEVATION (E) & PROPOSED DUTH ELEVATION (E) & PROPOSED		18 2018	
SHEET A-07 (N) ELECTI SHEET A-08 DEMOLITIO SHEET A-09 FENESTRA' SHEET A-10 DETACHED SHEET A-11 CAL. GREE SHEET A-12 CAL. GREE	RICAL			
SHEET S-1 FOUNDATIC SHEET S-2 FRAMING SHEET S-3 FRAMING SHEET SD-1 STRUCTUR	AL DETAILS AL DETAILS	SHEET TITLE:		
PROJECT	DESCRIPTION			
ADDITION TO (E) HOME OF A OPEN BEAM TRELLIS. EXISTING GARAGE SQ, FT. ADD BATHROOM AND STORAGE ARE ADDITION OF A NEW 432 SQ. TALL WOOD RETAINING WALL V		037		
STORM WATE	R QUALITY NOTES	ST	CA 92	
CONSTRUCTION BMP'S This project shall comply with a Permit; California Regional Water San Diego Municipal Storm Water Development Code, and the Stor represent key minimum requirem 1. The contractor shall be res adjacent street(s), due to const activity, at the end of each wor a breech in installed construction Water Quality within any street (required to prevent construction silt onto the street. 2. All stockpiles of soil &/or bu	owners: ROBERTS	PROJECT: HOME REMODEL 7333 VIA CAPRI LA JOLLA CA 92037		
for a period greater than 7 calendar days are to be covered. All removable BMP devices shall be in place at the end of each working day when 5 day rain probability forecast exceeds 40%. 3. A concrete washout shall be provided on all projects which propose the construction of any concrete improvements which are to be poured in place on site. 4. The contractor shall restore all erosion/sediment control devices to working order after each run-off producing rainfall or after any material breach in effectiveness. 5. All slopes that are created or disturbed by construction activity must be protected against erosion and sediment transport at all times. 6. The storage of all construction materials and equipment must be protected against any potential release of pollutants into the environment. Updated 09/09/2015				

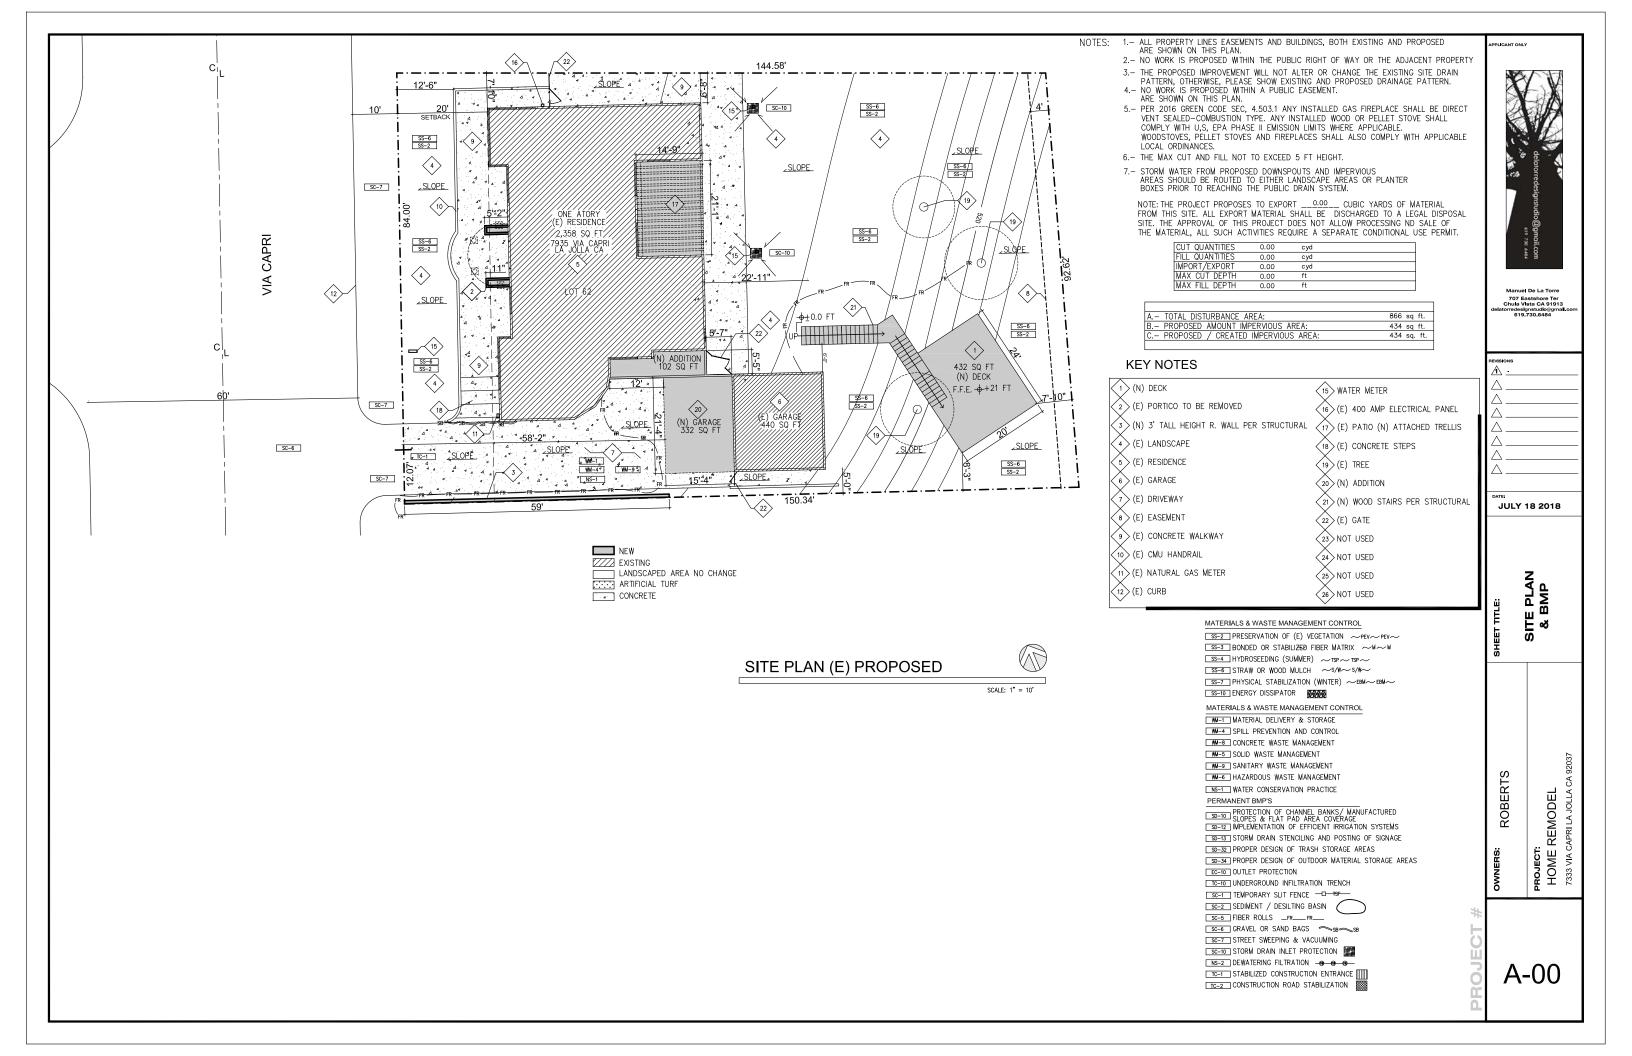

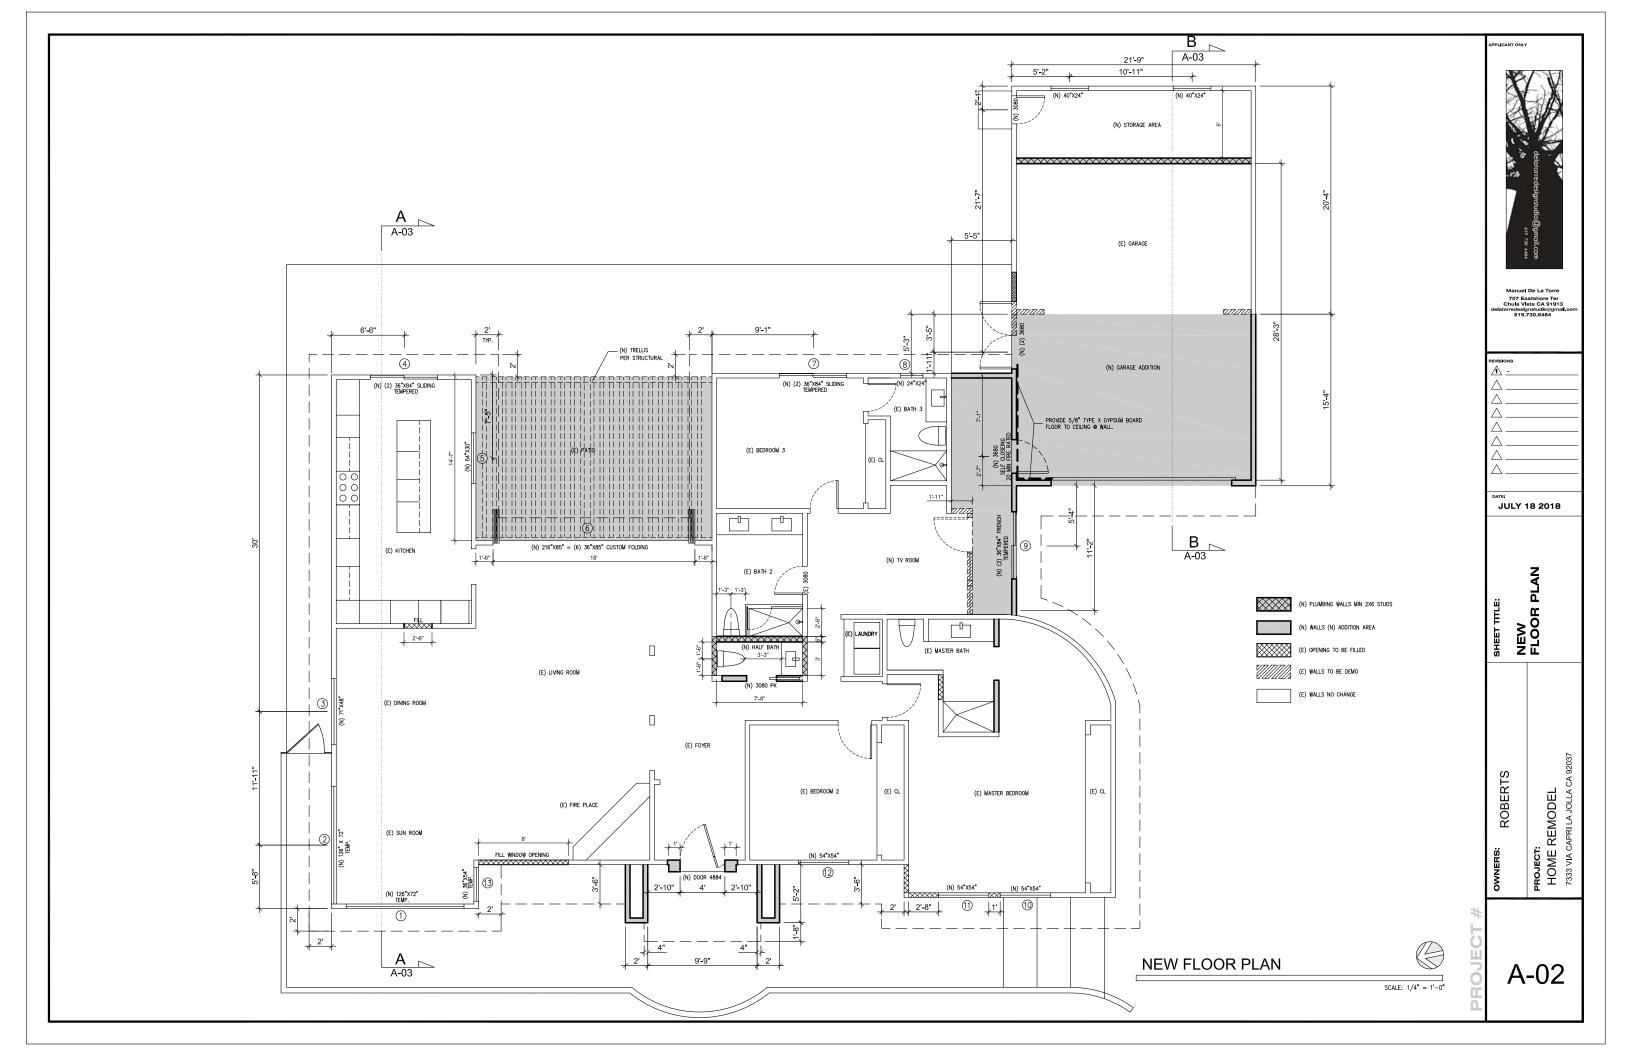

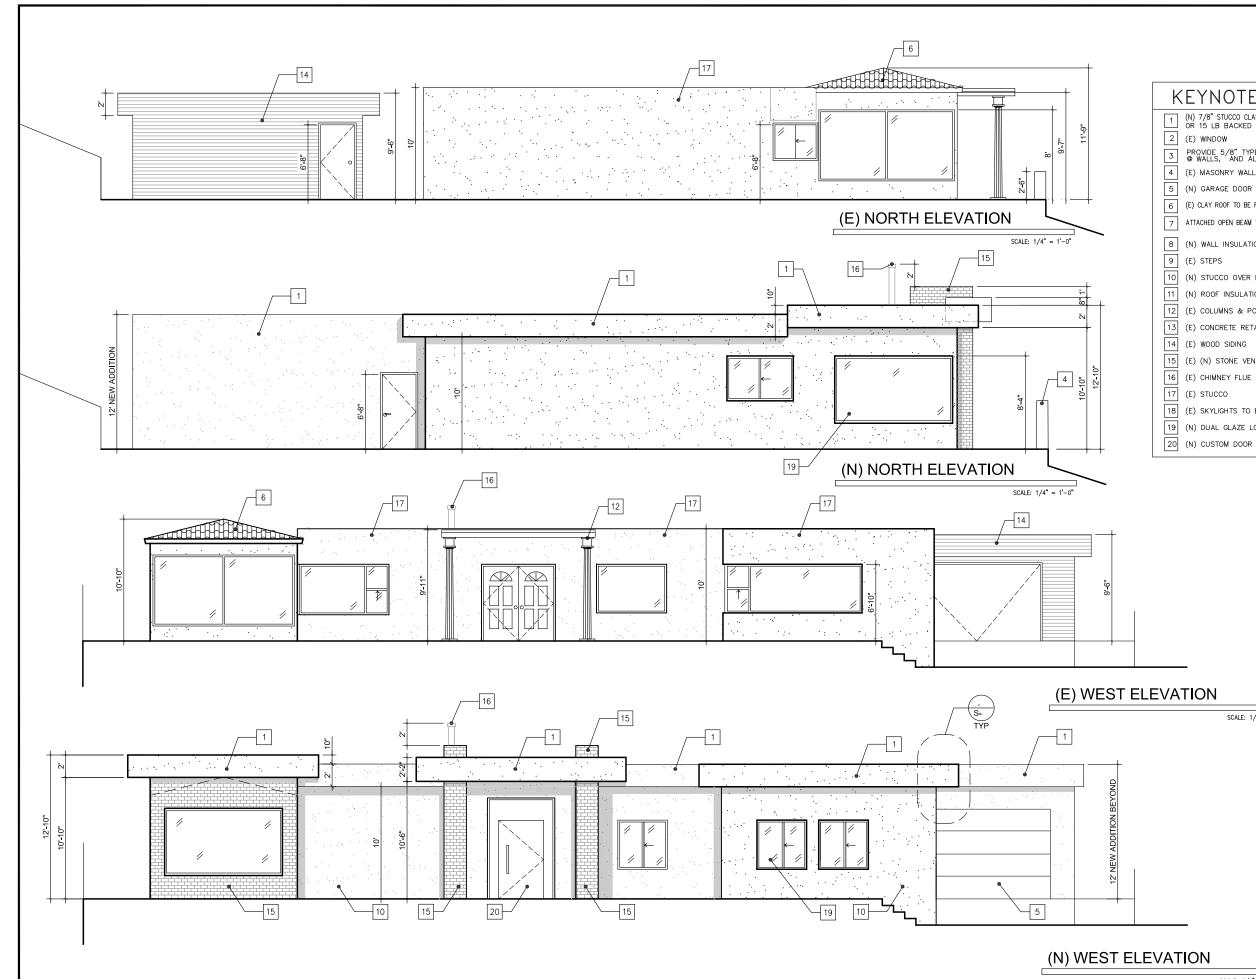



KEYNOTES

1	(N) 7/8" STUCCO CLASS "A" W/ 2 LAYERS OF GRADE "D" PAPER OR 15 LB BACKED GALV. METAL LATH. – COLOR TO MATCH (E)
2	(E) WINDOW
3	PROVIDE 5/8" TYPE X GYPSUM BOARD FLOOR TO CEILING © WALLS, AND ALL CEILING
4	(E) MASONRY WALL TO BE UPDATED TO 42" TALL
5	(N) GARAGE DOOR
6	(E) CLAY ROOF TO BE REMOVED
7	ATTACHED OPEN BEAM TRELLIS PER STRUCTURAL PLAN
8	(N) WALL INSULATION PER T-24 R-13
9	(E) STEPS
10	(N) STUCCO OVER EXISTING STUCCO
11	(N) ROOF INSULATION PER T-24 R-30
12	(E) COLUMNS & PORCH TO BE REMOVED
13	(E) CONCRETE RETAINING WALL
14	(E) WOOD SIDING
15	(E) (N) STONE VENEER, MODEL PER OWNER
16	(E) CHIMNEY FLUE $W/$ APPROVED SPARK ARRESTOR
17	(E) STUCCO
18	(E) SKYLIGHTS TO BE REMOVED
19	(N) DUAL GLAZE LOW E WIDOWS & DOORS
20	(N) CUSTOM DOOR

SCALE: 1/4" = 1'-0"

SCALE: 1/4" = 1'-0"

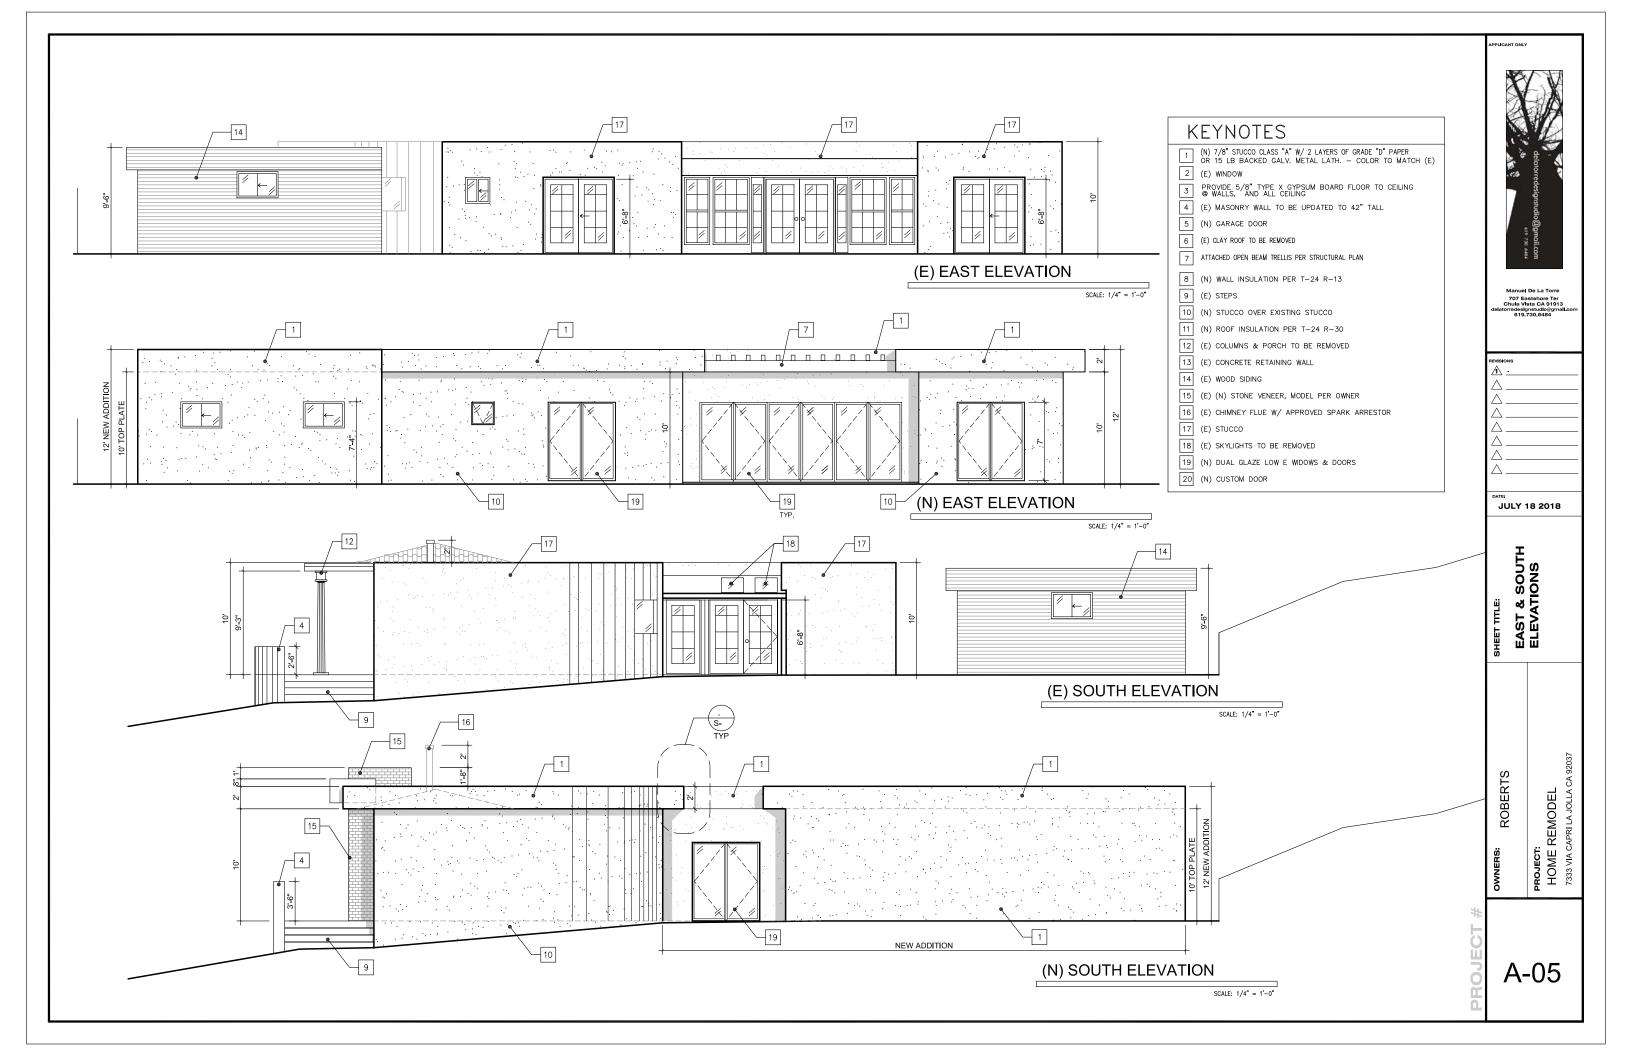

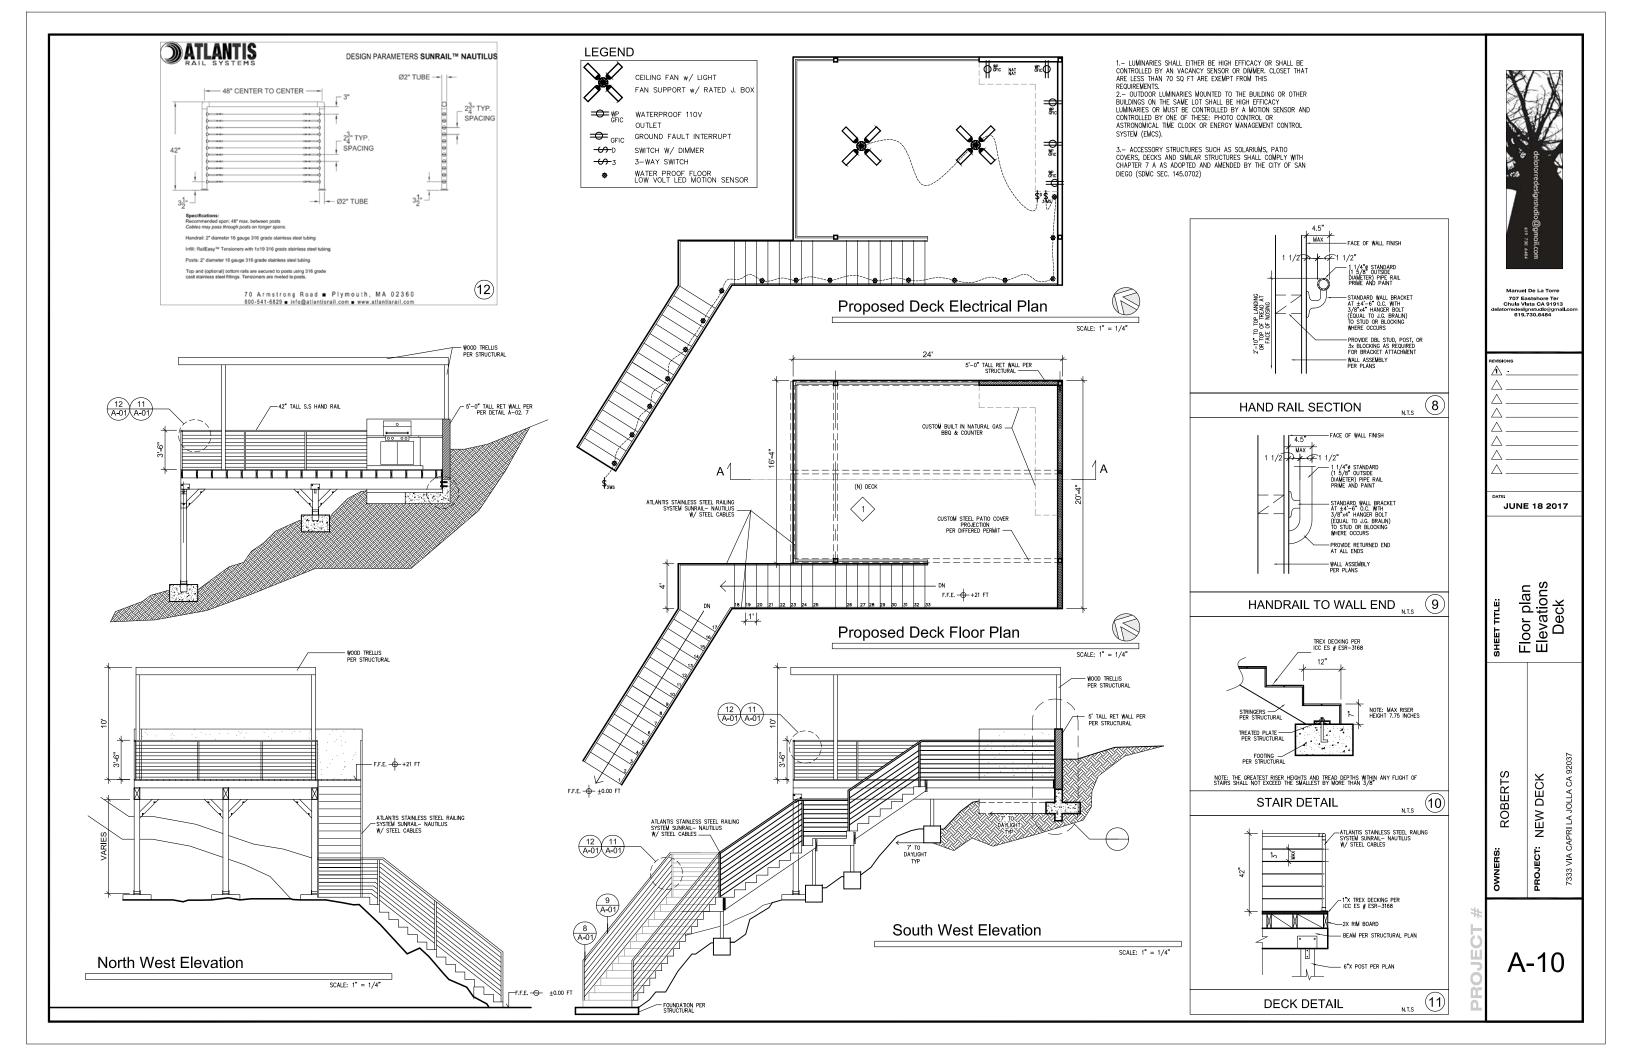



Proposed Front Elevation





Proposed Driveway Garage









