#### La Jolla Shores Planned District Advisory Board La Jolla Recreation Center 615 Prospect Street, La Jolla CA 92037

Please provide the following information on this form for calendaring your project on an upcoming La Jolla Shores Planned District Advisory Board meeting.

#### For Action Items

- Project PTS number from Development Services and project name (only submitted projects can be heard as action items):
   PN # 638504
   SINNETT HOUSE
- Address and APN(s): 2365 VIA SIENA, LA JOUR 352-165-04-00
- · Project contact name, phone, e-mail: SCOTT SINNETT, 951-235.9223, SRSINNETT (DEMAIL
- · Project description: REMODEL EXISTING, ADD APPROX 2,500 SQ PT., NEW GARAGE
- In addition, provide the following:
  - o lot size: 12, 345
  - o existing structure square footage and FAR (if applicable): EXISTING 1684 / FAR = 14%
  - o proposed square footage and FAR: 4274 / FAR 35%
  - o existing and proposed setbacks on all sides: FRONT 20', ALL OTHERS 10'
  - o height if greater than 1-story (above ground): SINGLE STORY

#### For Information Items

- Project name (Unsubmitted projects can be informational items if the development team is seeking comments and direction from the Trustees on the concept):
- Address and APN(s): \_\_\_\_\_\_
- Project description:

  In addition to the project description, please provide the following:
- In addition to the project description, please provide the following:
  - o existing structure square footage and FAR (if applicable): \_\_\_\_\_
  - existing structure square footage and FAR (if applicable): \_\_\_\_
     proposed square footage and FAR: \_\_\_\_
  - o existing and proposed setbacks on all sides: \_\_\_\_
  - o height if greater than 1-story (above ground): \_\_\_\_\_
- Project aspect(s) that the applicant team is seeking Trustee direction on. (community character, aesthetics, design features, etc.):

#### Exhibits and other materials to provide:

Exhibits and other project-related presentation materials (e.g. site plan, elevations, exhibits showing addition/remodel areas, etc.) although not required, are extremely helpful in informing the Advisory Board's review and understanding of a project. The following exhibits and materials are recommended and if provided by the applicant, will be attached to the agenda and posted to the City's website for view by the public:

- All exhibits should be sized to 8 ½" X 11" format
- Exhibits, which can contain the following:
  - A. A site plan showing the street, the property line on all sides, the setbacks on all sides, and the setbacks from the property lines to the neighboring building;

GANG PS

JIA EMAIL

#### (CONTINUED ON THE NEXT PAGE)

- B. Elevations for all sides;
- C. If the proposal is for a remodel, a clear delineation of what part of the proposed structure is new construction
- D. If the proposal is for a building with more than one story, show:
  - how the upper story sits on the story beneath it (setback of the upper story from the lower story);
  - > the distance from the proposed upper story to comparable stories of the neighboring buildings; and
  - > the height of neighboring buildings compared to the proposed structure's height.
- Any surveys that indicate similarities in floor area or architectural style in the surrounding neighborhood PHOTO'S AND EXCEL SHOWING SIMILARITIES
- Any communications from adjacent neighbors, local neighborhood groups, and/or the Homeowners' Association SPOKE WOOR NEIGHBORS AT 2342 PUE DE ANNE AND THEY HAVE GIVEN THEIR SUPPORT ON 6/15/20 AT LISPRE.

  Meeting Presentation NO COMMENTS FROM OTHER SURPOUNDING NEIGHBORS

  Due to COVID-19, the La Jolla Shores Planned District Advisory Group meetings will be conducted as online virtual meetings utilizing Microsoft Teams. Staff will provide all applicants meeting appointments and instructions for logging in and participating in the meeting.

In addition to the exhibits provided, the applicant may choose to provide a concise powerpoint presentation on their project or indicate that they will use the exhibits provided as their presentation – which staff can place into a powerpoint presentation. All information for the agenda and any presentations will need to be provided in advance, so that staff may include it in the agenda distribution and have it available for public comment. All public comment will be based on the project information provided prior to the meeting and submitted to staff to be read into the record during public comment for each project.

Prior to the meeting, staff will provide the presentation in advance so that the applicant can note the order of slides for reference during the presentation. At the meeting, staff will be running the presentation and the applicant will be speaking and directing staff to advance the slides in the presentation.

#### PLEASE DO NOT PROVIDE THE FOLLOWING:

- The complete plan set of the project. Complete plan sets take up a lot of memory to distribute and most of the information is not necessary for the Advisory Board's review.
- Plans or exhibits of the interior of the project. Interiors are not reviewed by the Advisory Board.
- Personal contact information of the property owners of the project should not be included, unless they are the "owner/applicant" and they are the designated point of contact

The Trustees are very keen to know that the neighbors in the immediate vicinity have been noticed and their views noted. Community conformity, setbacks, FAR, parking, view corridors, bulk & scale, and articulation are key discussion points on all projects. Action Items will be heard first.



1. CONTRACTOR SHALL VERIFY ALL DIMENSIONS (INCLUDING SETBACKS & ROOF PITCH) PRIOR TO STARTING.

2. ALL DIMENSIONS ARE TO NOMINAL ROUGH FRAMING.

3. ALL WORK SHALL COMPLY WITH THE 2019 CALIFORNIA RESIDENTIAL CODE (CRC) AND WHEN APPLICABLE, THE 2019 CALIFORNIA BUILDING CODE. PROJECT SHALL COMPLY WITH THE FOLLOWING CODES: 2019 CALIFORNIA RESIDENTIAL CODE, 2019 CALIFORNIA ELECTRICAL CODE, 2019 CALIFORNIA GREEN CODE, 2019 CALIFORNIA MECHANICAL CODE, 2019 CALIFORNIA

CODE, 2019 CALIFORNIA PLUMBING CODE, 2019 CALIFORNIA BUILDING ENERGY EFFICIENCY STANDARDS, 2019 CALIFORNIA BUILDING CODE, AND THE 2019 CALIFORNIA

4. NO TRANSIT STOPS EXIST NEAR PROPERTY.

WATER CLOSETS SHALL HAVE A MAXIMUM FLOW OF 1.28 GALLONS PER FLUSH (GPF). 6. SHOWERHEADS SHALL HAVE A MAXIMUM 2.0 GPM FLOW. LAVATORY FAUCETS SHALL HAVE A MAXIMUM 1.5 GPM FLOW AND KITCHEN FAUCETS SHALL HAVE A MAXIMUM 1.8 GPM FLO.

10. ATTIC VENT OPENINGS SHALL BE COVERED WITH CORROSION RESISTANT WIRE MESH WITH MESH OPENINGS OF NOT LESS THAN 1/16-INCH AND NOT MORE THAN 1/8-INCH IN

13. ALL NEW GLAZING (FENESTRATIONS) WILL BE INSTALLED WITH A CERTIFYING LABEL

ATTACHED, SHOWING U-VALUE.

CHLORIDE (CPVC) & CROSSLINKED POLYETHELYN (PEX) FOR INTERIOR WATER-SUPPLY

15. ALL BEDROOM ELECTRICAL OUTLETS MUST BE PROTECTED BY ARC FAULT CIRCUIT INTERUPTERS (AFCI).

16. PERMANENTLY WIRED CARBON MONOXIDE ALARM WITH BATTERY BACK UP WILL BE INSTALLED ACCORDING TO THE 2016 CRC, SECTION 315.

DIRECTED INTO LANDSCAPE AREAS WHERE FEASIBLE.

18. THE HIGHEST POINT OF THE ROOF, EQUIPMENT, OR ANY VENT PIPE, ANTENNA OR OTHER PROJECTION SHALL NOT EXCEED 30 FEET ABOVE THE REFERENCE DATUM ESTABLISHED

19. PRIOR TO THE ISSUANCE OF ANY CONSTRUCTION PERMITS, THE OWNER/PERMITEE SHALL SHALL INCORPERATE ANY CONSTRUCTION 'BEST MANAGEMENT PRACTICES" NECESSARY TO COMPLY WITH CHAPER 14, ARTICLE 2, DIVISION 1 (GRADING REGULATIONS) OF THE

ADJACENT PUBLIC RIGHT-OF-WAY SHALL NOT EXCEED 36 INCHES IN HEIGHT, MEASURED FROM THE LOWEST GRADE ABUTTING THE PLANT MATERIAL TO THE TOP OF THE PLANT MATERIAL.

2365 VIA SIENA EXIST. 8" VC SEWER PER DWG 5647-D EXIST. 8" AC WATER PER DWG 5432-D NEW 1" WATER METER \ WITH NEW 1" SERVICE **CLOSE EXISTING** 10' DRIVEWAY EXISTING FENCING IS -SCREENING NEIGHBOR FROM PARKING AREA PROPOSED ADDITION < PROPOSED LANAI \ \\_\_\_\_\_**\_\_** INTO LANDSCAPING PROPOSED ROOF DECK -

-PROPOSED GARAGE CONVERSION PROPOSED BREEZEWAY \_\_\_\_\_

PROPOSED LANAI

F.F.E. 476.96

, KILL EXIST. 3/4" WATER

METER AND 3/4" SERVICE

PROPOSED 12'-0" DRIVEWAY

➤ VISABILTY TRIANGLE

NO STRUCTURES OVER

/EXIST. 4" SEWER LATERAL

→ 36" HIGH MAX, WALL

WITHIN FRONT SETBACK

∠DRAIN CHANNEL GRATE TO

SUMP PUMP TO LANDSCAPING

-PROPOSED BASEMENT GARAGE

-ROOF DOWNSPOUT INTO LANDSCAPING

\EXISTING 5' DRAINAGE EASEMENT

-PROPOSED ADDITION

WITH DECK ABOVE

-ROOF DOWNSPOUT INTO LANDSCAPING

PROPOSED GUEST QUARTERS INTO LANDSCAPING

OBTAIN COASTAL DEVELOPMENT PERMIT AND SITE DEVELOPMENT PERMIT TO BUILD AN ADDITION TO AN EXISTING ONE STORY SINGLE FAMILY RESIDENCE (BUILT IN 1947), GARAGE CONVERSION, BASEMENT GARAGE, GUEST QUARTERS, TWO LANAIS, PATIO, BREEZEWAY, DECK AND ROOF DECK

NOTICE OF GEOLOGIC AND GEOTECHNICAL CONDITIONS, DOCUMENT NO. 2020-0313873, DATE RECORDED JUNE 17, 2020.

**OWNER:** 

SCOTT & REEM SINNETT 2365 VIA SIENA SAN DIEGO, CA

### **LEGAL DESCRIPTION:**

A.P.N.: 352-165-04 MAP 3921, HIDDEN VALLEY HILLS, UNIT NO. 1

**LOT 23** 

# **DESIGNER:**

**ED SIEFKEN** SIEFKEN & ASSOCIATES 7126 HYATT ST. SAN DIEGO, CA 92111 (619) 778-9750

### **PROJECT DATA:**

TYPE OF CONSTRUCTION	TYPE
ZONE	LJSPD
LA JOLLA SHORES PLANNED DISTRICT	
COASTAL DEVELOPMENT PERMIT OVERLAY	
COASTAL HEIGHT LIMIT OVERLAY	
FIRE BRUSH ZONES 300' BUFFER	
FIRE HAZARD SEVERITY ZONE	
PARKING IMPACT (COASTAL)	
TRANSIT AREA (PRIORITY)	
GEOLOGIC HAZARD CATAGORY	
MAX. LOT COVERAGE ALLOWED	
PROPOSED LOT COVERAGE	
MAX. HEIGHT ALLOWED	
MIN. REQUIRED LANDSCAPE AREA	
LANDSCAPE AREA PROVIDED	

LANDSCAPE AREA PROVIDED	31
SETBACKS	
FRONT YARD (ESTABLISHED):	20'
INTERIOR YARDS:	10¹
REAR YARD:	10¹
LOT AREA:	12,345 S.F.
LOT AREA (ACRES)	.27
ALLOWABLE GFA:	9,259 SQ. FT.
EXISTING LIVING AREA:	1,684 SQ. FT.
PROPOSED LIVING AREA:	1,384 SQ. FT.
PROPOSED GARAGE CONVERSION AREA:	730 SQ. FT.
PROPOSED BASEMENT LIVNG AREA:	69 SQ. FT.
TOTAL PROPOSED RESIDENCE LIVNG AREA:	3,867 SQ. FT.
PROPOSED GUEST QUARTERS LIVING AREA:	407 SQ. FT.
TOTAL PROPOSED GFA:	4,274 SQ. FT.
PROPOSED FAR:	.35
PROPOSED BASEMENT GARAGE AREA:	1,753 SQ. FT.
PROPOSED LANAI AREA:	649 SQ. FT.
PROPOSED PATIO AREA:	72 SQ. FT.
PROPOSED BREEZEWAY AREA:	203 SQ. FT.

## **SHEET INDEX:**

PROPOSED ROOF DECK AREA:

SHEET 1	SITE PLAN
SHEET 2	EXISTING FLOOR PLAI
SHEET 3	BASEMENT FLOOR PLAN
SHEET 4	FIRST FLOOR PLAI
SHEET 5	ROOF PLAN
SHEET 6	ELEVATIONS
SHEET 7	ELEVATIONS
SHEET 8	SECTIONS
SHEET 9	SECTIONS

PREPAIRED BY:

	REVISION 13:
ED SIEFKEN	REVISION 12:
SIEFKEN & ASSOCIATES	REVISION 11:
7126 HYATT STREET	REVISION 10:
SAN DIEGO, CA 92111	REVISION 9:
619-778-9750	REVISION 8:
	REVISION 7:
PROJECT ADDRESS:	REVISION 6:
	REVISION 5:
2365 VIA SIENA	REVISION 4:
SAN DIEGO, CALIFORNIA 92037	REVISION 3:
	REVISION 2: 6-1-20
	REVISION 1: 11-25-19
PROJECT NAME:	
011111ETT 11014E	ODICINIAL DATE:

ORIGINAL DATE: SINNETT HOME 4-10-19 SHEET 1 OF 9 SHEET TITLE: SITE PLAN PROJECT # 638504

**NOTED** JOB NO.

**ED SIEFKEN** ES CHECKED 4-10-19

O. REVISION DESCRIPTION

S

FIRE CODE.

PROVIDE PERMANENTLY WIRED TOGETHER SMOKE DETECTORS IN ALL BEDROOMS AND THEIR ADJACENT HALLWAYS, AND ABOVE STAIRWAYS, AND ON EACH FLOOR. SMOKE DETECTORS SHALL SOUND AN ALARM AUDIBLE IN ALL SLEEPING AREAS OF THE

PRIMARY RESIDENCE. 9. THE INSTALLATION OF SMOKE ALARMS AND SMOKE DETECTORS SHALL COMPLY WITH

THE SPECIFIC LOCATION REQUIREMENTS OF CRC SECTION 314.3.4.

11. SURFACE WATER SHALL DRAIN AWAY FROM BUILDING.

12. EXHAUST FANS SHALL PROVIDE 5 AIR CHANGES PER HOUR.

14. STATE HEALTH & SAFETY CODE SEC. 17921.9 BANS THE USE OF CHLORINATED POLYVINYL

17. DOWNSPOUTS SHALL BE DIRECTED INTO LANDSCAPE AREAS AND WALKWAYS SHALL BE

IN ACCORDANCE WITH CITY OF SAN DIEGO TECHNICAL BULLETIN BLDG-5-4.


SAN DIEGO MUNICIPAL CODE, INTO THE CONSTRUCTION PLANS OR SPECIFICATIONS. 20. PERMANENT VACCUM BREAKERS SHALL BE INCLUDED WITH ALL NEW HOSE BIBBS. 21. PLANT MATERIAL, OTHER THAN TREES, LOCATED WITHIN VISIBILITY AREAS OR THE

**SOURCE OF TOPOGRAPHY:** FIELD SURVEYBY METROPOLITAN MAPPING SEPT. 28, 2018

DATUM: MEAN SEA LEVEL (NGVD 29)

**PAGE 5, NO. 9** 

BASIS OF ELEVATIONS: CITY OF SAN DIEGO VERTICAL CONTROL BENCHMARK MONUMENT DESCRIPTION: BRASS/PLUG TOP OF CURB LOCATION: SOUTHWEST CORNER OF VIA CAPRI AND VIA RIALTO DATUM: MEAN SEA LEVEL (NGVD 29) ELEVATION: 451.82 FEET

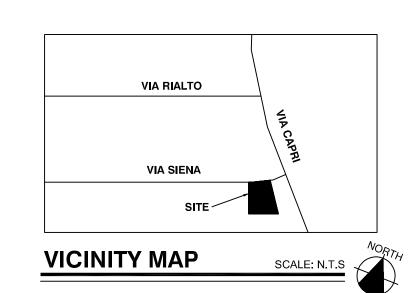

TOTAL IMPERVIOUS AREA

**IMPERVIOUS % INCREASE** 

737 CUBIC YARDS OF EXPORT 0 CUBIC YARDS OF IMPORT 18" FOOTING CUT DEPTH (MAX. 9'-8" CUT DEPTH) 22" FILL DEPTH 877 CUBIC YARDS OF CUT (INCLUDING FOOTINGS) 170 CUBIC YARDS OF FILL TOTAL DISTURBANCE AREA 7530 SQ. FT. EXIST. AMOUNT OF IMPERVIOUS AREA 2614 SQ. FT.

PROPOSED AMOUNT OF IMPERVIOUS AREA\_\_\_\_\_

NOTE: PERVIOUS AREA SHALL NOT INCLUDE: ROOF, SIDEWALKS, PARKING AREA, WALKWAYS, POOLS, POOL DECKS, ETC.

4442 SQ. FT.

7056 SQ. FT.

**SCOPE OF WORK:** 



EXISTING FLOOR PLAN SCALE: 1/4"=1'-0"

1,684 S.F.

ED SIEFKEN SIEFKEN & ASSOCIATES 7126 HYATT STREET SAN DIEGO, CA 92111 619-778-9750

PREPAIRED BY:

PROJECT ADDRESS: 2365 VIA SIENA SAN DIEGO, CALIFORNIA 92037

PROJECT NAME: SINNETT HOME

SHEET TITLE: EXISTING FLOOR PLAN PROJECT # 638504

ORIGINAL DATE: 4-10-19

REVISION 13:\_\_\_\_\_ REVISION 12:\_\_\_\_\_

REVISION 8:

REVISION 7:

REVISION 6:

REVISION 5:

REVISION 3: REVISION 2:

REVISION 1:

REVISION 11:

REVISION 10:

REVISION 4:

SHEET 2 OF 9

2

DESIGN BY
ED SIEFKEN


ES

CHECKED

DATE 4-10-19

SCALE NOTED

JOB NO.

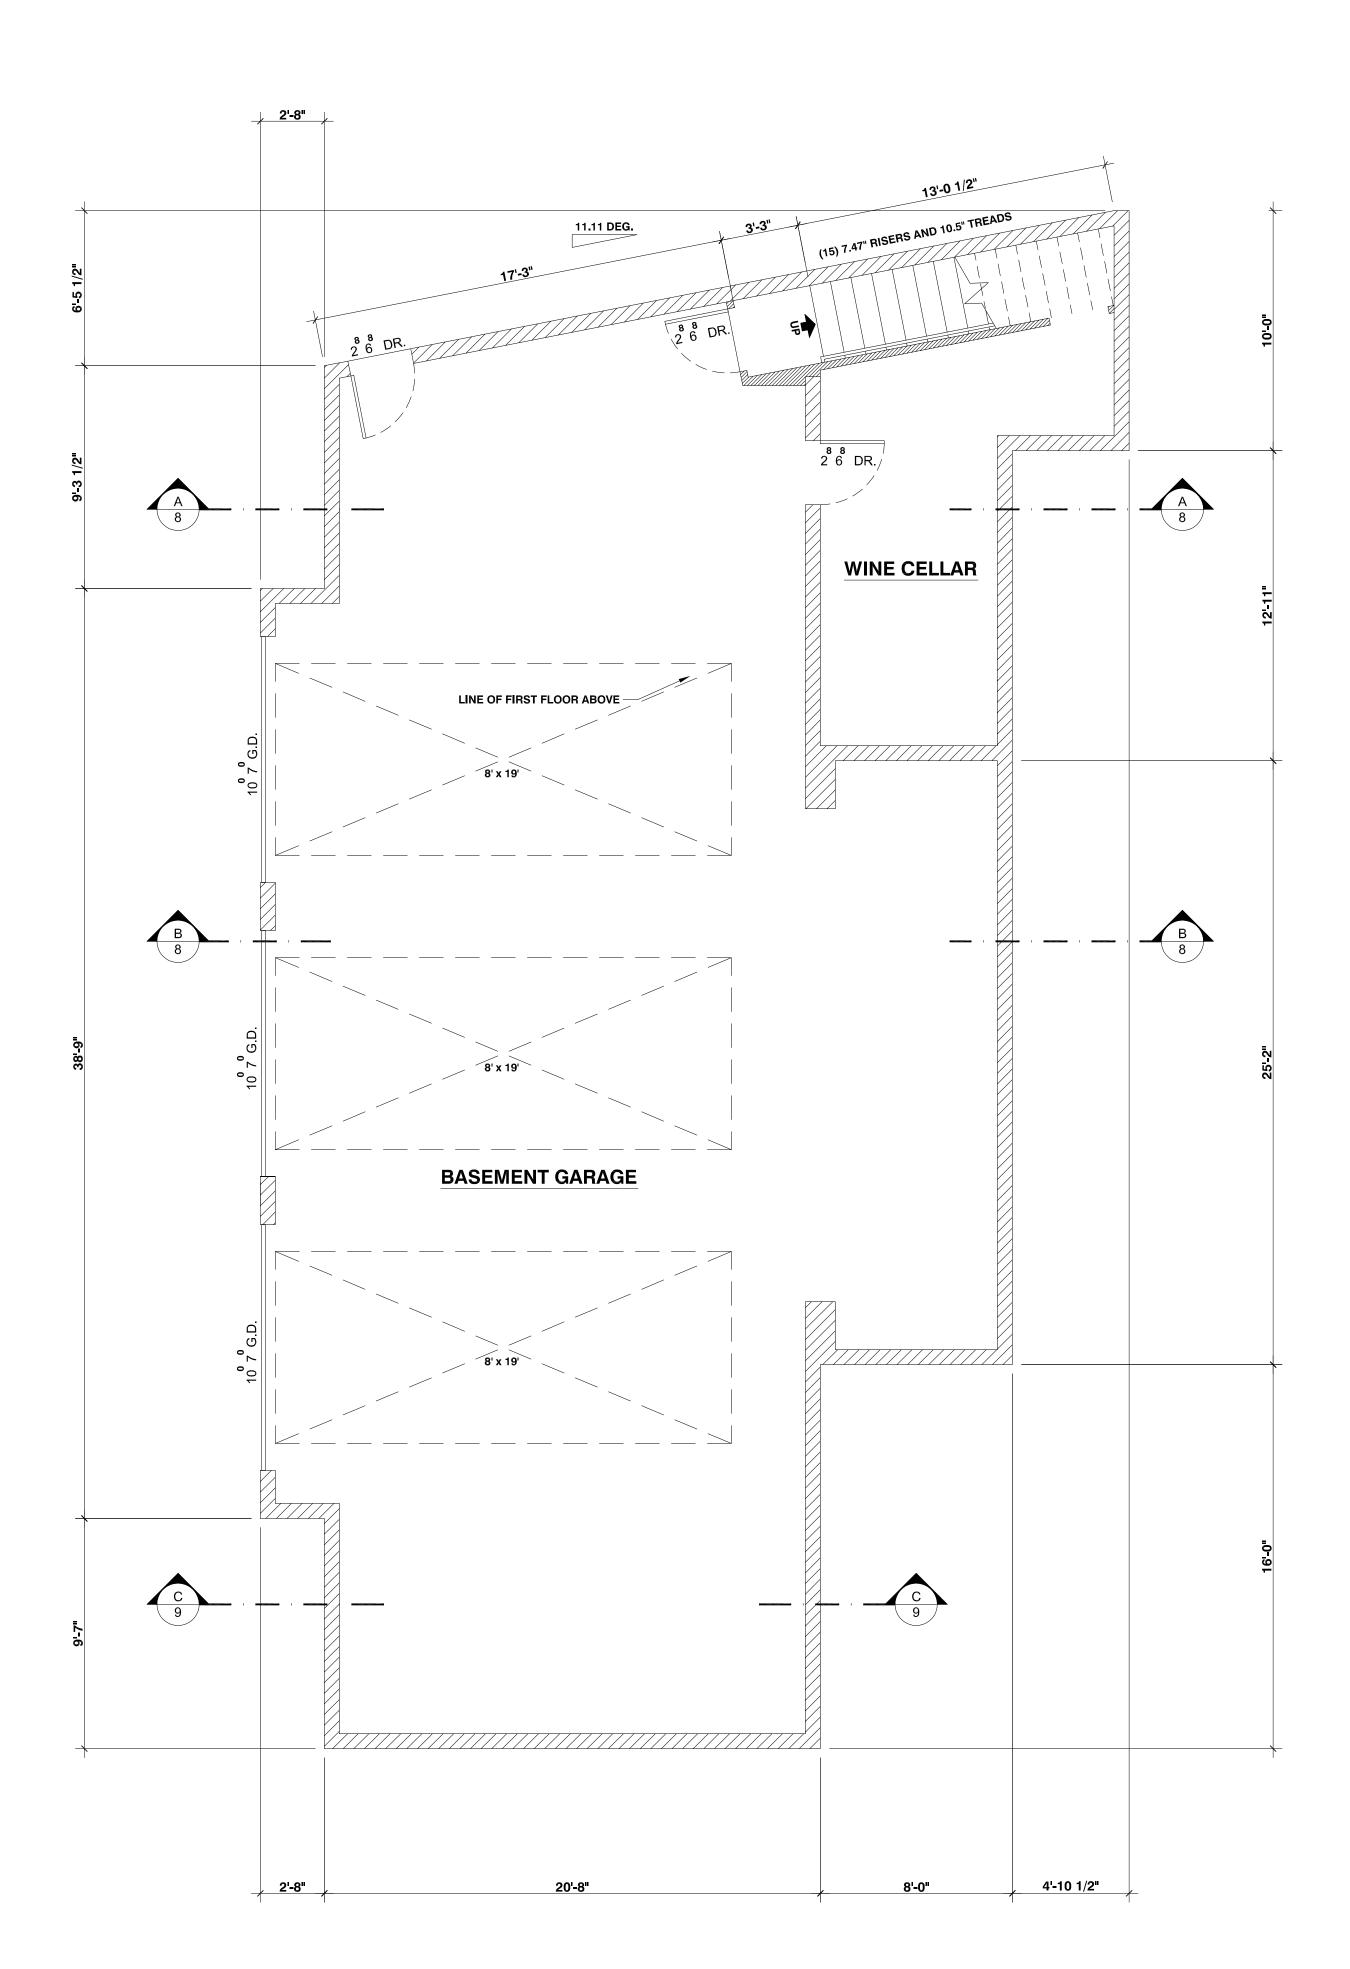



REVISION 13:\_\_ REVISION 12:\_\_ **ED SIEFKEN** SIEFKEN & ASSOCIATES REVISION 11:\_ 7126 HYATT STREET SAN DIEGO, CA 92111 REVISION 10:\_\_\_ REVISION 9: REVISION 8: 619-778-9750 REVISION 7: PROJECT ADDRESS: REVISION 6: \_\_ REVISION 5: REVISION 4: 2365 VIA SIENA REVISION 3: 6-1-20
REVISION 1: 11-25-19 SAN DIEGO, CALIFORNIA 92037 PROJECT NAME: ORIGINAL DATE: 4-10-19 SINNETT HOME SHEET TITLE:

PREPAIRED BY:

SHEET 3 OF 9 BASEMENT FLOOR PLAN PROJECT # 638504

3

DESIGN BY

**ED SIEFKEN** 


ES

CHECKED

4-10-19

NOTED

JOB NO.

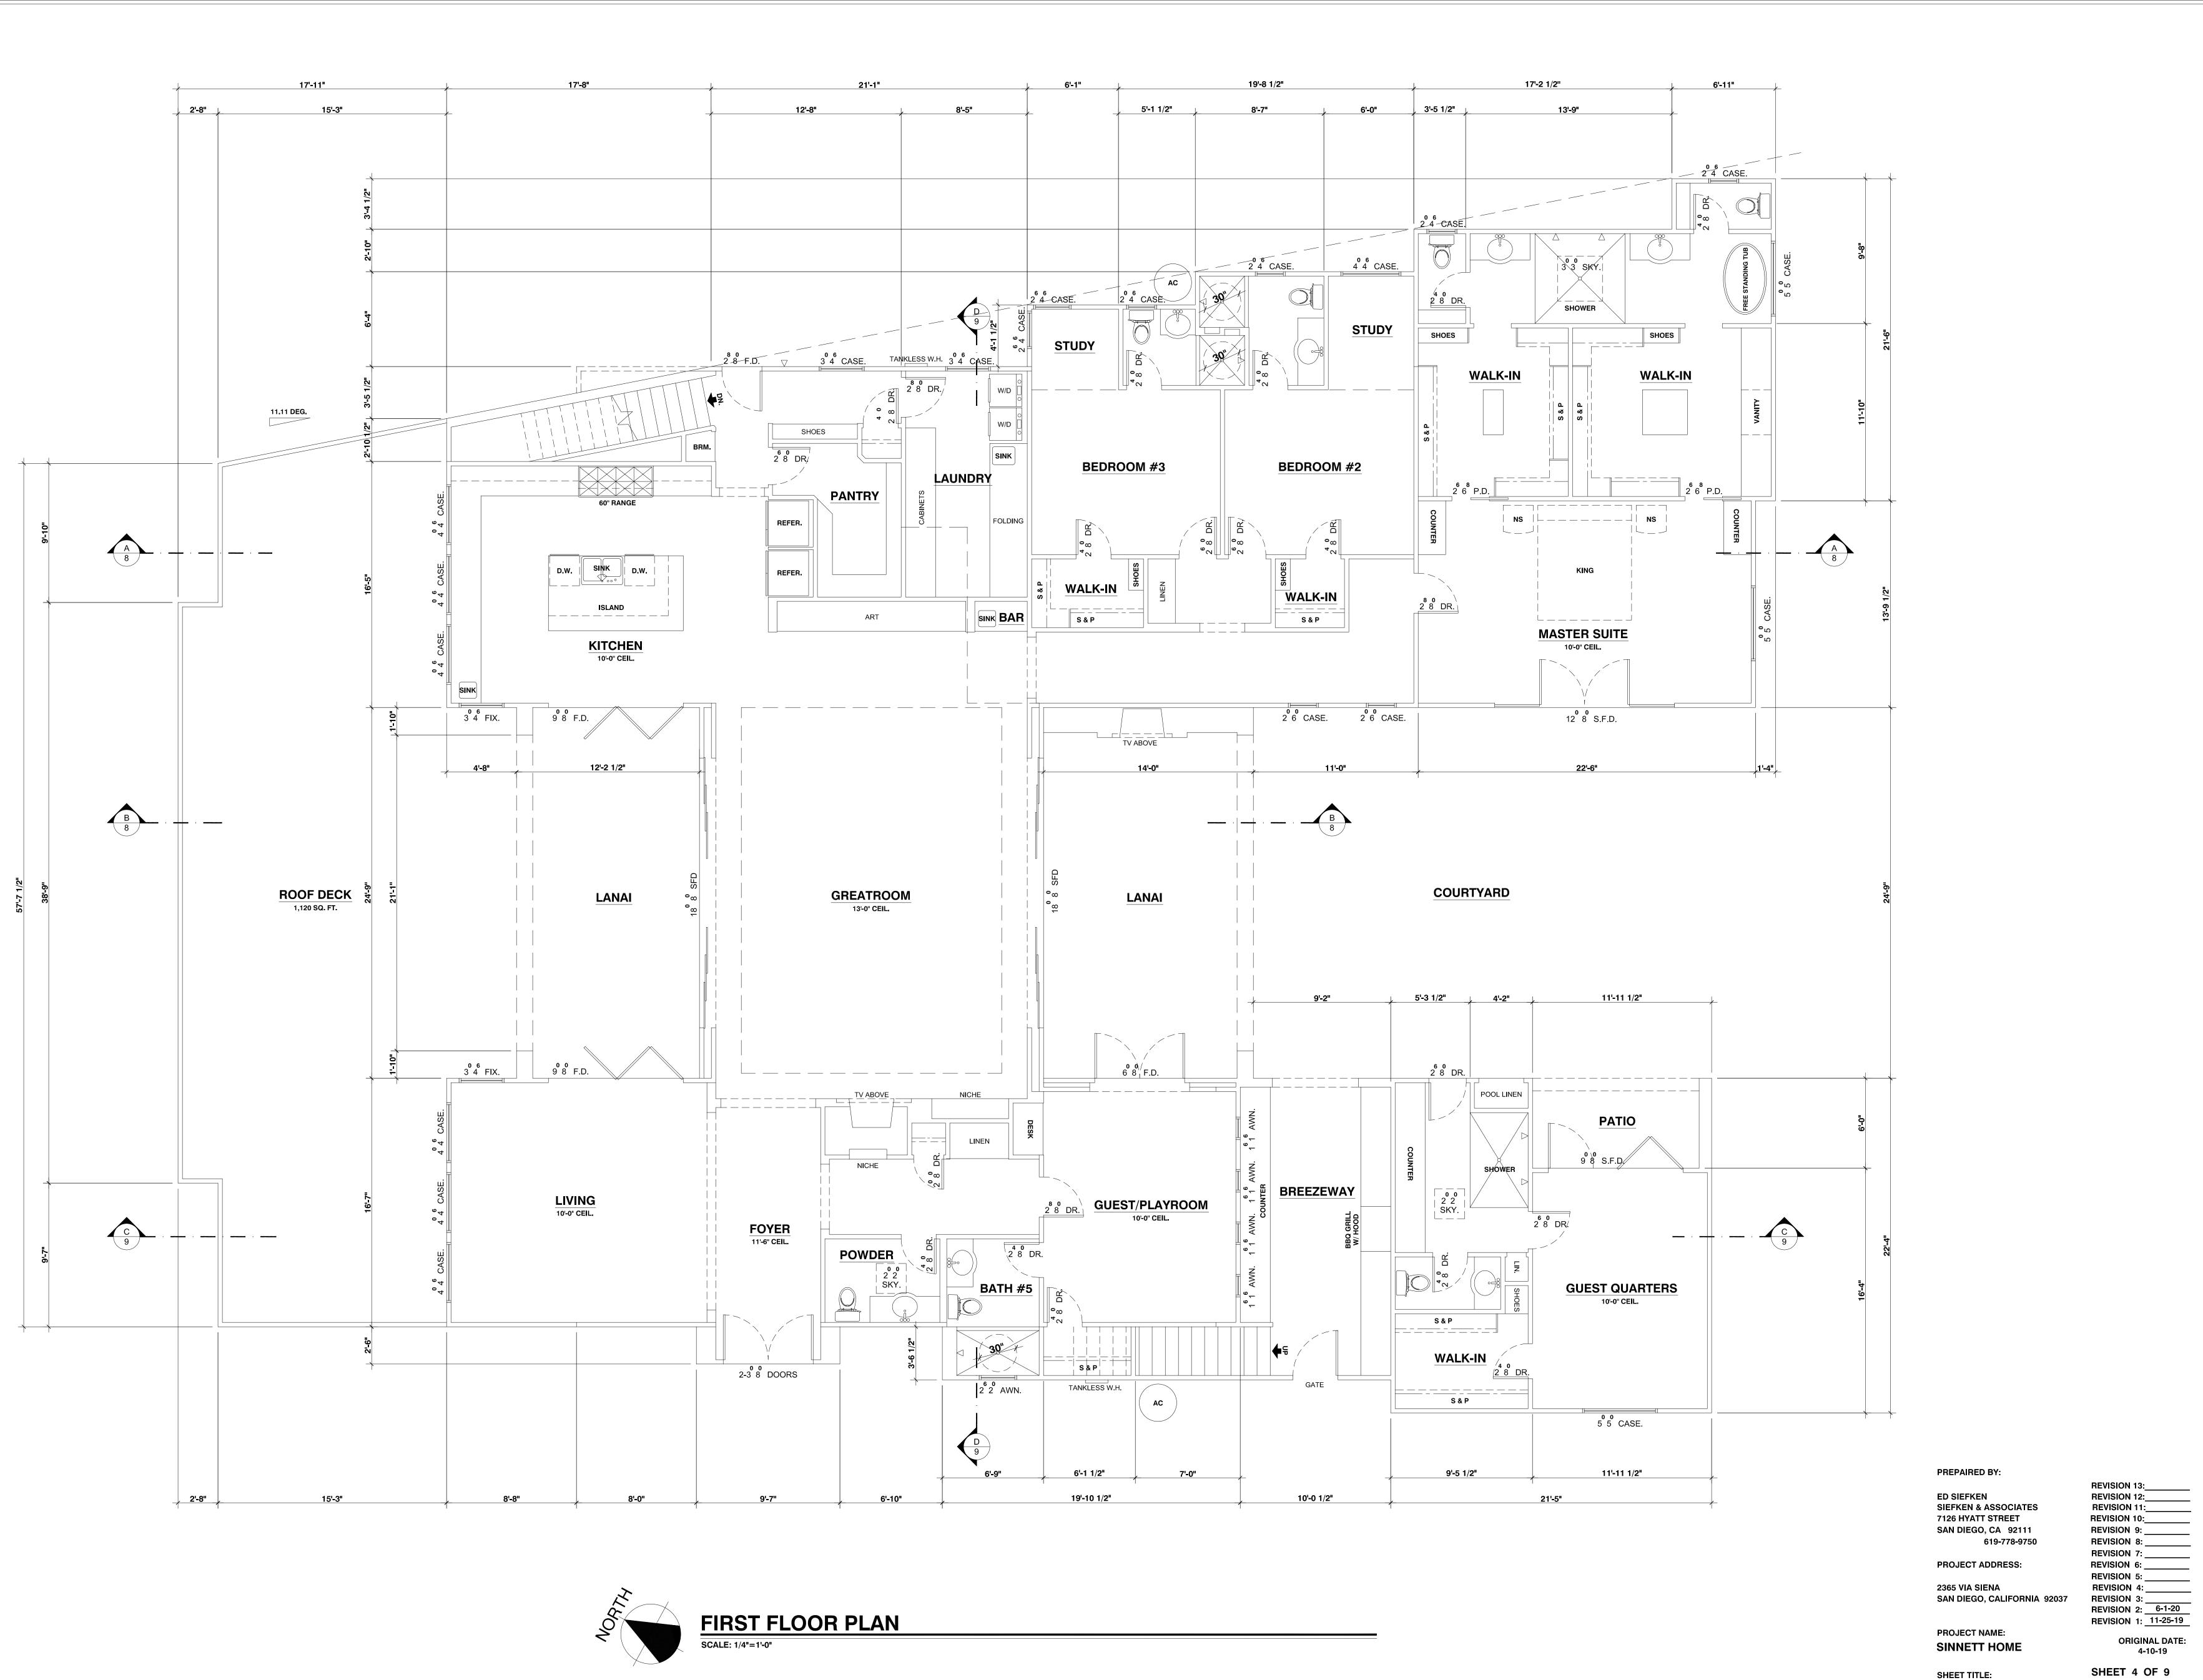

SIEFKEN & ASSOC.
7126 HYATT STREET
SAN DIEGO CA (619) 778-9750

SINNETT HOME 2365 VIA SIENA SAN DIEGO, CA 92037

DESIGN BY
ED SIEFKEN

DRAWN
ES

CHECKED

DATE
4-10-19

SCALE
NOTED


JOB NO.

SHEET

SHEET

SHEET:

FIRST FLOOR PLAN PROJECT # 638504

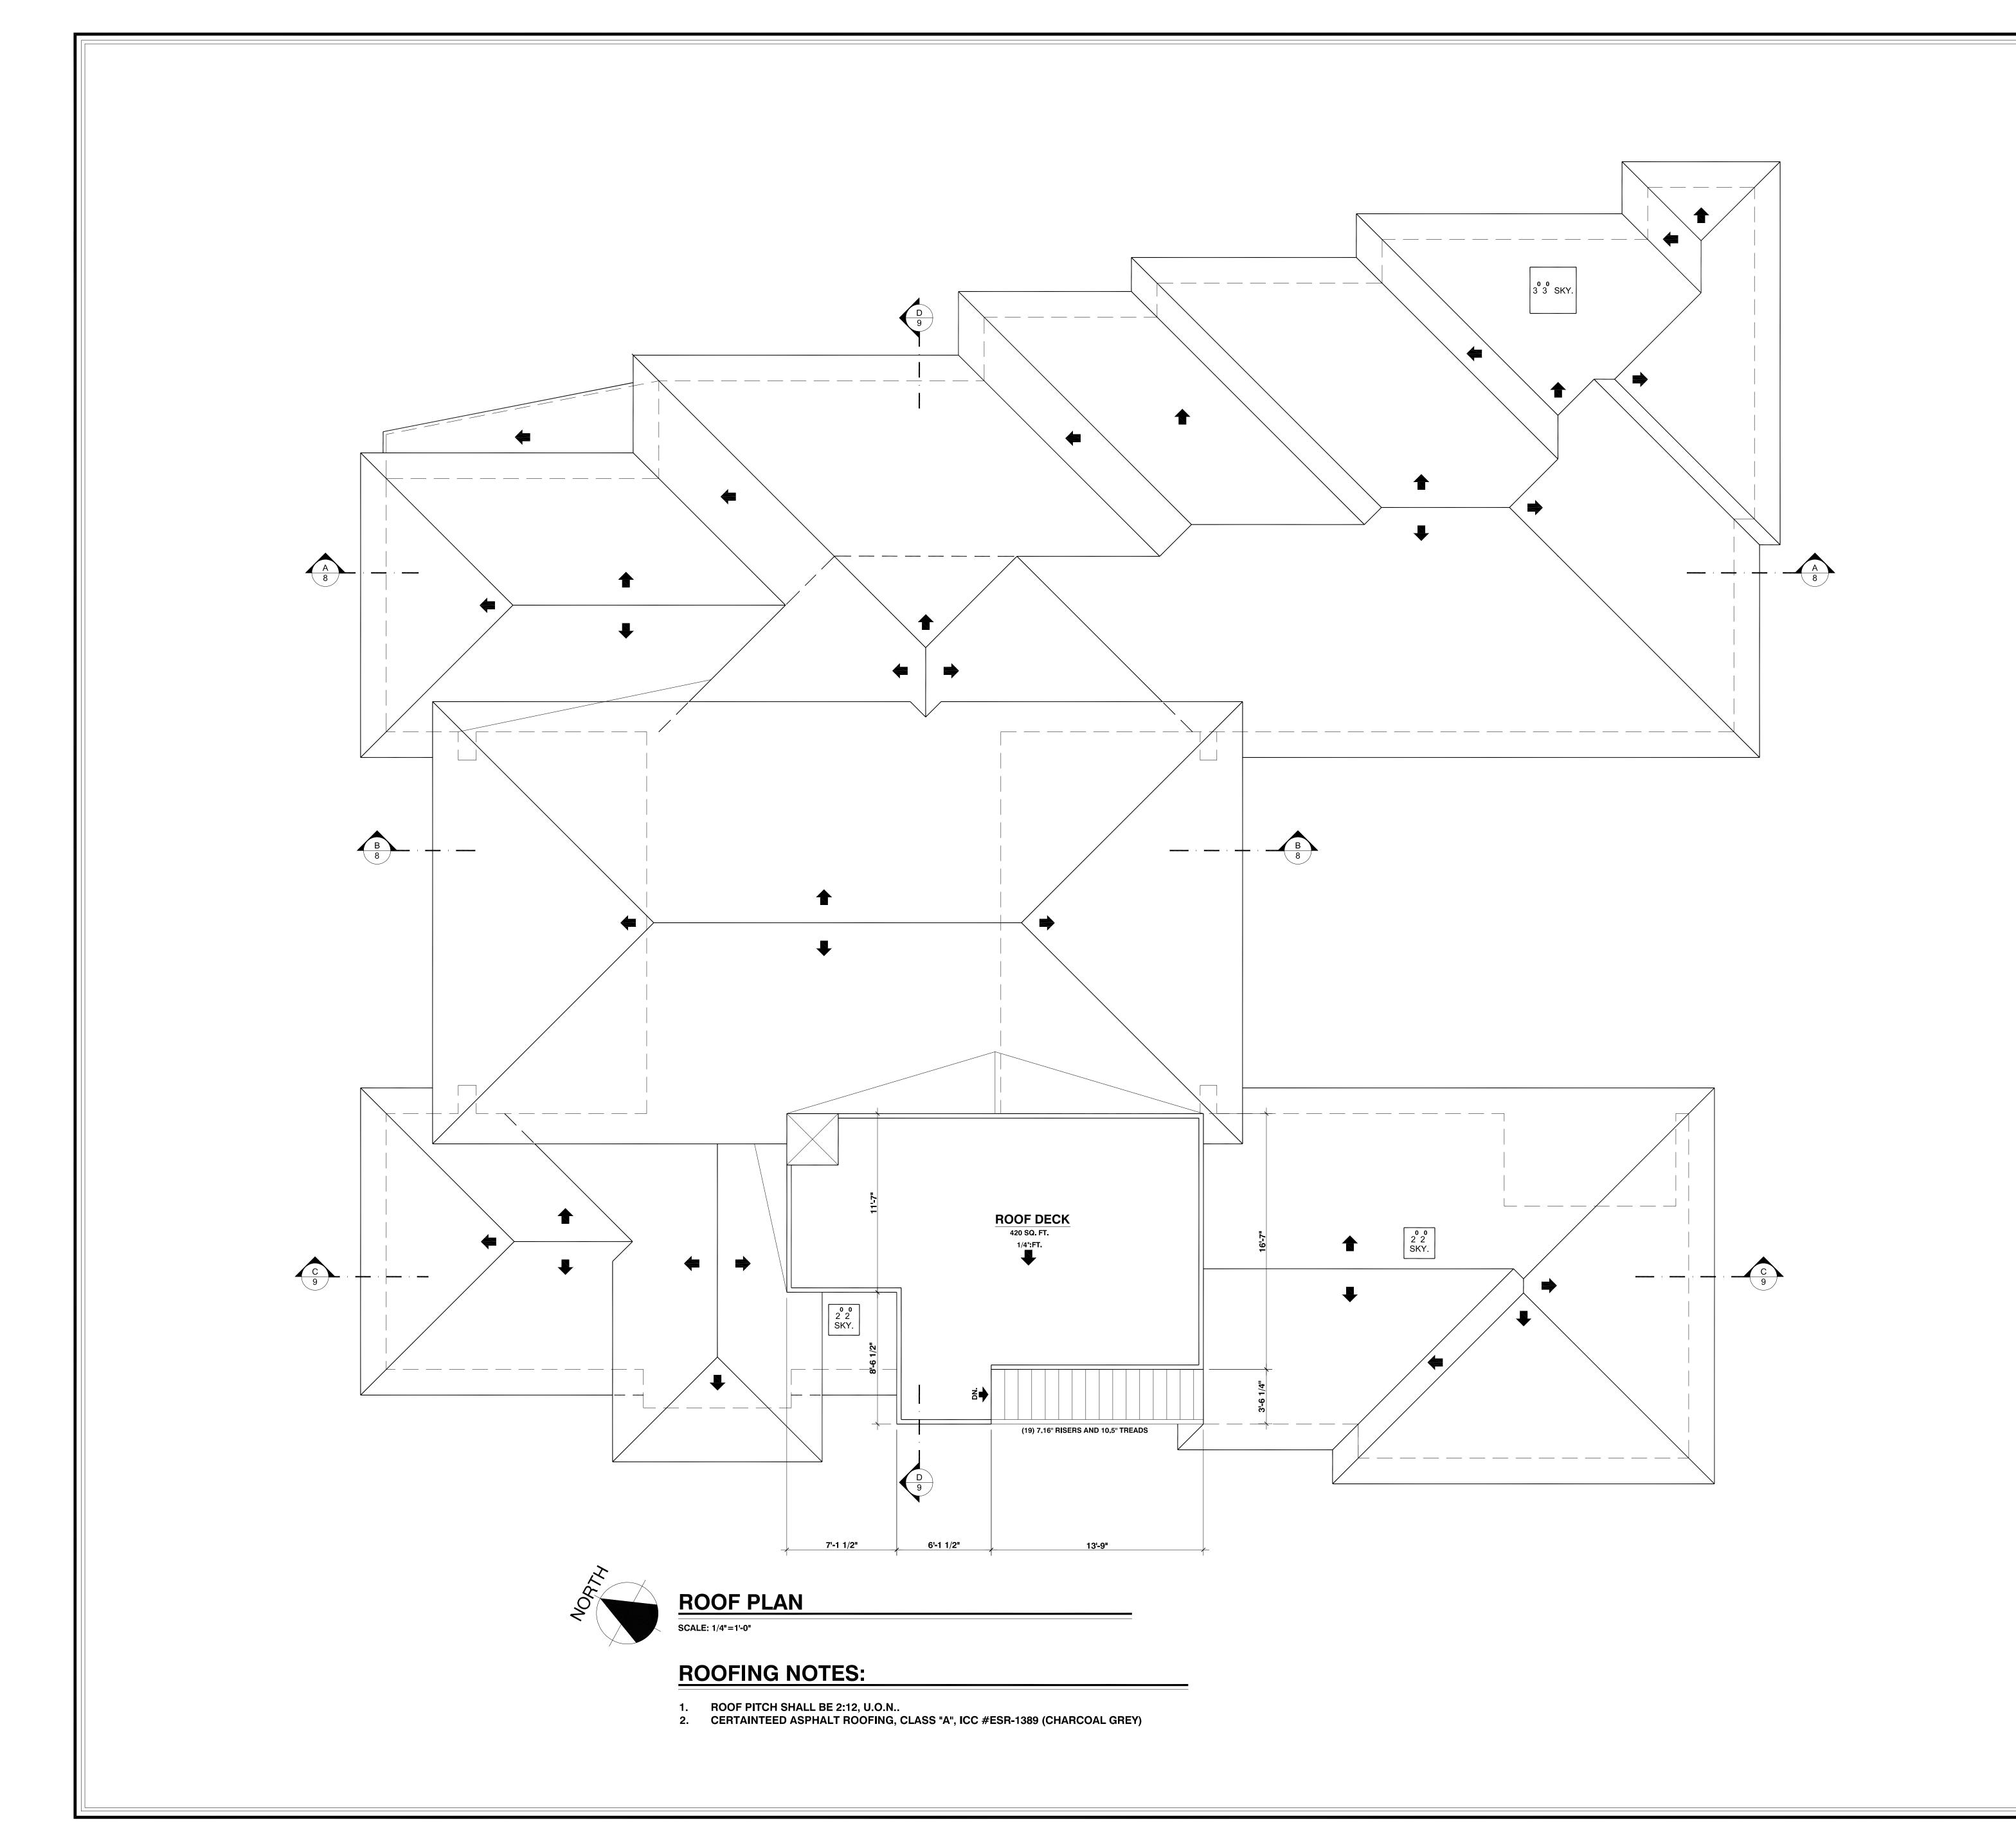

DESIGN BY

**ED SIEFKEN** 

ES

CHECKED

4-10-19

NOTED

JOB NO.

REVISION 13:\_\_\_\_ REVISION 12: REVISION 11: REVISION 10:\_ REVISION 9: REVISION 8: REVISION 7: REVISION 6:\_ REVISION 5:

**REVISION 4:** REVISION 3:
REVISION 2:
REVISION 1: 6-1-20 SAN DIEGO, CALIFORNIA 92037 ORIGINAL DATE: 4-10-19

PREPAIRED BY:

SIEFKEN & ASSOCIATES

7126 HYATT STREET SAN DIEGO, CA 92111

**PROJECT ADDRESS:** 

2365 VIA SIENA

PROJECT NAME:

SHEET TITLE:


SINNETT HOME

**ROOF PLAN** 


619-778-9750

ED SIEFKEN

SHEET 5 OF 9 PROJECT # 638504

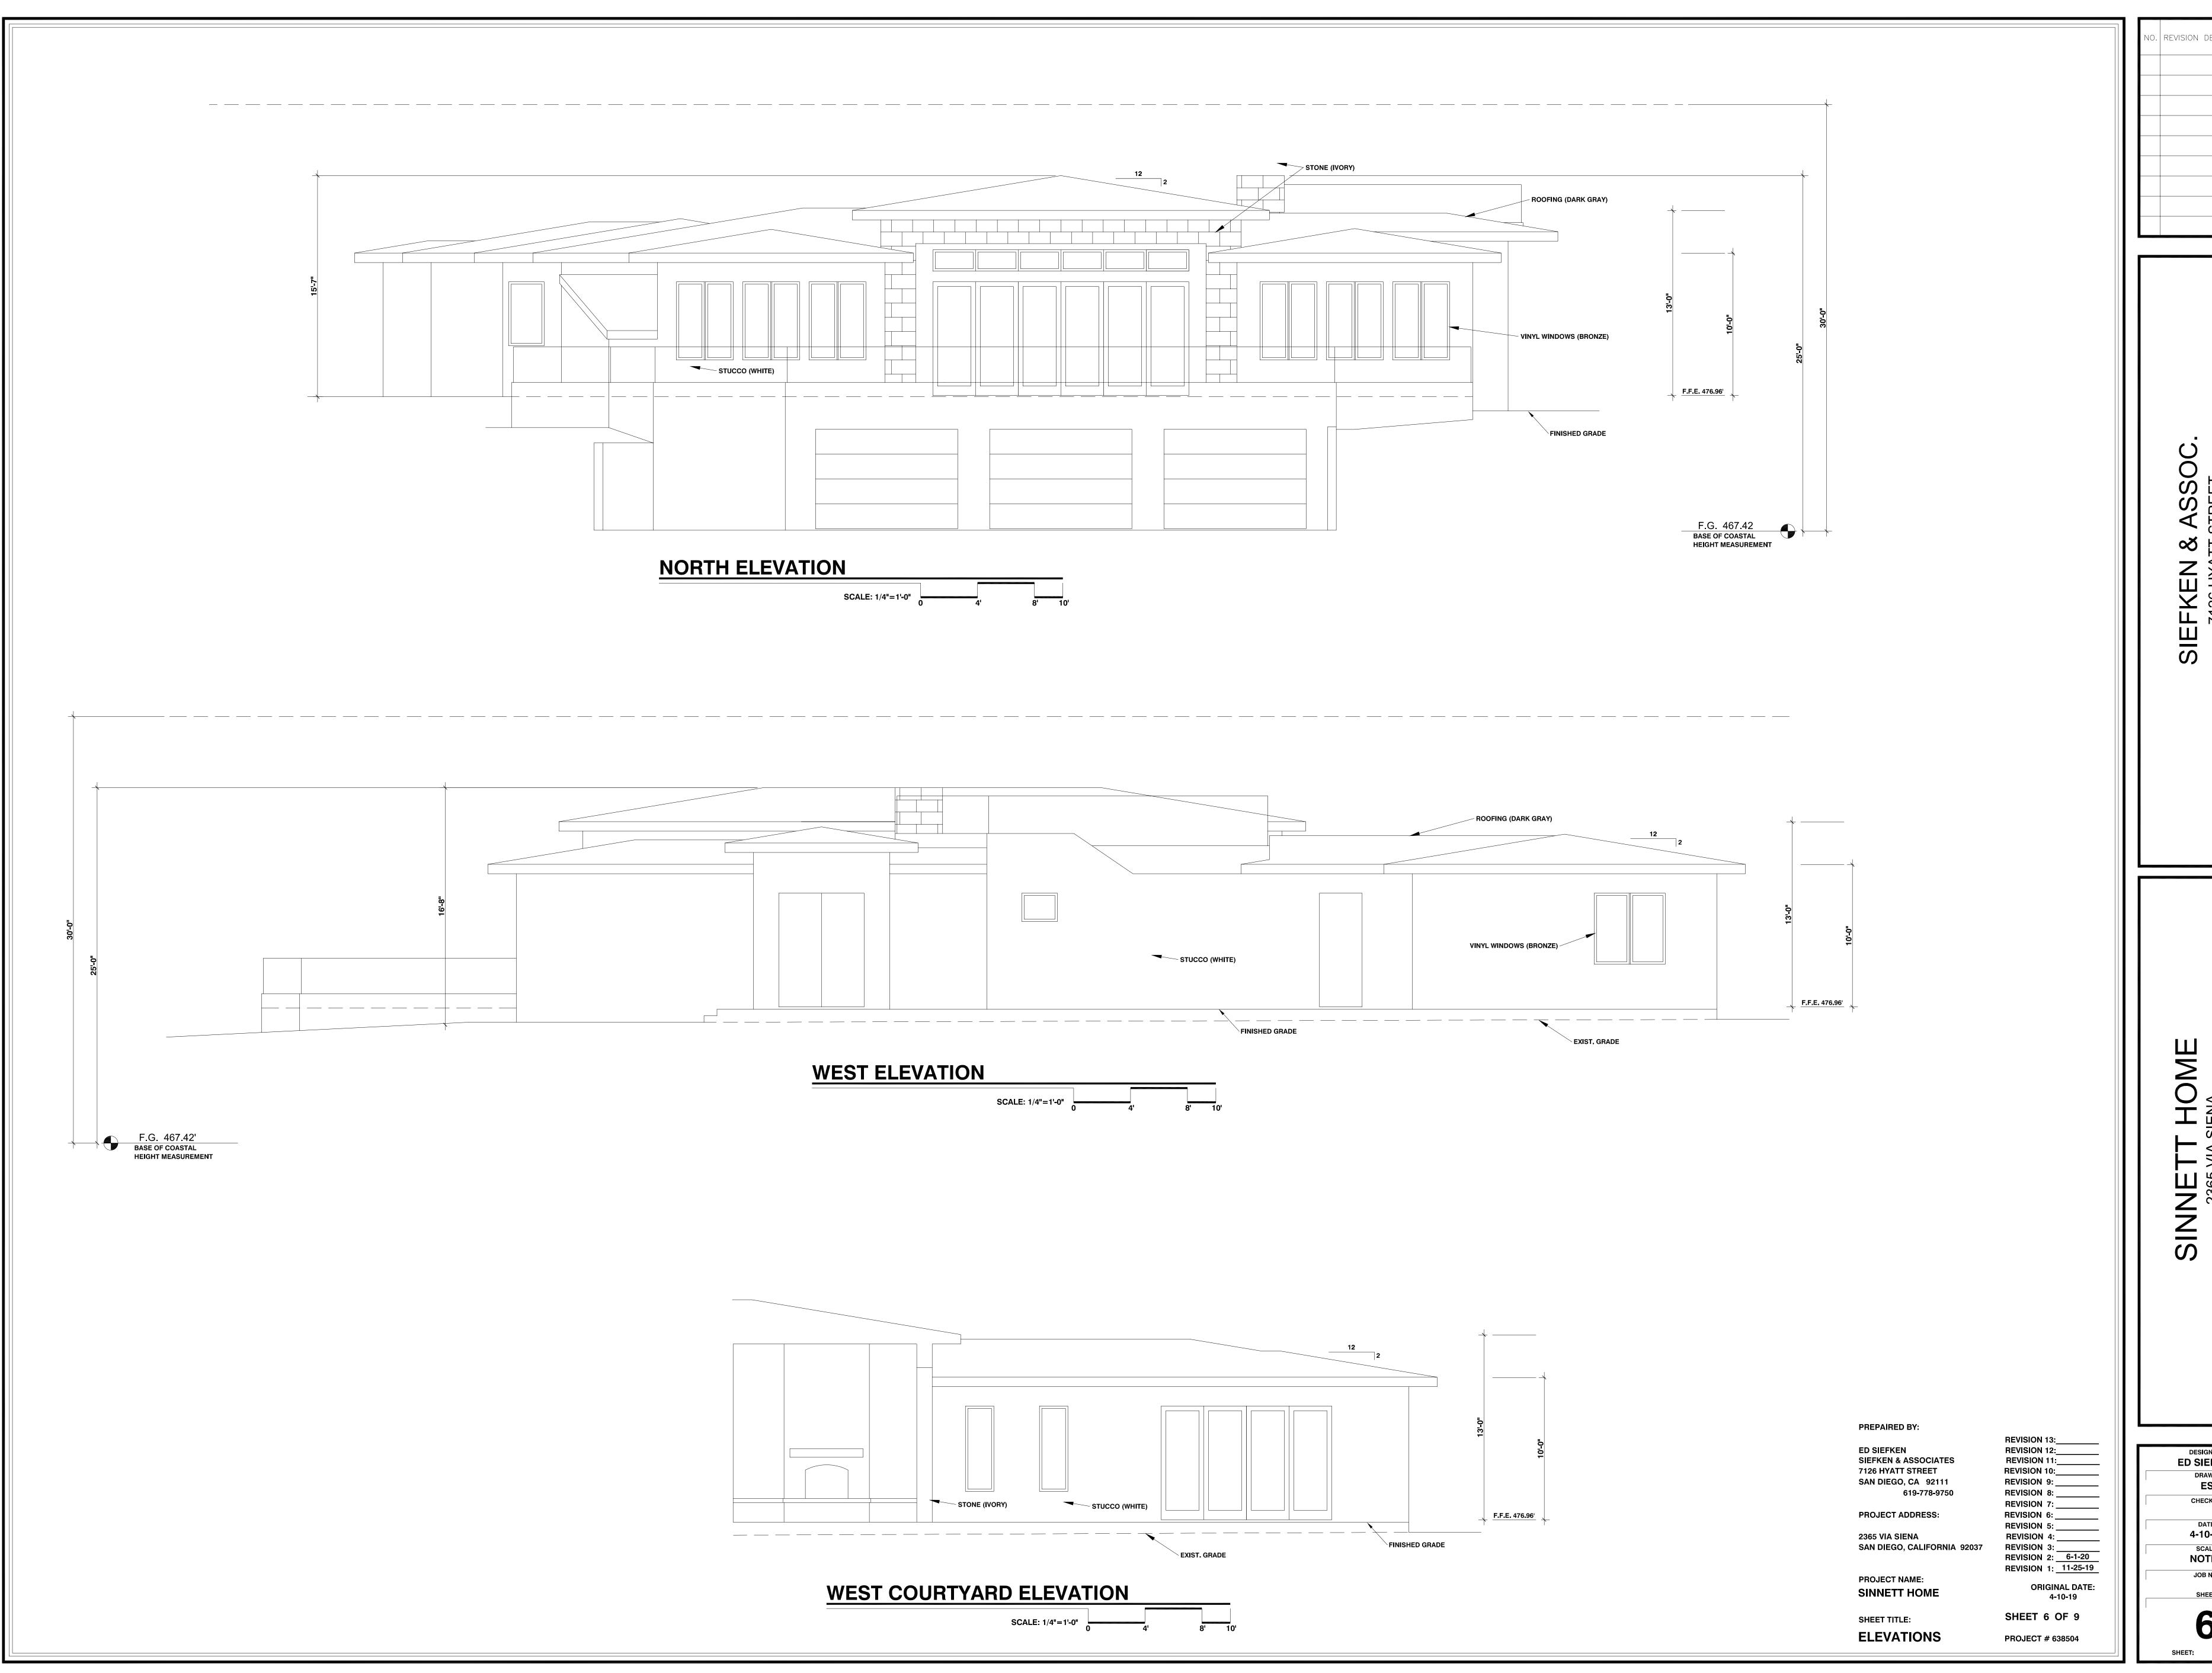

**DESIGN BY ED SIEFKEN** ES CHECKED 4-10-19 NOTED JOB NO.

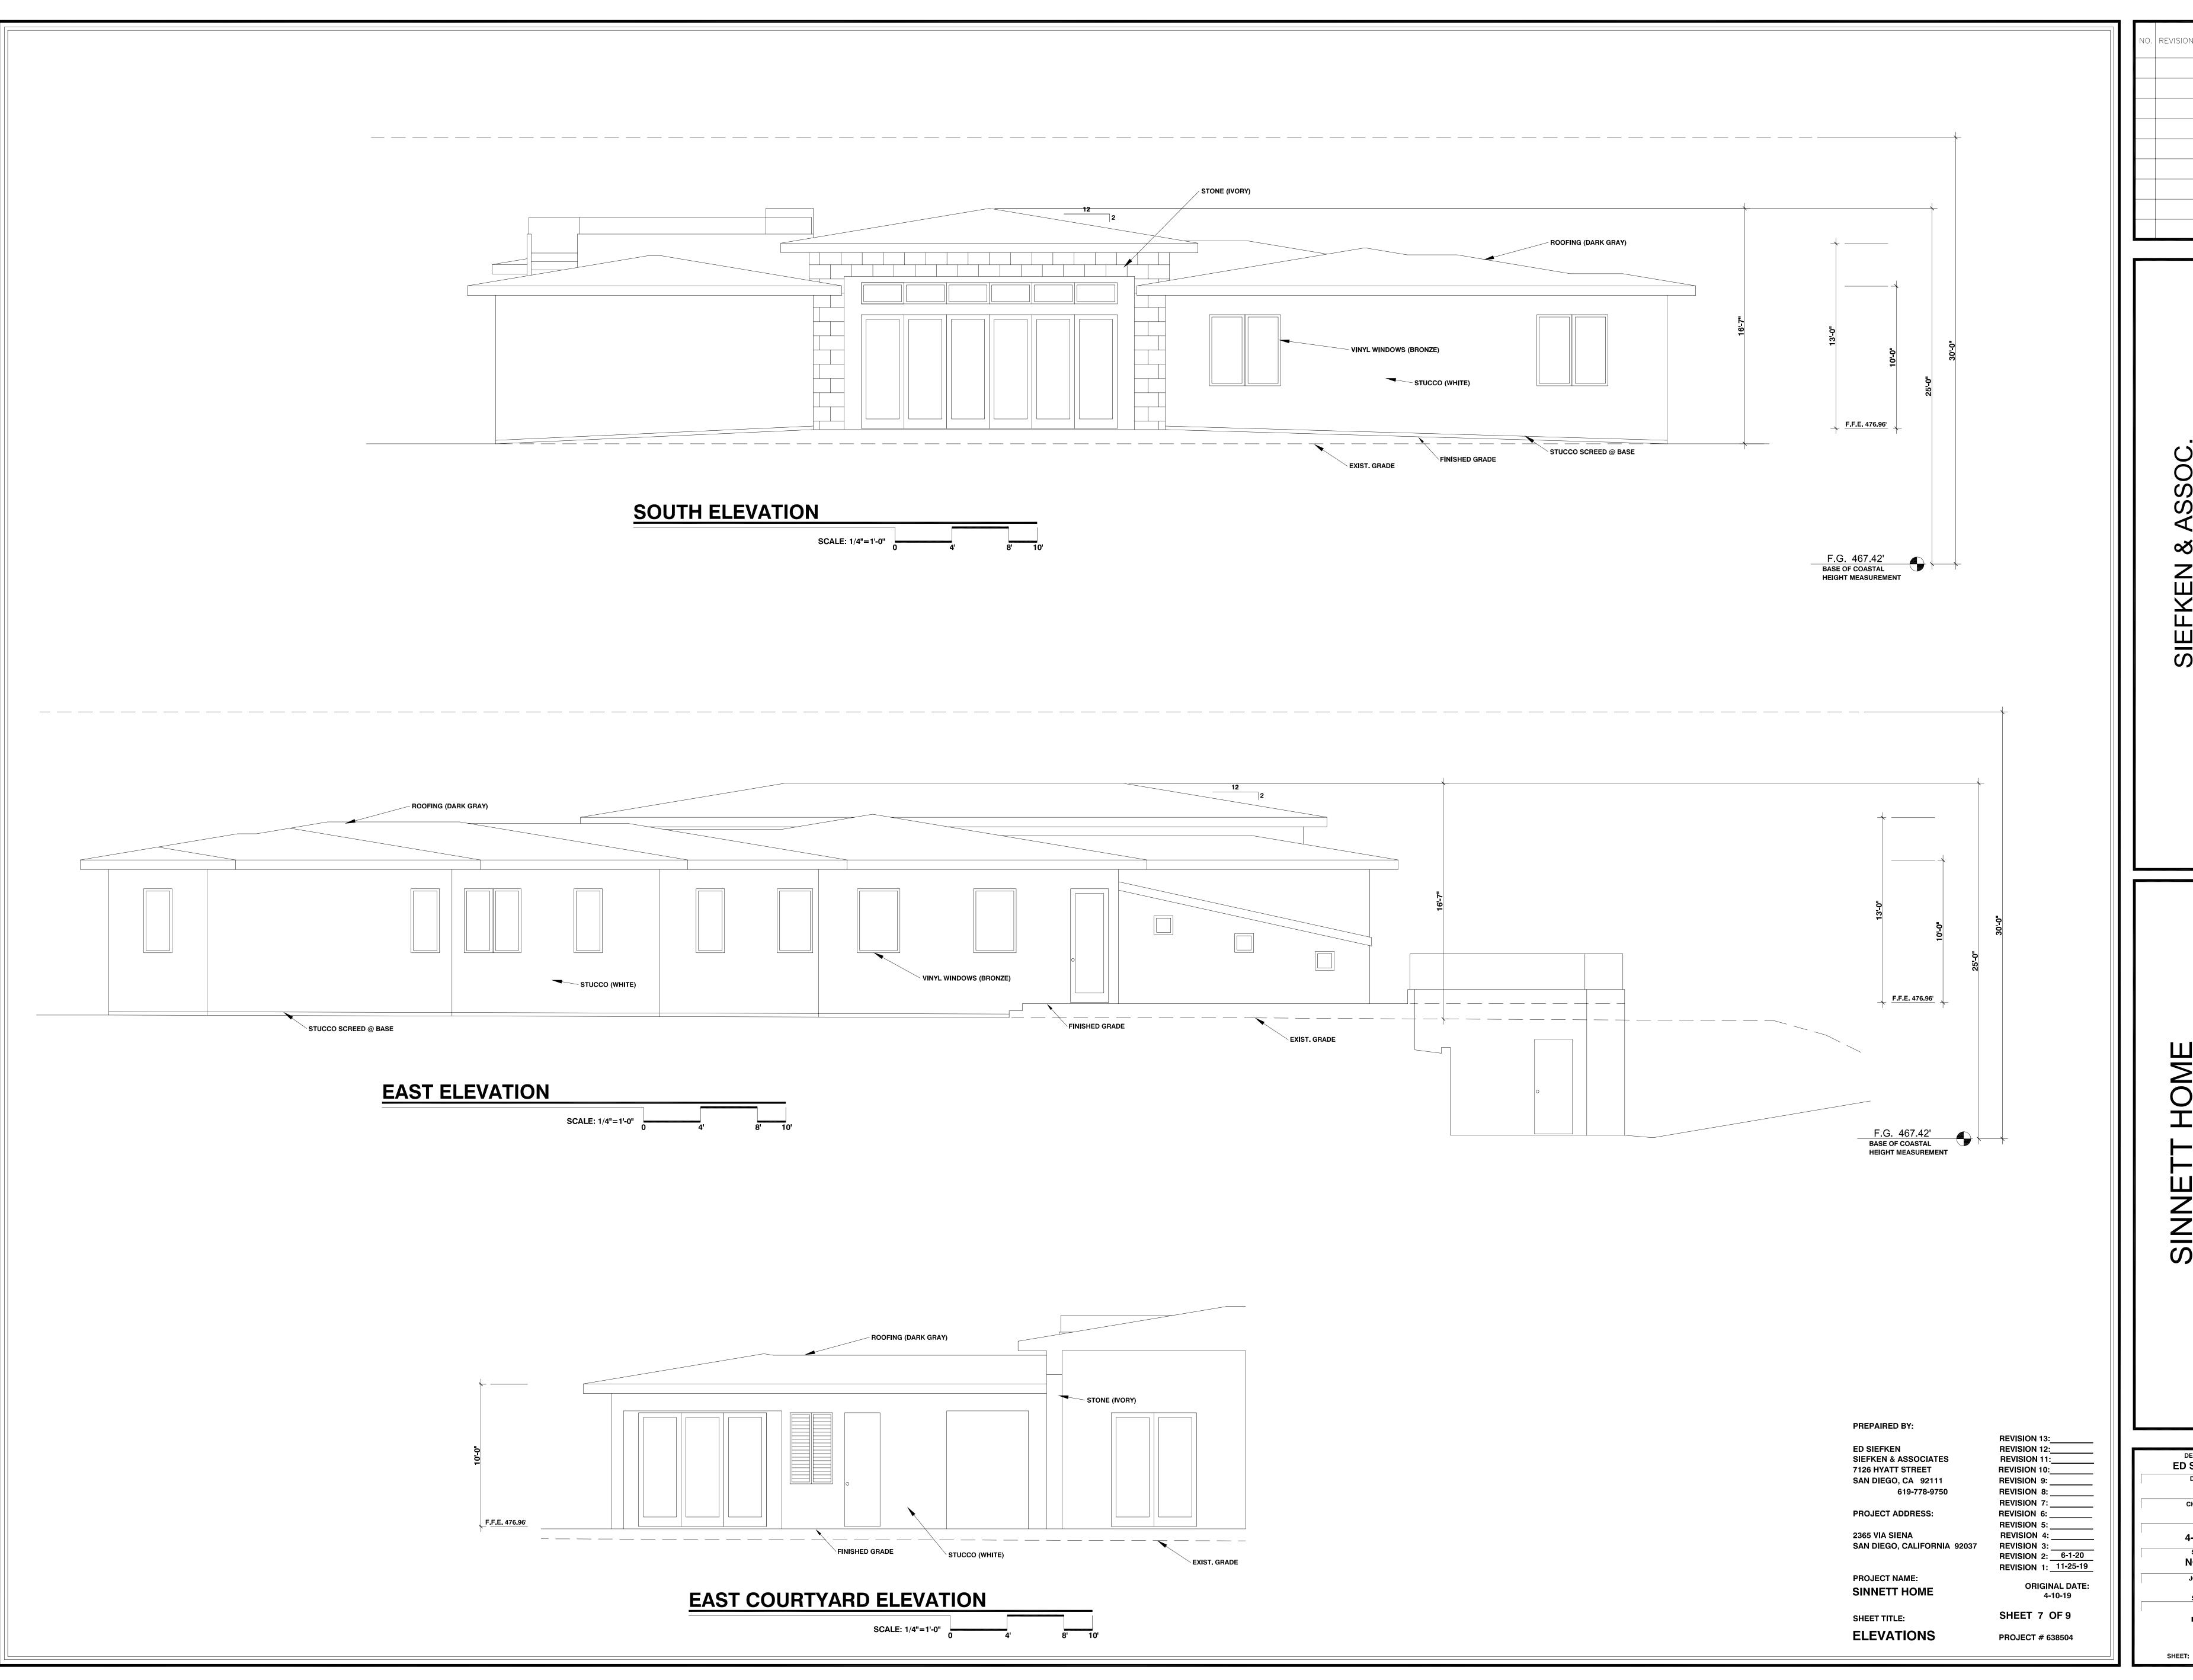

SIEFKEN & ASSOC.
7126 HYATT STREET
SAN DIEGO, CA (619) 778-9750

SINNETT HOME
2365 VIA SIENA

DESIGN BY
ED SIEFKEN

DRAWN
ES

CHECKED


DATE
4-10-19

SCALE
NOTED

JOB NO.

SHEET

SHEET 7

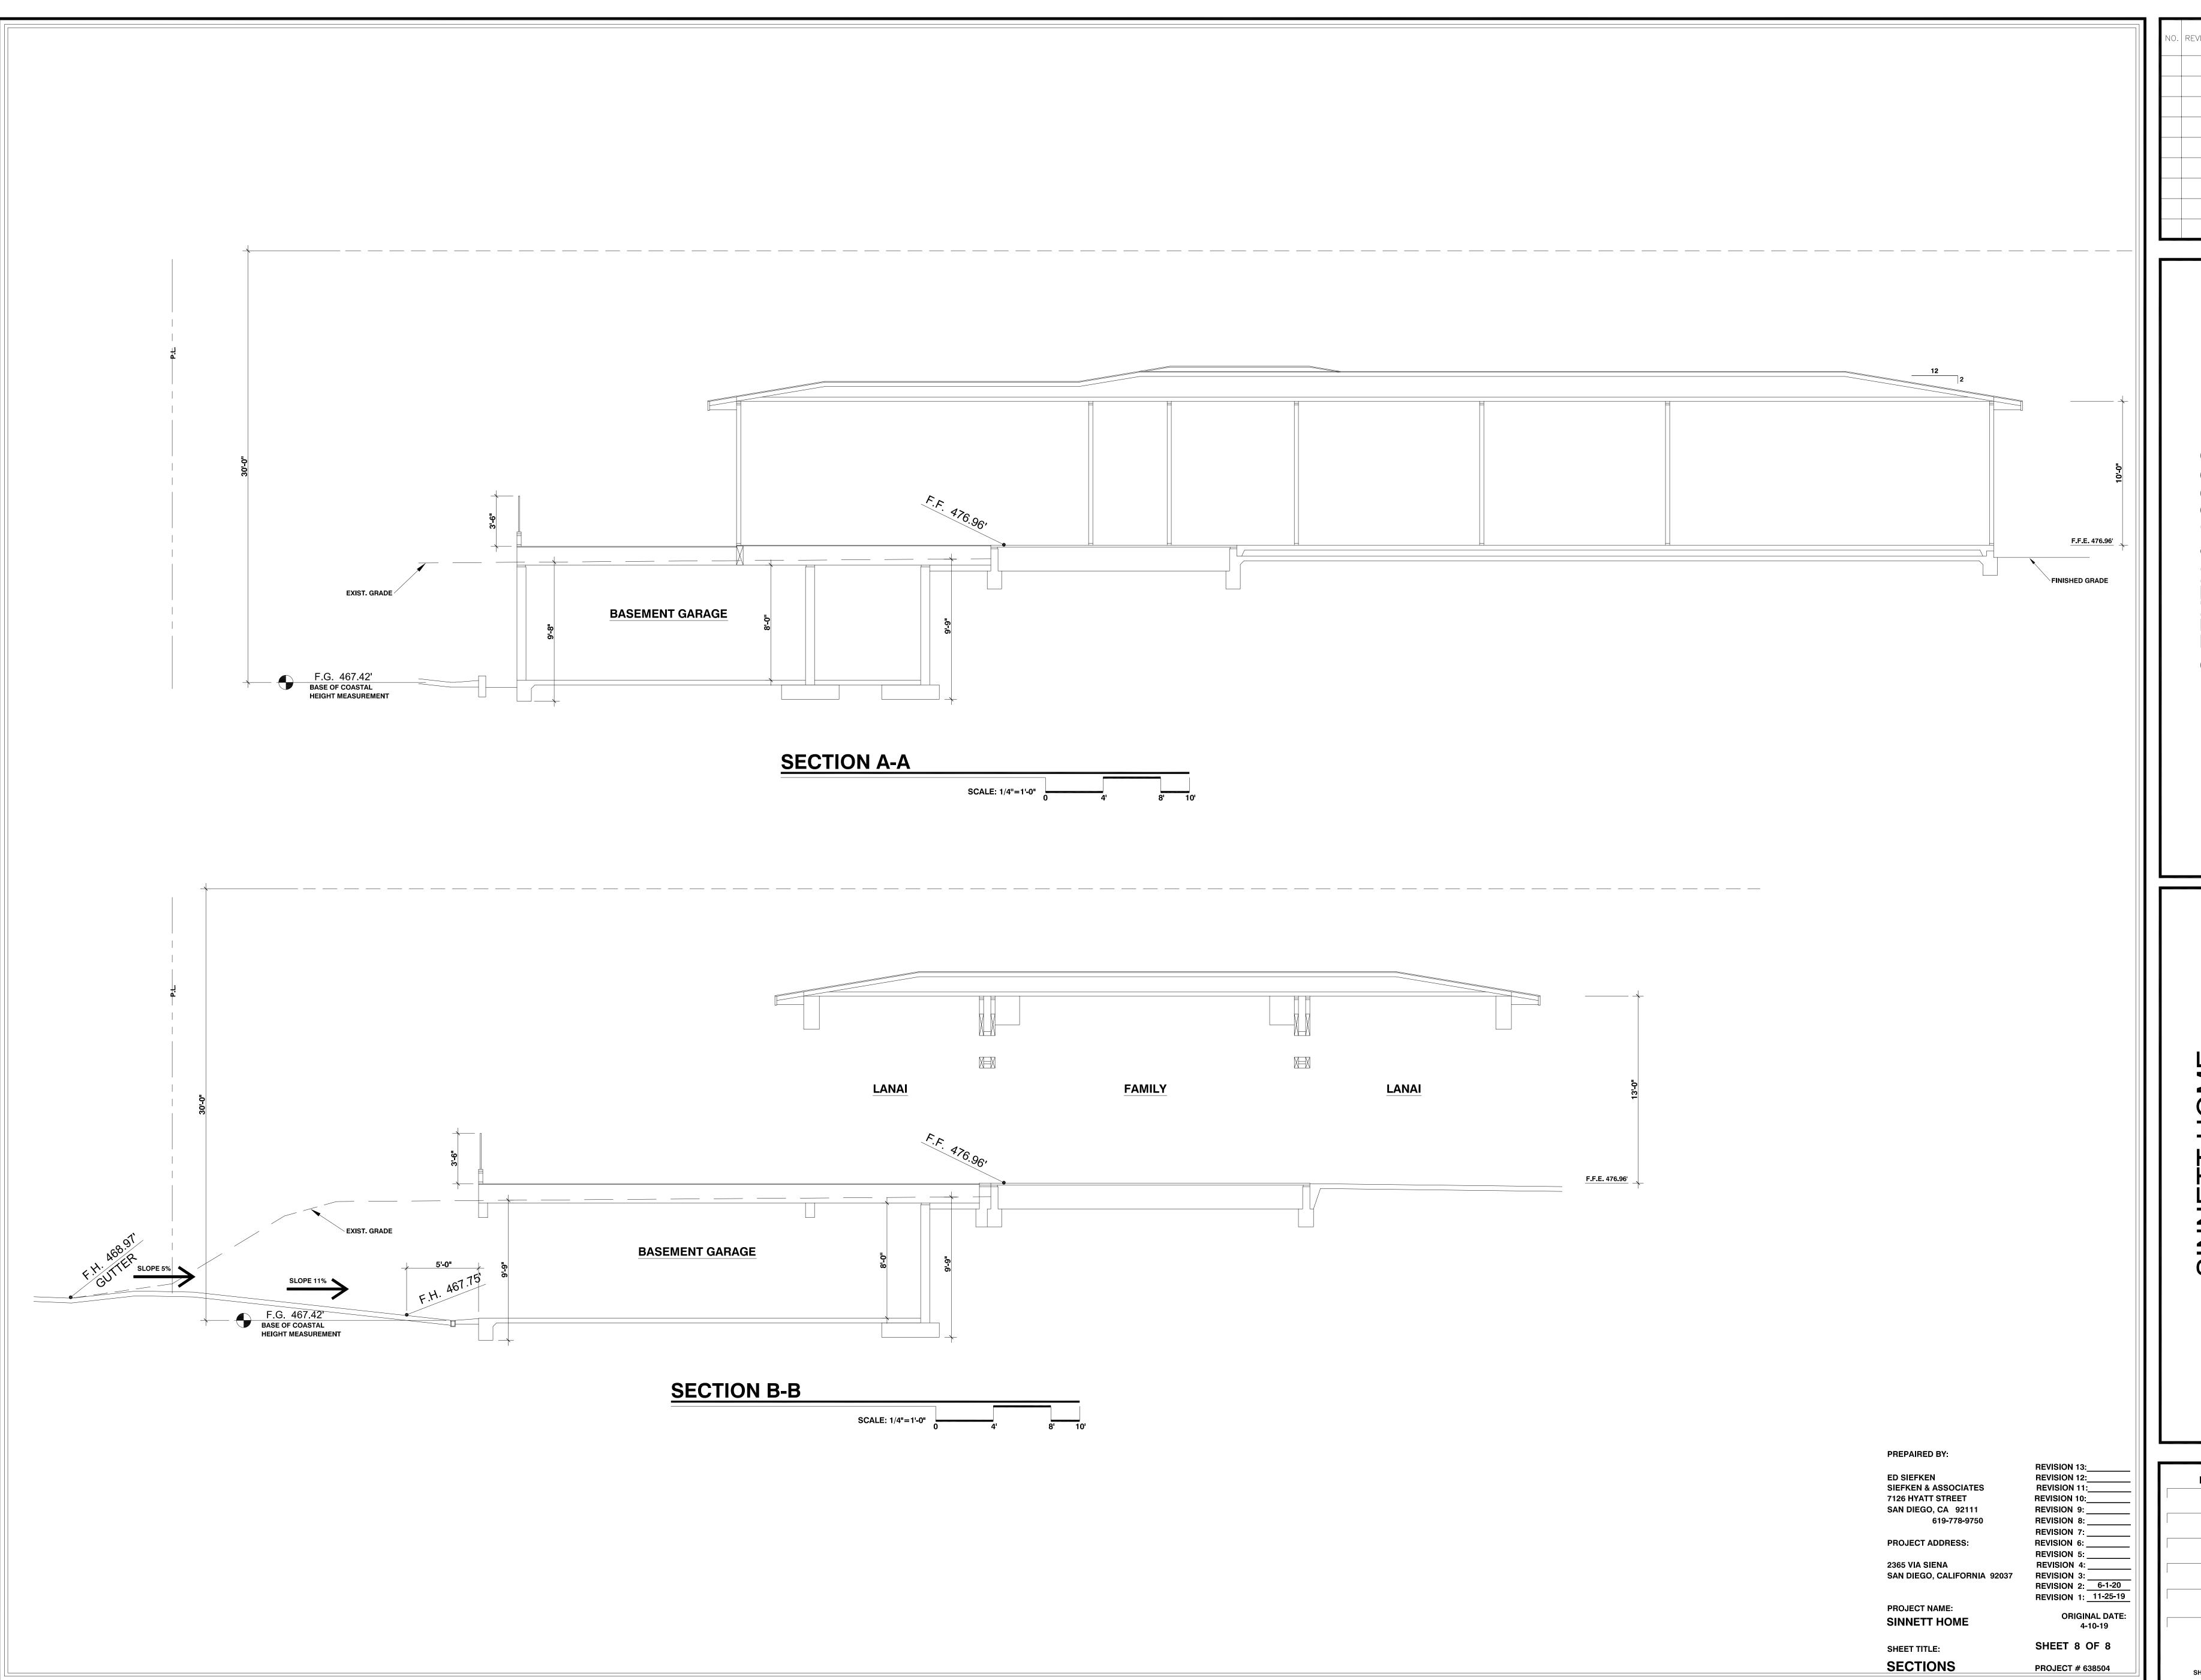

SSOC.
REET
) 778-9750

SIEFKEN & ASS 7126 HYATT STREE SAN DIEGO, CA (619) 77

SINNETT HOME
2365 VIA SIENA

DESIGN BY
ED SIEFKEN

DRAWN
ES


CHECKED

DATE
4-10-19

SCALE
NOTED

JOB NO.

SHEET

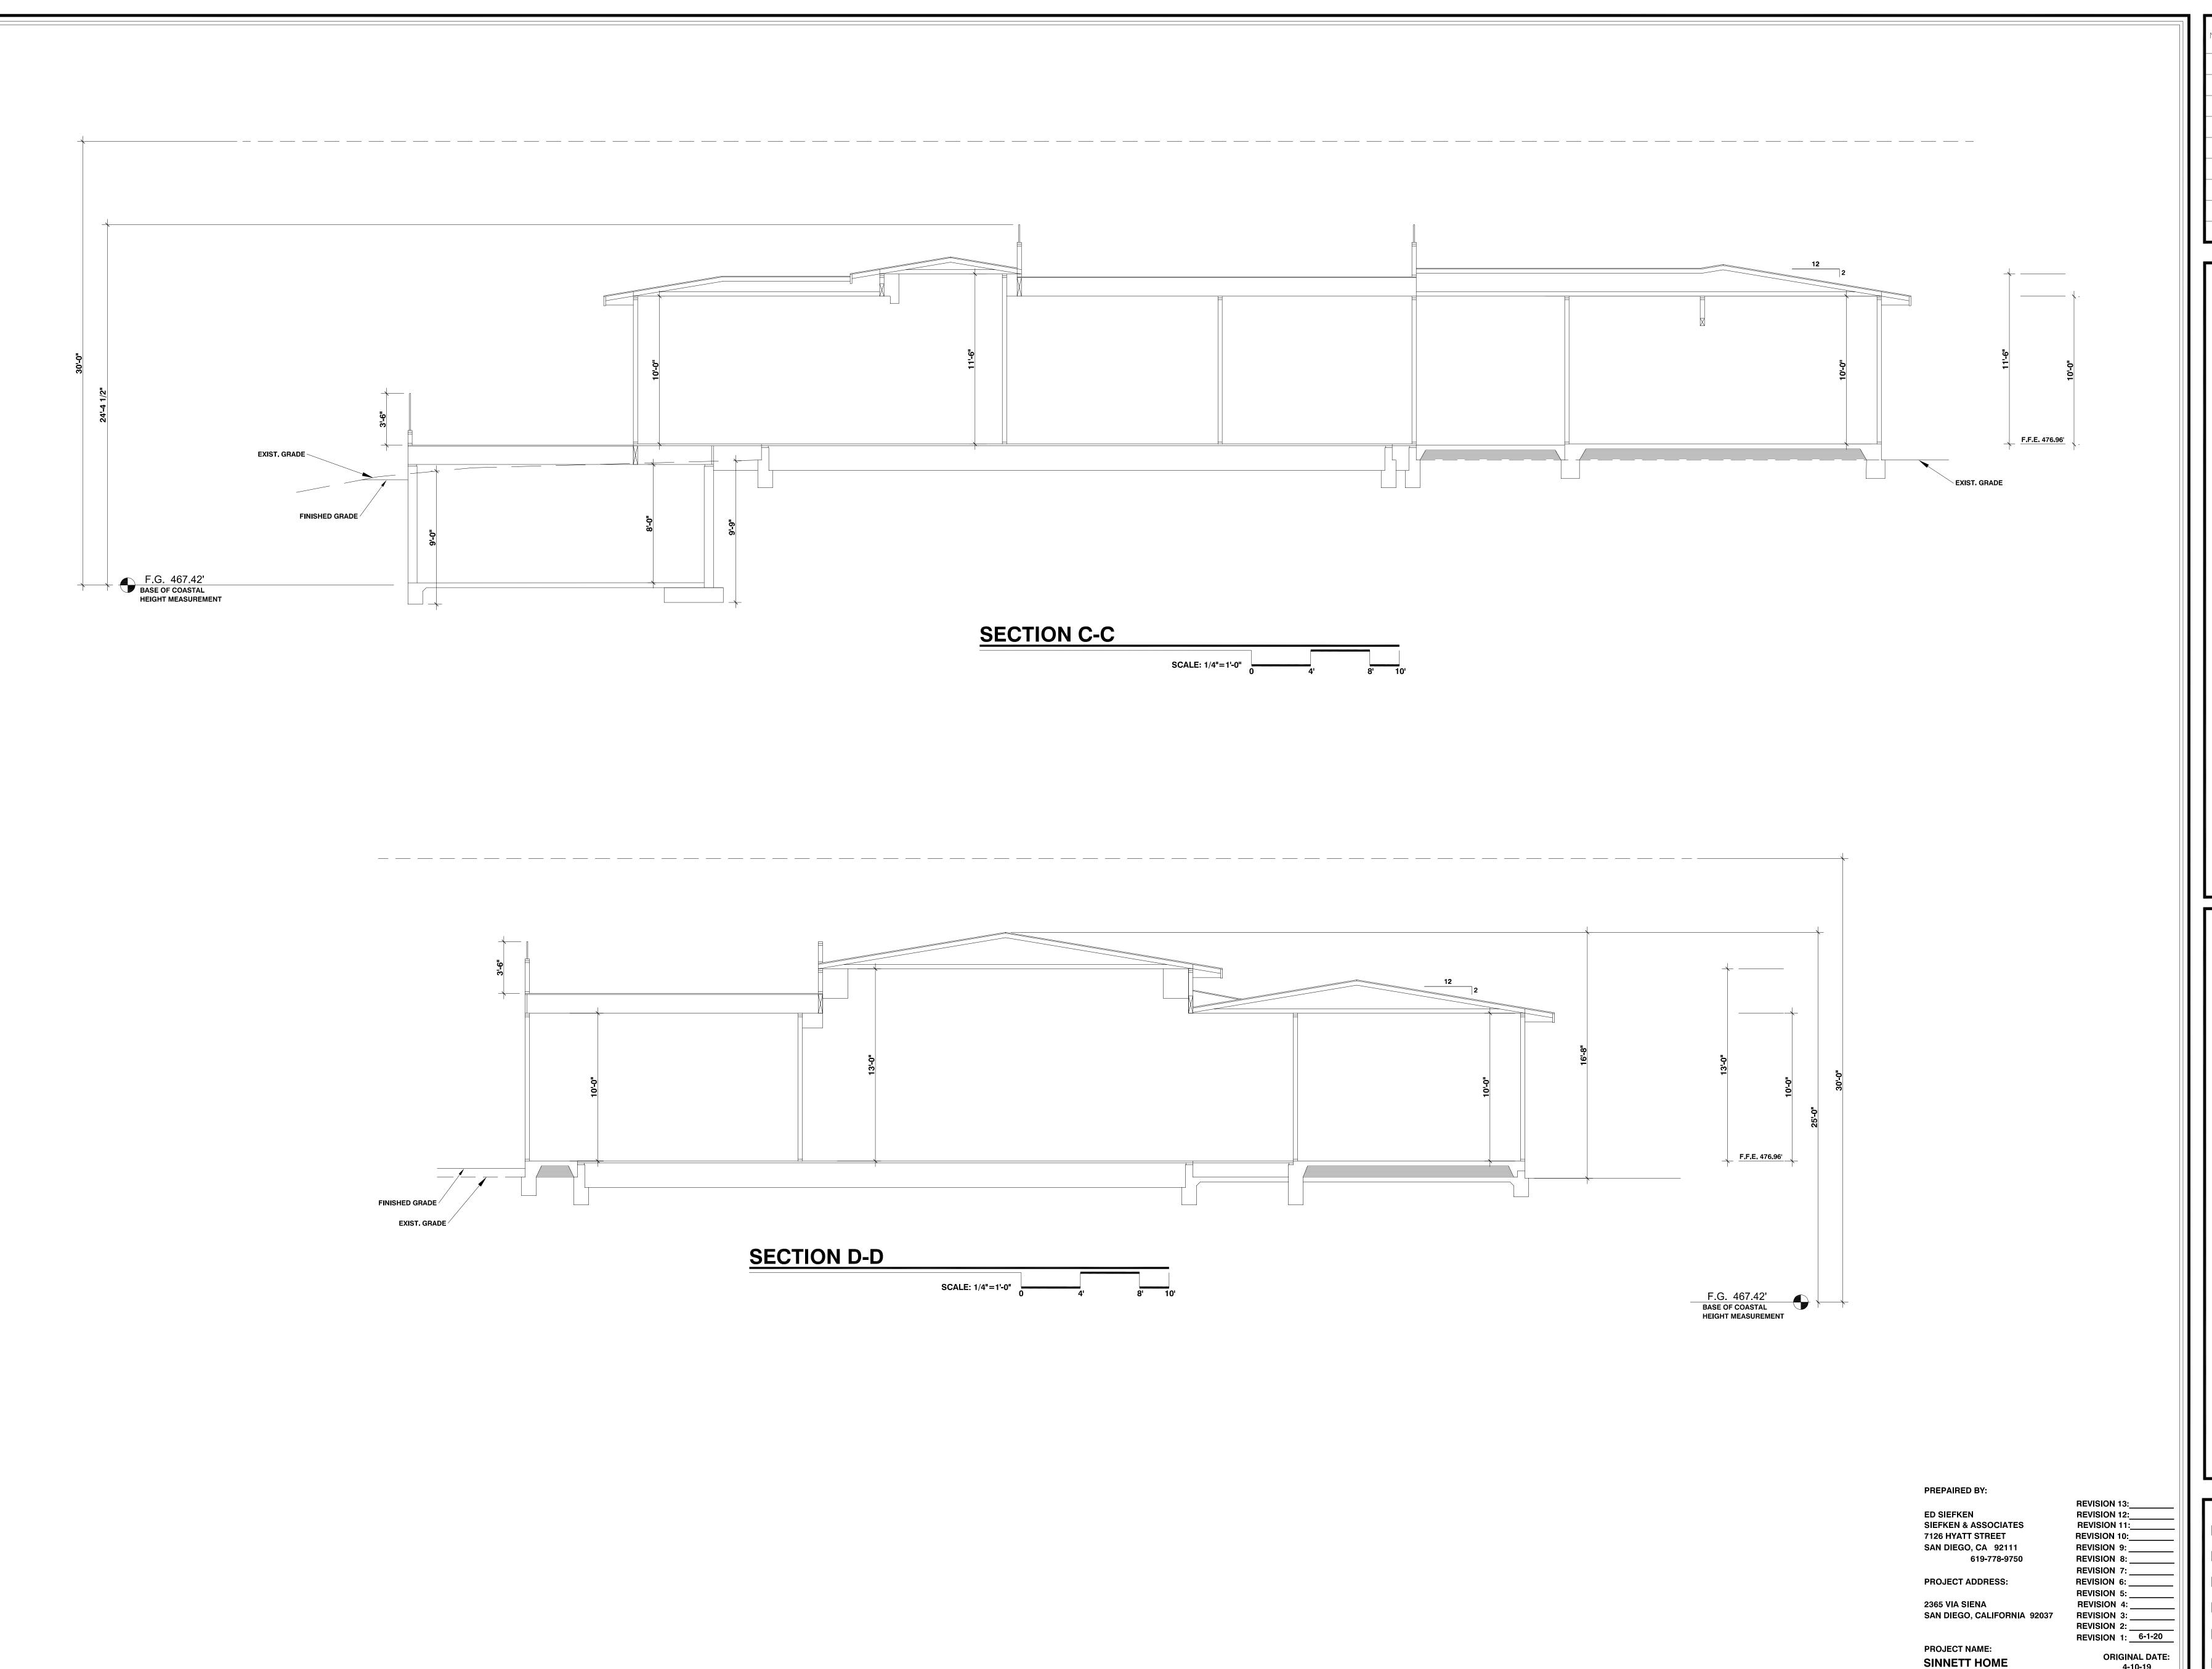

DESIGN BY **ED SIEFKEN** DRAWN ES CHECKED 4-10-19 SCALE NOTED JOB NO. SHEET

4-10-19

SHEET 9 OF 9

PROJECT # 638504

SHEET TITLE:

**SECTIONS** 

LOT AREA	12,345 SQ. FT.
GROSS FLOOR AREA	4,274 SQ. FT.
FRONT SETBACK	20'
SIDE SETBACK	10'
REAR SETBACK	10'
F.A.R.	.35



LOT AREA	12,150 SQ. FT.
GROSS FLOOR AREA	2,630 SQ. FT.
FRONT SETBACK	20"
SIDE SETBACK	10'
REAR SETBACK	25'
F.A.R	.22



LOT AREA	12,150 SQ. FT.
GROSS FLOOR AREA	2,748 SQ. FT.
FRONT SETBACK	20'
SIDE SETBACK	10'
REAR SETBACK	28'
F.A.R	.23



LOT AREA	12,030 SQ. FT.
GROSS FLOOR AREA	2,748 SQ. FT.
FRONT SETBACK	25'
SIDE SETBACK	10'
REAR SETBACK	10'
F.A.R.	. 23



## 7403 HILLSIDE DRIVE

LOT AREA	13,160 SQ. FT.
GROSS FLOOR AREA	7,556 SQ. FT.
FRONT SETBACK	10'
SIDE SETBACK	10'
REAR SETBACK	41'
F.A.R	.57



LOT AREA	12,010 SQ. FT.
GROSS FLOOR AREA	2,544 SQ. FT.
FRONT SETBACK	20'
SIDE SETBACK	7'
REAR SETBACK	38'
FA.R.	.21



LOT AREA	10,080 SQ. FT.
GROSS FLOOR AREA	2,529 SQ. FT.
FRONT SETBACK	20'
SIDE SETBACK	<b>7</b> '
REAR SETBACK	20'
F.A.R.	.25

