

Report to the Hearing Officer

DATE ISSUED: October 14, 2020 REPORT NO. HO-20-048

HEARING DATE: October 21, 2020

SUBJECT: MORGAN RESIDENCE CDP/SDP, Process Three Decision

PROJECT NUMBER: <u>635054</u>

OWNER/APPLICANT: POJ-WWW, LLC, a California Limited Liability Company, Owner and Applicant

SUMMARY:

<u>Issue:</u> Should the Hearing Officer approve a Coastal Development Permit and Site Development Permit to demolish an existing single-family residence and construct a new two-story, single-family residence with an attached three-car garage located at 8441 Whale Watch Way within the La Jolla Community Plan area?

<u>Staff Recommendation</u>: Approve Coastal Development Permit No. 2296383 and Site Development Permit No. 2296385.

<u>Community Planning Group Recommendation</u>: On January 9, 2020, the La Jolla Community Planning Association voted 14-0-1 to recommend approval of the project with no conditions. (Attachment 7).

<u>La Jolla Shores Advisory Board</u>: On February 18, 2020, the La Jolla Shores Advisory Board voted 4-0 to recommend approval of the project (Attachment 8).

Environmental Review: This project was determined to be categorically exempt from the California Environmental Quality Act (CEQA) pursuant to CEQA Section 15302, Replacement or Reconstruction (Attachment 6). This project is not pending an appeal of the environmental determination. The environmental exemption determination for this project was made on September 3, 2020, and the opportunity to appeal that determination ended September 18, 2020. There were no appeals filed on the environmental determination.

BACKGROUND:

The existing 4,453-square-foot, two-story, single-family residence on the 0.46-acre project site was built in 1983 and is located at 8441 Whale Watch Way, west of North Torrey Pines Road and east of La Jolla Shores Drive, approximately 2,325 feet from the Pacific Ocean coastline (Attachment 1). The

surrounding properties are fully developed and form a well-established single-family residential neighborhood of one and two-story homes (Attachment 3).

The project site is in the Single-Family (SF) Zone of the La Jolla Shores Planned District, Coastal (Non-Appealable Area 2) Overlay Zone, Coastal Height Limitation Overlay Zone, and Parking Impact (Campus Impact) Overlay Zone within the La Jolla Community Plan area. Review of resources maps, aerial and street level photography shows that the project site does not contain any sensitive biological resources, sensitive riparian habitat or any other identified habitat community. Furthermore, the project site does not contain, nor is it adjacent to land designated as Multiple Habitat Planning Area.

DISCUSSION:

This project proposes to demolish an existing single-family residence and construct a two-story, 11,652-square foot single-family residence with an attached three-car garage, swimming pool, and spa on portions of a 0.46-acre property. The project requires a Coastal Development Permit and a Site Development Permit. The Coastal Development Permit is required by the San Diego Municipal Code (SDMC) Section 126.0702 for the proposed demolition and construction on property within the Coastal Overlay Zone. The Site Development Permit is required by the SDMC Section 1510.0201(a) for the erection of any new building or structure, or remodeling, alteration, addition, or demolition of any existing structure within the La Jolla Shores Planned District.

The La Jolla Community Plan designates the site as Very Low Density (0-5 du/ac) residential land use (Attachment 2). The proposed residential use of the 0.46-acre property is consistent with that land use designation. The La Jolla Shores Planned District does not contain quantifiable development standards such as building setbacks and floor area ratio. Instead, the Planned District contains language in the General Design regulations which references the character of the area, being in general conformity to surrounding development and design principles. The surrounding neighborhood is a mix of large one and two-story homes with a mix of architectural styles. Based on a submitted neighborhood survey of the existing development pattern and bulk and scale comparisons, the proposed residence was found to be in general conformity with setbacks and bulk and scale as encouraged by the La Jolla Shores Planned District Ordinance SF Zone. The project conforms to all development regulations of the La Jolla Shores Planned District Ordinance's SF Zone, along with the applicable regulations of the Coastal Overlay Zone, such as the Coastal Height Limitation Overlay Zone and the Campus Parking Impact Overlay Zone.

The La Jolla Shores Planned District contains General Design Regulations, SDMC Section 1510.0301(b), which states that, "No structure shall be approved which is substantially like any other structure located on an adjacent parcel. Conversely, no structure will be approved that is so different in quality, form, materials, color, and relationship as to disrupt the architectural unity of the area." The proposed residence is designed to include board and batten siding, wood shingle siding, stone veneer and cooper metal roofing, which was found in general conformance with surrounding development and in conformance with the La Jolla Shores General Design Regulations.

The project site is located approximately 2,325 feet from the Pacific Ocean coastline with no identified public view or pedestrian access on or adjacent to the subject property, as identified within the La Jolla Community Plan and Local Coastal Land Use Plan. The project site is not located

between the ocean and the First Public Roadway (El Paseo Grande and North Torrey Pines Road). The project site is not identified as containing any form of public access by the La Jolla Community Plan and Local Coastal Program Land Use Plan. A review of the project's plans demonstrate conformance with public access and coastal public views, and staff has determined that the proposed redevelopment of this property is in conformance with the La Jolla Community Plan and Local Coastal Program Land Use Plan.

The project site does not contain any form of Environmentally Sensitive Lands. The proposed new residence will be located within the previously developed portion of the property. All surface storm water will be captured beneath pavers within the driveway located in the southeast portion of the property conveyed through a perforated pipe to the southeast corner of the property where it is discharged. The redevelopment of this site proposes 2,170 cubic yards of cut, 240 cubic yards of fill, for a total export of 1,930 cubic yards. The proposed grading will occur primarily within the building footprint for the proposed 1,348-square-foot subterranean area. The highest point of the proposed residence will be approximately 28'-4" feet in height, in compliance with the allowed 30-foot height limit per the Coastal Height Limitation Overlay Zone. Furthermore, the existing alley, located adjacent to the site, will be reconstructed to the full width required per current City Standards, and serve as vehicular access to the new residence.

CONCLUSION:

Staff has reviewed the proposal, including all the issues identified through the review process, and has determined that all project issues have been addressed. The project conforms with the Community Plan, the adopted City Council policies and regulations of the Land Development Code. Draft findings and conditions of approval are presented to the Hearing Officer for consideration. Staff recommends the Hearing Officer approve Coastal Development Permit No. 2296383 and Site Development Permit No. 2296385, as proposed.

ALTERNATIVES:

- 1. Approve Coastal Development Permit No. 2296383 and Site Development Permit No. 2296385, with modifications.
- 2. Deny Coastal Development Permit No. 2296383 and Site Development Permit No. 2296385, if the findings required to approve the project cannot be affirmed.

Respectfully submitted,

Sammi Ma

Development Project Manager


Attachments:


- 1. Project Location Map
- 2. Community Plan Land Use Map
- 3. Aerial Photograph
- 4. Draft Resolution with Findings
- 5. Draft Permit with Conditions
- 6. Notice of Exemption
- 7. Community Planning Association Recommendations
- 8. La Jolla Shores Planned District Advisory Board Recommendations
- 9. Ownership Disclosure Statement
- 10. Project Plans



Project Location Map

Morgan Residence CDP/SDP - 8441 Whale Watch Way Project No. 635054

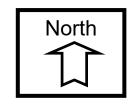

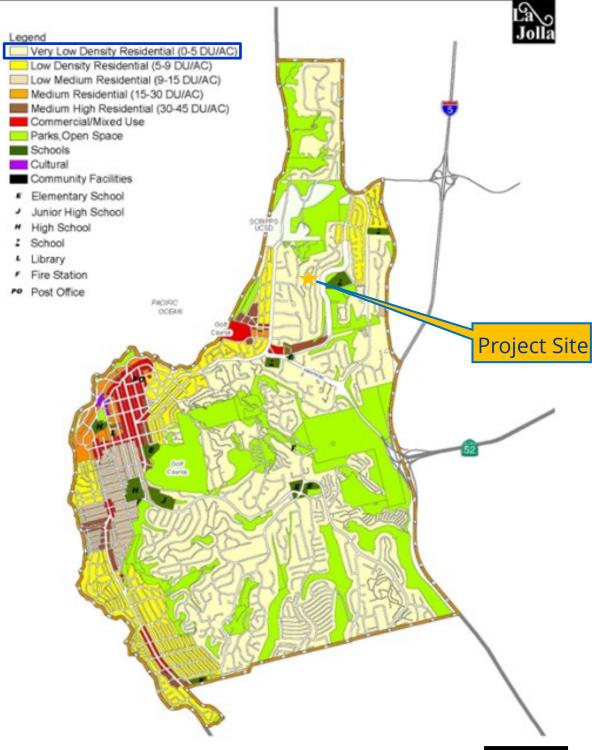



Community Plan Land Use Map

Morgan Residence CDP/SDP - 8441 Whale Watch Way Project No. 635054






Aerial Photograph

Morgan Residence CDP/SDP - 8441 Whale Watch Way Project No. 635054

Project Site

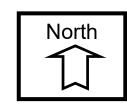

HEARING OFFICER RESOLUTION NO. _____ COASTAL DEVELOPMENT PERMIT NO. 2296383 SITE DEVELOPMENT PERMIT NO. 2296385

MORGAN RESIDENCE CDP/SDP - PROJECT NO. 635054

WHEREAS, POJ-WWW, LLC, a California Limited Liability Company, Owner/Permittee, filed an application with the City of San Diego for a permit to demolish an existing single-family residence, and construct a new single-family residence (as described in and by reference to the approved Exhibits "A" and corresponding conditions of approval for the associated Coastal Development Permit No. 2296383 and Site Development Permit No. 2296385), on portions of a 0.46-acre site;

WHEREAS, the project site is located at 8441 Whale Watch Way, in the Single-Family (SF) Zone of the La Jolla Shores Planned District, Coastal (Non-Appealable Area 2) Overlay Zone, Coastal Height Limitation Overlay Zone, and Parking Impact (Campus Impact) Overlay Zone within the La Jolla Community Plan area;

WHEREAS, the project site is legally described as Lot 25 of La Jolla Costa Dorado, in the City of San Diego, County of San Diego, State of California, according to Map Thereof No. 6865, filed in the Office of the County Recorder of San Diego County on February 26, 1971;

WHEREAS, on September 3, 2020, the City of San Diego, as Lead Agency, through the Development Services Department, made and issued an Environmental Determination that the project is exempt from the California Environmental Quality Act (CEQA) (Public Resources Code Section 21000 et seq.) under CEQA Guideline Section 15302, Replacement or Reconstruction; and there was no appeal of the Environmental Determination filed within the time period provided by San Diego Municipal Code Section 112.0520;

WHEREAS, on October 21, 2020, the Hearing Officer of the City of San Diego considered Coastal Development Permit No. 2296383 and Site Development Permit No. 2296385 pursuant to the Land Development Code of the City of San Diego;

BE IT RESOLVED by the Hearing Officer of the City of San Diego, that it adopts the following findings with respect to Coastal Development Permit No. 2296383 and Site Development Permit No. 2296385:

A. COASTAL DEVELOPMENT PERMIT [SDMC Section 126.0708]

- 1. <u>Findings for all Coastal Development Permits:</u>
 - a. The proposed coastal development will not encroach upon any existing physical accessway that is legally used by the public or any proposed public accessway identified in a Local Coastal Program land use plan; and the proposed coastal development will enhance and protect public views to and along the ocean and other scenic coastal areas as specified in the Local Coastal Program land use plan.

The project proposes to demolish an existing single-family residence and construct a new two-story, 11,652-square-foot single-family residence with an attached three-car garage, swimming pool and spa, located at 8441 Whale Watch Way. The proposed structure will be situated in approximately the same location as the existing residential structure. The 0.46-acre project site is located approximately 2,325 feet from the Pacific Ocean coastline. The proposed structure is contained within the existing legal lot area and will not encroach upon any existing or proposed physical access to the coast. The project site is not located between the First Public Roadway and the Pacific Ocean.

The project site is located on the north side Whale Watch Way. As identified within the La Jolla Community Plan (LJCP) and Local Coastal Land Use Plan (LCLUP), the project site is not located within or adjacent to public view corridors or partial vistas. The proposed building envelope will meet all setback requirements and there are no requested deviations from the San Diego Municipal Code (SDMC). Therefore, the proposed redevelopment will not encroach upon any existing physical accessway that is legally used by the public or any proposed public accessway identified in a Local Coastal Program land use plan; and the proposed coastal development will enhance and protect public views to and along the ocean and other scenic coastal areas as specified in the La Jolla Community Plan and Local Coastal Program Land Use Plan.

b. The proposed coastal development will not adversely affect environmentally sensitive lands.

The project proposes to demolish an existing single-family residence and construct a new two-story, 11,652-square-foot single-family residence with an attached three-car garage, swimming pool and spa, located at 8441 Whale Watch Way. The fully graded project site is currently developed with a single-family residence that was built in 1983 and within a developed residential neighborhood. The northern and eastern portion of the site contain slope areas that will remain with proposed retaining walls.

A Preliminary Geotechnical Investigation indicates that this area has been cut and filled to accommodate the existing home. All surface storm water will be captured beneath pavers within the driveway located in the southeast portion of the property conveyed through a perforated pipe to the southeast corner of the property where it is discharged. The redevelopment of this site proposes 2,170 cubic yards of cut, 240 cubic yards of fill, for a total export of 1,930 cubic yards. The proposed grading will occur primarily within the building footprint for the proposed 1,348-square-foot subterranean area.

Review of resources maps, aerial and street level photography shows that the project site does not contain any sensitive biological resources, sensitive riparian habitat or any other identified habitat community. Furthermore, the project site does not contain any Environmentally Sensitive Lands, nor is it adjacent to land designated as Multiple Habitat Planning Area. Additionally, an environmental review of this site has been conducted, in accordance with the California Environmental Quality Act (CEQA) Guidelines, the proposed project activity has been determined to be exempt from CEQA pursuant to Section 15302 of the State CEQA Guidelines, which addresses the replacement or reconstruction of existing structures and facilities. Thus, this proposed redevelopment of an existing residence will not adversely affect Environmentally Sensitive Lands.

c. The proposed coastal development is in conformity with the certified Local Coastal Program land use plan and complies with all regulations of the certified Implementation Program.

The project proposes to demolish an existing single-family residence and construct a new two-story, 11,652-square-foot single-family residence with an attached three-car garage, swimming pool and spa, located at 8441 Whale Watch Way. The project site has been designated in the LJCP and LCLUP as Very Low Density Residential (0-5 du/ac), which is implemented through the SF Zone. The proposed single-family residential use is consistent with that land use designation and density. Based on the review of the project plans, including building setbacks, drainage, lot coverage, building mass, building height, landscaping, public views, public access, as well as a neighborhood survey of the surrounding development pattern, the project's design was determined to be in general conformity with all of the applicable development regulations of the La Jolla Shores Planned District's SF-Zone and the Coastal Overlay Zone. Additionally, the project is not requesting any deviations from the SDMC and is adhering to all code regulations.

The project site is located approximately 2,325 feet from the Pacific Ocean coastline with no identified public view or pedestrian access on or adjacent to the subject property, as identified within the La Jolla Community Plan and Local Coastal Land Use Plan. The existing alley, located adjacent to the site, will be reconstructed to the full width required per current City Standards, and serve as vehicular access to the new residence. The proposed building envelope will be fully contained within the existing legal lot area. The highest point of the proposed residence will be approximately 28'-4" feet in height, in compliance with the allowed 30-foot height

limit per the Coastal Height Limitation Overlay Zone. Therefore, the proposed redevelopment of this property is in conformity with the certified La Jolla Community Plan and the certified Local Coastal Program Land Use Plan and complies with all regulations of the certified Implementation Program.

d. For every Coastal Development Permit issued for any coastal development between the nearest public road and the sea or the shoreline of any body of water located within the Coastal Overlay Zone the coastal development is in conformity with the public access and public recreation policies of Chapter 3 of the California Coastal Act.

The project proposes to demolish an existing single-family residence and construct a new two-story, 11,652-square-foot single-family residence with an attached three-car garage, swimming pool and spa, located at 8441 Whale Watch Way. The 0.46-acre site is located within an established residential neighborhood approximately 2,325 feet from the Pacific Ocean coastline and is not located within the First Public Roadway and the sea or the shoreline of any body of water located within the Coastal Overlay Zone. Therefore, the project is in compliance with the public access and public recreation policies of Chapter 3 of the California Coastal Act.

B. <u>SITE DEVELOPMENT PERMIT [SDMC Section 126.0505]</u>

- 2. <u>Findings for all Site Development Permits:</u>
 - a. The proposed development will not adversely affect the applicable land use plan.

The project proposes to demolish an existing single-family residence and construct a new two-story, 11,652-square-foot single-family residence with an attached three-car garage, swimming pool and spa, located at 8441 Whale Watch Way. The proposed project is located in an area identified as Very low density (0-5 du/ac) residential within the La Jolla Community Plan. The proposed residential use of the 0.46-acre property is consistent with that land use designation. The La Jolla Shores Planned District does not contain quantifiable development standards such as building setbacks and floor area ratio. Instead, the Planned District contains language in the General Design regulations which references the character of the area, being in general conformity to surrounding development and design principles. The surrounding neighborhood is a mix of large one and two-story homes with a mix of architectural styles. Based on a submitted neighborhood survey of the existing development pattern and bulk and scale comparisons, the proposed residence was found to be in general conformity with setbacks and bulk and scale as encouraged by the La Jolla Shores Planned District Ordinance SF Zone. The project conforms to all development regulations of the La Jolla Shores Planned District Ordinance's SF Zone, along with the applicable regulations of the Coastal Overlay Zone, such as the Coastal Height Limitation Overlay Zone and the Campus Parking Impact Overlay Zone.

The La Jolla Shores Planned District contains General Design Regulations, SDMC Section 1510.0301(b), which states that, "No structure shall be approved which is substantially like any other structure located on an adjacent parcel. Conversely, no structure will be approved that is so different in quality, form, materials, color, and relationship as to disrupt the architectural unity of the area." The proposed residence is designed to include board and batten siding, wood shingle siding, stone veneer and cooper metal roofing, which was found in general conformance with surrounding development and in conformance with the La Jolla Shores General Design Regulations.

The project site does not contain, nor is it adjacent to, any identified public access or any identified public views identified by the La Jolla Community Plan and Local Coastal Land Use Plan. Based on the review of the project plans along with a setback and bulk/scale neighborhood survey of the surrounding development pattern, the proposed design and materials for the siding and roofing the proposed single-family dwelling unit was found consistent with the SF Zone of the La Jolla Shores Planned District development regulations, allowed density and design recommendations. Thus, this single-family residential dwelling unit redevelopment will not adversely affect the La Jolla Community land use plan.

b. The proposed development will not be detrimental to the public health, safety and welfare.

The project proposes to demolish an existing single-family residence and construct a new two-story, 11,652-square-foot single-family residence with an attached three-car garage, swimming pool and spa, located at 8441 Whale Watch Way. A Preliminary Geotechnical Investigation indicates that this area has been cut and filled to accommodate the existing home. All surface storm water will be captured beneath pavers within the driveway located in the southeast portion of the property conveyed through a perforated pipe to the southeast corner of the property where it is discharged. The redevelopment of this site proposes 2,170 cubic yards of cut, 240 cubic yards of fill, for a total export of 1,930 cubic yards. The proposed grading will occur primarily within the building footprint for the proposed 1,348-square-foot subterranean area. The highest point of the proposed residence will be approximately 28'-4" feet in height, in compliance with the allowed 30-foot height limit per the Coastal Height Limitation Overlay Zone.

The permit controlling the development and continued use of the proposed project for this site contains specific conditions addressing compliance with the City's codes, policies, regulations and other regional, state, and federal regulations. That includes public improvement requirement to reconstruct of the existing alley to the full width required per current City Standards. The conditions of approval will require the review and approval of all construction plans by staff to determine that the project will comply with all regulations prior to the issuance of any construction permits. Construction activities will be inspected by certified building and engineering inspectors to assure construction is in accordance with the approved plans and with

ATTACHMENT 4

all regulations. Therefore, the project will not be detrimental to the public health,

safety, and welfare.

c. The proposed development will comply with the regulations of the Land Development Code including any allowable deviations pursuant to the Land

Development Code.

The project proposes to demolish an existing single-family residence and construct a new two-story, 11,652-square-foot single-family residence with an attached three-car garage, swimming pool and spa, located at 8441 Whale Watch Way. The La Jolla Community Plan designates the site as Very Low Density (0-5 du/ac) residential land use. The proposed residential use of the 0.46-acre property is consistent with that land use designation. City staff reviewed the building setbacks, drainage, lot coverage, building mass, building height, landscaping, public views, public access, and found that the proposed project complies with all of the required development regulations. The project does not propose any variances or allowable deviations to the development regulations of the Land Development Code. Therefore, the

proposed development will comply with the regulations of the Land Development

Code.

The above findings are supported by the minutes, maps and exhibits, all of which are

incorporated herein by this reference.

BE IT FURTHER RESOLVED that, based on the findings hereinbefore adopted by the Hearing

Officer, Coastal Development Permit No. 2296383 and Site Development Permit No. 2296385 are

hereby GRANTED by the Hearing Officer to the referenced Owner/Permittee, in the form, exhibits,

terms and conditions as set forth in Permit No. 2296383 and No. 2296385, a copy of which is

attached hereto and made a part hereof.

Sammi Ma

Development Project Manager

Development Services

Adopted on: October 21, 2020

IO#: 24008239



RECORDING REQUESTED BY

CITY OF SAN DIEGO DEVELOPMENT SERVICES PERMIT INTAKE, MAIL STATION 501

WHEN RECORDED MAIL TO PROJECT MANAGEMENT PERMIT CLERK MAIL STATION 501

INTERNAL ORDER NUMBER: 24008239

SPACE ABOVE THIS LINE FOR RECORDER'S USE

COASTAL DEVELOPMENT PERMIT NO. 2296383 SITE DEVELOPMENT PERMIT NO. 2296385 MORGAN RESIDENCE CDP/SDP - PROJECT NO. 635054 HEARING OFFICER

This Coastal Development Permit No. 2296383 and Site Development Permit No. 2296385 are granted by the Hearing Officer of the City of San Diego to POJ-WWW, LLC, a California Limited Liability Company, Owner/Permittee, pursuant to San Diego Municipal Code [SDMC] sections 126.0702 and 1510.0201. The 0.46-acre site is located at 8441 Whale Watch Way, in the Single-Family (SF) Zone of the La Jolla Shores Planned District, Coastal (Non-Appealable Area 2) Overlay Zone, Coastal Height Limitation Overlay Zone, and Parking Impact (Campus Impact) Overlay Zone within the La Jolla Community Plan area. The project site is legally described as: Lot 25, of La Jolla Costa Dorado, in the City of San Diego, County of San Diego, State of California, According to Map Thereof No. 6865, Filed in the office of the County Recorder of San Diego County February 26, 1971.

Subject to the terms and conditions set forth in this Permit, permission is granted to Owner/Permittee to demolish an existing single-family residence, and construct a new single-family residence, as described and identified by size, dimension, quantity, type, and location on the approved exhibits [Exhibit "A"] dated October 21, 2020, on file in the Development Services Department.

The project shall include:

- a. Demolition of an existing single-family residence, and construction of a new two-story, 11,652-square foot single-family residence with an attached three-car garage, swimming pool and spa, on a 0.46-acre site;
- b. Landscaping (planting, irrigation and landscape related improvements);
- c. Off-street parking;
- d. Associated site walls, terrace, deck, courtyard, trash receptacles, exterior lighting; and

e. Public and private accessory improvements determined by the Development Services Department to be consistent with the land use and development standards for this site in accordance with the adopted community plan, the California Environmental Quality Act [CEQA] and the CEQA Guidelines, the City Engineer's requirements, zoning regulations, conditions of this Permit, and any other applicable regulations of the SDMC.

STANDARD REQUIREMENTS:

- 1. This permit must be utilized within thirty-six (36) months after the date on which all rights of appeal have expired. If this permit is not utilized in accordance with Chapter 12, Article 6, Division 1 of the SDMC within the 36-month period, this permit shall be void unless an Extension of Time has been granted. Any such Extension of Time must meet all SDMC requirements and applicable guidelines in effect at the time the extension is considered by the appropriate decision maker. This permit must be utilized by November 4, 2023.
- 2. No permit for the construction, occupancy, or operation of any facility or improvement described herein shall be granted, nor shall any activity authorized by this Permit be conducted on the premises until:
 - a. The Owner/Permittee signs and returns the Permit to the Development Services Department; and
 - b. The Permit is recorded in the Office of the San Diego County Recorder.
- 3. While this Permit is in effect, the subject property shall be used only for the purposes and under the terms and conditions set forth in this Permit unless otherwise authorized by the appropriate City decision maker.
- 4. This Permit is a covenant running with the subject property and all of the requirements and conditions of this Permit and related documents shall be binding upon the Owner/Permittee and any successor(s) in interest.
- 5. The continued use of this Permit shall be subject to the regulations of this and any other applicable governmental agency.
- 6. Issuance of this Permit by the City of San Diego does not authorize the Owner/Permittee for this Permit to violate any Federal, State or City laws, ordinances, regulations or policies including, but not limited to, the Endangered Species Act of 1973 [ESA] and any amendments thereto (16 U.S.C. § 1531 et seq.).
- 7. The Owner/Permittee shall secure all necessary building permits. The Owner/Permittee is informed that to secure these permits, substantial building modifications and site improvements may be required to comply with applicable building, fire, mechanical, and plumbing codes, and State and Federal disability access laws.

- 8. Construction plans shall be in substantial conformity to Exhibit "A." Changes, modifications, or alterations to the construction plans are prohibited unless appropriate application(s) or amendment(s) to this Permit have been granted.
- 9. All of the conditions contained in this Permit have been considered and were determined necessary to make the findings required for approval of this Permit. The Permit holder is required to comply with each and every condition in order to maintain the entitlements that are granted by this Permit.

If any condition of this Permit, on a legal challenge by the Owner/Permittee of this Permit, is found or held by a court of competent jurisdiction to be invalid, unenforceable, or unreasonable, this Permit shall be void. However, in such an event, the Owner/Permittee shall have the right, by paying applicable processing fees, to bring a request for a new permit without the "invalid" conditions(s) back to the discretionary body which approved the Permit for a determination by that body as to whether all of the findings necessary for the issuance of the proposed permit can still be made in the absence of the "invalid" condition(s). Such hearing shall be a hearing de novo, and the discretionary body shall have the absolute right to approve, disapprove, or modify the proposed permit and the condition(s) contained therein.

10. The Owner/Permittee shall defend, indemnify, and hold harmless the City, its agents, officers, and employees from any and all claims, actions, proceedings, damages, judgments, or costs, including attorney's fees, against the City or its agents, officers, or employees, relating to the issuance of this permit including, but not limited to, any action to attack, set aside, void, challenge, or annul this development approval and any environmental document or decision. The City will promptly notify Owner/Permittee of any claim, action, or proceeding and, if the City should fail to cooperate fully in the defense, the Owner/Permittee shall not thereafter be responsible to defend, indemnify, and hold harmless the City or its agents, officers, and employees. The City may elect to conduct its own defense, participate in its own defense, or obtain independent legal counsel in defense of any claim related to this indemnification. In the event of such election, Owner/Permittee shall pay all of the costs related thereto, including without limitation reasonable attorney's fees and costs. In the event of a disagreement between the City and Owner/Permittee regarding litigation issues, the City shall have the authority to control the litigation and make litigation related decisions, including, but not limited to, settlement or other disposition of the matter. However, the Owner/Permittee shall not be required to pay or perform any settlement unless such settlement is approved by Owner/Permittee.

CLIMATE ACTION PLAN REQUIREMENTS:

11. Owner/Permittee shall comply with the Climate Action Plan (CAP) Consistency Checklist stamped as Exhibit "A." Prior to issuance of any construction permit, all CAP strategies shall be noted within the first three (3) sheets of the construction plans under the heading "Climate Action Plan Requirements" and shall be enforced and implemented to the satisfaction of the Development Services Department.

ENGINEERING REQUIREMENTS:

- 12. Prior to the issuance of any construction permits, the Owner/Permittee shall assure, by permit and bond, to reconstruct the existing alley, full width per current City Standards, adjacent to the site, satisfactory to the City Engineer.
- 13. The drainage system proposed for this development as shown on the site plan, is private and subject to approval by the City Engineer.
- 14. Prior to the issuance of any construction permits, the Owner/Permittee shall incorporate any construction Best Management Practices necessary to comply with Chapter 14, Article 2, Division 1 (Grading Regulations) of the SDMC, into the construction plans or specifications.
- 15. Prior to the issuance of any construction permits, the Owner/Permittee shall enter into an agreement to indemnify, protect and hold harmless the City, its officials and employees from any and all claims, demands, causes or action, liability or loss because of, or arising out of surface drainage entering into the property from the Right-of-Way due to the design of the existing driveway.
- 16. Prior to the issuance of any construction permits, the applicant shall submit a Technical Report that will be subject to final review and approval by the City Engineer, based on the Storm Water Standards in effect at the time of the construction permit issuance.
- 17. Prior to the issuance of any construction permits, the Owner/Permittee shall enter into a Maintenance Agreement for the ongoing permanent BMP maintenance, satisfactory to the City Engineer.
- 18. Prior to the issuance of any construction permits, the Owner/Permittee shall submit a Water Pollution Control Plan (WPCP). The WPCP shall be prepared in accordance with the guidelines in Part 2 Construction BMP Standards Chapter 4 of the City's Storm Water Standards.

LANDSCAPE REQUIREMENTS:

- 19. Prior to issuance of any construction permits for structures, the Owner/Permittee shall submit complete landscape and irrigation construction documents to the Development Services Department for approval. The construction documents shall be consistent with approved Exhibit "A", the La Jolla Shores Planned District Ordinance, the La Jolla Community Plan, and the Land Development Manual Landscape Standards.
- 20. The Owner/Permittee shall be responsible for the maintenance of all landscape improvements shown on the approved plans, including in the right-of-way, unless long-term maintenance of said landscaping will be the responsibility of a Landscape Maintenance District or other approved entity. All required landscape shall be maintained consistent with the Landscape Standards in a disease, weed, and litter free condition at all times. Severe pruning or "topping" of trees is not permitted.

21. If any required landscape (including existing or new plantings, hardscape, landscape features, etc.) indicated on the approved construction document plans is damaged or removed, it shall be repaired and/or replaced in kind and equivalent size per the approved documents to the satisfaction of the Development Services Department within 30 days of damage.

PLANNING/DESIGN REQUIREMENTS:

- 22. The automobile parking spaces must be constructed in accordance with the requirements of the SDMC. All on-site parking stalls and aisle widths shall be in compliance with requirements of the City's Land Development Code and shall not be converted and/or utilized for any other purpose, unless otherwise authorized in writing authorized by the appropriate City decision maker in accordance with the SDMC.
- 23. A topographical survey conforming to the provisions of the SDMC may be required if it is determined, during construction, that there may be a conflict between the building(s) under construction and a condition of this Permit or a regulation of the underlying zone. The cost of any such survey shall be borne by the Owner/Permittee.
- 24. All private outdoor lighting shall be shaded and adjusted to fall on the same premises where such lights are located and in accordance with the applicable regulations in the SDMC.

GEOLOGY REQUIREMENTS:

- 25. The Owner/Permittee shall submit a geotechnical investigation report or update letter that specifically addresses the proposed construction plans. The geotechnical investigation report or update letter shall be reviewed for adequacy by the Geology Section of the Development Services Department prior to issuance of any construction permits.
- 26. The Owner/Permittee shall submit an as-graded geotechnical report prepared in accordance with the City's "Guidelines for Geotechnical Reports" following completion of the grading. The asgraded geotechnical report shall be reviewed for adequacy by the Geology Section of the Development Services Department prior to exoneration of the bond and grading permit close-out.

INFORMATION ONLY:

- The issuance of this discretionary permit alone does not allow the immediate commencement or continued operation of the proposed use on site. Any operation allowed by this discretionary permit may only begin or recommence after all conditions listed on this permit are fully completed and all required ministerial permits have been issued and received final inspection.
- Any party on whom fees, dedications, reservations, or other exactions have been imposed as
 conditions of approval of this Permit, may protest the imposition within ninety days of the
 approval of this development permit by filing a written protest with the City Clerk pursuant to
 California Government Code-section 66020.

• This development may be subject to impact fees at the time of construction permit issuance.

APPROVED by the Hearing Officer of the City of San Diego on October 21, 2020, by Resolution No. XXXX.



ATTACHMENT 5

Permit Type/PTS Approval No.: CDP No. 2296383 & SDP No. 2296385

Date of Approval: October 21, 2020

	ALITHENTICATED!	BY THE CITY OF SAN DI	EGO DEVELOPMENT	SERVICES DEPARTMEN
--	-----------------	-----------------------	------------------------	--------------------

Sammi Ma
Development Project Manager

NOTE: Notary acknowledgment must be attached per Civil Code section 1189 et seq.

The undersigned Owner/Permittee, by execution hereof, agrees to each and every condition of this Permit and promises to perform each and every obligation of Owner/Permittee hereunder.

Owner/Permittee

By _____

I. Ronnie Morgan Managing Member POJ-WWW, LLC

NOTE: Notary acknowledgments must be attached per Civil Code section 1189 et seq.

NOTICE OF EXEMPTION

(Check one or both TO:X	Recorder/County Clerk P.O. Box 1750, MS A-33 1600 Pacific Hwy, Room 260 San Diego, CA 92101-2400 Office of Planning and Research 1400 Tenth Street, Room 121 Sacramento, CA 95814	FROM:	City of San Diego Development Services Department 1222 First Avenue, MS 501 San Diego, CA 92101
Project Name	e/Number: Morgan Residence CDP SDP / 63	35054	SCH No.: N/A
Project Locat	ion-Specific: 8441 Whale Watch Way, San [iego, CA 92	037
Project Locat	ion-City/County: San Diego/San Diego		
Coastal Develonew 11,952-so developed lot, du/ac) pursua (LJSPD-Single l	of nature and purpose of the Project: The opment Permit (CDP) for the demolition of a quare-foot single-family residence with asso, located at 8441 Whale Watch Way. The 0.44 nt to the La Jolla Community Planning Area Family). The project is also subject to Coasta Impact (Campus), and Council District 1. (LE	n existing si ciated hards s-acre site is and is subje l Overlay (N-	ngle-family residence and construction of a cape and landscape on a previously designated Low Density Residential (5-9 ct to the La Jolla Shore Planed District zone -APP-2), Coastal Height Limitation Overlay
Name of Pub	lic Agency Approving Project: City of San	Diego	
Name of Pers	Del N	Huntsman 1arine View, Iar, CA 9201 792-2800	
() Minist () Declar () Emerg	us: (CHECK ONE) serial (Sec. 21080(b)(1); 15268); red Emergency (Sec. 21080(b)(3); 15269(a)); gency Project (Sec. 21080(b)(4); 15269 (b)(c) porical Exemption: CEQA Guidelines Section) 15302, Repla	acement or Reconstruction

Reasons why project is exempt: The City of San Diego determined that the project would qualify to be categorically exempt from CEQA pursuant to Section 15302, Replacement or Reconstruction. The exemption allows for the replacement or reconstruction of existing structures and facilities where the new structure will be located on the same site and will have substantially the same purpose and capacity as the structure replaced. The project as included in the description of this notice includes demolition of an existing single-family residence and construction of a new single-family residence on the same site and does not propose a change in density. Additionally, none of the exceptions listed in CEQA Section 15300.2 would apply.

ATTACHMENT 6

Lead Agency Contact Person: Rachael Ferrell

If filed by applicant:

1. Attach certified document of exemption finding.

2. Has a notice of exemption been filed by the public agency approving the project? () Yes () No

It is hereby certified that the City of San Diego has determined the above activity to be exempt from CEQA

Senior Planner

Signature/Title

Check One:

(X) Signed By Lead Agency

Date Received for Filing with County Clerk or OPR:

() Signed by Applicant



City of San Diego Development Services 1222 First Ave., MS-302 San Diego, CA 92101

Community Planning Committee Distribution Form Part 2

Project Name:					Project Number: Distribution Date:		
Morgan Residence				63	335054	12/16/2	019
Project Scope/Location:							
8441 Whale Watch Way Project Description: (Process 3) Site Development demolish an existing residence and construct a tw 0.46-acre property. The project site is located at 8 Jolla Shores Planned District, Coastal (Non-Appea Overlay Zone, Parking Impact (Campus Impact) Coastal within Council District 1	vo-story 3441 W alable)	y, 11,952 /hale Wat) Overlay	squii tch W Zone	re-fo /ay w e. Co	ot single fan vithin the SF astal Height	ily residence on Zone of the La Limitation	+
Applicant Name:			Applicant Phone Number:				
Scott Huntsman					858-792	2-2800	
Project Manager:	Phon	e Number	r:	Fax	Number:	E-mail Address:	
Glen Gargas	(619)) 446-51	142	(619	9) 321-3200		
Committee Recommendations (To be completed for Initial Review):							
✓ Vote to Approve		Members 14	Yes	M	lembers No	Members Abstain	
Vote to Approve With Conditions Listed Below		Members 14	Yes	М	lembers No	Members Abstain	
☐ Vote to Approve With Non-Binding Recommendations Listed Belo		Members 14	Yes	М	embers No	Members Abstain	
☐ Vote to Deny	1	Members 14	Yes	M	embers No	Members Abstain	
No Action (Please specify, e.g., Need further info quorum, etc.)	rmatio	on, Split v	ote, I	Lack	of	Continued	
CONDITIONS:							
approved on consent, 1/9/2020							
NAME: Suzanne Weissman					TITLE:	Secretary	
SIGNATURE: Suzanne W	eiss	man			DATE:	1/15/2020	
Attach Additional Pages If Necessary. Please return to: Project Management Division City of San Diego Development Services Department 1222 First Avenue, MS 302 San Diego, CA 92101							
Printed on recycled paper. Visit ou Upon request, this information is ava	ir web si	ite at www.	sandie e form	ego.go	ov/developmen	-services.	



THE CITY OF SAN DIEGO

La Jolla Shores Planned District Advisory Board APPROVED Meeting Minutes for February 18, 2020

615 Prospect Street La Jolla, CA 92037

Trustee	Attendance	Trustee	Attendance
Jane Potter	Present	Herbert Lazerow	Present
Andrea Moser	Present	Susanne Weissman	Present

1. Call to Order: 11:00 a.m.

Potter called the meeting to order at 11:00 a.m.

2. Approval of the Agenda

Lazerow moved to approve the agenda. Moser seconded. Motion approved 4-0-0.

3. Approval of the Minutes

Board member opined that minutes for January were transposed with agenda for February. The presenter for Espinoza in January was absent and the Calle Frescota project was continued. Both returned and were agendized for February. Board member requested to add "delay" for "decay" in comment. Lazerow moved to approve as amended. Moser seconded. Motion passed 4-0-0.

4. Public Comment:

None.

5. Project Review

ACTION ITEM A

Project: 651601 - Calle Frescota Residence

Location: 2175 Calle Frescota7834 Esterel Drive APN: 346-22-0400

Presented by: Bejan Arfaa, bejan@idm.sdcoxmail.com 619-293-3118 x

Description: Permit existing non-permitted 550 sf single story addition with deck

above.

Presentation

- Presenter said the board suggested two alternatives at the previous meeting, either: 1) get permission from the neighbor for the deck, or 2) remove the deck. The applicant decided to remove the deck.
- Presenter said the entrance to the deck had also been removed.

Motion: Lazerow moved to approve as presented as a minor project. Moser seconded. Motion passed 4-0-0.

ACTION ITEM B

Project: 628741 - Espinoza Residence

Location: 7964 Paseo del Ocaso APN: 346-503-0900

Presented by: James Lord, lordjim@preodigy.net 760-803-2260

Presentation

- Presenter said the project is just proposing to lengthen existing rooms (entry, living room, kitchen, master bedroom) not an addition in the traditional sense
- The project would add 357 sf to an existing 1,500 sf residence, resulting in a 25% increase in sf.
- According to the applicant, the project proposed no increase in height of residence.

Board Comment:

An issue was raised by the Board Members regarding the proposed reduction to the side setback. The applicant indicated the 4-foot setback would be retained. The height of the side fence was questioned. The applicant verified height of 6 feet.

Motion:

Lazerow moved to approve as a minor project. Motion passed 4-0-0.

ACTION ITEM C

Project: 635054 - Morgan Residence

Location: 8441 Whale Watch Way APN: 314-69-0250 **Presented by:** Scott Huntsman, shuntsman@hayerarchitecture.com 858-7792-2800

Presentation

- Presenter said height is increased at the sides, but not in the middle with the new flat roof design.
- Presenter said the neighbors above on Prestwick were initially concerned that the project would block their ocean views, but now support the redesign.
- From the street the new residence appears as a one-story house.
- Presenter said the La Jolla CPA recommended they not have a solid stucco wall with no articulation on the side facing a neighbor with a sold stucco wall, so they redesigned with a step back.

Board Comment:

Board members questioned how the proposed 11,000 sf residence compared with neighboring residences, indicating that the setbacks were small for such a large lot. Presenter said that the proposed project is compatible with neighboring two and three-story structures. Information on the cost of the project was also requested by the Board Members. The presenter responded the cost would be under \$5 million.

Motion:

Moser moved to approve as presented as a major project. Lazerow seconded. Motion passed 4-0-0.

Next meeting date: March 16, 2020

6. Adjournment: 12:15 p.m.

Minutes taken by Tony Kempton, Associate Planner, City of San Diego

3



City of San Diego Development Services1222 First Ave., MS 302
San Diego, CA 92101
(619) 446-5000

Ownership Disclosure Statement

FORM

DS-318

October 2017

Approval Type: Check appropriate box ☐ Neighborhood Development Permit ☐ Tentative Map ☐ Vesting Tentative	Site Devel	opment Permit 🗆 Planned Developm	nent Permit 🕻	Conditional Use Pe	ent Permit ermit 🗖 Variance
Project Title: MORGAN RESIDENCE			Proiect No	. For City Use Only	635054
Project Address: 8441 WHALE WATCH W					
LA JOLLA, CA 92037					
Specify Form of Ownership/Legal St	atus (please	check):		*******************************	
☐ Corporation ☐ Limited Liability -or-	General -	What State?Corporate	Identification	n No	
☐ Partnership ☐ Individual					Ti
By signing the Ownership Disclosure Swith the City of San Diego on the sultowner(s), applicant(s), and other finant individual, firm, co-partnership, joint with a financial interest in the application individuals owning more than 10% of officers. (A separate page may be attained at the serving as an officer or A signature is required of at least on notifying the Project Manager of any ownership are to be given to the Project accurate and current ownership inforr	bject property incially interest venture, association. If the all the shares. It is ached if necessive director of the property changes in ovect Manager all the shares and the property in th	with the intent to record an encuned persons of the above referenced ciation, social club, fraternal organiza pplicant includes a corporation or pafa publicly-owned corporation, inclusary.) If any person is a nonprofit organization or as truerty owners. Attach additional page wnership during the time the applicat least thirty days prior to any publicat	nbrance again property. A f tion, corpora intnership, ind de the names ganization or stee or bene es if needed. ation is being c hearing on t	nst the property. Prinancially interested tion, estate, trust, reclude the names, tit s, titles, and address a trust, list the name ficiary of the nonpotes. Note: The applicars processed or cons	lease list below the diparty includes any eceiver or syndicate les, addresses of all ses of the corporate es and addresses of profit organization. It is responsible for idered. Changes in
Property Owner					
Name of Individual: PoJ – www	LLC		Owner	☐ Tenant/Lessee	☐ Successor Agency
Street Address: 2223 Aven	ida de	la Playa #350	-		
City: La Julla				State: CA	Zip: 92037
Phone No.: 858-345-152	5	Fax No.: 858-345-1518	Email: 200	rganronnie	Agmail. wom
Signature: A Ronald S	m.	MGR	Date: 4	17-19	
		□ No			
Applicant					
Name of Individual: WILLIAM HAYER			d Owner	☐ Tenant/Lessee	☐ Successor Agency
Street Address: 445 MARINE VIEW AVE, SI	UITE 280		Agent		
City: _ DEL MAR				State: CA	Zip: 92014
Phone No.: _858-792-2800		Fax No.:	Email: BHA	YER@HAYERARCHITEC	TURE.COM
Signature:					
		□ No	Dute!		
Other Financially Interested Persons	S				
Name of Individual:			_ □ Owner	☐ Tenant/Lessee	☐ Successor Agency
Street Address:					
City:				State:	Zip:
Phone No.:		Fax No.:	Email:		
Signature:			Date:		
Additional pages Attached:	Yes	□ No			

LLC-1 Secretary of State **Articles of Organization** Limited Liability Company (LLC)

ATTACHMENT 9 201806110154




				40	
IMPORTANT — Read Instructions before completing this form. Filing Fee — \$70.00		Sec Sta	FILE(cretary of te of Cali	State /	
Copy Fees — First page \$1.00; each attachment page \$0.50; Certification Fee - \$5.00			AR 0 1 2		
Note: LLCs may have to pay minimum \$800 tax to the California Franceach year. For more information, go to https://www.ftb.ca.gov.	chise Tax Board	100 This Sp	pace For Of	fice Use Only	
1. Limited Liability Company Name (See Instructions – Must conta	ain an LLC ending su	ich as LLC or L.L.C.	"LLC" will be	e added, if not included.)	
POJ-WWW, LLC					
2. Business Addresses					
a. Initial Street Address of Designated Office in California - Do not enter a P.O. Box	City (no abbreviation	ns)	State	Zip Code	
2223 Avenida de la Playa, Suite 350	La Jolla		CA	92037	
b. Initial Mailing Address of LLC, If different than Item 2a City (no abbreviations) State Zip Code					
3. Service of Process (Must provide either Individual OR Corporation.) INDIVIDUAL – Complete Items 3a and 3b only. Must include agent's full name and California street address.					
a. California Agent's First Name (if agent is not a corporation)	Middle Name	Last Name		Suffix	
I. Ronald		Morgan			
b. Street Address (if agent is not a corporation) - Do not enter a P.O. Box	City (no abbreviation	s)	State	Zip Code	
2223 Avenida de la Playa, Suite 350	La Jolla		CA	92037	
CORPORATION - Complete Item 3c. Only include the name of the register	ered agent Corporati	on.			
c. California Registered Corporate Agent's Name (if agent is a corporation) - Do not	complete Item 3a or 3	b			
4. Management (Select only one box)					
The LLC will be managed by: One Manager More than One Manager All LLC Member(s)					
5. Purpose Statement (Do not alter Purpose Statement)	-				
The purpose of the limited liability company is to engage in ar may be organized under the California Revised Uniform Limited			h a limited	liability company	
6. The Information contained herein, including in any attachmen	nts, is true and c				

Organizer sign here

I. Ronald Morgan

Print your name here

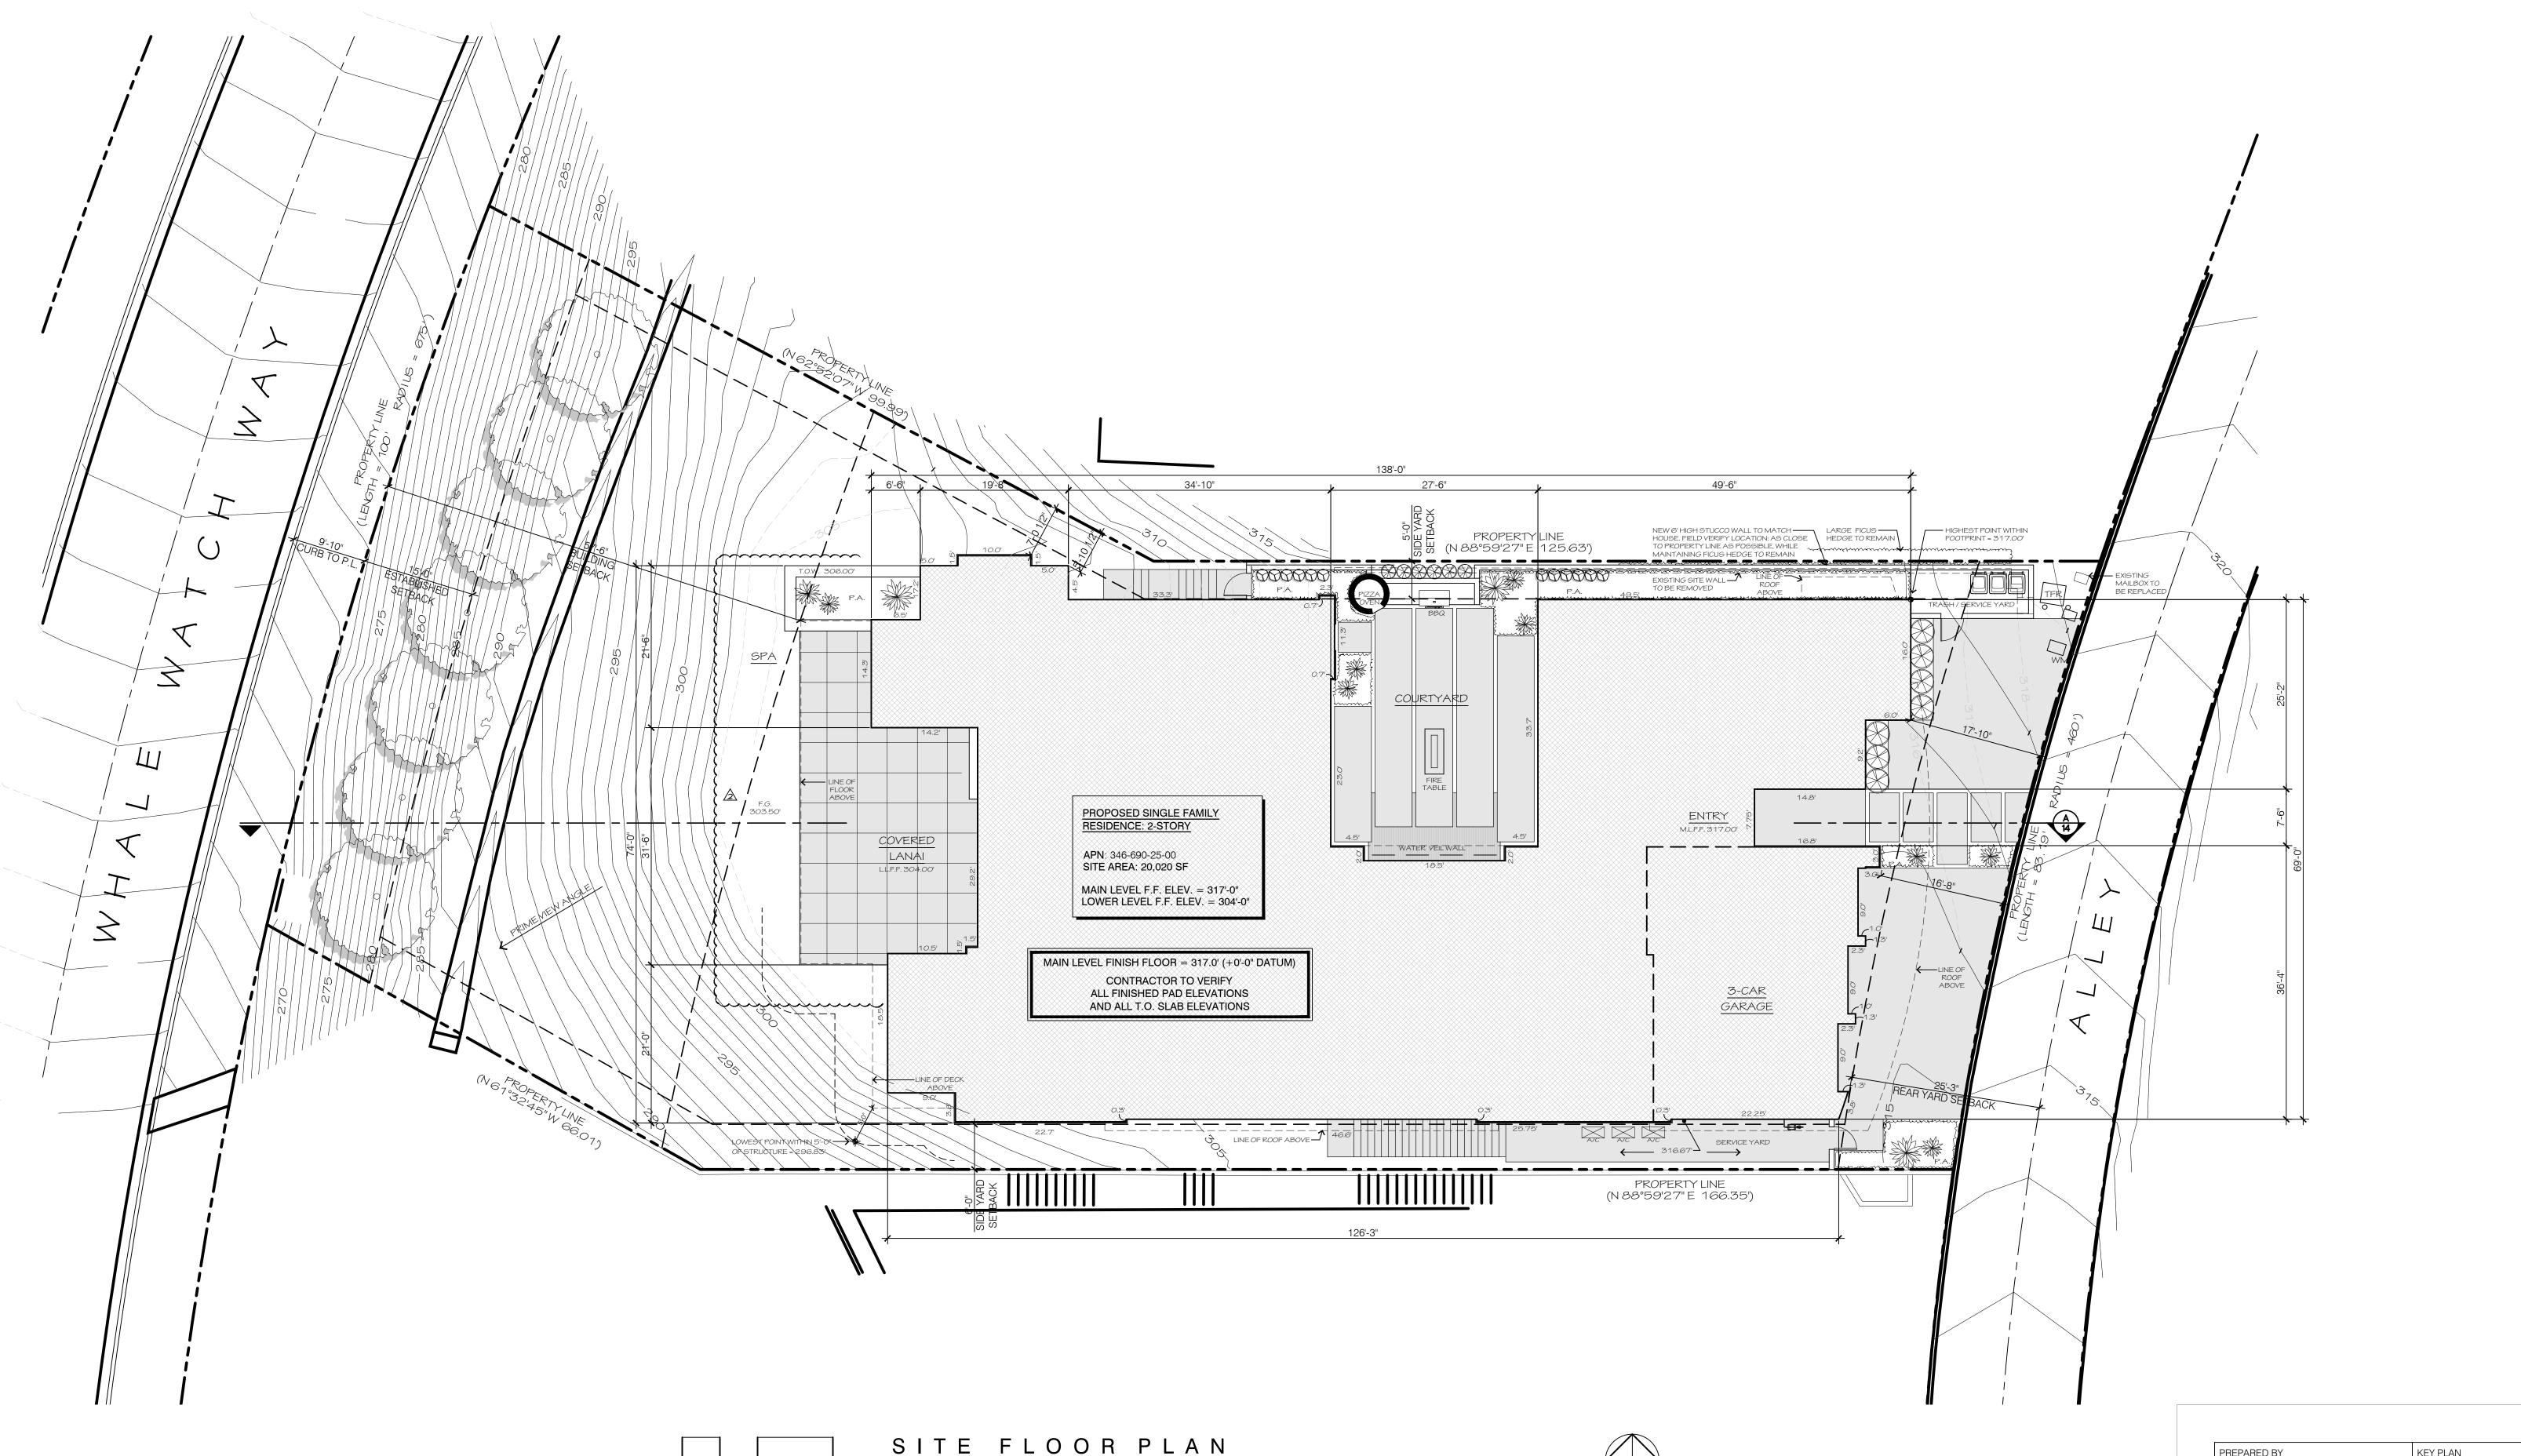

SITE CONDITIONS

- PALEONTOLOGICAL CONDITIONS
- 1. PRIOR TO ISSUANCE OF ANY CONSTRUCTION PERMITS, INCLUDING BUT NOT LIMITED TO, THE FIRST GRADING PERMIT, DEMOLITION PLANS/PERMITS AND BUILDING PLANS/PERMITS OR A NOTICE TO PROCEED FOR SUBDIVISIONS, BUT PRIOR TO THE FIRST PRECONSTRUCTION MEETING, WHICHEVER IS APPLICABLE, THE ASSISTANT DEPUTY DIRECTOR (ADD) ENVIRONMENTAL DESIGNEE SHALL VERIFY THAT THE REQUIREMENTS FOR PALEONTOLOGICAL MONITORING HAVE BEEN NOTED ON THE APPROPRIATE CONSTRUCTION DOCUMENTS IN "VERBATIM" AS REFERENCED IN THE CITY OF SAN DIEGO LAND DEVELOPMENT MANUAL FOR PALEONTOLOGICAL RESOURCES.
- 2. THE APPLICANT SHALL SUBMIT A LETTER OF VERIFICATION TO MITIGATION MONITORING COORDINATION (MMC)/ENVIRONMENTAL DESIGNEE (ED) IDENTIFYING THE PRINCIPAL INVESTIGATOR (PI), MONITORS, AND ALL PERSONS FOR THE PROJECT AND THE NAMES OF ALL PERSONS INVOLVED IN THE PALEONTOLOGICAL MONITORING PROGRAM, AS IDENTIFIED IN CITY OF SAN DIEGO LAND DEVELOPMENT MANUAL FOR PALEONTOLOGICAL RESOURCES.
- 3. MMC/ED WILL PROVIDE A LETTER TO THE APPLICANT CONFIRMING THE QUALIFICATIONS OF THE PI, MONITORS, AND ALL PERSONS INVOLVED IN THE PALEONTOLOGICAL MONITORING OF THE PROJECT. PROFESSIONAL
- QUALIFICATIONS SHALL MEET THE FOLLOWING STANDARDS: a. THE PRINCIPAL INVESTIGATOR (PI) SHOULD HAVE A PH.D. OR M.S. IN A FIELD RELATED TO PALEONTOLOGY, SUCH AS GEOLOGY OR BIOLOGY WITH AN EMPHASIS IN PALEOBIOLOGY. FOUR CUMULATIVE YEARS OF FULL-TIME PROFESSIONAL FIELD, RESEARCH, AND MUSEUM EXPERIENCE IN WORKING WITH THE GEOLOGICAL FORMATIONS OF SOUTHERN CALIFORNIA IS REQUIRED. TWO OF THE FOUR YEARS MUST BE IN A SUPERVISORY CAPACITY
- (CREW CHIEF OR ABOVE). b. PALEONTOLOGICAL MONITORS SHOULD HAVE A B.S. IN A FIELD RELATED TO PALEONTOLOGY, SUCH AS GEOLOGY OR BIOLOGY WITH AN EMPHASIS IN PALEOBIOLOGY. TWO CUMULATIVE YEARS OF FULL-TIME PROFESSIONAL FIELD. RESEARCH, AND MUSEUM EXPERIENCE IN WORKING WITH THE GEOLOGICAL FORMATIONS OF SOUTHERN CALIFORNIA IS REQUIRED.
- 4. PRIOR TO THE START OF WORK, THE APPLICANT SHALL OBTAIN APPROVAL FROM MMC FOR ANY PERSONNEL CHANGES ASSOCIATED WITH THE MONITORING

LANDSCAPE CONDITIONS

DAYS OF DAMAGE.

- 1. PRIOR TO ISSUANCE OF ANY CONSTRUCTION PERMITS FOR STRUCTURES, THE OWNER/PERMITTEE SHALL SUBMIT COMPLETE LANDSCAPE AND IRRIGATION CONSTRUCTION DOCUMENTS TO THE DEVELOPMENT SERVICES DEPARTMENT FOR APPROVAL. THE CONSTRUCTION DOCUMENTS SHALL BE CONSISTENT WITH APPROVED EXHIBIT 'A,' THE LA JOLLA SHORES PLANNED DISTRICT ORDINANCE, THE LA JOLLA COMMUNITY PLAN, AND THE LAND DEVELOPMENT MANUAL - LANDSCAPE STANDARDS.
- 2. THE OWNER/PERMITTEE SHALL BE RESPONSIBLE FOR THE MAINTENANCE OF ALL LANDSCAPE IMPROVEMENTS SHOWN ON THE APPROVED PLANS, INCLUDING IN THE RIGHT-OF-WAY, UNLESS LONG-TERM MAINTENANCE OF SAID LANDSCAPING WILL BE THE RESPONSIBILITY OF A LANDSCAPE MAINTENANCE DISTRICT OR OTHER APPROVED ENTITY. ALL REQUIRED LANDSCAPE SHALL BE MAINTAINED CONSISTENT WITH THE LANDSCAPE STANDARDS IN A DISEASE, WEED, AND LITTER FREE CONDITION AT ALL TIMES. SEVERE PRUNING OR "TOPPING" OF TREES IS NOT PERMITTED.
- 3. IF ANY REQUIRED LANDSCAPE (INCLUDING EXISTING OR NEW PLANTINGS, HARDSCAPE, LANDSCAPE FEATURES, ETC.) INDICATED ON THE APPROVED CONSTRUCTION DOCUMENT PLANS IS DAMAGED OR REMOVED DURING DEMOLITION OR CONSTRUCTION. IT SHALL BE REPAIRED AND/OR REPLACED IN KIND AND EQUIVALENT SIZE PER THE APPROVED DOCUMENTS TO THE SATISFACTION OF THE DEVELOPMENT SERVICES DEPARTMENT WITHIN 30

SITE NOTES

- GENERAL
- 1. RESIDENTIAL TRASH RECEPTACLES TO BE LOCATED IN A WALLED AREA.

3. BUILDING ADDRESS NUMBERS SHALL BE VISIBLE AND LEGIBLE FROM THE

 $20 \, FT.$ SCALE: 1" = 10' - 0"

- 2. NO BUS OR TRANSIT STOPS ADJACENT TO SITE.
- STREET OR ROAD FRONTING THE PROPERTY. (UFC 901.4.4)
- 4. ALL EXTERIOR LIGHTING FIXTURES SHALL BE UNOBTRUSIVE AND SHIELDED SUCH THAT NO LIGHT SHALL FALL EXCESSIVELY BEYOND THE SITE
- 5. THIS PROJECT SHALL COMPLY WITH MUNICIPAL CODE REQUIREMENTS FOR MAXIMUM HEIGHT OF STRUCTURE NOT TO EXCEED 30 FEET (S.D.M.C. SECTIONS 131.0444 & 132.0505).

LOT COVERAGE MAIN LEVEL TERRACE

MAIN LEVEL HABITABLE:

6,695 SF.

LOWER LEVEL HABITABLE:	4,846 SF.
GARAGE / MECHANICAL / STORAGE:	1,459 SF.
TOTAL HABITABLE:	11,541 SF.
CDOCC FLOOD ADEA.	11 650 05

GROSS FLOOR AREA: (1,348 sf subterranean removed)	11,652
SITE AREA:	20,020 SF. (.46
F.A.R.:	58
LOT COVERAGE	38

LOWER LEVEL TERRACE

AREA SUMMARY BUILDING NOTES

PROJECT SCOPE: DEMO EXISTING SINGLE FAMILY RESIDENCE. CONSTRUCT NEW 2-STORY 11,541 SF. (11,652 SF. GROSS) SINGLE FAMILY RESIDENCE WITH ASSOCIATED

- 2016 CALIFORNIA BUILDING CODE (CBC) 2016 CALIFORNIA RESIDENTIAL CODE (CRC) 2016 CALIFORNIA ELECTRICAL CODE (CEC)
- 2016 CALIFORNIA MECHANICAL CODE (CMC) 2016 CALIFORNIA PLUMBING CODE (CPC) 2016 CALIFORNIA ENERGY CODE CALIFORNIA ELEVATOR SAFETY CODE 2016 CALIFORNIA FIRE CODE

2016 CALIFORNIA GREEN BUILDING CODE

SITE WALLS, SWIMMING POOL, AND SPA.

- 1 OCCUPANT CLASS: R-3 RESIDENTIAL 2 CONSTRUCTION TYPE: V-B - RESIDENCE / U - GARAGE 100% SPRINKLERED 3 FIRE PROTECTION: 5 BUILDING HEIGHT: LIMITED TO 30 FT. (PROP. D) 6 NO. OF STORIES:
- ZONING DATA

12. BUILDING HEIGHT:

2. OVERLAY ZONES:

 COASTAL OVERLAY ZONE • COASTAL HEIGHT LIMIT OVERLAY ZONE STEEP HILLSIDE CAMPUS PARKING IMPACT OVERLAY ZONE GEOLOGICAL HAZARD CATEGORIES

ACTUAL

PROVIDED

30'-0"

(28'-4" PROP D)

20,020 SF. (0.46 AC) SITE AREA (SQ FT): (ACRES): REQUIRED or ALLOWED 4. BUILDING GROSS AREA: PREVAILING

11,652 SF. LOT COVERAGE: 38.98% 6. FLOOR AREA RATIO (FAR): PREVAILING 58.20% 7. LANDSCAPE AREA: 30% 41.81% 8. HARDSCAPE AREA: 19.21% 9. PARKING: 10. BUILDING SETBACKS: 15'-0" 57'-6" FRONT YARD: PREVAILING 6'-0" / 5'-0" SIDE YARD: REAR YARD: PREVAILING 25'-3" 11. NO. OF STORIES:

30'-0"

DRAWING INDEX

- SITE PLAN AND NOTES DRAINAGE NOTES AND SPECIFICATIONS
- WATER QUALITY INFORMATION DRAINAGE AND GRADING SITE PLAN GRADING SECTIONS AND DETAILS
- TOPOGRAPHIC SURVEY LANDSCAPE PLAN FLOOR PLAN - LOWER LEVEL

EROSION CONTROL PLAN

- 10 FLOOR PLAN MAIN LEVEL **ROOF PLAN** 12 ELEVATIONS
- 13 ELEVATION 14 SITE SECTION 15 DMA MAP - EXISTING
- 16 DMA MAP PROPOSED


KEY PLAN NTS VICINITY MAP HAYER ARCHITECTURE Contact: William S. Hayer 445 Marine View Avenue, Suite 280 Del Mar, CA 92014 (858) 792-2800 bhayer@hayerarchitecture.com PROJECT CONSULTANTS Civil Engineer: EARTH WIND WATER CIVIL ENGINEERING 11440 West Bernardo Court, Suite 300 NORTH Rancho Bernardo, CA 92127 (858) 753-1947 PROJECT DATA PROJECT ADDRESS Geotechnical Engineer: 8441 Whale Watch Way VB Sprinklered nstruction: GEOTECHNICAL EXPLORATION, INC La Jolla, CA 92037 7420 Trade Street Occupancy: San Diego, CA 92121 PROJECT OWNER (858) 549-7222 2016 Edition-C.R.C Ronnie & Marci Morgan LJSPD-SF WOODLAND SURVEYING, INC. ASSESSOR'S PARCEL NO.: 2180 Garnet Ave., Suite 3G No. of Stories: 2 Stories San Diego, CA 92108 346-690-25-00 (858) 273-4700 20,020 sf. LEGAL DESCRIPTION: Gross Floor Area: 11,652 sf. GREG HEBERT LANDSCAPE ARCHITECT LOT 25 OF LA JOLLA COSTA DORADO 3153 Third Avenue San Diego, CA 92103 (619) 283-5083 Geo Hazzard Area: 26 & 53 BENCHMARK: Landscape Area: 7,590 sf. Brass plug in top of curb at COMMUNITY PLAN Northwest corner of Prestwick Drive La Jolla Community Plan and Local & Prestwick Court Coastal Program Land Use Plan: Record from: City of San Diego - Very Low Density Residential EXISTING BUILDING Vertical Control Elevation: 350.289 To Be Demolished Datum: MSL, NGVD 1929 OVERLAY ZONES PROJECT NO: R-3 S.F.R. ccupancy: Coastal Overlay Zone Coastal Height Limit Overlay Zone 635054 Constructed: 1983 Non-Historic Steep Hillsides PROJECT NAME: Campus Parking Impact Overlay Zone Soil Condition: Prev. Developed Geological Hazard Categories MORGAN RESIDENCE SHEET TITLE: APPROVALS: SITE PLAN REVISIONS: | SHEET NUMBER: PERMITS REQUIRED: ORIGINAL DATE: 05-23-2019 Coastal Development Permit 02-05-2020 06-29-2020 Site Development Permit 10-06-2020 of **16**

ATTACHMENT 10

hayer

+ consultant +

architecture 445 Marine View AVE Suite 280 Del Mar , CA 92014 t858 792 2800 f858 792 2802

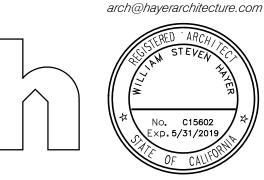


Morgan

8441 WHALE WATCH WAY

LA JOLLA, CA 92037

APN: 346-690-25-00

Residence

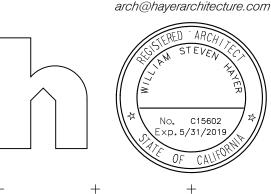

DIVISION (858) 627-3200.

DISTURBED OR DESTROYED DURING CONSTRUCTION.

SHALL BE TIED-OUT AND REFERENCED BY A LAND SURVEYOR.

- APPROVAL OF THESE PLANS BY THE CITY ENGINEER DOES NOT AUTHORIZE ANY WORK TO BE
- THE APPROVAL OF THIS PLAN OR ISSUANCE OF A PERMIT BY THE CITY OF SAN DIEGO DOES NOT AUTHORIZE THE UTILITY COMPANY TO VIOLATE ANY FEDERAL, STATE OR CITY LAWS, ORDINANCES REGULATIONS, OR POLICIES.
- IMPORTANT NOTICE: SECTION 4216 OF THE GOVERNMENT CODE REQUIRES A DIG ALERT IDENTIFICATION NUMBER ISSUED BEFORE A ` ` PERMIT TO EXCAVATE" WILL BE VALID. FOR YOUR DIG ALERT I.D. NUMBER, CALL UNDERGROUND SERVICE ALERT, TOLL FREE (800) 422-4133, TWO DAYS BEFORE YOU DIG.
- CONTRACTOR SHALL BE RESPONSIBLE FOR POT-HLING AND LOCATING ALL EXISTING UTILITIES THAT CROSS THE PROPOSED TRENCH LINE WHILE MAINTAINING A 1 FOOT VERTICAL CLEARANCE.
- "PUBLIC IMPROVEMENT SUBJECT TO DESUETUDE OR DAMAGE." IF REPAIR OR REPLACEMENT OF SUCH PUBLIC IMPROVEMENTS IS REQUIRED, CONTRACTOR SHALL OBTAIN THE REQUIRED PERMITS FOR WORK IN THE PUBLIC RIGHT-OF-WAY, SATISFACTORY TO THE PERMIT ISSUING AUTHORITY.
- DEVIATIONS FROM THESE SIGNED PLANS WILL NOT BE ALLOWED UNLESS A CONSTRUCTION CHANGE IS APPROVED BY THE CITY ENGINEER OR THE CHANGE IS REQUIRED BY THE RESIDENT ENGINEER.
- CONTRACTOR SHALL REPLACE OR REPAIR ALL TRAFFIC SIGNAL LOOPS, CONDUITS, AND LANE STRIPPING DAMAGED DURING CONSTRUCTION.
- PRIOR TO SITE DISTURBANCE, CONTRACTOR SHALL MAKE ARRANGEMENTS FOR A PRECONSTRUCTION MEETING WITH THE CITY OF SAN DIEGO, CONSTRUCTION MANAGEMENT AND FIELD ENGINEERING
- 10. CONTRACTOR MAY PERFORM SITE SURVEY AND UTILITY MARK OUT SERVICES PRIOR TO THE PRECONSTRUCTION MEETING.
- 1. PRIOR TO DEMOLITION, CONTRACTOR SHALL FURNISH THE RESIDENT ENGINEER WITH A LETTER FROM A LICENSED LAND SURVEYOR THAT HAS RESEARCHED AVAILABLE RECORDS AND FIELD INSPECTED THE SITE, STATING THAT NO SURVEY MONUMENTS EXIST IN THE AREA TO DEMOLISHES OR WILL BE
- 12. IF ANY VERTICAL CONTROL IS TO BE DISTURBED OR DESTROYED, THE CITY OF SAN DIEGO FIELD SURVEY SECTION SHALL BE NOTIFIED IN WRITING AT LEAST 7 DAYS PRIOR TO CONSTRUCTION. THE CONTRACTOR SHALL BE RESPONSIBLE FOR THE COST OF REPLACING VERTICAL CONTROL BENCHMARKS DESTROYED BY CONSTRUCTION.
- 13. CONTRACTOR IS RESPONSIBLE FOR THE COST OF REPLACING ALL SURVEY MONUMENTS WHICH ARE DAMAGED OR DESTROYED BY CONSTRUCTION.
- 14. PRIOR TO CONSTRUCTION, SURVEY MONUMENTS THAT ARE LOCATED IN THE CONSTRUCTION AREA
- 15. UPON COMPLETION OF CONSTRUCTION, ALL DESTROYED SURVEY MONUMENTS ARE REQUIRED TO BE REPLACED, AND A CORNER RECORD OR RECORD OF SURVEY SHALL BE PREPARED AND FILED WITH THE COUNTY SURVEYOR AS REQUIRED BY THE PROFESSIONAL LAND SURVEYOR ACT, SECTION 8771 OF THE BUSINESS AND PROFESSIONS CODE OF THE STATE OF CALIFORNIA..
- 16. CONTRACTOR SHALL IMPLEMENT AN EROSION CONTROL PROGRAM DURING THE PROJECT CONSTRUCTION ACTIVITIES. THE PROGRAM SHALL COMPLY WITH ALL APPLICABLE REQUIREMENTS OF THE STATE WATER RESOURCE CONTROL BOARD.
- 17. CONTRACTOR SHALL HAVE EMERGENCY MATERIAL AND EQUIPMENT ON HAND FOR UNFORESEEN SITUATIONS, SUCH AS DAMAGE TO UNDERGROUND WATER, SEWER, AND STORM DRAIN FACILITIES WHERE FLOW MAY GENERATE EROSION AND SEDIMENT POLLUTION.
- 18. MANHOLES AND PULL BOX COVER SHALL BE LABELED "NAME OF COMPANY."

GRADING NOTES

BMP DESCRIPTION

DESCRIPTION:

HMP EXEMPT

SITE DESIGN ELEMENTS

DESCRIPTION: SOURCE CONTROL ELEMENTS

POLLUTANT CONTROL BMP(S)

DESCRIPTION:
HMP FACILITY (IF SEPARATE)
DESCRIPTION:

- GRADING AS SHOWN ON THESE PLANS SHALL BE IN CONFORMANCE WITH CURRENT STANDARD SPECIFICATIONS AND CHAPTER 14, ARTICLE 2, DIVISION 1, OF THE SAN DIEGO MUNICIPAL CODE.
- PLANT AND IRRIGATE ALL CUT AND FILL SLOPES AS REQUIRED BY ARTICLE 2, DIVISION 4, SECTION 142.0411 OF THE SAN DIEGO LAND DEVELOPMENT CODE AND ACCORDING TO SECTION IV OR THE LAND DEVELOPMENT MANUAL LANDSCAPE STANDARDS.
- GRADED, DISTURBED, OR ERODED AREAS THAT WILL NOT BE PERMANENTLY PAVED, COVERED BY STRUCTURE, OR PLANTED FOR A PERIOD OVER 90 DAYS SHALL BE TEMPORARILY RE-VEGETATED WITH A NON-IRRIGATED HYDROSEED MIX, GROUND COVER, OR EQUIVALENT MATERIAL. SEE SHEET ____ FOR MIX AND SPECIFICATIONS.

FOR THE ONGOING PERMANENT BMP MAINTENANCE, SATISFACTORY TO THE CITY ENGINEER.

INSPECTION | MAINTENANCE

FREQUENCY FREQUENCY

O&M RESPONSIBLE PARTY DESIGNEE: PROPERTY OWNER / HOA / CITY / OTHER:

STORM WATER MANAGEMENT AND DISCHARGE CONTROL MAINTENANCE AGREEMENT APPROVAL NO.:

PRIOR TO THE ISSUANCE OF ANY CONSTRUCTION PERMIT, THE OWNER/PERMITTEE SHALL ENTER INTO A MAINTENANCE AGREEMENT

MAINTENANCE METHOD QUANTITY

SITE DESIGN, SOURCE CONTROL AND POLLUTANT CONTROL BMP OPERATION & MAINTENANCE PROCEDURE

- THE ESTIMATED MAXIMUM DISCHARGE RATES MUST NOT EXCEED THE LIMITS SET IN THE OFFICIAL "ENROLLMENT LETTER" FROM THE REGIONAL BOARD UNLESS PRIOR NOTIFICATION AND SUBSEOUENT AUTHORIZATION HAS BEEN OBTAINED, AND DISCHARGE OPERATIONS MODIFIED TO ACCOMMODATE THE INCREASED RATES.
- ALL GROUND WATER EXTRACTIONS AND SIMILAR WASTE DISCHARGES TO SURFACE WATERS TRIBUTARY TO THE SAN DIEGO BAY ARE PROHIBITED UNTIL IT CAN BE DEMONSTRATED THAT THE OWNER HAS APPLIED AND OBTAINED AUTHORIZATION FROM THE STATE OF CALIFORNIA VIA AN OFFICIAL "ENROLLMENT LETTER" FROM THE REGIONAL WATER QUALITY CONTROL BOARD IN ACCORDANCE WITH THE TERMS, PROVISIONS AND CONDITIONS OF STATE ORDER NO R9-2015-0013 NPDES NO. CAG919003.

GRADING & GEOTECHNICAL SPECIFICATIONS

- 1. ALL GRADING SHALL BE DONE UNDER OBSERVATION AND TESTING BY A QUALIFIED CIVIL ENGINEER OR GEOTECHNICAL ENGINEER AND, IF REQUIRED, BOTH A QUALIFIED CIVIL ENGINEER OR GEOTECHNICAL ENGINEER AND AN ENGINEERING GEOLOGIST. ALL GRADING MUST BE PERFORMED IN ACCORDANCE WITH APPLICABLE CITY ORDINANCE AND THE RECOMMENDATIONS AND SPECIFICATIONS SET FORTH IN THE SOILS REPORT OR GEOLOGICAL/GEOTECHNICAL INVESTIGATION ENTITLED, "REPORT OF GOETECHNICAL INVESTIGATION AND GEOLOGIC RECONNAISSANCE, MORGAN RESIDENTIAL PROJECT, 8441 WHALE WATCH WAY, LA JOLLA, CALIFORNIA", PREPARED BY GEOTECHNICAL EXPLORATIONS, INC. DATED MAY 17, 2018, THEIR JOB NUMBER 18-11813.
- 2. ALL FILL MATERIAL SHALL BE COMPACTED TO A MINIMUM OF 90% OF THE MAXIMUM DRY DENSITY AS DETERMINED BY THE MOST RECENT VERSION OF A.S.T.M. D-1557 OR AN APPROVED ALTERNATIVE
- AT THE COMPLETION OF THE GRADING OPERATIONS FOR THE EARTHWORK SHOWN ON THIS PLAN, AN AS-GRADED SOILS REPORT, OR IF REQUIRED, AN AS-GRADED GEOTECHNICAL REPORT WILL BE PREPARED IN ACCORDANCE WITH THE MOST RECENT EDITION OF THE CITY OF SAN DIEGO TECHNICAL GUIDELINES FOR GEOTECHNICAL REPORTS. THE FINAL "AS-GRADED" GEOTECHNICAL REPORT WILL BE SUBMITTED TO THE FIELD ENGINEERING SECTION OF ENGINEERING AND CAPITAL PROJECTS DEPARTMENT AND A SECOND COPY TO THE GEOLOGY SECTION OF THE DEVELOPMENT SERVICES DEPARTMENT WITHIN 30 DAYS OF THE COMPLETION OF GRADING. WHERE GEOLOGIC INSPECTION IS INDICATED IN THE PERMIT OR PROJECT PLANS, REPORTS OR SPECIFICATIONS, THE FINAL REPORT MUST ALSO BE REVIEWED AND SIGNED BY A CALIFORNIA CERTIFIED ENGINEERING GEOLOGIST.
- 4. IF THE GEOTECHNICAL CONSULTANT OF RECORD IS CHANGED FOR THE PROJECT, THE WORK SHALL BE STOPPED UNTIL THE REPLACEMENT HAS AGREED IN WRITING TO ACCEPT THE RESPONSIBILITY WITHIN THE AREA OF THEIR TECHNICAL COMPETENCE FOR APPROVAL UPON COMPLETION OF THE WORK. IT SHALL BE THE DUTY OF THE PERMITTEE TO NOTIFY THE CITY ENGINEER AND THE GEOLOGY SECTION OF DEVELOPMENT SERVICES IN WRITING OF SUCH CHANGE PRIOR TO THE RECOMMENCEMENT OF
- 5. THESE GRADING PLANS HAVE BEEN REVIEWED BY THE UNDERSIGNED AND FOUND TO BE IN CONFORMANCE WITH THE RECOMMENDATIONS AND SPECIFICATIONS CONTAINED IN THE REFERENCED GEOTECHNICAL REPORT(S) PREPARED FOR THIS PROJECT.

JAIME A. CERROS, PE R.C.E. 34,422 / G.E. 2007

LESLIE D. REED, C.E.G. 999 / P.G. 3391 GEOTECHNICAL EXPLORATION, INC.


6. FOR SOIL FILE SEE CITY RECORD S - XXXXXX

INCLUDED IN

NUMBER(S)

O&M MANUAL

7420 TRADE STREET, SAN DIEGO, CA. 92121

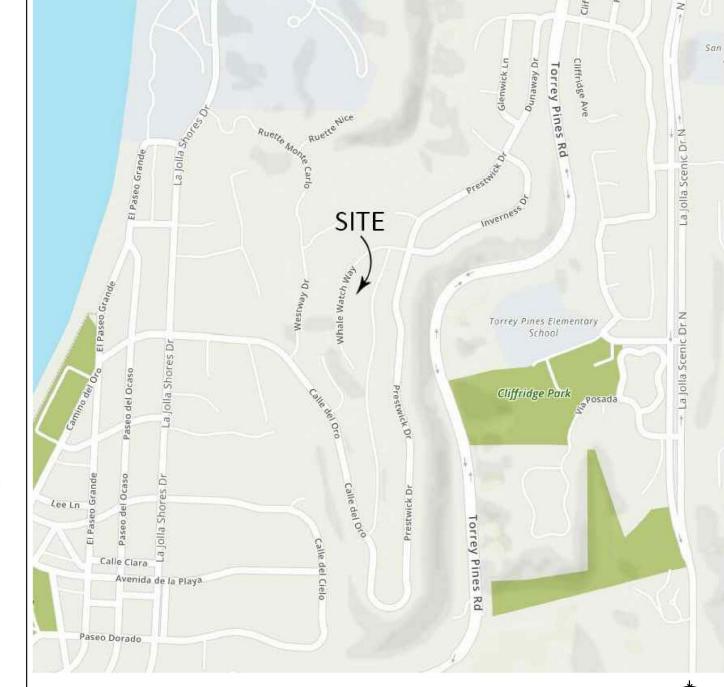

PRIVATE WATER AND WASTEWATER

VICINITY MAP

THE PRIVATE WATER/SEWER SYSTEM IS DESIGNED IN ACCORDANCE WITH THE CALIFORNIA PLUMBING CODE AND IS SHOWN ON THESE PLANS AS "INFORMATION ONLY". A SEPARATE PLUMBING PERMIT IS REQUIRED FOR CONSTRUCTION AND INSPECTION OF THE SYSTEM. APPROVAL NO.:

CONSTRUCTION STORM WATER PROTECTION NOTES

- 1. TOTAL SITE DISTURBANCE AREA (ACRES): 0.46
- 2. HYDROLOGIC UNIT / WATERSHED HYDROLOGIC: PENASQUITOS WATERSHED.
- 3. HYDRAULIC SUB AREA NAME AND NUMBER: WATERSHED # 906.30. THE PROJECT SHALL COMPLY WITH THE REQUIREMENTS OF THE,
- NUMBER R9-2013-0001 AND SUBSEQUENT AMENDMENTS.
- SWPPP (NONE IS REQUIRED), THE PROJECT IS SUBJECT TO MUNICIPAL STORM WATER PERMIT NUMBER R9-2013-0001 AND CONSTRUCTION GENERAL PERMIT ORDER NUMBER 2009-009-DWQ AS AMENDED BY ORDER 2010-0014 DWQ AND 2012-0006-DWQ

TRADITIONAL: RISK LEVEL [2] [3] [2] [3] RISK LEVEL

4. CONSTRUCTION SITE PRIORITY: [] ASBS [] HIGH [] MEDIUM [] LOW WDID NO: N/A

AREA OF SPECIAL BIOLOGICAL SIGNIFICANCE (ASBS)

THIS PROJECT IS LOCATED WITHIN AN ASBS. APPLICANT/PREMITTE WHALL COMLE WITH ALL ASBS REQUIREMENTS ACCORDINGLY.

WATER POLLUTION CONTROL PLAN

PRIOR TO THE ISSURANCE OF ANY CONSTRUCTION PERMIT THE OWNER/PERMITTEE SHALL SUBMIT A WATER POLLUTION CONTROL PLAN (WPCP). THE WPCP SHALL BE PREPARED IN ACCORDANCE WITH THE GUIDELINES IN PART 2 "CONSTRUCTION BMP STANDARDS", CHAPTER 4 OF THE CITY'S STORM WATER STANDARDS.

GRADING QUANTITIES

GRADED SITE AREA	20,020 SQ FT	MAX CUT DEPTH 2 FT	(OUTSIDE BLDG)
CUT QUANTITY	2,170 CY	MAX CUT SLOPE RATIO	2:1
FILL QUANTITY	240 CY	MAX FILL DEPTH 2 FT	(OURSIDE BLDG)
IMPORT / EXPORT	1,930 CY	MAX FILL SLOPE RATIO	2:1

REFERENCE DRAWINGS

NON AT THIS TIME.

SITE ADDRESS

8441 WHALE WATCH WAY LA JOLLA, CA. 92037

TOPOGRAPHY SOURCE

THE SOURCE OF TOPOGRAPHY USED IN THESE PLANS IS A SURVEY PERFORMED BY WOODS LAND SURVEYING, INC. 2180 CARNET AVENUE, SUITE 3G, SAN DIEGO, CA. THE DATE OF SURVEY IS: MAY 28,

BENCHMARK

THE BENCHMARK USED FOR THE PURPOSES OF THIS PLAT IS A BRASS PLUG IN THE TOP OF CURB LOCATED AT THE NORTHWEST CORNER OF PRESTWICK DRIVE AND PRESTWICK COURT, ELEV: 350.289' DATUM: MSL, NGVD '29 (RECORD FROM: CITY OF SAN DIEGO VERTICAL CONTROL)

TOTAL DISTURBED AREA

TOTAL SITE DISTURBED AREA IN ACRES IS REQUIRED FOR STORM WATER PURPOSES

- 1. GRADED AREA 0.46 ACRES.
- 2. MAX. CUT DEPTH 14 FEET (ALL BENEATH BUILDING ENVELOPE)
- 3. MAX CUT SLOPE RATIO (2:1MAX), THERE ARE NO CUT SLOPES
- 4. CUT QUANTITIES 2,170 CY
- 5. FILL QUANTITIES 240 CY
- MAXIMUM FILL DEPTH 2 FT
- 7. IMPORT/EXPORT 1,930 CY
- 8. MAX FILL SLOPE RATIO (2:1MAX), THERE ARE NO FILL SLOPES.
- 9. THIS PROJECT PROPOSES TO EXPORT 1,930 CY OF MATERIAL FROM THIS SITE. ALL EXPORT MATERIAL SHALL BE DISCHARGED TO A LEGAL DISPOSAL SITE. THE APPROVAL OF THIS PROJECT DOES NOT ALLOW PROCESSING AND SALE OF THE MATERIAL. ALL SUCH ACTIVITIES REQUIRE A SEPARATE CONDITIONAL USE PERMIT.

ASSESSORS PARCEL NUMBER

THE ASSESSORS PARCEL NUMBER OF THIS SITE IS: 346-690-25-00

LEGAL DESCRIPTION

THE EXISTING AND PROPOSED LEGA DESCRIPTION OF THIS SITE IS, LOT 25 OF MAP NO. 6865, IN THE CITY OF SAN DIEGO, COUNTY OF SAN DIEGO, STATE OF CALIFORNIA, ACCORDING TO MAPS FILED IN THE OFFICE OF THE SAN DIEGO COUNTY

SHEET INDEX SHEET

SHEET DESCRIPTION	SHEET N
GENERAL NOTES AND SPECIFICATIONS	DRN.1
DRAINAGE NOTES AND FORM DS-560	DRN.2
DRAINAGE SITE PLAN	DRN.3
DRAINAGE AND GRADING SECTIONS	DRN.4
EROSION CONTROL / BMP PLAN	DRN.5

PRIOR TO THE ISSUANCE OF ANY CONSTRUCTION PERMIT, THE OWNER/PERMITTEE SHALL INCORPORATE ANY CONSTRUCTION BEST MANAGEMENT PRACTICES NECESSARY TO COMPLY WITH CHAPTER 14, ARTICLE 2, DIVISION 1 (GRADING REGULATIONS) OF THE SAN DIEGO MUNICIPAL CODE, INTO THE CONSTRUCTION PLANS OR SPECIFICATIONS.

ENGINEERING PERMIT NO:__ DISCRETIONARY PERMIT NO: RETAINING WALL PROJECT NO:

CONSTRUCTION SITE STORM WATER PRIORITY:_



+ consultant

8441 WHALE WATCH WAY LA JOLLA, CA 92037 APN: 346-690-25-00

S

Coastal Development Permit

Site Development Permit

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PREPARED BY KEY PLAN NTS VICINITY MAP HAYER ARCHITECTURE Contact: William S. Hayer 445 Marine View Avenue, Suite 280 Del Mar, CA 92014 (858) 792-2800 bhayer@hayerarchitecture.com PROJECT CONSULTANTS Civil Engineer: EARTH WIND WATER CIVIL ENGINEERING 11440 West Bernardo Court, Suite 300 NORTH Rancho Bernardo, CA 92127 (858) 753-1947 PROJECT DATA PROJECT ADDRESS Geotechnical Engineer: 8441 Whale Watch Way VB Sprinklered onstruction: GEOTECHNICAL EXPLORATION, INC La Jolla, CA 92037 7420 Trade Street Occupancy: San Diego, CA 92121 PROJECT OWNER (858) 549-7222 2016 Edition-C.R.C Ronnie & Marci Morgan LJSPD-SF WOODLAND SURVEYING, INC. ASSESSOR'S PARCEL NO. 2180 Garnet Ave., Suite 3G 2 Stories No. of Stories: San Diego, CA 92108 346-690-25-00 (858) 273-4700 20,020 sf. Site Area: LEGAL DESCRIPTION: Gross Floor Area: 11,652 sf. GREG HEBERT LANDSCAPE ARCHITECT LOT 25 OF LA JOLLA COSTA DORADO 3153 Third Avenue F.A.R.: San Diego, CA 92103 (619) 283-5083 Geo Hazzard Area: 26 & 53 BENCHMARK: Landscape Area: 7,590 sf. Brass plug in top of curb at COMMUNITY PLAN Northwest corner of Prestwick Drive La Jolla Community Plan and Local & Prestwick Court Coastal Program Land Use Plan: Record from: City of San Diego - Very Low Density Residential FXISTING BUILDING Vertical Control 350.289 To Be Demolished

05-23-2019


02-05-2020 06-29-2020

10-06-2020

OF **16**

Datum: MSL, NGVD 1929 OVERLAY ZONES PROJECT NO: Occupancy: R-3 S.F.R. Coastal Overlay Zone Coastal Height Limit Overlay Zone 635054 Constructed: 1983 Non-Historic Steep Hillsides PROJECT NAME: Campus Parking Impact Overlay Zone Soil Condition: Prev. Developed Geological Hazard Categories MORGAN RESIDENCE SHEET TITLE: APPROVALS: DRAINAGE NOTES AND SPECIFICATIONS PERMITS REQUIRED: ORIGINAL DATE: REVISIONS: SHEET NUMBER:

GENERAL NOTES GROUND-WATER DISCHARGE NOTES OWNER/APPLICANT RONNIE AND MARCI MORGAN ALL GROUND WATER EXTRACTION AND SIMILAR WASTE DISCHARGES TO SURFACE WATERS NOT 8441 WHALE WATCH WAY PERFORMED UNTIL A PERMIT HAS BEEN ISSUED. TRIBUTARY TO THE SAN DIEGO BAY ARE PROHIBITED UNTIL IT CAN BE DEMONSTRATED THAT THE LA JOLLA, CA 92037 OWNER HAS APPLIED AND OBTAINED AUTHORIZATION FROM THE STATE OF CALIFORNIA VIA AN PHONE: 858-792-2800 UPON ISSUANCE OF A PERMIT, NO WORK WILL BE PERMITTED ON WEEKENDS OF HOLIDAYS UNLESS OFFICIAL "ENROLLMENT LETTER" FROM THE REGIONAL WATER QUALITY CONTROL BOARD IN APPROVED BY TRAFFIC CONTROL PERMIT FROM THE DEVELOPMENT SERVICES DEPARTMENT. ACCORDANCE WITH THE TERMS, PROVISIONS AND CONDITIONS OF STATE ORDER NO R9-2015-0013

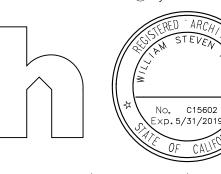





City of San Diego Development Services Development Services Development Services Development Services DS-560 **Applicability Checklist** Project Address: 8441 Whale Watch Way, La Jolla, CA **SECTION 1. Construction Storm Water BMP Requirements** All construction sites are required to implement construction BMPs in accordance with the performance standards in the <u>Storm Water Standards Manual</u>. Some sites are additionally required to obtain coverage under the State Construction General Permit (CGP)¹, which is administered by the State Regional Water Quality Control Board. For all projects complete PART A: If project is required to submit a SWPPP or WPCP, continue to PART B. **PART A: Determine Construction Phase Storm Water Requirements.** . Is the project subject to California's statewide General NPDES permit for Storm Water Discharges Associated with Construction Activities, also known as the State Construction General Permit (CGP)? (Typically projects with land disturbance greater than or equal to 1 acre.) Yes; SWPPP required, skip questions 2-4 X No; next question 2. Does the project propose construction or demolition activity, including but not limited to, clearing, grading, grubbing, excavation, or any other activity resulting in ground disturbance and/or contact with storm water? X Yes; WPCP required, skip questions 3-4 No; next question 3. Does the project propose routine maintenance to maintain original line and grade, hydraulic capacity, or original purpose of the facility? (Projects such as pipeline/utility replacement) Yes; WPCP required, skip question 4 No; next question 4. Does the project only include the following Permit types listed below? Electrical Permit, Fire Alarm Permit, Fire Sprinkler Permit, Plumbing Permit, Sign Permit, Mechanical Permit, Individual Right of Way Permits that exclusively include only ONE of the following activities: water service, sewer lateral, or utility service. Right of Way Permits with a project footprint less than 150 linear feet that exclusively include only ONE of the following activities: curb ramp, sidewalk and driveway apron replacement, pot holing, curb and gutter replacement, and retaining wall encroachments. Yes; no document required Check one of the boxes below, and continue to PART B: If you checked "Yes" for question 1, a SWPPP is REQUIRED. Continue to PART B If you checked "No" for question 1, and checked "Yes" for question 2 or 3, **a WPCP is REQUIRED.** If the project proposes less than 5,000 square feet of ground disturbance AND has less than a 5-foot elevation change over the entire project area, a Minor WPCP may be required instead. **Continue to PART B.** If you checked "No" for all questions 1-3, and checked "Yes" for question 4 PART B **does not apply and no document is required. Continue to Section 2.** . More information on the City's construction BMP requirements as well as CGP requirements can be found at: Printed on recycled paper. Visit our web site at www.sandiego.gov/development-services.

Upon request, this information is available in alternative formats for persons with disabilities.

Page 2 of 4 City of San Diego • Development Services • Storm Water Requirements Applicability Checklist

This prioritization must be completed within this form, noted on the plans, and included in the SWPPP or WPCP. The city reserves the right to adjust the priority of projects both before and after construction. Construction projects are assigned an inspection frequency based on if the project has a "high threat to water quality." The City has aligned the local definition of "high threat to water quality" to the risk determination approach of the State Construction General Permit (CGP). The CGP determines risk level based on project specific sediment risk

and receiving water risk. Additional inspection is required for projects within the Areas of Special Biological Significance (ASBS) watershed. **NOTE:** The construction priority does **NOT** change construction BMP requirements

a. Projects that qualify as Risk Level 2 or Risk Level 3 per the Construction General Permit

a. Projects that are not located in an ASBS watershed or designated as a High priority site. b. Projects that qualify as Risk Level 1 or LUP Type 1 per the CGP and not located in an ASBS

a. Projects not subject to a Medium or High site priority designation and are not located in an ASBS

c. WPCP projects (>5,000sf of ground disturbance) located within the Los Penasquitos

Additional information for determining the requirements is found in the <u>Storm Water Standards Manual</u>.

PART C: Determine if Not Subject to Permanent Storm Water Requirements.

Projects that are considered maintenance, or otherwise not categorized as "new development projects" or "redevelopment projects" according to the <u>Storm Water Standards Manual</u> are not subject to Permanent Storm Water

If "yes" is checked for any number in Part C, proceed to Part F and check "Not Subject to Permanent Storm Water BMP Requirements".

b. Projects that qualify as LUP Type 2 or LUP Type 3 per the CGP and not located in the ASBS watershed.

that apply to projects; rather, it determines the frequency of inspections that will be conducted by city staff.

PART B: Determine Construction Site Priority

Complete PART B and continued to Section 2

High Priority

Medium Priority

creating new impervious surfaces?

a. Projects located in the ASBS watershed.

watershed management area.

SECTION 2. Permanent Storm Water BMP Requirements.

If "no" is checked for all of the numbers in Part C continue to Part D.

replacement of damaged pavement (grinding, overlay, and pothole repair).

Does the project only include interior remodels and/or is the project entirely within an

Does the project only include the construction of overhead or underground utilities without

roof or exterior structure surface replacement, resurfacing or reconfiguring surface parking lots or existing roadways without expanding the impervious footprint, and routine

existing enclosed structure and does not have the potential to contact storm water?

(CGP) and not located in the ASBS watershed.

PART D: PDP Exempt Requirements. PDP Exempt projects are required to implement site design and source control BMPs. If "yes" was checked for any questions in Part D, continue to Part F and check the box labeled "PDP Exempt." If "no" was checked for all questions in Part D, continue to Part E. 1. Does the project ONLY include new or retrofit sidewalks, bicycle lanes, or trails that: • Are designed and constructed to direct storm water runoff to adjacent vegetated areas, or other non-erodible permeable areas? Or; Are designed and constructed to be hydraulically disconnected from paved streets and roads? Or; Are designed and constructed with permeable pavements or surfaces in accordance with the Green Streets guidance in the City's Storm Water Standards manual? Yes; PDP exempt requirements apply No; next question Does the project ONLY include retrofitting or redeveloping existing paved alleys, streets or roads designed and constructed in accordance with the Green Streets guidance in the <u>City's Storm Water Standards Manual</u>? Yes; PDP exempt requirements apply No; project not exempt. PART E: Determine if Project is a Priority Development Project (PDP). Projects that match one of the definitions below are subject to additional requirements including preparation of a Storm Water Quality Management Plan (SWQMP). If "yes" is checked for any number in PART E, continue to PART F and check the box labeled "Priority Development Project". If "no" is checked for every number in PART E, continue to PART F and check the box labeled

1.	New Development that creates 10,000 square feet or more of impervious surfaces collectively over the project site. This includes commercial, industrial, residential, mixed-use, and public development projects on public or private land.	□Yes	×
2.	Redevelopment project that creates and/or replaces 5,000 square feet or more of impervious surfaces on an existing site of 10,000 square feet or more of impervious surfaces. This includes commercial, industrial, residential, mixed-use, and public development projects on public or private land.		
3.	New development or redevelopment of a restaurant. Facilities that sell prepared foods and drinks for consumption, including stationary lunch counters and refreshment stands sellir prepared foods and drinks for immediate consumption (SIC 5812), and where the land development creates and/or replace 5,000 square feet or more of impervious surface.	ng Yes	X
4.	New development or redevelopment on a hillside. The project creates and/or replaces 5,000 square feet or more of impervious surface (collectively over the project site) and where the development will grade on any natural slope that is twenty-five percent or greater.	ĭ¥Yes	
5.	New development or redevelopment of a parking lot that creates and/or replaces 5,000 square feet or more of impervious surface (collectively over the project site).	Yes	X
6.	New development or redevelopment of streets, roads, highways, freeways, and driveways. The project creates and/or replaces 5,000 square feet or more of impervious surface (collectively over the project site).	Yes	X

Page 4 of 4 City of San Diego • Development Services • Storm Water Requirements Applicability Checklist New development or redevelopment discharging directly to an Environmentally Sensitive Area. The project creates and/or replaces 2,500 square feet of impervious surface (collectively over project site), and discharges directly to an Environmentally Sensitive (collectively over project site), and discharges directly to an Environmentally Sensitive Area (ESA). "Discharging directly to" includes flow that is conveyed overland a distance of 200 feet or less from the project to the ESA, or conveyed in a pipe or open channel any distance as an isolated flow from the project to the ESA (i.e. not commingled with flows from adjacent Yes New development or redevelopment projects of a retail gasoline outlet (RGO) that create and/or replaces 5,000 square feet of impervious surface. The development project meets the following criteria: (a) 5,000 square feet or more or (b) has a projected Average Daily Traffic (ADT) of 100 or more vehicles per day. 🗌 Yes 🗵 No New development or redevelopment projects of an automotive repair shops that creates and/or replaces 5,000 square feet or more of impervious surfaces. Development projects categorized in any one of Standard Industrial Classification (SIC) codes 5013, 5014, 5541, 7532-7534, or 7536-7539. D. Other Pollutant Generating Project. The project is not covered in the categories above, results in the disturbance of one or more acres of land and is expected to generate pollutants post construction, such as fertilizers and pesticides. This does not include projects creating less than 5,000 sf of impervious surface and where added landscaping does not require regular use of pesticides and fertilizers, such as slope stabilization using native plants. Calculation of the square footage of impervious surface need not include linear pathways that are for infrequent

	vehicle use, such as emergency maintenance access or bicycle pedestrian use, if they are built with pervious surfaces of if they sheet flow to surrounding pervious surfaces.	es 🗵 N
PA	ART F: Select the appropriate category based on the outcomes of PART C through PART	E.
1.	The project is NOT SUBJECT TO PERMANENT STORM WATER REQUIREMENTS .	
2.	The project is a STANDARD DEVELOPMENT PROJECT . Site design and source control BMP requirements apply. See the <u>Storm Water Standards Manual</u> for guidance.	
3.	The project is PDP EXEMPT . Site design and source control BMP requirements apply. See the <u>Storm Water Standards Manual</u> for guidance.	
4.	The project is a PRIORITY DEVELOPMENT PROJECT . Site design, source control, and structural pollutant control BMP requirements apply. See the <u>Storm Water Standards Manual</u> for guidance on determining if project requires a hydromodification plan management	X

Dan S. Biggs, PE (Agent for Owner) Name of Owner or Agent (Please Print) Signature

PRIOR TO THE ISSUANCE OF ANY CONSTRUCTION PERMIT, THE OWNER/PERMITTEE SHALL INCORPORATE ANY CONSTRUCTION BEST MANAGEMENT PRACTICES NECESSARY TO COMPLY WITH CHAPTER 14, ARTICLE 2, DIVISION 1 (GRADING REGULATIONS) OF THE SAN DIEGO MUNICIPAL CODE, INTO THE CONSTRUCTION PLANS OR SPECIFICATIONS.

AREA OF SPECIAL BIOLOGICAL SIGNIFICANCE (ASBS)

THIS PROJECT IS LOCATED WITHIN AN ASBS. APPLICANT/PREMITTE WHALL COMLE WITH ALL ASBS REQUIREMENTS ACCORDINGLY



Morgan

8441 WHALE WATCH WAY LA JOLLA, CA 92037 APN: 346-690-25-00

+ project

PREPARED BY	KEY PLAN	NTS	VICINITY MAP	NTS
HAYER ARCHITECTURE Contact: William S. Hayer 445 Marine View Avenue, Suite 280 Del Mar, CA 92014 (858) 792-2800 bhayer@hayerarchitecture.com PROJECT CONSULTANTS Civil Engineer: EARTH WIND WATER CIVIL ENGINEERING			La Jolia Shores Dr.	Torrey Pines Rd (7 torrang) (7 torrang) (8 torrang) (9 torrang) (10
11440 West Bernardo Court, Suite 300 Rancho Bernardo, CA 92127 (858) 753-1947	PROJECT DATA	NORTH	PROJECT ADDRE	
Geotechnical Engineer:	Construction:	VB Sprinklered	8441 Whale Watch	
GEOTECHNICAL EXPLORATION, INC 7420 Trade Street		·	La Jolla, CA 9203	,
San Diego, CA 92121 (858) 549-7222	Occupancy:	R-3 S.F.R.	PROJECT OWNER	₹
	Code:	2016 Edition-C.R.C.	Ronnie & Marci Mo	organ
Surveyor: WOODLAND SURVEYING, INC.	Zoning:	LJSPD-SF	- ASSESSOR'S PAR	OCEL NO :
2180 Garnet Ave., Suite 3G San Diego, CA 92108	No. of Stories:	2 Stories		
(858) 273-4700	Site Area:	20,020 sf.	346-690-	25-00
Landscape Architect: GREG HEBERT LANDSCAPE ARCHITECT	Gross Floor Area:	11,652 sf.	LEGAL DESCRIPT	ION:
3153 Third Avenue San Diego, CA 92103	F.A.R.:	58.2%	LOT 25 OF LA JOI MAP NO. 6865	LA COSTA DORADO
(619) 283-5083	Geo Hazzard Area	ı: 26 & 53	BENCHMARK:	
COMMUNITY PLAN	Landscape Area:	7,590 sf.	Brass plug in top of	
La Jolla Community Plan and Local Coastal Program Land Use Plan: Very Low Density Residential	EXISTING BUILDIN	NG	Northwest corner of & Prestwick Court Record from:	City of San Diego Vertical Control
OVERLAY ZONES	Status:	To Be Demolished	Elevation: Datum:	350.289' MSL, NGVD 1929
Coastal Overlay Zone	Occupancy:	R-3 S.F.R.	PROJECT NO:	
Coastal Height Limit Overlay ZoneSteep Hillsides	Constructed:	1983 Non-Historic	635054	
 Campus Parking Impact Overlay Zone Geological Hazard Categories 	Soil Condition:	Prev. Developed	PROJECT NAME:	DECIDENCE
				RESIDENCE
APPROVALS:			-	EET TITLE:
PERMITS REQUIRED:	ORIGINAL DATE:	REVISIONS:		R QUALITY RMATION
Coastal Development Permit Site Development Permit	05-23-2019	02-05-2020 06-29-2020 10-06-2020	3	OF 16


ATTACHMENT 10


hayer

+ consultant +

+ project

architecture 445 Marine View AVE Suite 280 Del Mar , CA 92014 t858 792 2800 f858 792 2802

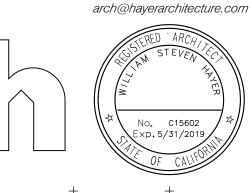

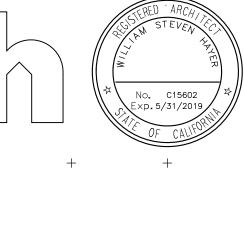


Morgan Residence

8441 WHALE WATCH WAY

LA JOLLA, CA 92037

APN: 346-690-25-00

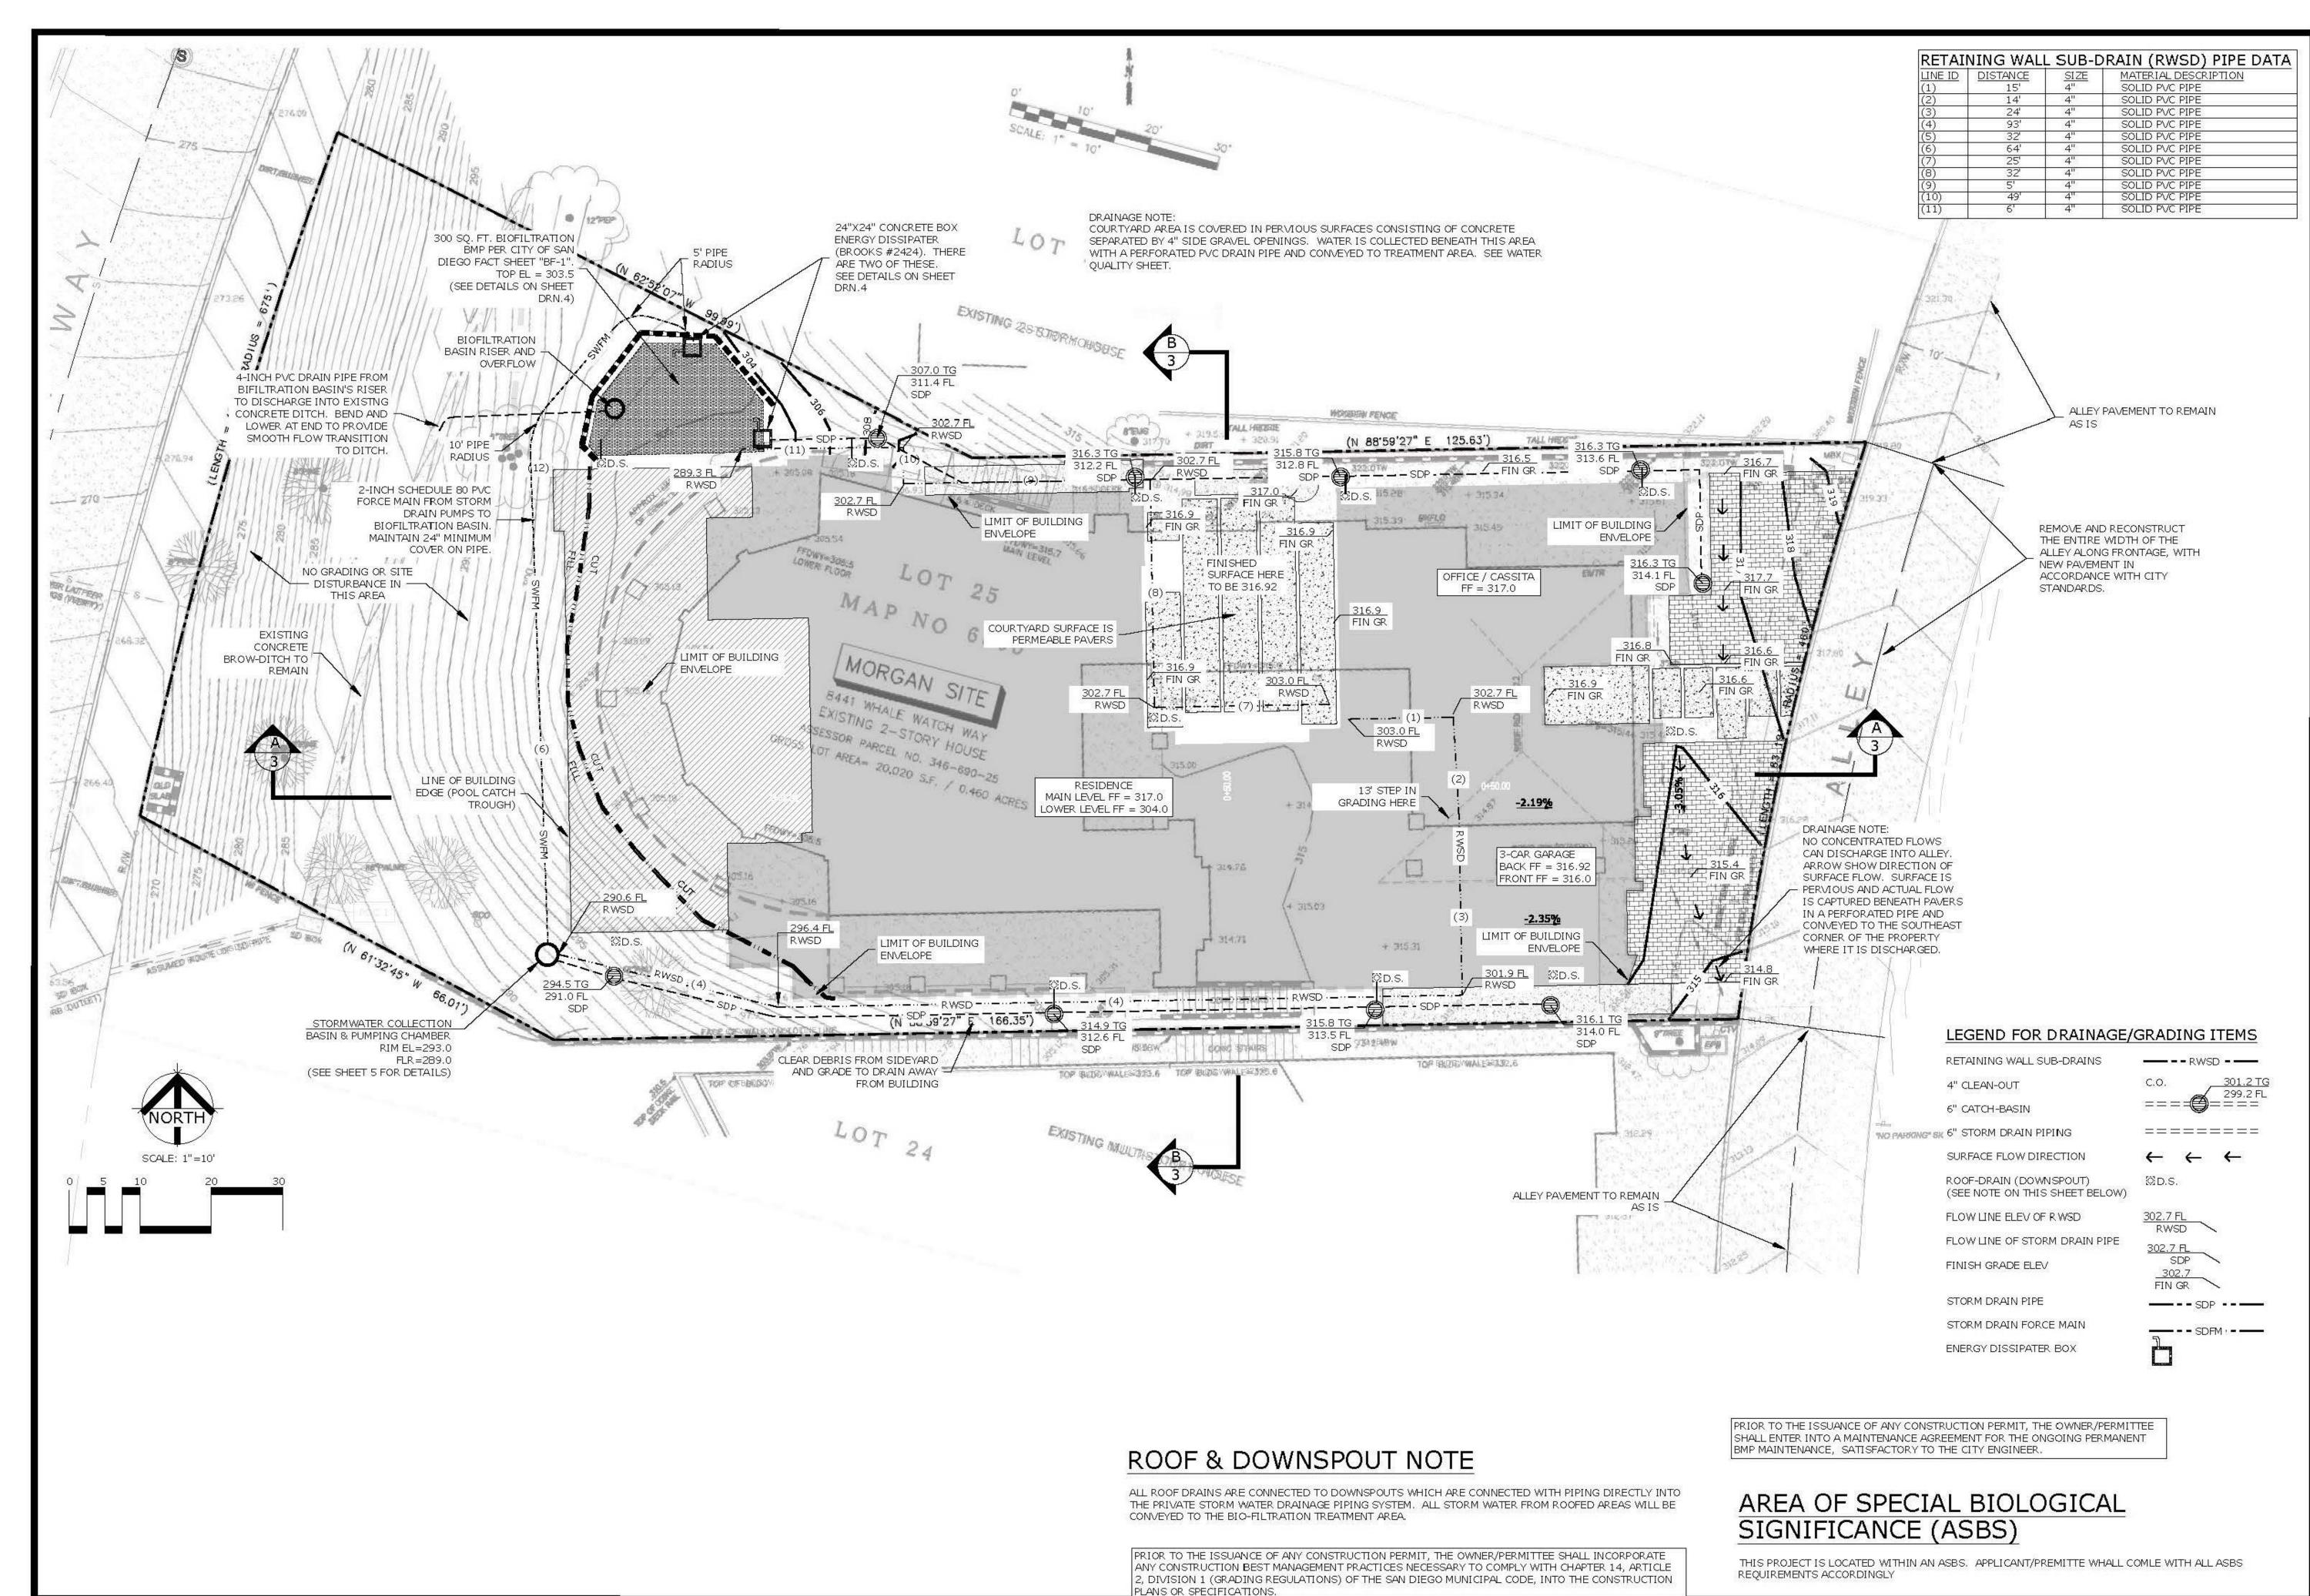

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PREPARED BY	KEY PLAN	NTS	VICINITY MAP NTS				
HAYER ARCHITECTURE Contact: William S. Hayer 445 Marine View Avenue, Suite 280 Del Mar, CA 92014 (858) 792-2800 bhayer@hayerarchitecture.com			Made Water) All Shores By Commercial La Jolla Shores By Da Sauld AlaJoL La Jolla Scenic Dr.				
PROJECT CONSULTANTS			Shores Dr.				
Civil Engineer: EARTH WIND WATER CIVIL ENGINEERING 11440 West Bernardo Court, Suite 300 Rancho Bernardo, CA 92127	(NORTH	Torrey Pines Rd Torrey Pines Rd Sellog et all additions				
(858) 753-1947	PROJECT DATA		PROJECT ADDRESS				
Geotechnical Engineer: GEOTECHNICAL EXPLORATION, INC	Construction:	VB Sprinklered	8441 Whale Watch Way La Jolla, CA 92037				
7420 Trade Street San Diego, CA 92121	Occupancy:	R-3 S.F.R.	·				
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Campus Parking Impact Overlay Zone Geological Hazard Categories	Soil Condition:	Prev. Developed	PROJECT NAME:				
Goological Hazard Gategories			MORGAN RESIDENCE				
APPROVALS:			SHEET TITLE:				
PERMITS REQUIRED:	ORIGINAL DATE:	REVISIONS:	DRAINAGE AND GRADING SITE PLAN SHEET NUMBER:				
Coastal Development Permit Site Development Permit	05-23-2019	02-05-2020 06-29-2020 10-06-2020	4				


EXISTING GROUND LINE OUTDOOR LIVING AREA LOWER LEVEL OF RESIDENCE REAR DECK AND POOL EXISTING GROUND LINE -FINISH GROUND LINE FINISH GROUND LINE LOWER LEVEL OF RESIDENCE EXISTING SLOPE AREA TO REMAIN GRADING SECTION "B" - SIDE TO SIDE OF LOT GRADING SECTION "A" - FRONT TO BACK OF LOT SCALE: 1" = 10' H & V SCALE: 1" = 10' H & V S 30" DIAMETERCMP RISER. INFLOW PIPE HERE, SO IT TOP EL=305.0 PRECAST CONCRETE BOX BY IMPACTS OPPOSITE WALL. WEIR EL=304.5 BROOKS, OR EQUAL (BROOKS - #2424) WITH GALVANIZED FLAT GRATE ON COP. ENTIRE RISER STRUCTURE COATED IN "TRENCHCOAT" PROTECTANT. STEEL SOLID LID, REMOVABLE WELL AGED MULCH ON TOP CONCRETE BOX IS SITTING OUTFLOW PIPE IS 2" SOLID A BSM (BIORETENTION SOIL MEDIA) WITH A MIN. ON MIN. 18" OF 2" ROCK PVC WITH UP-TURN AT END 5"/HR INFILTRATION RATE, PER SPECIFICATIONS IN APPENDIX F.3 OF CITY OF SAN DIEGO BMP GRAVEL BASE, UNDERNEATH. SO DISCHARGE BUBBLES UP AS IT EXITS. DESIGN MANUAL - FILTER COURSE LAYER: → 3" OF CLEAN, WASHED ASTM#33 FINE UP-BEND AT EXIT AGGREGATE OVER 3" LAYER OF ASTM#8 STONE. 🕄 20 MIL PVC LINING 🎚 END OF PIPE ALL AROUND BIOFILTRATION STORAGE LAYER: SET ELEVATION OF ENERGY BASIN ASTM#57 OPEN GRADED STONE. DISSIPATER SO THAT THE EXIT UP-BEND IS 6" ABOVE THE MULCH ELEVATION 8" PERFORATED PVC BASIN UNDER-DRAIN FROM **BIOFILTRATION BED** ENERGY DISSIPATER AT BIOFILTRATION BASIN STORAGE LAYER: ASTM#57 OPEN GRADED STONE. HYDROMODIFICATION DEVICES IN RISER: ORIFICE #1= 0.4" DIAMETER HOLE AT BOTTOM CMP RISER SITS ON ORIFICE #2= 0.5" DIAMETER HOLE AT 0.9' SUITABLE CONCRETE BASE ABOVE BOTTOM **RET WALL** A RECTANGULAR WEIR IS LOCATED AT TOP OF PREPARED BY − TW=305.2 RISER AND IS 6" BY 6" **RET WALL** TF=303.2 TW=305.2 -HAYER ARCHITECTURE NOTE: "BOTTOM", ABOVE MEANS THE FLOW-LINE RETAINING WALL: TF=302.2 Contact: William S. Hayer OF THE 8" BASIN UNDER-DRAIN. PER CITY OF SAN 445 Marine View Avenue, Suite 280 DIEGO INFORMATION TYPICAL SECTION THROUGH Del Mar, CA 92014 BULLETIN#221 (858) 792-2800 4-INCH PVC bhayer@hayerarchitecture.com BIOFILTRATION BASIN AT RISER San Barrier Barrier DISCHARGE FROM RISER IS INTO **EXISTING CONCRETE** SCALE: 1'' = 2'BROW-DITCH, AT PROJECT CONSULTANTS **FLOWLINE** Civil Engineer: EARTH WIND WATER CIVIL ENGINEERING **RET WALL** 11440 West Bernardo Court, Suite 300 TW = 305.2 -8" PERF PVC Rancho Bernardo, CA 92127 TF=302.2 BOTTOM DRAIN (858) 753-1947 Geotechnical Engineer: GEOTECHNICAL EXPLORATION, INC FG=302.0 7420 Trade Street San Diego, CA 92121 (858) 549-7222 30" DIAMETER CMP RISER FOR EHYDROMODIFICATION 3 WOODLAND SURVEYING, INC. RET WALL % FG=302.0 55 € 100 FG E AND EMERGENCY 2180 Garnet Ave., Suite 3G TW = 305.2OVERFLOW. SEE San Diego, CA 92108 TF=302.2 DETAILS ON THIS (858) 273-4700 ENERGY DISSIPATER GREG HEBERT LANDSCAPE ARCHITECT 3153 Third Avenue San Diego, CA 92103 (619) 283-5083 COMMUNITY PLAN PRIOR TO THE ISSUANCE OF ANY CONSTRUCTION PERMIT, THE OWNER/PERMITTEE SHALL INCORPORATE La Jolla Community Plan and Local ANY CONSTRUCTION BEST MANAGEMENT PRACTICES NECESSARY TO COMPLY WITH CHAPTER 14, ARTICLE Coastal Program Land Use Plan: PLAN VIEW OF WATER-QUALITY TREATMENT AREA 2, DIVISION 1 (GRADING REGULATIONS) OF THE SAN DIEGO MUNICIPAL CODE, INTO THE CONSTRUCTION - Very Low Density Residential PLANS OR SPECIFICATIONS. OVERLAY ZONES Coastal Overlay Zone Coastal Height Limit Overlay Zone Steep Hillsides Campus Parking Impact Overlay Zone Geological Hazard Categories APPROVALS:

ATTACHMENT 10

hayer

+ consultant

architecture 445 Marine View AVE Suite 280 Del Mar , CA 92014 t858 792 2800 f858 792 2802

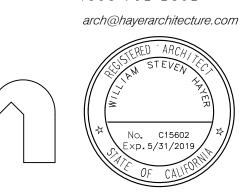



8441 WHALE WATCH WAY LA JOLLA, CA 92037 APN: 346-690-25-00

KEY PLAN NTS VICINITY MAP NORTH PROJECT DATA PROJECT ADDRESS 8441 Whale Watch Way VB Sprinklered Construction: La Jolla, CA 92037 Occupancy: PROJECT OWNER 2016 Edition-C.R.C. Ronnie & Marci Morgan LJSPD-SF ASSESSOR'S PARCEL NO.: No. of Stories: 2 Stories 346-690-25-00 20,020 sf. Site Area: Gross Floor Area: 11,652 sf. LEGAL DESCRIPTION: LOT 25 OF LA JOLLA COSTA DORADO Geo Hazzard Area: 26 & 53 BENCHMARK: Landscape Area: 7,590 sf. Brass plug in top of curb at Northwest corner of Prestwick Drive & Prestwick Court Record from: City of San Diego EXISTING BUILDING Vertical Control 350.289' To Be Demolished MSL, NGVD 1929 Datum: PROJECT NO: Occupancy: R-3 S.F.R. 635054 Constructed: 1983 Non-Historic PROJECT NAME: Soil Condition: Prev. Developed MORGAN RESIDENCE SHEET TITLE: SECTIONS AND DETAILS

ORIGINAL DATE:

05-23-2019

REVISIONS:

02-05-2020

06-29-2020 10-06-2020 SHEET NUMBER:

5


OF **16**

PERMITS REQUIRED:

Coastal Development Permit

Site Development Permit

+ consultant +

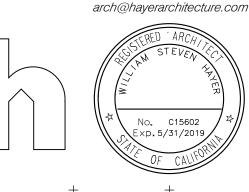

Morgan

Residence



CONC STAIRS

GENERAL EROSION CONTROL / BMP

PRIOR TO ANY SOIL DISTURBANCE, TEMPORARY SEDIMENT CONTROLS SHALL BE INSTALLED

- BY THE CONTRACTOR OR QUALIFIED PERSON (S)AS INDICATED BELOW: 1. ALL REQUIREMENTS OF THE CITY OF SAN DIEGO "STORM WATER STANDARDS MANUAL" MUST BE INCORPORATED INTO THE DESIGN AND CONSTRUCTION OF THE PROPOSED GRADING/IMPROVEMENTS CONSISTENT WITH THE APPROVED STORM WATER POLLUTION PREVENTION PLAN (SWPPP) AND/OR WATER POLLUTION CONTROL PLAN (WPCP) FOR CONSTRUCTION LEVEL BMPS AND, IF APPLICABLE, THE STORM WATER QUALITY MANAGEMENT PLAN (SWQMP) FOR POST-CONSTRUCTION BMPS.
- THE CONTRACTOR SHALL INSTALL AND MAINTAIN ALL STORM DRAIN INLET PROTECTION. INLET PROTECTION IN THE PUBLIC RIGHT-OF-WAY MUST BE TEMPORARILY REMOVED PRIOR TO A RAIN EVENT TO ENSURE NO FLOODING OCCURS AND REINSTALLED AFTER RAIN IS OVER.
- 3. ALL CONSTRUCTION BMPS SHALL B E INSTALLED AND PROPERLY MAINTAINED THROUGHOUT THE DURATION OF CONSTRUCTION.
- 4. THE CONTRACTOR SHALL ONLY GRADE, INCLUDING CLEARING AND GRUBBING, AREAS FOR WHICH THE CONTRACTOR OR QUALIFIED CONTACT PERSON CAN PROVIDE EROSION AND SEDIMENT CONTROL MEASURES.
- 5. THE CONTRACTOR IS RESPONSIBLE FOR ENSURING THAT ALL SUB-CONTRACTORS AND SUPPLIERS ARE AWARE OF ALL STORM WATER BMPS AND IMPLEMENT SUCH MEASURES. FAILURE TO COMPLY WITH THE APPROVED SWPPP/WPCP WILL RESULT IN THE ISSUANCE OF CORRECTION NOTICES, CITATIONS, CIVIL PENALTIES, AND/OR STOP WORK NOTICES.
- 6. THE CONTRACTOR OR QUALIFIED CONTACT PERSON SHALL BE RESPONSIBLE FOR CLEANUP OF ALL SILT, DEBRIS, AND MUD ON AFFECTED AND ADJACENT STREET (S)AND WITHIN STORM DRAIN SYSTEM DUE TO CONSTRUCTION VEHICLES/EQUIPMENT AND CONSTRUCTION ACTIVITY AT THE END OF EACH WORK DAY.
- 7. THE CONTRACTOR SHALL PROTECT NEW AND EXISTING STORM WATER CONVEYANCE SYSTEMS FROM SEDIMENTATION, CONCRETE RINSE, OR OTHER CONSTRUCTION RELATED DEBRIS AND DISCHARGES WITH THE APPROPRIATE BMPS THAT ARE ACCEPTABLE TO THE

- RESIDENT ENGINEER AND AS INDICATED IN THE SWPPP/WPCP.
- 8. THE CONTRACTOR OR QUALIFIED CONTACT PERSON SHALL CLEAR DEBRIS, SILT, AND MUD FROM ALL DITCHES AND SWALES PRIOR TO AND WITHIN 3 BUSINESS DAYS AFTER EACH RAIN EVENT OR PRIOR TO THE NEXT RAIN EVENT, WHICHEVER IS SOONER.

(N₀88*59'27" F 166.35')

309257W/0502B168W

THE PROPERTY - SOUTH A TOP POUTSCHILD - 32325 6

- 9. IF A NON-STORM WATER DISCHARGE LEAVES THE SITE, THE CONTRACTOR SHALL IMMEDIATELY STOP THE ACTIVITY AND REPAIR THE DAMAGES. THE CONTRACTOR SHALL NOTIFY THE RESIDENT ENGINEER OF THE DISCHARGE, PRIOR TO RESUMING CONSTRUCTION ACTIVITY. ANY AND ALL WASTE MATERIAL, SEDIMENT, AND DEBRIS FROM EACH NON-STORM WATER DISCHARGE SHALL BE REMOVED FROM THE STORM DRAIN CONVEYANCE SYSTEM AND PROPERLY DISPOSED OF BY THE CONTRACTOR.
- 10. EQUIPMENT AND WORKERS FOR EMERGENCY WORK SHALL BE MADE AVAILABLE AT ALL ALL NECESSARY MATERIALS SHALL BE STOCKPILED ONSITE AT CONVENIENT LOCATIONS TO FACILITATE RAPID DEPLOYMENT OF CONSTRUCTION BMPS WHEN RAIN IS IMMINENT.
- 11. THE CONTRACTOR SHALL RESTORE AND MAINTAIN ALL EROSION AND SEDIMENT CONTROL BMPS TO WORKING ORDER YEAR ROUND.
- 12. THE CONTRACTOR SHALL INSTALL ADDITIONAL EROSION AND SEDIMENT CONTROL MEASURES DUE TO UNFORESEEN CIRCUMSTANCES TO PREVENT NON-STORM WATER AND SEDIMENT-LADEN DISCHARGES.
- 13. THE CONTRACTOR SHALL BE RESPONSIBLE AND SHALL TAKE NECESSARY PRECAUTIONS TO PREVENT PUBLIC TRESPASS ONTO AREAS WHERE IMPOUNDED WATERS CREATE A HAZARDOUS CONDITION.
- 14. ALL EROSION AND SEDIMENT CONTROL MEASURES PROVIDED PER THE APPROVED SWPPP/WPCP SHALL BE INSTALLED AND MAINTAINED. ALL EROSION AND SEDIMENT CONTROLS FOR INTERIM CONDITIONS SHALL BE PROPERLY DOCUMENTED AND INSTALLED TO THE SATISFACTION OF THE RESIDENT ENGINEER.
- 15. AS NECESSARY, THE RESIDENT ENGINEER SHALL SCHEDULE MEETINGS FOR THE PROJECT TEAM (GENERAL CONTRACTOR, QUALIFIED CONTACT PERSON, EROSION CONTROL SUBCONTRACTOR IF ANY, ENGINEER OF WORK, OWNER/DEVELOPER, AND THE RESIDENT ENGINEER)TO EVALUATE THE ADEQUACY OF THE EROSION AND SEDIMENT CONTROL MEASURES AND OTHER BMPS RELATIVE TO ANTICIPATED CONSTRUCTION ACTIVITIES.

16. THE CONTRACTOR OR QUALIFIED CONTACT PERSON SHALL CONDUCT VISUAL INSPECTIONS AND MAINTAIN ALL BMPS DAILY AND AS NEEDED. VISUAL INSPECTIONS AND MAINTENANCE OF ALL BMPS SHALL BE CONDUCTED BEFORE, DURING, AND AFTER EVERY RAIN EVENT AND EVERY 24 HOURS DURING ANY PROLONGED RAIN EVENT. THE CONTRACTOR SHALL MAINTAIN AND REPAIR ALL BMPS AS SOON AS POSSIBLE AS SAFETY

TOP BUDGWWALE 363 50.6

- 17. CONSTRUCTION ENTRANCE AND EXIT AREA. TEMPORARY CONSTRUCTION ENTRANCE AND EXITS SHALL BE CONSTRUCTED IN ACCORDANCE WITH CASQA FACT SHEET TC-1 OR CALTRANS FACT SHEET TC-01 TO PREVENT TRACKING OF SEDIMENT AND OTHER POTENTIAL POLLUTANTS ONTO PAVED SURFACES AND TRAVELED WAYS. WIDTH SHALL BE 10' OR THE MINIMUM NECESSARY TO ACCOMMODATE VEHICLES AND EQUIPMENT WITHOUT BY- PASSING THE ENTRANCE.
- 18. NON-STORM WATER DISCHARGES SHALL BE EFFECTIVELY MANAGED PER THE SAN DIEGO MUNICIPAL CODE CHAPTER 4, ARTICLE 3, DIVISION 3 "STORM WATER MANAGEMENT AND DISCHARGE CONTROL".

SPECIAL RAINY SEASON PROVISIONS

DURING THE RAINY SEASON, THE CONTRACTOR MUST TAKE SPECIAL CARE TO MAKE SURE THAT ALL PROVISIONS OF THIS PLAN AND THE WATER POLLUTION CONTROL PROGRAM ARE FULLY IMPLEMENTED.

- 1. THE RAINY SEASON IS DEFINED AS FROM OCTOBER 1ST TO MAY 1ST.
- 2. ALL EROSION CONTROL FEATURES (BMPs) SHALL BE INSPECTED AT LEAST ONCE EACH WEEK.
- 3. SEE PROVISIONS OF THE WATER POLLUTION CONTROL PROGRAM FOR REQUIRED WORK WHEN A RAIN EVENT IS ANTICIPATED.

EROSION CONTROL LEGEND

THE FOLLOWING EROSION CONTROL BMPs WILL BE USED ON THIS PROJECT, ALONG WITH ALL ELEMENTS OF THE PROJECT'S WATER POLLUTION CONTROL PROGRAM (WPCP) WHICH ARE INCLUDED HEREIN BY REFERENCE.

BMP DWG NO

SS-7

SC-2

SC-7

WM-1

WM-4

WM-8

WM-9

WM-6

SC-6, SC-8

TEMPORARY BMP NAME

EROSION CONTROL METHOD


PHYSICAL STABILIZATION, EROSION CONTROL BLANKET (WINTER) LOT PERIMETER PROTECTION DETAILS

SEDIMENT CONTROL FOR DISTURBED AREAS SILT FENCE GRAVEL BAGS

PREVENTION OF OFF-SITE TRACKING OF SEDIMENT

STREET SWEEPING & VACUUMING GENERAL SITE MANAGEMENT FOR WASTE MATERIAL DELIVERY & STORAGE SPILL PREVENTION & CONTROL CONCRETE WASTE MANAGEMENT

SOLID WASTE MANAGEMENT SANITARY WASTE MANAGEMENT HAZARDOUS WASTE MANAGEMENT

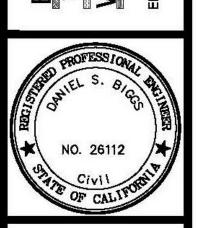

SYMBOL

8441 WHALE WATCH WAY LA JOLLA, CA 92037 APN: 346-690-25-00

PRIOR TO THE ISSUANCE OF ANY CONSTRUCTION PERMIT, THE OWNER/PERMITTEE SHALL INCORPORATE ANY CONSTRUCTION BEST MANAGEMENT PRACTICES NECESSARY TO COMPLY WITH CHAPTER 14, ARTICLE 2, DIVISION 1 (GRADING REGULATIONS) OF THE SAN DIEGO MUNICIPAL CODE, INTO THE CONSTRUCTION PLANS OR SPECIFICATIONS.

PRIOR TO THE ISSUANCE OF ANY CONSTRUCTION PERMIT, THE OWNER/PERMITTEE SHALL ENTER INTO A

MAINTENANCE AGREEMENT FOR THE ONGOING PERMANENT BMP MAINTENANCE, SATISFACTORY TO THE

AREA OF SPECIAL BIOLOGICAL SIGNIFICANCE (ASBS)

CITY ENGINEER.

THIS PROJECT IS LOCATED WITHIN AN ASBS. APPLICANT/PREMITTE WHALL COMLE WITH ALL ASBS REQUIREMENTS ACCORDINGLY

EARTH WIND WATER CIVIL ENGINEERING 11440 West Bernardo Court, Suite 300 NORTH Rancho Bernardo, CA 92127 (858) 753-1947 PROJECT DATA PROJECT ADDRESS Geotechnical Engineer: 8441 Whale Watch Way VB Sprinklered onstruction: GEOTECHNICAL EXPLORATION, INC La Jolla, CA 92037 7420 Trade Street Occupancy: San Diego, CA 92121 PROJECT OWNER (858) 549-7222 2016 Edition-C.R.C Ronnie & Marci Morgan LJSPD-SF WOODLAND SURVEYING, INC. ASSESSOR'S PARCEL NO.: 2180 Garnet Ave., Suite 3G 2 Stories No. of Stories: San Diego, CA 92108 346-690-25-00 (858) 273-4700 20,020 sf. Site Area:

KEY PLAN

NTS VICINITY MAP

GREG HEBERT LANDSCAPE ARCHITECT 3153 Third Avenue San Diego, CA 92103 (619) 283-5083 COMMUNITY PLAN

PREPARED BY

HAYER ARCHITECTURE

Del Mar, CA 92014

(858) 792-2800

Civil Engineer:

Contact: William S. Hayer

445 Marine View Avenue, Suite 280

bhayer@hayerarchitecture.com

PROJECT CONSULTANTS

Coastal Program Land Use Plan: - Very Low Density Residential OVERLAY ZONES Coastal Overlay Zone Steep Hillsides

 Coastal Height Limit Overlay Zone Campus Parking Impact Overlay Zone Geological Hazard Categories APPROVALS:

La Jolla Community Plan and Local

REVISIONS: PERMITS REQUIRED: ORIGINAL DATE: 05-23-2019 02-05-2020 Coastal Development Permit 06-29-2020 Site Development Permit

Gross Floor Area: 11,652 sf.

Geo Hazzard Area: 26 & 53

Landscape Area: 7,590 sf.

To Be Demolished

R-3 S.F.R.

onstructed: 1983 Non-Historic

Soil Condition: Prev. Developed

EXISTING BUILDING

ccupancy:

SHEET TITLE: **EROSION CONTROL PLAN** SHEET NUMBER 0 10-06-2020 OF **16**

MORGAN RESIDENCE

LEGAL DESCRIPTION:

Brass plug in top of curb at

Northwest corner of Prestwick Drive

Record from: City of San Diego

Vertical Control

MSL, NGVD 1929

350.289'

BENCHMARK:

& Prestwick Court


Datum:

PROJECT NO:

635054

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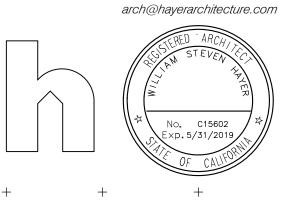
LOT 25 OF LA JOLLA COSTA DORADO

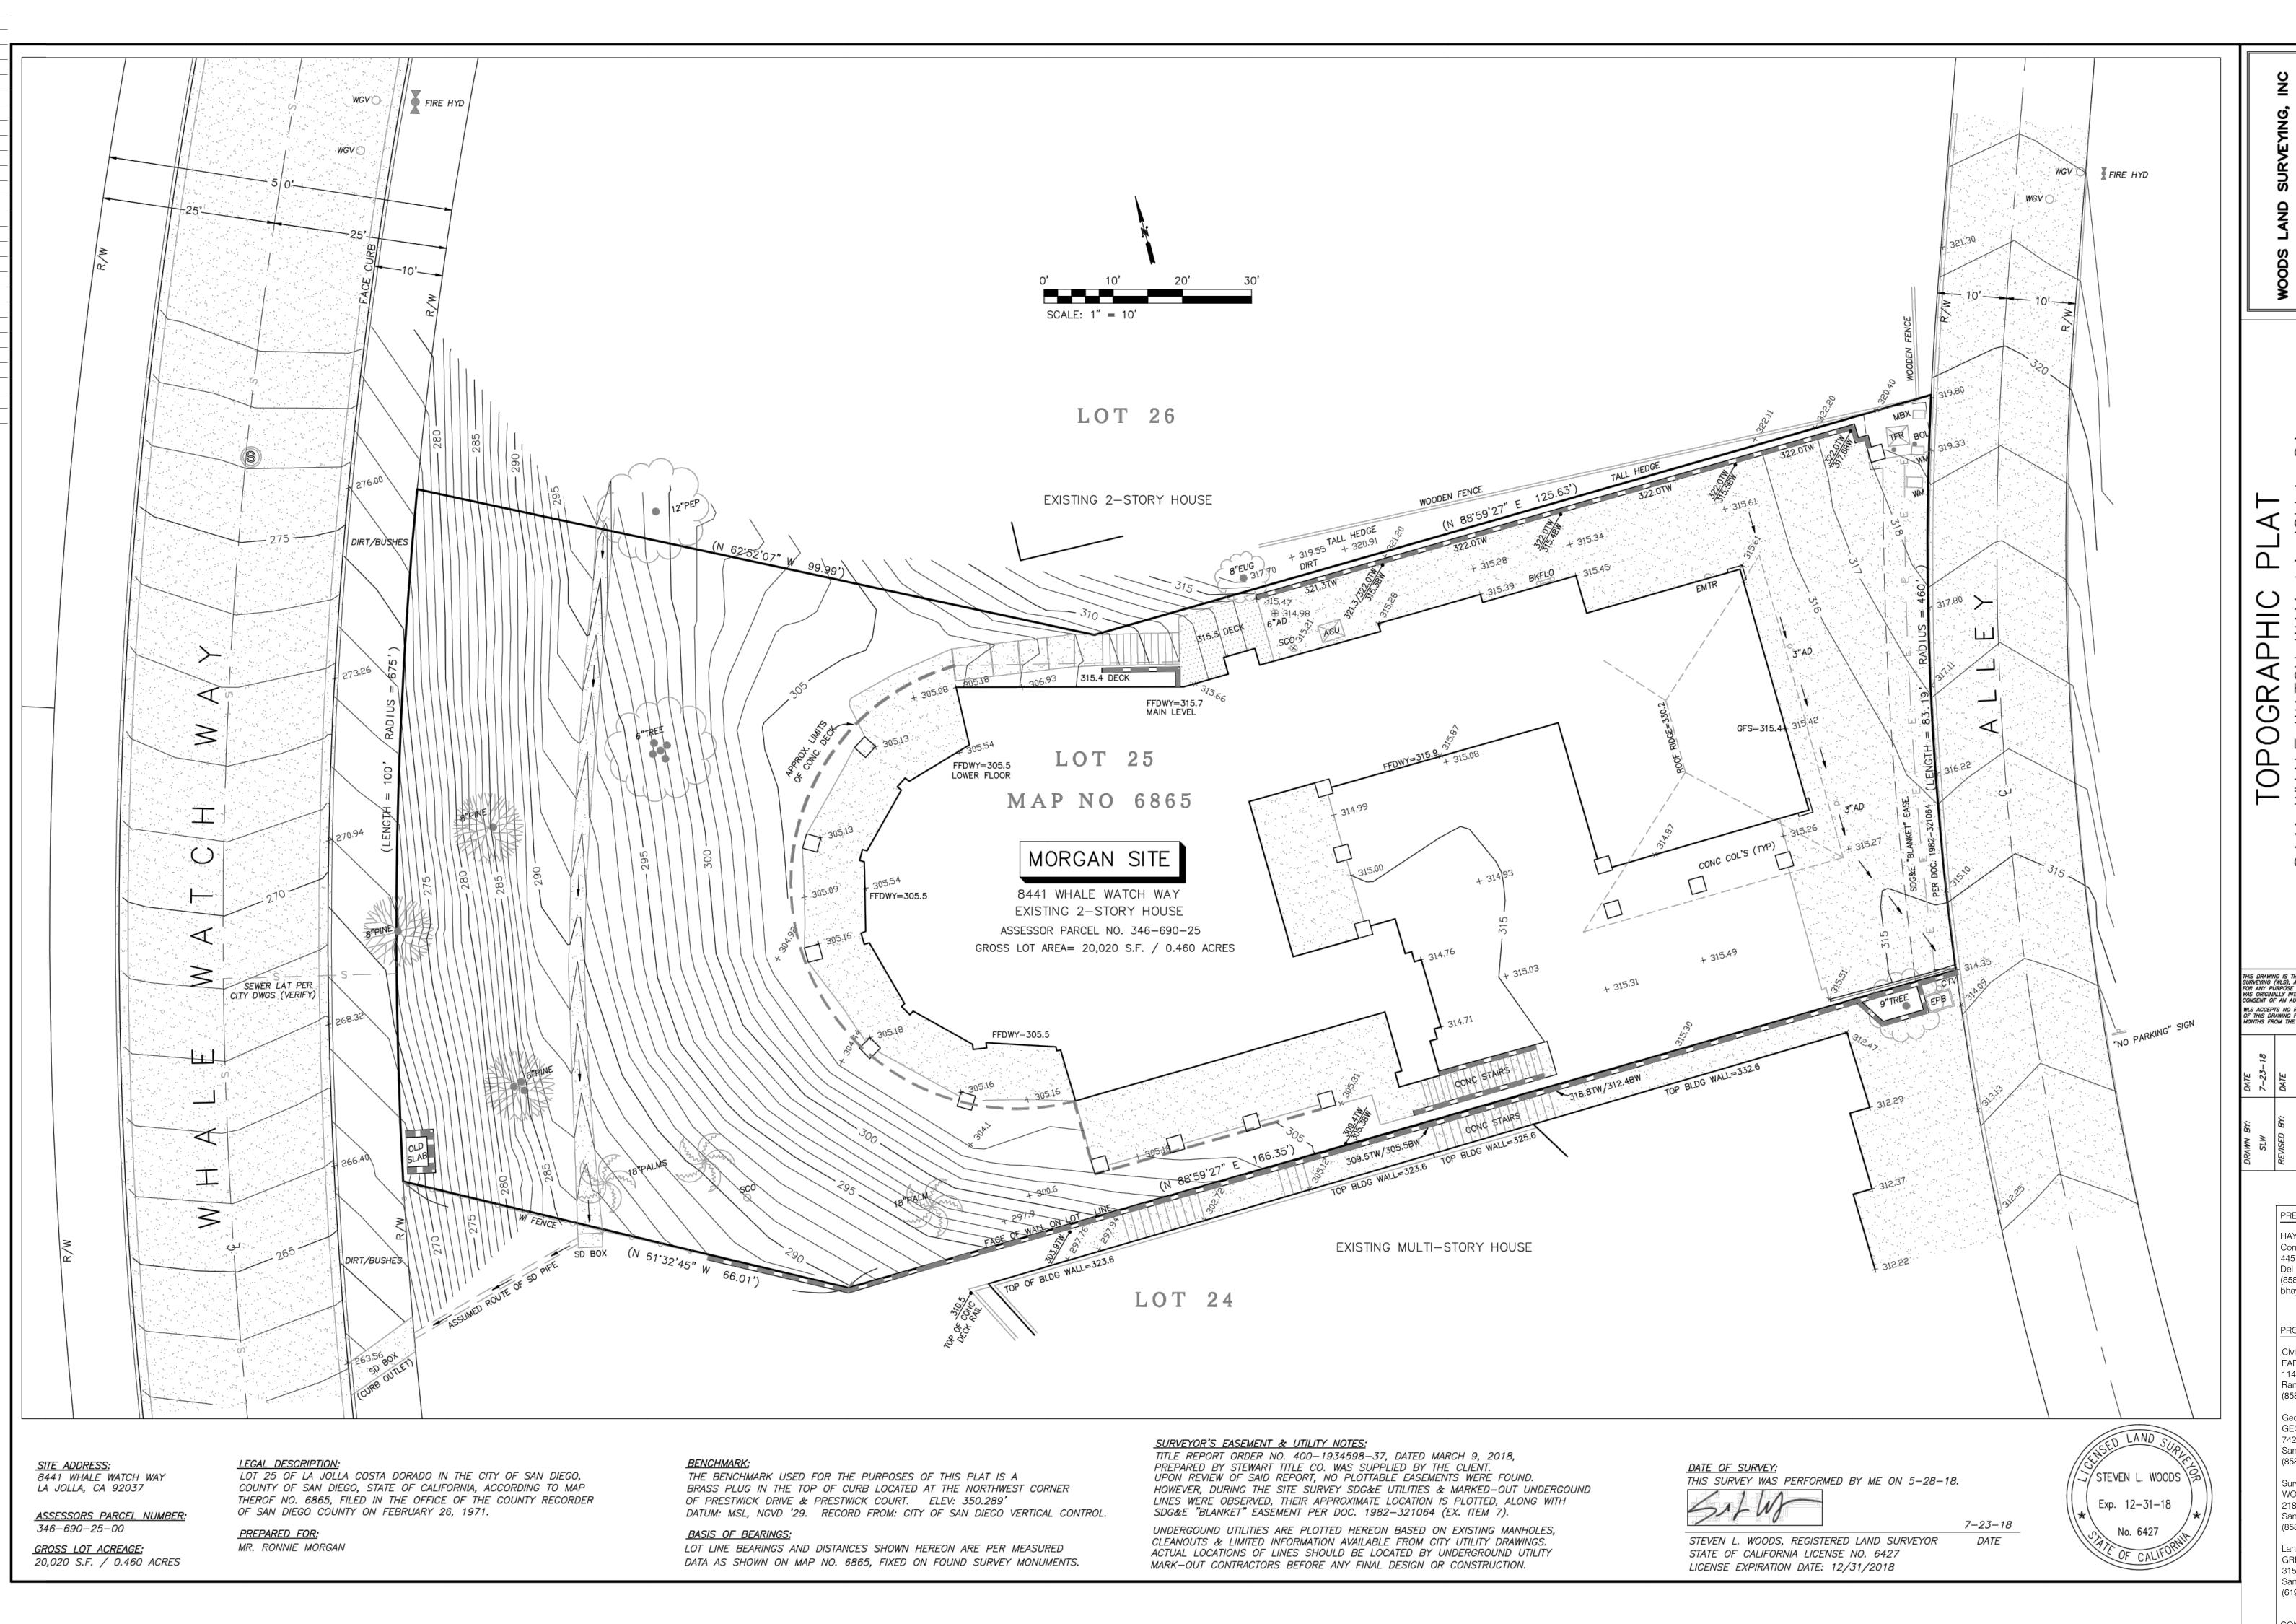

ATTACHMENT 10

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architecture 445 Marine View AVE Suite 280 Del Mar , CA 92014 t858 792 2800 f858 792 2802





Morgan Residence

8441 WHALE WATCH WAY LA JOLLA, CA 92037 APN: 346-690-25-00

THIS DRAWING IS THE PROPERTY OF WISURVEYING (WLS), AND SHALL NOT BE FOR ANY PURPOSE OTHER THAN FOR MAS ORIGINALLY INTENDED WITHOUT THE CONSENT OF AN AUTHORIZED AGENT OF WLS ACCEPTS NO RESPONSIBILITY FOR THIS DRAWING FOR ANY PURPOSE MONTHS FROM THE DATE INDICATED BUT THE DATE BUT THE BUT THE DATE BUT THE										
DATE	7-23-18	DATE								
DRAWN BY:	NTS	REVISED BY:	REVISED BY:							

Campus Parking Impact Overlay Zone

Geological Hazard Categories

APPROVALS:

PERMITS REQUIRED:

Coastal Development Permit

Site Development Permit

PREPARED BY	KEY PLAN	NTS	VICINITY MAP NTS
HAYER ARCHITECTURE Contact: William S. Hayer 445 Marine View Avenue, Suite 280 Del Mar, CA 92014 (858) 792-2800 bhayer@hayerarchitecture.com PROJECT CONSULTANTS			Shores Dr.
Civil Engineer: EARTH WIND WATER CIVIL ENGINEERING 11440 West Bernardo Court, Suite 300 Rancho Bernardo, CA 92127		NORTH	Torrey Pines Rd
(858) 753-1947	PROJECT DATA		PROJECT ADDRESS
Geotechnical Engineer: GEOTECHNICAL EXPLORATION, INC	Construction:	VB Sprinklered	8441 Whale Watch Way La Jolla, CA 92037
7420 Trade Street San Diego, CA 92121	Occupancy:	R-3 S.F.R.	·
(858) 549-7222	Code:	2016 Edition-C.R.C.	PROJECT OWNER Ronnie & Marci Morgan
Surveyor: WOODLAND SURVEYING, INC.	Zoning:	LJSPD-SF	_
2180 Garnet Ave., Suite 3G San Diego, CA 92108	No. of Stories:	2 Stories	ASSESSOR'S PARCEL NO.:
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ORIGINAL DATE:

05-23-2019

PROJECT NAME:

REVISIONS: SHEET NUMBER:

02-05-2020 06-29-2020 10-06-2020

MORGAN RESIDENCE

TOPOGRAPHIC SURVEY

SHEET TITLE:


OF **16**

DRIVEWAY DECK DRIVEWAY BUILDING **EXISTING CONCRETE** DRAINAGE CHANNEL TO REMAIN

ATTACHMENT 10

hayer

architecture 445 Marine View AVE Suite 280 Del Mar , CA 92014 t858 792 2800 f858 792 2802 arch@hayerarchitecture.com

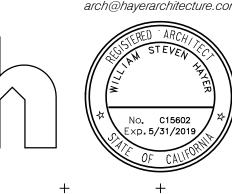

Morgan Residence

8441 WHALE WATCH WAY LA JOLLA, CA 92037 APN: 346-690-25-00


LANDSCAPE PLAN 0 5 10 20 F T. S C A L E: 1 " = 10'-0"

LANDSCAPE NOTES:


- 1. ALL LANDSCAPE AND IRRIGATION SHALL CONFORM TO THE STANDARDS OF THE CITY-WIDE LANDSCAPE REGULATIONS AND THE CITY OF SAN DIEGO LAND DEVELOPMENT MANUAL LANDSCAPE STANDARDS AND ALL OTHER LANDSCAPE RELATED CITY AND REGIONAL STANDARDS.
- IRRIGATION: AN AUTOMATIC, ELECTRICALLY CONTROLLED IRRIGATION SYSTEM SHALL BE PROVIDED AS REQUIRED FOR PROPER IRRIGATION, DEVELOPMENT, AND MAINTENANCE OF THE VEGETATION IN A HEALTHY, DISEASE-RESISTANT CONDITION. THE DESIGN OF THE SYSTEM SHALL PROVIDE ADEQUATE SUPPORT FOR THE VEGETATION SELECTED.
- ALL LANDSCAPE AREAS ARE TO BE IRRIGATED BY A COMPLETELY AUTOMATED IRRIGATION SYSTEM -UTILIZING AN AUTOMATIC CONTROLLER, REMOTE CONTROL VALVES, LOW PRECIPITATION HEADS AND UNDERGROUND PIPING. THE POTABLE SYSTEM WILL BE PROTECTED BY A REDUCED PRESSURE BACKFLOW PREVENTER.
- 4. THE SYSTEM WILL BE PROGRAMMED AND OPERATED TO MAXIMIZE THE EFFICIENCY OF THE SYSTEM AND LIMIT WATER CONSUMPTION. THE SYSTEM WILL BE DESIGNED TO ACHIEVE 100% COVERAGE.
- 5. PLANTING AREAS TO RECEIVE A 3" LAYER OF "ECO-MULCH" EARTHWISE PRODUCTS OR EQUAL. ALL REQUIRED PLANTING AREAS SHALL BE COVERED WITH MULCH TO A MIN. DEPTH OF 2 INCHES, EXCLUDING SLOPES REQUIRING REVEGETATION AND AREAS PLANTED WITH GROUNDCOVER. ALL EXPOSED SOIL AREAS WITHOUT VEGETATION SHALL ALSO BE MULCHED TO THIS MINIMUM DEPTH. [LCD 142.0413(b)]
- 6. ALL TREES WITHING 5' OF HARDSCAPE SHALL BE INSTALLED WITH ROOT BARRIERS PER CITY OF SAN DIEGO REQUIREMENTS.
- 7. ALL LANDSCAPING SHALL BE COMPLETED WITHIN 6 MONTHS OF OCCUPANCY OR WITHIN ONE YEAR OF THE NOTICE OF COMPLETION OF A RESIDENCE.
- 8. ALL GRADED, DISTURBED OR ERODED AREAS THAT WILL NOT BE PERMANENTLY PAVED OR COVERED BY STRUCTURES SHALL BE PERMANENTLY REVEGETATED AND IRRIGATED AS SHOWN IN TABLE 142-04F AND IN ACCORDANCE WITH THE STANDARDS IN THE LAND DEVELOPMENT MANUAL [142.0411(a)].
- MAINTENANCE: ALL REQUIRED LANDSCAPE AREAS SHALL BE MAINTAINED BY THE OWNER. LANDSCAPE & IRRIGATION AREAS IN THE PUBLIC ROW SHALL BE MAINTAINED BY THE OWNER. THE LANDSCAPE AREAS SHALL BE MAINTAINED FREE OF DEBRIS AND LITTER AND ALL PLANT MATERIAL SHALL BE MAINTAINED IN A HEALTHY GROWING CONDITION. DISEASED OR DEAD PLANT MATERIAL SHALL BE SATISFACTORILY TREATED OR REPLACED PER THE CONDITIONS OF THE PERMIT.




K E Y

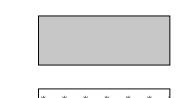

BUILDING FOOTPRINT = 7,803 SF. / 38.98%

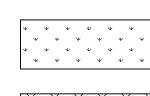

LANDSCAPED AREA = 8,371 SF. / 41.81%

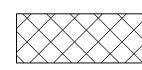

HARDSCAPED AREA = 3,846 SF. / 19.21%

LANDSCAPE DATA

30% = 6,006.00 SF.

LANDSCAPE PERCENTAGE REQUIRED:

LANDSCAPED AREA PROVIDED:

8,371 SF

LANDSCAPE PERCENTAGE PROVIDED:

41.81%


HARDSCAPED AREA PROVIDED: HARDSCAPED PERCENTAGE PROVIDED:

3,846 SF 19.21%

NOTE 1: A MINIMUM OF 30% LANDSCAPE AREA SHALL BE PROVIDED AS REQUIRED AND DEFINED BY THE LA JOLLA SHORES PLANNED DISTRICT. PER THE LJSPD, ALL OF THE PROPERTY NOT USED OR OCCUPIED BY STRUCTURES, UNPLANTED RECREATIONAL AREAS, WALKS AND DRIVEWAYS SHALL BE LANDSCAPED AND IN NO CASE SHALL THIS AREA BE LESS THAN 30% OF THE TOTAL PARCEL AREA.

NOTE 2: ALL OF THE LANDSCAPE MEETING THE 30% AREA REQUIREMENTS SHALL BE INSTALLED AS REQUIRED BY THE LA JOLLA SHORES PLANNED DISTRICT ORDINANCE AND ALL REQUIRED LANDSCAPE INSPECTIONS MUST BE OBTAINED PRIOR TO ISSUANCE OF ANY CERTIFICATE OF OCCUPANCY.

PREPARED BY	KEY PLAN	NTS	VICINITY MAP
HAYER ARCHITECTURE Contact: William S. Hayer 445 Marine View Avenue, Suite 280 Del Mar, CA 92014 (858) 792-2800 bhayer@hayerarchitecture.com PROJECT CONSULTANTS Civil Engineer: EARTH WIND WATER CIVIL ENGINEERING 11440 West Bernardo Court, Suite 300		NORTH	Torney Pines Rd
Rancho Bernardo, CA 92127 (858) 753-1947)	NOMM	
	PROJECT DATA		PROJECT ADDRESS
Geotechnical Engineer: GEOTECHNICAL EXPLORATION, INC	Construction: V	B Sprinklered	8441 Whale Watch Way La Jolla, CA 92037
7420 Trade Street San Diego, CA 92121	Occupancy: R	-3 S.F.R.	
(858) 549-7222	Code: 20	016 Edition-C.R.C.	PROJECT OWNER Poppio & Marci Morgan
Surveyor: WOODLAND SURVEYING, INC.	Zoning: L	JSPD-SF	Ronnie & Marci Morgan
2180 Garnet Ave., Suite 3G San Diego, CA 92108	No. of Stories: 2	Stories	ASSESSOR'S PARCEL NO.:
(858) 273-4700	Site Area: 20	0,020 sf.	346-690-25-00
Landscape Architect: GREG HEBERT LANDSCAPE ARCHITECT	Gross Floor Area: 1	1,652 sf.	LEGAL DESCRIPTION:
3153 Third Avenue San Diego, CA 92103	F.A.R.: 58	8.2%	LOT 25 OF LA JOLLA COSTA DORAL MAP NO. 6865
(619) 283-5083	Geo Hazzard Area: 20	6 & 53	BENCHMARK:
COMMUNITY PLAN	Landscape Area: 7	,590 sf.	Brass plug in top of curb at
La Jolla Community Plan and Local Coastal Program Land Use Plan: - Very Low Density Residential OVERLAY ZONES Coastal Overlay Zone		Be Demolished S.F.R.	Northwest corner of Prestwick Drive & Prestwick Court Record from: City of San Diego Vertical Control 350.289' Datum: MSL, NGVD 1929 PROJECT NO:
 Coastal Height Limit Overlay Zone 		3 Non-Historic	635054
Steep HillsidesCampus Parking Impact Overlay Zone		/. Developed	PROJECT NAME:
Geological Hazard Categories	— Frev	7. Developed	MORGAN RESIDENC
APPROVALS:			SHEET TITLE:
	_		LANDSCAPE PLAN
PERMITS REQUIRED:	ORIGINAL DATE:	REVISIONS:	SHEET NUMBER:
Coastal Development Permit Site Development Permit	05-23-2019	02-05-2020 06-29-2020 10-06-2020	8

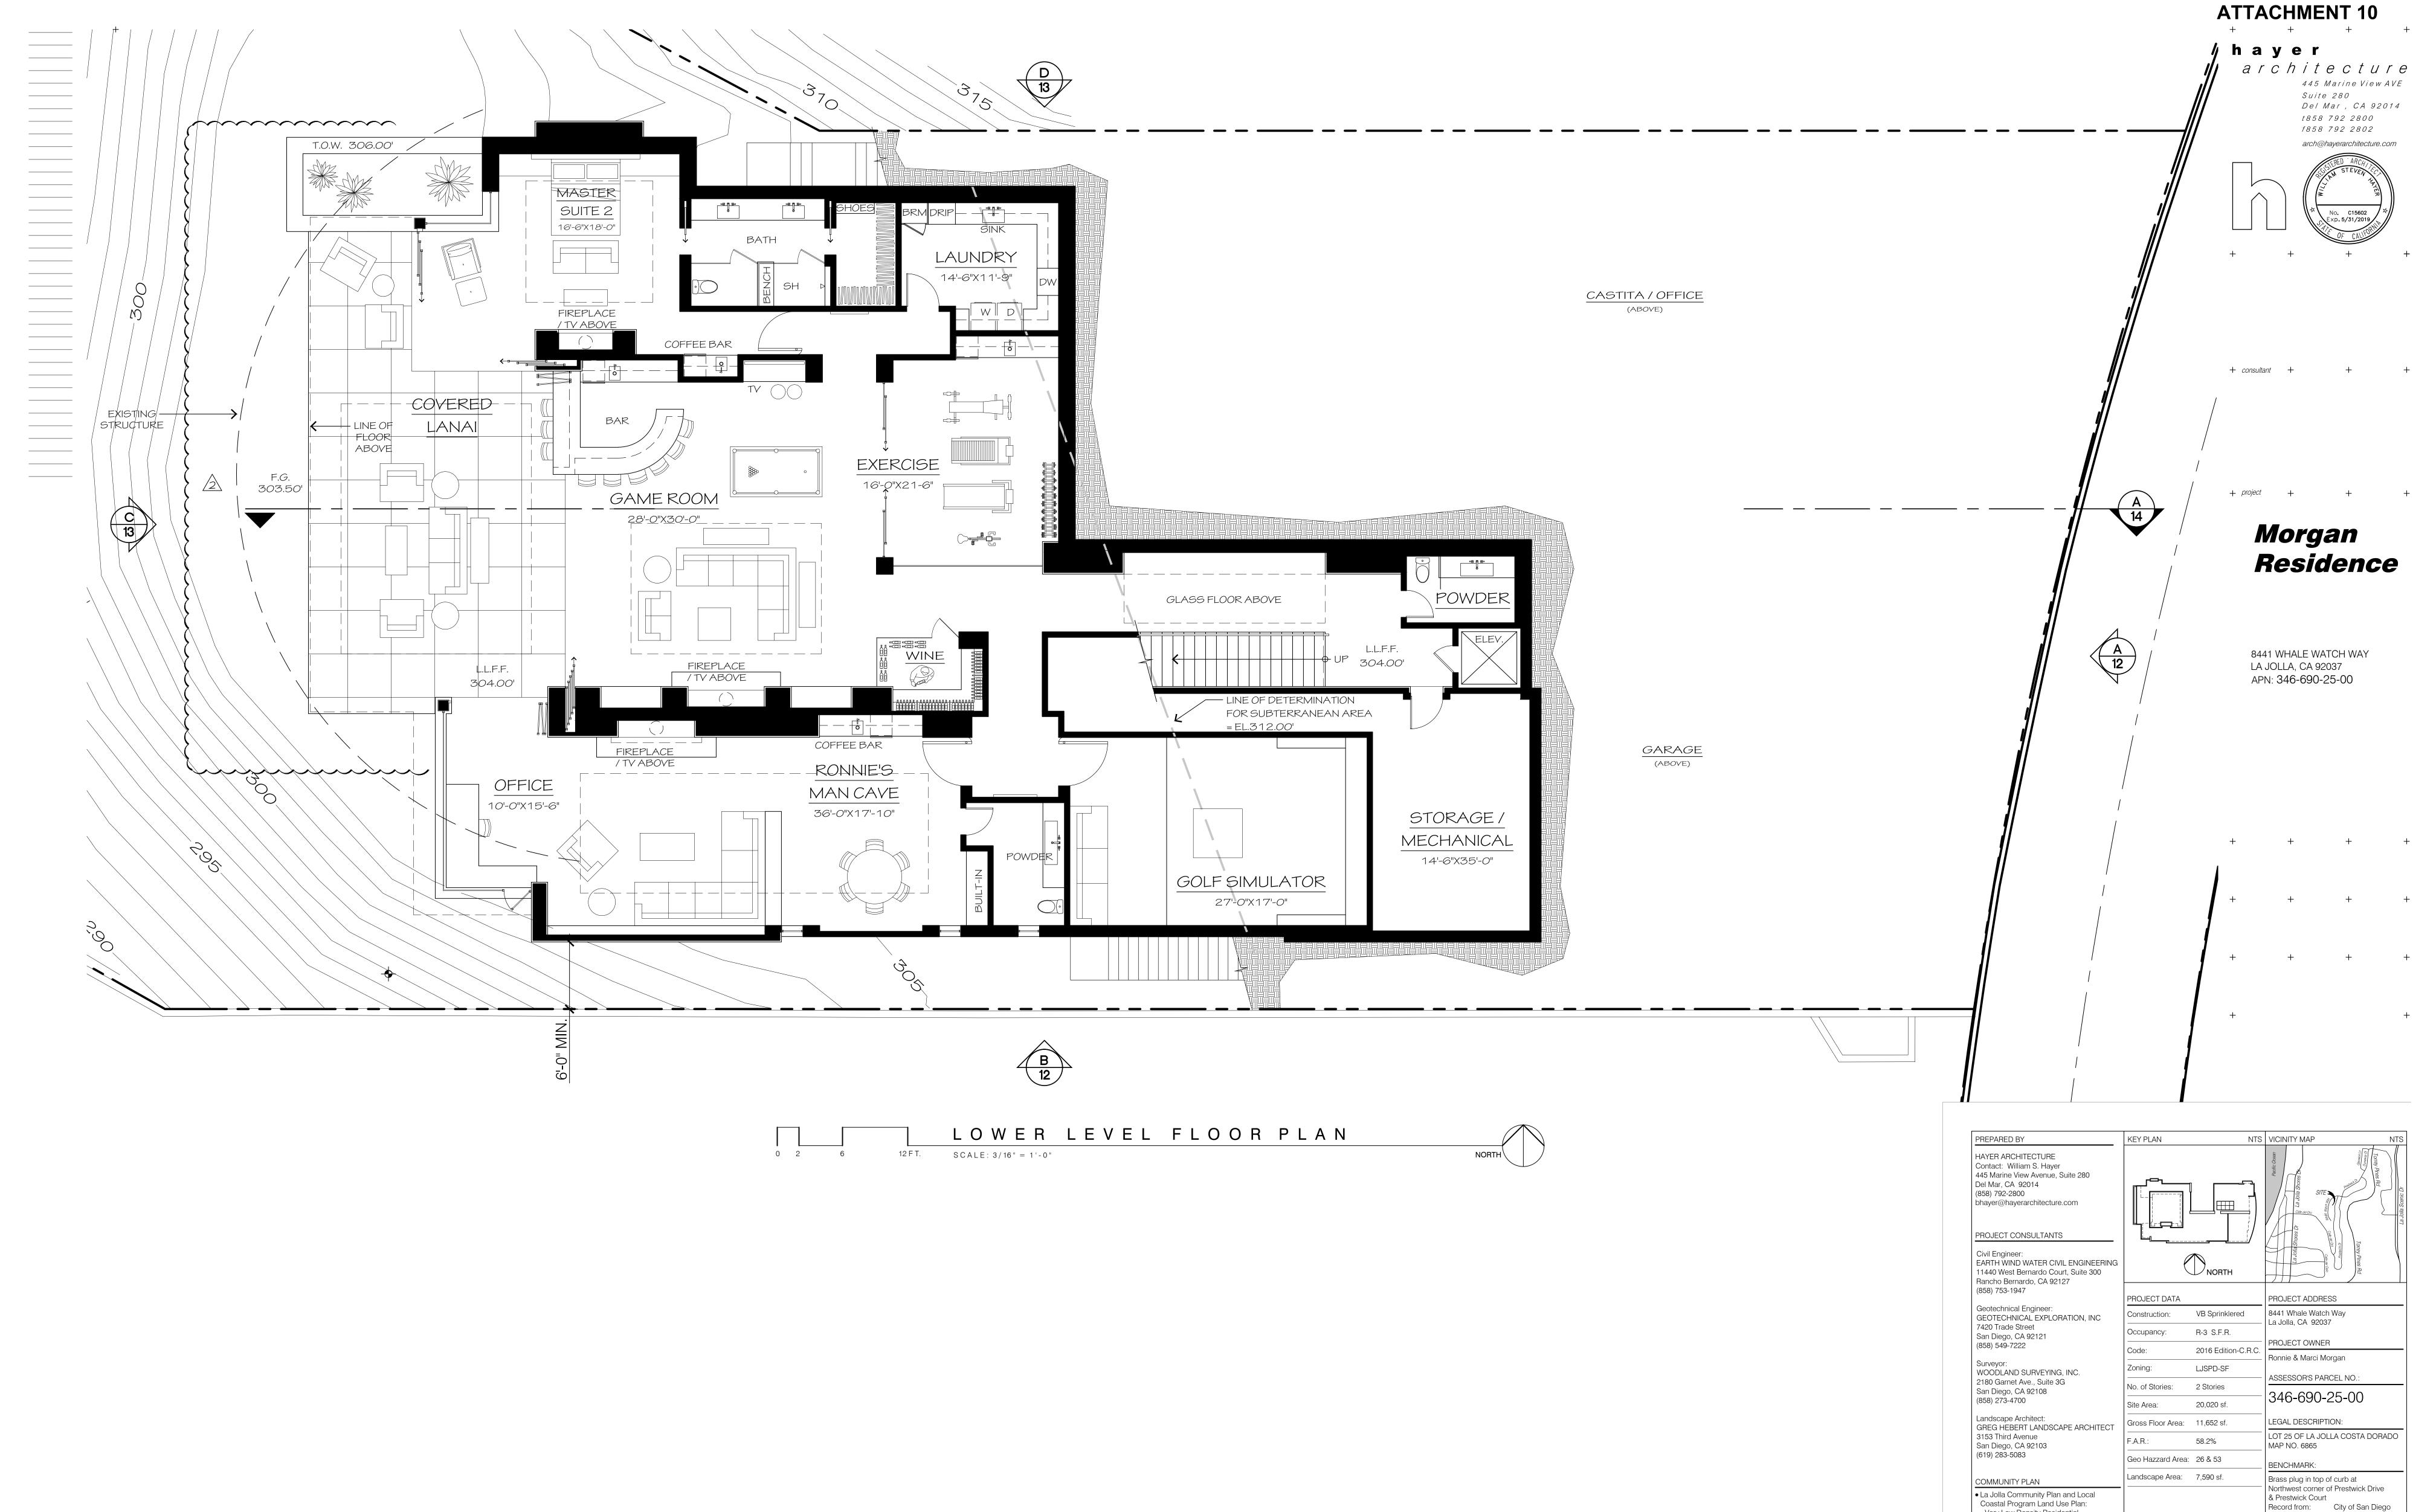

- Very Low Density Residential

Coastal Height Limit Overlay Zone

Geological Hazard Categories

Campus Parking Impact Overlay Zone

OVERLAY ZONES

Steep Hillsides

APPROVALS:

PERMITS REQUIRED:

Coastal Development Permit Site Development Permit

Coastal Overlay Zone

EXISTING BUILDING

ORIGINAL DATE:

05-23-2019

Occupancy: R-3 S.F.R.

constructed: 1983 Non-Historic

Soil Condition: Prev. Developed

To Be Demolished

02-05-2020 06-29-2020

10-06-2020

Vertical Control

MSL, NGVD 1929

OF **16**

350.289

MORGAN RESIDENCE

SHEET TITLE:

FLOOR PLAN LOWER LEVEL

Elevation:


PROJECT NO:

635054

REVISIONS: SHEET NUMBER:

PROJECT NAME:

Datum:

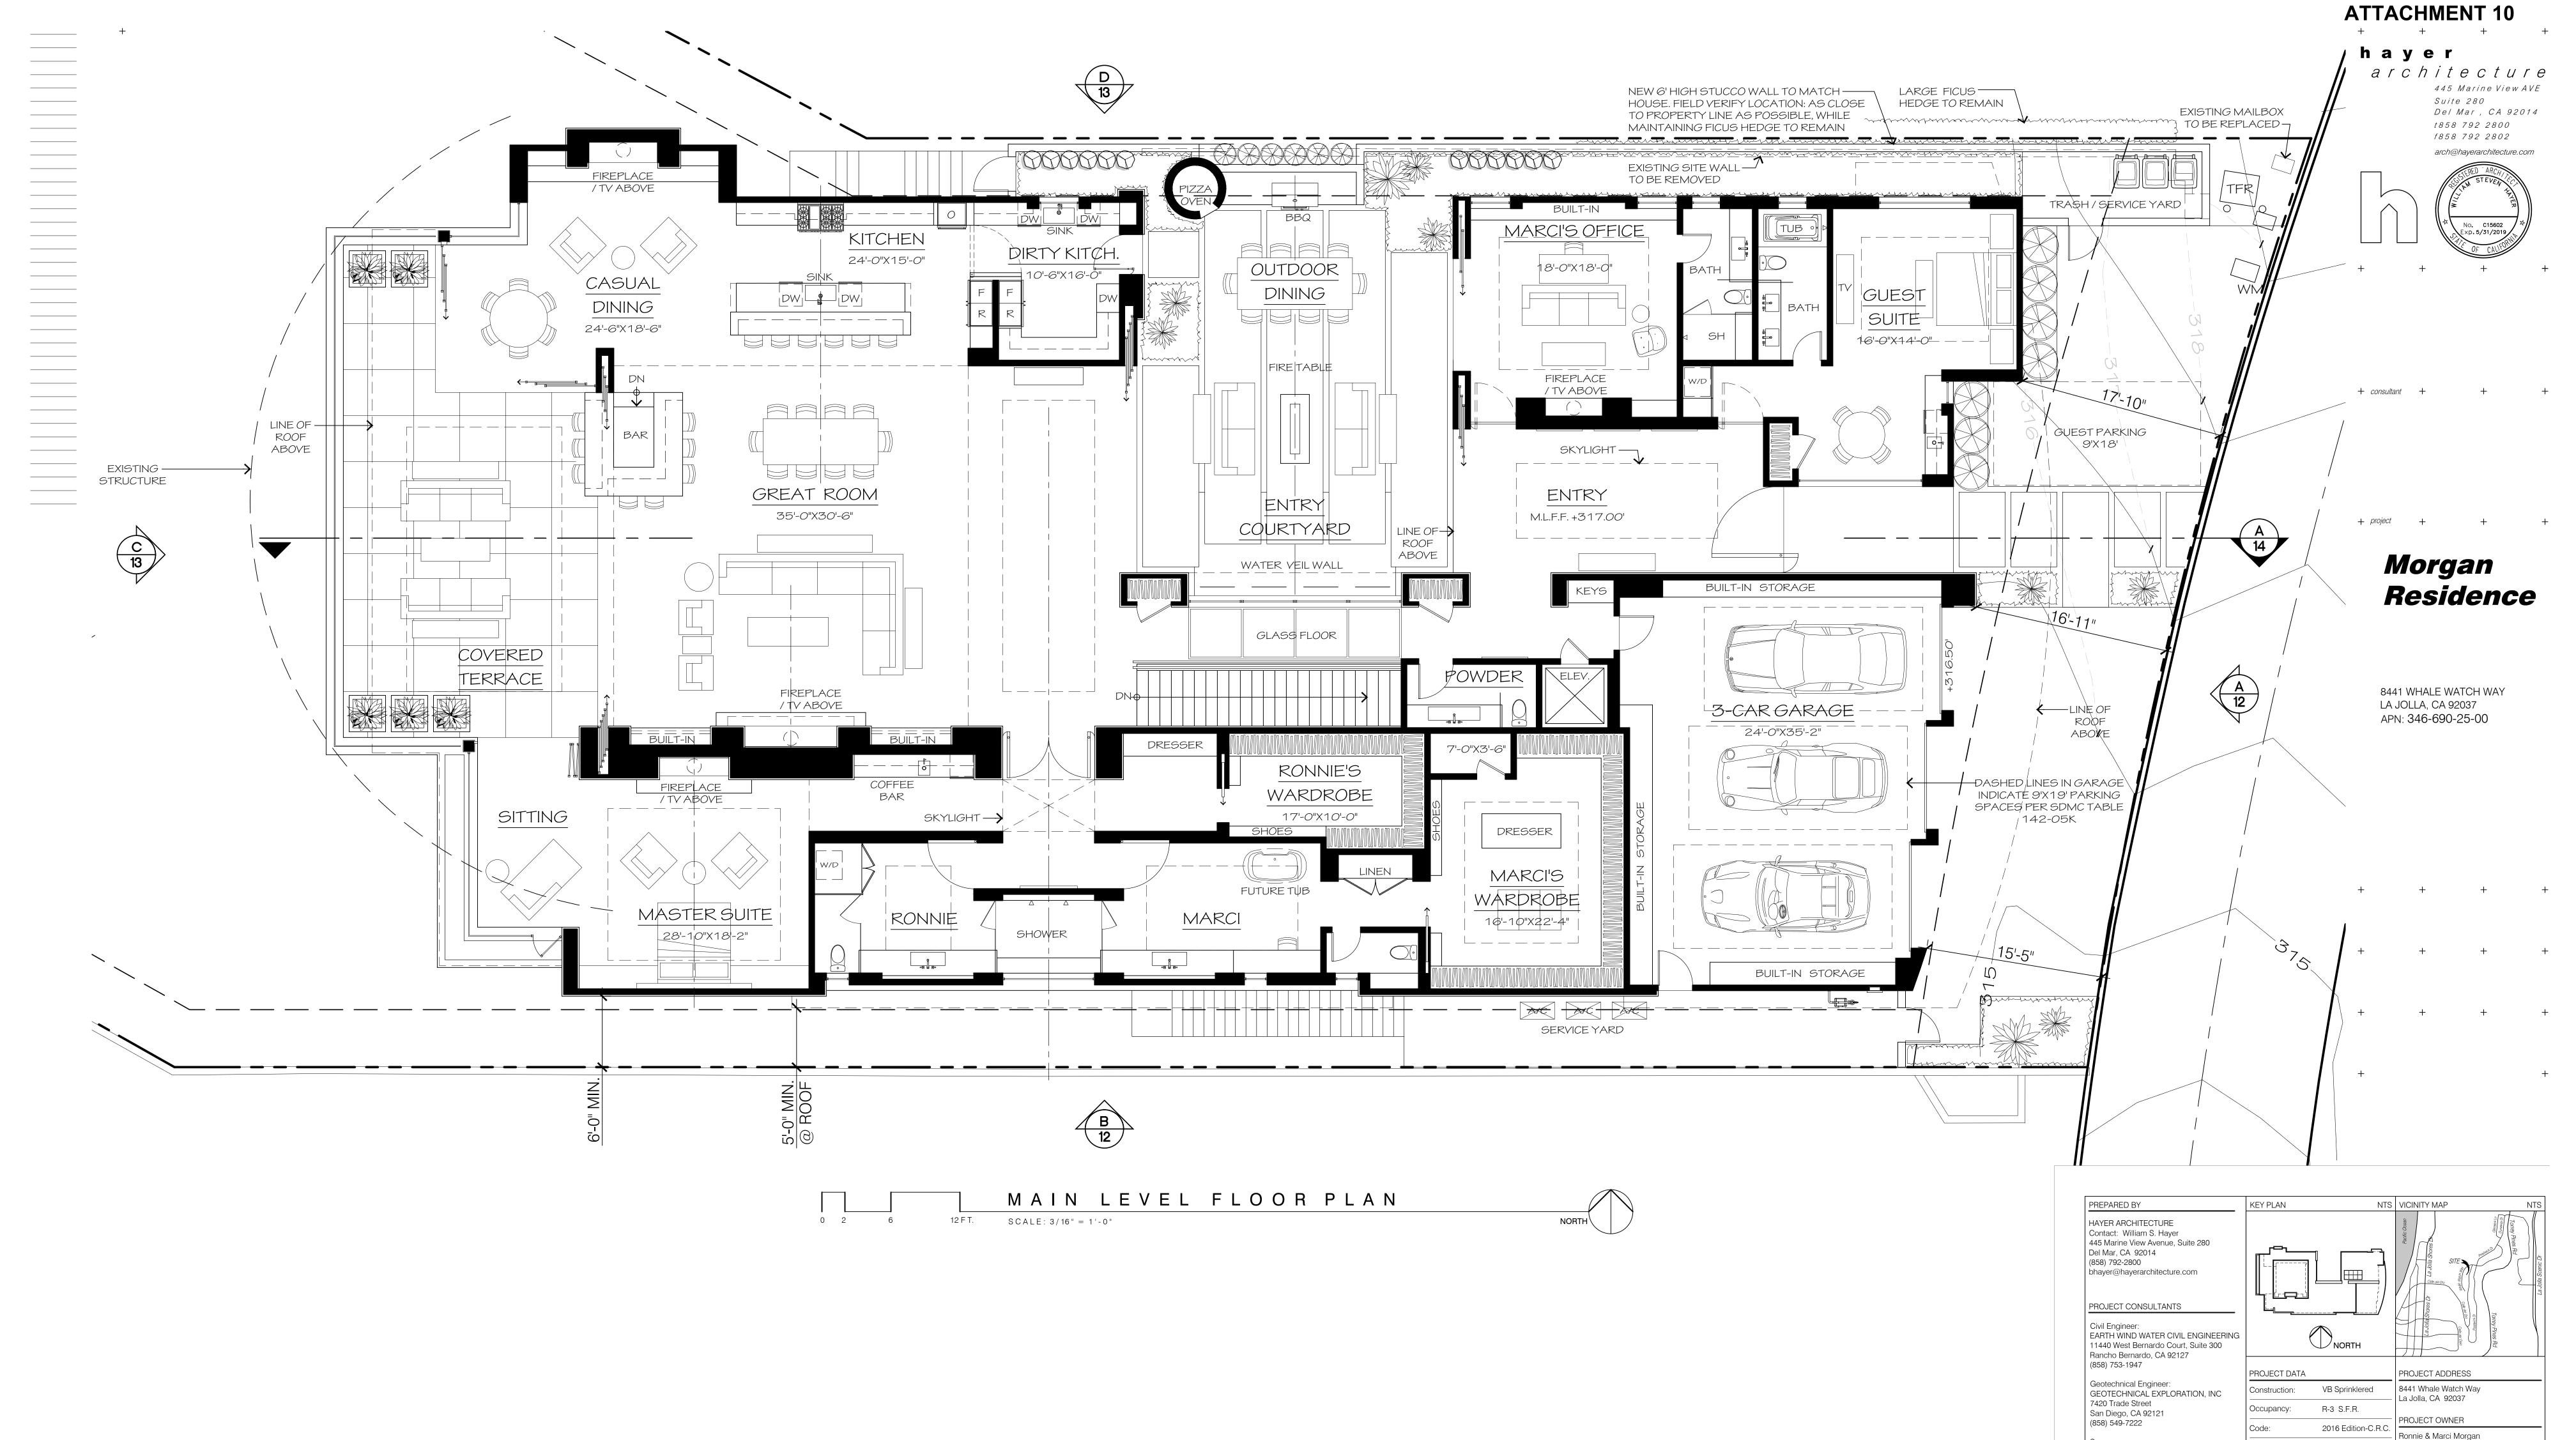

LJSPD-SF

20,020 sf.

To Be Demolished

02-05-2020

06-29-2020

10-06-2020

No. of Stories: 2 Stories

Gross Floor Area: 11,652 sf.

Geo Hazzard Area: 26 & 53

Landscape Area: 7,590 sf.

Occupancy: R-3 S.F.R.

constructed: 1983 Non-Historic

Soil Condition: Prev. Developed

EXISTING BUILDING

ORIGINAL DATE:

05-23-2019

Site Area:

ASSESSOR'S PARCEL NO.:

346-690-25-00

Brass plug in top of curb at

Northwest corner of Prestwick Drive

Record from: City of San Diego

Vertical Control

MSL, NGVD 1929

of **16**

350.289

MORGAN RESIDENCE

SHEET TITLE:

FLOOR PLAN MAIN LEVEL

LOT 25 OF LA JOLLA COSTA DORADO

LEGAL DESCRIPTION:

MAP NO. 6865

BENCHMARK:

& Prestwick Court

Elevation:

PROJECT NO:

635054

PROJECT NAME:

10

Datum:

REVISIONS: | SHEET NUMBER:

WOODLAND SURVEYING, INC.

GREG HEBERT LANDSCAPE ARCHITECT

La Jolla Community Plan and Local

Coastal Program Land Use Plan:

Coastal Height Limit Overlay Zone

Geological Hazard Categories

Campus Parking Impact Overlay Zone

- Very Low Density Residential

2180 Garnet Ave., Suite 3G

San Diego, CA 92108

(858) 273-4700

3153 Third Avenue San Diego, CA 92103

COMMUNITY PLAN

OVERLAY ZONES

Steep Hillsides

APPROVALS:


PERMITS REQUIRED:

Coastal Development Permit


Site Development Permit

Coastal Overlay Zone

(619) 283-5083

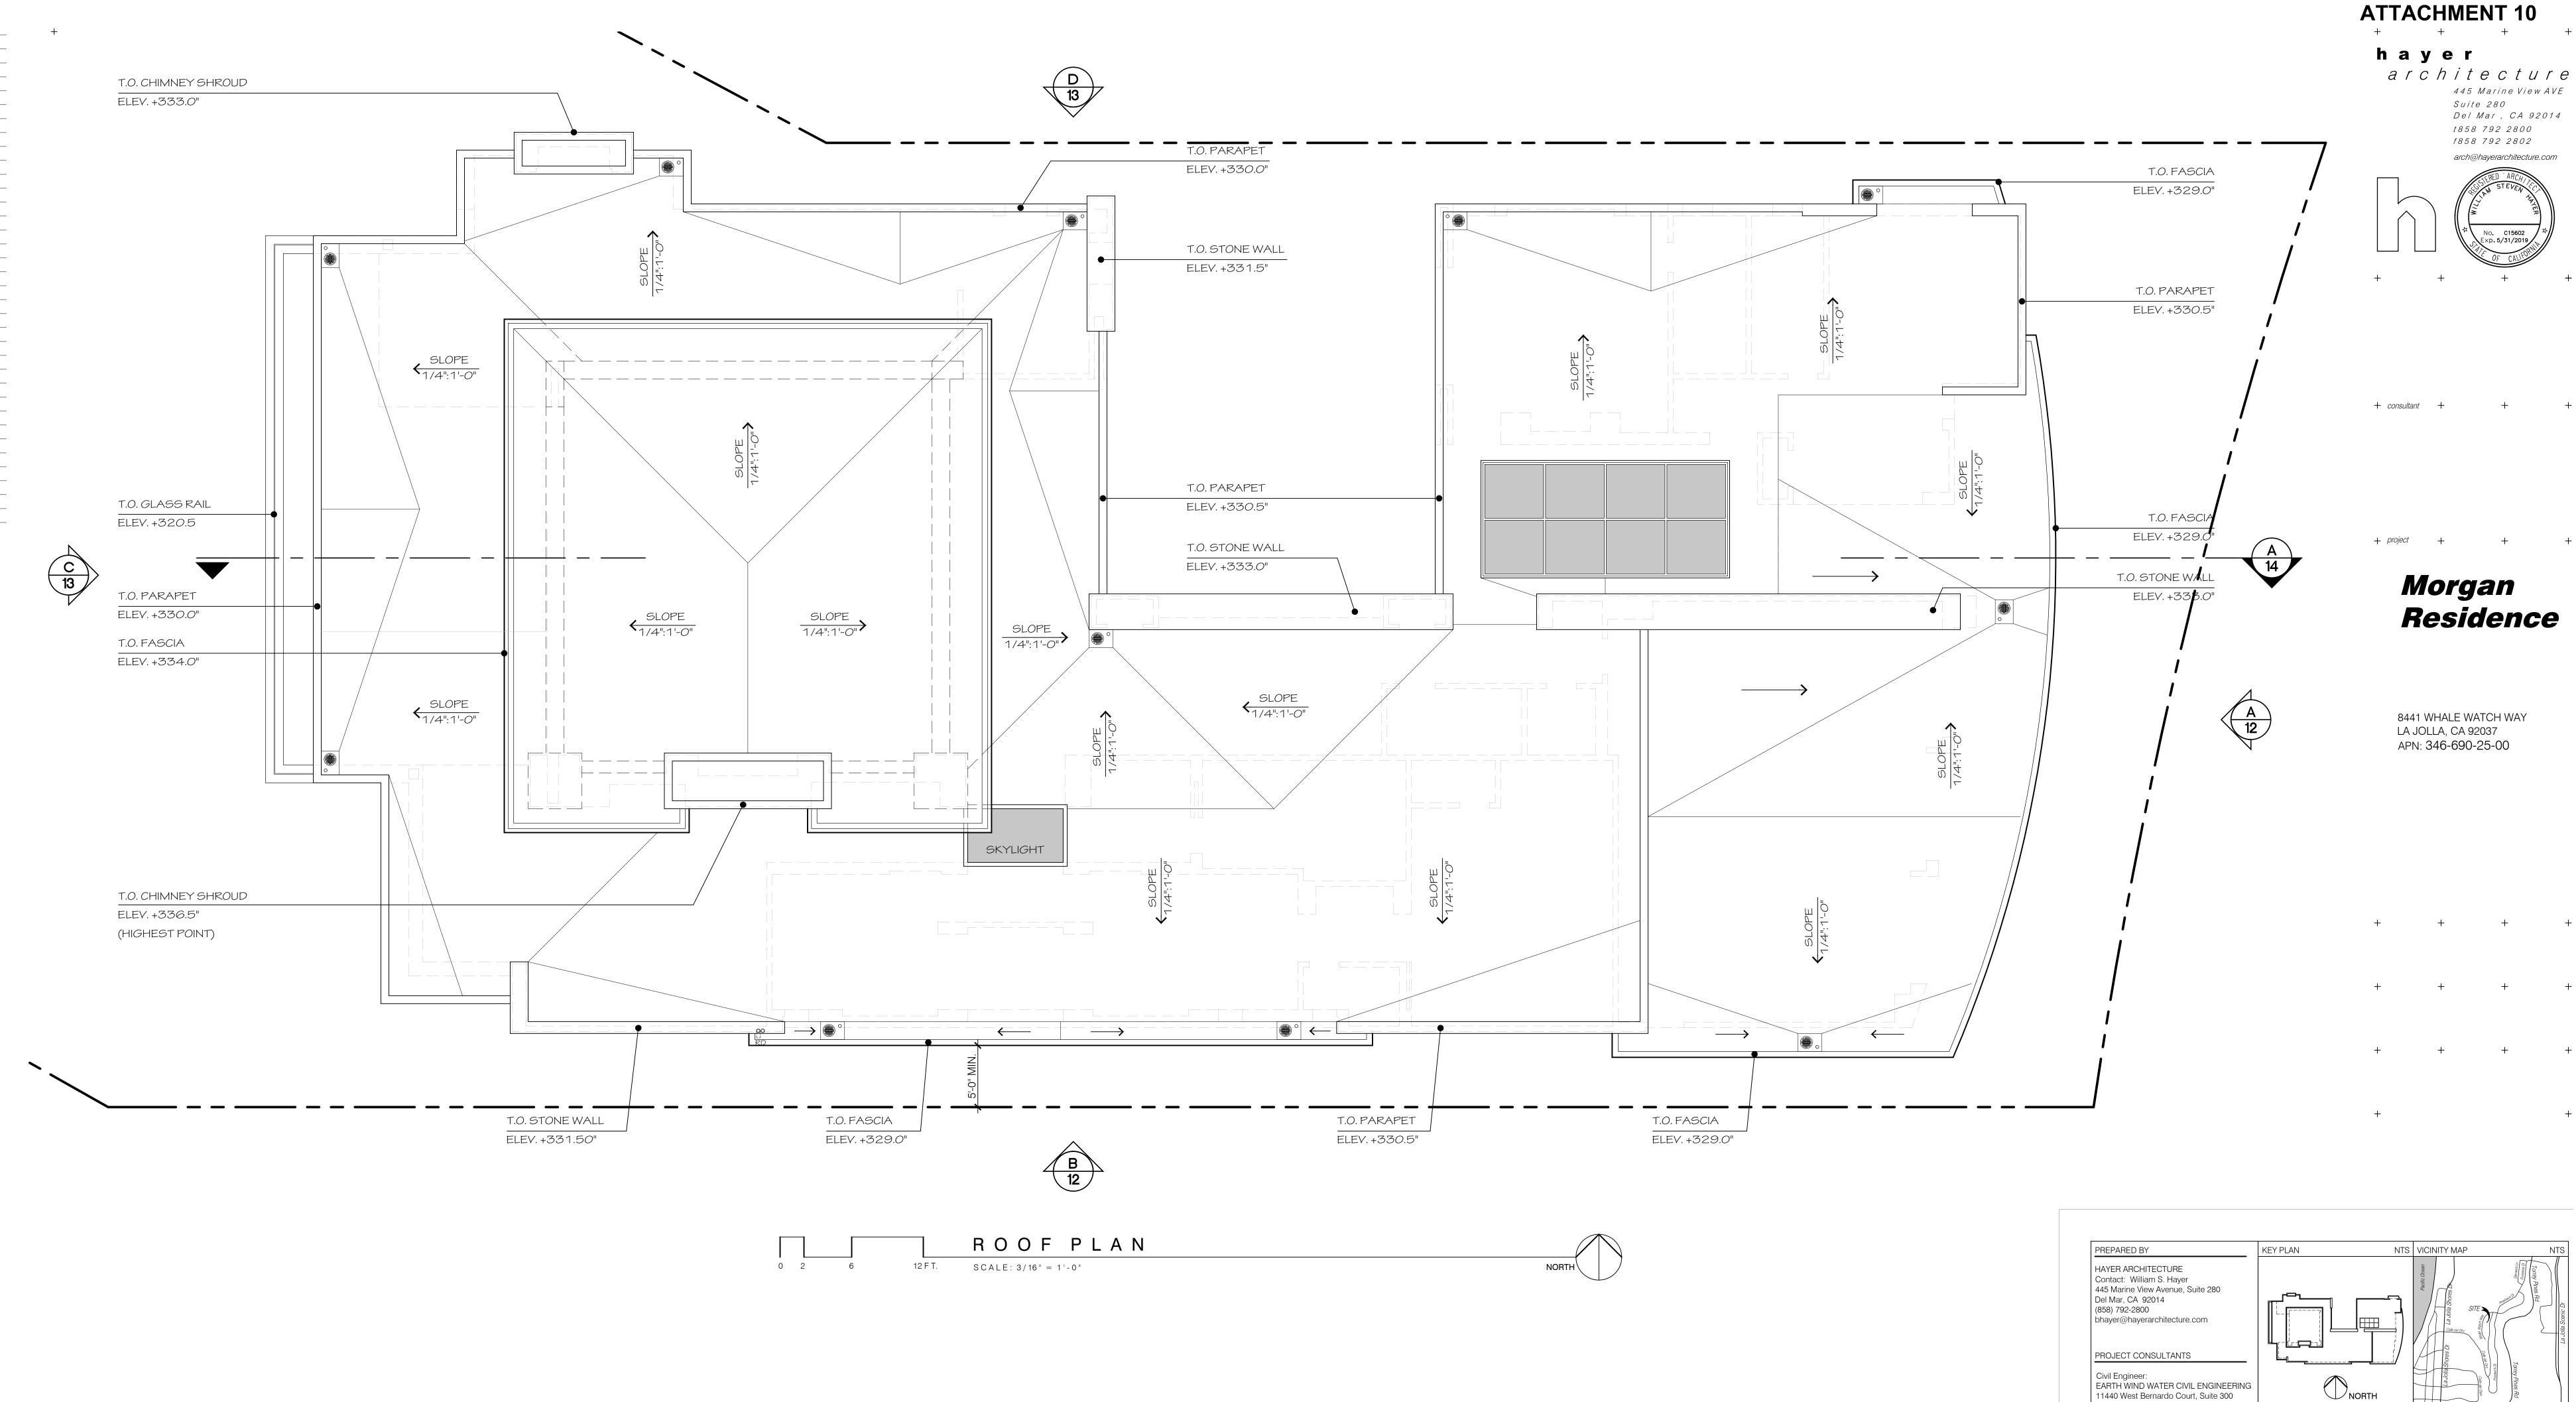

Civil Engineer:
EARTH WIND WATER CIVIL ENGINEERING
11440 West Bernardo Court, Suite 300 Rancho Bernardo, CA 92127 (858) 753-1947 PROJECT DATA PROJECT ADDRESS Geotechnical Engineer: GEOTECHNICAL EXPLORATION, INC VB Sprinklered 8441 Whale Watch Way onstruction: La Jolla, CA 92037 7420 Trade Street Occupancy: San Diego, CA 92121 PROJECT OWNER (858) 549-7222 2016 Edition-C.R.C. Ronnie & Marci Morgan Surveyor: WOODLAND SURVEYING, INC. 2180 Garnet Ave., Suite 3G LJSPD-SF ASSESSOR'S PARCEL NO.: No. of Stories: 2 Stories San Diego, CA 92108 346-690-25-00 (858) 273-4700 20,020 sf. LEGAL DESCRIPTION: Gross Floor Area: 11,652 sf. GREG HEBERT LANDSCAPE ARCHITECT 3153 Third Avenue San Diego, CA 92103 LOT 25 OF LA JOLLA COSTA DORADO MAP NO. 6865 (619) 283-5083 Geo Hazzard Area: 26 & 53 BENCHMARK: Landscape Area: 7,590 sf. Brass plug in top of curb at COMMUNITY PLAN Northwest corner of Prestwick Drive • La Jolla Community Plan and Local & Prestwick Court Coastal Program Land Use Plan: Record from: City of San Diego Vertical Control - Very Low Density Residential EXISTING BUILDING Elevation: 350.289 To Be Demolished MSL, NGVD 1929 Datum: OVERLAY ZONES PROJECT NO: Occupancy: R-3 S.F.R. Coastal Overlay Zone Coastal Height Limit Overlay Zone 635054 constructed: 1983 Non-Historic Steep Hillsides PROJECT NAME: Campus Parking Impact Overlay Zone Soil Condition: Prev. Developed Geological Hazard Categories MORGAN RESIDENCE SHEET TITLE: APPROVALS: **ROOF PLAN** PERMITS REQUIRED: ORIGINAL DATE: REVISIONS: SHEET NUMBER: 02-05-2020 06-29-2020 10-06-2020 05-23-2019 Coastal Development Permit Site Development Permit OF **16**

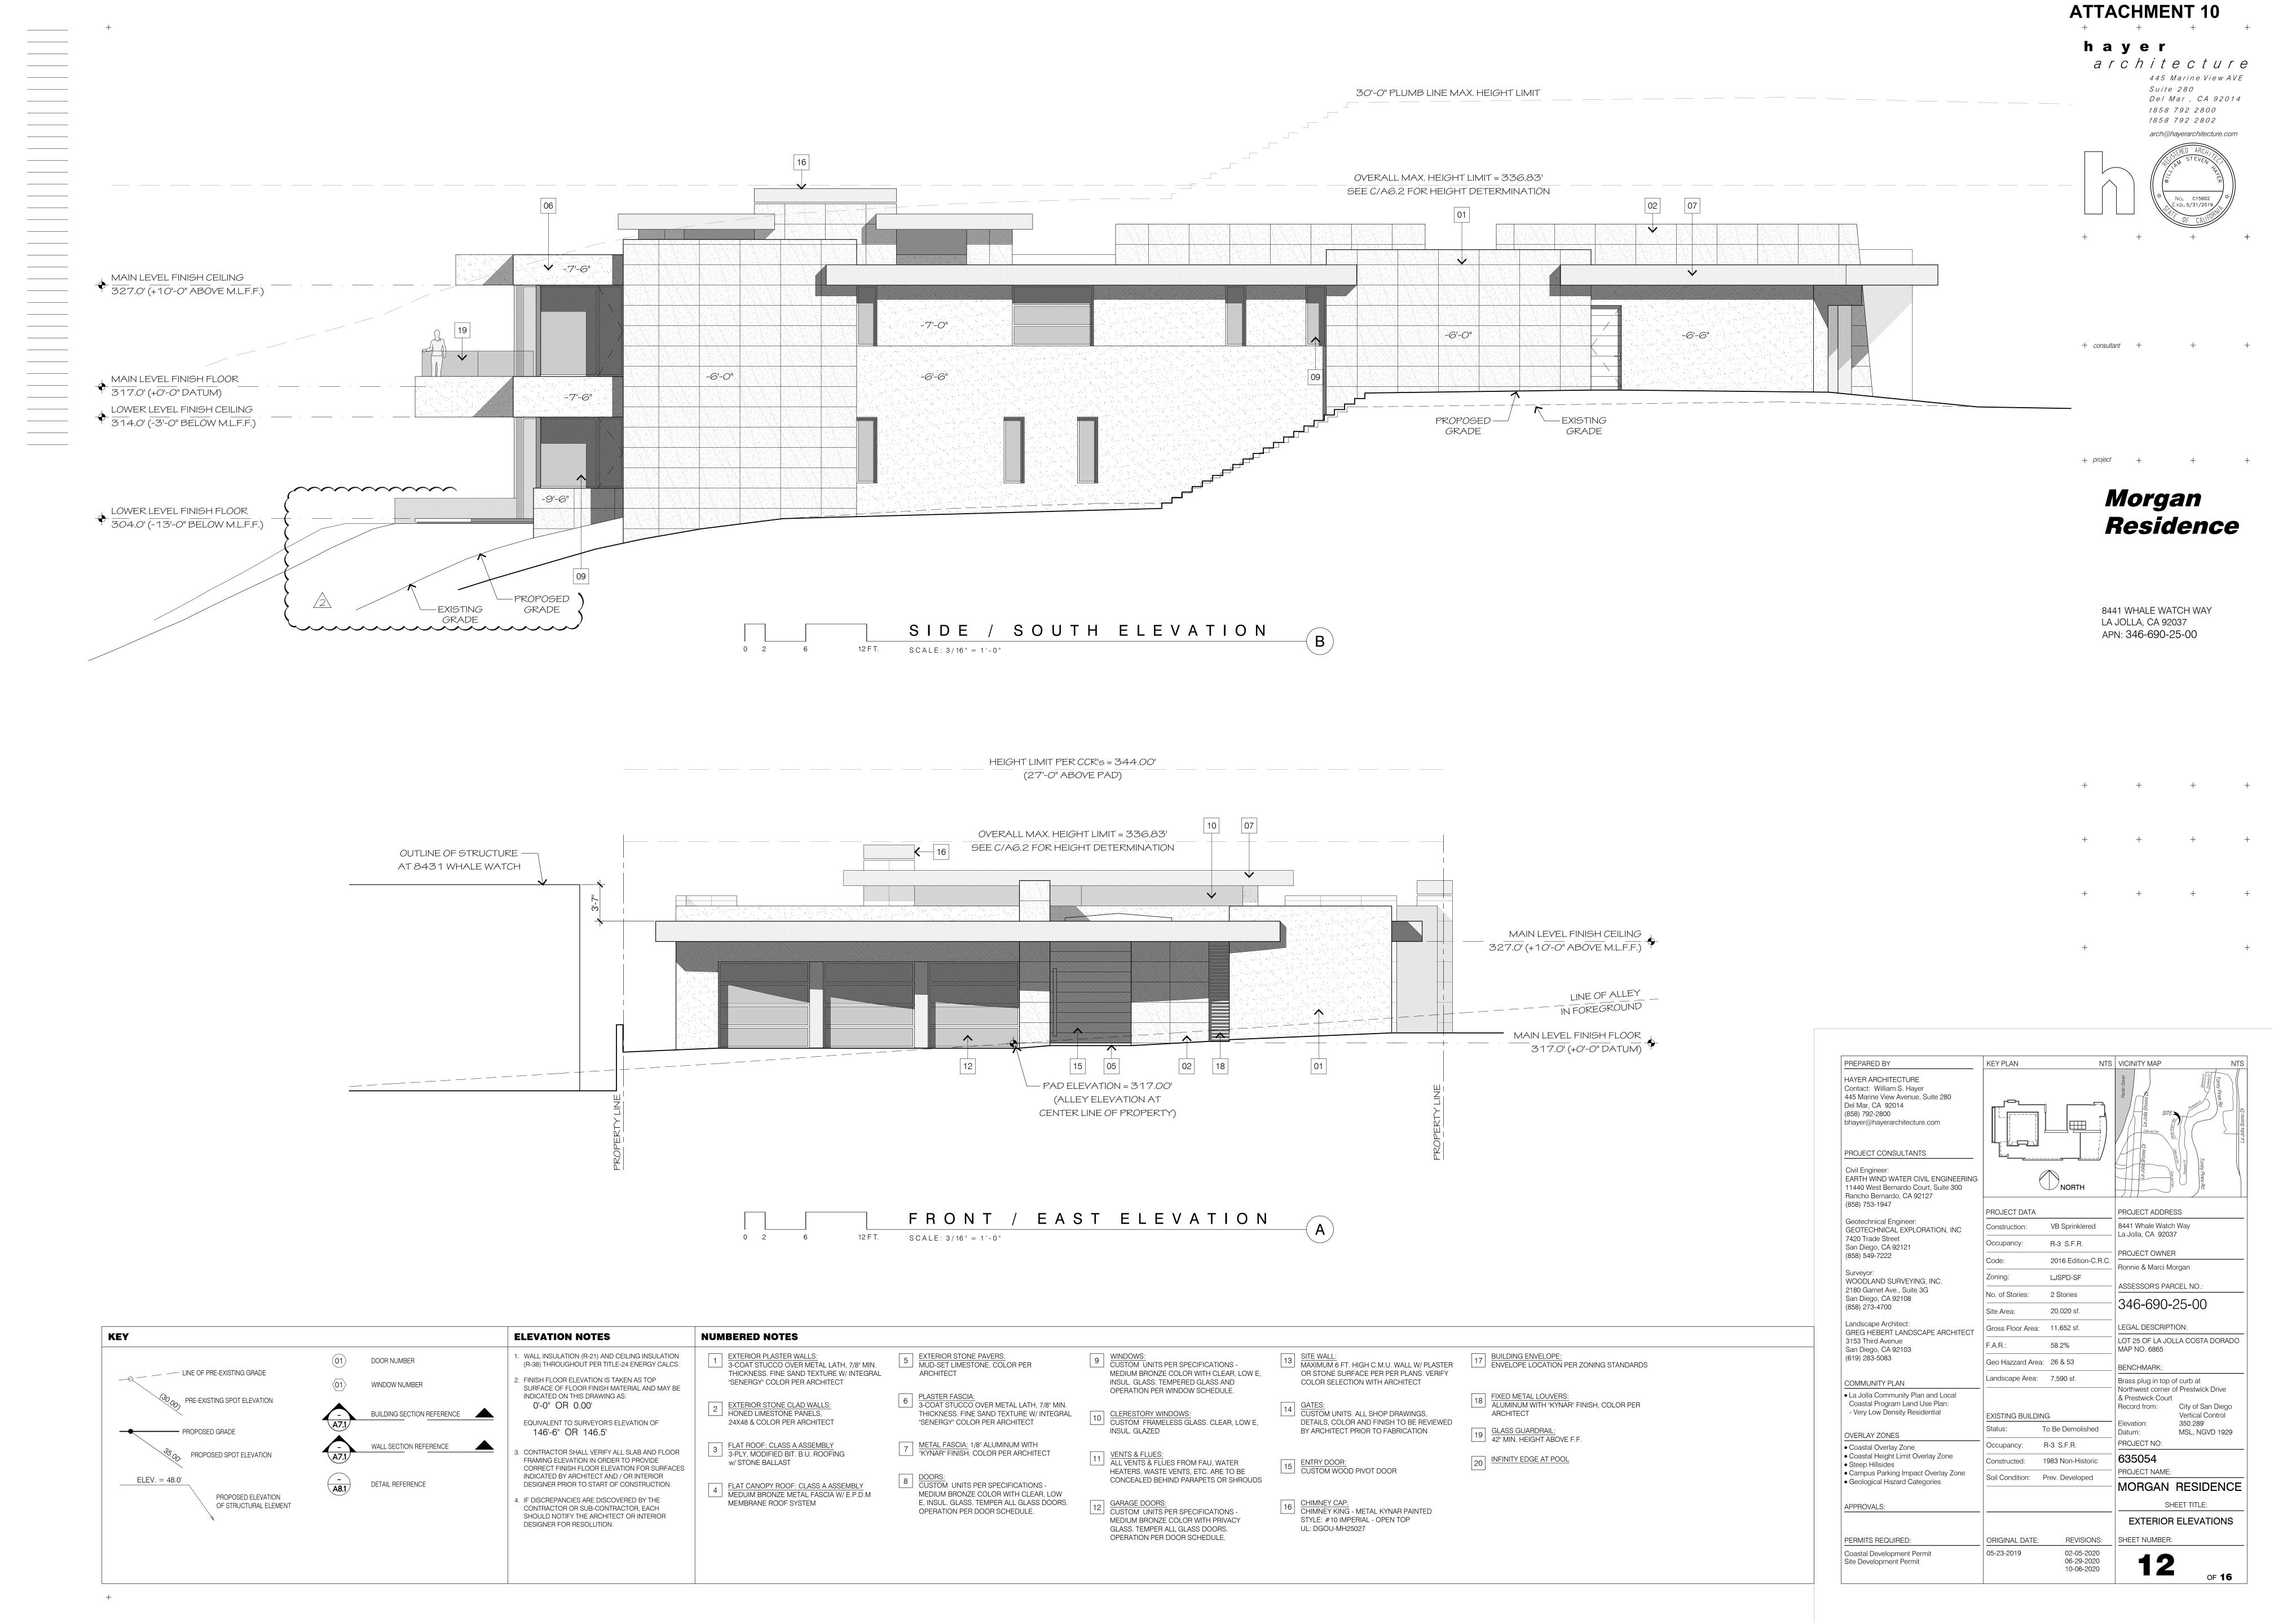

02-05-2020

06-29-2020

10-06-2020

OF **16**

05-23-2019


Coastal Development Permit

Site Development Permit

hayer


+ consultant +


architecture 445 Marine View AVE Suite 280 Del Mar, CA 92014 t858 792 2800 f858 792 2802

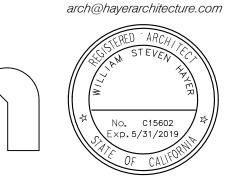

30'-0" PLUMB LINE MAX. HEIGHT LIMIT

Morgan Residence OVERALL MAX. HEIGHT LIMIT = 336.83' SEE C/A6.2 FOR HEIGHT DETERMINATION 8441 WHALE WATCH WAY LA JOLLA, CA 92037 MAINLEVEL FINISH CEILING 327.0' (+10'-0" ABOVE M.L.F.F.) APN: 346-690-25-00 COVERED ENTRY COURTYARD GREAT ROOM TERRACE MAIN LEVEL FINISH FLOOR 317.0' (+0'-0" DATUM) LOWER LEVEL FINISH CEILING 314.0' (-3'-0" BELOW M.L.F.F.) EXISTING — GRADE COVERED - PROPOSED GAMEROOM <u>LANAI</u> EXERCISE GRADE ---EXISTING GRADE ~ LOWER LEVEL FINISH FLOOR 304.0' (-13'-0" BELOW M.L.F.F.) 2 SECTION 12 F T. SCALE: 3/16" = 1'-0"

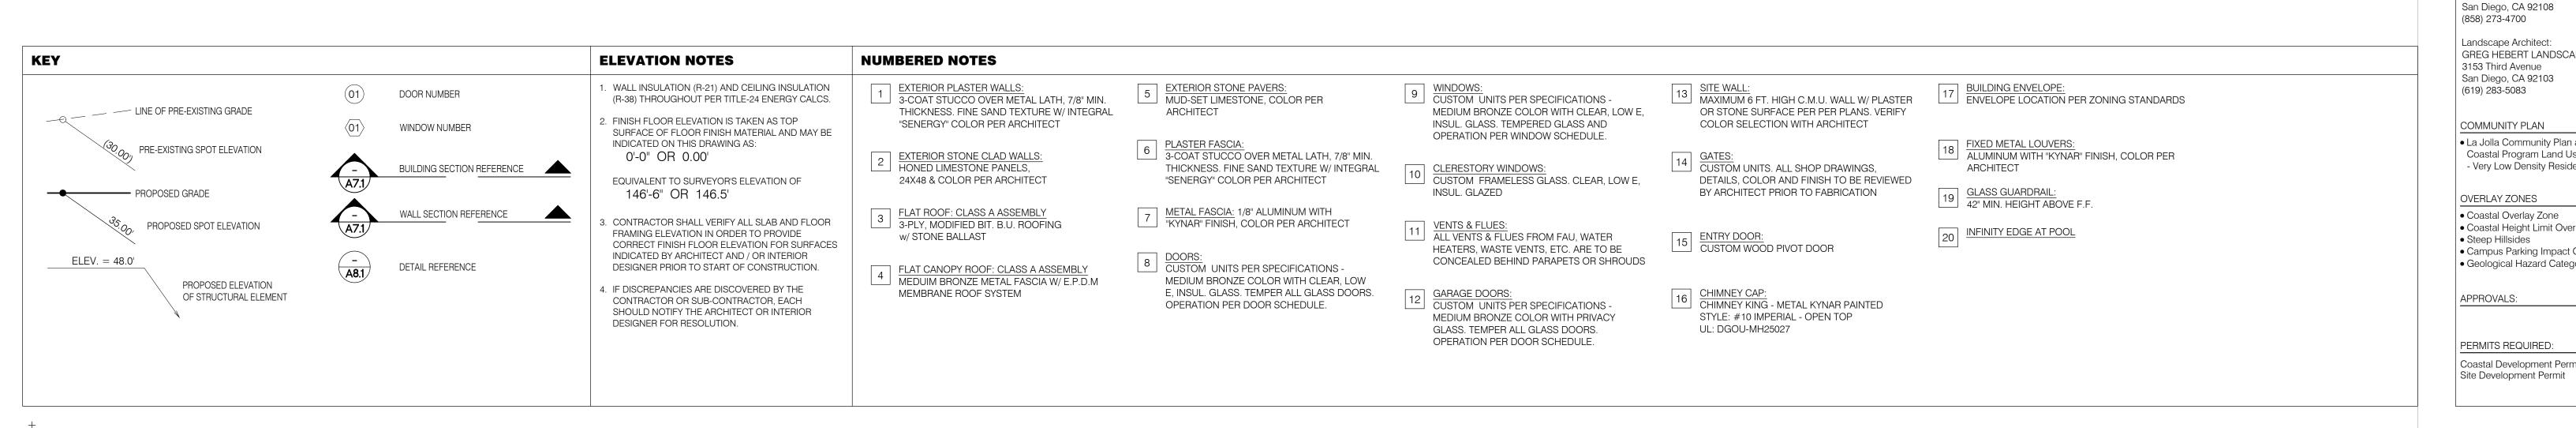

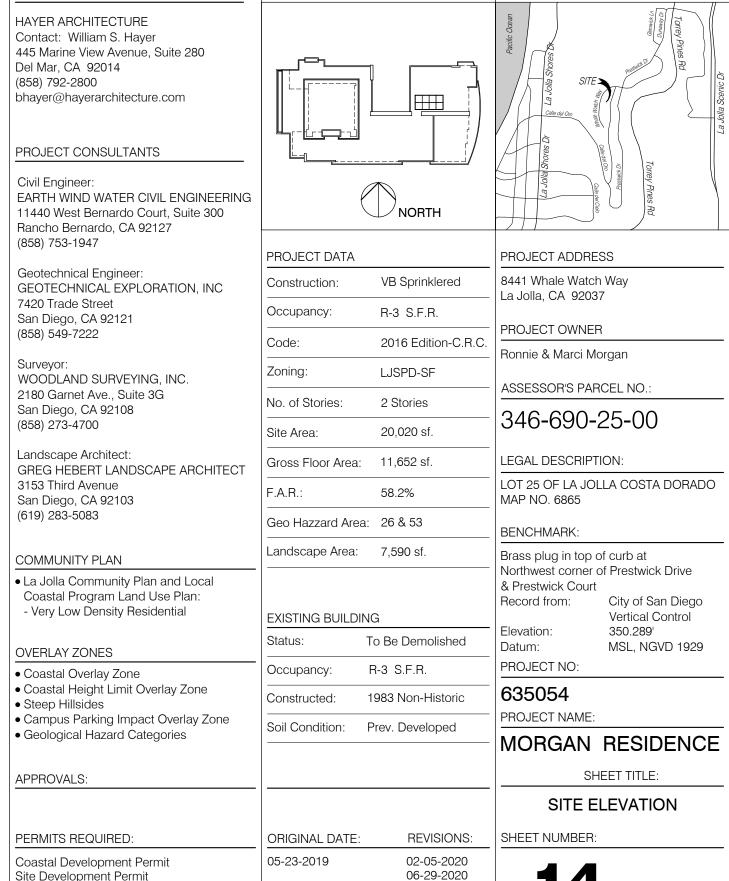

10-06-2020

OF **16**

KEY PLAN

NTS VICINITY MAP


PREPARED BY


ATTACHMENT 10


hayer

+ consultant +

architecture 445 Marine View AVE Suite 280 Del Mar , CA 92014 t858 792 2800 f858 792 2802

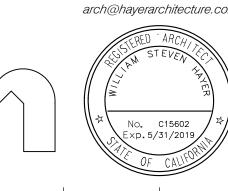

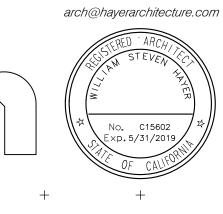


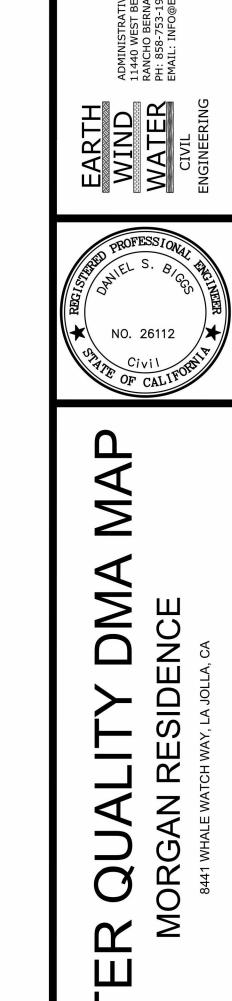

8441 WHALE WATCH WAY LA JOLLA, CA 92037 APN: 346-690-25-00

Morgan

Residence

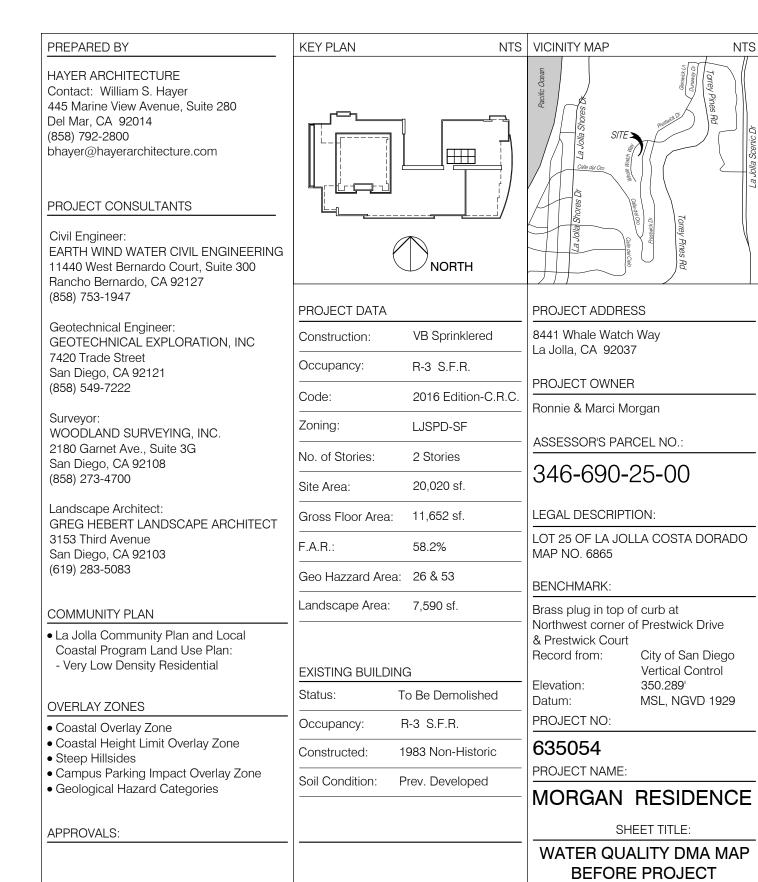

ORIGINAL DATE:

05-23-2019

Coastal Development Permit

Site Development Permit


REVISIONS:

06-29-2020

10-06-2020

15

OF **16**

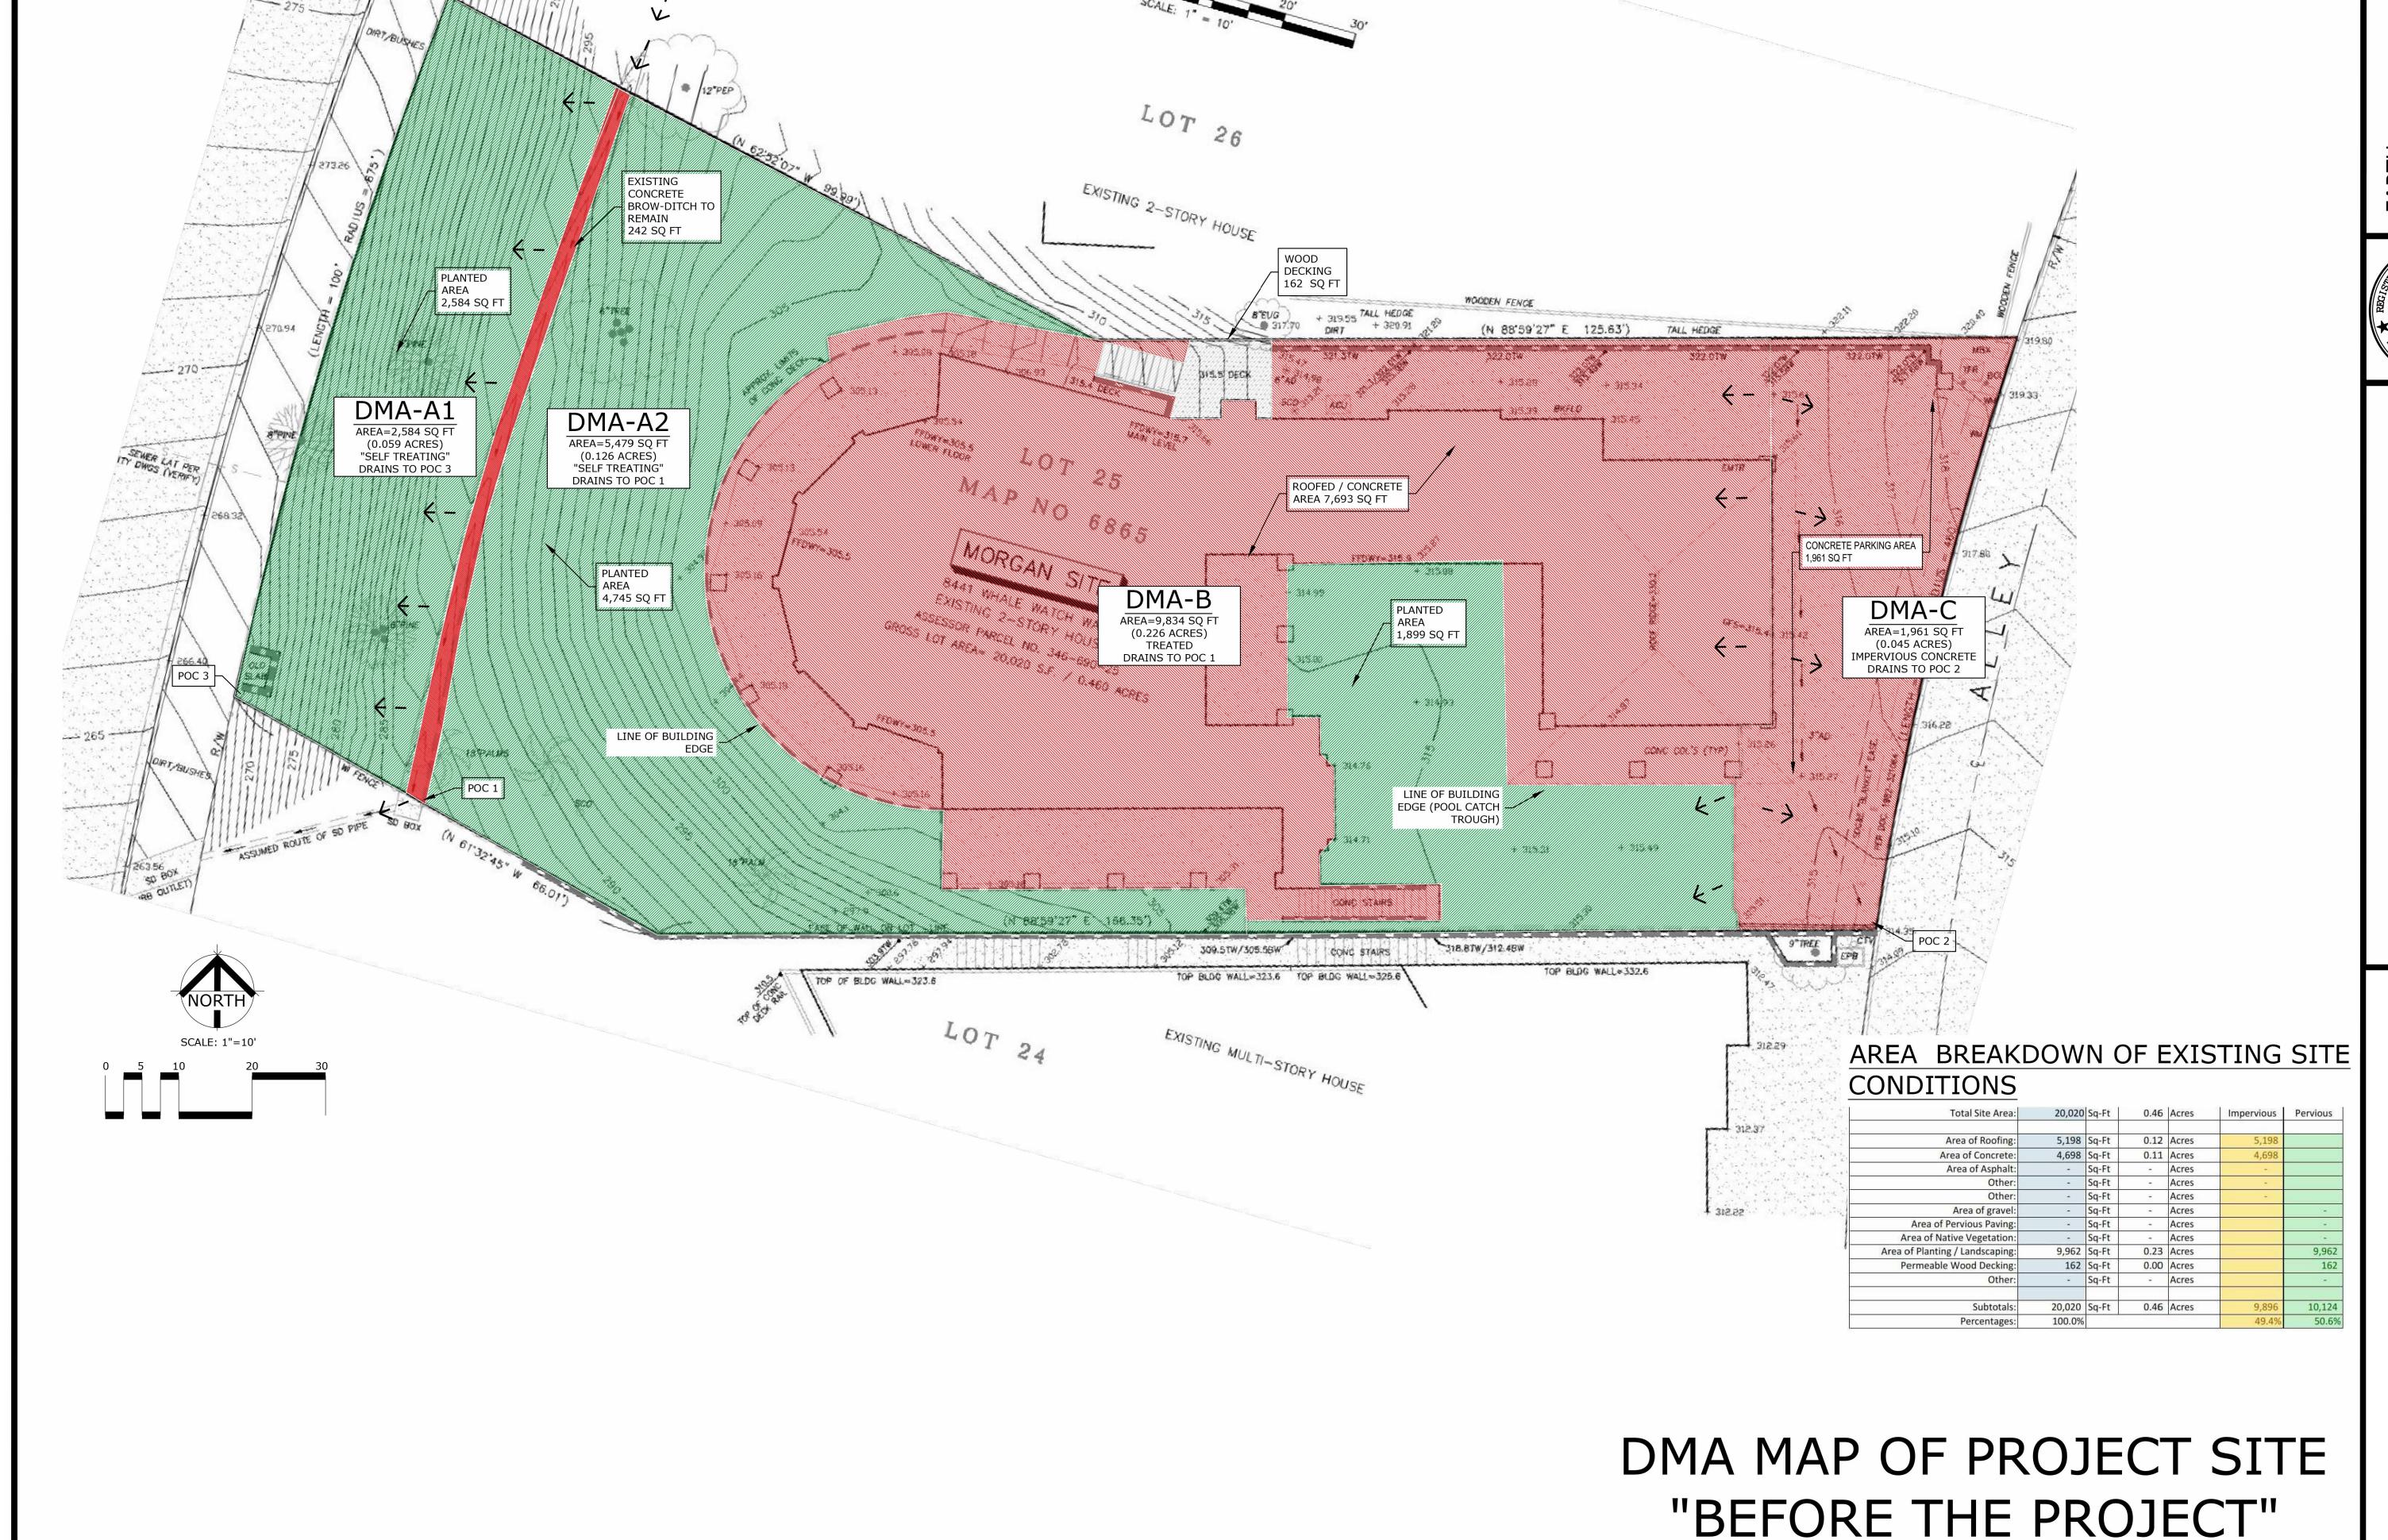


ATTACHMENT 10


hayer

+ consultant +

+ project +

architecture 445 Marine View AVE Suite 280 Del Mar , CA 92014 t858 792 2800 f858 792 2802

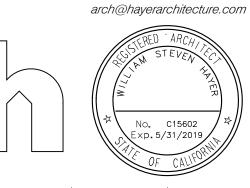

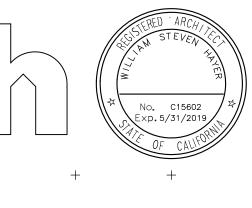





8441 WHALE WATCH WAY LA JOLLA, CA 92037 APN: 346-690-25-00

0.30

0.30

165 0.10 0.010

Runoff Factor Ave Calc: 0.290

1,636

98.4%

PREPARED BY	KEY PLAN	NTS
HAYER ARCHITECTURE Contact: William S. Hayer 445 Marine View Avenue, Suite 280 Del Mar, CA 92014 (858) 792-2800 bhayer@hayerarchitecture.com		
PROJECT CONSULTANTS		
Civil Engineer: EARTH WIND WATER CIVIL ENGINEERING 11440 West Bernardo Court, Suite 300 Rancho Bernardo, CA 92127	(NORTH
(858) 753-1947	PROJECT DATA	
Geotechnical Engineer: GEOTECHNICAL EXPLORATION, INC	Construction:	VB Sprinklered
7420 Trade Street San Diego, CA 92121	Occupancy:	R-3 S.F.R.
(858) 549-7222	Code:	2016 Edition-C.R.C.
Surveyor: WOODLAND SURVEYING, INC.	Zoning:	LJSPD-SF
2180 Garnet Ave., Suite 3G San Diego, CA 92108	No. of Stories:	2 Stories
(858) 273-4700	Site Area:	20,020 sf.
Landscape Architect: GREG HEBERT LANDSCAPE ARCHITECT	Gross Floor Area:	11,652 sf.
3153 Third Avenue San Diego, CA 92103	F.A.R.:	58.2%
(619) 283-5083	Geo Hazzard Area	: 26 & 53
	Landscape Area:	7,590 sf.

APPROVALS:

PERMITS REQUIRED:

Coastal Development Permit Site Development Permit

11440 West Bernardo Court, Suite 300 Rancho Bernardo, CA 92127		NORTH	y Cipio						
(858) 753-1947	PROJECT DATA		PROJECT ADDRESS						
Geotechnical Engineer: GEOTECHNICAL EXPLORATION, INC	Construction:	VB Sprinklered	8441 Whale Wate La Jolla, CA 920						
7420 Trade Street San Diego, CA 92121	Occupancy:	R-3 S.F.R.							
(858) 549-7222	Code:	2016 Edition-C.R.C.	PROJECT OWNE						
Surveyor: WOODLAND SURVEYING, INC.	Zoning:	LJSPD-SF		Ü					
2180 Garnet Ave., Suite 3G San Diego, CA 92108	No. of Stories:	2 Stories	ASSESSOR'S PA						
(858) 273-4700	Site Area:	20,020 sf.	346-690-	-25-00					
Landscape Architect: GREG HEBERT LANDSCAPE ARCHITECT	Gross Floor Area:	11,652 sf.	LEGAL DESCRIPTION:						
3153 Third Avenue San Diego, CA 92103	F.A.R.:	58.2%	LOT 25 OF LA JOLLA COSTA DORA MAP NO. 6865						
(619) 283-5083	Geo Hazzard Area	a: 26 & 53	BENCHMARK:						
COMMUNITY PLAN	Landscape Area:	7,590 sf.	Brass plug in top of curb at Northwest corner of Prestwick Drive						
La Jolla Community Plan and Local Coastal Program Land Use Plan: Very Low Density Residential			& Prestwick Cour Record from:	t City of San Diego					
vory Low Boriotty Hoolderthal	EXISTING BUILDII		 Elevation:	Vertical Control 350.289'					
OVERLAY ZONES	Status:	To Be Demolished	Datum:	MSL, NGVD 1929					
Coastal Overlay Zone	Occupancy:	R-3 S.F.R.	PROJECT NO:						
Coastal Height Limit Overlay Zone Steep Hillsides Coastal Parking Innoct Overlay Zone	Constructed:	1983 Non-Historic	635054 PROJECT NAME						
Campus Parking Impact Overlay Zone Geological Hazard Categories	Soil Condition:	Prev. Developed	-	RESIDENCE					

Residential	EXISTING BUILDING						
	Status:	To Be Demolished	Ele Dat				
one	Occupancy:	R-3 S.F.R.	PRO				
nit Overlay Zone	Constructed:	1983 Non-Historic	63				
mpact Overlay Zone I Categories	Soil Condition:	Prev. Developed	M PRO				
			l				

ORIGINAL DATE:

05-23-2019

MORGAN RESIDENCE SHEET TITLE: WATER QUALITY DMA MAP

> REVISIONS: SHEET NUMBER: 02-05-2020 06-29-2020 10-06-2020 **16** OF **16**

	(LENGTH = 100)	NO GRADING OR DISTURBANCE IN THE	SITE IS AREA	File			IMIT OF BUILDING ENVELOPE	COURTYARD AR PERVIOUS SURFACE CONCRETE SEPA GRAVEL OPE COLLECTED BENEAT A PERFORATED PV CONVEYED TO TREAT	ARATED BY 4" SIDE ENINGS. WATER IS THE THIS AREA WITH I/C DRAIN PIPE AND	S'EUG 31770 DIRT	ANTED AREA 2 SQ FT	(N 88°59'27" E PERVIOUS SURFACE AREA 1,373 SQ FT		CASSITA	31	ANTED ARE SQ FT	PERVIOUS PAVERS 168 SQ FT				
SP COM	NORT SCALE: 1":		LINE OF BUILDING E IPOOL CATCH TROP			TOP OF B	DECV NAH32-30 3.6	LIMIT OF BUILT ENVELOPE	CLEAR DEBRIS	FF = 317.0 FF = 304.0	NCRETE AREA	318.80W3TR 2EVBW		PE 20	PLANTE 54 SQ F	A F A P C C C IS	DRAINAGE NOTE: ARROW SHOW DIRECTION OF FLOW. SURFACE IS PERVIOU ACTUAL FLOW IS CAPTURED PAVERS IN A PERFORATED PI CONVEYED TO THE SOUTHEA CORNER OF THE PROPERTY S DISCHARGED.	S AND BENEATH PE AND ST			
					\$ V		LOT	24	EXISTING	MULLTHS EORR HOUG	DESE			312.29	30.13	$\langle \cdot \rangle$	"NO PARKING" SIG	GN			
	Version: Calcula		ff Factor using Method ES FOR POLLUTANT To entification: DMA A	d of Appendix B REATMENT				Version: Calculation	ORGAN RESIDENCE, 8 03/17/19 on of Weighted Runof ANALYSIS OF SURFACE DMA Ide	f Factor using Metho	od of Appendix B.1	1.1		Version	: 03/17/19 lation of Weighte ANALYSIS OF	ed Runof	8441 Whale Watch W off Factor using Methor ES FOR POLLUTANT To	d of Appendix E	.1.1		
	Total Site Area:	5,940 Sq-Ft	0.14 Acres	Impervious	Pervious Fac	ctor Part Ca	С	Total Site Area:	12,418 Sq-Ft	0.29 Acres	Impervious	Pervious Factor	Part Calc	Total Site Area			0.04 Acres	Impervious	Pervious	Factor Part Calc	С
	Area of Roofing:	- Sq-Ft	- Acres	9		0.90 -		Area of Roofing:	9,422 Sq-Ft	0.22 Acres	9,422	0.90		Area of Roofing	: :	Sq-Ft	- Acres	-		0.90 -	
	Area of Concrete:	400 Sq-Ft	0.01 Acres	400		0.90 0.00	51	Area of Concrete:	200 Sq-Ft	0.00 Acres	200	0.90	(4)	Area of Concrete	26	Sq-Ft	0.00 Acres	26		0.90 0.014	4
	Area of Asphalt:	- Sq-Ft	- Acres	*		0.90 -		Area of Asphalt:	- Sq-Ft	- Acres	-	0.90		Area of Asphalt		Sq-Ft	- Acres	+		0.90 -	
	Other:	- Sq-Ft - Sq-Ft	- Acres			0.90 - 0.90 -	 	Other:	- Sq-Ft - Sq-Ft	- Acres	-	0.90	8	Other Other		Sq-Ft Sq-Ft	- Acres	·		0.90 -	4
	Area of gravel:	- Sq-Ft	- Acres		-	0.30 -		Area of gravel:	- Sq-Ft	- Acres		- 0.30	+	Area of gravel		Sq-Ft	- Acres		=	0.30 -	
	Area of Pervious Paving:	- Sq-Ft	- Acres			0.30 -	Area	of Pervious Paving:	1,373 Sq-Ft	0.03 Acres		1,373 0.30		Area of Pervious Paving			0.03 Acres	8	1,471	0.30 0.266	56
	Area of Native Vegetation:	- Sq-Ft	- Acres		9:	0.30 -		Native Vegetation:	- Sq-Ft	- Acres		- 0.30	540	Area of Native Vegetation		Sq-Ft	- Acres		-	0.30 -	1
	Area of Planting / Landscaping:	5,540 Sq-Ft	0.13 Acres		5.540	0.10 0.09	Area of Plant	ting / Landscaping:	1,423 Sq-Ft	0.03 Acres		1.423 0.10	0.011	Area of Planting / Landscaping	. 165	Sa-Et	0.00 Acres		165	0.10 0.010	(0

1,373 Sq-Ft
- Sq-Ft
1,423 Sq-Ft

12,418 Sq-Ft

100.0%

0.03 Acres

Acres

Acres

0.29 Acres

Area of Planting / Landscaping:

Permeable Wood Decking:

Percentages:

0.30

0.30

Runoff Factor Ave Calc: 0.154

6.7% 93.3%

Other:

Subtotals:

Percentages:

165 Sa-Ft 0.00 Acres

1,662 Sq-Ft 0.04 Acres

Acres

- Acres

- Sq-Ft

Permeable Wood Decking:

Area of Native Vegetation:
Area of Planting / Landscaping:

0.30

0.30

Runoff Factor Ave Calc: 0.742

22.5%

AREA FOR WATER-QUALITY

TREATMENT BMPs

EL = 297.7, AREA = 198 SQ FT

PLANTED AREA 1,120 SQ FT

EXISTING CONCRETE
BROW-DITCH TO REMAIN

Percentages:

- Sq-Ft

- Sq-Ft

5,940 Sq-Ft

100.0%

Acres

Acres

0.14 Acres

Area of Planting / Landscaping:

Permeable Wood Decking:

____ ____

____ ____