

THE CITY OF SAN DIEGO

# **Report to the Planning Commission**

DATE ISSUED:	February 6, 2020	REPORT NO. PC-20-003
HEARING DATE:	February 13, 2020	
SUBJECT:	BORDER BUSINESS PARK TRUCK.NET. Process Four Decision	
PROJECT NUMBER:	<u>497545</u>	
OWNER/APPLICANT:	Otay Mesa Property L.P., Otay Acquisition L.P Parking L.P./David Wick	., Truck.Net L.P., Otay Truck

# **SUMMARY**

<u>Issue</u>: Should the Planning Commission approve the continued operation of a truck/trailer parking and storage facility with proposed site improvements on a 16.43-acre site located at 2222 Avenida Costa Del Sol, 8470 Avenida De La Fuente, 2224 Avenida Costa Del Sol, and 8490 Avenida De La Fuente within the Otay Mesa Community Plan area?

# Staff Recommendations:

- 1. Approve Planned Development Permit No. 1752902; and
- 2. Approve Conditional Use Permit No. 1752903.

<u>Community Planning Group Recommendation</u>: On October 17, 2019, the Otay Mesa Community Planning Group voted 10-0-3 to recommend approval of the project without conditions (Attachment 11).

<u>Environmental Review</u>: This project was determined to be categorically exempt from the California Environmental Quality Act (CEQA) pursuant to CEQA State Guidelines, Sections 15301 (Existing Facilities) and 15311 (Accessory Structures). This project is not pending an appeal of the environmental determination. The environmental exemption determination for this project was made on October 17, 2019 and the opportunity to appeal that determination ended October 31, 2019.

<u>Fiscal Impact Statement</u>: None associated with this action. All costs associated with the processing of this project are paid by the applicant.

Code Enforcement Impact: None.

Housing Impact Statement: There is no impact on the provision of housing with the

proposed project. The site is designated as International Business and Trade (IBT). The site is further identified in the Otay Mesa's Community Plan Economic Prosperity Element as Prime Industrial. The project proposes the continued operation of an existing truck/trailer parking and storage facility with proposed site improvements, consistent with the proposed land use designation and proposed zoning.

# BACKGROUND

The project site consists of 16.43-acres of disturbed land occupied by an existing truck/trailer parking and storage facility located at 2222 Avenida Costa Del Sol, 8470 Avenida De La Fuente, 2224 Avenida Costa Del Sol, and 8490 Avenida De La Fuente. The site is located within the De La Fuente Business Park Tentative Map area approved by the Planning Commission on June 24, 1985 (Figure 1). The site is zoned IBT-1-1 and designated International Business Trade and Prime Industrial within the Otay Mesa Community Plan. Additionally, the site is located within the Community Plan

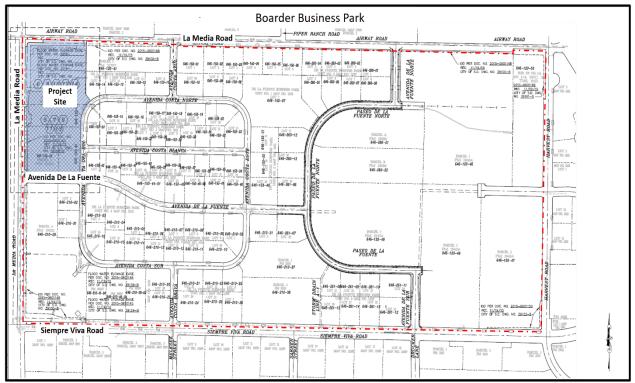


Figure 1: Border Business Park Site Plan

Implementation Overlay Zone (CPIOZ)-A, Airport Land Use Compatibility Overlay Zone, Airport Influence Area (Review Area 2), and the Federal Aviation Administration Part 77 Notification area. To the south and east of the site are other truck/trailer parking and storage facilities that are part of the De La Fuente Business Park, and vacant land lies to the west and north across La Media Road and Airway Road.

On October 19, 1989, the Planning Commission approved Otay Mesa Development (OMD) Permit No. 89-1013 for the construction of a 16,800 square-foot industrial building, landscaping and 51 offstreet parking spaces (Attachment 9). On August 6, 1992 the Planning Commission approved Otay Mesa Development Permit No. 92-0465 for the construction of a 3,933 square-foot truck terminal and supporting facility, landscaping and 22 on-site parking spaces (Attachment 10). Both OMD No. 89-1013 and OMD No. 92-0465 are being amended with this application to allow for proposed improvements to the existing facility.

The entire site is irregular in shape and flat with an elevation differential of five feet from the northern property line to the southern property line. The site currently includes truck parking, an office building inclusive of a restaurant and convenience store located adjacent to Avenida De La Fuente, gas and diesel fuel pumps with canopies, a truck wash and various storage and repair places. The majority of the site has been previously paved (concrete). The project site is not located within or adjacent to the Multiple Habitat Planning Area and does not contain Environmentally Sensitive Lands as defined in San Diego Municipal Code (SDMC) <u>Section 113.0103</u>.

# DISCUSSION

# Project Description:

The project proposes the continued operation of an existing truck/trailer parking and storage facility with proposed site improvements. The proposed improvements include modified drive aisles, reconstructed driveways, landscaping, a new diesel dispenser island, truck scale, fire lane access, canopy structures, and new curb, gutter and sidewalks. The project proposes deviations to the street side yard setback, driveway widths, and driveway separation (see Project related discussion below). Additionally, the project will include bike parking, additional storm drain installation, additional concrete paving, fencing, infiltration basins, and a new mechanical room. Egress and ingress will be updated so that one-way truck circulation will enter the site from Airway Road and exit through Avenida De La Fuente when the curb cut along Airway Road are reconstructed.

Development of the project includes a Planned Development Permit in accordance with San Diego Municipal Code (SDMC) Section 126.0602 for deviations to the street side yard setback, curb cut widths, and driveway separation, and a Conditional Use Permit in accordance with SDMC Section 126.0303 to expand an automobile service station.

### Community Plan Analysis:

The Otay Mesa Community Plan (OMCP) designates the proposed project site as International Business and Trade (IBT). The site is further identified in the Otay Mesa's Economic Prosperity Element as Prime Industrial. In general, lands identified as Prime Industrial in the Community Plan are intended to support export-oriented activities such as warehouse distribution, manufacturing, research and development uses, and supporting business services uses. The project is consistent with the site's identification as Prime Industrial lands as the project provides goods and services to land transportation cargo haulers who carry goods between the United States and Mexico. Additionally, the existing service station is consistent with the IBT land use designation because of the fact it provides support to land transportation cargo haulers. The project provides diesel fueling stations, truck scales, a truck wash and lube station, food and beverage for consumption on-site and off-site, rest-stop facilities and parking for the cargo haulers. The project also supports the IBT businesses by providing these same services to their employees and customers other than cargo

# haulers.

The project is within the Otay Mesa Community Plan Implementation Overlay Zone-A (CPIOZ-A) which includes all industrial and commercial properties within Otay Mesa. The CPIOZ-A protects sensitive resources, ensures construction of circulation infrastructure, and ensures conformance with appropriate policies of the Community Plan's Urban Design Element. The project is consistent with CPIOZ-A. It will provide on-site improvements, and screening and separation from industrial uses to the public right-of-way as a required by CPIOZ-A. The proposed facility and use, along with the associated improvements are consistent with the IBT industrial use designation.

# Project-Related Issues:

<u>Deviations</u> - An applicant may request deviations from the applicable development regulations in accordance with a Planned Development Permit decided in accordance with Process Four, provided that the findings in <u>SDMC Section 126.0605(a)</u> are made. Three deviations are being requested as part of the project design including: 1) encroachment into the street side yard setback for La Media Road; 2) enlarged driveway widths along La Media Road, Airway Road and Avendia Costa Del Sol; and 3) reduction in driveway separation requirements (Figure 2). The following outlines the deviations and justifications:

DEVIATIONS SUMMARY Table 1						
Deviation Description	<b>Deviation from SDMC</b>	Required	Proposed			
1. Street Side Yard	SDMC Section 131.0631	20 feet	11-foot street side			
Setback	<u>Table 131.06C</u>		yard setback along La			
			Media Road			
2. Driveway Widths	SDMC Section	Maximum driveway	60 feet, 40 feet, and			
	<u>142.0560(j) Table</u>	widths of 30 feet for	38 feet			
	<u>142.05M</u>	two-ways and 20 feet				
		for one-way travel.				
3. Driveway	SDMC section	45 feet	14 feet along Avenida			
Separation	<u>142.0560(j)(6) Table</u>		De La Fuente			
	<u>142-05M</u>					

1. <u>Encroachment into the street side yard setback</u>: The 2014 Otay Mesa Community Plan Update added an enhanced parkway along La Media Road. The enhanced parkway reconfigured the property line and resulted in the property owner dedicating a portion of the site for the parkway. SDMC section 131.0631 requires a 20-foot street side yard setback. Due to the reconfiguration of La Media Road, the existing 20-foot long fuel dispenser and three existing, 30-foot long metal canopies, with a 26-foot high ceiling encroach 11 feet into the setback along La Media Road. Additionally, the proposed fuel dispenser will also encroach 11 feet into the setback along La Media Road to align with the existing development.

2. <u>Enlarged Driveway Widths</u>: SDMC section 142.0560(j) and Table 142-05M require nonresidential development outside of the Parking Impact Overlay Zone to provide maximum driveway widths of 30 feet for two-way and 20 feet for one-way vehicle travel. The project proposes one 60-foot wide driveway along La Media Road and Avenida De La Fuente, two 40-foot wide driveways along Avenida Costa Del Sol, and one 38-foot wide driveway along Airway Road.

The project's primary purpose is to provide goods and services to land transportation cargo haulers who carry goods between the United States and Mexico. These land transportation haulers use semi-trucks and trailers which require special consideration for ingress, egress, and on-site circulation patterns. Five of the existing eight driveways have been designed to accommodate the land transportation cargo haulers. The California Department of Transportation (Caltrans) requires for a 56-foot turning radius for semi-trucks and trailers. The proposed curb return with curb ramp will efficiently accommodate the 56-foot turning radius.

The Airway Road driveway would eventually be updated to current City improvement standards using City Standard Drawing SDG-120, subject to the approved Capital Improvement Project (CIP) No. B-19020. CIP No. 19020 would modify the Airway Road driveway reducing the curb cut from 60 feet to 38 feet. This alignment would change the ingress/egress from a two-way driveway to a one-way driveway to allow access but not negatively impact operations at the La Media/Airway intersection.

*3.* <u>Driveway Separation</u>: SDMC section 142.0560(j)(6) and Table 142-05M require a 45-foot length full-height curb between driveways serving the same premises. The project is proposing a 14-foot separation for two driveways located along Avenida De La Fuente.

The project provides diesel fueling stations, truck scales, truck wash and lube, food and beverage for consumption on-site and off-site, rest-stop facilities, and parking for the cargo haulers. The public who live, work, or are passing through Otay Mesa in passenger vehicles also use the project's amenities. The two driveways allow the separation of two different types of traffic uses, truck/trailer storage haulers and patrons walking or using an automobile to access the facility including the convenience store. The two driveways will allow access to the truck/trailer storage yard and access to the convenience store, providing for efficient and safe on-site circulation.

The above three deviations have been analyzed and determined to be consistent with the goals and recommendations of the General Plan, Otay Mesa Community Plan, and the purpose and intent of the IBT 1-1 Zone. The Project has been designed to address the physical environment and would not adversely impact the public's health or safety.

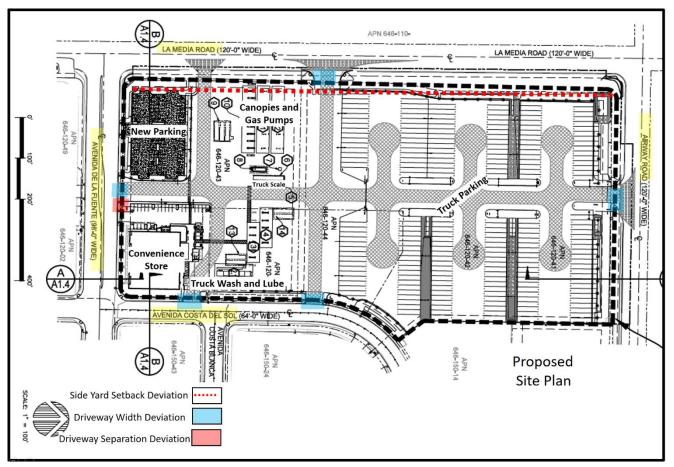


Figure 2: Proposed Site Plan and Deviations

# Conclusion:

Staff has reviewed the proposed project and all issues identified through the review process have been resolved in conformance with adopted City Council policies and regulations of the SDMC. With the approval of the deviations, the project is consistent with the recommended land use plan, development standards in effect for this site per the SDMC, the Otay Mesa Community Plan, and the General Plan. Thus, staff recommends that the Planning Commission approve the project as proposed.

# **ALTERNATIVES**

- 1. Approve Planned Development Permit No. 1752902 and Conditional Use Permit No. 1752903 with modifications.
- 2. Deny Planned Development Permit No. 1752902 and Conditional Use Permit No. 1752903, if the findings required to approve the project cannot be affirmed.

Respectfully submitted,

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PCF/czGerald Assistant Deputy Director Development Services Department

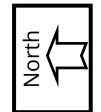
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<u>liam Zoun</u>es

William Zounes Development Project Manager Development Services Department

Attachments:

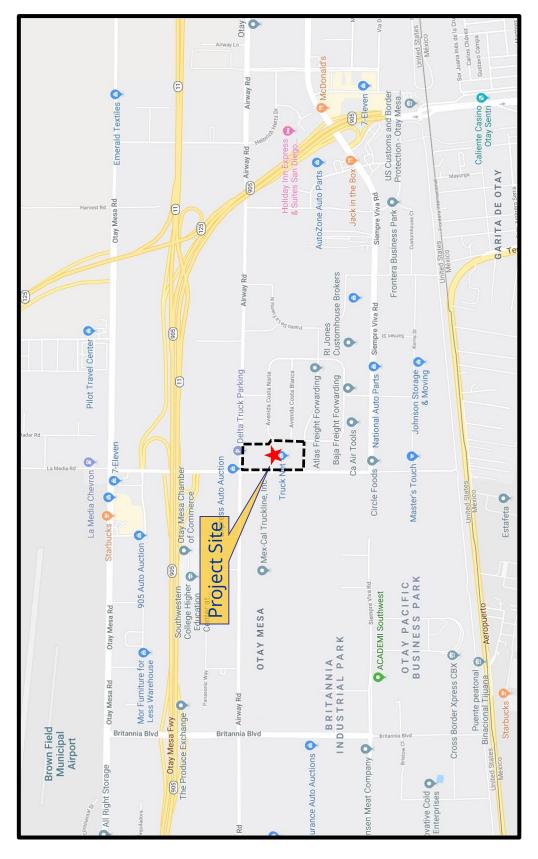
- 1. Location Map
- 2. Existing Land Use Designation
- 3. Aerial Photograph
- 4. Existing Zoning
- 5. Site Photographs (Existing)
- 6. Data Sheet
- 7. Draft PDP/CUP Resolution with Findings
- 8. Draft PDP/CUP Permit with Conditions
- 9. Otay Mesa Development Permit No. 89-1013
- 10. Otay Mesa Development Permit No. 92-0465
- 11. Community Planning Group Recommendation
- 12. Ownership Disclosure Statement
- 13. Project Plans

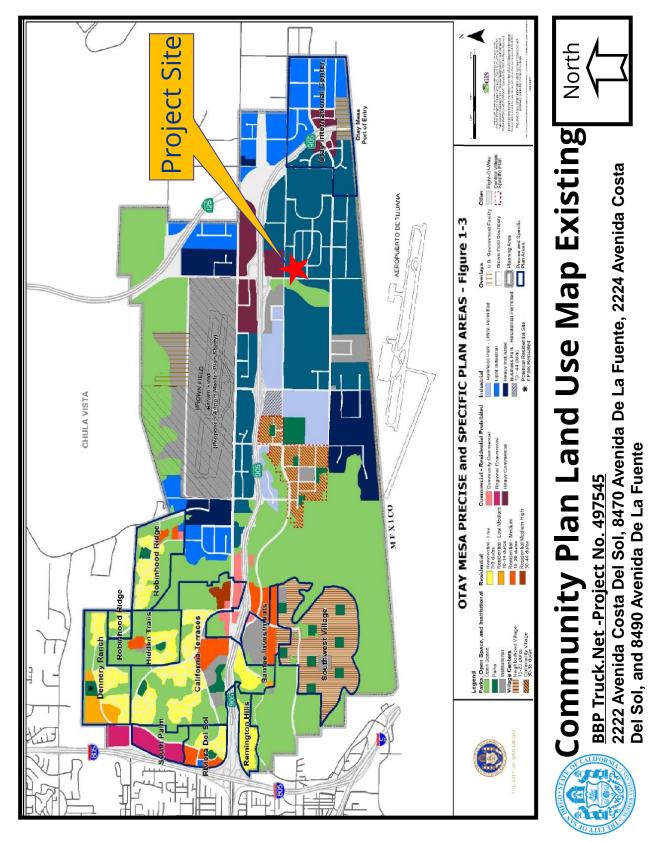


2222 Avenida Costa Del Sol, 8470 Avenida De La Fuente, 2224 Avenida Costa Del Sol, and 8490 Avenida De La Fuente **BBP Truck.Net -Project No. 497545** 



# Location Map BBP Truck.Net -Project No. 49





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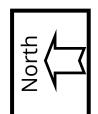
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**Project Site** 

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Avenida Costa Azul

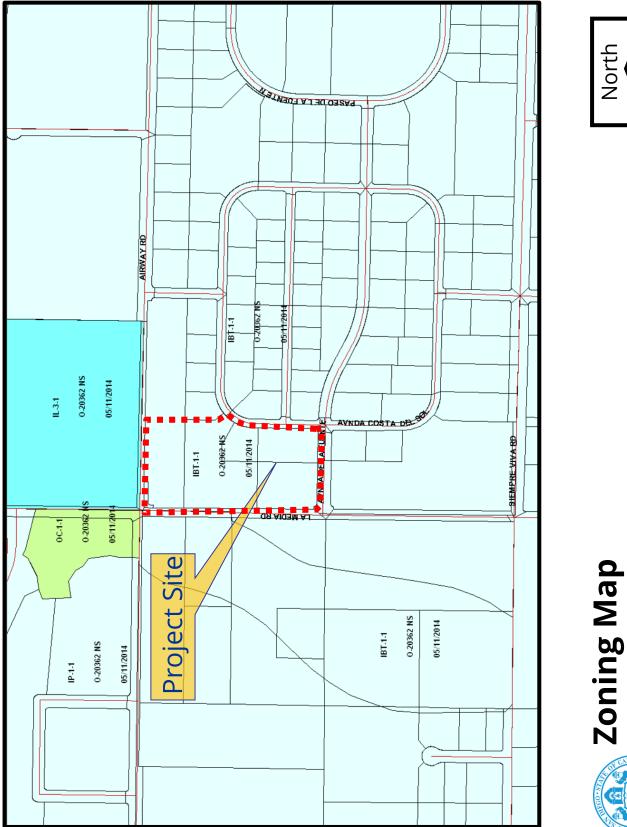


2222 Avenida Costa Del Sol, 8470 Avenida De La Fuente, 2224 Avenida Costa Del Sol, and 8490 Avenida De La Fuente **BBP Truck.Net -Project No. 497545** 



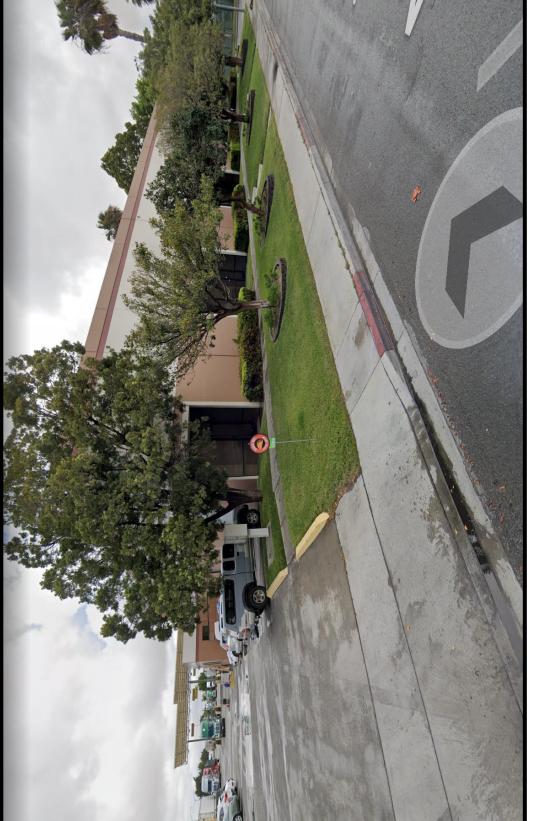
**Aerial Photograph** 





North

2222 Avenida Costa Del Sol, 8470 Avenida De La Fuente, 2224 Avenida Costa Del Sol, and 8490 Avenida De La Fuente **BBP Truck.Net -Project No. 497545** 



# Site Photographs – Looking North from **Avenida De La Fuente**



2222 Avenida Costa Del Sol, 8470 Avenida De La Fuente, 2224 Avenida Costa Del Sol, and 8490 Avenida De La Fuente **BBP Truck.Net -Project No. 497545** 



# Site Photographs – Looking west from **Avenida Costa Del Sol**



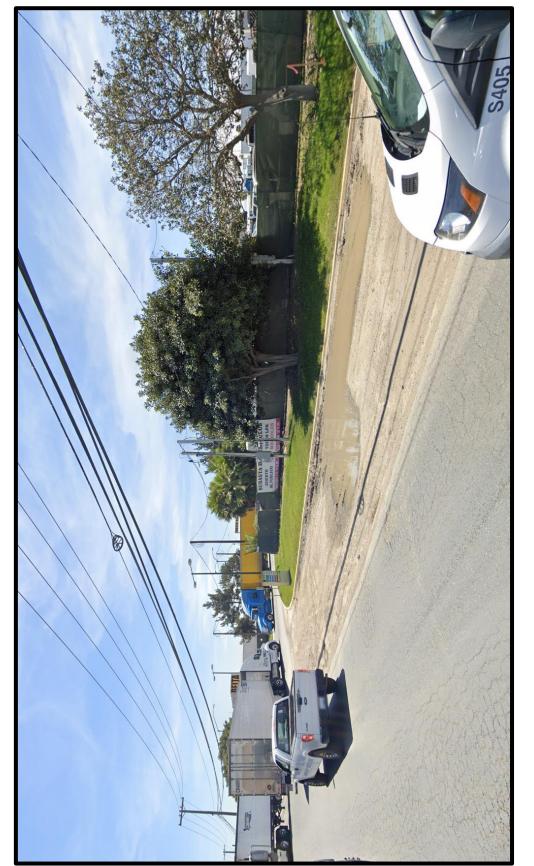
<u>BBP Truck.Net -Project No. 497545</u> 2222 Avenida Costa Del Sol, 8470 Avenida De La Fuente, 2224 Avenida Costa Del Sol, and 8490 Avenida De La Fuente



# Site Photographs – Looking East from La Media Road



<u>BBP Truck.Net -Project No. 497545</u> 2222 Avenida Costa Del Sol, 8470 Avenida De La Fuente, 2224 Avenida Costa Del Sol, and 8490 Avenida De La Fuente



# Site Photographs – Looking Southeast from **Airway Road**



2222 Avenida Costa Del Sol, 8470 Avenida De La Fuente, 2224 Avenida Costa Del Sol, and 8490 Avenida De La Fuente **BBP Truck.Net -Project No. 497545** 

	PROJECT DATA SHEET				
PROJECT NAME:	BBP – Truck.Net - Project No. 497545				
PROJECT DESCRIPTION:	The continued operation of an existing truck/trailer parking and storage facility with proposed site improvements. The proposed improvements include modified drive aisles, reconstructed driveways, landscaping, a new diesel dispenser with island, truck scale, fire lane access, canopy structures, and new curb, gutter and sidewalks with deviations to the street side yard setback and driveway widths				
COMMUNITY PLAN AREA:	Otay Mesa				
DISCRETIONARY ACTIONS:	Planned Development Permit and Conditional Use Permit				
COMMUNITY PLAN LAND USE DESIGNATION:	Business Trade and Prime Industrial				
ZONING INFORMATION:					
HEIGHT LIMIT: N/A LOT SIZE: 16.43-acre FLOOR AREA RATIO: 2.0 FRONT SETBACK: 20/25 SIDE SETBACK: 15 feet STREETSIDE SETBACK: 20 feet REAR SETBACK: 25 feet PARKING: Varies					
ADJACENT PROPERTIES:	LAND USE DESIGNATION & ZONE	EXISTING LAND USE			
NORTH:	Heavy Commercial; IL-3-1	Vacant Land			
SOUTH:	International Business and Trade; IBT-1-1	Truck/Trailer Parking and Storage Facility			
EAST:	International Business and Trade; IBT-1-1	Truck/Trailer Parking and Storage Facility			
WEST:	International Business and Trade; IBT-1-1	Vacant Land			
DEVIATIONS OR VARIANCES REQUESTED:	Street Side Yard Setback, driveway widths, and driveway separation.				
COMMUNITY PLANNING GROUP RECOMMENDATION:	On October 17, 2019 the Otay Mesa Community Planning Group voted 10-0-3 to recommend approval of the project without conditions				

# PLANNING COMMISSION RESOLUTION NO. \_\_\_\_\_ PLANNED DEVELOPMENT PERMIT NO. 1752902 CONDITIONAL USE PERMIT NO. 1752903 **BORDER BUSINESS PARK – TRUCK.NET PROJECT NO. 497545** AMENDMENT TO OTAY MESA DEVELOPMENT PERMIT NO. 89-1013 AND OTAY MESA DEVELOPMENT PERMIT NO. 92-0465

WHEREAS, Otay Mesa Property L.P., Otay Acquisitions L.P., Truck.net LLC, and Otay Truck Parking L. P., Owner/Permittee, filed an application with the City of San Diego for a permit to modify an existing truck/trailer parking and storage facility with proposed off and on-site improvements and remodel an existing automobile service station/food mart as described in and by reference to the approved Exhibits "A" and corresponding conditions of approval for the associated Permit No. 1752902 and 1752903, on portions of a 16.43-acre site;

WHEREAS, the project site is located at 2222 Avenida Costa Del Sol, 8470 Avenida De La Fuente, 2224 Avenida Costa Del Sol, and 8490 Avenida De La Furente in the IBT-1-1 zone of the Otay Mesa Community Plan;

WHEREAS, the project site is legally described as Parcel 1, 2 and 3 of Parcel Map No. 19322, in the City of San Diego, County of San Diego, State of California, filed in the Office of the County Recorder of San Diego County, September 10, 2003 and Parcel 1 of Parcel Map No. 19322, as file/page No. 2003-1106905 Official Records;

WHEREAS, on October 17, 2019 the City of San Diego, as Lead Agency, through the Development Services Department, made and issued an Environmental Determination that the project is exempt from the California Environmental Quality Act (CEQA) (Public Resources Code Section 21000 et seq.) under CEQA Guideline Section 15301and 15311 (existing facilities) and there was no appeal of the Environmental Determination filed within the time period provided by San Diego Municipal Code Section 112.0520; WHEREAS, on February 13, 2020, the Planning Commission of the City of San Diego

considered Planned Development Permit No. 1752902 and Conditional Use Permit No. 1752903

pursuant to the Land Development Code of the City of San Diego; NOW THEREFORE;

BE IT RESOLVED by the Planning Commission of the City of San Diego, that it adopts the

following findings with respect to Planned Development Permit No. 1752902 and Conditional Use

Permit No. 1752903:

# A. PLANNED DEVELOPMENT PERMIT [SDMC Section 126.0605]

# 1. <u>Findings for all Planned Development Permits:</u>

# a. The proposed development will not adversely affect the applicable land use plan.

The project proposes the continued operation of an existing truck/trailer parking and storage facility with proposed site improvements to include modified drive aisles, reconstructed driveways, landscaping, a new diesel dispenser with island, a truck scale, a new fire lane access, canopy structures, and new curb, gutter and sidewalks. The project also includes improvements to an existing automobile service station/food mart. The 16.43-acre site is located at 2222 Avenida Costa Del Sol, 8470 Avenida De La Fuente, 2224 Avenida Costa Del Sol, and 8490 Avenida De La Furente . The project is in the IBT-1-1 Zone and Community Plan Implementation Overlay Zone (CPIOZ)-A of the Otay Mesa Community Plan .

The Otay Mesa Community Plan (OMCP) designates the proposed project site as International Business and Trade (IBT). The site is further identified in the Otay Mesa's Economic Prosperity Element as Prime Industrial. In general, lands identified as Prime Industrial in the Community Plan are intended to support export-oriented activities such as warehouse distribution, manufacturing, research and development uses, and supporting business services uses. The project is consistent with the site's identification as Prime Industrial lands as the project provides goods and services to land transportation cargo haulers who carry goods between the United States and Mexico. Additionally, the existing service station is consistent with the IBT land use designation becasue it provides support to land transportation cargo haulers. The project provides diesel fueling stations, truck scales, a truck wash and lube station, food and beverage for consumption on-site and off-site, rest-stop facilities and parking for the cargo haulers. The project also supports the IBT businesses by providing these same services to their employees and customers other than cargo haulers. The project is within the CPIOZ-A which includes all industrial and commercial properties within Otay Mesa. The CPIOZ-A protects sensitive resources, ensures construction of circulation infrastructure, and ensures conformance with appropriate policies of the Community Plan's Urban Design Element. The project is consistent with CPIOZ-A. It will provide on-site improvements, screening and separation from industrial uses to the public right-of-way as a required by CPIOZ-A.

The proposed facility and use, along with the associated improvements are consistent with IBT industrial use designation. Therefore, the proposed project and its associated site improvements will not adversely affect the applicable land use plan.

# b. The proposed development will not be detrimental to the public health, safety, and welfare.

The City of San Diego conducted an environmental review that determined the project would not have the potential for causing a significant effect on the environment. The project was determined to be categorically exempt from CEQA pursuant to CEQA State Guidelines, Sections 15301 (Existing Facilities) and 15311 (Accessory Structures). The project involves negligible expansion of the existing use and consists of the construction, or placement of minor structures accessory to (appurtenant to) existing commercial, industrial, or institutional facilities, including on-premise signs and small parking lots.

The permit prepared for this project includes various conditions and corresponding exhibits of approvals relevant to achieving compliance with the regulations of the San Diego Municipal Code and California Building Codes for grading and construction. Conditions required for the project include, but are not limited to, storm water and general runoff requirements, landscaping, public improvements including the reconstruction of driveways to current standards, lighting, and sign requirements. The project is required to continue to implement Best Management Practices to minimize discharges to soil and surface waters. All Building, Fire, Plumbing, Electrical and Mechanical Codes governing the construction and continued operation of the development apply to this site to prevent adverse effects. Therefore, the project will not be detrimental to the public health, safety and welfare.

c. The proposed development will comply with the regulations of the Land Development Code including any proposed deviations pursuant to Section 126.0602(b)(1) that are appropriate for this location and will result in a more desirable project than would be achieved if designed in strict conformance with the development regulations of the applicable zone, and any allowable deviations that are otherwise authorized pursuant to the Land Development Code.

The project proposes the continued operation of an existing truck/trailer parking and storage facility with proposed site improvements to include modified drive aisles,

reconstructed driveways, landscaping, a new diesel dispenser with island, a truck scale, a new fire lane access, canopy structures, and new curb, gutter and sidewalks. The project also includes improvements to an existing automobile service station/food mart. The 16.43-acre site is located at 8490 Avenida De La Fuente east of La Media Road between Airway Road and Avenida De La Fuente. The project is in the IBT-1-1 Zone of the Otay Mesa Community Plan and Community Plan Implementation Overlay Zone (CPIOZ)-A.

<u>Encroachment into the street side yard setback</u>: The 2014 Otay Mesa Community Plan Update added an enhanced parkway along La Media Road. The enhanced parkway reconfigured the property line and resulted in the property owner dedicating a portion of the site for the parkway. SDMC section 131.0631 requires a 20-foot street side yard setback. Due to the reconfiguration of La Media Road, the existing 20-foot long fuel dispenser and three existing, 30-foot long metal canopies, with a 26-foot high ceiling encroach 11 feet into the setback along La Media Road. Additionally, the proposed fuel dispenser will also encroach 11 feet into the setback along La Media Road to align with the existing development.

<u>Enlarged Driveway Widths</u>: SDMC section 142.0560(j) and Table 142-05M\_require nonresidential development outside of the Parking Impact Overlay Zone to provide maximum driveway widths of 30 feet for two-way and 20 feet for one-way vehicle travel. The project proposes one 60-foot wide driveway along La Media Road and Avenida De La Fuente, two 40-foot wide driveways along Avenida Costa Del Sol, and one 38-foot wide driveway along Airway Road.

The project's primary purpose is to provide goods and services to land transportation cargo haulers who carry goods between the United States and Mexico. These land transportation haulers use semi-trucks and trailers which require special consideration for ingress, egress, and on-site circulation patterns. Five of the existing eight driveways have been designed to accommodate the land transportation cargo haulers. The California Department of Transportation (Caltrans) requires for a 56-foot turning radius for semi-trucks and trailers. The proposed curb return with curb ramp will efficiently accommodate the 56-foot turning radius.

The Airway Road driveway would eventually be updated to current City improvement standards using City Standard Drawing SDG-120, subject to the approved Capital Improvement Project (CIP) No. B-19020. CIP No. 19020 would modify the Airway Road driveway reducing the curb cut from 60 feet to 38 feet. This alignment would change the ingress/egress from a two-way driveway to a one-way driveway to allow access but not negatively impact operations at the La Media/Airway intersection.

*Driveway Separation*: SDMC section 142.0560(j)(6) and Table 142-05M require a 45foot length full-height curb between driveways serving the same premises. The project is proposing a 14-foot separation for two driveways located along Avenida De La Fuente. The project provides diesel fueling stations, truck scales, truck wash and lube, food and beverage for consumption on-site and off-site, rest-stop facilities, and parking for the cargo haulers. The public who live, work, or are passing through Otay Mesa in passenger vehicles also use the project's amenities. The two driveways allow the separation of two different types of traffic uses, truck/trailer storage haulers and patrons walking or using an automobile to access the facility including the convenience store. The two driveways will allow access to the truck/trailer storage yard and access to the convenience store, providing for efficient and safe on-site circulation.

The above three deviations have been analyzed and determined to be consistent with the goals and recommendations of the General Plan, Otay Mesa Community Plan, and the purpose and intent of the IBT 1-1 Zone. The Project has been designed to address the physical environment and would not adversely impact the public's health or safety. Therefore, the proposed development will comply with the regulations of the Land Development Code including any proposed deviations pursuant to Section 126.0602(b)(1) that are appropriate for this location and will result in a more desirable project than would be achieved if designed in strict conformance with the development regulations of the applicable zone, and any allowable deviations that are otherwise authorized pursuant to the Land Development Code.

# B. CONDITIONAL USE PERMIT [SDMC 126.0305]

# 1. Findings for all Conditional Use Permits:

# a. The proposed development will not adversely affect the applicable land use Plan.

As outlined in Planned Development Permit Finding No. (1)(a), the proposed development will not adversely affect the applicable land use plan.

# b. The proposed development will not be detrimental to the public health, safety, and welfare.

As outlined in Planned Development Permit Finding No. (1)(b), the proposed development will not be detrimental to the public health, safety, and welfare.

# c. The proposed development will comply with the regulations of the Land Development Code including any allowable deviations pursuant to the Land Development Code.

As outlined in Planned Development Permit Finding No. (1)(c), the proposed development will comply with the regulations of the Land Development Code including any allowable deviations pursuant to the Land Development Code.

# d. The proposed use is appropriate at the proposed location.

The project proposes the continued operation of an existing truck/trailer parking and storage facility with site improvements to include modified drive aisles, reconstructed driveways, landscaping, a new diesel dispenser with island, a truck scale, a new fire lane access, canopy structures, and new curb, gutter and sidewalks. The project also includes improvements to an existing automobile service station/food mart.

The proposed Conditional Use Permit is to amend two previously approved Otay Mesa Development Permits (OMD 89-1013 and OMD 92-0465) approved by the Planning Commission on October 19, 1989 and OMD 92-0465 and August 6, 1992, respectively. Both sites are part of the De La Fuente Business Park approved by the Planning Commission on June 24, 1985. The base use for the business park since the 1980's has primarily been truck/trailer parking and storage facility which includes providing goods and services to land transportation cargo haulers who carry goods between the United States and Mexico.

The existing facility currently includes a 20,585-square-foot concrete tilt-up building with a convenience store, delicatessen, public showers, restrooms, laundry facilities, lounge, retail and office space with customer parking areas; 21 diesel fuel dispensers with metal canopies; a masonry building for truck wash and lube services with metal canopy; one ground-level truck scale; an electrical switchboard outbuilding; three 30,000 gallon underground diesel fuel storage tanks; one 10,000 gallon above ground Diesel Exhaust Fluid tank; three 20,000 gallon underground diesel fuel storage tanks; truck park and storage yards; one monument sign; and one pole sign. The project proposes to add an additional ground-level truck scale, customer vehicular parking, and parking for cargo haulers, as well as directional signage.

The proposed improvements to the existing truck/trailer parking and storage facility use are consistent with the existing industrial use of the property and implements the International Business and Trade (IBT) land use designation of the Community Plan. The existing use is expanding with improvements and providing appropriate accommodations to keep up with current market demand for the facility, therefore, the proposed use is appropriate at the proposed location.

The above findings are supported by the minutes, maps and exhibits, all of which are

incorporated herein by this reference.

BE IT FURTHER RESOLVED that, based on the findings hereinbefore adopted by the Planning

Commission, Planned Development Permit No. 1752902 and Conditional Use Permit No. 1752903 is

hereby GRANTED by the Planning Commission to the referenced Owner/Permittee, in the form,

exhibits, terms and conditions as set forth in Planned Development Permit No. 1752902 and

Conditional Use Permit No. 1752903, a copy of which is attached hereto and made a part hereof.

William Zounes Development Project Manager Development Services

Adopted on: February 13, 2019

IO#: 24006607

RECORDING REQUESTED BY CITY OF SAN DIEGO DEVELOPMENT SERVICES PERMIT INTAKE, MAIL STATION 501

### WHEN RECORDED MAIL TO PROJECT MANAGEMENT PERMIT CLERK MAIL STATION 501

INTERNAL ORDER NUMBER: 24006607

SPACE ABOVE THIS LINE FOR RECORDER'S USE

# PLANNED DEVELOPMENT PERMIT NO. 1752902 CONDITIONAL USE PERMIT NO. 1752903 BORDER BUSINESS PARK – TRUCK.NET PROJECT NO. 497545 [AMENDMENT TO OTAY MESA DEVELOPMENT PERMIT NO. 89-1013 AND OTAY MESA DEVELOPMENT PERMIT NO. 92-0465] PLANNING COMMISSION

This Planned Development Permit No. 1752902 and Conditional Use Permit No. 1752903 [amendment to Otay Mesa Development Permit No. 89-1013 and Otay Mesa Development Permit No. 92-04654] is granted by the Planning Commission of the City of San Diego to Otay Mesa Property LP, Otay Acquisitions L.P., Truck.Net LLC, and Otay Truck Parking, L. P. Owners, and Permittees, pursuant to San Diego Municipal Code [SDMC] section 143.0402, 126.0303 and 141.0801. The 16.43-acre site is located at 2222 Avenida Costa Del Sol, 8470 Avenida De La Fuente, 2224 Avenida Costa Del Sol, and 8490 Avenida De La Fuente in the IBT-1-1 zone of the Otay Mesa Community Plan. The project site is legally described as: Parcel 2 of Parcel Map No. 21707, in the City of San Diego, County of san Diego, State of California, filed in the Office of the County Recorder of San Diego County, August 9, 2019 as file/page No. 2019-7000294 Official Records and Parcel 3 of Parcel Map No. 19322, filed in the Office of the County Recorder of San Diego County, September 10, 2003 as file/page No. 2003-1106905 Official Records;

Subject to the terms and conditions set forth in this Permit, permission is granted to Owner/Permittee for modifications to an existing truck/trailer parking and storage facility with proposed off and on-site improvements and remodel to an existing truck/automobile service station/food mart described and identified by size, dimension, quantity, type, and location on the approved exhibits [Exhibit "A"] dated February 13, 2020, on file in the Development Services Department.

The project shall include:

- a. Modifications to an existing truck/trailer parking and storage facility to include improvements to:
  - The remodel of a 20,585 square-foot truck/automobile service station/food mart;
  - Removal/Replacement of a 6,240 square-foot truck wash canopy;

- Construction of two existing 3,000 square-foot Novum Open canopies;
- Truck scales;
- Asphalt paving;
- Automobile Parking;
- Chain link fence;
- Loading area;
- Infiltration basin;
- Light poles;
- Curb, gutters, and sidewalks;
- Wheel stops;
- Bicycle/motorcycle parking;
- Zero emissions parking;
- Signs;
- Truck parking;
- Storm drain;
- Additional diesel dispenser and island
- Fire access;
- Pedestrian ramps;
- Decorative gravel;
- Mechanical room;
- Shower facility;
- Truck wash and lube facility; and
- Refuse and recycling area.
- b. Deviations:
  - A deviation from SDMC Section 131.0631, and Table 131-06C allowing a portion of an existing 20-foot long fuel dispenser, three existing, 30-foot long metal canopies, with a 26-foot high ceiling to encroach 11 feet, and a proposed fuel dispenser into the setback along La Media Road ;
  - 2. A deviation from SDMC section 142.0560(j), and Table 142-05M allowing one 60-foot wide driveway along La Media Road and Avenida De La Fuente, two, 40-foot wide driveways along Avenida Costa Del Sol, and one 38-foot wide driveway along Airway Road;
  - 3. A deviation from SDMC section 142.0560(j)(6), and Table 142-05M allowing a 14-foot separation for two driveways located along Avenida De La Fuente.
- c. Landscaping (planting, irrigation and landscape related improvements);
- d. Off-street parking;
- e. Public and private accessory improvements determined by the Development Services Department to be consistent with the land use and development standards for this site in accordance with the adopted community plan, the California Environmental Quality Act

[CEQA] and the CEQA Guidelines, the City Engineer's requirements, zoning regulations, conditions of this Permit, and any other applicable regulations of the SDMC.

# STANDARD REQUIREMENTS:

1. This permit must be utilized within thirty-six (36) months after the date on which all rights of appeal have expired. If this permit is not utilized in accordance with Chapter 12, Article 6, Division 1 of the SDMC within the 36-month period, this permit shall be void unless an Extension of Time has been granted. Any such Extension of Time must meet all SDMC requirements and applicable guidelines in effect at the time the extension is considered by the appropriate decision maker. This permit must be utilized by February 27, 2023.

2. No permit for the construction, occupancy, or operation of any facility or improvement described herein shall be granted, nor shall any activity authorized by this Permit be conducted on the premises until:

- a. The Owner/Permittee signs and returns the Permit to the Development Services Department; and
- b. The Permit is recorded in the Office of the San Diego County Recorder.

3. While this Permit is in effect, the subject property shall be used only for the purposes and under the terms and conditions set forth in this Permit unless otherwise authorized by the appropriate City decision maker.

4. This Permit is a covenant running with the subject property and all of the requirements and conditions of this Permit and related documents shall be binding upon the Owner/Permittee and any successor(s) in interest.

5. The continued use of this Permit shall be subject to the regulations of this and any other applicable governmental agency.

6. Issuance of this Permit by the City of San Diego does not authorize the Owner/Permittee for this Permit to violate any Federal, State or City laws, ordinances, regulations or policies including, but not limited to, the Endangered Species Act of 1973 [ESA] and any amendments thereto (16 U.S.C. § 1531 et seq.).

7. The Owner/Permittee shall secure all necessary building permits. The Owner/Permittee is informed that to secure these permits, substantial building modifications and site improvements may be required to comply with applicable building, fire, mechanical, and plumbing codes, and State and Federal disability access laws.

8. Construction plans shall be in substantial conformity to Exhibit "A." Changes, modifications, or alterations to the construction plans are prohibited unless appropriate application(s) or amendment(s) to this Permit have been granted.

9. All of the conditions contained in this Permit have been considered and were determined necessary to make the findings required for approval of this Permit. The Permit holder is required to comply with each and every condition in order to maintain the entitlements that are granted by this Permit.

If any condition of this Permit, on a legal challenge by the Owner/Permittee of this Permit, is found or held by a court of competent jurisdiction to be invalid, unenforceable, or unreasonable, this Permit shall be void. However, in such an event, the Owner/Permittee shall have the right, by paying applicable processing fees, to bring a request for a new permit without the "invalid" conditions(s) back to the discretionary body which approved the Permit for a determination by that body as to whether all of the findings necessary for the issuance of the proposed permit can still be made in the absence of the "invalid" condition(s). Such hearing shall be a hearing de novo, and the discretionary body shall have the absolute right to approve, disapprove, or modify the proposed permit and the condition(s) contained therein.

The Owner/Permittee shall defend, indemnify, and hold harmless the City, its agents, officers, 10. and employees from any and all claims, actions, proceedings, damages, judgments, or costs, including attorney's fees, against the City or its agents, officers, or employees, relating to the issuance of this permit including, but not limited to, any action to attack, set aside, void, challenge, or annul this development approval and any environmental document or decision. The City will promptly notify Owner/Permittee of any claim, action, or proceeding and, if the City should fail to cooperate fully in the defense, the Owner/Permittee shall not thereafter be responsible to defend, indemnify, and hold harmless the City or its agents, officers, and employees. The City may elect to conduct its own defense, participate in its own defense, or obtain independent legal counsel in defense of any claim related to this indemnification. In the event of such election, Owner/Permittee shall pay all of the costs related thereto, including without limitation reasonable attorney's fees and costs. In the event of a disagreement between the City and Owner/Permittee regarding litigation issues, the City shall have the authority to control the litigation and make litigation related decisions, including, but not limited to, settlement or other disposition of the matter. However, the Owner/Permittee shall not be required to pay or perform any settlement unless such settlement is approved by Owner/Permittee.

11. This Permit supersedes Otay Mesa Development Permit NO. 89-1013 and Otay Mesa Development Permit NO. 92-0465.

# **CLIMATE ACTION PLAN REQUIREMENTS:**

12. Owner/Permittee shall comply with the Climate Action Plan (CAP) Consistency Checklist stamped as Exhibit "A." Prior to issuance of any construction permit, all CAP strategies shall be noted within the first three (3) sheets of the construction plans under the heading "Climate Action Plan Requirements" and shall be enforced and implemented to the satisfaction of the Development Services Department.

# **ENGINEERING REQUIREMENTS:**

13. Prior to the issuance of any construction permit, the Owner/Permittee shall incorporate any construction Best Management Practices necessary to comply with Chapter 14, Article 2, Division 1 (Grading Regulations) of the San Diego Municipal Code, into the construction plans or specifications, in a manner satisfactory to the City Engineer.

14. Development of this project shall comply with all storm water construction requirements of the State Construction General Permit, Order No. 2009-0009DWQ, or subsequent order, and the Municipal Storm Water Permit, Order No. R9-2013-0001, or subsequent order. In accordance with Order No. 2009-0009DWQ, or subsequent order, a Risk Level Determination shall be calculated for the site and a Storm Water Pollution Prevention Plan (SWPPP) shall be implemented concurrently with the commencement of grading activities.

15. Prior to issuance of a grading or a construction permit, a copy of the Notice of Intent (NOI) with a valid Waste Discharge ID number (WDID#) shall be submitted to the City of San Diego as a proof of enrollment under the Construction General Permit. When ownership of the entire site or portions of the site changes prior to filing of the Notice of Termination (NOT), a revised NOI shall be submitted electronically to the State Water Resources Board in accordance with the provisions as set forth in Section II.C of Order No. 2009-0009DWQ and a copy shall be submitted to the City, satisfactory to the City Engineer.

# LANDSCAPE REQUIREMENTS:

16. Prior to issuance of any engineering permits for grading, the Owner/Permittee shall submit complete construction documents for the revegetation and hydroseeding of all disturbed land in accordance with the City of San Diego Landscape Standards, Stormwater Design Manual, and to the satisfaction of the Development Services Department. All plans shall be in substantial conformance to this permit (including Environmental conditions) and Exhibit "A," on file in the Office of the Development Services Department.

17. Prior to issuance of any engineering permits for right-of-way improvements, the Owner/Permittee shall submit complete landscape construction documents for right-of-way improvements to the Development Services Department for approval. Improvement plans shall show, label, and dimension a 40-square-foot area around each tree which is unencumbered by utilities. Driveways, utilities, drains, water and sewer laterals shall be designed so as not to prohibit the placement of street trees.

18. Prior to issuance of any construction permits for structures (including shell), the Owner/Permittee shall submit complete landscape and irrigation construction documents consistent with the Landscape Standards to the Development Services Department for approval. The construction documents shall be in substantial conformance with Exhibit "A," Landscape Development Plan, on file in the Office of the Development Services Department. Construction plans shall provide a 40-square-foot area around each tree that is unencumbered by hardscape and utilities unless otherwise approved per SDMC 142.0403(b)(5).

19. In the event that a foundation only permit is requested by the Owner/Permittee, a site plan or staking layout plan shall be submitted to the Development Services Department identifying all

landscape areas consistent with Exhibit "A," Landscape Development Plan, on file in the Office of the Development Services Department. These landscape areas shall be clearly identified with a distinct symbol, noted with dimensions and labeled as "landscaping area."

20. The Owner/Permittee shall be responsible for the maintenance of all landscape improvements shown on the approved plans, including in the right-of-way, consistent with the Landscape Standards unless long-term maintenance of said landscaping will be the responsibility of a Landscape Maintenance District or other approved entity.

21. All required landscape shall be maintained in a disease, weed and litter free condition at all times. Severe pruning or "topping" of trees is not permitted unless specifically noted in this Permit.

22. If any required landscape (including existing or new plantings, hardscape, landscape features, etc.) indicated on the approved construction document plans is damaged or removed during demolition or construction, the Owner/Permittee shall repair and/or replace in kind and equivalent size per the approved documents to the satisfaction of the Development Services Department within 30 days of damage.

# PLANNING/DESIGN REQUIREMENTS:

23. All signs associated with this development shall be consistent with sign criteria established by either the approved Exhibit "A" or City-wide sign regulations.

24. All private outdoor lighting shall be shaded and adjusted to fall on the same premises where such lights are located and in accordance with the applicable regulations in the SDMC.

# TRANSPORTATION REQUIREMENTS

25. The automobile, motorcycle and bicycle parking spaces must be constructed in accordance with the requirements of the SDMC. All on-site parking stalls and aisle widths shall be in compliance with requirements of the City's Land Development Code and shall not be converted and/or utilized for any other purpose, unless otherwise authorized in writing authorized by the appropriate City decision maker in accordance with the SDMC.

26. Prior to issuance of the first building permit, the applicant shall provide a recorded Shared Parking Agreement between all affected properties, satisfactory to the City Engineer.

27. Prior to issuance of the first building permit, the applicant shall provide a recorded Joint Use Driveway/Mutual Access Agreement between all affected properties, satisfactory to the City Engineer.

28. Prior to issuance of any building permit, the Owner/Permittee shall assure by permit and bond the construction of two 24-foot wide driveway curb cuts along Avenida De La Fuente in the location shown on Exhibit A, satisfactory to the City Engineer.

29. Prior to issuance of any building permit, the Owner/Permittee shall assure by permit and bond the construction of one 60-foot wide driveway curb cut along Avenida De La Fuente in the location shown on Exhibit A, satisfactory to the City Engineer.

30. Prior to issuance of any building permit, the Owner/Permittee shall assure by permit and bond the construction of two 40-foot wide driveway curb cut along Avenida Costa Del Sol in the location shown on Exhibit A, satisfactory to the City Engineer.

31. Prior to issuance of any building permit, the Owner/Permittee shall assure by permit and bond the construction of one 60-foot wide driveway with 30-foot radius curb returns along La Media Road in the location shown on Exhibit A, satisfactory to the City Engineer. This may be completed by CIP project WBS # B-19020.

32. Prior to issuance of any building permit, the Owner/Permittee shall assure by permit and bond the construction of one 30-foot wide driveway curb cut along La Media Road in the location shown on Exhibit A, satisfactory to the City Engineer. This may be completed by CIP project WBS # B-19020.

33. Prior to the issuance of any building permit, the Owner/Permittee shall assure by permit and bond the construction of a 38-foot wide one-way driveway with 30-foot radius curb returns along Airway Road in the location shown on Exhibit A, satisfactory to the City Engineer. This may be completed by CIP project WBS # B-19020.

# PUBLIC UTILITIES DEPARTMENT REQUIREMENTS:

34. All on-site utilities must be private.

35. All proposed private sewer facilities located within a single lot are to be designed to meet the requirements of the California Plumbing Code and will be reviewed as part of the building permit plan check.

36. The proposed development is currently subject to the following sewer reimbursement fee: The Otay Mesa Sewer Surcharge fee of \$1821.75 per equivalent dwelling unit (EDU) plus six percent simple interest from 3 12 08 (21351-D-O).

37. No trees or shrubs exceeding three feet in height at maturity shall be installed within ten feet of any sewer and five feet of any water facilities.

# **INFORMATION ONLY:**

• The issuance of this discretionary permit alone does not allow the immediate commencement or continued operation of the proposed use on site. Any operation allowed by this discretionary permit may only begin or recommence after all conditions listed on this permit are fully completed and all required ministerial permits have been issued and received final inspection.

- Any party on whom fees, dedications, reservations, or other exactions have been imposed as conditions of approval of this Permit, may protest the imposition within ninety days of the approval of this development permit by filing a written protest with the City Clerk pursuant to California Government Code-section 66020.
- This development may be subject to impact fees at the time of construction permit issuance.

APPROVED by the Planning Commission of the City of San Diego on February 13, 2020.

PDP No. 1752902/CUP No. 1752903 Date of Approval: February 13, 2020

AUTHENTICATED BY THE CITY OF SAN DIEGO DEVELOPMENT SERVICES DEPARTMENT

William Zounes Development Project Manager

NOTE: Notary acknowledgment must be attached per Civil Code section 1189 et seq.

**The undersigned Owner/Permittee**, by execution hereof, agrees to each and every condition of this Permit and promises to perform each and every obligation of Owner/Permittee hereunder.

Otay Mesa Property L.P. Owner/Permittee Otay Truck Parking, LP Owner/Permittee

By\_

Ву \_\_\_\_\_

Otay Acquisitions L.P. Owner/Permittee Truck.Net LLC Owner/Permittee

Ву \_\_\_\_\_

Ву \_\_\_\_\_

NOTE: Notary acknowledgments must be attached per Civil Code section 1189 et seq.

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ATTACHMENT 9

amdo

OTAY MESA DEVELOPMENT PERMIT NO. 89-1013 PLANNING DIRECTOR

This Otay Mesa Development Permit is granted by the Planning Industrial Director of the City of San Diego to LOWELL D. STRATE, Owner/Permittee, under conditions in Section 103.1100 of the Building Municipal Code of the City of San Diego.

1. Permission is hereby granted to Owner/Permittee, to construct an industrial use building located at 6310 Avenida de la Fuente between Avenida Costa del Sol and the western development boundary, described as Lot 3, Unit 2 of the De La Fuente Businesse Park, in the Industrial Zone.

2. The Project shall consist of the following:

a. One 16,800-square-foot industrial use building;

b. Landscaping;

c. Off-street Parking; and

d. Incidental accessory uses as may be determined incidental and approved by the Planning Director.

3. Not fewer than 51 off-street parking spaces shall be maintained on the property in the approximate location shown on Exhibit "A," dated October 19, 1989, on file in the office of the Planning Department. Parking spaces shall be consistent with Division 8 of the Municipal Code and shall be permanently maintained and not converted for any other use. Parking spaces and aisles shall conform to Planning Department standards. Parking areas shall be marked.

4. Before issuance of any building permits, complete grading along building plans shall be submitted to the Planning Director for approval. Plans shall be in substantial conformity to Exhibit "A," dated October 19, 1989, on file in the office of the Planning Department. No change, modifications or alterations shall be made unless appropriate applications or amendment of the permit shall have been granted.

5. Before issuance of any grading or building permits, a complete landscape plan, including a permanent irrigation system, shall log submitted to the Planning Director for approval. Plans shall be in substantial conformity to Exhibit "A," dated October 19, 1989, on file in the office of the Planning Department. Approved plantings shall be installed before issuance of any occupancy permit on any building. Such plantings shall not be modified of altered unless this permit has been amended.

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All outdoor lighting shall be so shaded and adjusted that the light is directed to fall only on the same premises as light sources are located.

7. All uses, except storage and loading, shall be conducted entirely within an enclosed building. Outdoor storage of merchandise, material and equipment is permitted in any required interior side or rear yard, provided the storage area is completely enclosed by walls, fences or a combination thereof. Walls or fences shall be solid and not less than six feet in height and, provided further, that no merchandise, material or equipment is stored to a height greater than any adjacent wall or fence.

8. No mechanical equipment, tank, duct, elevator enclosure, cooling tower or mechanical ventilator or air conditioner shall be erected, constructed, converted, established, altered, or enlarged on the roof of any building, unless all such equipment and appurtenances are contained within a completely enclosed structure whose top and sides may include grillwork, louvers and latticework.

9. No merchandise, material or equipment shall be stored on the roof of any building.

10. This Otay Mesa Development Permit must be used within 36 months after the date of City approval October 19, 1989, or the permit shall be void. An Extension of Time may be granted as set forth in Section 101.0920 of the Municipal Code. Any extension of time shall be subject to all standards and criteria in effect at the time the extension is applied for.

11. Construction and operation of the approved use shall comply at all times with the regulations of this or any other governmental agencies.

12. After establishment of the project, the property shall not be used for any other purposes unless:

a. Authorized by the Planning Director; or

b. The proposed use meets every requirement of the zone existing for the property at the time of conversion; or

c. The permit has been revoked by the City.

13. This Otay Mesa Development Permit may be revoked by the City if there is a material breach or default in any of the conditions of this permit. May 05 04 09:40a \_\_\_\_\_\_Inc

14. Office use shall be permitted on this site in accordance with the Ordinance, provided adequate parking ratios exist for such uses.

15. Prior to the issuance of any building permits, the applicant shall grant an avigation easement over the entire site. The conditions of this easement shall be made satisfactory to the Deputy Director of the Airports Division of the General Services Department.

16. As a condition of approval for this project, the applicant must submit \$289.00 to the Metropolitan Transit Development Board for the Otay Mesa Transit Study.

17. As a final condition of approval for this project, the applicant must satisfy the San Diego Fire Department's requirements. Applicant must provide building address numbers visible and legible from street or road fronting property or a directory, and provide access in conformance with Fire Department Folicy A-85-3.

18. This Otay Mesa Development Permit is a covenant running with the lands and shall be binding upon the Permittee and any successor or successors, and the interests of any successor shall be subject to each and every condition set out.

Eassed and adopted by the Planning Director of the City of San liego on October 19, 1989.

### OTAY MESA DEVELOPMENT PERMIT NO. 92-0465 OTAY TRUCK STOP PLANNING DIRECTOR

This Otay Mesa Development Permit is granted by the Planning Director of the City of San Diego to VICTORIA GOMEZ Owner/Permittee, under conditions in Section 103.1100 of the Municipal Code of the City of San Diego.

1. Permission is hereby granted to Owner/Permittee, to construct a truck terminal and supporting facility located at 2222 Avenida Costa Del Sol, described as Lots 1 & 2, unit 2 of the De La Fuente Business Park, in the industrial Zone.

The Project shall consist of the following:

- a. Truck terminal and supporting facility of total
   3,933 square feet;
- b. Landscaping;
- c. Off-street Parking; and
- d. Incidental accessory uses as may be determined incidental and approved by the Planning Director.

3. Not fewer than 22 off-street parking spaces shall be maintained on the property in the approximate location shown on Exhibit "A," dated August 6, 1992, on file in the office of the Planning Department. Parking spaces shall be consistent with Division 8 of the Municipal Code and shall be permanently maintained and not converted for any other use. Parking spaces and aisles shall conform to Planning Department standards. Parking areas shall be marked.

4. Before issuance of any building permits, complete grading and building plans shall be submitted to the Planning Director for approval. Plans shall be in substantial conformity to Exhibit "A," dated August 6, 1992, on file in the office of the Planning Department. No change, modifications or alterations shall be made unless appropriate applications or amendment of this permit shall have been granted.

5. Before issuance of any grading or building permits, a complete landscape plan, including a permanent irrigation system, shall be submitted to the Planning Director for approval. Plans shall be in substantial conformity to Exhibit "A," dated August 6, 1992, on file in the office of the Planning Department. Approved plantings shall be installed before issuance of any occupancy permit on any building. Such plantings shall not be modified or altered unless this permit has been amended. . · · .

Page Z

6. Prior to the issuance of any building permits, the applicant shall assure the installation of fire hydrants at locations satisfactory to the Fire Department and to the City Engineer.

7. Prior to the issuance of any building permits, the applicant shall provide evidence to the Planning Department indicating that approval has been obtained from the Otay Water District for this development.

8. This Otay Mesa Development Permit must be used within 36 months after the date of City approval (August 6, 1995), or the permit shall be void. An Extension of Time may be granted as set forth in Section 101.0920 of the Municipal Code. Any extension of time shall be subject to all standards and criteria in effect at the time the extension is applied for.

9. Construction and operation of the approved use shall comply at all times with the regulations of this or any other governmental agencies.

10. After establishment of the project, the property shall not be used for any other purpose unless:

- a. Authorized by the Planning Director; or
- b. The proposed use meets every requirement of the zone existing for the property at the time of conversion; or
- c. The permit has been revoked by the City.

Passed and adopted by the Planning Director of the City of San Diego on August 6, 1992.



City of San Diego Development Services 1222 First Ave., MS-302 San Diego, CA 92101

# Community Planning Committee Distribution Form Part 2

Project Name:			Proj	ect N	umber:	Distribution Date:
BBP-Truck.Net Project No. 497545			497545			
Project Scope/Location: Conditional Use Permit for Truck Stop at Airway Ro	oad an	nd La Medi	a Roa	ıd		
Applicant Name:					Applicant P	hone Number:
Project Manager:	Pho	ne Numbe	r:	Fax	Number:	E-mail Address:
William Zounes	619	9 687 5942		(619	) 321-3200	wzounes@sandiego.gov
Committee Recommendations (To be completed for Initial Review):						
Vote to Approve		Members 10	s Yes	M	lembers No 0	Members Abstain 3 (Ted Shaw, Alejandra Mier y Teran & Diane Kirma)
Vote to Approve With Conditions Listed Below		Members	s Yes	M	lembers No	Members Abstain
Vote to Approve With Non-Binding Recommendations Listed Bell	low	Members	s Yes	M	lembers No	Members Abstain
<b>Vote to Deny</b>		Members	s Yes	N	lembers No	Members Abstain
<b>No Action (Please specify, e.g., Need further inf</b> quorum, etc.)	format	tion, Split v	vote,	Lack	of	Continued
CONDITIONS:			I I			
NAME: Rob Hixson & Ted Shaw					TITLE: PI	anning Group Chair and Vice Chair
SIGNATURE: Hitson					<b>DATE:</b> 10/2	29/2019
Attach Additional Pages If Necessary.		Please return Project Ma City of San Developme 1222 First A San Diego,	nagen Diege nt Ser Avenu	nent ] D vices le, M	Department S 302	
Printed on recycled paper. Visit o Upon request, this information is av						



**City of San Diego Development Services** 1222 First Ave., MS 302 San Diego, CA 92101 (619) 446-5000

# Ownership Disclosure Statement DS-318

October 2017

FORM

Approval Type: Check appropriate box for type of approval(s) requested: 🗆 Neighborhood Use Permit 🗅 Coastal Development Permit 🗆 Neighborhood Development Permit 🗅 Site Development Permit 🗅 Planned Development Permit 🖻 Conditional Use Permit 🗅 Variance □ Tentative Map □ Vesting Tentative Map □ Map Waiver □ Land Use Plan Amendment • □ Other \_ Project Title: Border Business Park - Truck Net Project No. 497545 Project No. For City Use Only: Project Address: 2222 - 2224 Avenida Costa Del Sol; 8470 - 8490 Avenida De La Fuente San Diego, CA 92154 Specify Form of Ownership/Legal Status (please check): Corporation 🛽 Limited Liability -or- 🗆 General - What State? California Corporate Identification No. 200112000006; 200524900003, 199706300032 Partnership 
Individual By signing the Ownership Disclosure Statement, the owner(s) acknowledge that an application for a permit, map or other matter will be filed with the City of San Diego on the subject property with the intent to record an encumbrance against the property. Please list below the owner(s), applicant(s), and other financially interested persons of the above referenced property. A financially interested party includes any individual, firm, co-partnership, joint venture, association, social club, fraternal organization, corporation, estate, trust, receiver or syndicate with a financial interest in the application. If the applicant includes a corporation or partnership, include the names, titles, addresses of all individuals owning more than 10% of the shares. If a publicly-owned corporation, include the names, titles, and addresses of the corporate officers. (A separate page may be attached if necessary.) If any person is a nonprofit organization or a trust, list the names and addresses of the corporate officers. (A separate page may be attached if necessary.) If any person is a nonprofit organization or a trust, list the names and addresses of <u>ANY</u> person serving as an officer or director of the nonprofit organization or as trustee or beneficiary of the nonprofit organization. A signature is required of at least one of the property owners. Attach additional pages if needed. Note: The applicant is responsible for notifying the Project Manager of any changes in ownership during the time the application is being processed or considered. Changes in ownership are to be given to the Project Manager at least thirty days prior to any public hearing on the subject property. Failure to provide accurate and current ownership information could result in a delay in the hearing process. **Property Owner** Name of Individual: Otay Mesa Property LP 🛛 🖾 Owner 🖓 Tenant/Lessee 🖓 Successor Agency Street Address: 5440 Morehouse Drive Suite 4000 City: San Diego \_\_\_\_\_ State: <u>CA</u>\_\_\_\_Zip: <u>92121</u> Phone No.: 858-623-9000 Fax No.: 858-623-9009 Email: dwick@natent.com David Wick, President of Date: 1/7/2020 Signature: G.P. 🛛 Yes 🗆 No Additional pages Attached: Applicant Name of Individual: Owner Tenant/Lessee Successor Agency Street Address: \_\_\_\_\_ \_\_\_\_\_\_ State: \_\_\_\_\_\_ Zip: \_\_\_\_\_ City: Phone No.: \_\_\_\_\_\_ Email: \_\_\_\_\_ \_\_\_\_\_ Date: \_\_\_\_ Signature: □ Yes □ No Additional pages Attached: Other Financially Interested Persons Owner Tenant/Lessee Successor Agency Name of Individual: Street Address: \_\_\_\_\_ State: Zip: City: \_\_\_\_ Fax No.: \_\_\_\_\_ Email: \_\_\_\_\_ Phone No.: \_\_\_\_ Signature: \_\_\_\_\_ Date: \_\_\_\_ 🛛 Yes Additional pages Attached: No

> Printed on recycled paper. Visit our web site at <u>www.sandiego.gov/development-services</u>. Upon request, this information is available in alternative formats for persons with disabilities.

Property Owner Name of Individual:   Otay Acquisitions LP	Xi Owner 🗖 Tenant/Lessee 🛄 Successor Agency
Street Address: 5440 Morehouse Drive Suite 4000	
City: San Diego	State: CA Zip: 92121
Phone No.: 858-623-9000 Fax No.: 858-623-9009	Email: dwick@natent.com
Signature:	Date: 1/07/2020
Additional pages Attached: X Yes 🛛 No Partner	
Applicant	
Name of Individual:	Owner      Tenant/Lessee     Successor Agency
Street Address:	
City: _	State: Zip:
Phone No.: Fax No.:	
	Date:
Additional pages Attached:	
Other Financially Interested Persons	
Name of Individual:	Owner      Tenant/Lessee     Corcessor Agency
Street Address:	
City: _	State: Zip:
Phone No.: Fax No.:	Email:
Signature:	Date:
Additional pages Attached:	
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PTIMIEU OU FECYCIEU DAPEL. VISIL OUL WED SILE AL WWW.SANDIEGO.GOV/DEVEIODMENT-SERVICES.

	;		
Property Owner			
Name of Individual:   Otay Truck Parking, LP		🕱 Owner 🛛 🗆 Tenant/Lessee	Successor Agency
Street Address: 5440 Morehouse Drive Suite 4000	4000		
City: San Diego		State: CA	Zip:92121
Phone No.: 858-62329000	Fax No.: 858-623-9009	Email: dwick@natent.com	
Signature:	David Wick, President of SD Commercial, Date: 1/07/2020	,Date: 1/07/2020	
Additional pages Attached: X Yes LLC, S	LLC, Sole Member of General Partner		
Applicant			
Name of Individual:		Owner Tenant/Lessee	Successor Agency
Street Address:			
City:		State:	Zip:
Phone No.:	Fax No.:	Email:	
Signature:		Date:	
Additional pages Attached:	O No		
Other Financially Interested Persons			
Name of Individual:		Owner Denant/Lessee	Successor Agency
Street Address:			
City:		State:	Zip:
Phone No.:	Fax No.:	Email:	
Signature:		Date:	
Additional pages Attached:	No		

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Successor Agency Successor Agency Successor Agency 92121 Zip: Zip: Zip: Email: dwick@natent.com Tenant/Lessee Tenant/Lessee X Tenant/Lessee CA State: State: State: Date: 1/07/2020 Owner Owner Owner Email: Email: Date: Date: David Wick, President of Member ) Fax No.: 858-623-9009 Fax No.: Fax No.: 5440 Morehouse Drive Suite 4000 ON D No No No Ves X Yes Ves **Other Financially Interested Persons** Name of Individual: Truck.Net LLC Phone No.: 858-623-9000 Additional pages Attached: Additional pages Attached: Additional pages Attached: Name of Individual: Name of Individual: City: San Diego Property Owner Street Address: Street Address: Signature: Street Address: Signature: - NAME Phone No.: Phone No.: Signature: Applicant City: City:

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# **ATTACHMENT 12**

### BORDER BUSINESS PARK – TRUCK.NET PROJECT NO. 497545

There are three record owners of the real estate which compose the Proposed Conditional Use Permit 1752903 – Otay Mesa Property LP, Otay Truck Parking, LP, and Otay Acquisitions LP.

### TRUCK.NET LLC

The owner and operator of the actual truck stop business is Truck.Net LLC. **Truck.Net LLC** is a California limited liability company, corporate identification number 101998327072.

There are two members in **Truck.Net LLC**. **R.K.R. DLFY LP**, is a California limited partnership which owns 99% interest in **Truck.Net LLC**. Its corporate identification number is 199814000038. One percent of **Truck.Net LLC** is owned by **SD Commercial**, **LLC**.

The General Partner and 1% owner of **R.K.R. DLFY LP** is **NEI Holdings, LLC**. There are 3 limited partners in **R.K.R. DLFY LP**, each of which owns 33% of the limited partnership. The partners are Jaime Marti Irturbide and Gary Triphan co-trustees for the Roque De La Fuente III 1995 Irrevocable Trust; Jaime Marti Irturbide and Gary Triphan co-trustees for the Katayoun De La Fuente Yazdani 1995 Irrevocable Trust; and Jaime Marti Irturbide and Gary Triphan co-trustees for the Katayoun De La Fuente Yazdani 1995 Irrevocable Trust; and Jaime Marti Irturbide and Gary Triphan co-trustees for the Ricardo De La Fuente Yazdani 1995 Irrevocable Trust.

**SD Commercial, LLC** is a California limited liability company which has two members. Its corporate identity is 101995010005. **National Enterprises, Inc.** owns 99% of **SD Commercial, LLC** and **International Property Enterprises, Inc.** owns 1%. The President of **SD Commercial, LLC** is David Wick.

National Enterprises, Inc. is a California corporation. Its corporate identity is 1550918. The President of National Enterprises, Inc. is David Wick. The following parties account for 95% of the stock ownership in National Enterprises, Inc: Jaime Marti Irturbide and Gary Triphan co-trustees for the Roque De La Fuente III 1995 Irrevocable Trust; Jaime Marti Irturbide and Gary Triphan co-trustees for the Katayoun De La Fuente Yazdani 1995 Irrevocable Trust; and Jaime Marti Irturbide and Gary Triphan co-trustees for the Katayoun the Ricardo De La Fuente Yazdani 1995 Irrevocable Trust.

**International Property Enterprises, Inc.** is a Nevada corporation. Its corporate identity is 7270-95. There are three shareholders in **International Property Enterprises, Inc.**, each of which own 1/3 of the company: Jaime Marti Irturbide and Gary Triphan co-trustees for the Roque De La Fuente III 1995 Irrevocable Trust; Jaime Marti Irturbide and Gary Triphan co-trustees for the Katayoun De La Fuente Yazdani 1995 Irrevocable Trust; and Jaime Marti Irturbide and Gary Triphan co-trustees for the Katayoun De La Fuente De La Fuente Stardo De La Fuente Yazdani 1995 Irrevocable Trust; and Jaime Marti Irturbide and Gary Triphan co-trustees for the Katayoun De La Fuente Stardo De La Fuente Yazdani 1995 Irrevocable Trust.

**NEI Holdings, LLC** is a Delaware limited liability company. Its corporation identity is LLC-4039059. It is sole member is **SD Commercial, LLC**.

### **Otay Mesa Property LP**

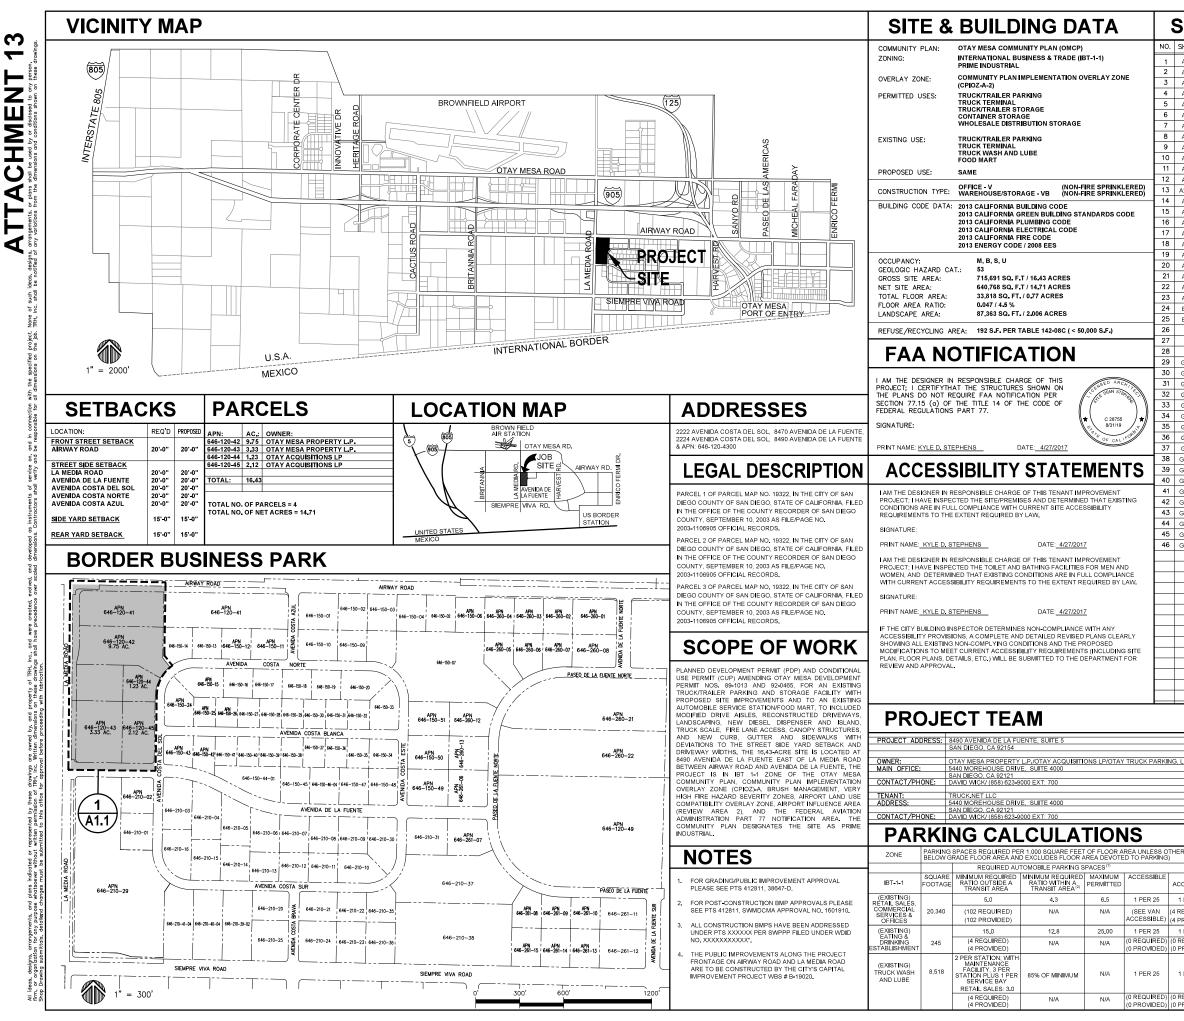
Otay Mesa Property LP is one of three real property owners. It is a California limited partnership. Its corporation identity is 200112000006. The general partner and 1% owner of Otay Mesa Property LP is SD Commercial, LLC. The remaining 99% owner of Otay Mesa Property LP is NEI Real Estate LLC, which is also the sole limited partner. NEI Real Estate LLC is a Nevada limited liability company. Its corporate identity is 3295-98. There are two managing members: National Enterprises, Inc. which owns 99% of NEI Real Estate LLC and SD Commercial, LLC which owns 1% of NEI Real Estate LLC.

### **Otay Truck Parking, LP**

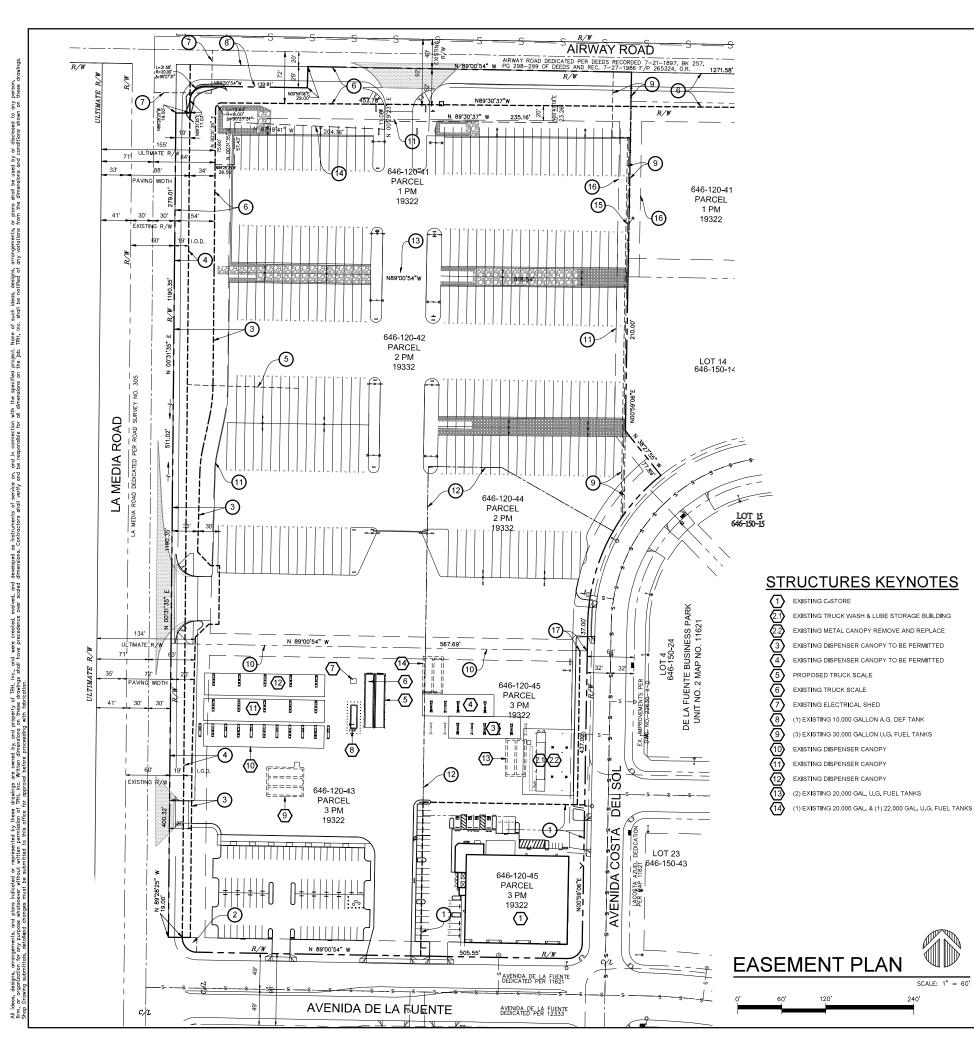
**Otay Truck Parking, LP** is the second of three real property owners. It is a California limited partnership. Its corporation identity is 200524900003. The general partner and 1% owner of **Otay Truck Parking, LP** is **NEI Holdings, LLC.** The limited partner and 99% owner of **Otay Truck Parking, LP** is **NEI REAL ESTATE LLC.** 

### **Otay Acquisitions LP**

**Otay Acquisitions LP** is the third of three real property owners. It is a California limited partnership. Its corporation identity is 199706300032. The general partner and 1% owner of **Otay Acquisitions LP** is **SD Commercial, LLC.** The remaining 99% owner of **Otay Acquisitions LP** is **NEI Real Estate LLC**, which is also the sole limited partner.



:11		דא	AT	'TAC	CHMENT 13
SHT.	SHEET TITLE - DES				l 1
A0.1	TITLE SHEET, VICINIT	Y & LOCATION MAP	S, DATA & NOTES		tra
A0.2	SITE EASEMENT PLAN				
A1.2	PARTIAL SITE PLAN, L		S		
A1.3 A1.4	PARTIAL SITE PLAN, L		S		1350 COLUMBIA ST. SUITE 702 SAN DIEGO, CA 92101
A2.1	FIRST FLOOR PLAN - 0		URE 1		TEL (619) 230-1088
A2.2 A2.3	MEZZANINE FLOOR PI			- 2	FAX (619) 230-1089 trhinc.com
A2.3	FLOOR & ROOF PLAN				
A2.5 A2.6	FLOOR PLANS - TRUC				CENSED ARCHITEC
A2.6.1	PROPOSED FLOOR PLAN				Che the the
A2.7 A2.8	ROOF PLAN - C-STOR			EC 10 11 8 10	C 28755 ★
A4.1	ROOF PLAN - DIESEL F ELEVATIONS - C-STOP		IOPIES-STRUCTUR	.23 10, 11 & 12	BI31/2021 Pre OF CAL IFORM
A4.2 A4.3	ELEVATIONS - C-STOP				OF CALIT
A4.3	ELEVATIONS - TRUCK			TURES 3 & 4	
A4.5	ELEVATIONS - ELECT				APPLICANT:
A4.6 A5.1	ELEVATIONS - DIESEL		NOPIES-STRUCTU	RES 10, 11 & 12	Truck.Net LLC
A5.2	SITE SIGNAGE PROFIL				
E1.1 E1.2	PARTIAL ELECTRICAL PARTIAL ELECTRICAL				
L1	LANDSCAPE TITLE SH	EET, KEYMAP, CAL	CULATIONS AND NO		5440 MOREHOUSE DR. #4000 SAN DIEGO, CA 92121
L2 L3	LANDSCAPE PLAN, PL LANDSCAPE PLAN, PL				PROJECT:
GP-1	IMPROVEMENT & GRA				
GP-2 GP-3	IMPROVEMENT & GRA STREET SECTIONS &				TRUCK NET
GP-4	GRADING PLAN KEY N				
GP-5					CUP
GP-6 GP-7	TOPOGRAPHIC PLANS SURFACING PLANS	>			8490 AVENIDA DE LA FUENTE
GP-8	SURFACING PLANS				SUITE 5
GP-9 GP-10	GRADING PLANS				SAN DIEGO, CA 92154
GP <b>-</b> 11	PRE-PROJECT DMA P				REVISION ITEM DATE
GP-12 GP-13	PRE-PROJECT DMA P POST DEVELOPMENT				A
GP-14	POST DEVELOPMENT				
GP-15 GP-16	STORMWATER NOTES				
GP-17	STORMWATER NOTES				
GP <b>-</b> 18	STORMWATER NOTES	& DETAILS FOR D	RAINAGE AREAS C	i	
					THIS SET ISSUE DATE
					PERMIT SUBMITTAL _6/27/16_
					■ FULL SUBMITTAL <u>7/20/16</u>
					■ RESUBMITTAL 1 <u>12/9/16</u>
					■ RESUBMITTAL 2 <u>4/27/17</u>
					■ RESUBMITTAL 3 <u>1/9/2018</u>
	CIVIL ENGINEER:	ALTA CONSUL	TANTS TREET, SUITE 109		■ RESUBMITTAL 5 <u>9/10/2019</u>
L.P.	ADDRESS: CONTACT/PHONE	EL CAJON, CA	92021 F / (858) 581-6101		■ RESUBMITTAL 6 <u>10/21/2019</u>
	DESIGNER:	TRH, INC.			SHEET TITLE / CONTENTS
	ADDRESS:	SAN DIEGO, C.			
	CONTACT/PHONE	: TOBY HALLAL	/ (619) 230-1088 EX	1:1#	TITLE SHEET,
					INDEX, VICINITY
					& LOCATION
RWISE	NOTED (FLOOR AREA	NCLUDES GROSS F	LOOR AREAS PLUS		MAPS, DATA,
					NOTES & INFO
VAN CESSIE	BLE CARPOOL / ZERO EMISSIONS VEHICLES	SHORT-TERM BICYCLE PARKING SPACES	LONG-TERM BICYCLE PARKING SPACES	MOTORCYCLE PARKING SPACES	
1 PER 2		5%	5%	2%	TRH PROJECT#: 248-13-CUP SCALE: AS NOTED
		(5 REQUIRED)	(5 REQUIRED)	(2 REQUIRED)	DRAWN BY: TRH
1 PER 2	,	(7 PROVIDED) 5%	(7 PROVIDED) 5%	(4 PROVIDED) 2%	ORIGINAL DATE: 1/4/2016
REQU <b>I</b> R PROV <b>I</b> D	ED) (0 REQUIRED)	(0 REQUIRED) (0 PROVIDED)	(0 REQUIRED) (0 PROVIDED)	(0 REQUIRED) (0 PROVIDED)	
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REQUIR	ED) (0 REQUIRED)	(0 REQUIRED)	(0 REQUIRED)	(0 REQUIRED)	A0.1
PROVID		(0 PROVIDED)	(0 PROVIDED)	(0 PROVIDED)	



### EASEMENT KEYNOTES

1	EXISTING AVIGATION EASEMENT GRAN 90-279997, O.R.
2	EXISTING EASEMENT FOR LANDSCAPE 2002-0357776, O.R.
3	EXISTING IOD PER DOC. NO.2015-060
4	EXISTING 19' IRREVOCABLE OFFER TO
5	EXISTING SAN DIEGO GAS & ELECTRIC
6	EXISTING IOD PER DOC. NO.2015-060
Ō	EXISTING EASEMENT FOR LANDSCAPE 2002-0357776, O.R.
8	PORTION OF AIRWAY ROAD AND LA M DOCUMENT NO. 2013-0099269, O.R.
9	EXISTING PACIFIC BELL EASEMENT PER
10	EXISTING PROPERTY LINE TO REMAIN
(1)	EXISTING BUILDING SETBACK LINE
12	EXISTING ASSESSOR'S LINE
13	EXISTING PROPERTY LINE TO BE ADJU
(14)	PROPOSED FLOOD WATER FLOWAGE A PER SD CITY DWG. 39412-B, STORM AGREEMENT APPROVAL NO. 1809117
(15)	PROPOSED PROPERTY LINE ADJUSTME
16	PROPOSED BUILDING SETBACK LINE P
17	EXISTING 10' SDG&E EASEMENT PER F

ITED TO THE CITY OF SAN DIEGO RECORDED MAY 22, 1990 FILE NO. AND SIGN MONUMENTATION RECORDED APRIL 29, 2002, AS FILE NO.

D1147 RECORDED 11/19/15, CITY OF SAN DIEGO DWG. NO. 39099-B DEDICATE PER PM 19332

C EASEMENT PER DEED REC. 10/26/48 IN BOOK 2996, PAGE 185, O.R. 01148 RECORDED 11/19/15, CITY OF SAN DIEGO DWG. NO. 39100-B AND SIGN MONUMENTATION RECORDED APRIL 29, 2002, AS FILE NO.

MEDIA ROAD DEDICATED PER DEED RECORDED FEBUARY 13, 2013 AS

ER DEED REC. 12/3/86 AS FILE/PAGE NO. 86-558001, O.R.

USTED PER LOT LINE ADJUSTMENT PARCEL MAP/PTS 525906 AND STORAGE EASEMENT PER DOC. NO. 2016- DATED WATER MANAGEMENT & DISCHARGE CONTROL MAINTENANCE

ENT PER LOT LINE ADJUSTMENT PARCEL MAP/PTS 525906 PER LOT LINE ADJUSTMENT PARCEL MAP/PTS 525906 FILE NO. B7-194667



**ATTACHMENT 13** 

1350 COLUMBIA ST. Suite 702 San Diego, ca 92101

TEL (619) 230-1088 FAX (619) 230-1089 trhinc.com



APPLICAN

# Truck.Net LLC

5440 MOREHOUSE DR. #4000 SAN DIEGO, CA 92121

PROJEC TRUCK.NET CUP

8490 AVENIDA DE LA FUENTE SUITE 5 SAN DIEGO, CA 92154

	1.			
		REVISION	ITEM	DATE
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ISSUE DATE

PERMIT SUBMITTAL 6/27/16

- FULL SUBMITTAL \_7/20/16
- RESUBMITTAL 1 12/9/16
- RESUBMITTAL 2 4/27/17
- RESUBMITTAL 3 1/9/2018
- RESUBMITTAL 4 12/3/2018
- RESUBMITTAL 5 9/10/2019
- RESUBMITTAL 6 10/21/2019

### SHEET TITLE / CONTENTS EASEMENT PLAN

TRH PROJECT#: 248-13-CUP SCALE: DRAWN BY: ORIGINAL DATE: 1/4/2016 CHECKED BY:

AS NOTED TRH

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SHEET: 2

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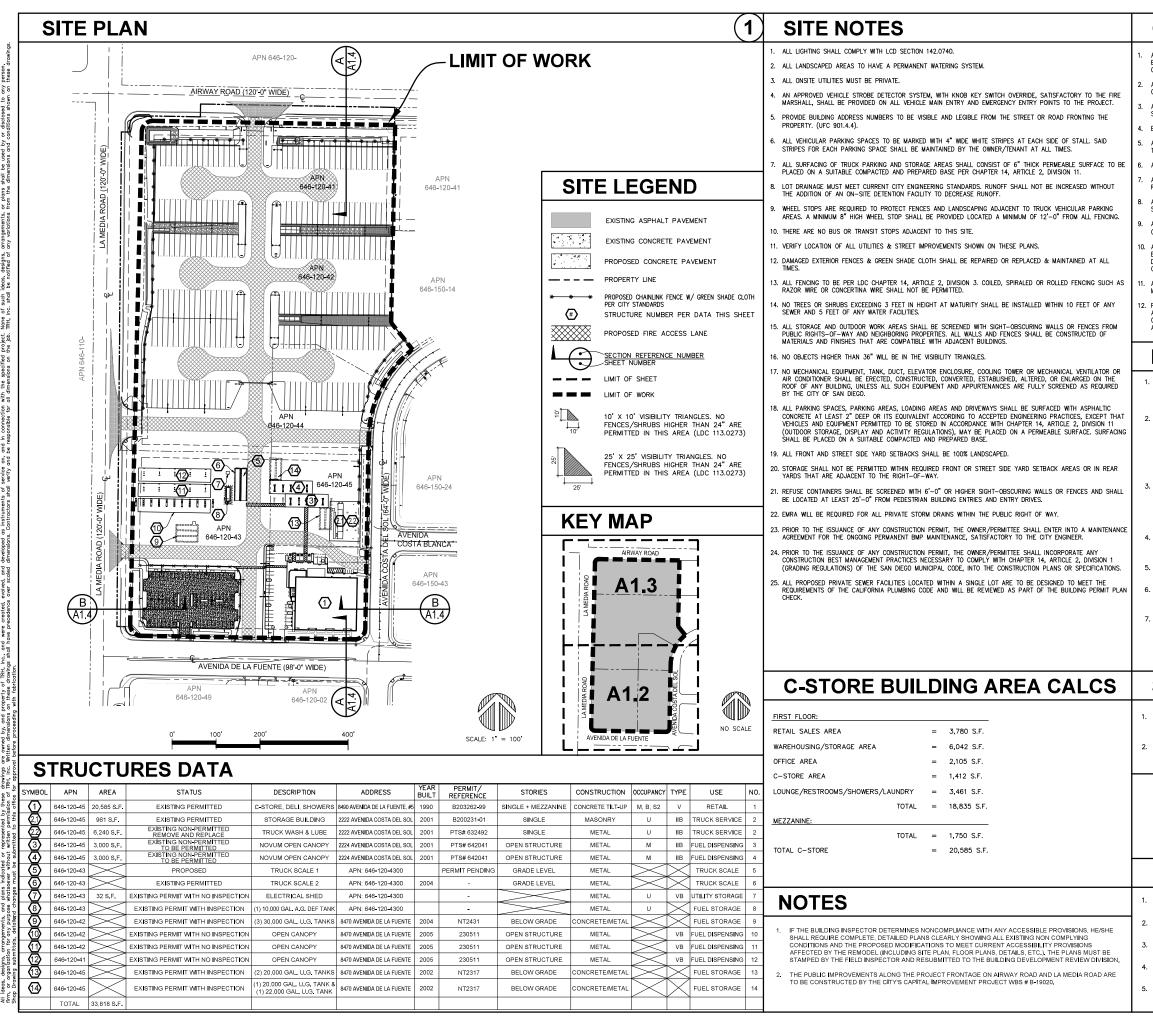
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NOTE: EASEMENTS PLOTTED HEREON ARE FROM TITLE REPORTS PREPARED BY CHICAGO TITLE COMPANY ORDER NUMBERS 12206312-996-SD1 AND 12206313-996-SD1 BOTH DATED OCTOBER 5, 2015



# COMPLIANCE NOTES ACHMENT 13

ALL PROPANE STORAGE TANKS SHALL BE ANCHORED TO THE GROUND AS REQUIRED BY THE CITY OF SAN DIEGO. ALL EXISTING ELECTRICAL CONDUCTORS SHALL BE CORRECTED AND INSTALLED AS REQUIRED PER THE CURRENT CODE

ALL HAZARDOUS MATERIAL SHALL BE DISPOSED OF SAFELY BY AN APPROVED

ALL EXPOSED ELECTRICAL CONDUCTORS SHALL BE CORRECTED AS NECESSARY AND SAFELY PROTECTED TO MEET THE CURRENT CODE.

EMERGENCY VEHICLE ACCESS SHALL BE PROVIDED AT ALL TIMES.

ALL ELECTRICAL WIRING AND INSTALLATIONS SHALL BE INSTALLED AS REQUIRED BY THE CITY OF SAN DIEGO.

ALL PUBLIC SEWER SERVICE SHALL BE INSTALLED PER CITY STANDARDS.

ALL PUBLIC POTABLE SERVICE SHALL BE INSTALLED PER CITY STANDARDS AND AS REQUIRED BY THE OTAY WATER DISTRICT.

ALL ACCESSIBLE PATHS OF TRAVEL AND EMERGENCY FIRE ACCESS TURNAROUNDS SHALL BE INSTALLED AS REQUIRED BY THE CITY OF SAN DIEGO FIRE DEPARTMENT.

ALL BUILDING ADDRESS NUMBERS SHALL BE VISIBLE AND LEGIBLE FROM THE STREET OR ROAD FRONTING THE PROPERTY PER FHPS POLICY P-00-6 (UFC 901.4.4).

ALL SITE DRAINAGE SHALL BE DESIGNED AND APPROVED BY THE CITY OF SAN DIEGO ENGINEERING DEPARTMENT TO PREVENT IMPROPER DISCHARGE OF UNCONTROLLED DRAINAGE. ALL FILL AND IMPORTED MATERIAL SHALL BE PROPERLY ENGINEERED AND COMPACTED

ALL STORMWATER DISCHARGE SHALL BE PROPERLY DESIGNED AND CONSTRUCTED TO MEET CURRENT CITY STANDARDS AND APPLICABLE CODES.

TIRE ACCESS KUAUS ARE TO BE MAINTAINED THROUGHOUT THE SITE IN ACCORDANCE WITH BFLS POLICY A-96-1 AND UFC 902. ANY RECONFIGURATION OF VEHICLE STORAGE SPACES WILL REQUIRE FIRE DEPARTMENT REVIEW AND APPROVAL.

# **BMP NOTES**

- THIS PROJECT SHALL COMPLY WITH ALL REQUIREMENTS OF THE STATE PERMIT; CALIFORNIA REGIONAL WATER QUALITY CONTROL BOARD, SAN DIEGO REGION, CURRENT ORDER, AND THE CITY OF SAN DIEGO LAND DEVELOPMENT CODE.
- SUFFICIENT BMPS MUST BE INSTALLED TO PREVENT SLT, MUD OR OTHER CONSTRUCTION DEBRIS FROM BEING TRACKED INTO THE ADJACENT STREET(S) OR STORM WATER CONVEYACE SYSTEMS DUE TO CONSTRUCTION VEHICLES OR ANY OTHER CONSTRUCTION ACTIVITY. THE CONTRACTOR SHALL BE RESPONSIBLE FOR CLEANING ANY SUCH DEBRIS THAT MAY BE IN THE STREET AT THE END OF EACH WORK DAY OR AFTER A STORM EVENT THAT CAUSES A PPEGOLY THE INSTALLED CONSTRUCTION DWPS. BREECH IN THE INSTALLED CONSTRUCTION BMPS
- ALL STOCK PILES OF UNCOMPACTED SOIL AND/OR BUILDING MATERIALS THAT ARE INTENDED TO BE LEFT UNPROTECTED FOR A PERIOD GREATER THAN SEVEN CALENDAR DAYS ARE TO BE PROVIDED WITH EROSION AND SEDIMENT CONTROLS. SUCH SOIL MUST BE PROTECTED EACH DAY WHEN THE PROBABILITY OF RAIN IS 40% OR GREATER.
- A CONCRETE WASHOUT SHALL BE PROVIDED ON ALL PROJECTS. WHICH PROPOSE THE CONSTRUCTION OF ANY CONCRETE IMPROVEMENTS THAT ARE TO BE POURED IN PLACE ON THE SITE.
- 5. ALL EROSION/SEDIMENT CONTROL DEVICES SHALL BE MAINTAINED IN WORKING ORDER AT ALL TIMES.
- ALL SLOPES THAT ARE CREATED OR DISTURBED BY CONSTRUCTION ACTIVITY MUST BE PROTECTED AGAINST EROSION AND SEDIMENT TRANSPORT AT ALL TIMES.
- THE STORAGE OF ALL CONSTRUCTION MATERIALS AND EQUIPMENT MUST BE PROTECTED AGAINST ANY POTENTIAL RELEASE OF POLLUTANTS INTO THE ENVIRONMENT.

# STRUCTURAL NOTES

ALL EXTERIOR WALLS OF ALL EXISTING BUILDINGS SHALL HAVE A FIRE RATING OF NOT LESS THAN THAT SPECIFIED IN CBC TABLE 602. [CBC 602.1]

. ALL EXISTING BUILDING EXTERIOR WALL CONSTRUCTION, PROJECTIONS AND OPENING PROTECTION SHALL COMPLY WITH CBC SECTION 705.

# LANDSCAPE NOTES

THIS PROJECT SHALL INCLUDE STREET TREES WITHIN ALL PUBLIC ROVEMENTS PER 142.0610(a).

THIS PROJECT SHALL PROVIDE THE REQUIRED 25 PERCENT LANDSCAPING OF THE STREET YARD PER TABLE 142-04C.

THIS PROJECT SHALL COMPLY WITH CPIOZ-A DESIGN GUIDELINES FOR INDUSTRIAL DEVELOPMENT.

. ALL FENCING, SCREENING, LANDSCAPING AND SIGNAGE SHALL BE DONE IN ACCORDANCE WITH CITY REGULATIONS.

. NO TREES OR SHRUBS EXCEEDING 3 FEET IN HEIGHT AT MATURITY SHALL BE INSTALLED WITHIN 10 FEET OF ANY SEWER AND 5 FEET OF ANY WATER FACILITES.



350 COLUMBIA ST. UITE 702 AN DIEGO, CA 92101

TEL (619) 230-1088 FAX (619) 230-1089 trhinc com



# Truck.Net LLC

5440 MOREHOUSE DR. #4000 SAN DIEGO, CA 92121

# ROJEC TRUCK.NET CUP

8490 AVENIDA DE LA FUENTE SUITE 5 SAN DIEGO, CA 92154

REVISION	ITEM	DATE
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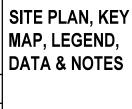
THIS SET

ISSUE DATE

□ DESIGN DEVEL. PERMIT SUBMITTAL \_6/27/16

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- RESUBMITTAL 3 1/9/2018
- RESUBMITTAL 4 12/3/2018
- RESUBMITTAL 5 9/10/2019
- RESUBMITTAL 6 <u>10/21/2019</u>

### SHEET TITLE / CONTENTS



**A1.**1

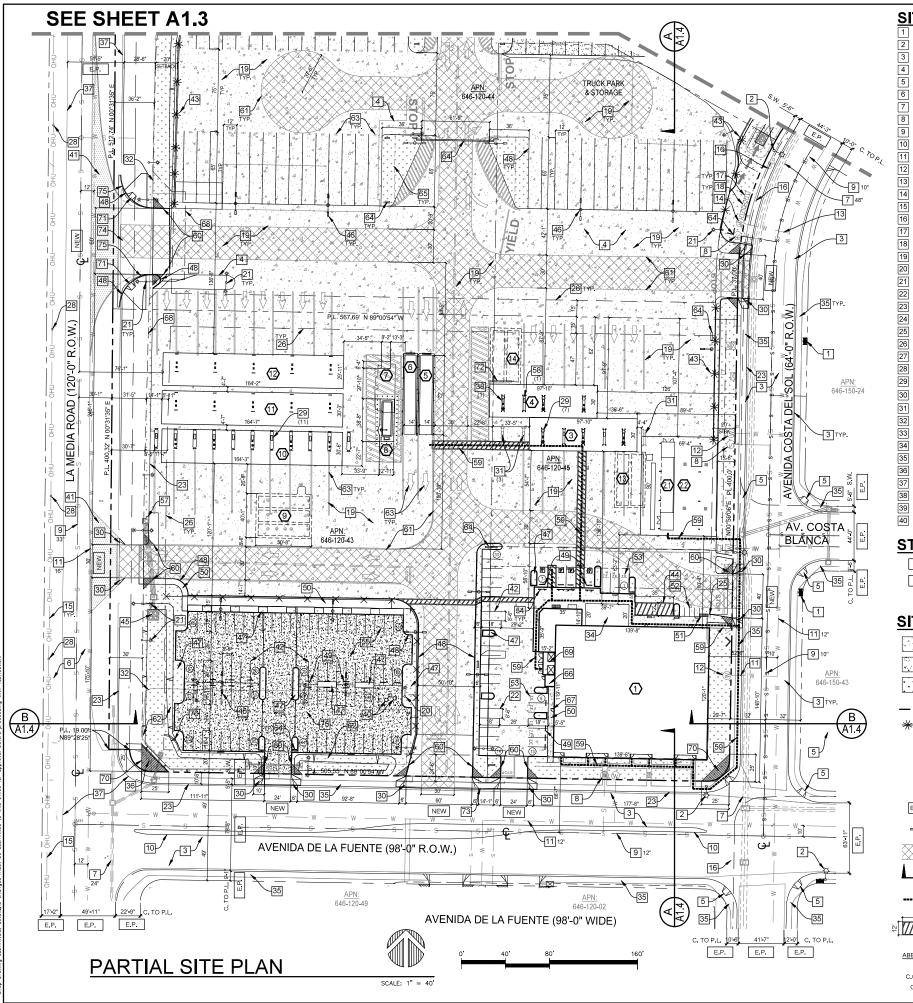
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### SITE KEYNOTES



A1.2

40 EXISTING PERMITTED PROPANE TANKS TO REMAIN

E.P. NEW

# SITE LEGEND

4	EXISTING CONCRETE PAVEMENT TO REMAIN
	PROPOSED CONCRETE PAVEMENT
· · · · · · · ·	PROPOSED LANDSCAPING PER LANDSCAPING PLAN
	PROPERTY LINE
* *	PROPOSED CHAINLINK FENCE W/ GREEN SHADE CLOTH PER CITY STANDARDS
###	SITE KEYNOTE SYMBOL THIS SHEET
(#)	STRUCTURE NUMBER SYMBOL PER STRUCTURE DATA SHEET A1.1
(#)	VEHICULAR PARKING SPACE SYMBOL
#	TRUCK PARKING SPACE SURFACE PAINTED NUMBER
E	STREET IMPROVEMENTS KEYNOTE SYMBOL THIS SHEET
	29'0" HIGH LIGHT POLE & FIXTURE, PER CITY STANDARDS
	PROPOSED FIRE ACCESS LANE
$\Box$	SECTION REFERENCE NUMBER
35'	ACCESSIBLE PATH OF TRAVEL NOT TO EXCEED 2% SLOPE IN ALL DIRECTIONS
	PROPOSED LOADING ZONE
ABBREVIATION S.W.	<u>⊴S:</u> = SIDEWALK
5.W. C.C. & D.W.	= SIDEWALK = CURB CUT & DRIVE-WAY
C. TO P.L.	= CURB TO PROPERTY LINE

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OF: 46

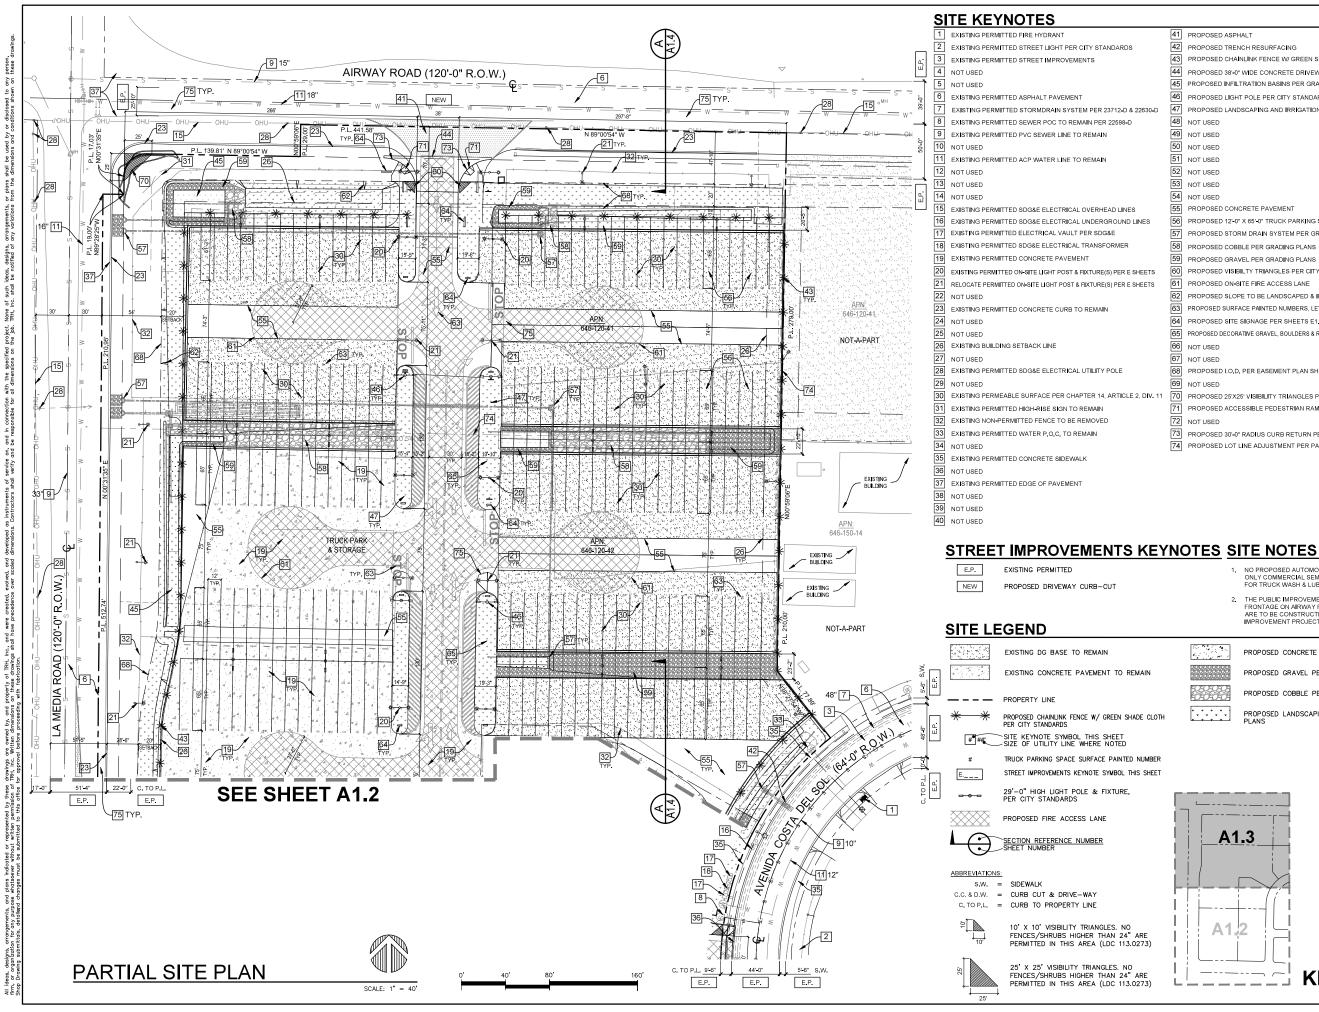
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**KEY MAP** 



		<b>HMENT 13</b>
	ATTAC	писут тэ
41	PROPOSED ASPHALT	
42	PROPOSED TRENCH RESURFACING	
43	PROPOSED CHAINLINK FENCE W/ GREEN SHADE CLOTH	trn
44	PROPOSED 38-0" WIDE CONCRETE DRIVEWAY PER CITY STANDARDS	
45	PROPOSED INFILTRATION BASINS PER GRADING PLANS	
46	PROPOSED LIGHT POLE PER CITY STANDARDS AND KEY LEGEND	1350 COLUMBIA ST.
47	PROPOSED LANDSCAPING AND IRRIGATION PER LANDSCAPE SHEETS	SUITE 702 San Diego, ca 92101
48	NOT USED	TEL (619) 230-1088 FAX (619) 230-1089
49	NOT USED	trhinc.com
50	NOT USED	
51	NOT USED	SED ARCH
52	NOT USED	LOF E DEAN STEPLE
53	NOT USED	4° %
54	NOT USED	C 28755
55	PROPOSED CONCRETE PAVEMENT	B/31/2021
56	PROPOSED 12'-0" X 65'-0" TRUCK PARKING SPACE	FIE OF CALIFOR
57	PROPOSED STORM DRAIN SYSTEM PER GRADING PLANS	
58	PROPOSED COBBLE PER GRADING PLANS	
59	PROPOSED GRAVEL PER GRADING PLANS	APPLICANT:
60	PROPOSED VISIBILTY TRIANGLES PER CITY STANDARDS (LDC 113.0273)	Twisk Natio
61	PROPOSED ON-SITE FIRE ACCESS LANE	Truck.Net LLC
62	PROPOSED SLOPE TO BE LANDSCAPED & IRRIGATED	
63	PROPOSED SURFACE PAINTED NUMBERS, LETTERS, STRIPES, & SYMBOLS	
64	PROPOSED SITE SIGNAGE PER SHEETS E1.1 & E1.2	5440 MOREHOUSE DR. #4000
65	PROPOSED DECORATIVE GRAVEL, BOULDERS & RIVER ROCK TO REPLACE GRASS	SAN DIEGO, CA 92121
66	NOT USED	PROJECT:
67	NOT USED	
68	PROPOSED I.O.D. PER EASEMENT PLAN SHEET A0.2	TRUCK NET
69	NOT USED	
70	PROPOSED 25'X25' VISIBILITY TRIANGLES PER CITY STANDARDS	CUP
71	PROPOSED ACCESSIBLE PEDESTRIAN RAMP	
72	NOT USED	8490 AVENIDA DE LA FUENTE
73	PROPOSED 30'-0" RADIUS CURB RETURN PER CITY STANDARDS	SUITE 5



# ruck.Net LLC

# RUCK.NET CUP

90 AVENIDA DE LA FUENTE JITE 5 SAN DIEGO, CA 92154

REVISION	ITEM	DATE
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- RESUBMITTAL 6 <u>10/21/2019</u>

### SHEET TITLE / CONTENTS

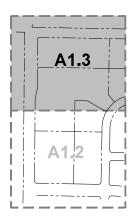


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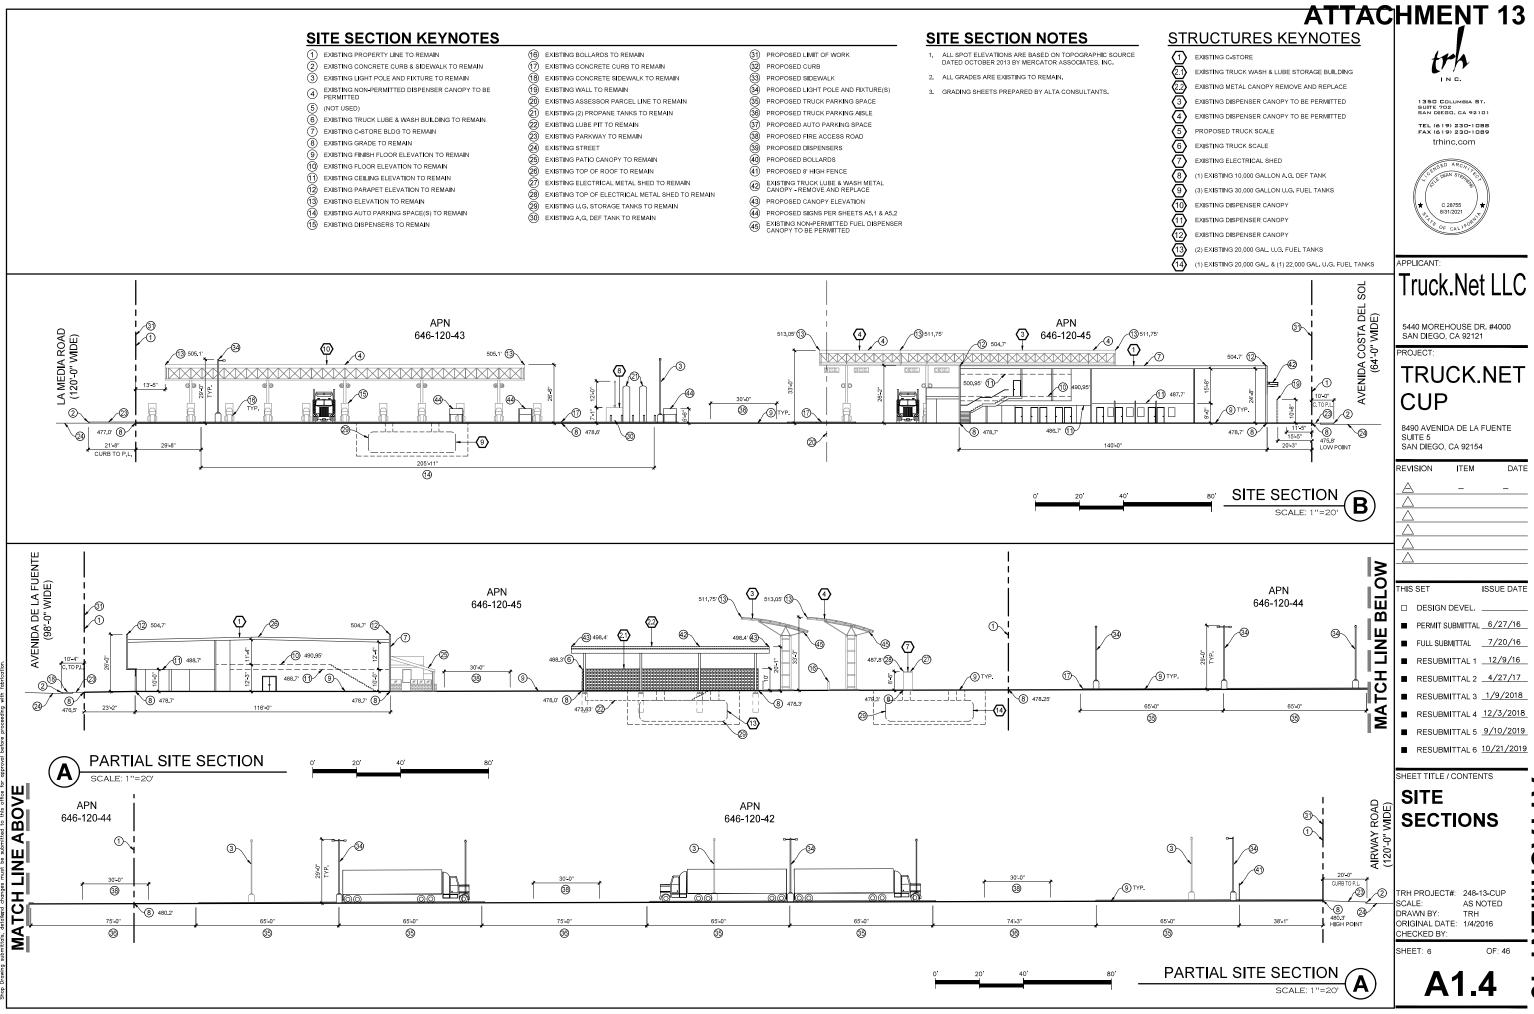
- 1. NO PROPOSED AUTOMOBILE SERVICE STATIONS, ONLY COMMERCIAL SEMI TRUCK SERVICE STATION FOR TRUCK WASH & LUBE.
- 2 THE PUBLIC IMPROVEMENTS ALONG THE PROJECT FRONTAGE ON ARWAY ROAD AND LA MEDIA ROAD ARE TO BE CONSTRUCTED BY THE CITY'S CAPITAL IMPROVEMENT PROJECT WBS # B-19020.

1	PROPOSED CONCRETE PAVEMENT
	PROPOSED GRAVEL PER GRADING PLANS
	PROPOSED COBBLE PER GRADING PLANS
$\begin{array}{c} \bullet & \bullet & \bullet \\ \bullet & \bullet & \bullet \\ \bullet & \bullet & \bullet & \bullet \\ \bullet & \bullet &$	PROPOSED LANDSCAPING PER LANDSCAPING PLANS

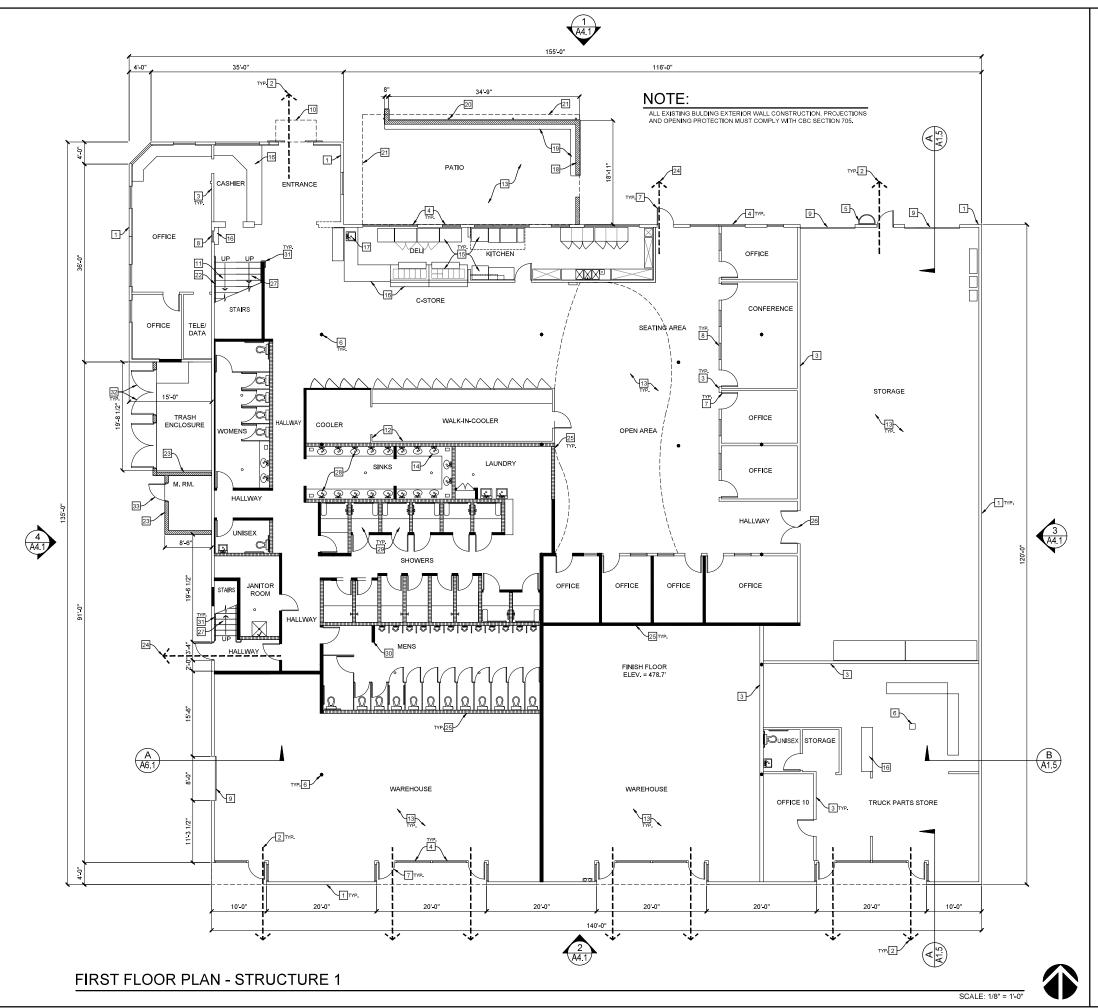
74 PROPOSED LOT LINE ADJUSTMENT PER PARCEL MAP PTS 525906







TACHME Z ω



# FLOOR PLAN KEYNOTES ATTAC HMENT 13

- 1 EXISTING CONCRETE TILT-UP WALL PER LEGEND BELOW EXISTING ACCESSIBLE PATH OF TRAVEL EXISTING INTERIOR WALL EXISTING STOREFRONT WINDOW EXISTING ROOF ACCESS LADDER EXISTING INTERIOR BUILDING STRUCTURAL COLUMN EXISTING DOOR EXISTING INTERIOR WINDOW 9 EXISTING ROLL-UP DOOR EXISTING ENTRANCE CANOPY ABOVE EXISTING INTERIOR STAIRS EXISTING COOLER WALLS EXISTING CONCRETE FLOOR 14 EXISTING SINKS EXISTING KITCHEN EQUIPMEN EXISTING COUNTER EXISTING HAND SINK EXISTING PATIO COUNTER EXISTING PATIO CANOPY STEEL COLUMN EXISTING PATIO CANOPY ABOVE EXISTING RAILING PROPOSED EXTERIOR WALL PROPOSED ACCESSIBLE PATH OF TRAVEL PROPOSED INTERIOR WALL PROPOSED INTERIOR DOOR PROPOSED INTERIOR STAIRS PROPOSED SINKS & COUNTERTOPS PROPOSED SHOWERS PROPOSED 5'-0" HIGH PARTITION WALL PROPOSED INTERIOR RAILING PROPOSED TRASH ENCLOSURE DOORS
- PROPOSED EXTERIOR DOOR TO MATCH EXISTING

### FLOOR PLAN LEGEND

	EXISTING EXTERIOR CONCRETE PANEL WALL TO HAVE A MINIMUM FIRE PROTECTION RATING OF NOT LESS THAN SPECIFIED IN CBC TABLE 602
	EXISTING INTERIOR WALL
	EXISTING MASONRY WALL
	NEW 1 HR. RATED WALL W/ METAL STUDS @ 16" O.C. W/ 5/8" GYP. ON BOTH SIDES
	NEW 7" PLUMBING WALL @ 16" O.C. W/ 5/8" GYPSUM BOARD ON BOTH SIDES - TAPE, MUD, SAND, PRIMER AND PAINT. (COLOR BY OWNER)
	ACCESSIBLE PATH OF TRAVEL NOT TO EXCEED 2% SLOPE IN ALL DIRECTIONS
	NEW EXTERIOR WALL TO MATCH EXISTING WALL & FIRE RATING
#	KEY NOTE SYMBOL
	SECTION REFERENCE NUMBER
	EXTERIOR ELEVATION REFERENCE NUMBER
<u>+</u> +	DIMENSION TO FACE OR CENTER OF STUD, COLUMN OR WALL



1350 COLUMBIA ST. SUITE 702 SAN DIEGO, CA 92101

TEL (619) 230-1088 FAX (619) 230-1089 trhinc.com



APPI ICANT

# Truck.Net LLC

5440 MOREHOUSE DR. #4000 SAN DIEGO, CA 92121

# PROJECT TRUCK.NET CUP

8490 AVENIDA DE LA FUENTE SUITE 5 SAN DIEGO, CA 92154

REVISION	ITEM	DATE
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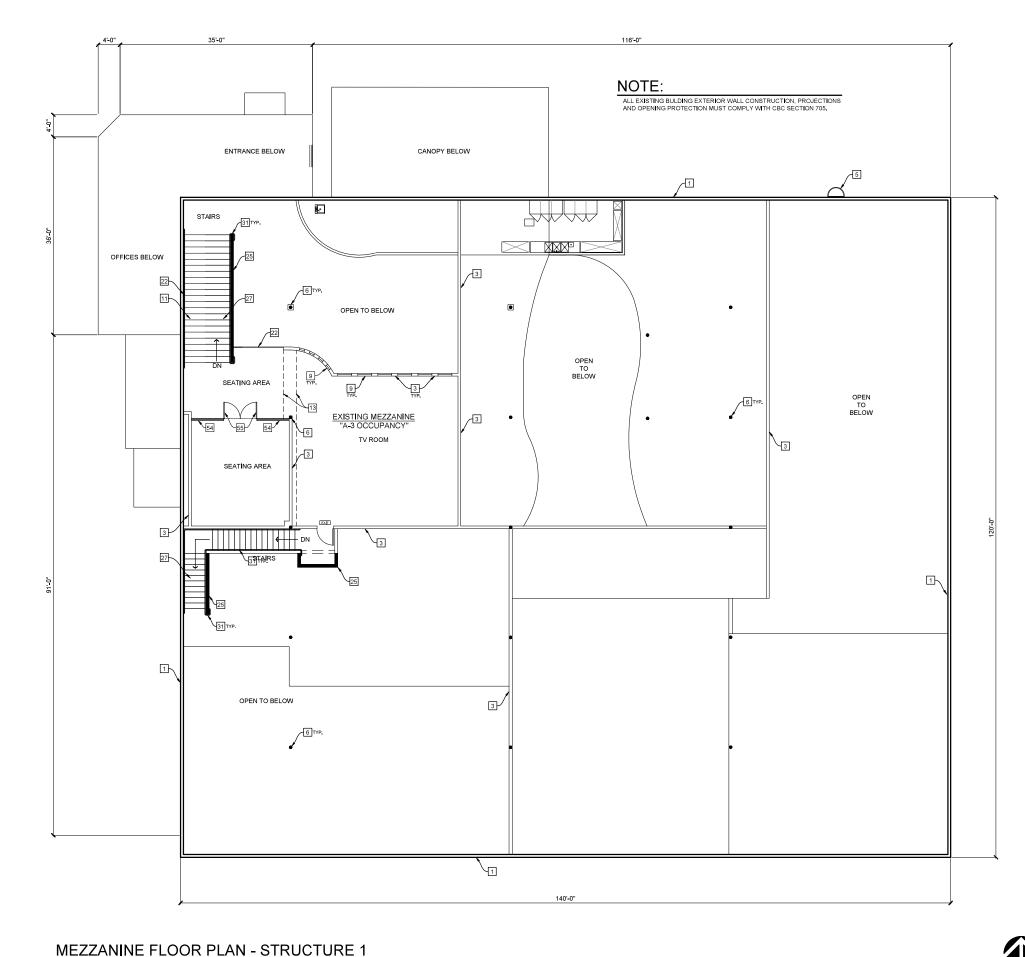
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### SHEET TITLE / CONTENTS





represented by three drawings are owned by, and property of TRH, Inc., and were created, evolved, and developed as instruments of service on, and in connection with the specified project. None of such ideas, designs, arrangements, or plans shall be used by or disclosed to any pers wither the mission of the missions with the drawings shall have precedence over scaled dimensions. Contractors shall werty and be responsible for all dimensions on the poly. TRH, Inc. shall be notified or any variations from the dimensions and conditions shown on these mission in the mission of the mission with the drawings shall have precedence over scaled dimensions. Contractors shall werty and be responsible for all dimensions on the poly. TRH, Inc. shall be notified of any variations from the dimensions and conditions shown on these

SCALE: 1/8"=1'-0"

# FLOOR PLAN KEYNOTES ATTAC HMENT 13

1 EXISTING CONCRETE TILT-UP WALL PER LEGEND BELOW EXISTING ACCESSIBLE PATH OF TRAVEL EXISTING INTERIOR WALL EXISTING STOREFRONT WINDOW EXISTING ROOF ACCESS LADDER EXISTING INTERIOR BUILDING STRUCTURAL COLUMN EXISTING DOOR EXISTING INTERIOR WINDOW EXISTING ROLL-UP DOOR EXISTING ENTRANCE CANOPY ABOVE EXISTING INTERIOR STAIRS EXISTING COOLER WALLS EXISTING CONCRETE FLOOR EXISTING SINKS EXISTING KITCHEN EQUIPMENT EXISTING COUNTER EXISTING HAND SINK EXISTING PATIO WALL EXISTING PATIO COUNTER EXISTING PATIO CANOPY STEEL COLUMN EXISTING PATIO CANOPY ABOVE EXISTING RAILING PROPOSED EXTERIOR WALL PROPOSED ACCESSIBLE PATH OF TRAVEL PROPOSED INTERIOR WALL PROPOSED INTERIOR DOOR PROPOSED INTERIOR STAIRS PROPOSED SINKS & COUNTERTOPS PROPOSED SHOWERS PROPOSED 5'-0" HIGH PARTITION WALL PROPOSED INTERIOR RAILING PROPOSED TRASH ENCLOSURE DOORS PROPOSED EXTERIOR DOOR TO MATCH EXISTING

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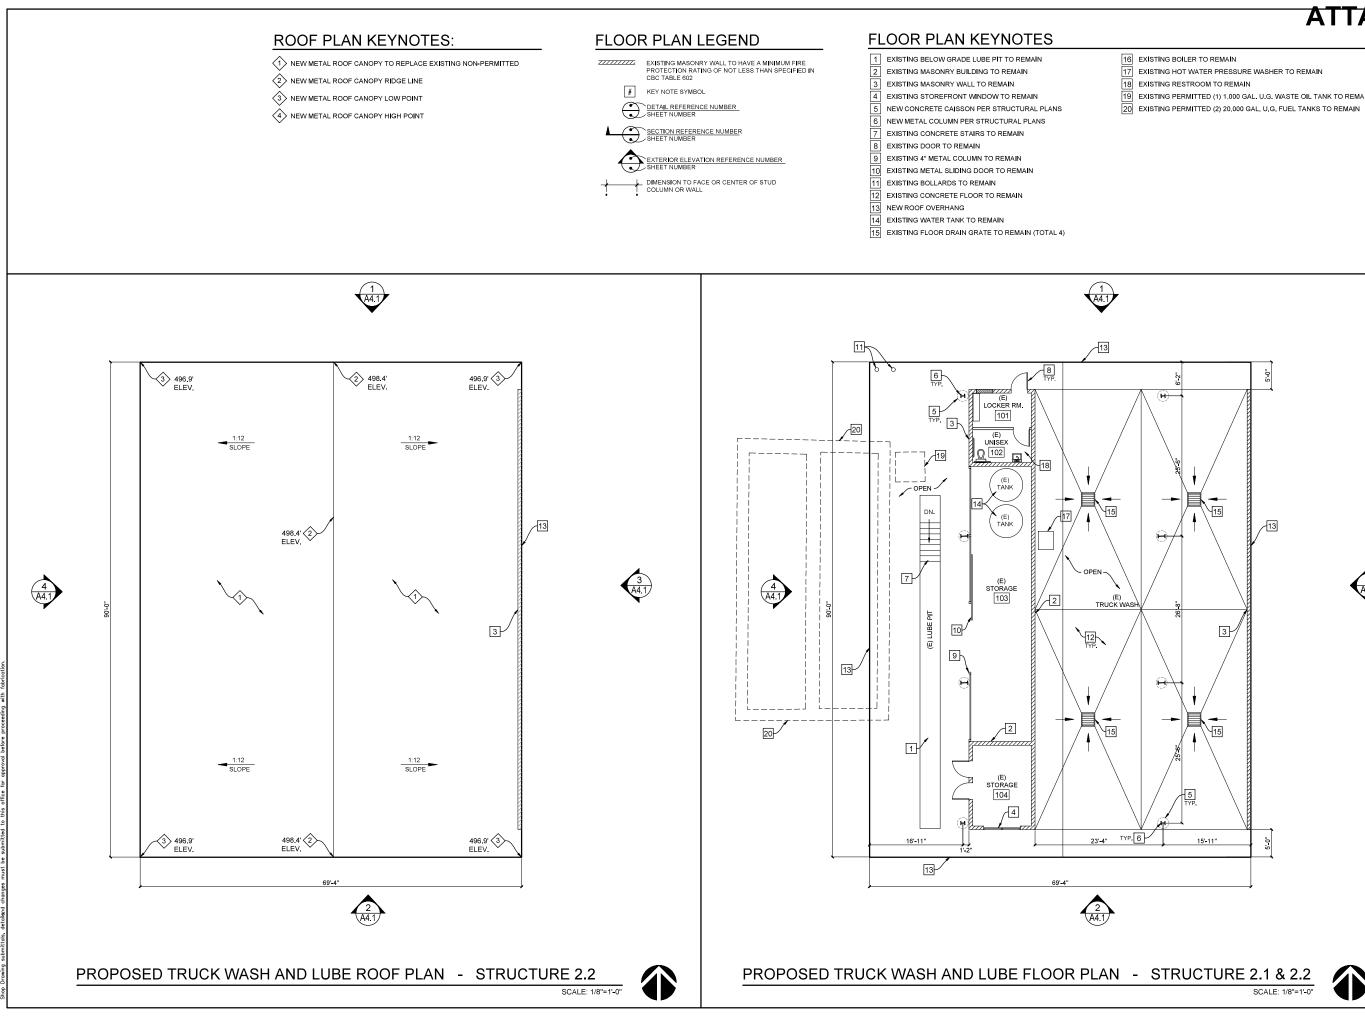
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- EXISTING PERMITTED (1) 1,000 GAL. U.G. WASTE OIL TANK TO REMAIN



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LEGEND & KEYNOTES **>** (STRUCTURE 2.2) TRH PROJECT#: 248-13-CUP AS NOTED

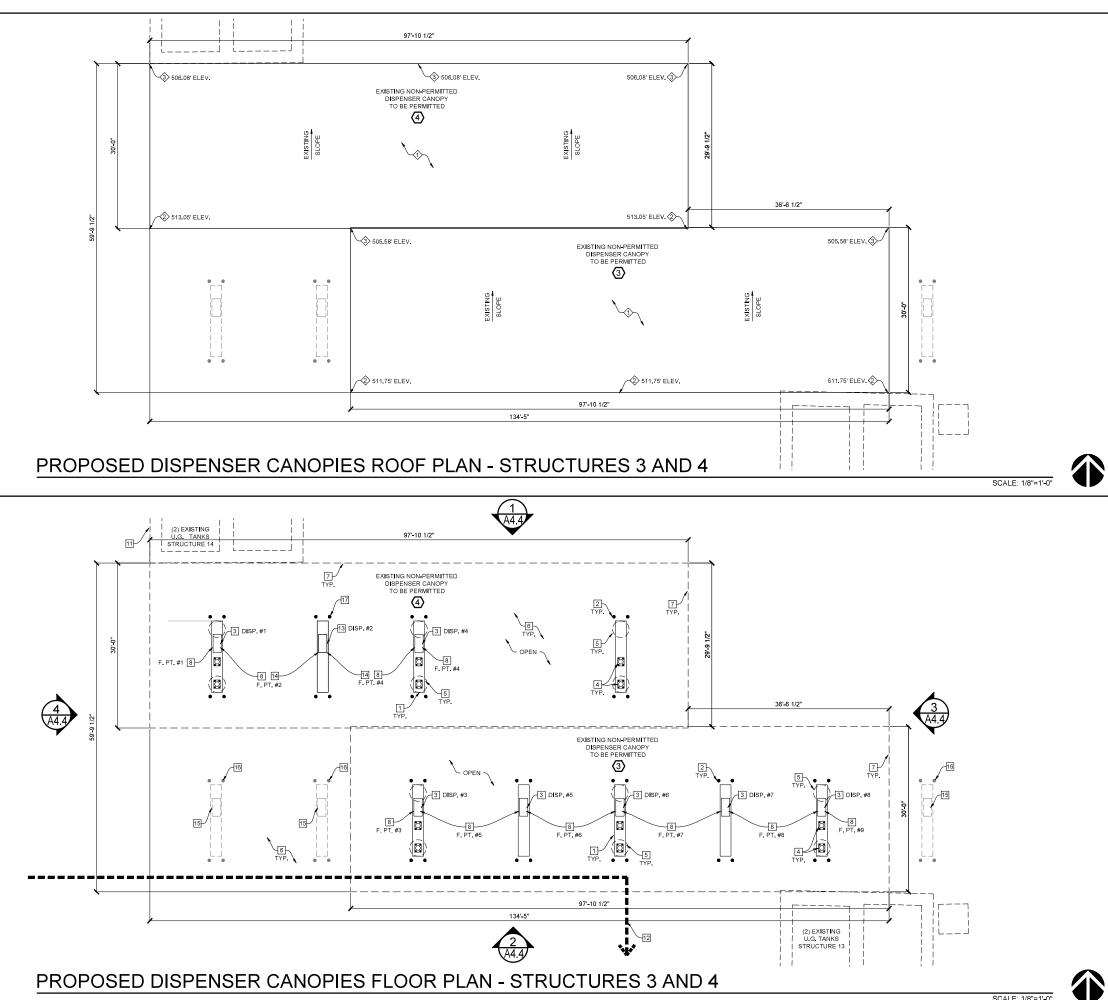
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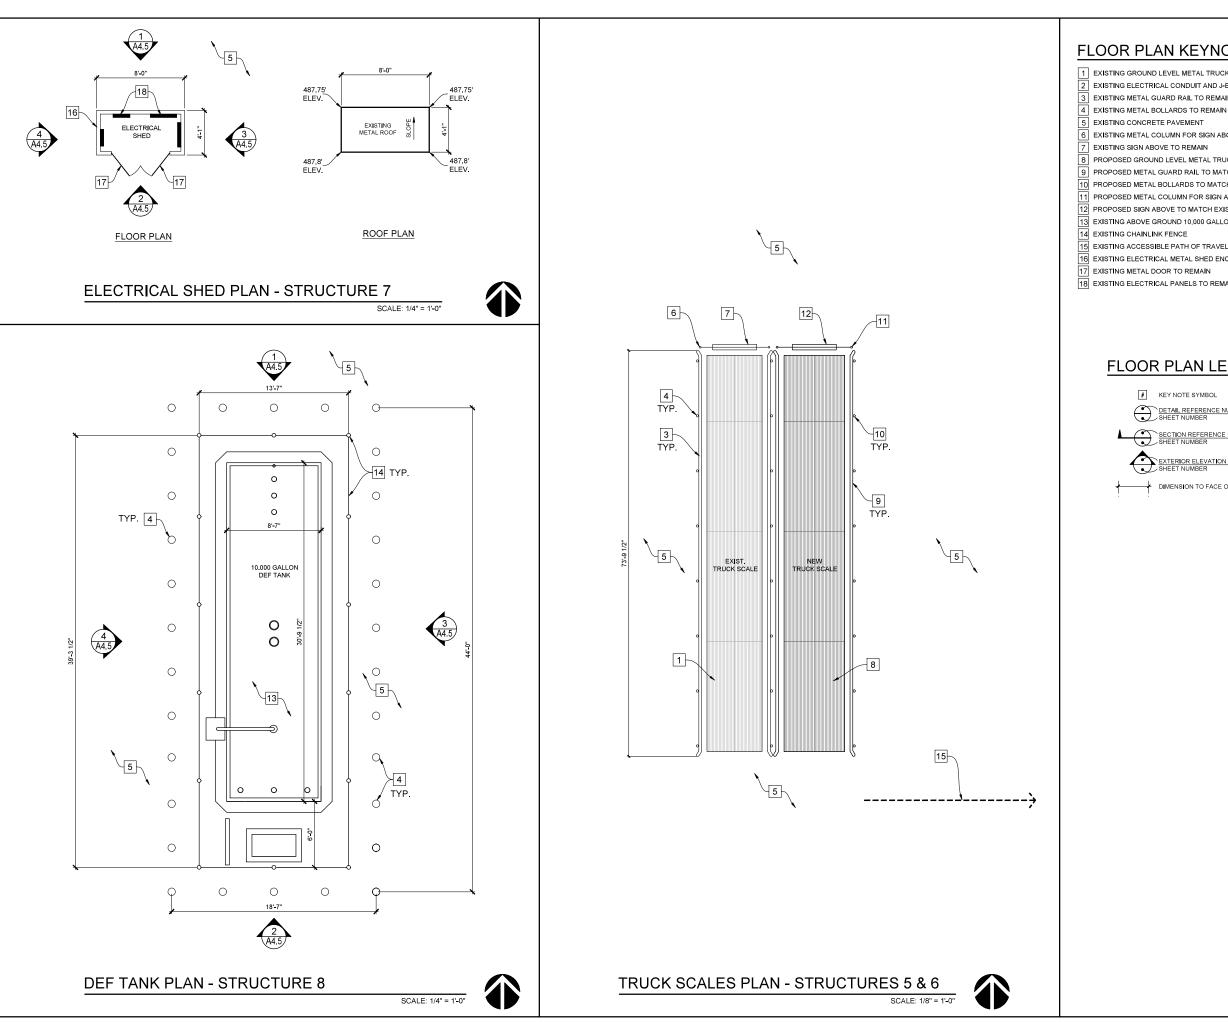


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# FLOOR PLAN KEYNOTES

- 1 EXISTING GROUND LEVEL METAL TRUCK SCALE TO REMAIN
- 2 EXISTING ELECTRICAL CONDUIT AND J-BOX TO CONFORM TO CURRENT CODE
- EXISTING METAL GUARD RAIL TO REMAIN
- EXISTING METAL COLUMN FOR SIGN ABOVE TO REMAIN
- EXISTING SIGN ABOVE TO REMAIN
- PROPOSED GROUND LEVEL METAL TRUCK SCALE TO MATCH EXISTING
- PROPOSED METAL GUARD RAIL TO MATCH EXISTING
- 10 PROPOSED METAL BOLLARDS TO MATCH EXISTING
- PROPOSED METAL COLUMN FOR SIGN ABOVE TO MATCH EXISTING
- 12 PROPOSED SIGN ABOVE TO MATCH EXISTING 13 EXISTING ABOVE GROUND 10,000 GALLON DEF TANK
- 15 EXISTING ACCESSIBLE PATH OF TRAVEL
- 16 EXISTING ELECTRICAL METAL SHED ENCLOSURE TO REMAIN
- 17 EXISTING METAL DOOR TO REMAIN
- 18 EXISTING ELECTRICAL PANELS TO REMAIN

# FLOOR PLAN LEGEND

- # KEY NOTE SYMBOL
- SECTION REFERENCE NUMBER
- DIMENSION TO FACE OR CENTER OF WALL OR COLUMN



**ATTACHMENT 13** 

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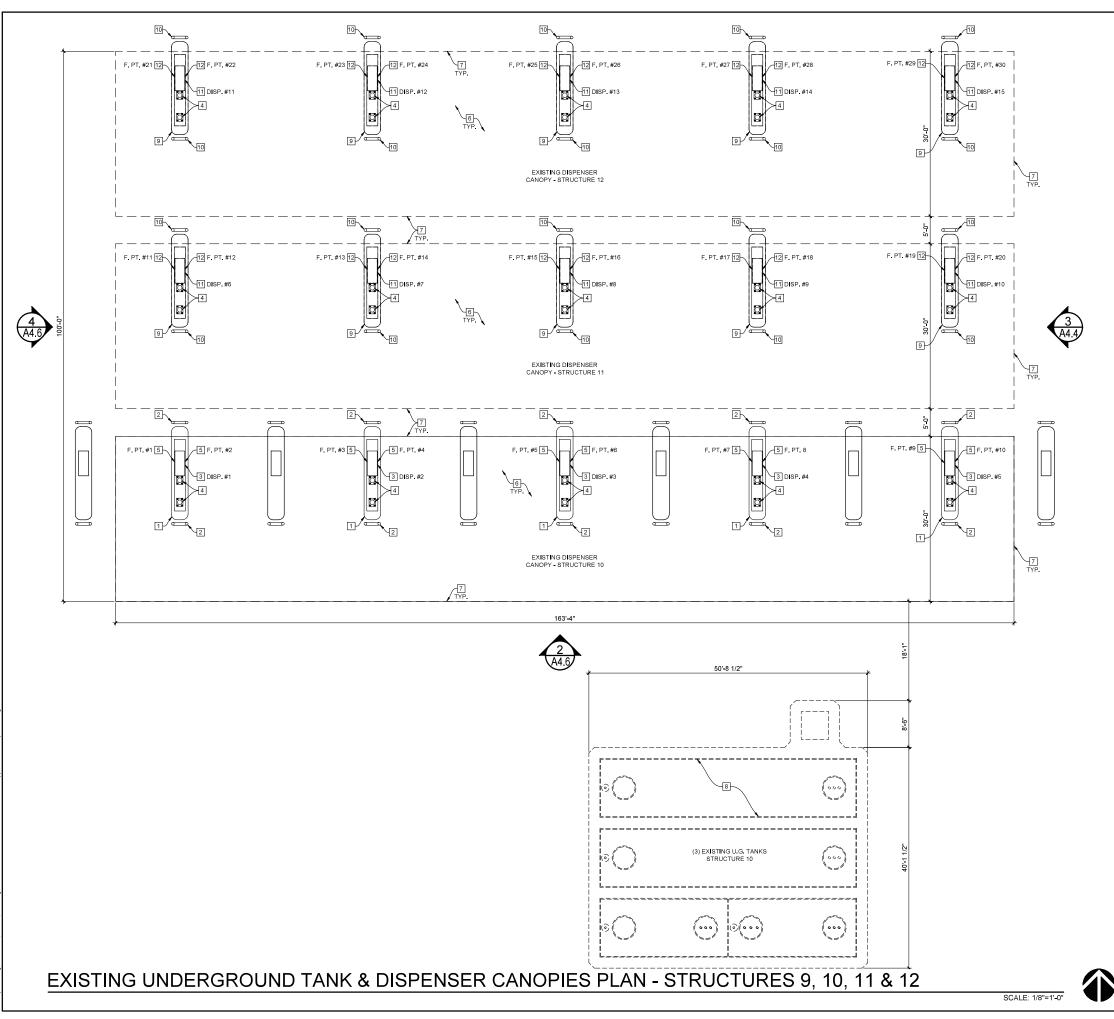
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### FLOOR PLAN KEYNOTES:

- 1 EXISTING RAISED CONCRETE ISLAND TO REMAIN TOTAL 5
- 2 EXISTING METAL BOLLARDS TO REMAIN TOTAL 10 LOCATIONS
- 3 EXISTING PERMITTED DIESEL DISPENSERS TO REMAIN TOTAL 5 4 EXISTING PERMITTED METAL CANOPY COLUMN TO REMAIN
- 5 EXISTING FUELING POINTS TO REMAIN TOTAL 10
- 6 EXISTING CONCRETE PAVEMENT TO REMAIN
- 7 EXISTING PERMITTED METAL CANOPY ABOVE TO REMAIN
- 8 EXISTING (3) 30,000 GAL. U.G. FUEL TANKS TO REMAIN
- 9 EXISTING RAISED CONCRETE ISLAND TO BE REMOVED TOTAL 10
- 10 EXISTING METAL BOLLARDS TO BE REMOVED 20 LOCATIONS
- 11 EXISTING PERMITTED DIESEL DISPENSER TO BE REMOVED TOTAL 10
- 12 EXISTING FUELING POINTS TO BE REMOVED TOTAL 20

### FLOOR PLAN LEGEND

KEYNOTE SYMBOL



EXTERIOR ELEVATION REFERENCE NUMBER HEET NUMBER

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# SHEET TITLE / CONTENTS EXISTING DISPENSER CANOPIES FLOOR & **ROOF PLANS. NOTES** & SCHEDULES

TRH PROJECT#: 248-13-CUP SCALE: DRAWN BY: ORIGINAL DATE: 1/4/2016 CHECKED BY:

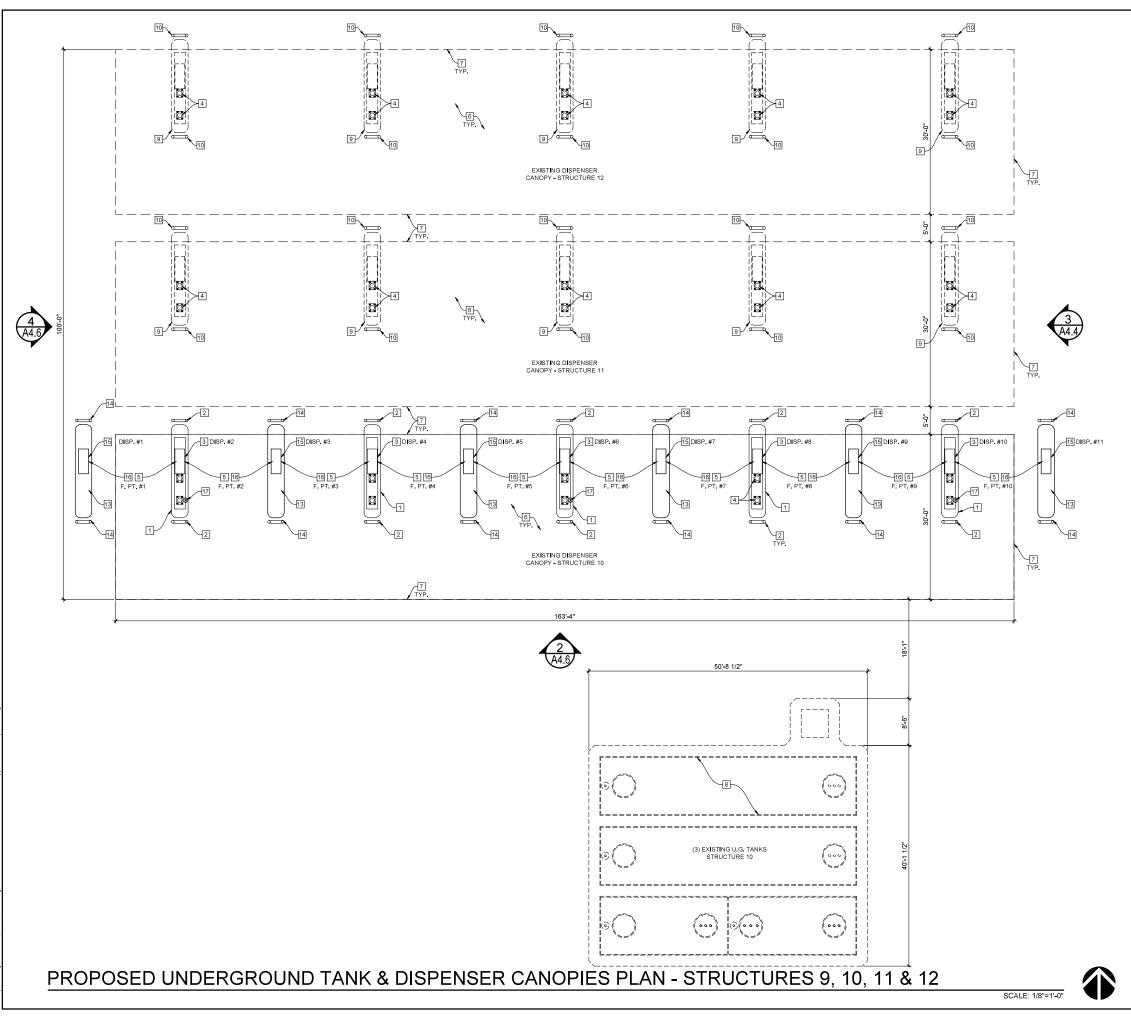
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### FLOOR PLAN KEYNOTES:

- 1 EXISTING RAISED CONCRETE ISLAND TO REMAIN TOTAL 5
- 2 EXISTING METAL BOLLARDS TO REMAIN TOTAL 10 LOCATIONS
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- 12 EXISTING FUELING POINTS TO BE REMOVED TOTAL 20 13 PROPOSED RAISED CONCRETE ISLAND - TOTAL 5
- 14 PROPOSED METAL BOLLARDS TOTAL 10 LOCATIONS
- 15 PROPOSED FUEL DISPENSERS TOTAL 5
- 16 PROPOSED FUELING POINTS TOTAL10
- 17 PROPOSED 4A-60B:C FIRE EXTINGUISHER



**ATTACHMENT 13** 

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PROPOSED DISPENSER CANOPIES FLOOR & ROOF PLANS. NOTES & SCHEDULES

TRH PROJECT#: 248-13-CUP SCALE: DRAWN BY: ORIGINAL DATE: 1/4/2016 CHECKED BY:

AS NOTED TRH

SHEET: 13

OF: 46



KEYNOTE SYMBOL

FLOOR PLAN LEGEND

EXTERIOR ELEVATION REFERENCE NUMBER HEET NUMBER

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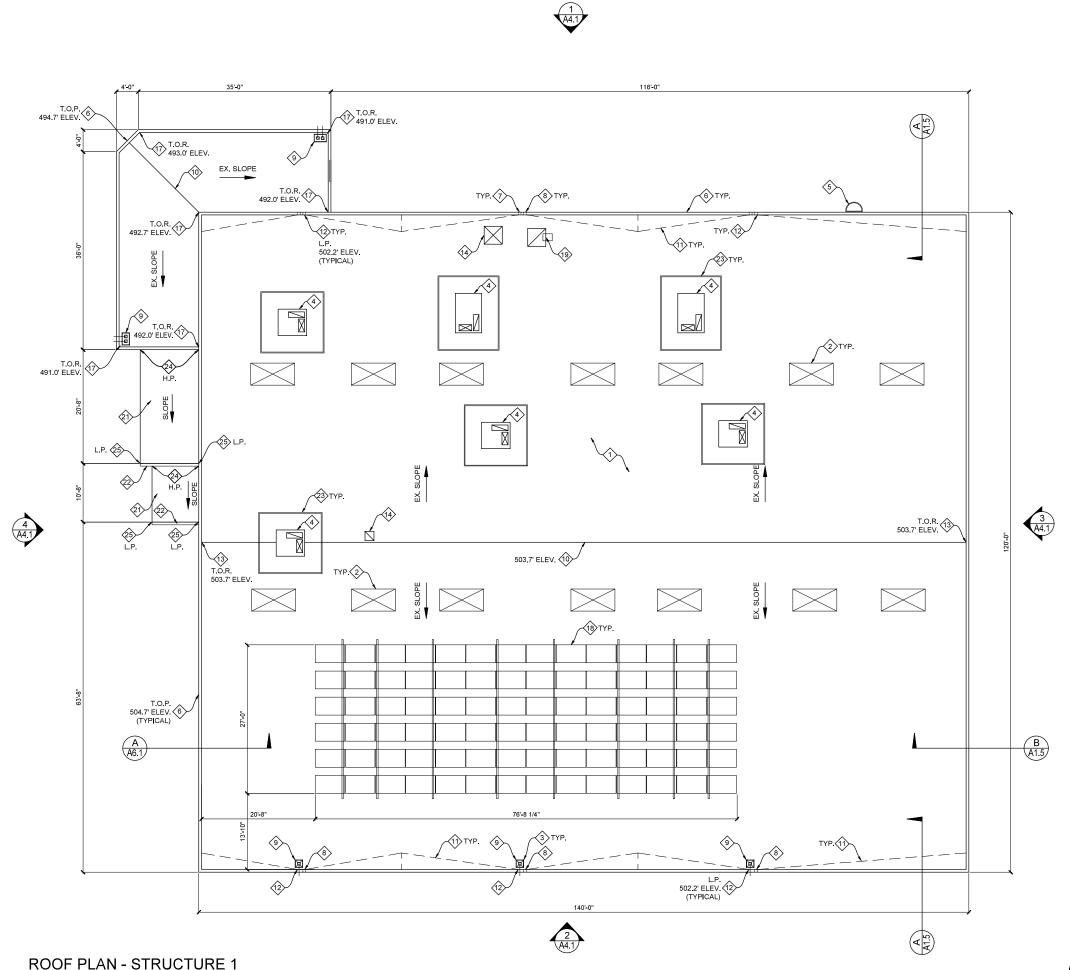
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# ATTACHMENT 13

(1) EXISTING 4-PLY BUILT-UP CLASS "A" ROOF SYSTEM TO BE MAINTAINED

2 EXISTING SKYLIGHT TO REMAIN

3 EXISTING TAPERED INSULATIONS @ 1/4" FT TO PROVIDE POSITIVE SLOPE TO ROOF DRAIN

(4) EXISTING HVAC ROOF TOP UNIT - VERIFY EXACT LOCATION

5 EXISTING ROOF LADDER TO REMAIN

6 EXISTING PARAPET TO REMAIN

(7) EXISTING ROOF DRAIN SCUPPER TO REMAIN - V.I.F.

(8) EXISTING ROOF OVERFLOW SCUPPER - V.I.F.

9 EXISTING ROOF DRAIN - V.I.F.

(1) EXISTING ROOF RIDGE LINE - V.I.F.

(1) EXISTING ROOF CRICKET - V.I.F.

(12) EXISTING ROOF LOW POINT - V.I.F.

(13) EXISTING ROOF HIGH POINT - V.I.F.

(14) EXISTING ROOF EXHAUST FAN - V.I.F.

(NOT USED)

(16) EXISTING MECHANICAL DUCTWORK

17 EXISTING TOP OF ROOF

(18) EXISTING SOLAR PANELS TO REMAIN

(19) EXISTING MAKE-UP AIR DIFFUSER

(NOT USED)

21 PROPOSED CLASS "A" ROOF SYSTEM

22 PROPOSED COMMERCIAL GRADE GUTTER & DOWNSPOUTS

23 PROPOSED RTU SCREENING IF MECHANICAL EQUIPMENT EXCEEDS 30" HEIGHT

PROPOSED NEW ROOF HIGH POINT

25 PROPOSED NEW ROOF LOW POINT

### trh INC

1350 COLUMBIA ST. Suite 702 San Diego, ca 92101

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### SHEET TITLE / CONTENTS



# **ROOF PLAN NOTES:**

PRIMARY ROOF SLOPE (MIN. 3/16/FT.) CREATED THROUGH ELEVATION OF PRIMARY STRUCTURAL SYSTEM COMPONENTS.

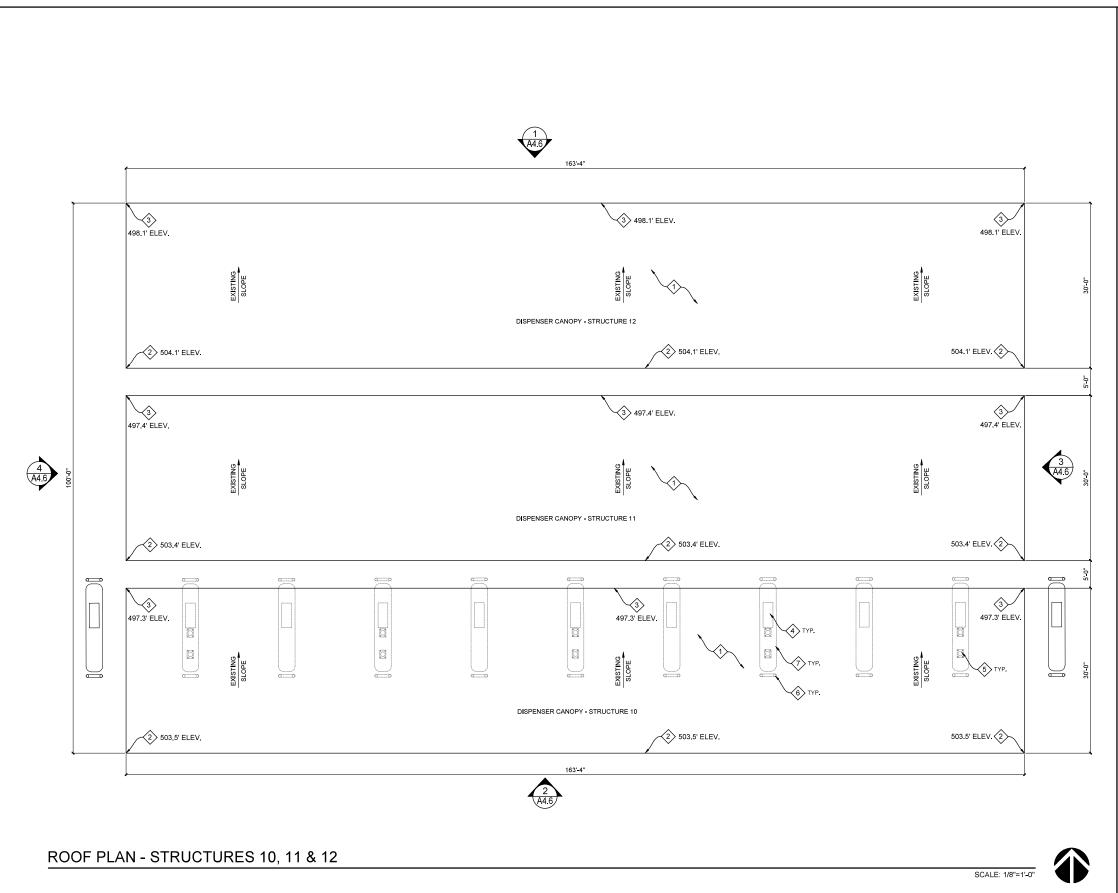
2. SECONDARY ROOF SLOPES CREATED THROUGH INSTALLATION OF TAPERED ROOF INSULATION (1/4"/FT.) AS INDICATED TO ADVANCE DRAINAGE TOWARDS ROOF DRAINS.

VERIFY LOCATIONS OF ALL ROOF DRAINS & MECHANICAL EQUIPMENT. ALL NEWLY CONSTRUCTED ROOFS SHALL BE CLASS "A" ROOFING ASSEMBLY

# **ROOF ABBREVIATIONS:**

- TOP OF PARAPET
- LOW POINT
- HIGH POINT
- ELEVATION =

TOP OF ROOF



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- (1) EXISTING METAL ROOF CANOPY TO REMAIN
- 2 EXISTING METAL ROOF CANOPY HIGH POINT
- 3 EXISTING METAL ROOF CANOPY LOW POINT
- $\overleftarrow{\rm (4)}$  existing fuel dispenser below
- 5 EXISTING METAL COLUMN BELOW
- 6 EXISTING METAL BOLLARD BELOW
- EXISTING CONCRETE ISLAND BELOW



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# Truck.Net LLC

5440 MOREHOUSE DR. #4000 SAN DIEGO, CA 92121

# PROJECT **TRUCK.NET** CUP

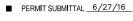
8490 AVENIDA DE LA FUENTE SUITE 5 SAN DIEGO, CA 92154

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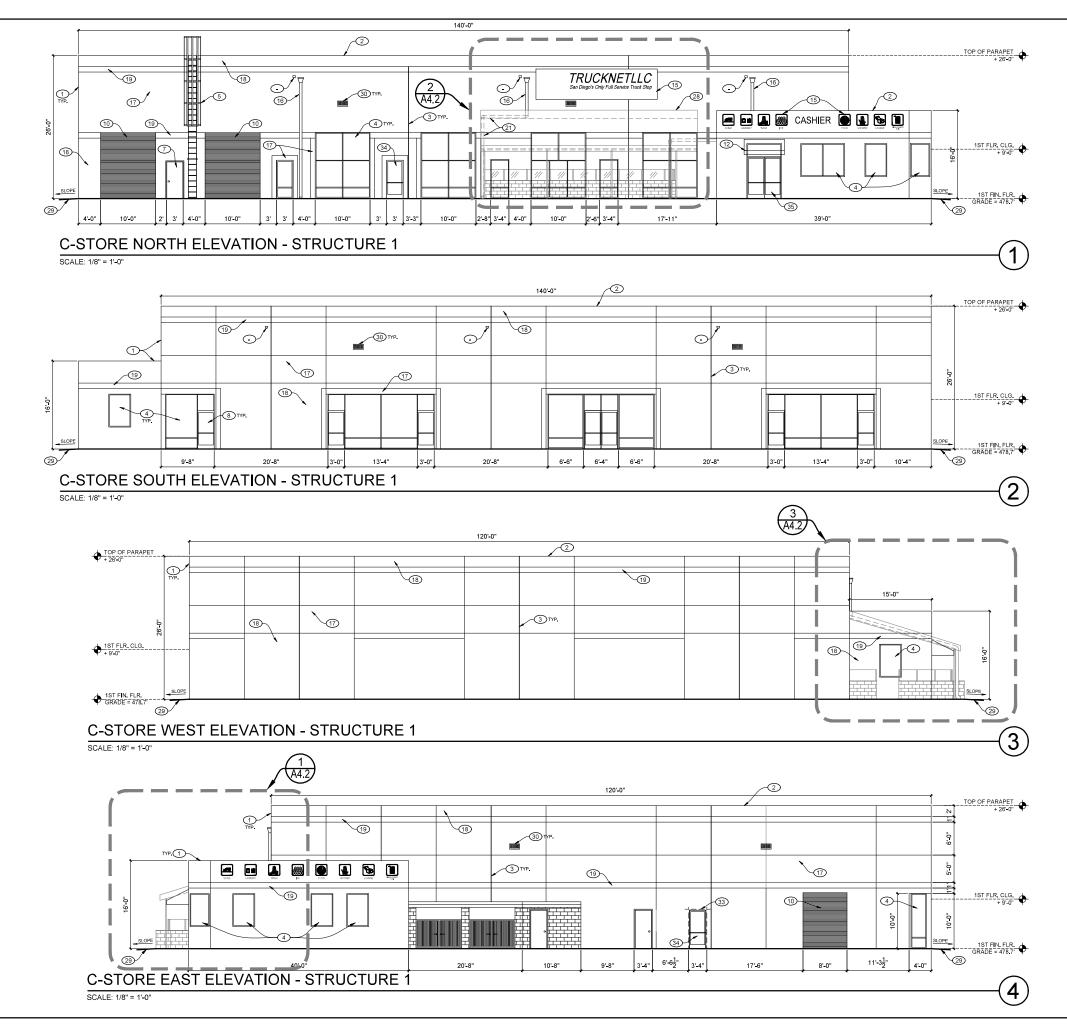
- FULL SUBMITTAL 7/20/16
- RESUBMITTAL 1 \_\_12/9/16\_\_
- RESUBMITTAL 2 \_4/27/17
- RESUBMITTAL 3 1/9/2018
- RESUBMITTAL 4 <u>12/3/2018</u>
- RESUBMITTAL 5 9/10/2019
- RESUBMITTAL 6 10/21/2019

SHEET TITLE / CONTENTS



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# **ATTACHMENT 13**

### ELEVATION KEYNOTES

1 EXISTING CONCRETE TILT-UP WALL EXISTING PARAPET EXISTING GAP EXISTING STOREFRONT WINDOW EXISTING ROOF LADDER EXISTING STRUCTURAL COLUMN EXISTING DOOR EXISTING STOREFRONT DOOR EXISTING ROOF LINE EXISTING ROLL-UP DOOR EXISTING WALL OPENING EXISTING ENTRANCE CANOPY EXISTING REVEAL LINE EXISTING FIRE RISER EXISTING EXTERIOR SIGN EXISTING DOWNSPOUT EXISTING BEIGE COLOR PAINTED SURFACE EXISTING LIGHT BROWN COLOR PAINTED SURFACE EXISTING DARK BROWN COLOR PAINTED SURFACE EXISTING TRASH ENCLOSURE WALL EXISTING DRAIN PIPE EXISTING DEMISING WALL ) EXISTING PATIO WALL EXISTING PATIO COUNTER EXISTING PATIO CANOPY STEEL COLUMN EXISTING PATIO CANOPY STEEL BEAM EXISTING PATIO FURNITURE EXISTING PATIO CANOPY EXISTING GRADE TO REMAIN EXISTING WALL MOUNTED LIGHT FIXTURE PROPOSED TRASH ENCLOSURE WALL PROPOSED TRASH ENCLOSURE DOORS PROPOSED OPENING IN EXISTING WALL PROPOSED SWINGING STOREFRONT DOOR

PROPOSED ELECTRIC SLIDING GLASS DOOR

trh INC.

1350 COLUMBIA ST. SUITE 702 SAN DIEGO, CA 92101

TEL (619) 230-1088 FAX (619) 230-1089 trhinc.com



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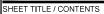
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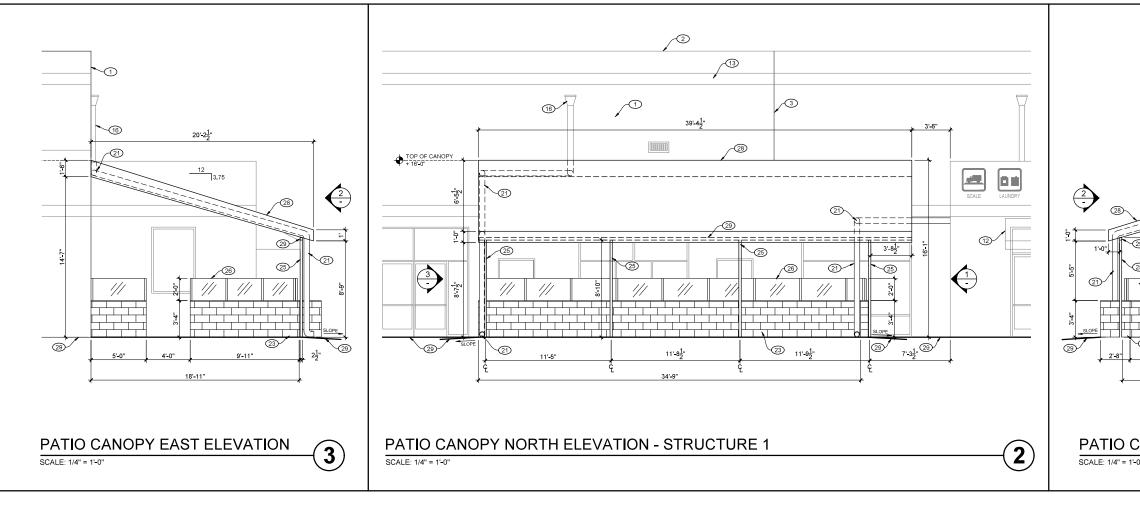
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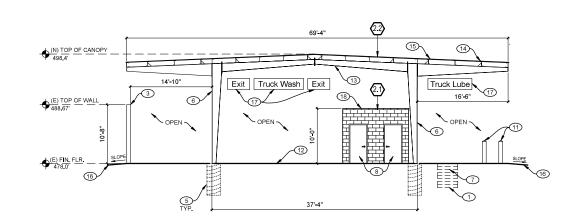
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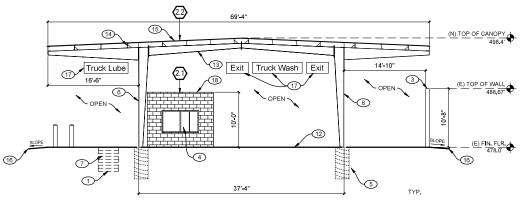
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argements, and plans indicated or represented by these dravings and property of TRH, Inc., and were created, evolved, and developed as instruments of service on, and in connection with the specified project. None of such ideas, designs, arrangements, or plans shall be used by or disclosed to any person for any procession such service instruments on the plans instruments of service on, and in connection with the specified project. None of such ideas, designs, arrangements, or plans shall be used by or disclosed to any person for any person-person ensures has instruments on the plan instruments of services shall verify and be responsible for all dimensions on the jab. TRH, Inc. shall be notified of any variations from the dimensions and uncompleted project. designs, arr organization

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(B)		1350 COLUMBIA ST. SUITE 702 SAN DIEGO, CA 92101 TEL (619) 230-1088 FAX (619) 230-1089 trhinc.com	
3.75		CL <sup>USED</sup> ARCH/1 CL <sup>US</sup>	
	14'-7"	APPLICANT: Truck.Net LLC	
	29	5440 MOREHOUSE DR. #4000 SAN DIEGO, CA 92121 PROJECT:	
18'-11"		TRUCK.NET CUP 8490 AVENIDA DE LA FUENTE	
CANOPY WEST ELEVATION	-1	SUITE 5 SAN DIEGO, CA 92154 REVISION ITEM DATE	
TION KEYNOTES CONCRETE TILT-UP WALL PARAPET GAP			
STOREFRONT WINDOW ROOF LADDER STRUCTURAL COLUMN DOOR STOREFRONT DOOR		<ul> <li>PERMIT SUBMITTAL <u>6/27/16</u></li> <li>FULL SUBMITTAL <u>7/20/16</u></li> </ul>	
ROOF LINE ROLL-UP DOOR WALL OPENING ENTRANCE CANOPY REVEAL LINE FIRE RISER EXTERIOR SIGN DOWNSPOUT		<ul> <li>RESUBMITTAL 1 <u>12/9/16</u></li> <li>RESUBMITTAL 2 <u>4/27/17</u></li> <li>RESUBMITTAL 3 <u>1/9/2018</u></li> <li>RESUBMITTAL 4 <u>12/3/2018</u></li> <li>RESUBMITTAL 5 <u>9/10/2019</u></li> </ul>	
BEIGE COLOR PAINTED SURFACE LIGHT BROWN COLOR PAINTED SURFACE DARK BROWN COLOR PAINTED SURFACE TRASH ENCLOSURE WALL DRAIN PIPE DEMISING WALL PATIO WALL		RESUBMITTAL 6 10/21/2019 SHEET TITLE / CONTENTS C-STORE	Þ
PATIO COUNTER PATIO COUNTER PATIO CANOPY STEEL COLUMN PATIO CANOPY STEEL BEAM PATIO FURNITURE PATIO CANOPY GRADE TO REMAIN		PATIO CANOPY ELEVATIONS	TTAC
WALL MOUNTED LIGHT FIXTURE D TRASH ENCLOSURE WALL D TRASH ENCLOSURE DOORS D OPENING IN EXISTING WALL D SWINGING STOREFRONT DOOR D ELECTRIC SLIDING GLASS DOOR		SHEET TITLE / CONTENTS C-STORE PATIO CANOPY ELEVATIONS (STRUCTURE 1) TRH PROJECT#: 248-13-CUP SCALE: AS NOTED DRAWN BY: TRH ORIGINAL DATE: 1/4/2016 CHECKED BY: SHEET: 17 OF: 46	HMEN
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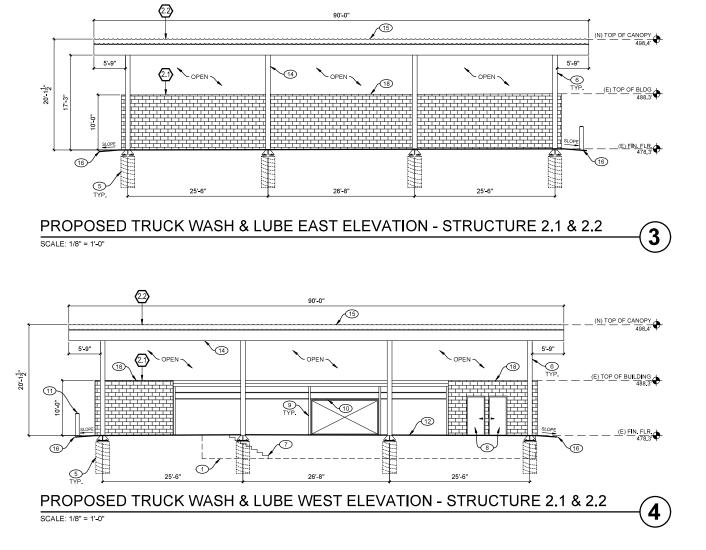




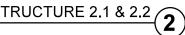












### ELEVATION KEYNOTES

- 1 EXISTING BELOW GRADE CONCRETE LUBE PIT TO REMAIN
- EXISTING EXTERIOR SIGN TO REMAIN
- ) EXISTING MASONRY WALL TO REMAIN EXISTING STOREFRONT WINDOW TO REMAIN
- NEW CONCRETE CAISSON PER STRUCTURAL PLANS
- NEW METAL COLUMN PER STRUCTURAL PLANS
- EXISTING CONCRETE STAIRS TO REMAIN
- ) EXISTING DOOR TO REMAIN
- ) EXISTING 4" METAL COLUMN TO REMAIN
- ) EXISTING METAL SLIDING DOOR TO REMAIN
- EXISTING 8.5" BOLLARDS TO REMAIN
- ) EXISTING CONCRETE FLOOR TO REMAIN ) NEW METAL TRUSSES PER STRUCTURAL PLANS
- 14) NEW METAL BEAMS PER STRUCTURAL PLANS
- NEW CORREGATED METAL DECK
- 16 EXISTING GRADE TO REMAIN
- ) RELOCATED EXISTING EXTERIOR SIGN TO REMAIN
- (18) EXISTING MASONRY BUILDING TO REMAIN

### LEGEND

(E) EXISTING (N) NEW

### STRUCTURES KEYNOTES



21 EXISTING TRUCK WASH & LUBE STORAGE BUILDING 2.2 EXISTING METAL CANOPY REMOVE AND REPLACE

### trh INC

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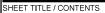
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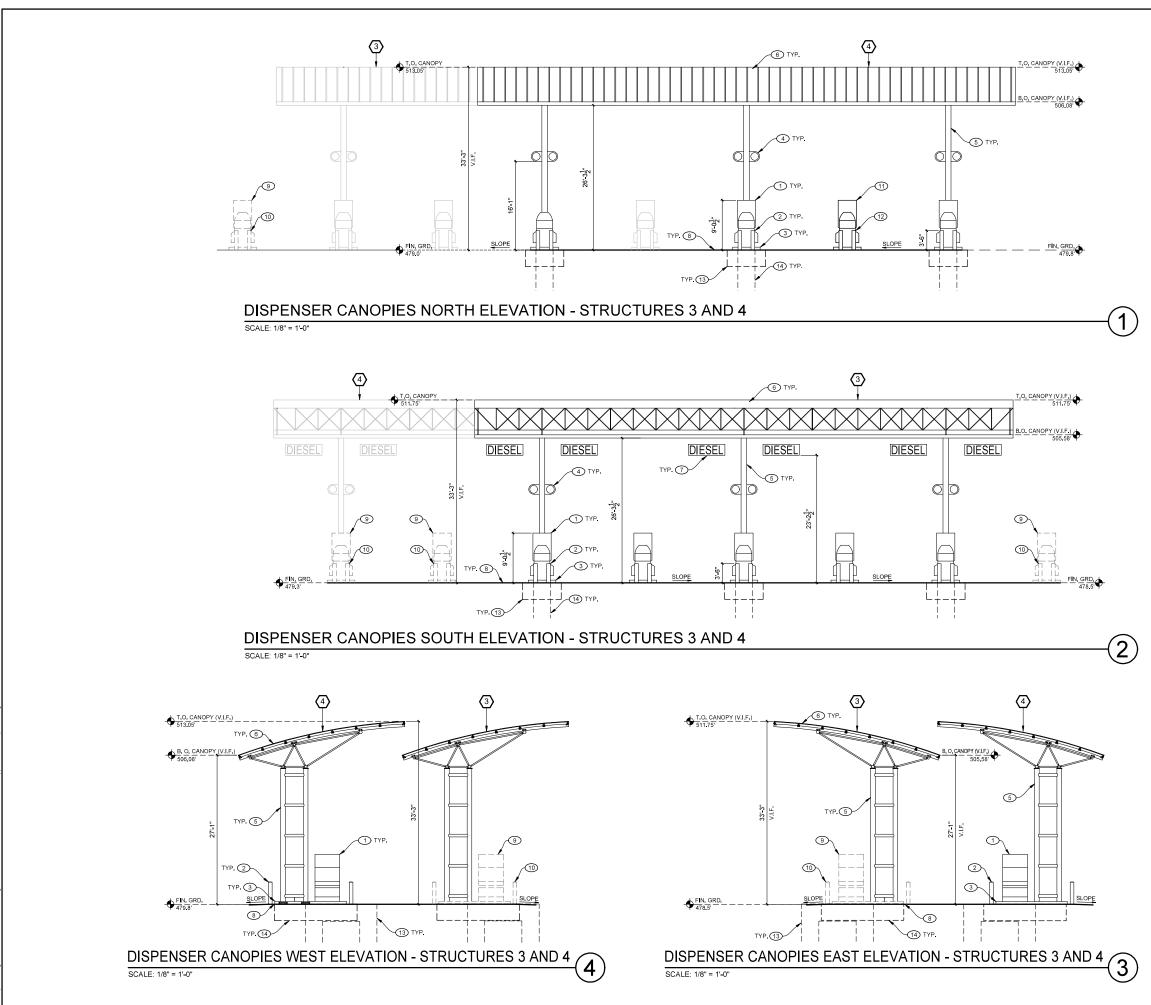


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# **ELEVATION KEYNOTES**

- EXISTING DIESEL DISPENSER TO REMAIN
   EXISTING BOLLARDS TO REMAIN
- ) EXISTING RAISED CONCRETE ISLAND TO REMAIN
- EXISTING DISPENSER NUMBER SIGN TO REMAIN
   SEXISTING METAL CANOPY COLUMN TO REMAIN
- 6 EXISTING METAL CANOPY ROOF STRUCTURE TO REMAIN
- ) EXISTING SIGN TO REMAIN
- EXISTING GRADE TO REMAIN
   EXISTING GRADE TO REMAIN
   EXISTING DISPENSER & ISLAND TO BE REMOVED
   EXISTING BOLLARDS TO BE REMOVED
   PROPOSED (1) NEW DISPENSER & ISLAND

STRUCTURES KEYNOTES

(3) EXISTING DISPENSER CANOPY TO BE PERMITTED

(4) EXISTING DISPENSER CANOPY TO BE PERMITTED

- (12) PROPOSED BOLLARDS



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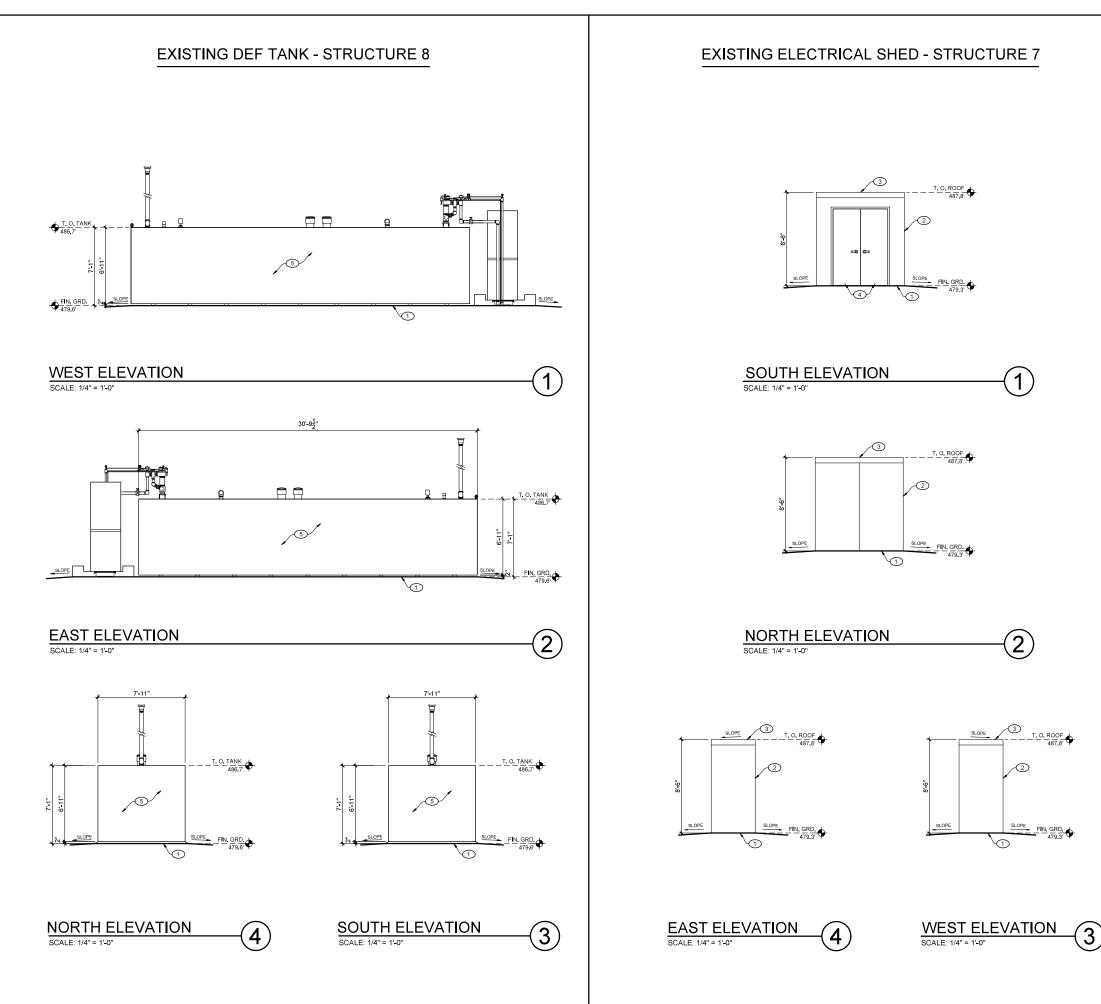
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# ELEVATION KEYNOTES

- 1 EXISTING GRADE TO REMAIN
- (2) EXISTING VEEDER-ROOT ELECTRICAL SHED
- 3 EXISTING METAL ROOF
- EXISTING METAL DOORS
- 5 EXISTING 10,000 GAL. A.G. DEF TANK



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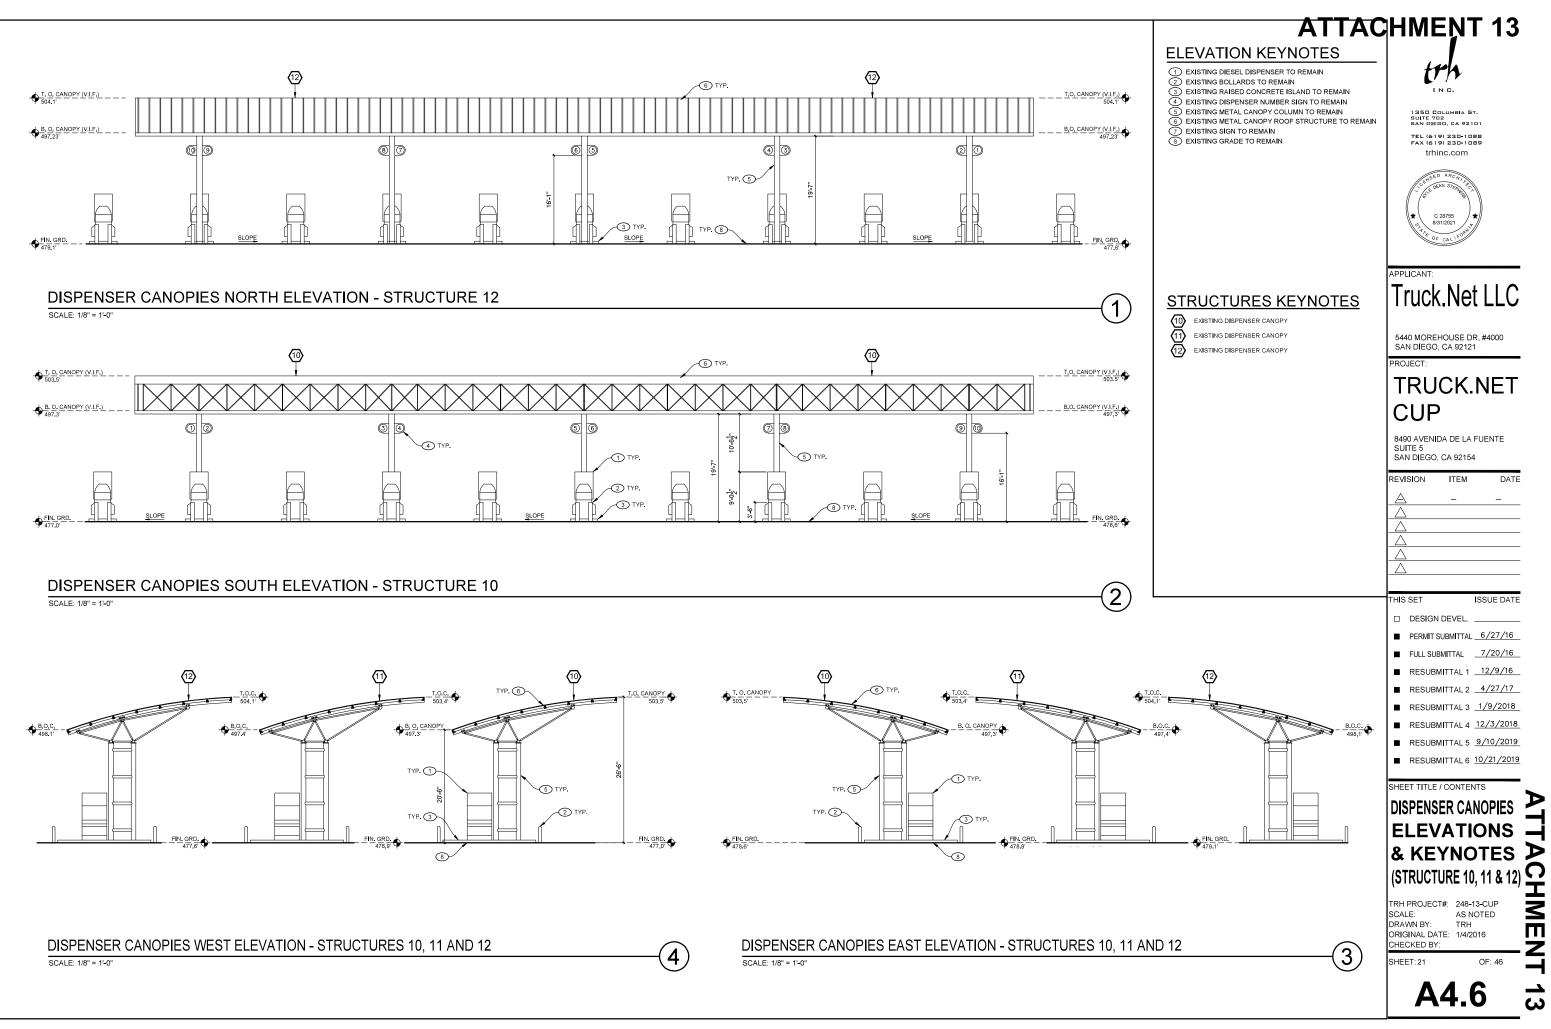
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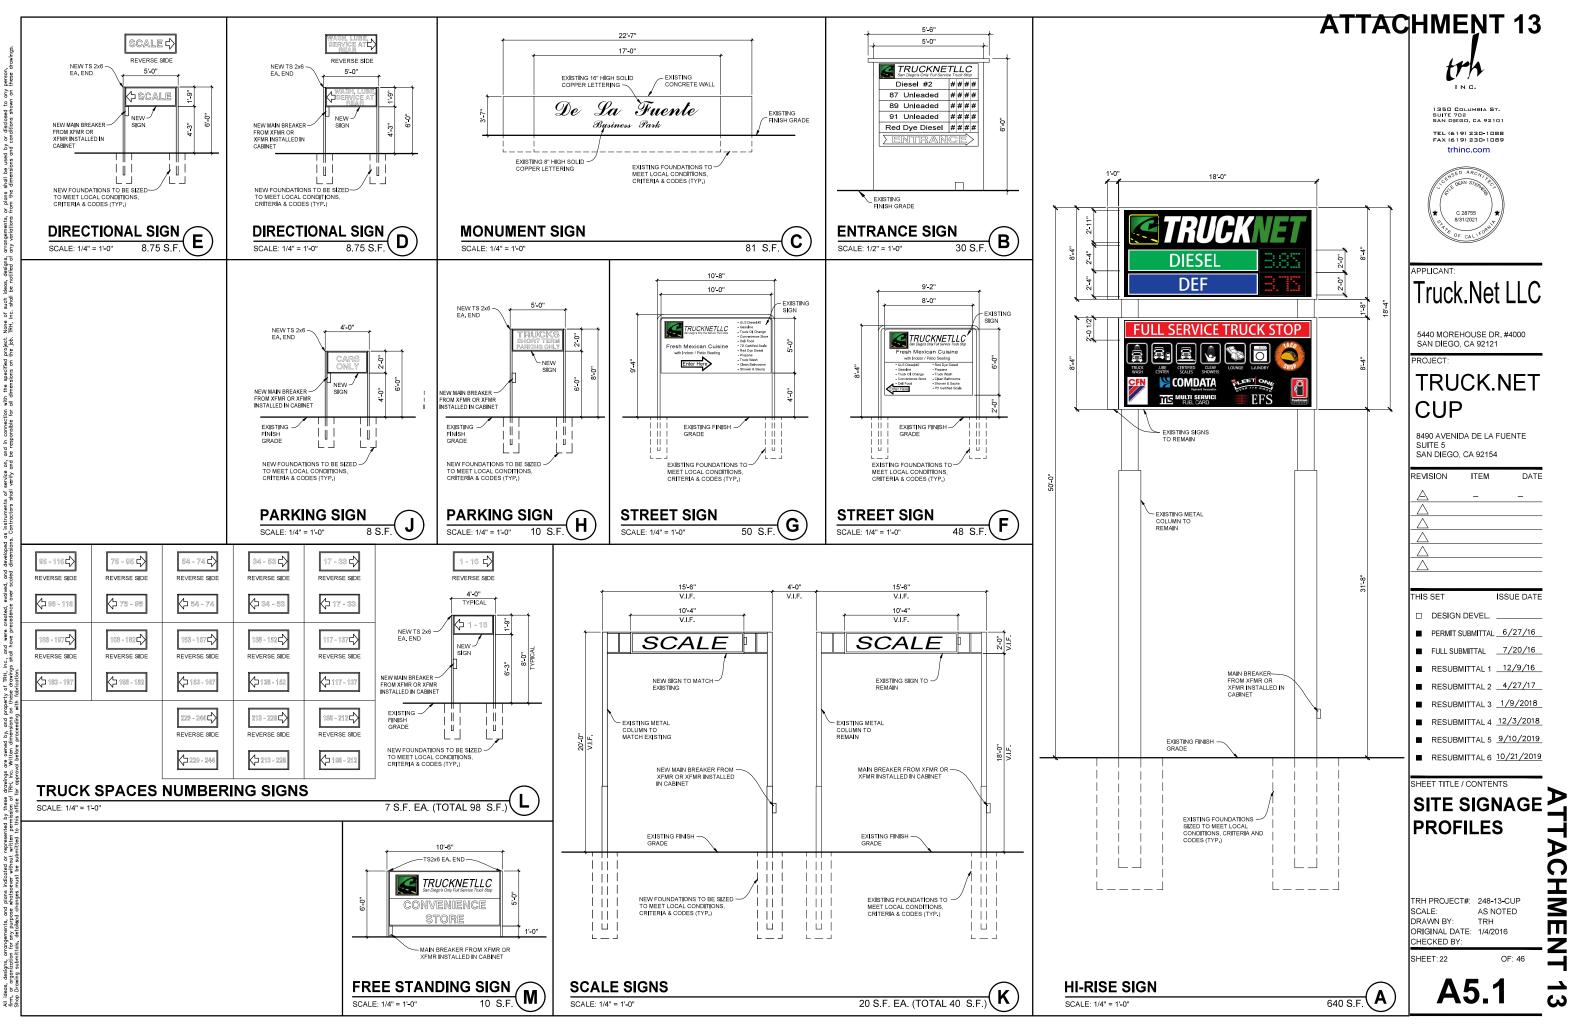
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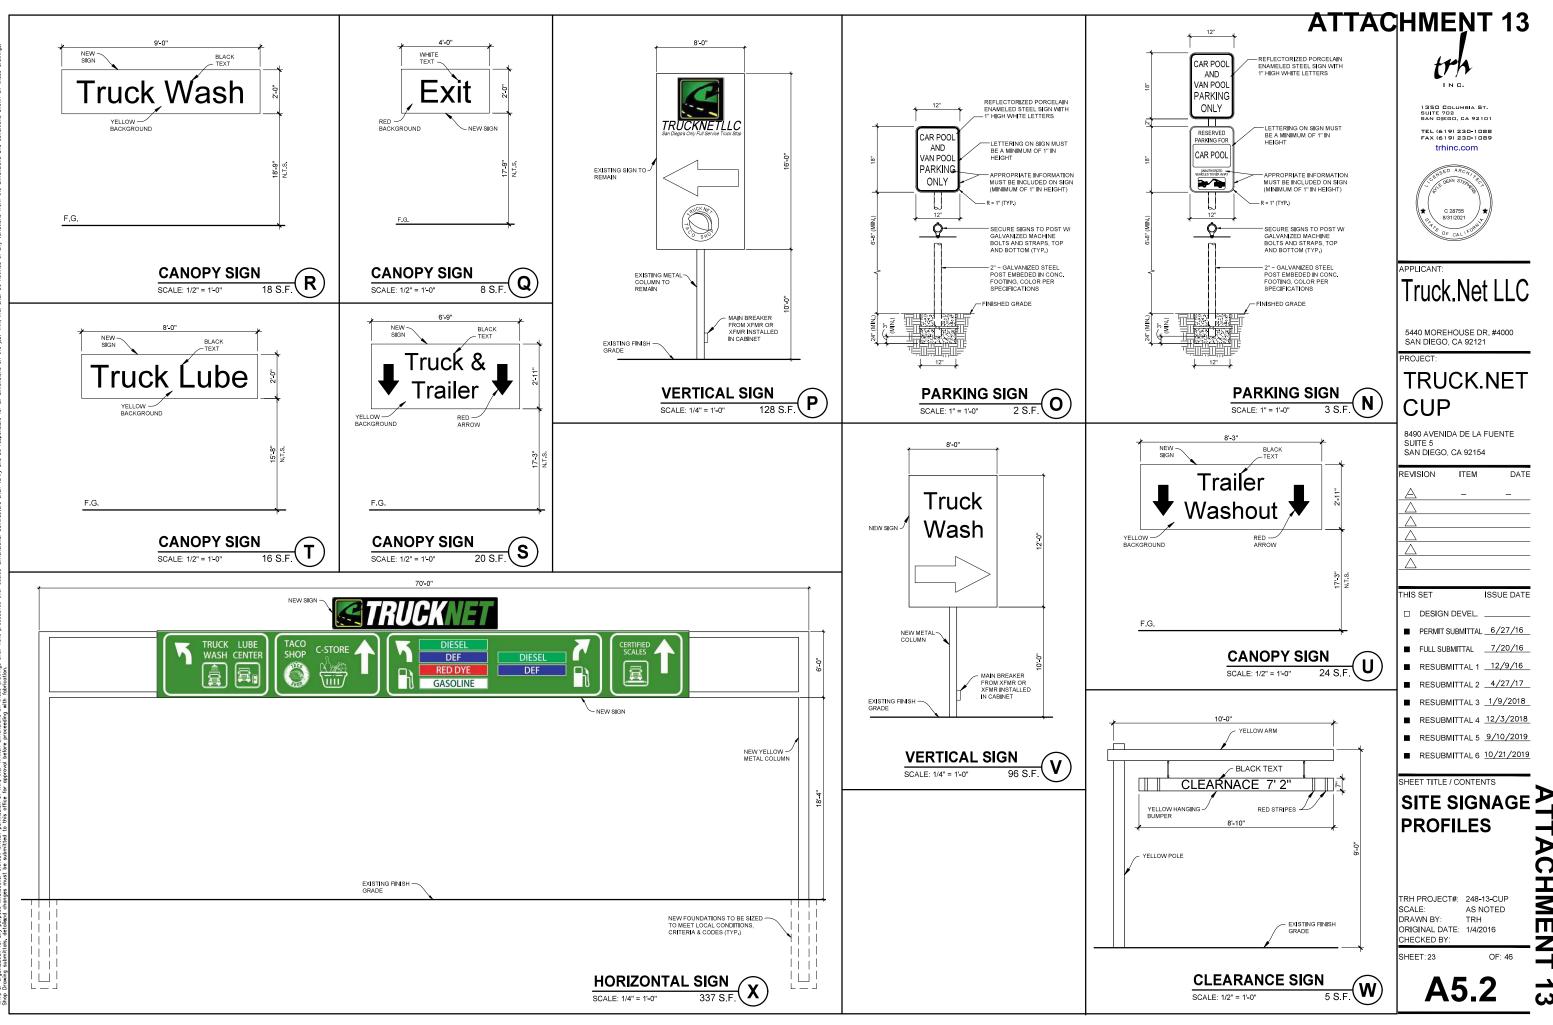
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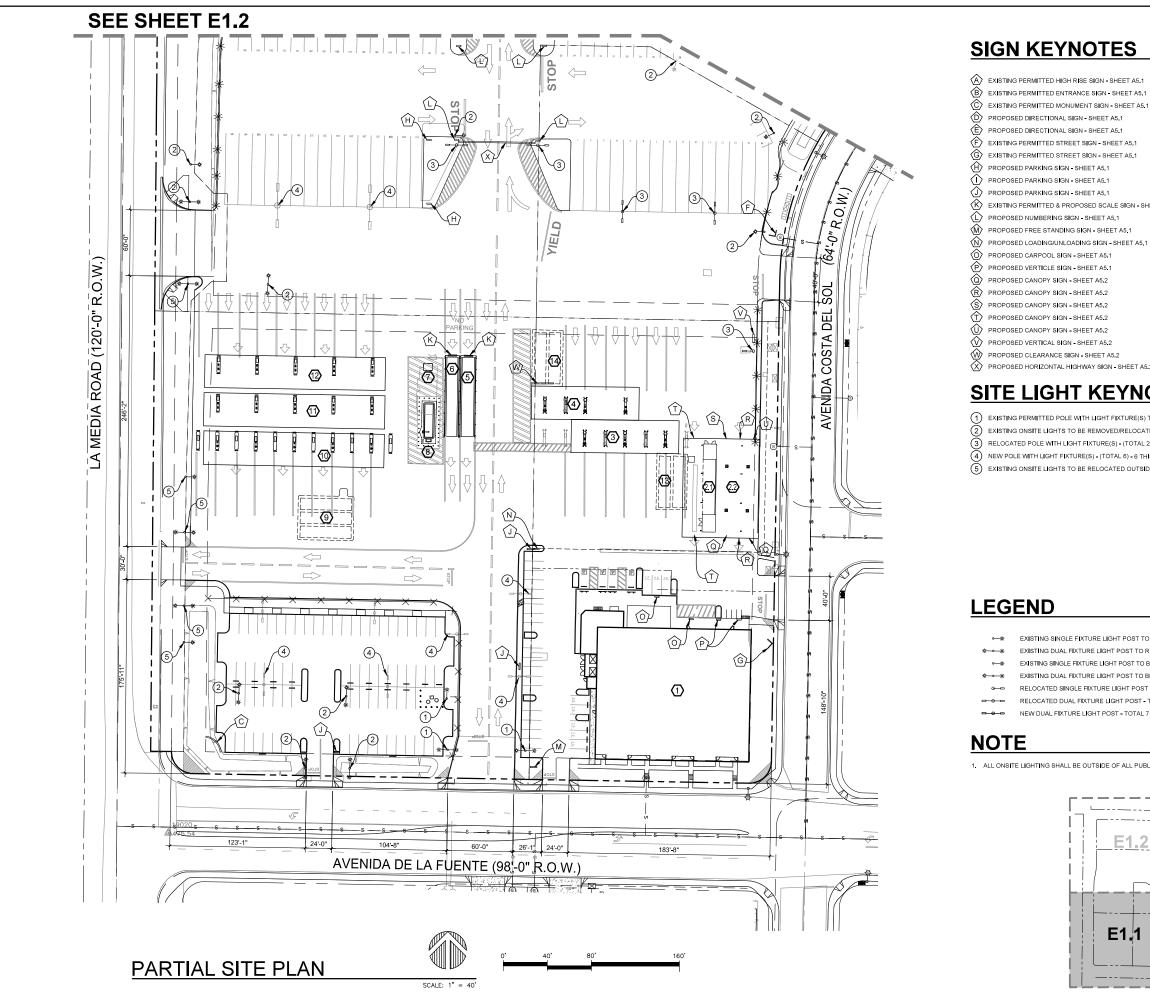




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K EXISTING PERMITTED & PROPOSED SCALE SIGN - SHEET A5.1

PROPOSED HORIZONTAL HIGHWAY SIGN - SHEET A5.2

# **SITE LIGHT KEYNOTES**

1 EXISTING PERMITTED POLE WITH LIGHT FIXTURE(S) TO REMAIN - (TOTAL 9) - 3 THIS SHEET

- (2) EXISTING ONSITE LIGHTS TO BE REMOVED/RELOCATED (TOTAL 21) 11 THIS SHEET
- (3) RELOCATED POLE WITH LIGHT FIXTURE(S) (TOTAL 24) 8 THIS SHEET
- (4) NEW POLE WITH LIGHT FIXTURE(S) (TOTAL 6) 6 THIS SHEET
- (5) EXISTING ONSITE LIGHTS TO BE RELOCATED OUTSIDE THE RIGHT OF WAY- (TOTAL 10) 5 THIS SHEET



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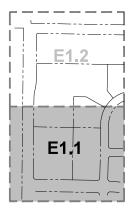
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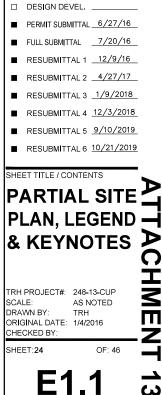
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- EXISTING SINGLE FIXTURE LIGHT POST TO REMAIN TOTAL 1
- EXISTING DUAL FIXTURE LIGHT POST TO REMAIN TOTAL 8
- EXISTING SINGLE FIXTURE LIGHT POST TO BE REMOVED/RELOCATED TOTAL 14
- EXISTING DUAL FIXTURE LIGHT POST TO BE RELOCATED TOTAL 17
- RELOCATED SINGLE FIXTURE LIGHT POST TOTAL 5
- RELOCATED DUAL FIXTURE LIGHT POST TOTAL 17
- NEW DUAL FIXTURE LIGHT POST TOTAL 7

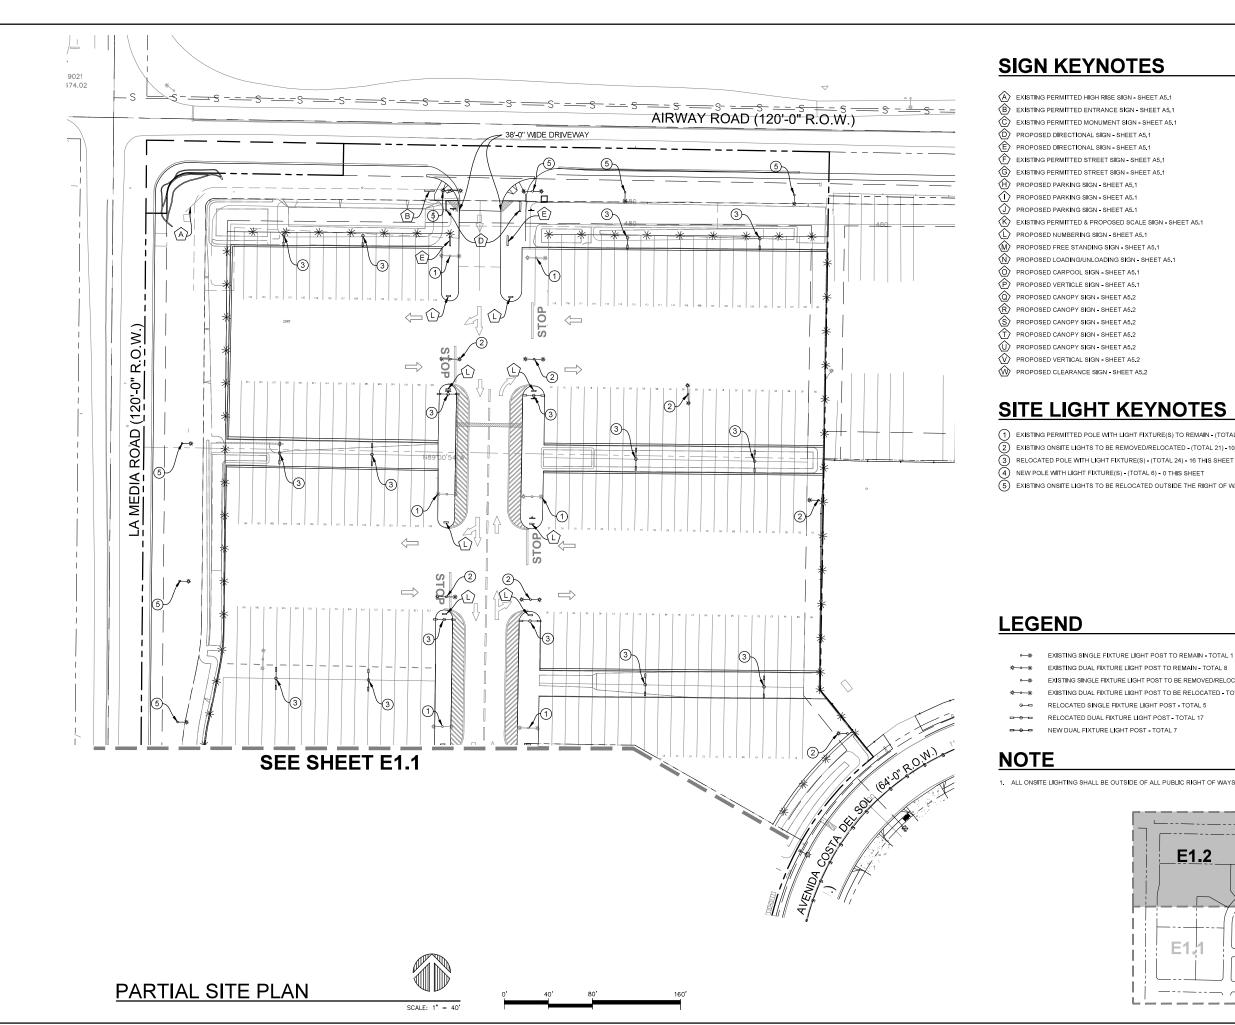
1. ALL ONSITE LIGHTING SHALL BE OUTSIDE OF ALL PUBLIC RIGHT OF WAYS







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# **ATTACHMENT 13**

(1) EXISTING PERMITTED POLE WITH LIGHT FIXTURE(S) TO REMAIN - (TOTAL 9) - 6 THIS SHEET

- (2) EXISTING ONSITE LIGHTS TO BE REMOVED/RELOCATED (TOTAL 21) 10 THIS SHEET
- (5) EXISTING ONSITE LIGHTS TO BE RELOCATED OUTSIDE THE RIGHT OF WAY- (TOTAL 10) -5 THIS SHEET

EXISTING SINGLE FIXTURE LIGHT POST TO REMAIN - TOTAL 1 EXISTING DUAL FIXTURE LIGHT POST TO REMAIN - TOTAL 8 EXISTING SINGLE FIXTURE LIGHT POST TO BE REMOVED/RELOCATED - TOTAL 14 EXISTING DUAL FIXTURE LIGHT POST TO BE RELOCATED - TOTAL 17

- RELOCATED SINGLE FIXTURE LIGHT POST TOTAL 5

1. ALL ONSITE LIGHTING SHALL BE OUTSIDE OF ALL PUBLIC RIGHT OF WAYS







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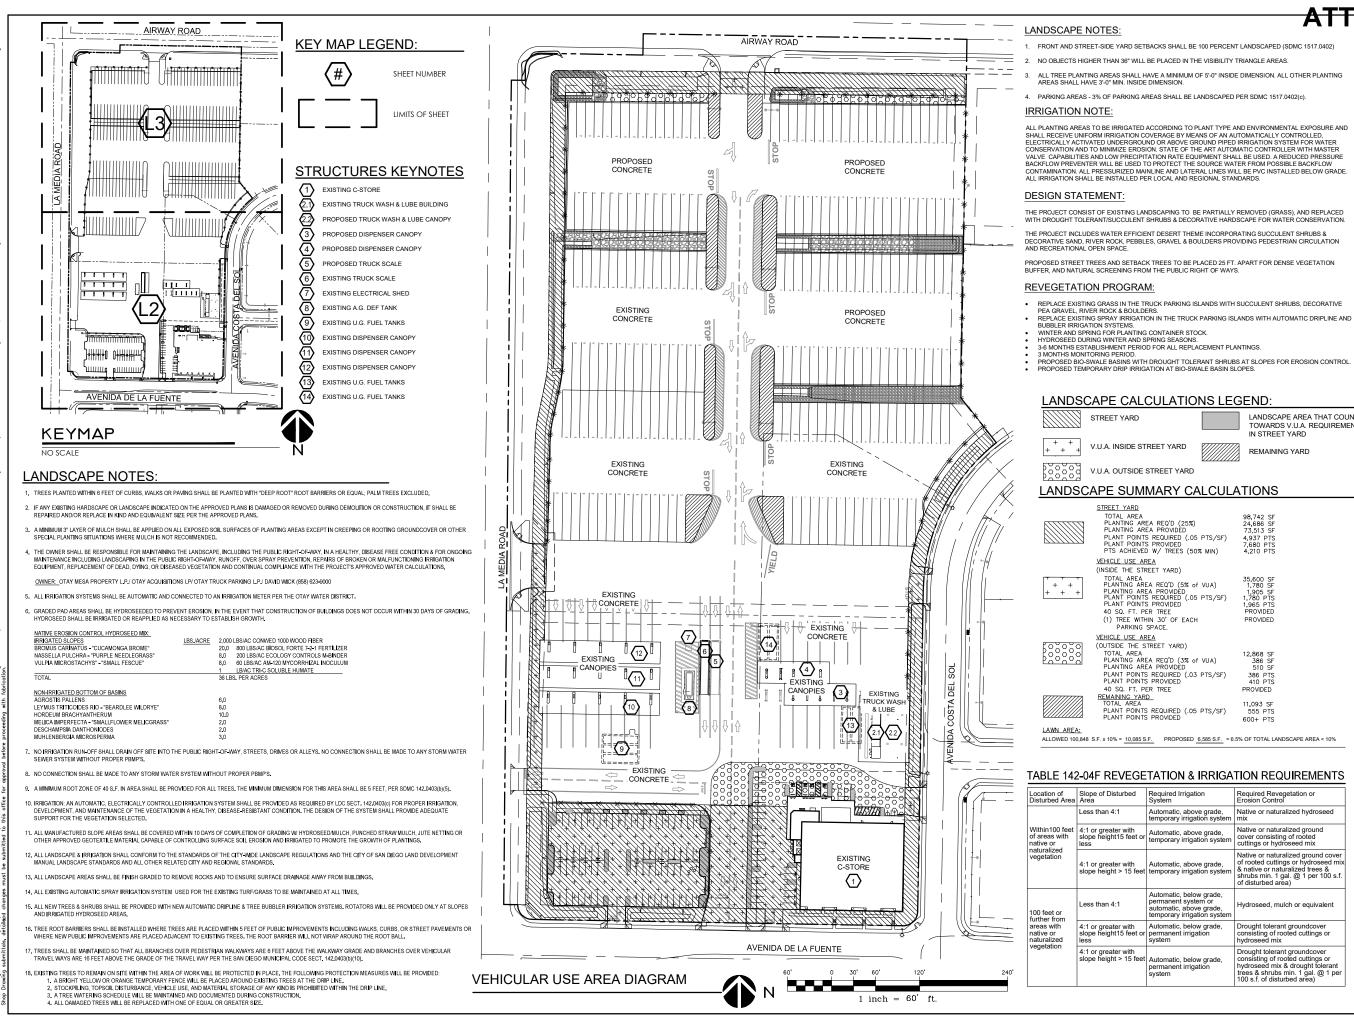
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- FRONT AND STREET-SIDE YARD SETBACKS SHALL BE 100 PERCENT LANDSCAPED (SDMC 1517.0402)
- NO OBJECTS HIGHER THAN 36" WILL BE PLACED IN THE VISIBILITY TRIANGLE AREAS
- ALL TREE PLANTING AREAS SHALL HAVE A MINIMUM OF 5'-0" INSIDE DIMENSION. ALL OTHER PLANTING AREAS SHALL HAVE 3'-0" MIN. INSIDE DIMENSION.
- 4. PARKING AREAS 3% OF PARKING AREAS SHALL BE LANDSCAPED PER SDMC 1517.0402(c).

ALL PLANTING AREAS TO BE IRRIGATED ACCORDING TO PLANT TYPE AND ENVIRONMENTAL EXPOSURE AND SHALL RECEIVE UNIFORM IRRIGATION COVERAGE BY MEANS OF AN AUTOMATICALLY CONTROLLED, ELECTRICALLY ACTIVATED UNDERGROUND OR ABOVE GROUND PIPED IRRIGATION SYSTEM FOR WATER CONSERVATION AND TO MINIMIZE EROSION. STATE OF THE ART AUTOMATIC CONTROLLER WITH MASTER VALVE CAPABILITIES AND TO MINIMIZE EROSION. STATE OF THE ART AUTOMATIC CONTROLLE WITH MASTER BACKFLOW PREVENTER WILL BE USED TO PROTECT THE SOURCE WATER FROM POSSIBLE BACKFLOW CONTAINMATION ALL DPESSIBILIZED MAININE AND LATERAL LIBE USED TO PROTECT THE SOURCE WATER FROM POSSIBLE BACKFLOW CONTAINTS AND A TO MINIMINE AND LATERAL LIBE WISED TO PROTECT THE SOURCE WATER FROM POSSIBLE BECKFLOW CONTAINTS. CONTAMINATION. ALL PRESSURIZED MAINLINE AND LATERAL LINES WILL BE PVC INSTALLED BELOW GRADE. ALL IRRIGATION SHALL BE INSTALLED PER LOCAL AND REGIONAL STANDARDS.

- THE PROJECT CONSIST OF EXISTING LANDSCAPING TO BE PARTIALLY REMOVED (GRASS), AND REPLACED WITH DROUGHT TOLERANT/SUCCULENT SHRUBS & DECORATIVE HARDSCAPE FOR WATER CONSERVATION
- PROPOSED STREET TREES AND SETBACK TREES TO BE PLACED 25 FT. APART FOR DENSE VEGETATION

- PROPOSED BIO-SWALE BASINS WITH DROUGHT TOLERANT SHRUBS AT SLOPES FOR EROSION CONTROL. PROPOSED TEMPORARY DRIP IRRIGATION AT BIO-SWALE BASIN SLOPES.

### LANDSCAPE CALCULATIONS LEGEND:

LANDSCAPE AREA THAT COUNTS TOWARDS V.U.A. REQUIREMENTS IN STREET YARD

REMAINING YARD

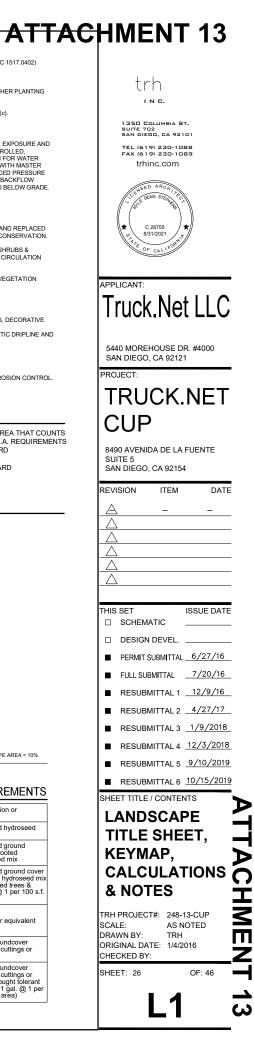
### LANDSCAPE SUMMARY CALCULATIONS

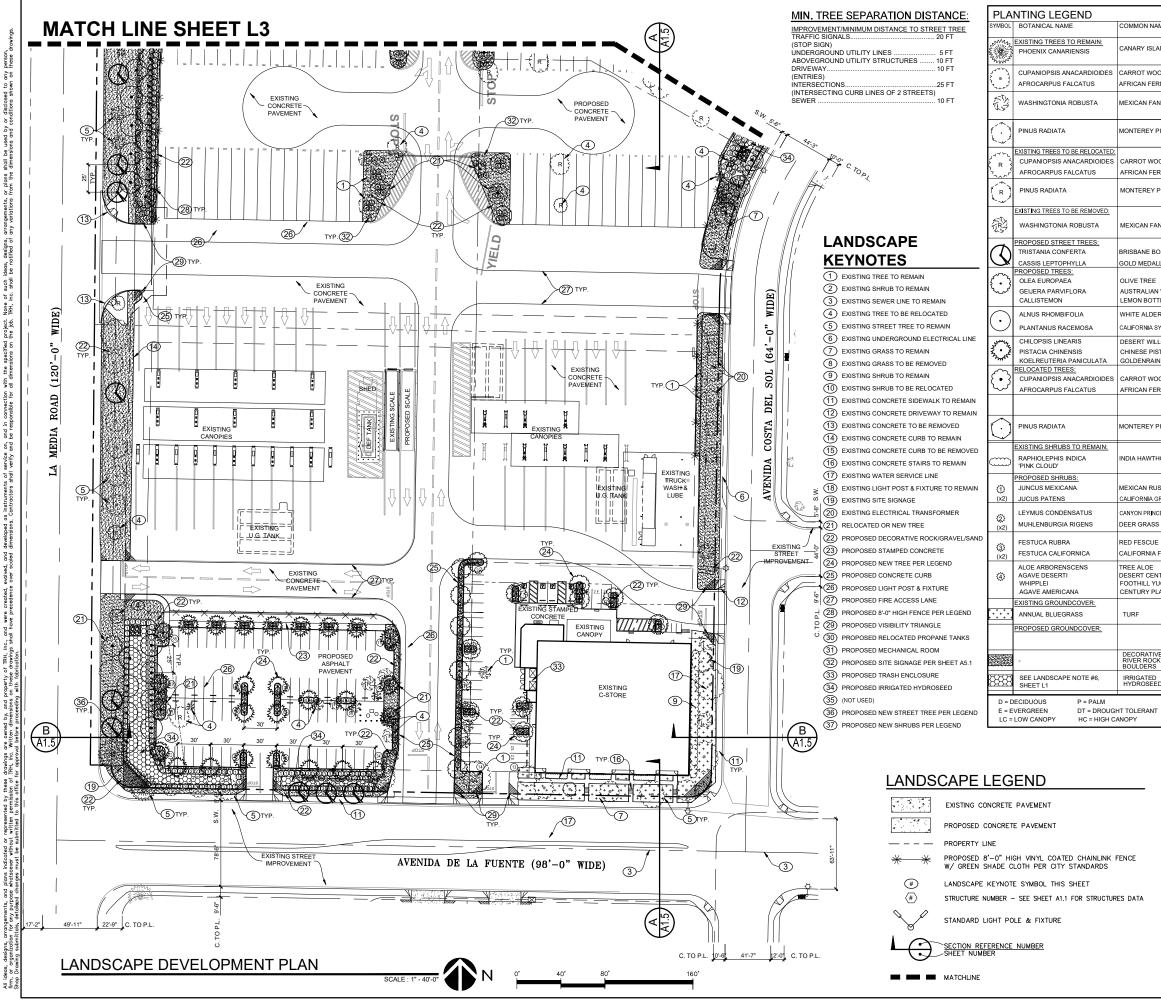
A AREA REQ'D (25%)	98,742 SF 24,686 SF
AREA PROVIDÈD NTS REQUIRED (.05 PTS/SF)	73,513 SF 4,937 PTS 7,680 PTS 4,210 PTS
ABEA STREET YARD) A REA PROVDED VIS REQUIRED (.05 PTS/SF) VIS PROVDED PER TREE ITHIN 30' OF EACH G SPACE.	35,600 SF 1,780 SF 1,905 SF 1,780 PTS 1,965 PTS PROVIDED PROVIDED
AREA STREET YARD) AREA REO'D (3% of VUA) RREA PROVIDED JITS REQUIRED (.03 PTS/SF) JITS PROVDED PER TREE ARD A TITS REQUIRED (.05 PTS/SF) JITS PROVIDED	12,868 SF 386 SF 510 SF 410 PTS PROVIDED 11,093 SF 555 PTS 600+ PTS

ALLOWED 100,848 S.F. x 10% = 10,085 S.F. PROPOSED 6,585 S.F. = 6.5% OF TOTAL LANDSCAPE AREA < 10%

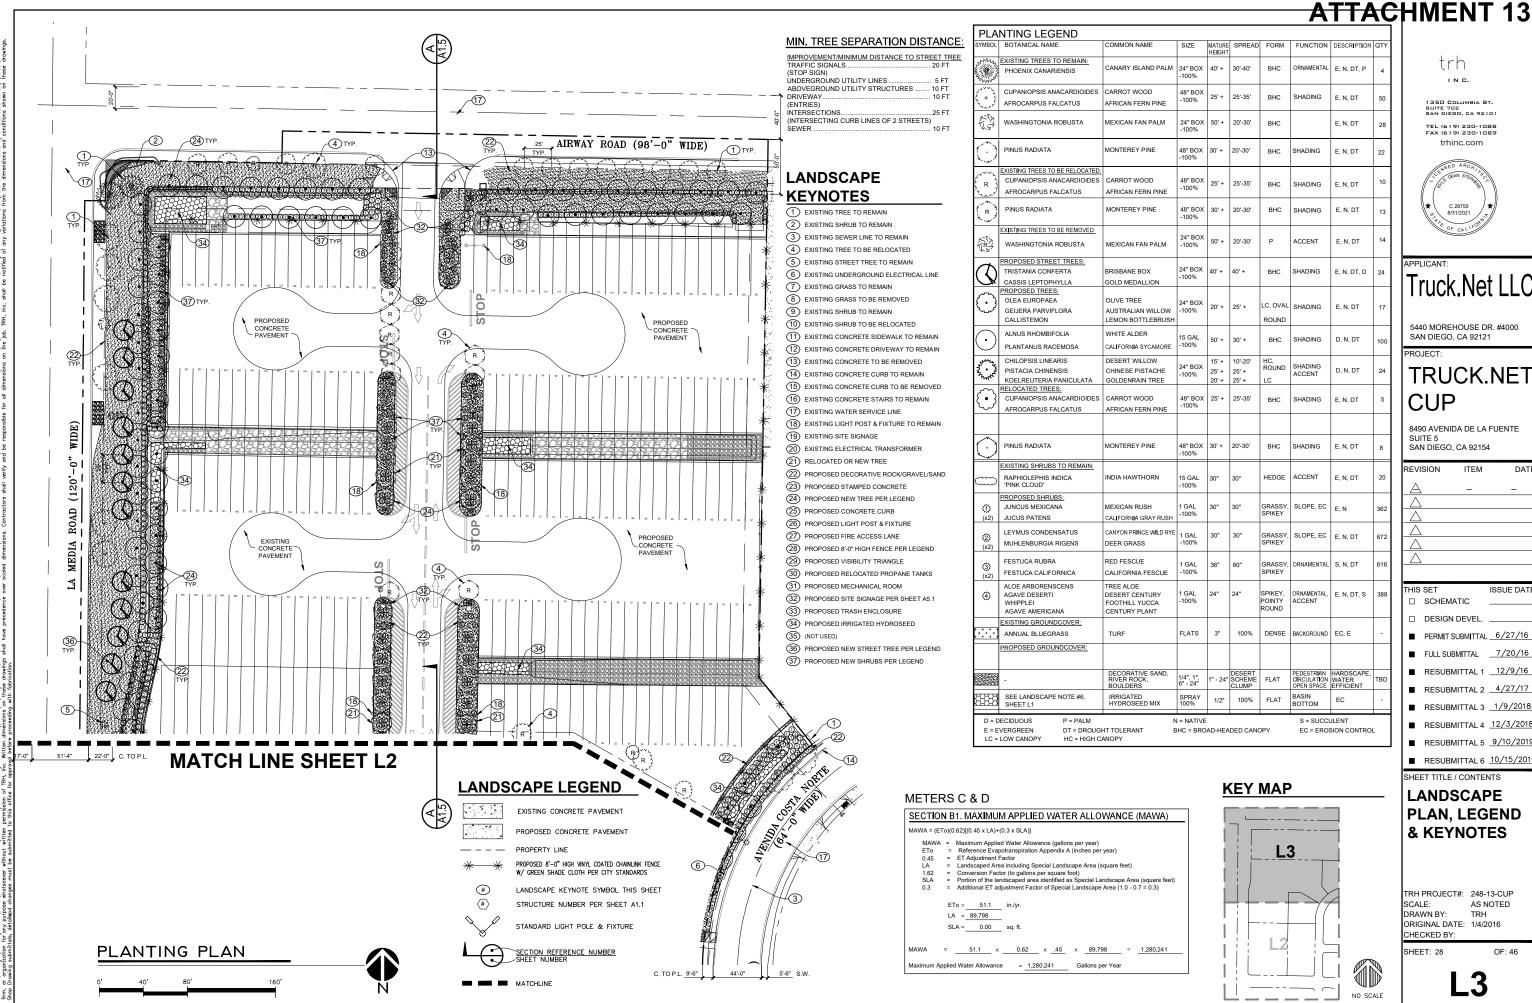
### TABLE 142-04F REVEGETATION & IRRIGATION REQUIREMENTS

Required Irrigation System	Required Revegetation or Erosion Control
Automatic, above grade, temporary irrigation system	Native or naturalized hydroseed mix
Automatic, above grade, temporary irrigation system	Native or naturalized ground cover consisting of rooted cuttings or hydroseed mix
Automatic, above grade, temporary irrigation system	Native or naturalized ground cover of rooted cuttings or hydroseed mix & native or naturalized trees & shrubs min. 1 gal. @ 1 per 100 s.f. of disturbed area)
Automatic, below grade, permanent system or automatic, above grade, temporary irrigation system	Hydroseed, mulch or equivalent
Automatic, below grade, permanent irrigation system	Drought tolerant groundcover consisting of rooted cuttings or hydroseed mix
Automatic, below grade, permanent irrigation system	Drought tolerant groundcover consisting of rooted cuttings or hydroseed mix & drought tolerant trees & shrubs min. 1 gal. @ 1 per 100 s.f. of disturbed area)
	System C Automatic, above grade, temporary irrigation system Automatic, above grade, temporary irrigation system Automatic, above grade, temporary irrigation system Automatic, below grade, permanent system or automatic, above grade, permanent irrigation system Automatic, below grade, permanent irrigation system





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IAME	SIZE	MATURE	SPREAD	FORM	FUNCTION	DESCRIPTION		
LAND PALM	24" BOX -100%	HEIGHT 40' +	30'-40'	внс	ORNAMENTAL	E, N, DT, P	4	trh
OOD ERN PINE	48" BOX -100%	25' +	25'-35'	внс	SHADING	E, N, DT	50	IN E.
AN PALM	24" BOX -100%	50' +	20'-30'	внс		E, N, DT	28	1350 COLUMBIA ST. Suite 702 San Diego, ca 92101
PINE	48" BOX -100%	30' +	20'-30'	внс	SHADING	E, N, DT	22	TEL (619) 230-1088 FAX (619) 230-1089 trhinc.com
OOD ERN PINE	48" BOX -100%	25' +	25'-35'	внс	SHADING	E, N, DT	10	TENSED ARCH/ICC
PINE	48" BOX -100%	30' +	20'-30'	внс	SHADING	E, N, DT	13	(★ C 28755 ★
AN PALM	24" BOX -100%	50' +	20'-30'	Р	ACCENT	E, N, DT	14	PAR OF CALIFORN
BOX	24" BOX -100%	40' +	40' +	внс	SHADING	E, N, DT, D	24	APPLICANT:
E IN WILLOW TTLEBRUSH	24" BOX -100%	20' +	25' +	LC, OVAL ROUND	SHADING	E, N, DT	17	Truck.Net LLC
ER SYCAMORE	15 GAL. -100%	50' +	30' +	BHC	SHADING	D, N, DT	100	5440 MOREHOUSE DR. #4000 SAN DIEGO, CA 92121
ILLOW ISTACHE NN TREE	24" BOX -100%	15' + 25' + 20' +	10'-20' 25' + 25' +	HC, ROUND LC	SHADING ACCENT	D, N, DT	24	PROJECT: TRUCK.NET
OOD	48" BOX -100%	25' +	25'-35'	внс	SHADING	E, N, DT	5	
								8490 AVENIDA DE LA FUENTE
PINE	48" BOX -100%	30' +	20'-30'	внс	SHADING	E, N, DT	8	SUITE 5 SAN DIEGO, CA 92154
THORN	15 GAL -100%	30"	30"	HEDGE	ACCENT	E, N, DT	20	REVISION ITEM DATE
USH GRAY RUSH	1 GAL -100%	30"	30"	GRASSY, SPIKEY	SLOPE, EC	E, N	362	
NCE WILD RYE	1 GAL -100%	30"	30"	GRASSY, SPIKEY	SLOPE, EC	E, N, DT	672	$\Delta$
IE A FESCUE	1 GAL -100%	36"	60"	GRASSY, SPIKEY	ORNAMENTAL	S, N, DT	616	$\underline{\Delta}$
INTURY YUCCA PLANT	1 GAL -100%	24"	24"	SPIKEY, POINTY ROUND	ORNAMENTAL, ACCENT	E, N, DT, S	388	THIS SET ISSUE DATE
	FLATS	3"	100%	DENSE	BACKGROUND	EC, E	-	DESIGN DEVEL.     PERMIT SUBMITTAL <u>6/27/16</u>
								■ FULL SUBMITTAL7/20/16
VE SAND, CK, S	1/4", 1", 6" - 24"	1" - 24"	DESERT SCHEME CLUMP	FLAT	PEDESTRIAN CIRCULATION OPEN SPACE BASIN	HARDSCAPE, WATER EFFICIENT	TBD	■ RESUBMITTAL 1 <u>12/9/16</u>
D ED MIX	SPRAY 100%	1/2"	100%	FLAT	BOTTOM	EC	-	<ul> <li>RESUBMITTAL 2 <u>4/27/17</u></li> <li>RESUBMITTAL 3 <u>1/9/2018</u></li> </ul>
	I = NATIVE HC = BRO		DED CAN	OPY	S = SUCCU EC = EROS	JLENT SION CONTROL	-	■ RESUBMITTAL 4 <u>12/3/2018</u>
								<ul> <li>RESUBMITTAL 5 <u>9/10/2019</u></li> <li>RESUBMITTAL 6 <u>10/15/2019</u></li> </ul>
		KE	EY N	1AP				SHEET TITLE / CONTENTS
							-	PLAN, LEGEND
		i7						& KEYNOTES
			-	<u>L3</u>				
						1		
			-	_	$\searrow$			LANDSCAPE PLAN, LEGEND & KEYNOTES
								DRAWN BY: TRH ORIGINAL DATE: 1/4/2016 CHECKED BY:
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								ר <u>י</u> רו
						NO SCALE		



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ИЕ	SIZE	MATURE HE <b>I</b> GHT	SPREAD	FORM	FUNCTION	DESCRIPTION	QTY
ND PALM	24" BOX -100%	40' +	30'-40'	BHC	ORNAMENTAL	E, N, DT, P	4
D N PINE	48" BOX -100%	25' +	25'-35'	BHC	SHADING	E, N, DT	50
PALM	24" BOX -100%	50' +	20'-30'	BHC		E, N, DT	28
INE	48" BOX -100%	30' +	20'-30'	BHC	SHADING	E, N, DT	22
DD IN PINE	48" BOX -100%	25' +	25'-35'	BHC	SHADING	E, N, DT	10
INE	48" BOX -100%	30' +	20'-30'	BHC	SHADING	E, N, DT	13
I PALM	24" BOX -100%	50' +	20'-30'	Ρ	ACCENT	E, N, DT	14
X LION	24" BOX -100%	40' +	40' +	BHC	SHADING	E, N, DT, D	24
WILLOW LEBRUSH	24" BOX -100%	20' +	25' +	LC, OVAL ROUND	SHADING	E, N, DT	17
CAMORE	15 GAL. -100%	50' +	30' +	BHC	SHADING	D, N, DT	100
OW FACHE TREE	24" BOX -100%	15' + 25' + 20' +	10'-20' 25' + 25' +	HC, ROUND LC	SHADING ACCENT	D, N, DT	24
DD N PINE	48" BOX -100%	25' +	25'-35'	BHC	SHADING	E, N, DT	5
INE	48" BOX -100%	30' +	20'-30'	внс	SHADING	E, N, DT	8
ORN	15 GAL -100%	30"	30"	HEDGE	ACCENT	E, N, DT	20
SH RAY RUSH	1 GAL -100%	30"	30"	GRASSY, SPIKEY	SLOPE, EC	E, N	362
E WILD RYE	1 GAL -100%	30"	30"	GRASSY, SPIKEY	SLOPE, EC	E, N, DT	672
ESCUE	1 GAL -100%	36"	60"	GRASSY, SPIKEY	ORNAMENTAL	S, N, DT	616
TURY CCA ANT	1 GAL -100%	24"	24"	SPIKEY, POINTY ROUND	ORNAMENTAL, ACCENT	E, N, DT, S	388
	FLATS	3"	100%	DENSE	BACKGROUND	EC, E	-
SAND,	1/4", 1", 6" - 24"	1" - 24"	DESERT SCHEME CLUMP	FLAT	PEDESTRIAN CIRCULATION OPEN SPACE	HARDSCAPE, WATER EFFICIENT	TBD
міх	SPRAY 100%	1/2"	100%	FLAT	BASIN BOTTOM	EC	-
N = NATIVE S = SUCCULENT BHC = BROAD-HEADED CANOPY EC = EROSION CONTROL							

trh
1350 Социмвід ST. Suite 702 San Diego, са 92101 TEL (619) 230-1088 FAX (619) 230-1089 trhinc.com
CENSED ARG/// CENSE (CENSE
APPLICANT: Truck.Net LLC 5440 MOREHOUSE DR. #4000 SAN DIEGO, CA 92121
PROJECT: TRUCK.NET

8490 AVENIDA DE LA FUENTE SUITE 5 SAN DIEGO, CA 92154

CUP

	-	
REVISION	ITEM	DATE
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### THIS SET ISSUE DATE □ SCHEMATIC DESIGN DEVEL. PERMIT SUBMITTAL \_6/27/16 ■ FULL SUBMITTAL \_ 7/20/16 RESUBMITTAL 1 12/9/16 RESUBMITTAL 2 4/27/17 RESUBMITTAL 3 1/9/2018 ■ RESUBMITTAL 4 12/3/2018 RESUBMITTAL 5 <u>9/10/2019</u> ■ RESUBMITTAL 6 10/15/2019 SHEET TITLE / CONTENTS LANDSCAPE PLAN, LEGEND & KEYNOTES $\triangleright$

TRH PROJECT#: 248-13-CUP SCALE: DRAWN BY: TRH ORIGINAL DATE: 1/4/2016 CHECKED BY

SHEET: 28

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#### GENERAL NOTES

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1. APPROVAL OF THESE PLANS BY THE CITY ENGINEER DOES NOT AUTHORIZE ANY WORK TO BE PERFORMED UNTIL A PERMIT HAS BEEN ISSUED.

2. THE APPROVAL OF THIS PLAN OR ISSUANCE OF A PERMIT BY THE CITY OF SAN DIEGO DOES NOT AUTHORIZE THE SUBDIVIDER AND OWNER TO VIOLATE ANY FEDERAL, STATE OR CITY LAWS, ORDINANCES, REGULATIONS, OR POLICIES, INCLUDING, BUT NOT LIMITED TO, THE FEDERAL ENDANGERED SPECIES ACT OF 1973 AND AMENDMENTS THERETO (16 USC SECTION 1531 ET.SEQ.).

3. THE CONTRACTOR SHALL BE RESPONSIBLE FOR SURVEY MONUMENTS AND/OR VERTICAL CONTROL BENCHMARKS WHICH ARE DISTURBED OR DESTROYED BY CONSTRUCTION. A LAND SURVEYOR MUST FIELD LOCATE, REFERENCE, AND/OR PRESERVE ALL HISTORICAL OR CONTROLLING MONUMENTS PRIOR TO ANY EARTHWORK. IF DESTROYED, A LAND SURVEYOR SHALL REPLACE SUCH MONUMENTS WITH APPROPRIATE MONUMENTS. A CORNER RECORD OR RECORD OF SURVEY, AS APPROPRIATE, SHALL BE FILED AS REQUIRED BY THE PROFESSIONAL LAND SURVEYORS ACT, SECTION 8711 OF THE BUSINESS AND PROFESSIONS CODE OF THE STATE OF CALIFORNIA, IF ANY VERTICAL CONTROL IS TO BE DISTURBED OR DESTROYED, THE CITY OF SAN DIEGO FIELD SURVEY SECTION MUST BE NOTIFIED, IN WRITING, AT LEAST 3 DAYS PRIOR TO THE CONSTRUCTION. THE CONTRACTOR WILL BE RESPONSIBLE FOR THE COST OF REPLACING ANY VERTICAL CONTROL CONTROL CONTROL FOR THE COST OF

4. IMPORTANT NOTICE: SECTION 4216 OF THE GOVERNMENT CODE REQUIRES A DIG ALERT IDENTIFICATION NUMBER BE ISSUED BEFORE A "PERMIT TO EXCAVATE" WILL BE VALID. FOR YOUR DIG ALERT I.D. NUMBER, CALL UNDERGROUND SERVICE ALERT, TOLL FREE 1-800-422-4133, TWO DAYS BEFORE YOU

5. CONTRACTOR SHALL IMPLEMENT AN EROSION AND SEDIMENT CONTROL PROGRAM DURING THE PROJECT GRADING AND/OR CONSTRUCTION ACTIVITIES. THE PROGRAM SHALL MEET ALL APPLICABLE REQUIREMENTS OF THE STATE WATER RESOURCE CONTROL BOARD AND THE CITY OF SAN DIEGO MUNICIPAL CODE AND STORM WATER STANDARDS MANUAL.

6. "PUBLIC IMPROVEMENT SUBJECT TO DESUETUDE OR DAMAGE." IF REPAIR OR REPLACEMENT OF SUCH PUBLIC IMPROVEMENTS IS REQUIRED, THE OWNER SHALL OBTAIN THE REQUIRED PERMITS FOR WORK IN THE PUBLIC RIGHT-OF-WAY, SATISFACTORY TO THE PERMIT- ISSUING AUTHORITY.

7. ALL EXISTING AND/OR PROPOSED PUBLIC UTILITY SYSTEM AND SERVICE FACILITIES SHALL BE INSTALLED UNDERGROUND IN ACCORDANCE WITH SECTION 144.0240 OF THE MUNICIPAL CODE.

8. PRIOR TO ANY DISTURBANCE TO THE SITE, EXCLUDING UTILITY MARK-OUTS AND SURVEYING. TH CONTRACTOR SHALL MAKE ARRANGEMENTS FOR A PRE-CONSTRUCTION MEETING WITH THE CITY OF SAN DIEGO FIELD ENGINEERING DIVISION (858) 627-3200.

9. DEVIATIONS FROM THESE SIGNED PLANS WILL NOT BE ALLOWED UNLESS A CONSTRUCTION CHANGE IS APPROVED BY THE CITY ENGINEER OR THE CHANGE IS REQUIRED BY THE CITY INSPECTOR.

10. AS-BUILT DRAWINGS MUST BE SUBMITTED TO THE RESIDENT ENGINEER PRIOR TO ACCEPTANCE OF THIS PROJECT BY THE CITY OF SAN DIEGO.

11. AN AS-GRADED GEOTECHNICAL REPORT AND A SET OF THE REDLINE GRADING PLANS SHALL BE SUBMITTED AT AREA 3 ON THE THIRD FLOOR OF DEVELOPMENT SERVICES WITHIN 30 CALENDAR DAYS OF THE COMPLETION OF GRADING. AN ADDITIONAL SET SHALL BE PROVIDED TO THE RESIDENT ENGINEER OF THE FIELD ENGINEERING DIVISION AT 9485 AERO DR.

12. THE AREA WHICH IS DEFINED AS A NON GRADING AREA AND WHICH IS NOT TO BE DISTURBED SHALL BE STAKED PRIOR TO START OF THE WORK. THE PERMIT APPLICANT AND ALL OF THEIR REPRESENTATIVES OR CONTRACTORS SHALL COMPLY WITH THE REQUIREMENTS FOR PROTECTION OF THIS REFRESENTATIVES OR CONTRACTORS SHALL COMPLY WITH THE REQUIREMENTS FOR PROTECTION OF THIS AREA AS REQUIRED BY ANY APPLICABLE AGENCY. ISSUANCE OF THE CITY'S GRADING PERMIT SHALL NOT RELIEVE THE APPLICANT OR ANY OF THEIR REPRESENTATIVES OR CONTRACTORS FROM COMPLYING WITH ANY STATE OR FEDERAL REQUIREMENTS BY AGENCIES INCLUDING BUT NOT LIMITED TO CALIFORNIA REGIONAL WATER QUALITY CONTROL BOARD, CALIFORNIA DEPARTMENT OF FISH AND GAME. COMPLIANCE MAY INCLUDE OBTAINING PERMITS, OTHER AUTHORIZATIONS, OR COMPLIANCE WITH MANDATES BY ANY APPLICABLE STATE OR FEDERAL AGENCY.

13. CONTRACTOR SHALL REMOVE AND REPLACE ALL UTILITY BOXES SERVING AS HANDHOLES THAT ARE 13. CONTRACTOR STALL REMOVE AND KEPLACE ALL UTILITY DOLES JERVING AS THANDHOLES THAT ARE NOT IN "AS-NEW" CONDITION IN PROPOSED SIDEWALK. DAMAGED BOXES, OR THOSE THAT ARE NOT IN COMPLIANCE WITH CURRENT CODE SHALL BE REMOVED AND REPLACED WITH NEW BOXES, INCLUDING WATER, SEWER, TRAFFIC SIGNALS, STREET LIGHTS, DRY UTILITES-SDO&&, COX, ETC. ALL NEW METAL LIDS SHALL BE SUP RESISTANT (FRICTION FACTOR >/= 0.50) AND INSTALLED FLUSH WITH PROPOSED SIDEWALK GRADE. IF A SUP RESISTANT WETAL LID IS NOT COMMERCIALLY AVAILABLE FOR THAT USE, NEW BOXES AND LIDS SHALL BE INSTALLED.

#### GRADING NOTES

GRADING AS SHOWN ON THESE PLANS SHALL BE IN CONFORMANCE WITH CURRENT STANDARD SPECIFICATIONS AND CHAPTER 14, ARTICLE 2, DIVISION 1, OF THE SAN DIEGO MUNICIPAL CODE.

2. PLANT AND IRRIGATE ALL CUT AND FILL SLOPES AS REQUIRED BY ARTICLE 2, DIVISION 4, SECTION 142.0411 OF THE SAN DIEGO LAND DEVELOPMENT CODE AND ACCORDING TO SECTION IV OR THE LAND DEVELOPMENT MANUAL LANDSCAPE STANDARDS.

3. GRADED, DISTURBED, OR ERODED AREAS THAT WILL NOT BE PERMANENTLY PAVED, COVERED BY STRUCTURE, OR PLANTED FOR A PERIOD OVER 90 DAYS SHALL BE TEMPORARILY RE-VEGETATED WITH A NON-IRRIGATED HYDROSEED MIX, GROUND COVER, OR EQUIVALENT MATERIAL. SEE SHEET L-1 FOR MIX AND SPECIFICATIONS.

#### PRIVATE WATER AND WASTEWATER

THE PRIVATE WATER/SEWER SYSTEM IS DESIGNED IN ACCORDANCE WITH THE CALIFORNIA PLUMBING CODE AND IS SHOWN ON THESE PLANS AS "INFORMATION ONLY". A SEPARATE PLUMBING PERMIT IS REQUIRED FOR CONSTRUCTION AND INSPECTION OF THE SYSTEM.

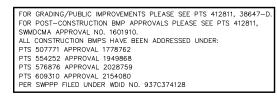
#### DECLARATION OF RESPONSIBLE CHARGE

I HEREBY DECLARE THAT I AM THE ENGINEER OF WORK FOR THIS PROJECT, THAT I HAVE EXERCISED RESPONSIBLE CHARGE OVER THE DESIGN OF THE PROJECT AS DEFINED IN SECTION 6703 OF THE BUSINESS AND PROFESSIONS CODE, AND THAT THE DESIGN IS CONSISTENT WITH CURRENT STANDARDS.

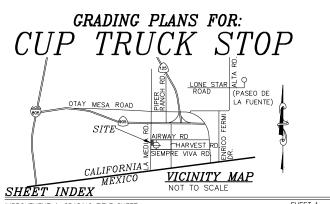
I UNDERSTAND THAT THE CHECK OF PROJECT DRAWINGS AND SPECIFICATIONS BY THE CITY OF SAN DIEGO AND OTAY WATER TO UNDERSTAND THAT THE CHECK OF PROJECT DRAWINGS AND SPELIFICATIONS BIT THE CITTOR SAM DIEGO AND UTAT WALKE DISTRICT IS CONFINED TO A REVIEW ONLY AND DOES NOT RELIEVE ME, SE EXGNEER OF WORK, OF MY RESPONSIBILITIES FOR PROJECT DESIGN.

Bantel	R	- No.36606 0 W 2 Exp.3/31/21 + 10 - 2 + -	10/22/19

BARTOLÓME J. PASTOR	R.C.E. NO.38606	EXP. 03-31-21	



ALTA CONSULTANTS PLANNING ENGINEERING SURVEYING 1283 E. MAIN ST., Ske. 109, EL CAION, CA 26202 [Phone (618) 749-8818 Pax (618) 749-8813 JOB NO. 184-120, DATED OCTOBER 22, 2019



IMPROVEMENT & GRADING TITLE SHEET		
NOTES		
STREET SECTIONS, TRENCH RESURFACING TABLE & DETAILS		
GRADING PLAN KEY MAP		
TOPOGRAPHIC PLANS		
SURFACING PLANS	SHEET	7-8
GRADING PLANS		
PRE-PROJECT DMA PLAN		
POST-DEVELOPMENT DMA PLAN		
DRAINAGE AND BMP DETAILS	SHEET	15-18

#### GROUND WATER DISCHARGE NOTES

1. ALL GROUND WATER EXTRACTION AND SIMILAR WASTE DISCHARGES TO SURFACE WATERS NOT TRIBUTARY TO THE SAN DIEGO BAY ARE PROHIBITED UNTIL IT CAN BE DEMONSTRATED THAT THE OWNER HAS APPLIED AND OBTAINED AUTHORIZATION FROM THE STATE OF CALIFORNIA VIA AN OFFICIAL "ENROLLMENT LETTER" FROM THE REGIONAL WATER QUALITY CONTROL BOARD IN ACCORDANCE WITH THE TERMS, PROVISIONS AND CONDITIONS OF STATE ORDER NO. <u>R9-2015-0100</u>, NPDES<u>CAS010266</u>. 2. THE ESTIMATED MAXIMUM DISCHARGE RATES MUST NOT EXCEED THE LIMITS SET IN THE OFFICIAL "ENROLLMENT LETTER" FROM THE REGIONAL BOARD UNLESS PRIOR NOTIFICATION AND SUBSEQUENT AUTHORIZATION HAS BEEN OBTAINED, AND DISCHARGE OPERATIONS

MODIFIED TO ACCOMMODATE THE INCREASED RATES 3. ALL GROUND WATER EXTRACTIONS AND SIMILAR WASTE DISCHARGES TO SURFACE WATERS TRIBUTARY TO THE SAN DIEGO BAY ARE PROHIBITED UNTIL IT CAN BE DEMONSTRATED THAT THE OWNER HAS APPLIED AND OBTAINED AUTHORIZATION FROM THE STATE OF CALIFORNIA VIA AN OFFICIAL "ENROLLMENT LETTER" FROM THE REGIONAL WATER QUALITY CONTROL BOARD IN ACCORDANCE WITH THE TERMS, PROVISIONS AND

#### GRADING & GEOTECHNICAL SPECIFICATIONS

1. ALL GRADING SHALL BE DONE UNDER OBSERVATION AND TESTING BY A QUALIFIED CIVIL ENGINEER OR GEOTECHNICAL ENGINEER AND, IF REQUIRED, BOTH A QUALIFED CIVIL ENGINEER OR GEOTECHNICAL ENGINEER AND AN ENGINEERING GEOLOGIST, ALL GRADING MUST BE PERFORMED IN ACCORDANCE WITH APPLICABLE CITY ORDINANCE AND THE RECOMMENDATIONS AND SPECIFICATIONS SET FORTH IN THE SOLS REPORT OR GEOLOGICAL/GEOTECHNICAL INVESTIGATION ENTITLED:

REPORT TITLE, REPORT OF AS GRADED CONDITIONS AND CHANGE OF GEOTECHNICAL ENGINEER OF RECORD BORDER BUSINESS PARK, SAN DIEGO, CA 22154, PREPARED BY GEOCON DATED NOVEMBER 3, 2015; THEIR COMPANY PROJECT NO. <u>G1873-32-01</u>

SIGNED BE AND ALL OF A CALIFORNIA CERTIFIED ENGINEERING GEOLOGIST.

A IF THE GEOTECHNICAL CONSULTANT OF RECORD IS CHANGED FOR THE PROJECT, THE WORK SHALL BE STOPPED UNTIL THE REPLACEMENT HAS AGREED IN WRITING TO ACCEPT THE RESPONSIBILITY WITHIN THE AREA OF THEIR TECHNICAL COMPETENCE FOR APPROVAL UPON COMPLETION UPON COMPLETION OF THE WORK. IT SHALL BE THE DUTY OF THE PREMITTEE TO NOTFY THE CITY EVOINCER AND THE GEOLOGY SECTION OF DEVELOPMENT SERVICES IN WRITING OF SUCH CHANGE PRIOR TO THE RECOMMENCEMENT OF GRADING.

5. THESE GRADING PLANS HAVE REEN REVIEWED BY THE UNDERSIGNED AND FOUND TO BE IN CONFORMANCE WITH THE RECOMMENDATIONS AND SPECIFICATIONS CONTAINED IN THE REFERENCED GEOTECHNICAL REPORT(S) PREPARED FO THIS PROJECT

G.E. 2842		GEOCON
R.C.E. OR G.E.	DATE	6960 FLANDERS DRIVE.
C.E.G. 1860		SAN DIEGO, CA 92121 PHONE: (858) 558-6100
C.E.G.	DATE	
	C.E.G. 1860	C.E.G. 1860

ARE NOT FROM THE SAME COMPANY, BOTH COMPANY NAMES AND PHONE NUMBERS MUST BE PROVIDED 6. FOR SOIL FILE SEE CITY RECORD S - PTS- 412811

#### EARTHWORK

SUITE 109 EL CAJON, CA 92021 COMPANY PHONE 619-749-8818 COMPANY FAX 619-749-8806 ALTACONSULTANTS@AOL.COM

DATE

#### CUT = 4,415 C.Y. FILL= 4,484 C.Y. NET = 69 C.Y. BALANCE AT 4,400 C.Y. EARTHWORK TO FINISH SURFACE DES NOT INCLUDE TRENCING, SPOILS, PAVEMENT UNDERCUT OR EXCAVATION REQUIRED TO INSTALL PERMANENT BMP'S SUCH AS TRENCH DRAINS & BIO-FILTRATION.

#### OWNER/APPLICANT

NATIONAL ENTERPRISES, INC 5440 MOREHOUSE DRIVE, # 4000, SAN DIEGO CA 92121. (858) 623-9000

#### SITE ADDRESS

OTAY MESA COMMUNITY, SAN DIEGO CA 92154

ASSESSORS PARCEL NUMBERS

PORTION OF APN 646-120-41 & APNS 646-120-42 THROUGH 45

#### LEGAL DESCRIPTION

PARCEL 3 OF PARCEL MAP NO. 19322, RECORDED SEPTEMBER 10, 2003, IN THE CITY OF SAN DIEGO, COUNTY OF SAN DIEGO, STATE OF CALIFORNIA, TOGETHER WITH PARCEL 2 OF PARCEL MAP NO. 21707, RECORDED AUGUST 9, 2019, IN THE CITY OF SAN DIEGO, COUNTY OF SAN DIEGO, STATE OF CALIFORNIA.

#### REFERENCE DRAWINGS

IMPROVEMENT PLAN: 24004-D, 25130-D, 23744-D, 23712-D, 38647-D 38936-D

#### BENCHMARK

S.E.B.P. HARVEST ROAD AT OTAY CENTER DRIVE ELEV. 534.095 MSL DATUM TODOCDADUY SOUDCE

OFUGNAFIII SUUNC	Б
ERCATOR ASSOCIATES, INC. 396 CHAPARRAL DRIVE 157A, CALIFORNIA HONE: 760–599–7390 MALL: MERCATOR@MERCATORUSA.COM LOWN OCTOBER 2013	ALTA CONSULTANTS 1283 E. MAIN STREET, SUITE 109 EL CAJON, CA 92021 PHONE: 619-749-8818 FAX: 619-749-8806 ALTACONSULTANTS@AOL.COM AERIAL PANELS SET SEPTEMBER 1, 2013

#### TOTAL DISTURBED AREA

TOTAL SITE TO BE DISTURBED BY 38647-D = 2.93 AC TOTAL SITE TO BE DISTURBED BY CUP CONST. PLANS = 0.98 AC TOTAL DISTURBED AREA FOR PROJECT = 3.91 AC GRADING QUANTITIES

GRADING TO BE DONE AS PART OF CONST. CUP PLANS 

LECEND EXISTING IMPROVEMENTS SYMBOL EXISTING CONTOUR LINE --- -- -- -- -- -- -- -- -- ---500 

#### STORM WATER PROTECTION NOTES

	THOTES	ABBREVI	ATIONS:	
1. THIS PROJECT IS SUBJECT TO MUNICIPAL STORM WATER PERMIT OF NO. <u>B-2015-0100</u> ; AND RISK LEVEL/TYPE: CHECK ONE BELOW □ WPCP □ CCP RISK LEVEL 1 □ CCP LUP TYPE 1 BX CCP RISK LEVEL 2 □ CCP LUP TYPE 2 □ CCP RISK LEVEL 3 □ CCP LUP TYPE 3 2. CHECK ONE □ THIS PROJECT WILL EXCEED THE MAXIMUM DISTURBED AF		TOP OF CUR	B TC ACE GRADE FC R FI TE T F	G WATE
THEREFORE A WEATHER TRIGGERED ACTION PLAN (WTAP)	IS REQUIRED.			
THIS PROJECT WILL FOLLOW PHASED GRADING NOT TO EX ACRES PER PHASE. NOT APPLICABLE THE OPTICADELE	.,		0P	POS ERATIO
3. THE CONTRACTOR SHALL COMPLY WITH THE REQUIREMENTS OF THE	WPUP OR SWPPP AS APP	LICABLE	STORM WATER M	ANAGEMENT
				O&M R
	BMP DESC	RIPTION	INSPECTION FREQUENCY	MAINTENA FREQUEN
	SITE DESIGN		SEMI-ANNUALLY	AS REQUIRED
	SOURCE CONTROL			
	STORM DRAIN SIGN	IAGE (SD-13)	SEMI-ANNUALLY	AS REQUIRED
	TREATMENT CONTROL			
	BIO-DETENTION B	ASINS	POST RAIN EVENT	2 X A YEAR

							AS REQUIRED
	STREET DATA TAI	BLE			FLOW CONTROL		
STREET NAME		SPEED	ADT	R/W	GRAVEL TRENCH DRAINS	POST RAIN EVENT	2 X A YEAR
SIREET NAME	CEASSIFICATION	(MPH)	(VEHICLES)	(FT)			AS REQUIRED
AVENIDA DE LA FUENTE	INDUSTRIAL LOCAL STREET	25	2,000	84			
AVENIDA COSTA NORTE	INDUSTRIAL LOCAL STREET	25	2,000	70			
AVENIDA COSTA AZUL	INDUSTRIAL LOCAL STREET	25	2,000	70	HMP FACILITY	11/1//	1111111
AIRWAY ROAD	4 LANE MAJOR STREET	45	13,357	VARIES			
LA MEDIA ROAD (PER 38936-D)	4 LANE MAJOR STREET	45		VARIES			
	STREET NAME AVENDA DE LA FUENTE AVENDA COSTA NORTE AVENDA COSTA AZUL ARWAY ROAD LA MEDIA ROAD (PER 38936–D)	STREET NAME CLASSIFICATION AVENDA DE LA FUENTE INDUSTRIAL LOCAL STREET AVENDA COSTA NORTE INDUSTRIAL LOCAL STREET AVENDA COSTA AZUL INDUSTRIAL LOCAL STREET AVENDA COSTA AZUL AVENTAL LOCAL STREET	AVENDA DE LA FUENTE         INDUSTRIAL LOCAL STREET         (MPH)           AVENDA COSTA NORTE         INDUSTRIAL LOCAL STREET         25           AVENDA COSTA AZUL         INDUSTRIAL LOCAL STREET         25           ARWAY ROAD         4 LANE MAJOR STREET         45	STREET NAME         CLASSIFICATION         SPEED (MPH)         ADT (MPH)           AVENDA DE LA FUENTE         INDUSTRAL LOCAL STREET         25         2,000           AVENDA COSTA NORTE         INDUSTRAL LOCAL STREET         25         2,000           AVENDA COSTA AUL         INDUSTRAL LOCAL STREET         45         13,357	STREET NAME         CLASSIFICATION         SPEED (MPH)         ADT (VMEH)         R/W (FT)           AVENDA DE LA FUENTE         INDUSTRIAL LOCAL STREET         25         2,000         84           AVENDA COSTA NORTE         INDUSTRIAL LOCAL STREET         25         2,000         70           AVENDA COSTA AULI         INDUSTRIAL LOCAL STREET         25         2,000         70           AVENDA COSTA AULI         INDUSTRIAL LOCAL STREET         25         2,000         70           AVENDA COSTA AULI         INDUSTRIAL LOCAL STREET         45         13,357         VARIES	STREET NAME         CLASSIFICATION         SPEED (MFH)         ADT (WFH)         RAT (VERICLES)         RAT (FT)         GRAVEL TRENCH DRAINS           AVENDA DE LA FUENTE         INDUSTRIAL LOCAL STREET         25         2,000         84           AVENDA COSTA NORTE         INDUSTRIAL LOCAL STREET         25         2,000         70           AVENDA COSTA AZUL         INDUSTRIAL LOCAL STREET         25         2,000         70           AVENDA COSTA AZUL         INDUSTRIAL LOCAL STREET         25         2,000         70           AVENDA COSTA AZUL         INDUSTRIAL LOCAL STREET         25         2,000         70	STREET NAME         CLASSIFICATION         SPEED (MPH)         ADT (VEHICLES)         R/W         GRAVEL TRENCH DRAINS         POST RAIN EVENT           AVENDA DE LA FUENTE         INDUSTRIAL LOCAL STREET         25         2,000         84

### WORK TO

#### THE IMPROVEMENTS ( AND THE SPECIFICATI STANDARD S DOCUMENT NO. PITS070112-01

PITS070112-02

PITS070112-04

PITS070112-06

	ATTACHMENT 13
WORK TO BE DONE	
THE IMPROVEMENTS CONSIST OF THE FOLLOWING WORK TO BE DONE ACCORDING TO AND THE SPECIFICATIONS AND STANDARD DRAWINGS OF THE CITY OF SAN DIEGO STANDARD SPECIFICATIONS:	THESE PLANS trh
DOCUMENT NO. DESCRIPTION PITS070112-01 STANDARD SPECIFICATIONS FOR PUBLIC WORKS	IN C.
CONSTRUCTION (GREENBOOK), 2012 EDITION PITS070112-02 CITY OF SAN DIEGO STANDARD SPECIFICATIONS CONSTRUCTION (WHITE BOOK), 2012 EDITION	SU TE 702
PITS070112-04 CALIFORNIA DEPARTMENT OF TRANSPORTATION N TRAFFIC CONTROL DEVICES, 2012 EDITION.	IANUAL OF UNIFORM 5AN DIEGO, CA 92101 TEL (619) 230-1088
PITS070112-06 CALIFORNIA DEPARTMENT OF TRANSPORTATION L STANDARD SPECIFICATIONS, 2010 EDITION	I.S. CUSTOMARY FAX (619) 230-1089
STANDARD DRAWINGS: DOCUMENT NO. DESCRIPTION	
PITS070112-03 CITY OF SAN DIEGO STANDARD WORKS CON DRAWINGS FOR PUBLIC 2012 EDITION PITS070112-05 CALIFORNIA DEPARTMENT OF CUSTOMARY S	
TRANSPORTATION U.S. 2010 EDITION WATER AGENCIES' STANDARD SPECIFICATION	
LEGEND	<u></u>
RIGHT-OF-WAY LINE	
SET BACK LINE	
PROPOSED DIRECTION OF FLOW	
PROPOSED 2:1 MAX CUT SLOPE	Truck.Net LLC
DAYLIGHT LINE	FILL
PROPOSED CONTOR	500
ITEM         STANDARD DWG.           SAWCUT EX. AC PAVING	<u>SYMBOL</u> 5440 MOREHOUSE DR. #4000 SAN DIEGO, CA 92121
CONCRETE PAVING	PROJECT:
TRENCH RESURFACING	
DG SURFACING — — — — — — — — — — — — —	
AC PAVING (PRIVATE) 6" CURB & GUTTER PER DETAIL ON SHEET 18 (PRIVATE) 6" CURB SDG-150	
CONCRETE COMMERCIAL DRIVEWAY SIZE PER PLAN_SDG-163	- 8490 AVENIDA DE LA FUENTE SUITE 5
60' CONCRETE COMMERCIAL DRIVEWAY _SDG-120	SAN DIEGO, CA 92154
DRAINAGE IMPROVEMENTS	REVISION ITEM DATE
(PRIVATE) RCP OR HDPE STORM DRAIN (SIZE PER PLAN)	
(PRIVATE) WINGED HEADWALLS D-34, OR MANUFACTURED	
CONCRETE PIPE LUG SDRSD-D-63	-=====1]
(PRIVATE) RIP RAP ENERGY DISSIPATOR_SDD-104, SDD-105, D-40	
(PRIVATE) 18"×18" BROOKS BOX PER DETAIL ON SHEET 18	
BEST MANAGEMENT PRACTICES	- o <u>-</u>
SILT FENCE— — — — — — — — — — — — — — — — — — —	
GRAVEL OR SAND BAGS	
STORM DRAIN INLET PROTECTION — — — — — — — — — — — — — — — STABILIZED CONSTRUCTION ENTRANCE — — — — — — — — — — — — — — — — — — —	
FIRE ACCESS	
PERMANENT BMP 100 YEAR	
(PRIVATE) RETENTION BASIN PER DETAILS ON SHEETS 18-21 -	- (
(PRIVATE) GRAVEL TRENCH DETAIL PER DETAIL ON SHEETS 18-21-	RESUBMITTAL 2 _ 4/27/17_
(PRIVATE) MODIFIED A-4 CLEANOUT RISER PER DETAILS ON SHEETS 18-21- (PRIVATE) BIO-TREATMENT PER DETAIL ON SHEETS 18-21	—
IONS:	■ RESUBMITTAL 4 <u>12/3/2018</u>
TC BOTTOM OF WALL BW	RESUBMITTAL 5 <u>9/10/2019</u>
FF INVERT FLEVATION IF ENGINEERING PERMIT NO:	<u>N/A</u> RESUBMITTAL 6 <u>10/23/2019</u>
FL HYDRAULIC GRADE LINE HGL WUID NO: 9 370374128 FL HYDRAULIC GRADE LINE HGL RETAINING WALL PROJECT NO VERT IF TOP OF SLOPE TS CONSTRUCTION STRE	
PRIVATE CONTRACT STORM WATER PRIORITY: HIC	H C
POST-CONSTRUCTION PERMANENT E	
OPERATION & MAINTENANCE PROCEDURE	
RM WATER MANAGEMENT AND DISCHARGE CONTROL MAINTENANCE AGREEMENT APPROV.	
PECTION MAINTENANCE MAINTENANCE METHOD QUANT	
CUENCY FREQUENCY MAINTENANCE METHOD QUART -ANNUALLY AS REQUIRED PERVIOUS SURFACING TRUCK STORAGE AREAS 7	10 & 11
	TRH PROJECT#: 248-13-CUP
-ANNUALLY AS REQUIRED RE-PAINT OR REPLACE INLET MARKINGS AND/OR 4 PLACARDS	9, 10 & 11 SCALE: AS NOTED DRAWN BY: ALTA
T RAIN EVENT 2 X A YEAR REMOVE TRASH, DEBRIS, SEDIMENT. MOW AND/OR 1 AS REQUIRED REMOVE REMOVE DEAD VEGETATION.	DETAILS 15-18 CHECKED BY:
T RAIN EVENT 2 X A YEAR REMOVE TRASH, DEBRIS, SEDIMENT. MOW AND/OR 5	DETAILS 15-18 SHEET: 29 OF: 46
AS REQUIRED	
	GP-1 5

#### STRIPING AND SIGNING GENERAL NOTES

#### SEE SHEETS 19-21 FOR STRIPING AND SIGNAGE PLANS 1. Installation of all striping, signs and pavement markers shall be the responsibility of the Contractor

2. All striping and signing shall conform to the most recently adopted edition of the following

DESCRIPTION	EDITION	DOCUMENT NO	
STANDARD SPECIFICATIONS FOR PUBLIC WORKS CONSTRUCTION (THE "GREENBOOK")	20	PITS070	12-01
CITY OF SAN DIEGO STANDARD DRAWINGS	20	PITS070	12-03
California manual on uniform traffic control devices (CA MUTCD)	0126	PITS070112-06	

3. All signing and striping is subject to the approval of the City Engineer prior to installation and/or

4. The contractor shall remove all conflicting striping, pavement markings and legends by sandblasting and/or grinding with the seal. Any debris shall be promptly removed by the contractor.

5. Sign posts shall be installed with square perforated steel tubing with a breakaway base per City of San Diego Standard Drawing M-45.

6. All raised median noses shall be painted yellow.

7. All signs shown on the striping and signing plans shall be new signs provided and installed by the Contractor, except for existing signs specifically indicated to be relocated or to remain.

8. Striped crosswalks shall have an inside dimension of 10 feet unless indicated otherwise.

9. All limit lines/stop lines, crosswalk lines, pavement legends, and arrows (except within bike lanes) shall be thermore

10. The contractor shall notify the City Traffic Engineer at (858) 495-4741 a minimum of five (5) working days prior to and upon completion of striping and signing.

#### TRUCK HAUL ROUTE NOTES

PRIOR TO BEGINNING OF GRADING, SUBMIT A TRAFFIC CONTROL PLAN TO ENVIRONMENTAL SERVICE UNIT (ESU) FOR APPROVAL INCLUDING

1. SPECIFIC TRUCK TRAVEL ROUTES.

- 2. ANTICIPATED LENGTH OF GRADING PERIOD INVOLVING THE NEED FOR TRUCK IMPORTS OF SOIL.
- 3. TIME OF OPERATIONS.

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None TRH,

project.

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- 4. EXISTING CONDITIONS OF THE IMPACTED ROAD AREAS INCLUDING TRAFFIC AND ROAD CONDITIONS.
- 5. TRAFFIC SAFETY INCLUDING SAFETY TO RESIDENTS ON FOOT, ON BICYCLE AND IN VEHICLES, AND POSSIBLE MITIGATION FOR AVOIDANCE OF SIGNIFICANT PEAK HOUR TRAFFIC AT CERTAIN INTERCHANGES, AND
- 6. INTERCHANGE GEOMETRY TO DETERMINE IF IT WILL ALLOW SAFE USE BY THE TRUCKS.

#### EROSION AND SEDIMENT CONTROL NOTES

TEMPORARY EROSION/SEDIMENT CONTROL, PRIOR TO COMPLETION OF FINAL IMPROVEMENTS, SHALL BE PERFORMED BY THE CONTRACTOR OR QUALIFIED PERSON AS INDICATED BELOW:

1. ALL REQUIREMENTS OF THE CITY OF SAN DIEGO "LAND DEVELOPMENT MANUAL, STORM WATER STANDARDS" MUST BE INCORPORATED INTO THE DESIGN AND CONSTRUCTION OF THE PROPOSED GRADING/IMPROVEMENTS CONSISTENT WITH THE APPROVED STORM WATER POLLUTION PREVENTION PLAN (SWPPP) AND/OR WATER POLLUTION CONTROL PLAN (WPCP) FOR CONSTRUCTION LEVEL BMP'S AND FOR PERMANENT POST CONSTRUCTION TREATMENT CONTROL PERMANENT BMP'S, THE WATER QUALITY TECHNICAL REPORT (WQTR) IF APPLICABLE.

2. FOR STORM DRAIN INLETS, PROVIDE A GRAVEL BAG SILT BASIN IMMEDIATELY UPSTREAM OF INLET AS INDICATED ON DETAILS. 3. FOR INLETS LOCATED AT SUMPS ADJACENT TO TOP OF SLOPES, THE CONTRACTOR SHALL ENSURE THAT WATER DRAINING TO THE SUMP IS DIRECTED INTO THE INLET AND THAT A MINIMUM OF 1.00 FREEBOARD EXISTS AND IS MAINTAINED ABOVE THE TOP OF THE INLET. IF FREEBOARD IS NOT PROVIDED BY GRADING SHOWN ON THESE PLANS, THE CONTRACTOR SHALL PROVIDE IT VIA TEMPORARY

MEASURES, LE. GRAVEL BAGS OR DIKES.

4. THE CONTRACTOR OR QUALIFIED PERSON SHALL BE RESPONSIBLE FOR CLEANUP OF SILT AND MUD ON ADJACENT STREET(S) AND STORM DRAIN SYSTEM DUE TO CONSTRUCTION ACTIVITY.

5. THE CONTRACTOR OR QUALIFIED PERSON SHALL CHECK AND MAINTAIN ALL LINED AND UNLINED DITCHES AFTER EACH RAINFALL 6. THE CONTRACTOR SHALL REMOVE SILT AND DEBRIS AFTER EACH MAJOR RAINFALL.

7. EQUIPMENT AND WORKERS FOR EMERGENCY WORK SHALL BE MADE AVAILABLE AT ALL TIMES DURING THE RAINY SEASON. ALL NECESSARY MATERIALS SHALL BE STOCKPILED ON SITE AT CONVENIENT LOCATIONS TO FACILITATE RAPID CONSTRUCTION OF TEMPORARY DEVICES WHEN RAIN IS IMMINENT.

THE CONTRACTOR SHALL RESTORE ALL EROSION/SEDIMENT CONTROL DEVICES TO WORKING ORDER TO THE SATISFACTION OF THE Y ENGINEER OR RESIDENT ENGINEER AFTER EACH RUN-OFF PRODUCING RAINFALL.

9. THE CONTRACTOR SHALL INSTALL ADDITIONAL EROSION/SEDIMENT CONTROL MEASURES AS MAY BE REQUIRED BY THE RESIDENT ENGINEER DUE TO UNCOMPLETED GRADING OPERATIONS OR UNFORESEEN CIRCUMSTANCES, WHICH MAY ARISE.

10. THE CONTRACTOR SHALL BE RESPONSIBLE AND SHALL TAKE NECESSARY PRECAUTIONS TO PREVENT PUBLIC TRESPASS ONTO AREAS WHERE IMPOUNDED WATERS CREATE A HAZARDOUS CONDITION.

11. ALL EROSION/SEDIMENT CONTROL MEASURES PROVIDED PER THE APPROVED GRADING PLAN SHALL BE INCORPORATED HEREON. ALL EROSION/SEDIMENT CONTROL FOR INTERIM CONDITIONS SHALL BE DONE TO THE SATISFACTION OF THE RESIDENT ENGINEER.

12. GRADED AREAS AROUND THE PROJECT PERIMETER MUST DRAIN AWAY FROM THE FACE OF THE SLOPE AT THE CONCLUSION OF FACH WORKING DA

13. ALL REMOVABLE PROTECTIVE DEVICES SHOWN SHALL BE IN PLACE AT THE END OF EACH WORKING DAY WHEN RAIN IS IMMINENT.

14. THE CONTRACTOR SHALL ONLY GRADE, INCLUDING CLEARING AND GRUBBING FOR THE AREAS FOR WHICH THE CONTRACTOR OR QUALIFIED PERSON CAN PROVIDE EROSION/SEDIMENT CONTROL MEASURES.

15. THE CONTRACTOR SHALL ARRANGE FOR WEEKLY MEETINGS DURING OCTOBER 1ST TO APRIL 30TH FOR PROJECT TEAM (GENERAL CONTRACTOR, QUALIFIED PERSON, EROSION CONTROL SUBCONTRACTOR IF ANY, ENGINEER OF WORK, OWNER/DEVELOPER AND THE RESIDENT ENGINEER) TO EVALUATE THE ADEQUACY OF THE EROSION/SEDIMENT CONTROL MEASURES AND OTHER RELATED CONSTRUCTION ACTIVITIES.

#### MINIMUM POST-CONSTRUCTION MAINTENANCE PLAN

AT THE COMPLETION OF THE WORK SHOWN, THE FOLLOWING PLAN SHALL BE FOLLOWED TO ENSURE WATER QUALITY CONTROL IS MAINTAINED FOR THE LIFE OF THE PROJECT:

1. STABILIZATION: ALL PLANTED SLOPES AND OTHER VEGETATED AREAS SHALL BE INSPECTED PRIOR TO OCTOBER 1 OF EACH YEAR AND AFTER MAJOR RAINFALL EVENTS (MORE THAN ½ INCH) AND REPAIRED AND REPLANTED AS NEEDED UNTIL A NOTICE OF TERMINATION (NOT) IS FILED.

2. STRUCTURAL PRACTICES: DESILTING BASINS, DIVERSION DITCHES, DOWNDRAINS, INLETS, OUTLET PROTECTION MEASURES, AND OTHER PERMANENT WATER QUALITY AND SEDIMENT AND EROSION CONTROLS SHALL BE INSPECTED PRIOR TO OCTOBER 1ST OF EACH YEAR AND AFTER MAJOR RAINFALL EVENTS (MORE THAN ½ INCH). REPAIRS AND REPLACEMENTS SHALL BE MADE AS NEEDED AND RECORDED IN THE MAINTENANCE LOG IN PERPETUITY.

3. OPERATION AND MAINTENANCE, FUNDING: POST-CONSTRUCTION MANAGEMENT MEASURES ARE THE RESPONSIBILITY OF THE DEVELOPER UNTIL THE TRANSFER OF RESPECTIVE SITES TO HOME BUILDERS, INDIVIDUAL OWNERS, HOMEOWNERS ASSOCIATIONS, SCHOOL DISTRICTS, OR LOCAL AGENCIES AND/OR GOVERNMENTS. AT THAT TIME, THE NEW OWNERS SHALL ASSUME RESPONSIBILITY FOR THEIR RESPECTIVE PORTIONS OF THE DEVELOPMENT.

#### PERMANENT POST-CONSTRUCTION BMP NOTES

1. OPERATION AND MAINTENANCE SHALL BE SECURED BY AN EXECUTED AND RECORDED STORM WATER MANAGEMENT AND DISCHARGE CONTROL MAINTENANCE AGREEMENT (SWMDCMA), OR ANOTHER MECHANISM APPROVED BY THE CITY ENGINEER, THAT ASSURES ALL PERMANENT BMP'S WILL BE MAINTAINED IN PERPETUITY, PER THE LAND DEVELOPMENT MANUAL, STORM WATER STANDARDS.

2. PERMANENT POST CONSTRUCTION BMP DEVICES SHOWN ON PLAN SHALL NOT BE MOVED OR MODIFIED WITHOUT THE APPROVAL OF THE CITY ENGINEER OR RESIDENT ENGINEER AND THE ENGINEER OF WORK.

#### PRIVATE NOTE

ALL ONSITE, PRIVATE IMPROVEMENTS SHOWN ON THIS DRAWING ARE FOR INFORMATION ONLY. THE CITY ENGINEER'S APPROVAL OF THIS DRAWING, IN NO WAY CONSTITUTES AN APPROVAL OF SAID PRIVATE IMPROVEMENTS. A SEPARATE PERMIT FOR SUCH IMPROVEMENTS MAY BE REQUIRED.

#### CURB RAMP NOTE

ALTA CONSULTANTS

THE REQUIRED DETECTABLE WARNING (TRUNCATED DOMES) ON CURB RAMPS ARE TO COMPLY WITH THE CITY STANDARDS (SDG-130) AND SPECIFICATIONS. A 12" X 12" (MIN.) SAMPLE OF THE DETECTABLE WARNING, THE PRODUCTS' TEST REPORT AND A COPY OF THE MANUFACTURER'S INSTALLATION INSTRUCTION MUST BE SUBMITTED TO THE DESIGNATED CITY RESIDENT ENGINEER FOR REVIEW PRIOR TO INSTALLATION. FAILURE TO COMPLY WITH THE STANDARDS, SPECIFICATIONS AND SAMPLE SUBMITTED TO THE DESIGNATED CITY RESIDENT ENGINEER FOR REVIEW PRIOR TO INSTALLATION. FAILURE TO COMPLY WITH THE STANDARDS, SPECIFICATIONS AND SAMPLE SUBMITTED REVIEW PROCESS WILL RESULT IN THE REMOVAL OR REPLACEMENT OF THE DETECTABLE WARNING AND/OR CURB RAMP(S) AT CONTRACTOR AND/OR OWNER'S EXPENSE.

1283 E. MAIN STREET, SUITE 109, EL CAJON, CA 92021
COMPANY PHONE 619-749-8818
COMPANY FAX 619-749-8806
ALTACONSULTANTS@AOL.COM





ALTA CONSULTANTS PLANNING ENGINEERING SURVEYING 1285 E. Main ST., Ste. 109, EL CAION, CA 20201 Frome (619) 749-6816 Fax (619) 749-6815 JOB NO. 184-120, DATED OCTOBER 22, 2019

trh INC.

ATTACHMENT 13

1350 COLUMBIA ST. Suite 702 San Diego, ca 92101 TEL (619) 230-1088 FAX (619) 230-1089

# Truck.Net LLC

5440 MOREHOUSE DR. #4000 SAN DIEGO, CA 92121

PROJECT

## TRUCK.NET CUP

8490 AVENIDA DE LA FUENTE SUITE 5 SAN DIEGO, CA 92154

REVISION	ITEM	DATE
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THIS SET

ISSUE DATE □ SCHEMATIC

DESIGN DEVEL.

PERMIT SUBMITTAL 6/27/16

FULL SUBMITTAL 7/20/16

RESUBMITTAL 1 12/9/16

RESUBMITTAL 2 4/27/17

- RESUBMITTAL 3 1/9/2018
- RESUBMITTAL 4 12/3/2018
- RESUBMITTAL 5 9/10/2019

RESUBMITTAL 6 10/23/2019

SHEET TITLE / CONTENTS

## NOTES

TRH PROJECT#: 248-13-CUP SCALE: DRAWN BY: ORIGINAL DATE: 4/4/2016 CHECKED BY

AS NOTED ALTA

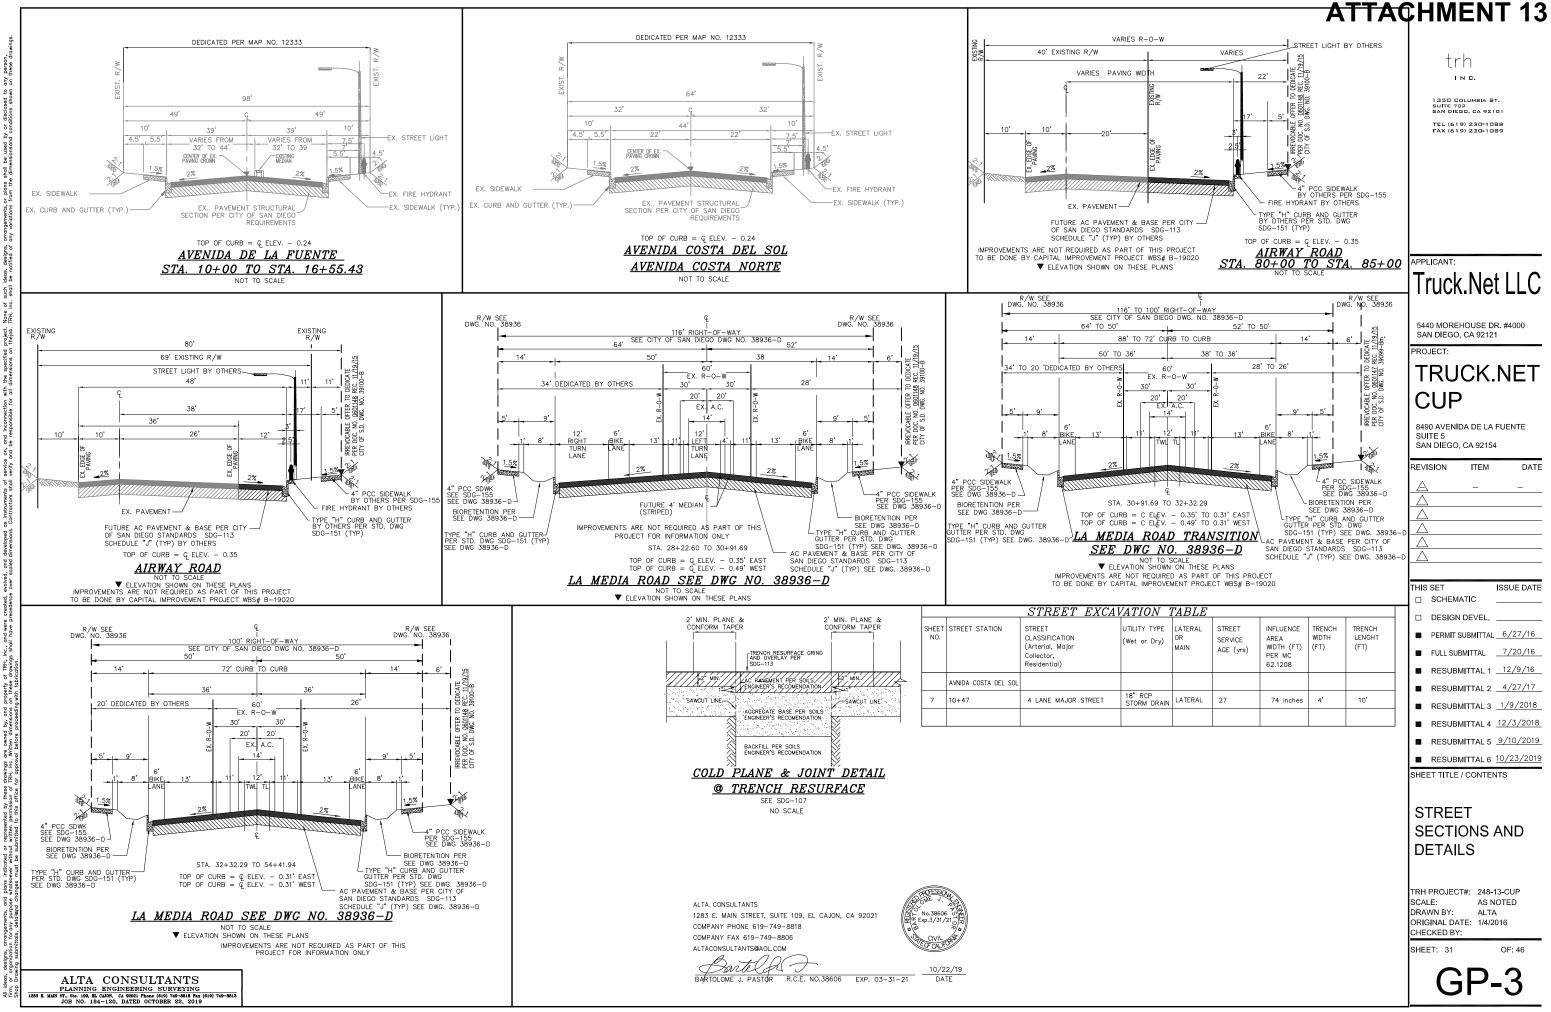
SHEET: 30

OF: 46

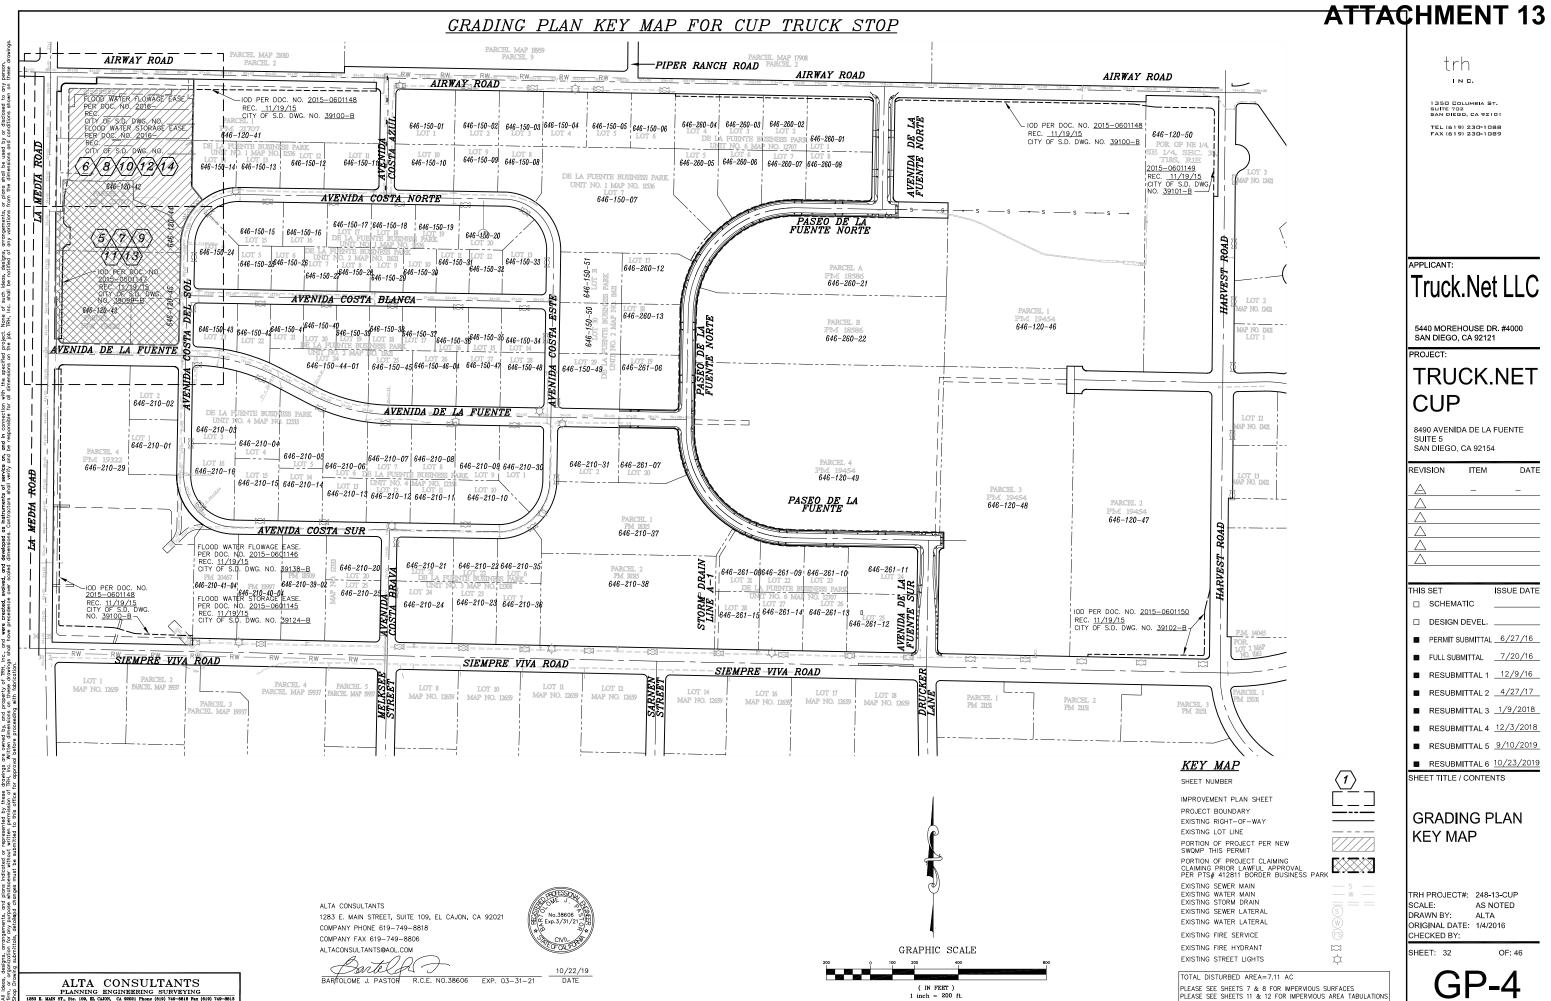




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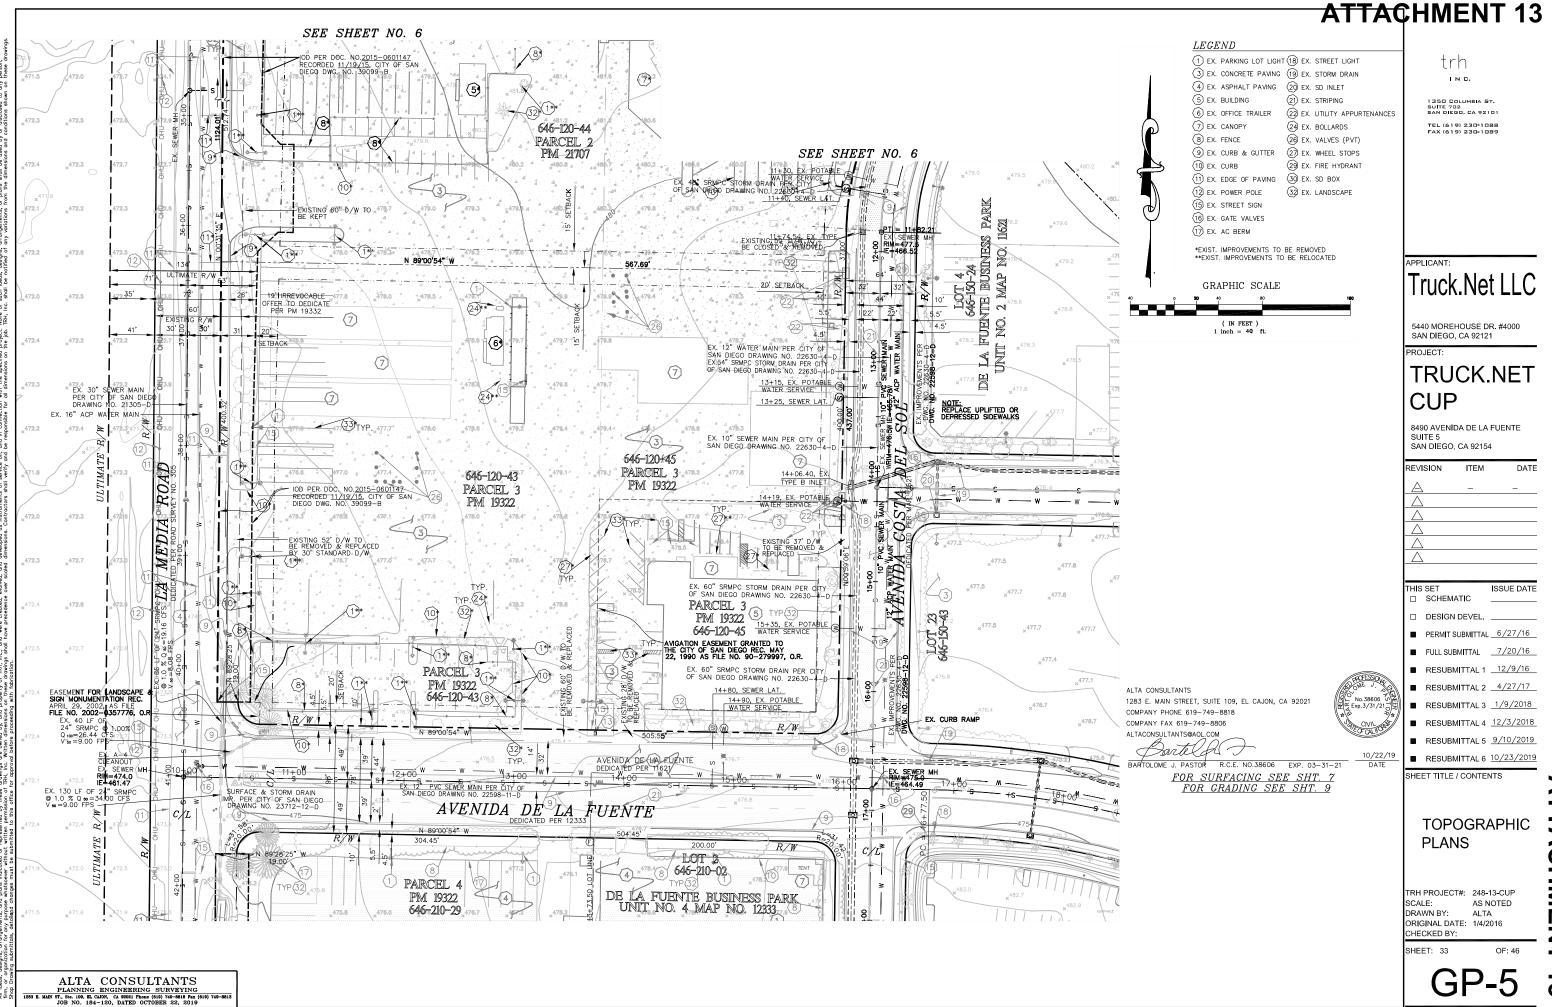
**NTTACHMENT 1** 



PLANNING ENGINEERING SURVEYING 1283 E. MAIN ST., Ste. 109, EL CAIDN, C. 392021 Phone (610) 749–6881 JOB NO. 184–120, DATED OCTOBER 22, 2019

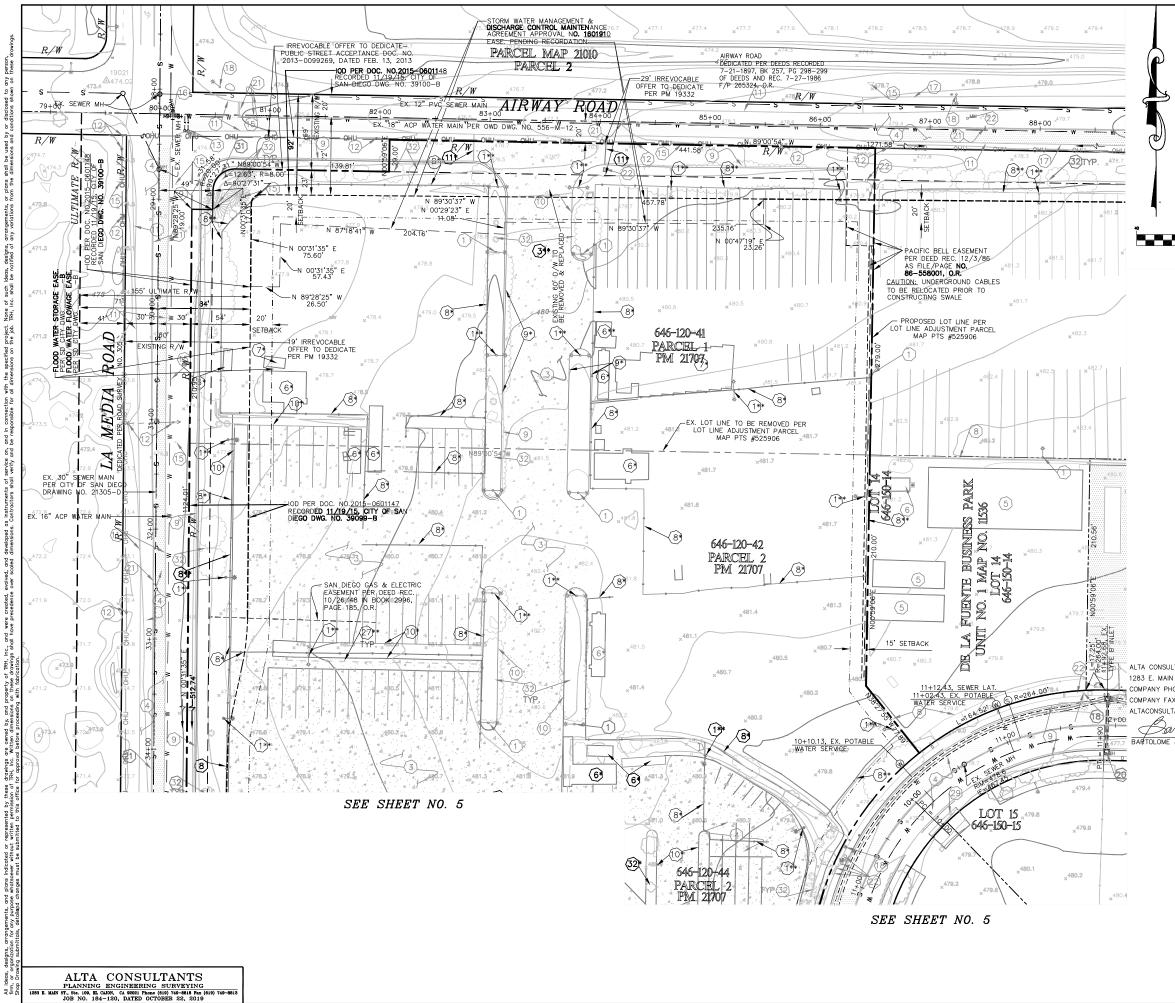
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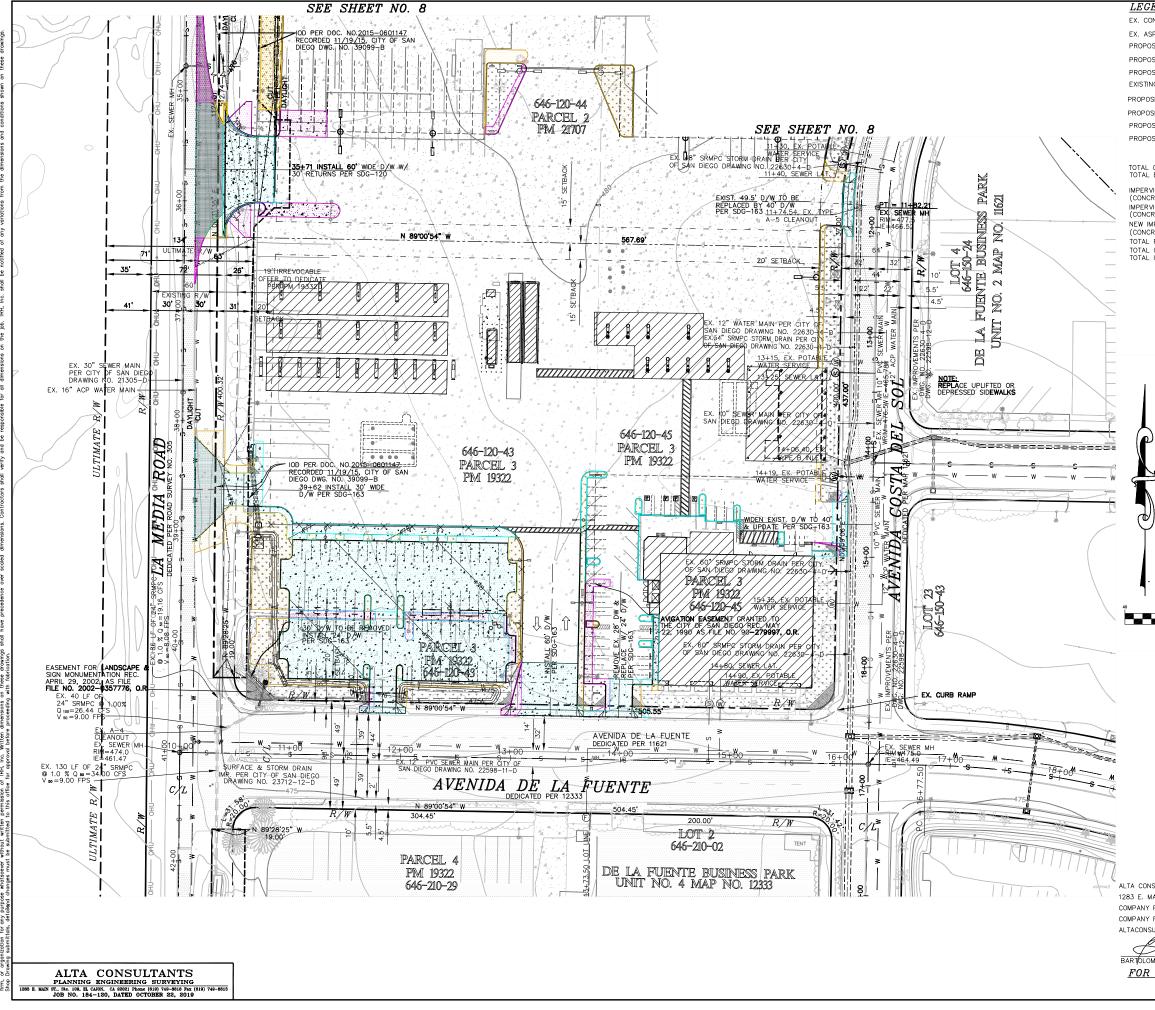
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HONE 619–749–8818 AX 619–749–8806 TANTS@ADLCOM TATS@ADLCOM TOPOGRAPHICAL 5 <u>9/10/2019</u> RESUBMITTAL 5 <u>9/10/2019</u> RESUBMITTAL 6 <u>10/23/2019</u> RESUBMITTAL 6 <u>10/23/2019</u> SHEET TITLE / CONTENTS TOPOGRAPHIC PLANS TRH PROJECT#: 248-13-CUP SCALE: AS NOTED DRAWN BY: ALTA ORIGINAL DATE: 1/4/2016 CHECKED BY: SHEET: 34 OF: 46	JLTANTS IN STREET, SUITE 109, EL CAJON, CA 92021	
TANTS@AOL.COM TALL 3	HONE 619-749-8818	
10/22/19 DATE       Image: Constraint of the second s		
RESUBMITTAL 6 10/23/2019 SHEET TITLE / CONTENTS      TOPOGRAPHIC PLANS      TRH PROJECT#: 248-13-CUP SCALE: 248-13-		
TRH PROJECT#: 248-13-CUP SCALE: AS NOTED DRAWN BY: ALTA ORIGINAL DATE: 1/4/2016 CHECKED BY: SHEET: 34 OF: 46		
PLANS TRH PROJECT#: 248-13-CUP SCALE: AS NOTED DRAWN BY: ALTA ORIGINAL DATE: 1/4/2016 CHECKED BY: SHEET: 34 OF: 46		SHEET TITLE / CONTENTS
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SCALE: AS NOTED DRAWN BY: ALTA ORIGINAL DATE: 1/4/2016 CHECKED BY: SHEET: 34 OF: 46		
ORIGINAL DATE: 1/4/2016 CHECKED BY: SHEET: 34 OF: 46		
SHEET: 34 OF: 46		DRAWN BY: ALTA
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**ATTACHMENT** 13

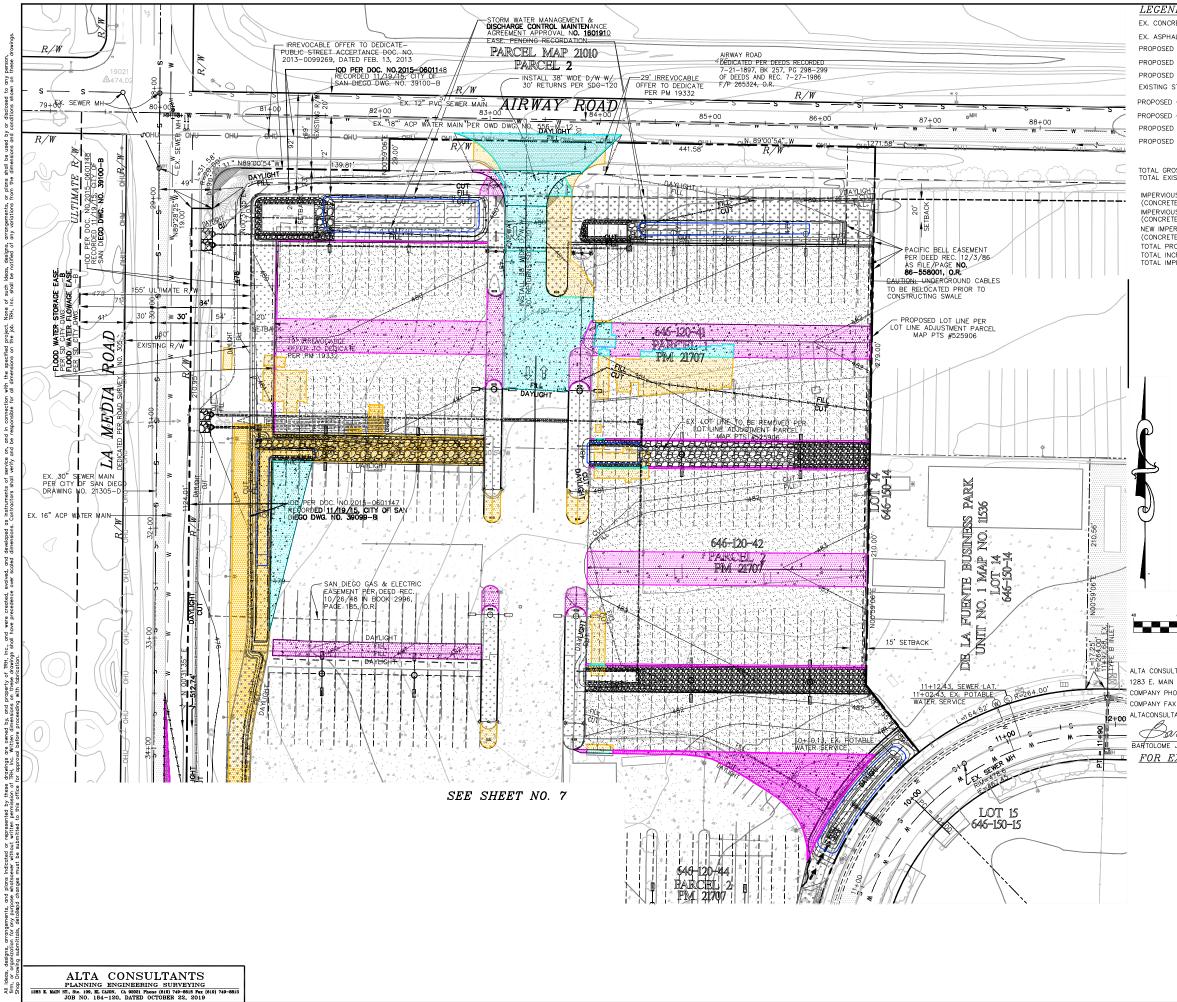


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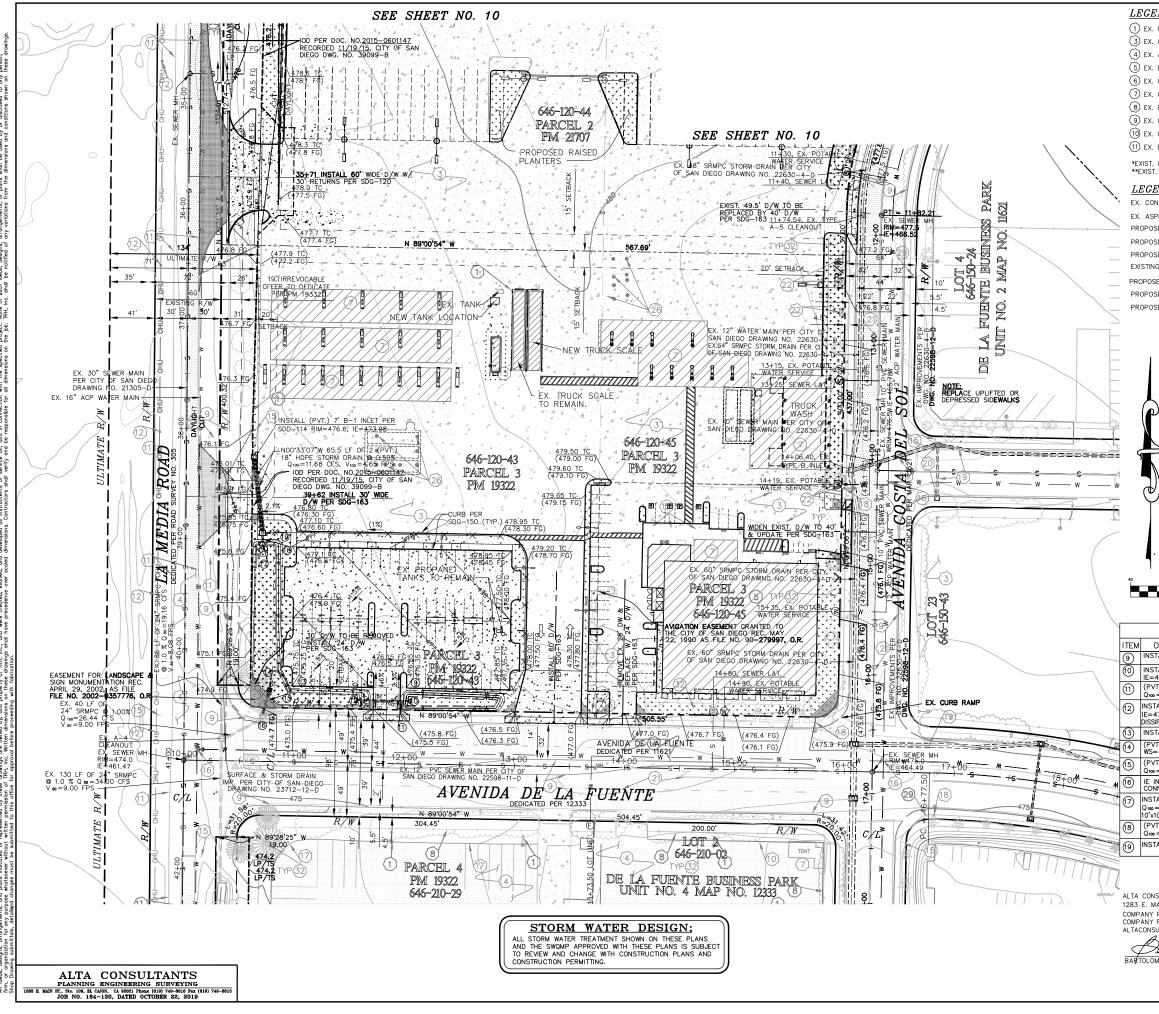
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	<b>HMENT 13</b>
NCRETE PAVING	
PHALT PAVING	
SED CONCRETE PAVING	trh
SED LANDSCAPING	IN G.
SED GRAVEL TRENCH DRAIN	1350 COLUMBIA ST. Suite 702 San Diego, ca 92101
SED GRAVEL SURFACE NO TRENCH DRAIN	TEL (619) 230-1088
SED DG / GRAVEL	FAX (619) 230-1089
SED BIO-TREATMENT	
GROSS SITE AREA=16.42 AC EXISTING IMPERVIOUS SURFACES=10.85 AC=66% OF SITE	
MOUS SURFACE REMOVED=0.97 AC	
RETE, ASPHALT) PROPOSED IMPERVIOUS SURFACES=10.80 AC=66% OF SITE	
INCREASE IN IMPERVIOUS SURFACES= $-0.05$ AC $-0.46\%$ IMPERVIOUS SURFACES IMPACTED BY THIS PROJECT= $3.00$ AC $28\%$	APPLICANT:
	Truck.Net LLC
	5440 MOREHOUSE DR. #4000 SAN DIEGO, CA 92121
	TRUCK.NET
	CUP
)	8490 AVENIDA DE LA FUENTE SUITE 5 SAN DIEGO, CA 92154
	REVISION ITEM DATE
3	
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	THIS SET ISSUE DATE
GRAPHIC SCALE	
0 <b>20</b> 40 80 <b>160</b>	DESIGN DEVEL
( IN FEET )	PERMIT SUBMITTAL _6/27/16
1  inch = 40  ft.	FULL SUBMITTAL 7/20/16
	RESUBMITTAL 2 <u>4/27/17</u>
	RESUBMITTAL 3 <u>1/9/2018</u>
	RESUBMITTAL 4 12/3/2018
	RESUBMITTAL 5 <u>9/10/2019</u>
	RESUBMITTAL 6 10/23/2019
	SHEET TITLE / CONTENTS
	SURFACING
CTREESON	
SULTANTS	TRH PROJECT#: 248-13-CUP SCALE: AS NOTED
AIN STREET, SUITE 109, EL CAJON, CA 92021	DRAWN BY: ALTA
FAX 619-749-8806	ORIGINAL DATE: 1/4/2016
ULTANTS@AOL.COM	CHECKED BY:
Barte A 10/22/19	SHEET: 35 OF: 46
ME J. PASTOR R.C.E. NO.38606 EXP. 03-31-21 DATE	
EXISTING TOPOGRAPHY SEE SHT. 5	GP-7 ;
<u>FOR GRADING SEE SHT. 9</u>	

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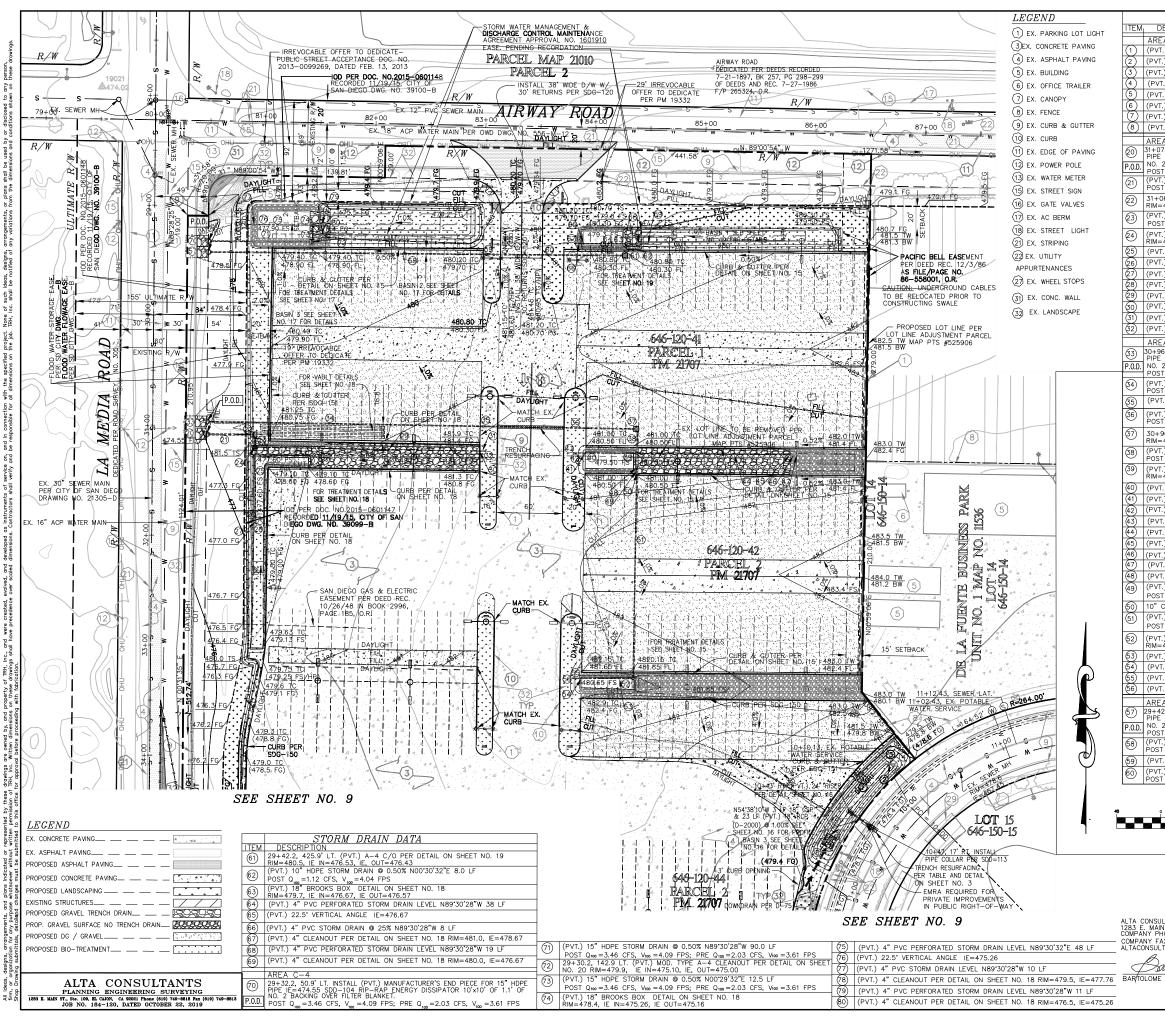
	CHMENT 13
SIND       Image: Sind Sind Sind Sind Sind Sind Sind Sind	trh IN C. 1350 COLUMBIA ST. SUITE 702 SAN DIEGO, GA 92101 TEL (619) 230-1088 FAX (619) 230-1089
GROSS SITE AREA=16.42 AC         EXISTING IMPERVIOUS SURFACES=10.85 AC=66% OF SITE         IOUS SURFACE REMOVED=0.97 AC         VETE, ASPHALT, STRUCTURES & ETC.)         IOUS SURFACE REMOVED & REPLACED=1.11 AC         PREVIOUS SURFACE-0.92 AC         VETE, ASPHALT, STRUCTURES & ETC.)         PROPOSED IMPERVIOUS SURFACES=10.80 AC=66% OF SITE         INCREASE IMPERVIOUS SURFACES=10.80 AC=66% OF SITE         INCREASE IMPERVIOUS SURFACES=0.05 AC         IMPERVIOUS SURFACES         IMPERVIOUS SURFACES         IMPERVIOUS SURFACES         IMPERVIOUS SURFACES         IMPERVIOUS SURFACES         IMPERVIOUS SURFACES	APPLICANT: Truck.Net LLC
	S440 MOREHOUSE DR. #4000 SAN DIEGO, CA 92121 PROJECT: TRUCK.NET CUP 8490 AVENIDA DE LA FUENTE SUITE 5 SAN DIEGO, CA 92154 REVISION ITEM DATE A A
GRAPHIC SCALE GRAPHIC SCALE (IN FEET) 1 inch = 40 ft. SULTANTS AIN STREET, SUITE 109, EL CAJON, CA 92021 PHONE 619-749-8818 FAX 619-749-8806 JUTANTSGAOLCOM MALE J. PASTOR R.C.E. NO.38606 EXP. 03-31-21 EXISTINC TOPOCRAPHY SEE SHT. 6 FOR CRADINC SEE SHT. 10	THIS SET       ISSUE DATE         SCHEMATIC
	SURFACING TRH PROJECT#: 248-13-CUP SCALE: AS NOTED DRAWN BY: ALTA ORIGINAL DATE: 1/4/2016 CHECKED BY: SHEET: 36 OF: 46 GP-8 13



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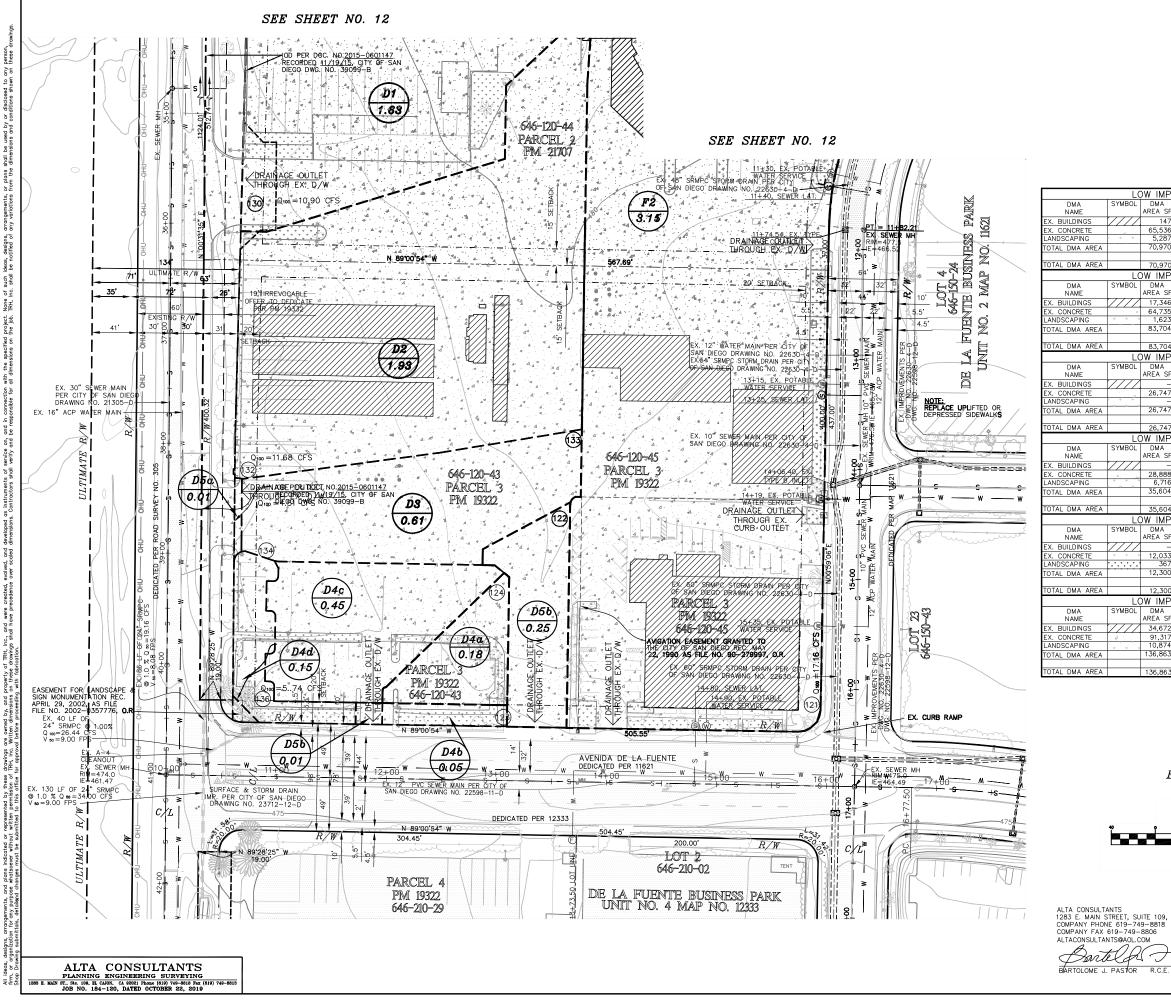
		ΔΤΤΔΛ	CHMENT 13	
PARKING LOT LICHT	(12) EX. POWER POLE			
CONCRETE PAVING	(1) EX. EDGE OF PAVIN	ž		
ASPHALT PAVING	12 EX. POWER POLE	22) EX. UTILITY APPURTENANCES	trh	
BUILDING	(15) EX. STREET SIGN	24 EX. BOLLARDS	IN G.	
OFFICE TRAILER	(16) EX. GATE VALVES	26 EX. VALVES (PVT)		
FENCE	(17) EX. AC BERM (18) EX. STREET LIGHT	(27) EX. WHEEL STOPS (29) EX. FIRE HYDRANT	1350 COLUMBIA ST. Suite 702 San Diego, ca 92101	
CURB & GUTTER	(19) EX. STORM DRAIN	30 EX. SD BOX	TEL (619) 230-1088 FAX (619) 230-1089	
CURB	20 EX. SD INLET	3 EX. LANDSCAPE		
EDGE OF PAVING	21) EX. STRIPING			
IMPROVEMENTS TO E				
<i>END</i> NCRETE PAVING				
PHALT PAVING				
SED ASPHALT PAVIN	G			
SED CONCRETE PAVI	NG			
SED LANDSCAPING _ IG STRUCTURES			APPLICANT:	
SED GRAVEL TRENCH	DRAIN		Truck.Net LLC	
SED DG / GRAVEL_ SED BIO-TREATMENT		[ <u>]</u>		
SED DIO- INEXTMENT		— — []	5440 MOREHOUSE DR. #4000 SAN DIEGO, CA 92121	
			PROJECT:	
			TRUCK.NET	
			CUP	
)			8490 AVENIDA DE LA FUENTE	
×			SUITE 5 SAN DIEGO, CA 92154	
			REVISION ITEM DATE	
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GRA	PHIC SCALE			
0 20 40	80	160	THIS SET ISSUE DATE	
	( IN FEET )		□ SCHEMATIC	
1 i	nch = 40 ft.			
	RAIN DATA (PV	T.)	PERMIT SUBMITTAL <u>6/27/16</u>	
DESCRIPTION TALL (PVT.) DOWNDF	RAIN PER D-75		FULL SUBMITTAL 7/20/16	
	ACTURER'S END PIECE FO	DR 12" HDPE PIPE	RESUBMITTAL 1 <u>12/9/16</u>	
	M DRAIN @ 1.0% N88*54'	34"E 46.83 LF	RESUBMITTAL 2 4/27/17	
5 = 1.87 CFS, V1∞=4 TALL (PVT.) MANUFA	I.51 FPS CTURER'S END PIECE FC	R 12" HDPE PIPE	RESUBMITTAL 3 <u>1/9/2018</u>	
		104 RIP-RAP ENERGY ER FILTER BLANKET.FL=474.3	RESUBMITTAL 4 <u>12/3/2018</u>	
TALL (PVT.) DOWNDF	RAIN PER D-75		RESUBMITTAL 5 9/10/2019	
/T.) TYPE F CATCH   =473.01, RIM=474.7	BASIN PER SDD-119 OPE 1, FL=473.5, IE=470.01	ENINGS ON 4-SIDES	RESUBMITTAL 6 10/23/2019	
/T.) 24" RCP STORM =21.40 CFS, V100 =8	DRAIN © 1.0% N15'59'0 3.19 FPS	6"E 21 LF	SHEET TITLE / CONTENTS	
IN=469.90, (IE OUT= NNECT TO BACK OF				J
TALL (PVT.) WINGED	WEADWALL PER D-34 IE			-
10' OF 1.1' OF NO. 2	BACKING OVER FILTER B		GRADING PLANS	-
/T.) 24" HDPE STOR =15.67 CFS, V100=5	M DRAIN @ 0.5% N01"11' 5.80 FPS	05″E 6.5 LF		J
TALL (PVT.) 6' B INL	ET PER SDD-114 IE IN=	474.65, IE OUT= 474.55		C
		COLSON:		
		BOOME . STE	TRH PROJECT#: 248-13-CUP	
ISULTANTS MAIN STREET, SUITE 1	109, EL CAJON, CA 92021	BL No.38606 0 Exp.3/31/21	SCALE: AS NOTED	
PHONE 619-749-88 FAX 619-749-8806	318	* OVIL +*	DRAWN BY: ALTA ORIGINAL DATE: 1/4/2016	Γ
SULTANTS@AOL.COM	$\frown$	ALC CALLOR	CHECKED BY:	2
Partel fl.	$\rightarrow$	10/22/19	SHEET: 37 OF: 46	-
ME J. PASTOR R.	C.E. NO.38606 EXP. (	03-31-21 DATE		_
			GP-9	C

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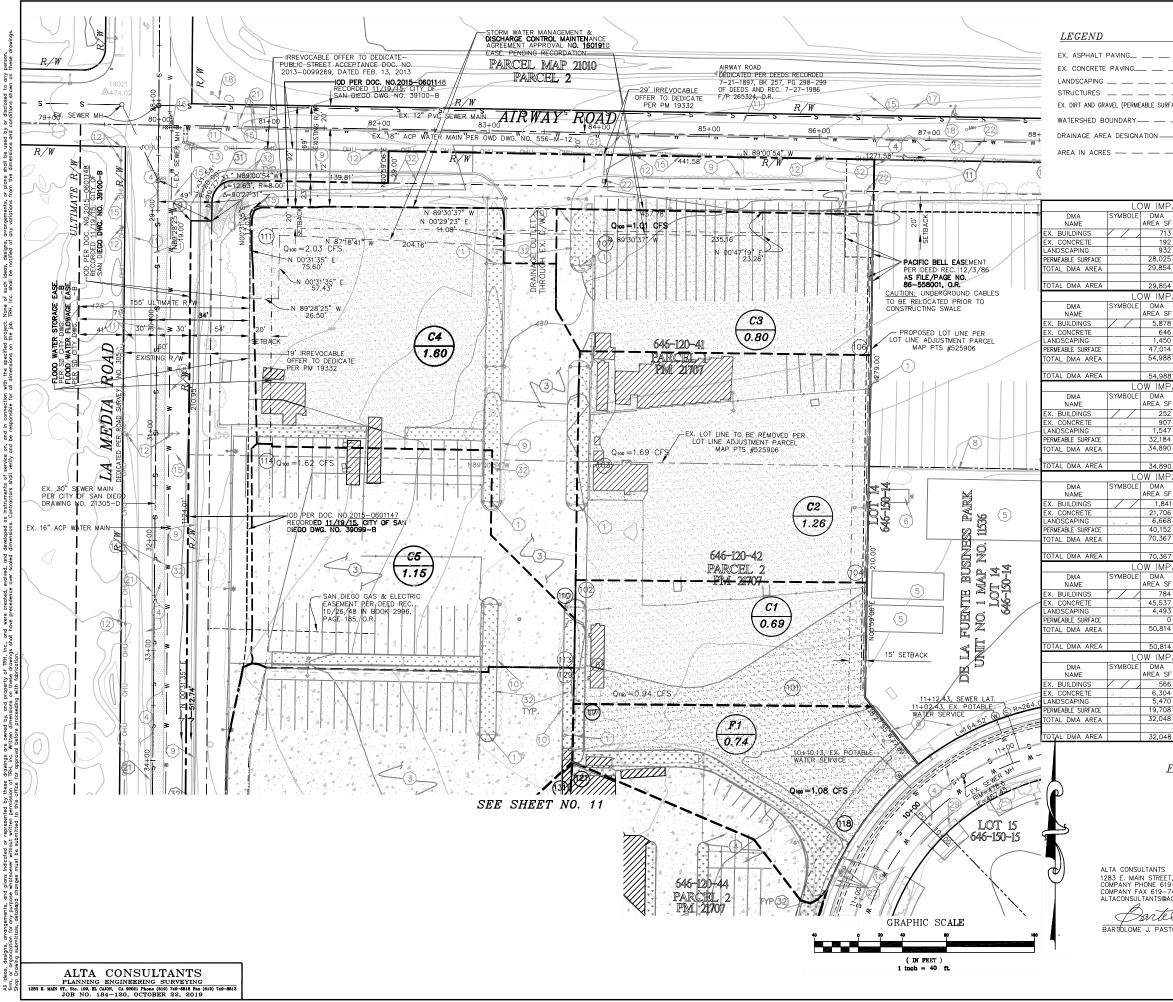
STORM DRAIN DATA ATTAL	CHMENT 13
DESCRIPTION	
EA F-1	
T.) 4" PVC PERFORATED STORM @ 0.50% N40'34'49"E 55.5 LF	4
C.) 22.5' VERTICAL ANGLE IE=472.15	l trh
<ul> <li>.) 4" PVC STORM DRAIN @ 25% N40'34'39"E 12.5 LF</li> <li>T.) 4" CLEANOUT DETAIL ON SHEET NO. 18 RIM=478.0, IE=475.28</li> </ul>	INC.
T.) 4" PVC PERFORATED STORM DRAIN @ 0.50% N3211'44"E 26.0 LF	-
r.) 22.5' VERTICAL ANGLE IE=471.57	1350 COLUMBIA ST.
T.) 4" PVC STORM DRAIN @ 25% N89'30'37"E 16.0 LF	SUITE 702 San Diego, ca 92101
T.) 4" CLEANOUT DETAIL ON SHEET NO. 18 RIM=476.0, IE=475.57	TEL (619) 230-1088
A C-5	FAX (619) 230-1089
	-
17.5, 50.9 LT. INSTALL (PVT.) MANUFACTURER'S END PIECE FOR 18" HDPE IE=474.55 SDD-104 RIP-RAP ENERGY DISSIPATOR 10'x10' OF 1.1' OF 2 BACKING OVER FILTER BLANKET.	
T $Q_{100} = 5.13$ CFS, V $_{100} = 4.53$ FPS; PRE $Q_{100} = 1.62$ CFS, V $_{100} = 3.36$ FPS	
Г.) 18" HDPE STORM DRAIN © 0.50% N89°28'25"W 38.5 LF	-
T $Q_{100} = 5.13$ CFS, $V_{100} = 4.53$ FPS; PRE $Q_{100} = 1.62$ CFS, $V_{100} = 3.36$ FPS	-
06.2, 91.9' LT. (PVT.) A–5 C/O PER D–9 & DETAIL ON SHEET NO. 21 =481.5, IE IN=474.84, IE, OUT=474.74	
T.) 18" HDPE STORM DRAIN @ 0.50% N00'31'35"E 8.00 LF	
ST $Q_{100} = 5.13$ CFS, $V_{100} = 4.53$ FPS	-
F.) TYPE "F" CATCH BASIN PER SDD-119 & DETAIL ON SHEET NO. 21 =478.1, IE IN=474.99, IE OUT=474.89	
T.) 4" PVC PERFORATED STORM DRAIN @ LEVEL NO0'35'51"E 62 LF	1
T.) 22.5° VERTICAL ANGLE IE=474.99	APPLICANT:
T.) 4" PVC STORM DRAIN @ 25% N89'00'54"W 6 LF	
.) 4" CLEANOUT PER DETAIL ON SHEET NO. 18RIM=478.00, IE=476.49	Truck.Net LLC
T.) 4" PVC PERFORATED STORM DRAIN LEVEL N89'00'54"W 202.7 LF	
.) 22.5° VERTICAL ANGLE IE=474.99	]
T.) 4" PVC STORM DRAIN @ 25% N89'00'54"W 5 LF	]
T.) 4" CLEANOUT DETAIL ON SHEET NO. 18 RIM=481.50, IE=476.24	5440 MOREHOUSE DR. #4000
EA C-2 & C-1	SAN DIEGO, CA 92121
6.2, 50.9' LT. INSTALL (PVT.) MANUFACTURER'S END PIECE FOR 12" HDPE : IE=474.55 SDD-104 RIP-RAP ENERGY DISSIPATOR 10'x10' OF 1.1' OF	PROJECT:
2 BACKING OVER FILTER BLANKET.	
T Q <sub>100</sub> =2.58 CFS, V <sub>100</sub> =3.65 FPS	TRUCK.NET
Γ.) 15" HDPE STORM DRAIN © 0.50% N89'00'54"W 249.6 LF T Q₁∞=2.58 CFS, V₁∞=3.65 FPS	
T.) 15" CLEANOUT DETAIL ON SHEET NO. 18RIM=481.60, IE=479.35	
r.) 15" HDPE STORM DRAIN © 0.50% N89'00'54"W 137 LF	CUP
T $Q_{100} = 2.96$ CFS, V $_{100} = 3.96$ FPS	
96.2, 433.5' LT. (PVT.) A-4 C/O PER DETAIL ON SHEET NO. 18 =480.6, IE IN=476.59, IE OUT=476.49	8490 AVENIDA DE LA FUENTE
	SUITE 5 SAN DIEGO, CA 92154
F.) 15" PVC STORM DRAIN @ 0.50% N24*37'50"W 19.5 LF T Q₁∞=2.96 CFS, V₁∞=3.96 FPS	SAN DIEGO, CA 92134
I.) 18" BROOKS BOX PER DETAIL ON SHEET NO. 18	REVISION ITEM DATE
=480.00, IE IN=476.79, IE OUT=476.69	Revision new bare
T.) 4" PVC PERFORATED STORM DRAIN LEVEL N89'30'37"E 46.0' LF	] A – –
T.) 22.5' VERTICAL ANGLE IE=476.79	
T.) 4" PVC STORM DRAIN @ 25% N89'30'37"E 11 LF	
T.) 4" CLEANOUT DETAIL ON SHEET NO. 18 RIM=481.50, IE=479.54	
T.) 4" PVC PERFORATED STORM DRAIN LEVEL N89'30'37"E 138.5 LF	
T.) 22.5' VERTICAL ANGLE IE=476.79	
T.) 4" PVC STORM DRAIN @ 25% N89 30'37"E 6.0 LF	
T.) 4" CLEANOUT DETAIL ON SHEET NO. 18 RIM=480.8, IE=478.29	
T.) 10" CLEANOUT DETAIL ON SHEET NO. 18 RIM=480.10, IE=476.96	
T.) 10" PERFORATED PVC STORM DRAIN @ 0.50% N89'59'06"E 5 LF T $Q_{100}$ =1.06 CFS, V $_{100}$ =3.06 FPS	THIS SET ISSUE DATE
COUPLING IE=476.99	
0001 EI10 IE - 170.55	
[) 10" PVC STORM DRAIN @ 0.50% N89'59'06"E 186.5 LE	DESIGN DEVEL
F.) 10" PVC STORM DRAIN © 0.50% N89'59'06"E 186.5 LF T Q <sub>100</sub> =1.06 CFS, V <sub>100</sub> =3.06 FPS	
T Q <sub>100</sub> =1.06 CFS, V <sub>100</sub> =3.06 FPS T.) 18" BROOKS BOX PER DETAIL ON SHEET NO. 18	PERMIT SUBMITTAL 6/27/16
T Q <sub>100</sub> =1.06 CFS, V <sub>100</sub> =3.06 FPS T.) 18" BROOKS BOX PER DETAIL ON SHEET NO. 18 =481.15, IE IN=478.02, IE OUT=477.92	
T Q <sub>100</sub> =1.06 CFS, V <sub>100</sub> =3.06 FPS T.) 18" BROOKS BOX PER DETAIL ON SHEET NO. 18 =481.15, IE IN=478.02, IE OUT=477.92 T.) 4" PVC PERFORATED STORM DRAIN LEVEL N89'30'27"W 46 LF	PERMIT SUBMITTAL         6/27/16           FULL SUBMITTAL         7/20/16
T Q <sub>100</sub> =1.06 CFS, V <sub>100</sub> =3.06 FPS ) 18" BROOKS BOX PER DETAIL ON SHEET NO. 18 +481.15, IE IN=478.02, IE OUT=477.92 ), 4" PVC PERFORATED STORM DRAIN LEVEL N89'30'27"W 46 LF T.) 22.5' VERTICAL ANGLE IE=478.02	■ FULL SUBMITTAL <u>7/20/16</u>
T Q <sub>100</sub> =1.06 CFS, V <sub>100</sub> =3.06 FPS .) 18" BROOKS BOX PER DETAIL ON SHEET NO. 18 =481.15, IE IN=478.02, IE OUT=477.92 .) 4" PVC PERFORATED STORM DRAIN LEVEL N89'30'27"W 46 LF T.) 22.5' VERTICAL ANGLE IE=478.02 T.) 4" PVC STORM DRAIN @ 25% N89'30'37"E 8 LF	■ FULL SUBMITTAL <u>7/20/16</u> ■ RESUBMITTAL 1 <u>12/9/16</u>
T Q <sub>100</sub> =1.06 CFS, V <sub>100</sub> =3.06 FPS .) 18" BROOKS BOX PER DETAIL ON SHEET NO. 18 =481.15, IE IN=478.02, IE OUT=477.92 .) 4" PVC PERFORATED STORM DRAIN LEVEL N89'30'27"W 46 LF T.) 22.5' VERTICAL ANGLE IE=478.02 T.) 4" PVC STORM DRAIN @ 25% N89'30'37"E 8 LF T.) 4" CLEANOUT DETAIL ON SHEET NO. 18 RIM=483.00, IE=480.02	■ FULL SUBMITTAL <u>7/20/16</u>
T Q <sub>100</sub> =1.06 CFS, V <sub>100</sub> =3.06 FPS T, 18" BROOKS BOX PER DETAIL ON SHEET NO. 18 +481.15, IE IN=478.02, IE OUT=477.92 T, 4" PVC PERFORATED STORM DRAIN LEVEL N89'30'27"W 46 LF T, 22.5' VERTICAL ANGLE IE=478.02 T, 4" PVC STORM DRAIN @ 25% N89'30'37"E 8 LF T, 4" CLEANOUT DETAIL ON SHEET NO. 18 RIM=483.00, IE=480.02 TA C-3	<ul> <li>FULL SUBMITTAL <u>7/20/16</u></li> <li>RESUBMITTAL 1 <u>12/9/16</u></li> <li>RESUBMITTAL 2 <u>4/27/17</u></li> </ul>
T Q <sub>100</sub> =1.06 CFS, V <sub>100</sub> =3.06 FPS .) 18" BROOKS BOX PER DETAIL ON SHEET NO. 18 e481.15, IE IN=478.02, IE OUT=477.92 .) 4" PVC PERFORATED STORM DRAIN LEVEL N89'30'27"W 46 LF .) 22.5" VERTICAL ANGLE IE=478.02 T.) 4" PVC STORM DRAIN @ 25% N89'30'37"E 8 LF T.) 4" CLEANOUT DETAIL ON SHEET NO. 18 RIM=483.00, IE=480.02 CA C-3 I.2.2, 50.9" LT. INSTALL (PVT.) MANUFACTURER'S END PIECE FOR 18" HDPE IE=474.55 SDD-104 RIP-RAP ENERGY DISSIPATOR 10'×10" OF 1.1" OF	■ FULL SUBMITTAL <u>7/20/16</u> ■ RESUBMITTAL 1 <u>12/9/16</u>
T Q <sub>100</sub> =1.06 CFS, V <sub>100</sub> =3.06 FPS 1.) 18" BROOKS BOX PER DETAIL ON SHEET NO. 18 441.15, IE IN=478.02, IE OUT=477.92 1.) 4" PVC PERFORATED STORM DRAIN LEVEL N89'30'27"W 46 LF T.) 22.5' VERTICAL ANGLE IE=478.02 T.) 4" PVC STORM DRAIN @ 25% N89'30'37"E 8 LF T.) 4" CLEANOUT DETAIL ON SHEET NO. 18 RIM=483.00, IE=480.02 CA C-3 I.2, 50.9' LT. INSTALL (PVT.) MANUFACTURER'S END PIECE FOR 18" HDPE I E=474.55 SDD-104 RIP-RAP ENERGY DISSIPATOR 10'x10' OF 1.1' OF 2 BACKING OVER FILTER BLANKET.	<ul> <li>FULL SUBMITTAL <u>7/20/16</u></li> <li>RESUBMITTAL 1 <u>12/9/16</u></li> <li>RESUBMITTAL 2 <u>4/27/17</u></li> </ul>
T Q <sub>100</sub> =1.06 CFS, V <sub>100</sub> =3.06 FPS       1.) 18" BROOKS BOX PER DETAIL ON SHEET NO. 18       481.15, 1E IN=478.02, 1E OUT=477.92       T.) 4" PVC PERFORATED STORM DRAIN LEVEL N89'30'27"W 46 LF       T.) 22.5' VERTICAL ANGLE IE=478.02       T.) 4" PVC STORM DRAIN @ 25% N89'30'37"E 8 LF       T.) 4" PVC STORM DRAIN @ 25% N89'30'37"E 8 LF       T.) 4" CLEANOUT DETAIL ON SHEET NO. 18 RIM=483.00, IE=480.02       2.4 C3       22.5 O.9' LT. INSTALL (PYT) MANUFACTURER'S END PIECE FOR 18" HDPE       1E 474.55 SDD-104 RIP-RAP ENERGY DISSIPATOR 10×10' OF 1.1' OF       2 BACKING OVER FILTER BLANKET.       T Q <sub>100</sub> =1.12 CFS, V <sub>100</sub> =3.09 FPS; PRE Q <sub>100</sub> =1.01 CFS, V <sub>100</sub> =3.03 FPS       10" HDPE STORM DRAIN @ 0.20% N89'30'28'W 251 LF	<ul> <li>FULL SUBMITTAL <u>7/20/16</u></li> <li>RESUBMITTAL 1 <u>12/9/16</u></li> <li>RESUBMITTAL 2 <u>4/27/17</u></li> <li>RESUBMITTAL 3 <u>1/9/2018</u></li> <li>RESUBMITTAL 4 <u>12/3/2018</u></li> </ul>
T Q <sub>100</sub> =1.06 CFS, V <sub>100</sub> =3.06 FPS         1.) 18° BROOKS BOX PER DETAIL ON SHEET NO. 18         481.15, IE IN=478.02, IE OUT=477.92         1.) 4° PVC PERFORATED STORM DRAIN LEVEL N89'30'27"W 46 LF         T.) 4° PVC STORM DRAIN @ 25% N89'30'37"E 8 LF         T.) 4° CLEANOUT DETAIL ON SHEET NO. 18 RIM=483.00, IE=480.02         CA C-3         2.2, 50.9° LT. INSTALL (PVT.) MANUFACTURER'S END PIECE FOR 18° HDPE         IE =474.55 SDD-104 RIP-RAP ENERGY DISSIPATOR 10'x10' OF 1.1' OF         2 BACKING OVER FILTER BLANKET.         T Q <sub>100</sub> =1.12 CFS, V <sub>100</sub> =3.09 FPS; PRE Q <sub>100</sub> =1.01 CFS, V <sub>100</sub> =3.03 FPS         T Q <sub>100</sub> =1.12 CFS, V <sub>100</sub> =3.09 FPS; PRE Q <sub>100</sub> =1.01 CFS, V <sub>100</sub> =3.03 FPS	<ul> <li>FULL SUBMITTAL <u>7/20/16</u></li> <li>RESUBMITTAL 1 <u>12/9/16</u></li> <li>RESUBMITTAL 2 <u>4/27/17</u></li> <li>RESUBMITTAL 3 <u>1/9/2018</u></li> </ul>
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T Q <sub>100</sub> =1.06 CFS, V <sub>100</sub> =3.06 FPS 1) 18" BROOKS BOX PER DETAIL ON SHEET NO. 18 +481.15, IE IN=478.02, IE OUT=477.92 1) 4" PVC PERFORATED STORM DRAIN LEVEL N89'30'27"W 46 LF T.) 22.5' VERTICAL ANGLE IE=478.02 T.) 4" CLEANOUT DETAIL ON SHEET NO. 18 RIM=483.00, IE=480.02 CA C-3 (22, 50.9' LT. INSTALL (PVT.) MANUFACTURER'S END PIECE FOR 18" HDPE IE=474.55 SDD-104 RIP-RAP ENERGY DISSIPATOR 10'x10' OF 1.1' OF 2 BACKING OVER FILTER BLANKET. T Q <sub>100</sub> =1.12 CFS, V <sub>100</sub> =3.09 FPS; PRE Q <sub>100</sub> =1.01 CFS, V <sub>100</sub> =3.03 FPS T) 10" HDPE STORM DRAIN @ 0.50% N89'30'28"W 251 LF T Q <sub>100</sub> =1.12 CFS, V <sub>100</sub> =3.09 FPS; PRE Q <sub>100</sub> =1.01 CFS, V <sub>100</sub> =3.03 FPS T) 12" CLEANOUT DETAIL ON SHEET NO. 18RIM=481.60, IE=475.81 T) 10" HDPE STORM DRAIN @ 0.50% N89'30'28"W 124 LF T Q <sub>100</sub> =1.12 CFS, V <sub>100</sub> =3.09 FPS; PRE Q <sub>100</sub> =1.01 CFS, V <sub>100</sub> =3.03 FPS T) 12" CLEANOUT DETAIL ON SHEET NO. 18RIM=481.60, IE=475.81 T) 10" HDPE STORM DRAIN @ 0.50% N89'30'28"W 124 LF T Q <sub>100</sub> =1.12 CFS, V <sub>100</sub> =3.09 FPS; PRE Q <sub>100</sub> =1.01 CFS, V <sub>100</sub> =3.03 FPS GRAPHIC SCALE 0 0 0 0 0 0 0 0 0 0 0 0 0 0 0 0 0 0 0	<ul> <li>FULL SUBMITTAL 7/20/16</li> <li>RESUBMITTAL 1 1/2/9/16</li> <li>RESUBMITTAL 2 4/27/17</li> <li>RESUBMITTAL 3 1/9/2018</li> <li>RESUBMITTAL 4 12/3/2018</li> <li>RESUBMITTAL 4 12/3/2019</li> <li>RESUBMITTAL 5 9/10/2019</li> <li>RESUBMITTAL 6 10/23/2019</li> <li>SHEET TITLE / CONTENTS</li> </ul> GRADING PLANS TRH PROJECT#: 248-13-CUP SCALE: AS NOTED DRAWN BY: ALTA ORIGINAL DATE: 1/4/2016 CHECKED BY:

**ATTACHMENT 13** 



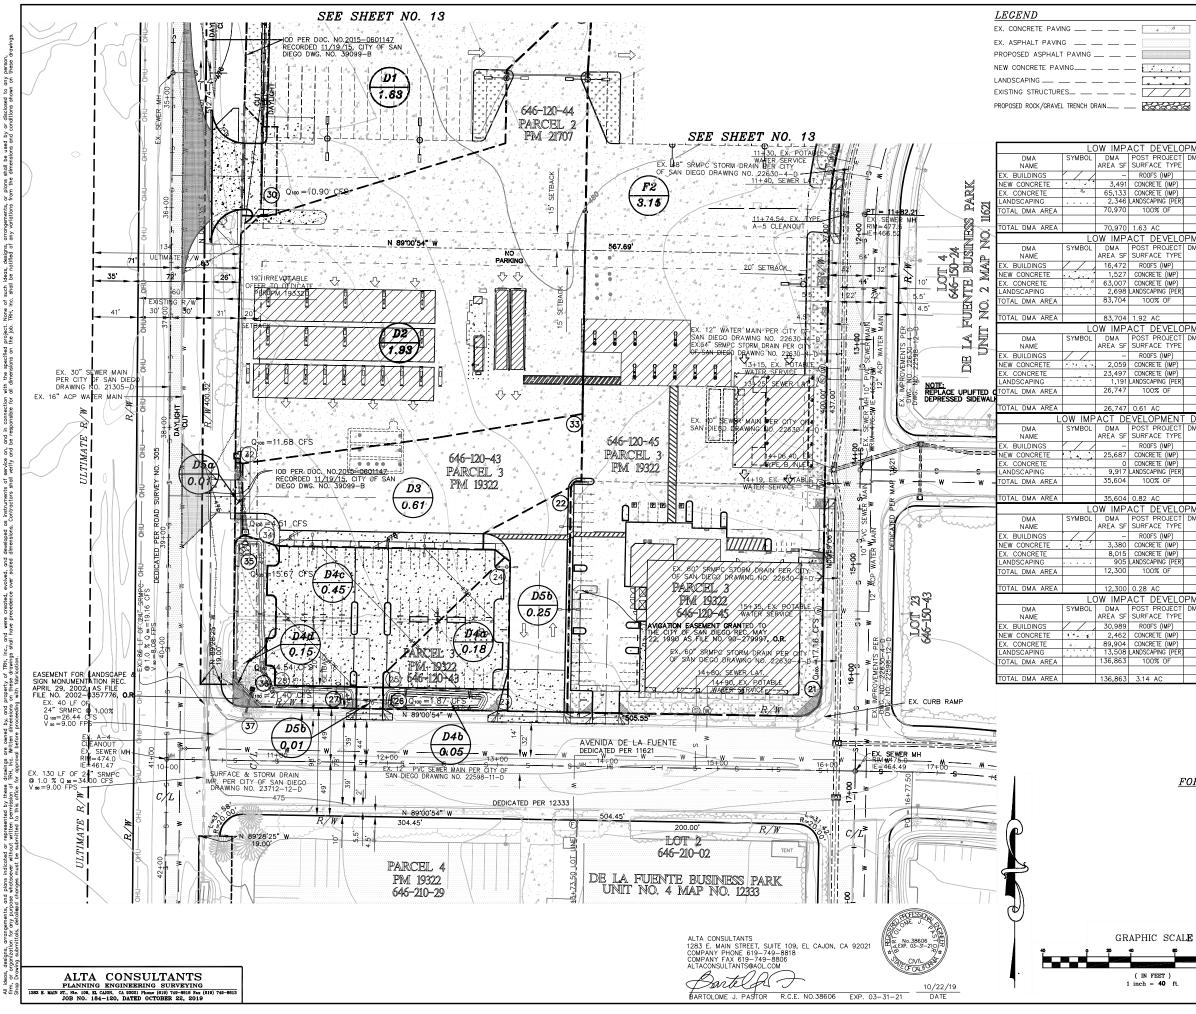
				<b>\</b> TT	- <mark>AC</mark>	CHMENT 13
	LEGEND		-		_	
	EX. ASPHALT I EX. CONCRETE LANDSCAPING EXISTING STRU EXISTING DIRT WATERSHED BC DRAINAGE ARE, AREA IN ACRES	PAVING  ICTURES AND GRAVEL DUNDARY A DESIGNATION			<b>→</b>	τή I N G. 1350 Орцимвіа St. Sunt 702 San Diebo, ga 92101 TEL (619) 230-1088 FAX (619) 230-1089
MP/ 1A \\SF 147	ACT DEVELC POST PROJECT SURFACE TYPE ROOFS (IMP)	PMENT DE DMA RUNOFF FACTOR 1.0	SIGN AREA I DMA AREA X RUNOFF FACTOR 147	D1 % OF SITE 0%	SOIL TYPE "D"	
536	CONCRETE (IMP) LANDSCAPING (PER) 100% OF	1.0 1.0 0.1	65,536 529	93% 7%	-	APPLICANT:
	1.63 AC ACT DEVELC POST PROJECT SURFACE TYPE ROOFS (IMP)		66,212 SIGN AREA I DMA AREA X RUNOFF FACTOR 17,346	2 % OF SITE 21%	SOIL TYPE	Truck.Net LLC
735 623 704	CONCRETE (IMP) LANDSCAPING (PER) 100% OF	1.0 0.1	64,735 162	77%		5440 MOREHOUSE DR. #4000 SAN DIEGO, CA 92121 PROJECT:
MP/ 1A SF - 747	POST PROJECT SURFACE TYPE ROOFS (IMP) CONCRETE (IMP) LANDSCAPING (PER)		82,243 SIGN AREA [ DMA AREA x RUNOFF FACTOR - 26,747 -	) 3 % OF SITE - 92% 8%	SOIL TYPE "D"	TRUCK.NET CUP
			26,747 SIGN AREA [		c, & d	8490 AVENIDA DE LA FUENTE SUITE 5 SAN DIEGO, CA 92154
1A SF - 888 ,716 604	POST PROJECT SURFACE TYPE ROOFS (IMP) CONCRETE (IMP) LANDSCAPING (PER) 100% OF	DMA RUNOFF FACTOR 1.0 1.0 0.1	DMA AREA x RUNOFF FACTOR 28,888 672	% OF SITE - 81% 19%	SOIL TYPE "D"	REVISION ITEM DATE
	0.82 AC ACT DEVELC POST PROJECT SURFACE TYPE		29,560 SIGN AREA I DMA AREA X RUNOFF FACTOR	D <b>5a, b</b> & % OF SITE		$\begin{array}{c} \Delta \\ \hline \Delta \\ \hline \Delta \end{array}$
- 033	ROOFS (IMP) CONCRETE (IMP) LANDSCAPING (PER) 100% OF	1.0 1.0	- 12,033 37	- 98% 2%		THIS SET ISSUE DATE
	0.28 AC ACT DEVELC POST PROJECT SURFACE TYPE ROOFS (IMP) CONCRETE (IMP)		12,070 SIGN AREA F DMA AREA x RUNOFF FACTOR 34,672 91,317	-2 % OF SITE 25% 67%	SOIL TYPE	SCHEMATIC     DESIGN DEVEL.     PERMIT SUBMITTAL _6/27/16
874 863	LANDSCAPING (PÉR) 100% OF	0.1	126,098	8%	-	<ul> <li>FULL SUBMITTAL 7/20/16</li> <li>RESUBMITTAL 1 12/9/16</li> <li>RESUBMITTAL 2 4/27/17</li> </ul>
F	OR TOPOG	RAPHY S	SEE SHT. 6	2		RESUBMITTAL 2
	GRAPHIC	80	160		e e	PRE-PROJECT DMA PLANS
18	1 inch = 4	40 n.	No.38606 707 No.38606 707 2 Exp.3/31/21	Ś		TRH PROJECT#: 248-13-CUP SCALE: AS NOTED DRAWN BY: ALTA ORIGINAL DATE: 1/4/2016 CHECKED BY: SHEET: 39 OF: 46

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						1350 COLUMBIA ST. Suite 702 San Diego, ca 92101
SURF	ACE)					TEL (619) 230-1088 FAX (619) 230-1089
	C3					PAX (019) 230-1009
	1.55	フ				
	_					
	ACT DEVELOPMENT	DESIGN	AREA C	1		
A SF	POST PROJECT SURFACE TYPE	DESIGN DMA RUNOFF FACTOR	DMA AREA X RUNOFF FACTOR	% OF SITE	SOIL TYPE	
713 192	ROOFS (IMP) CONCRETE (IMP)	1.0 1.0	713	2% 1%	IMP. 3% C=0.45	
932 025	LANDSCAPING (PER) COMPACTED SOIL (UNPAVED PARKING)	0.1 0.2	93 5,605	3% 94%		APPLICANT:
854	100% OF			SIZING FACTOR	MINIMUM AREA	Truck.Net LLC
854 MP.	ACT DEVELOPMENT	DESIGN		0.04	264	
A SF	POST PROJECT SURFACE TYPE	DMA RUNOFF FACTOR	DMA AREA x RUNOFF FACTOR	% OF SITE	SOIL TYPE "D"	5440 MOREHOUSE DR. #4000
878 646 450	ROOFS (IMP) CONCRETE (IMP) LANDSCAPING (PER)	1.0	5,878 646 145	11%	IMP. 12% C=0.50	SAN DIEGO, CA 92121
430 014 988	COMPACTED SOIL (UNPAVED PARKING) 100% OF	0.1	9,403	3% 85% SIZING	MINIMUM	PROJECT:
988	1.26 AC		16,072	FACTOR 0.04	AREA 643	TRUCK.NET
MP.	ACT DEVELOPMENT	DESIGN DMA RUNOFF	AREA C	3 % OF SITE	SOIL TYPE	CUP
SF 252	SURFACE TYPE ROOFS (IMP)	FACTOR 1.0	RUNOFF FACTOR 252	1%	"D" IMP. 4%	
907 547	CONCRETE (IMP) LANDSCAPING (PER)	1.0 0.1	907 155	3% 4%	C=0.45	8490 AVENIDA DE LA FUENTE SUITE 5 SAN DIECO, CA 92154
184 890	COMPACTED SOIL (UNPAVED PARKING) 100% OF	0.2	6,437	92% SIZING FACTOR	MINIMUM	SAN DIEGO, CA 92154
	0.80 AC ACT DEVELOPMENT	DESIGN	7,751 ARFA C4	0.04	310	REVISION ITEM DATE
A SF	ACT DEVELOPMENT POST PROJECT SURFACE TYPE	DESIGN DMA RUNOFF FACTOR	DMA AREA C4 DMA AREA X RUNOFF FACTOR	+ % OF SITE	SOIL TYPE	<u>A</u>
,841 706	ROOFS (IMP) CONCRETE (IMP)	1.0 1.0	1,841 21,706	3% 31%	IMP. 34% C=0.60	$\Delta$
668 152	LANDSCAPING (PÉR) COMPACTED SOIL (UNPAVED PARKING)	0.1	565 8,030	9% 57%		
367	100% OF			SIZING FACTOR	MINIMUM AREA	$\Delta$
	1.62 AC				1289	
A SF 784	POST PROJECT SURFACE TYPE ROOFS (IMP)	DMA RUNOFF FACTOR	DMA AREA x RUNOFF FACTOR 784		SOIL TYPE "D"	THIS SET ISSUE DATE
704 537 493	CONCRETE (IMP) LANDSCAPING (PER)	1.0 1.0 0.1	45,537 449	1% 90% 9%	IMP. 91% C=0.95	DESIGN DEVEL
0 814	· · · /	0.2	0	0% SIZING	MINIMUM	PERMIT SUBMITTAL _ 6/27/16
.814	1.17 AC		46,770	FACTOR 0.04	AREA 1,871	FULL SUBMITTAL _7/20/16_
MP.	ACT DEVELOPMENT POST PROJECT	DMA RUNOFF	DMA AREA x	% OF SITE	SOIL TYPE	RESUBMITTAL 1 12/9/16
、SF 566	SURFACE TYPE ROOFS (IMP)	FACTOR 1.0	RUNOFF FACTOR 566	1%	"D"	■ RESUBMITTAL 2 <u>4/27/17</u>
304 470 708	CONCRETE (IMP) LANDSCAPING (PER) COMPACTED SOIL (UNPAVED PARKING)	1.0 0.1	6,304 547 3,942	20%		RESUBMITTAL 3 <u>1/9/2018</u>
048	100% OF	0.2	5,5+2	62% SIZING FACTOR	MINIMUM	RESUBMITTAL 4 <u>12/3/2018</u>
048	0.74 AC		11,393	0.04	456	<ul> <li>RESUBMITTAL 5 <u>9/10/2019</u></li> <li>RESUBMITTAL 0 10/23 (2010)</li> </ul>
F	OR TOPOGRAPH	Y SEE	SHT 6			RESUBMITTAL 6 10/23/2019 SHEET TITLE / CONTENTS
1			<u> 0111. 0</u>			
						PRE-PROJECT
						DMA PLAN
			RE OME	SOLUTION SOLUTION		
TS REET, 619-	. SUITE 109, EL CAJON, C/ -749-8818	92021	Exp.3	8606 55 /31/21		TRH PROJECT#: 248-13-CUP
9-7-	49-8806 DL.COM		+ CA			SCALE: AS NOTED DRAWN BY: ALTA
te	14(-)-			0/22/19		ORIGINAL DATE: 1/4/2016
AST	OR / R.C.E. NO.38606	EXP. 03-	31-21	DATE		CHECKED BY: SHEET: 40 OF: 46
						GP-12

**ATTACHMENT 13** 



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trh	- $ C3$	— — — ПОN — — —	HED BOUNDARY	DRAINAG	<u></u>
1350 COLUMBIA ST. Suite 702 San Diego, ca 92101 Tel. (619) 230-1088 FAX (619) 230-1089			ACRES — —		
	SOIL TYPE "D"	)1 % OF SITE - 5% 92%	SIGN AREA E DMA AREA X RUNOFF FACTOR - 3,491	DMA RUNOFF FACTOR 1.0 1.0	ELO PCT PE ) IP) IP)
		3%	65,133 235 68,859 SIGN AREA [ DMA AREA x		PÉR)
APPLICANT: Truck.Net LLC		% OF SITE 20% 2% 75% 3%	RUNOFF FACTOR 16,472 1,527 63,007 268	FACTOR 1.0 1.0 1.0 0.1	101 YPE ) (P) (P) PER)
5440 MOREHOUSE DR. #4000 SAN DIEGO, CA 92121 PROJECT: TRUCK.NET	SOIL TYPE "D"	% OF SITE - 8%	DMA AREA x RUNOFF FACTOR - 2,059	PMENT DE DMA RUNOFF FACTOR 1.0 1.0	ECT YPE ) IP)
8490 AVENIDA DE LA FUENTE SUITE 5	SOIL TYPE	88% 4% . c & d % OF SITE	23,497 119 25,675 AREA D4a, b, DMA AREA X PLINOEE FACTOR	DMA RUNOFF	(P) PER)
REVISION ITEM DATE	<u>"D"                                   </u>	- 72% - 18%	RUNOFF FACTOR 	FACTOR 1.0 1.0 0.1	(PE ) (P) (P) PER)
		% OF SITE - 28% 65%	26,679 SIGN AREA [ DMA AREA x RUNOFF FACTOR - 3,380 8,015 91	DMA RUNOFF FACTOR 1.0 1.0 1.0	ELO ECT YPE ) IP) IP) PER)
THIS SET ISSUE DATE  SCHEMATIC  DESIGN DEVEL.	SOIL TYPE	7% 7% 7% 7% 7% 7% 7% 7%	11,486	0.1 PMENT DE DMA RUNOFF FACTOR	
<ul> <li>PERMIT SUBMITTAL 6/27/16</li> <li>FULL SUBMITTAL 7/20/16</li> <li>RESUBMITTAL 1 12/9/16</li> </ul>		23% 2% 65% 10%	30,989 2,462 89,904 1,351	1.0 1.0 1.0 0.1	) IP) PER)
<ul> <li>RESUBMITTAL 2 <u>4/27/17</u></li> <li>RESUBMITTAL 3 <u>1/9/2018</u></li> <li>RESUBMITTAL 4 <u>12/3/2018</u></li> <li>RESUBMITTAL 5 <u>9/10/2019</u></li> <li>RESUBMITTAL 6 <u>10/23/2019</u></li> <li>SHEET TITLE / CONTENTS</li> </ul> <b>POST-DMA PLANS</b>		<u>SHT. 9</u>	124,706	FOR GRAL	F

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TRH PROJECT#: 248-13-CUP

ORIGINAL DATE: 1/4/2016

AS NOTED

OF: 46

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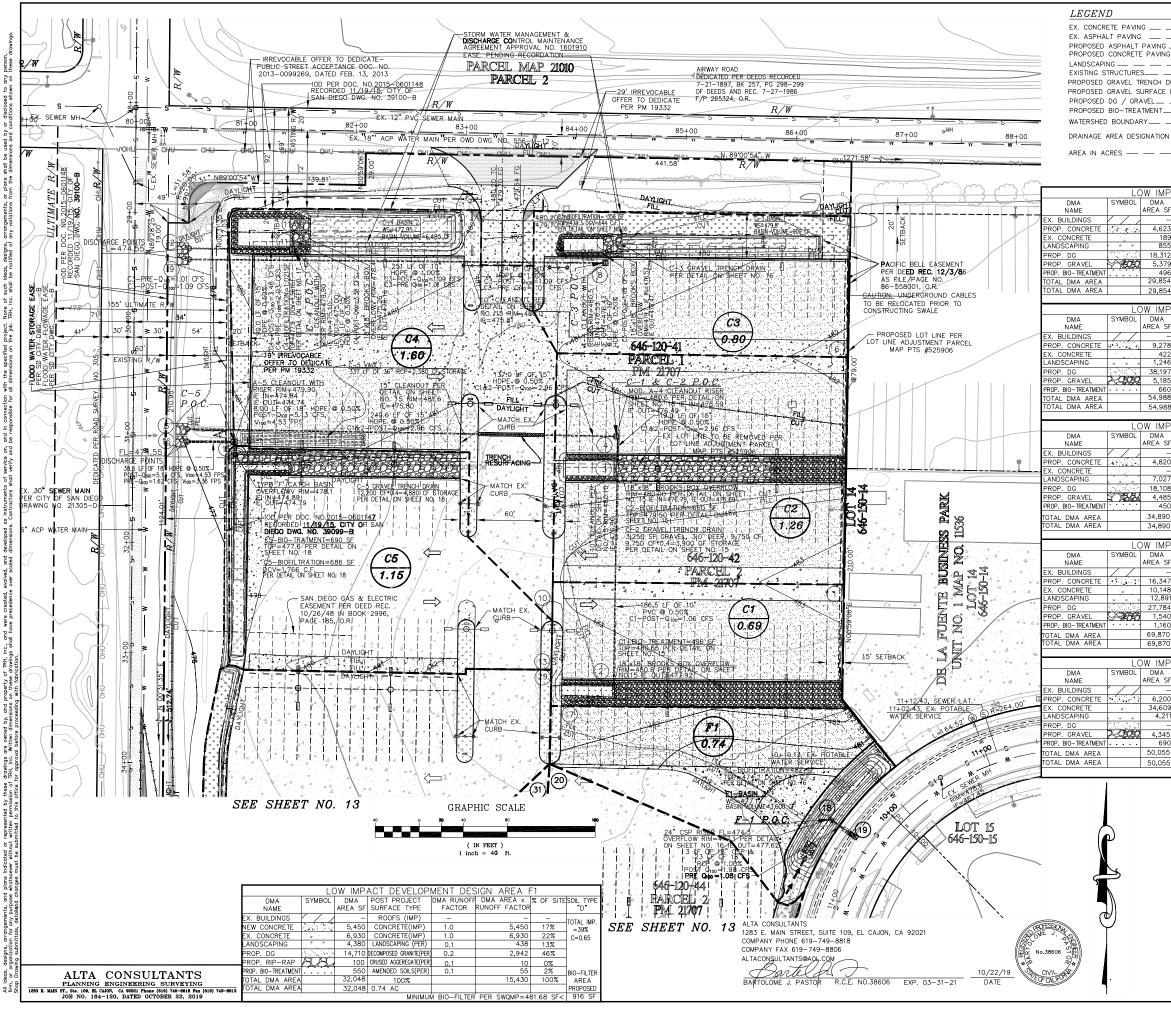
**GP-13** 

SCALE:

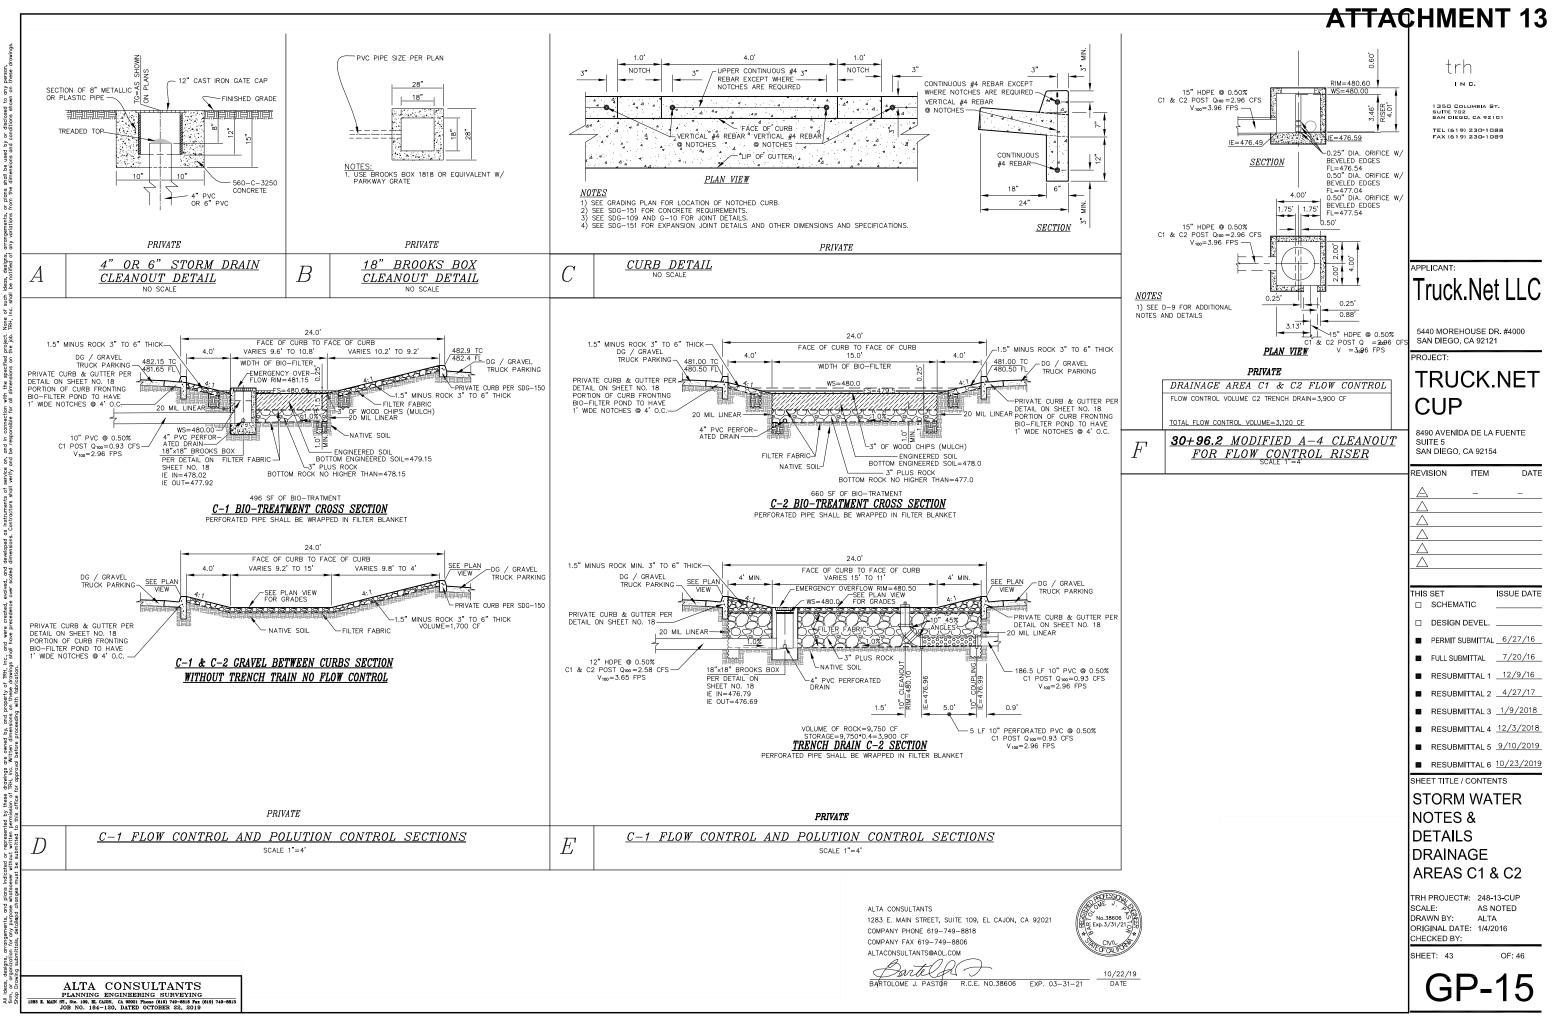
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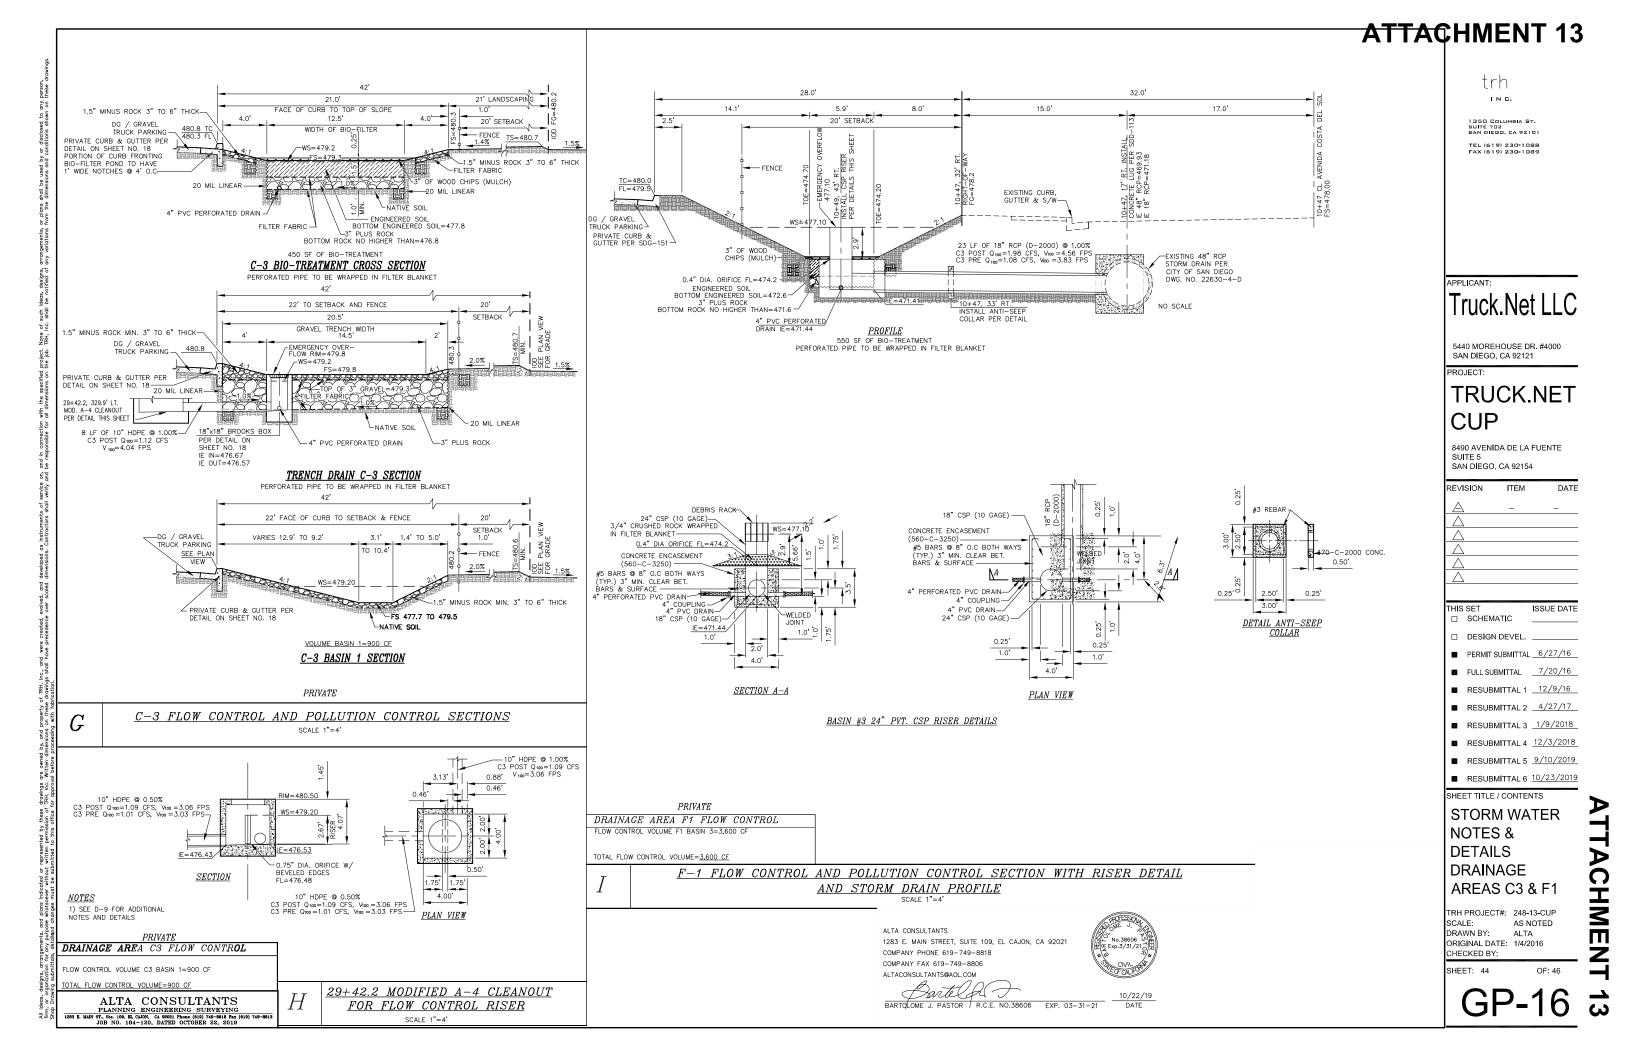


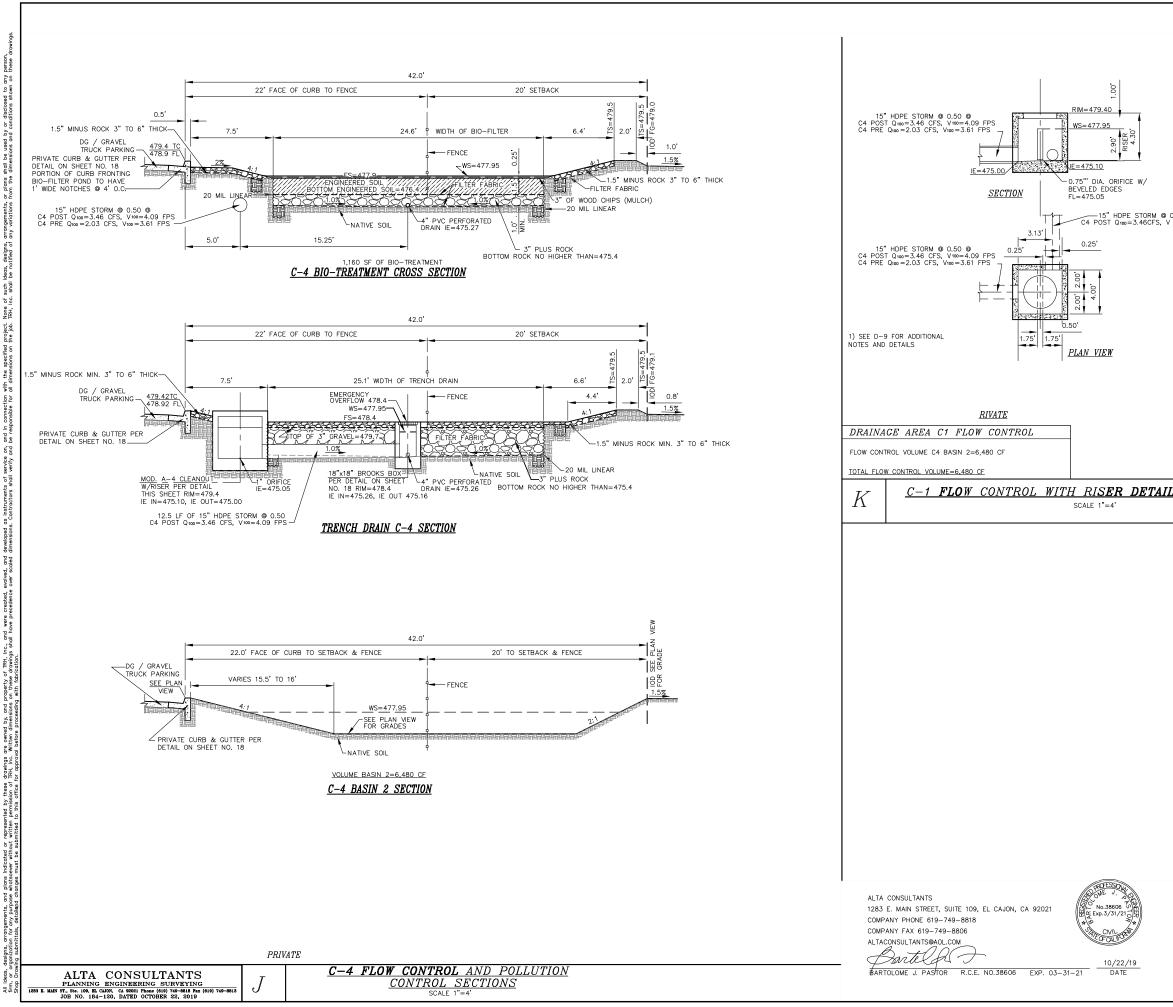
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	IO TRENCH DRAIN		<b>202020</b>			1350 COLUMBIA ST. Suite 702	
т		(				SAN DIEGO, CA 92101 TEL (619) 230-1088	
ION -		- <u>C3</u>				FAX (619) 230-1089	
		1.55					
		$\bigcirc$					
A	ACT DEVELOP POST PROJECT	DMA RUNOFF	DMA AREA x	C1 % OF SITE	SOIL TYPE "D"		
SF	ROOFS (IMP)	FACTOR	RUNOFF FACTOR	-	TOTAL IMP.	-	
623 189 855		1.0 1.0 0.1	4,623 189 86	16% 1% 3%	=17% C=0.50		
312	DECOMPOSED GRANITE(PER CRUSHED AGGEREGATE(PER	0.2	3,662 538	61% 18%		APPLICANT:	
496 854	100%	0.1	50 9,148	1% 100%	BIO-FILTER AREA		
854	0.69 AC MINIMU ACT DEVELOP		I <del>R per swomp=3</del> SIGN AREA (	1 349.29 SF< C2	PROPOSED 496 SF		
A SF	POST PROJECT SURFACE TYPE		DMA AREA X	% OF SITE	SOIL TYPE "D"	5440 MOREHOUSE DR. #4000 SAN DIEGO, CA 92121	
_ 278	ROOFS (IMP) CONCRETE(IMP)	- 1.0	- 9,278	- 17%	TOTAL IMP. =18%	PROJECT:	
422	CONCRETE(IMP) LANDSCAPING (PER)	1.0 0.1	422	1% 2%	C=0.50	TRUCK.NET	
	DECOMPOSED GRANITE(PER) CRUSHED AGGEREGATE(PER AMENDED SOILS(PER)		7,639 519 66	69% 10% 1%	BIO-FILTER		
988 988	100% 1.26 AC		18,049	100%	AREA PROPOSED		
	ACT DEVELOP	MENT DES	R PER SWQMP=6 SIGN AREA (	03	660 SF	8490 AVENIDA DE LA FUENTE	
A SF	POST PROJECT SURFACE TYPE ROOFS (IMP)	FACTOR	DMA AREA x RUNOFF FACTOR	% OF SITE	SOIL TYPE "D" TOTAL IMP.	SAN DIEGO, CA 92154	
820	CONCRETE(IMP) CONCRETE(IMP)	1.0 1.0	4,820	14% -	=14% C=0.50	REVISION ITEM DATE	
	LANDSCAPING (PER) DECOMPOSED GRANITE(PER) CRUSHED AGGEREGATE(PER	0.1 0.2 0.1	703 3,622 449	20% 52% 13%	-		
450 390	AMENDED SOILS(PER) 100%	0.1	449 45 9,639	1%	BIO-FILTER		
390	0.80 AC	JM BIO-FILTE	R PER SWQMP=		AREA PROPOSED 400 SF		
A	ACT DEVELOP POST PROJECT	DMA RUNOFF	DMA AREA x	C4 % OF SITE	SOIL TYPE		
SF 	ROOFS (IMP)	FACTOR -	RUNOFF FACTOR - 16,347	-	"D" TOTAL IMP. =38%		
148 ,891	CONCRETE(IMP)	1.0 1.0 0.1	10,148	23% 15% 18%	C=0.65	THIS SET ISSUE DATE	
540	DECOMPOSED GRANITE(PER CRUSHED AGGEREGATE(PER	0.1	5,557 154	40% 2%	-	DESIGN DEVEL	
160 370 370	AMENDED SOILS(PER) 100% 1.60 AC	0.1	116 33,661	2% 100%	BIO-FILTER		
			I PER SWQMP=1,0 SIGN AREA (	20.80 SF<	PROPOSED 1,160 SF	FOLL SUBMITTAL	
A SF	POST PROJECT		DMA AREA X RUNOFF FACTOR	% OF SITE	SOIL TYPE	■ RESUBMITTAL 1 <u>12/9/16</u> ■ RESUBMITTAL 2 <u>4/27/17</u>	
- 200	ROOFS (IMP) CONCRETE(IMP)	- 1.0	6,200	- 12%	TOTAL IMP. =81% C=0.85	RESUBMITTAL 3 <u>1/9/2018</u>	
609 ,211 _	CONCRETE(IMP) LANDSCAPING (PER) DECOMPOSED GRANITE(PER)	1.0 0.1 0.2	34,609	69% 8%	-0.85	RESUBMITTAL 4 <u>12/3/2018</u>	
345 690	CRUSHED AGGEREGATE(PER		435	9% 2%	BIO-FILTER	■ RESUBMITTAL 5 <u>9/10/2019</u>	
)55 )55	100% 1.15 AC		41,734	100%	AREA PROPOSED	RESUBMITTAL 6 <u>10/23/2019</u>	
	MINIMU	JM BIO-FILTE	R PER SWQMP=	685.54 SF<	690		
	<u>FOR</u>	GRADING	F PLAN SE	<u>e sht</u>	10	POST-DMA	
						PLANS	
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						TRH PROJECT#: 248-13-CUP SCALE: AS NOTED	
						SCALE: AS NOTED DRAWN BY: ALTA ORIGINAL DATE: 1/4/2016	
						POST-DMA PLANS TRH PROJECT#: 248-13-CUP SCALE: AS NOTED DRAWN BY: ALTA ORIGINAL DATE: 1/4/2016 CHECKED BY: SHEET: 42 OF: 46	
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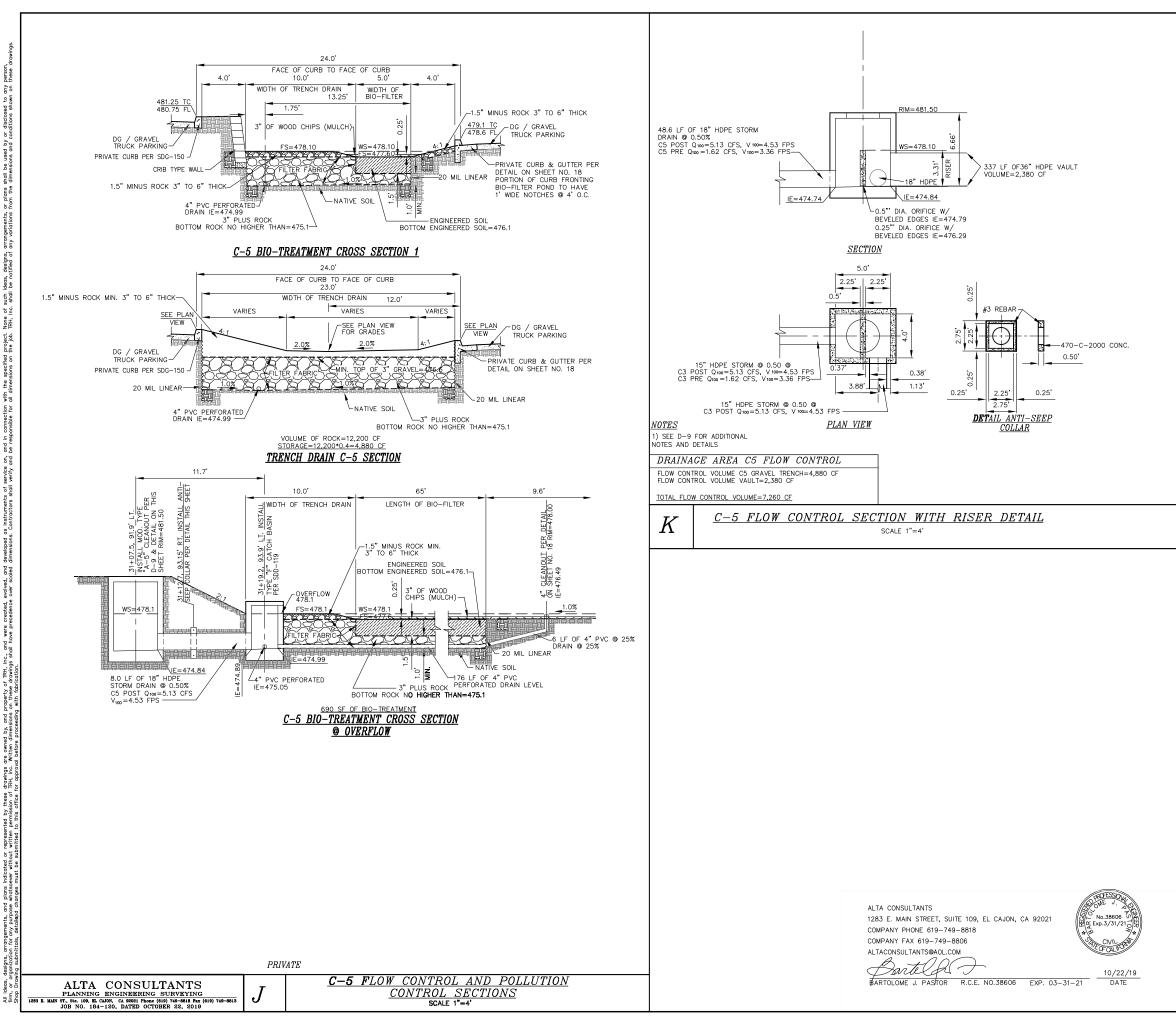
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	trh in G. Suffe 702 SAN DIEGO, GA 92101 TEL (619) 230-1088 FAX (619) 230-1089
9 0.50 0 V 100 4.09 FPS	APPLICANT: Truck.Net LLCC 5440 MOREHOUSE DR. #4000 SAN DIEGO, CA 92121 PROJECT: TRUCK.NET AUDITION DE LA FUENTE SUITE 5 SAN DIEGO, CA 92154 REVISION ITEM DATE
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	trh in e. 1350 columbia St. 500 columbia
	APPLICANT: Truck.Net LLC 5440 MOREHOUSE DR. #4000 SAN DIEGO, CA 92121
	PROJECT: TRUCK.NET CUP 8490 AVENIDA DE LA FUENTE SUITE 5 SAN DIEGO, CA 92154 REVISION ITEM DATE A
	△           △           △           △           △           △           △           △           □           SCHEMATIC           □           DESIGN DEVEL.           □           ■           FULL SUBMITTAL           6/27/16           ■           FULL SUBMITTAL           7/20/16           ■           RESUBMITTAL 1           12/9/16           ■           RESUBMITTAL 2           4/27/17           ■           RESUBMITTAL 3           1/9/2018           ■           ■           RESUBMITTAL 4           12/3/2018           ■           RESUBMITTAL 5           9/10/2019
	RESUBMITTAL 6 10/23/2019 SHEET TITLE / CONTENTS STORM WATER NOTES & DETAILS DRAINAGE AREA C5 TRH PROJECT#: 248-13-CUP SCALE: AS NOTED DRAWN BY: ALTA ORIGINAL DATE: 1/4/2016 CHECKED BY: SHEET: 46 OF: 46
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