

Report to the Planning Commission

DATE ISSUED: August 13, 2020 REPORT NO. PC-20-047

HEARING DATE: August 20, 2020

SUBJECT: 1398 LIETA STREET. Process Four Decision

PROJECT NUMBER: <u>512890</u>

REFERENCE: <u>Historical Resources Board Report No. HRB 20-024; ITEM #6 - 1398 Lieta</u>

Street Project Site Development Permit, May 28, 2020

Historical Resources Board Report No. HRB 18-033; ITEM #7 - Aizo and

Komume Sogo Farm, July 26, 2018

OWNER/APPLICANT: Almeria Investments, LP, a California Domestic Limited Partnership

SUMMARY

<u>Issues</u>: Should the Planning Commission approve the demolition of an existing single dwelling unit and the construction of 13 dwelling units within two three-story buildings on a designated resource site located at 1398 Lieta Street (HRB Site #1305, the Aizo and Komume Sogo Farm) within the Clairemont Mesa Community Plan area?

Staff Recommendations:

- 1. ADOPT Mitigated Negative Declaration No. 512890 and ADOPT the Mitigation, Monitoring, and Reporting Program;
- 2. APPROVE Site Development Permit No. 1823446;
- 3. APPROVE Neighborhood Development Permit No. 2011943; and
- 4. APPROVE Tentative Map No. 2011944.

Community Planning Group Recommendation: On June 16, 2020, the Clairemont Community Planning Group voted 10-1-0 to recommend denial of the project, stating the following reasons: Not in keeping with the level of development on its single-family residential street. No viable guest parking (don't agree tandem and lifts will be utilized). Privacy issues for adjacent residential. Landscaping on south side inadequate. West slope needs to be landscaped; applicant stated willing to landscape if allowed by staff (Attachment 13).

Other Recommendations: On May 28, 2020, the Historical Resources Board (HRB) voted 10-0-0 to recommend to the Planning Commission adoption of the permit findings and mitigation measures associated with the Site Development Permit per staff's recommendation with the following additions: the decorative fence be managed in perpetuity; both mitigations (decorative fence and storyboard) will be publicly accessible; a representative from the Japanese Historical Society will be able to have an input at the Design Assistance Subcommittee; a qualified historian will participate in the development of the storyboard; and the location of the storyboard will be at the front facing east toward oncoming traffic (see the Historical Designation section below for discussion).

<u>Environmental Review</u>: A <u>Mitigated Negative Declaration</u>, <u>Project No. 512890</u>, has been prepared for the project in accordance with State of California Environmental Quality Act (CEQA) Guidelines. A Mitigation, Monitoring and Reporting Program has been prepared and will be implemented which will reduce impacts to below a level of significance for Historical Resources.

<u>Fiscal Impact Statement</u>: No fiscal impact. All costs associated with the processing of the application are recovered through a deposit account funded by the applicant.

Housing Impact Statement: The Clairemont Mesa Community Plan designates the project site as Medium Density Residential (15-30 du/ac). The total site acreage is 0.615-acres and the site would allow between 9 and 19 dwelling units. The project proposes 13 multifamily dwelling units (21 du/ac) consistent with the density range of the land use designation. The proposed 13 multifamily dwelling units include 12 market-rate units, and one very low-income affordable housing unit. The affordable housing unit will be income-restricted to households with a combined annual gross income at or below 50 percent of the Area Median Income (AMI), subject to an affordable housing agreement with the San Diego Housing Commission (SDHC). As of 2018, there are 32,949 total housing units in Clairemont. Based on SDHC 2020 data, there are currently 852 affordable housing units within Clairemont Mesa (active deed-restricted affordable units).

BACKGROUND

The subject property is a 0.615-acre parcel located at 1398 Lieta Street (to be re-addressed to 4200 Tonopah Avenue), adjacent to the intersection of Lieta Street and Tonopah Avenue to the East and Morena Boulevard to the West. The site is located in the CC-4-5 and RS-1-7 zones within the Clairemont Mesa Community Plan area. The project site is also located in the Airport Influence Area (AIA) Review Area 2 for San Diego International Airport (SDIA), the Federal Aviation Administration (FAA) Part 77 Notification Area (SDIA - 155-feet MSL), the Clairemont Mesa Height Limit Overlay Zone, the Parking Standards Transit Priority Area, and the Transit Priority Area. The lot area zoned RS-1-7 is approximately 14,800 square feet and allows for one (1) dwelling unit. The lot area zoned CC-4-5 is approximately 12,000 square feet and allows for eight (8) dwelling units.

The subject property contains a single-family residence constructed in 1937 and garage constructed in 1956. The Minimal Traditional style house was originally located at the northwestern property boundary but was relocated in 1956 to the southwestern portion of the property. By 1938 the subject

property was owned and occupied by the family of Aizo and Komume Sogo who farmed the land and sold their crops at the hakujin market. In 1942, at the beginning World War II, the family was sent to the Colorado River Relocation Center (Poston War Relocation Center). They remained at this internment camp until 1945, after which time, they returned to the Lieta Street property.

In July 1953, Aizo and Komume Sogo were among the first of five Japanese-born individuals to become naturalized citizens of the United States in San Diego. Previously, natives of Japan, except for World War II veterans, were one of the nationalities barred from citizenship until the passage of the Immigration and Nationality Act of 1952 (aka the McCarran Walter Act). In February 1954, as citizens, the Sogos obtained ownership of the Lieta Street property. In 1962, the Sogos sold three acres of the land which had been zoned residential and commercial. Aizo died in 1974 and Komume, who remained at the property after his death, died in 1983.

The site was reviewed by the Historical Resources Board (HRB) and the site was designated as HRB Site #1305 on July 26, 2018 under HRB Criterion A as a special element of the Issei/Japanese-American agricultural practices within the Mission Bay area during the 1930s through the 1950s and the restrictive property rights/ownership measures taken against minorities, specifically Japanese nationals, during the 1930s through the 1950s. This designation did not include the structures located on the parcel.

The project site is surrounded by a three- and four-story, nine building multi-family complex to the north, one- and two-story single-family dwelling units to the east, and a slope adjacent to the south property line which the lower adjacent property contains commercial development. The sloped property along the western property line is within the City's public right-of-way for Morena Boulevard.

DISCUSSION

Project Description:

The project proposes the development of 13 townhome-type detached dwelling units on a 0.615-acre (26,800-square-foot) parcel. The project site is located within the Clairemont Mesa Community Plan and is dual zoned RS-1-7 and CC-4-5. The lot area zoned RS-1-7 is approximately 14,800 square feet and allows for one dwelling unit. The lot area zoned CC-4-5 is approximately 12,000 square feet and allows for eight dwelling units. The project includes one very low-income unit which allows for a 38.75-percent density bonus of four additional units for a total of 13 dwelling units to be constructed and allows for two development incentives. Of the 13 detached dwelling units, 12 units will be market-rate for-sale town home, and one would be retained for a very low-income affordable housing unit. Eleven dwelling units shall each have an attached two car garage, and Units No. 2 and 3 would include mechanical car lifts to allow for two parking spaces stacked vertically for a total of three spaces. In addition, each of the 13 detached dwelling units would include roof-mounted photovoltaic system consisting of solar panels sufficient to generate at least 50 percent of the proposed project's projected energy consumption. The project conforms to the Affordable/In-Fill Housing and Sustainable Buildings Expedite Program criteria by providing ten percent onsite affordable units and providing a roof-mounted photovoltaic system consistent with the requirements.

The proposed 13 detached dwelling units would consist of ten three-bedroom and three two-bedroom units as shown in Table 1, the project would construct a total of 34,265 square feet.

| Table 1 Total Project Square Footage | | | |
|---------------------------------------|---------------|--------------------------------|-----------------------------|
| Unit No. | Bedroom Count | Square Footage of Product Type | Square Footage of Garage |
| 1 and 2 | 3 | 2,642 (each) | 389 (each) |
| 3 | 3 | 2,543 | 389 |
| 4 | 3 | 2,623 | 352 |
| 5 | 2 | 1,695 | 500 |
| 6 | 2 | 1,751 | 428 |
| 7 | 2 | 1,480 | 500 |
| 8-13 | 3 | 2,284 | 373 (each) |
| TOTAL | | 29,080 | 5,185 |

The proposed development will extend Tonopah Avenue from its existing dead end at the intersection of Lieta Street and Tonopah Avenue into the subject property. Each dwelling unit contains enclosed parking of two parking spaces per unit. The construction of a "T-Intersection" at the center of the subject property along with the installation of a new fire hydrant will allow for both pedestrian vehicles and emergency vehicles to safely access each unit from within the subject property. This center intersection would allow for access for emergency vehicles and trash/utility services as well as to allow for pedestrian vehicles to safely turnaround and exit the property.

The organization of separated, low-lying buildings as opposed to a single multi-family structure keeps the project consistent with the surrounding low-lying single-family nature of the adjacent neighborhood to the east. The structures would be under the 30-foot height restriction of the Clairemont Mesa Height Limit requirement, and sited on the northern portion of the parcel to ensuring that neighbors will have view access from and along Tonopah Avenue to the San Diego Bay to the west and downtown San Diego to the south.

Discretionary Actions:

The project development requires the following discretionary actions:

- Site Development Permit (SDP) for development on a designated historical site.
- <u>Neighborhood Development Permit (NDP)</u> for deviations to the development regulations for an Affordable Housing and Sustainable Buildings project, and for tandem parking for the residential development.
- <u>Tentative Map (TM)</u> for a residential condominium development.

Community Plan Analysis:

The proposed project is consistent with the General Plan and Community Plan. The Clairemont Mesa Community Plan designates the 0.615-acre site as Medium Residential, allowing 15-30 du/ac. The proposed project's 13 townhome-type dwelling units, which includes one very low-income affordable dwelling unit, would implement the land use designation and meet Citywide goals for providing affordable housing opportunities on site.

The proposed project site is within the Clairemont Mesa Height Limit Overlay Zone 30 feet height limit. The height limit is intended to maintain the low-scale character of development in the community and to preserve public views of Mission Bay and the Pacific Ocean from western Clairemont. The proposed project's height of 30 feet would not exceed the limit established by the Overlay Zone and would not adversely affect public views.

The General Plan Urban Design Element Policy UD-A.5 states that building design should contribute to a positive neighborhood character and relate to neighborhood and community context. Building design is encouraged to be sensitive to the scale, form, rhythm, proportions, and materials in proximity to commercial areas and residential neighborhoods. The proposed project's 3-story townhome design is consistent in scale with the adjacent 3-story multifamily apartment complex to the north and the recently approved 3-story Morena Apartment Homes project (Project No. 526167, Item 334, approved by City Council on January 8, 2019) to the southwest of the project site, which is currently under construction. General Plan Urban Design Element Policy UD-A.5 also directs buildings to have architectural interest and offsetting planes to provide visual interest (page UD-10). The proposed project incorporates balconies, and variation in materials and colors to articulate the buildings and add visual interest along the project frontage.

The General Plan Mobility Element Policy ME-A.2 promotes safety and accessibility by directing the design and implementation of safe pedestrian routes (page ME-8). The proposed site design incorporates pedestrian paths along Tonopah Avenue that would connect pedestrians to the building entrances of each residence.

The proposed project site is adjacent to Morena Boulevard and is located just east of I-5. As a result, the proposed project would be exposed to noise levels potentially exceeding the exterior noise compatibility thresholds for residential uses. The General Plan Noise Element identifies construction techniques including sound-rated windows, door and wall construction materials and insulation as techniques to insulate the noise receiver and abate noise high noise levels (page NE -20). The Community Plan's Noise Sources section of the Transportation Element identifies architectural design features that can reduce high noise levels, including insulation of windows, acoustical walls, and dense building materials. The proposed project would incorporate noise attenuation measures including dense materials for walls and doors, and insulation of windows to ensure interior noise levels in residences do not exceed General Plan standards.

Historical Designation:

As stated above, the project site was reviewed by the HRB and the site was designated as HRB Site #1305 on July 26, 2018 under HRB Criterion A as a special element of the Issei/Japanese-American agricultural practices within the Mission Bay area during the 1930s through the 1950s and the restrictive property rights/ownership measures taken against minorities, specifically Japanese nationals, during the 1930s through the 1950s. This designation did not include the structures located on the parcel.

The City's <u>San Diego Municipal Code (SDMC) Section 126.0504(b)(2)</u> requires a recommendation from the HRB prior to the Planning Commission decision on an SDP when a historical district or designated historical resource is present. The HRB has adopted the following procedure for making recommendations to decision-makers (Historical Resources Board Procedures, Section II.D):

When the Historical Resources Board is taking action on a recommendation to a decision-maker, the Board shall make a recommendation on only those aspects of the matter that relate to the historical aspects of the project. The Board's recommendation action(s) shall relate to the cultural resources section, recommendations, findings and mitigation measures of the final environmental document, the Site Development Permit findings for historical purposes, and/or the project's compliance with the Secretary of the Interior's Standards for Treatment of Historic Properties. If the Board desires to recommend the inclusion of additional conditions, the motion should include a request for staff to incorporate permit conditions to capture the Board's recommendations when the project moves forward to the decision maker.

The project proposes a substantial alteration of the Aizo and Komume Sogo Farm (HRB Site #1305), by the demolition of all structures on the site and construction of 13 new three-story dwelling units. Although the structures on site were not included in the designation, the redevelopment of the site and the use of the site for anything other than its historic use will adversely impact the context of the site through alteration of the setting, feeling and association. Therefore, the proposed demolition and redevelopment of the designated site is by definition a substantial alteration requiring an SDP, consistent with SDMC Section 143.0251. Impacts related to the proposed demolition would be reduced through implementation of the required mitigation measures found in the Mitigated Negative Declaration No. 512890. Findings for the substantial alteration of a designated historical resource are required for approval of the permit, consistent with SDMC Section 126.0504(i) and have been included within the SDP/NDP Resolution (Attachment 6).

The applicant evaluated three different alternatives, including the proposed project, in an Economic Alternative Analysis conducted by London Moeder Advisors (Attachment 11) which found only the base project economically viable. Alternative 1 analyzed restoration of the property to its historic use by rehabilitating the existing residence and returning the remaining land to a dormant state because an agricultural use would not be allowed by the current zoning regulations. This alternative was not found to be economically feasible because the cost of the land is more than the anticipated sale price of the single-family home. Alternative 2 analyzed the demolition of the existing residence and the construction of three new single-family homes. This scenario provided a less dense development alternative that would reduce the impact to the historic resource. This alternative was also found to

be economically infeasible because the purchase price of the land as well as the cost to construct the three new residences was more than the combined anticipated sale prices of the units. A peer review conducted by the City of San Diego's Economic Development Department confirmed the results of the London Moeder study (Attachment 12).

While the use of this site for any other purpose other than its historic use will result in a loss of historic context; the proposed project will mitigate this impact to the historic setting, feeling and association of the site. Historical Resource mitigation measures have been developed and included within the project's Final Mitigated Negative Declaration No. 512890 – conditioning issuance of building permits upon prior submittal of a plan showing the design and location of both an interpretive story board and an etched glass panel fence and conditioning any Certificate of Occupancy upon prior installation of the approved story board to preserve the history of the site in the public realm. The story board will be placed at the entrance of the property at the western terminus of Tonopah Street and will use the story of the Sogo family and their farm to provide information about the Issei/Japanese-American agricultural practices specific to the Mission Bay area during the 1930s through the 1950s and the restrictive property rights/ownership measures taken against minorities during this time period. The etched panel fence will be located on the edge of the property above the highly trafficked Morena Boulevard and will use illustrations of row crops, historically grown in the Mission Bay area by the Japanese farmers, to depict the history of the resource.

On May 28, 2020, the HRB voted 10-0-0 to recommend to the Planning Commission adopt the permit findings and mitigation measures associated with the SDP per staff's recommendation with the following additions: the decorative fence be managed in perpetuity; both mitigations (decorative fence and storyboard) will be publicly accessible; a representative from the Japanese Historical Society will be able to have an input at the Design Assistance Subcommittee; a qualified historian will participate in the development of the storyboard; and the location of the storyboard will be at the front facing east toward oncoming traffic.

The applicant agreed to all of the additional revisions as discussed and made part of the motion prior to the HRB vote. However, the applicant later realized that agreeing to both the decorative fence and storyboard to be publicly accessible would require a public access easement to be recorded on and through the property following the ADA path of travel identified on the plans. A public access easement is the own way to assure the public would have access to the decorative fence and storyboard from the property and not be classified or cited as trespassing on private property.

The original intent of the decorative fence along the western property line is to represent the historical agricultural use of the property as seen from the public right-of-way along Morena Boulevard and the I-5, not for the public to have access from the property. In addition, the original intent of the storyboard was to provide the historical aspects of the property as you enter the property. Based on the original intent and to meet the objectives of the HRB recommendation for approval, the applicant revised the plans as follow:

1. The three-20-foot x 48-inch high decorative fences were reconfigured along the western property line to make them a prominent feature as viewed from the public right-of-way along Morena Boulevard (see Attachment 13, Exhibit A- Sheet A1.01). In addition, the landscape and

planters were reconfigured to not block the decorative fencing or create shadows onto or behind the panels. This change does not include a public access easement on the property for the decorative fencing.

2. The location size of the storyboard has been revised to four feet high x 15 feet wide mounted on posts in front of existing fence along the entrance to the property from the extend Tonopah Avenue (see Attachment 13, Exhibit A- Sheet A1.01). This change does include a four-foot six-inch x 61-foot long public access easement to be recorded on-site, located at the terminus of Tonopah Avenue and along the front of the storyboard to allow the public access to the storyboard.

City staff has reviewed and determined that the above revisions to the plans meets the original intent of the mitigation measures and have been included in the SDP/NDP Permit Conditions (Attachment 7).

Project-Related Issues:

<u>Incentives and Deviations to the SDMC</u> - The project is requesting two incentives for side setback and floor area ratio (FAR), and three deviations for side setback in the CC-4-5 zone, angled building envelope plane requirements, and to remove the commercial component required for the CC-4-5 zone. The details of the incentives and deviations are as follows:

<u>Incentive No. 1</u>- A development incentive to <u>SDMC Table 131-04D</u> to reduce the side setback requirements of the RS-1-7 zone from eight feet to five feet. This ensures that each unit is provided with a minimum of two parking spaces within individual garages (two will have car lifts that will have three parking spaces).

<u>Incentive No. 2</u>- A development incentive to <u>SDMC Section 131.0446(a)</u>, <u>Table 131-04</u> and to <u>SDMC Table 131-05E</u> to increase the allowed FAR of the combined zones of the property from 31,400 square feet to 34,265 square feet, an increase of approximately nine percent.

<u>Deviation No. 1</u>- A deviation request to <u>SDMC Section 131.0543(b)</u> to allow for a five-foot side setback along the northern property line in the CC-4-5 portion of the property, where a minimum 10-foot side setback or the option for no side setbacks are required. This deviation provides relief for adjacent residential units along the property line as well as keeps the proposed dwelling units in the CC-4-5 portion of the property consistent with the location of the dwelling units in the RS-1-7 portion of the zone with the requested reduced side setback development incentive being requested (see Incentive No. 1 above).

<u>Deviation No. 2</u>- A deviation request to <u>SDMC Section 131.0444(c)</u> to remove the angled building envelope plane requirement along the reduced side setback line in the RS-1-7 zone as outlined in Incentive No. 1 above. This deviation is necessary to incorporate an Affordable Housing Density Bonus of four dwelling units, which is consistent with the land use designation and density with additional density allowed under the Affordable Housing Density Bonus provision in SDMC Chapter 14, Article 3, Division 7.

<u>Deviation No. 3</u>- A deviation request to <u>SDMC Section 131.0540(b)</u> to remove the commercial component requirement in the CC-4-5 zone. A commercial component doesn't fit with the residential nature of the surrounding neighborhood and would require consumers of the commercial component to enter via a residential neighborhood to the east or navigate up a 20-foot steep slope from Morena Boulevard. The subject property sits approximately 20 feet above Morena Boulevard, separated by a steep hillside in the public right of way.

Each of the requested incentives and deviations has been reviewed as they relate to the proposed design and use of the proposed project, the site layout, and the impact on the surrounding neighborhood. The requested incentives and deviations are appropriate and will result in a better project that efficiently utilizes the subject property while meeting the purpose and intent of the Clairemont Mesa Community Plan and will respect the surrounding single-family and multi-family neighborhood. Other than the requested deviations, and the incentives allowed per the requirements of the San Diego Affordable Housing Density Bonus Program, the proposed project meets all applicable regulations and policy documents and is consistent with the recommended land use and development standards in effect for the subject property per the SDMC.

Conclusion:

While the use of this site for purposes other than its historic farm use will result in a loss of historic context, the proposed project will mitigate this impact to the historic setting, feeling and association of the site through the incorporation of a historic interpretive storyboard on site that will detail the history and significance of the Aizo and Komume Sogo Farm for the benefit of the public and decorative fencing that will be placed above the slope on Morena Boulevard that will depict the property's historic use as a farm as it relates to the designation. With the approval of the requested incentives and deviations, the proposed Project meets all applicable regulations and policy documents, and staff finds the Project consistent with the recommended land use, design guidelines, and development standards in effect for this site per the adopted Clairemont Mesa Community Plan, SDMC, and the General Plan. In addition, the Project would further the City's affordable housing goals by developing one affordable housing units on-site. Therefore, staff recommends that the Planning Commission approve the project.

ALTERNATIVES

- 1. ADOPT Mitigated Negative Declaration No. 512890 and ADOPT the Mitigation, Monitoring, and Reporting Program; and APPROVE Site Development Permit No. 1823446, Neighborhood Development Permit No. 2011943, and Tentative Map No. 2011944, with modifications.
- 2. DO NOT ADOPT Mitigated Negative Declaration No. 512890 and DO NOT ADOPT the Mitigation, Monitoring, and Reporting Program; and DENY Site Development Permit No. 1823446, Neighborhood Development Permit No. 2011943, and Tentative Map No. 2011944, if the findings required to approve the project cannot be affirmed.

Respectfully submitted,

for


PJ FitzGerald Assistant Deputy Director Development Services Department

Jeffrey M. Peterson
Development Project Manager
Development Services Department


FITZGERALD/JAP

Attachments:

- 1. Location Map
- 2. Aerial Photograph
- 3. Zoning Map
- 4. Community Plan Land Use Map
- 5. Site Photographs
- 6. Draft SDP/NDP Resolution
- 7. Draft SDP/NDP with Conditions
- 8. Draft TM Resolution
- 9. Draft TM Conditions
- 10. Draft Environmental Resolution with MMRP
- 11. Economic Alternative Analysis conducted by London Moeder Advisors
- 12. City of San Diego's Economic Development Department Memo
- 13. Community Planning Group Recommendation
- 14. Ownership Disclosure Statement
- 15. Project Plans

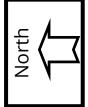




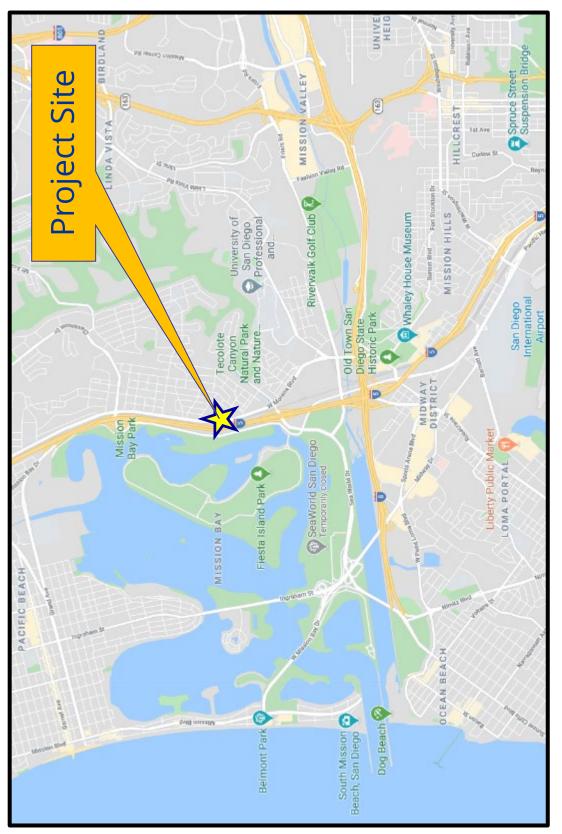


Location Map

1398 Lieta Street (to be re-addressed to 4200 Tonopah Avenue) 1398 Lieta Street-Project 512890

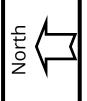




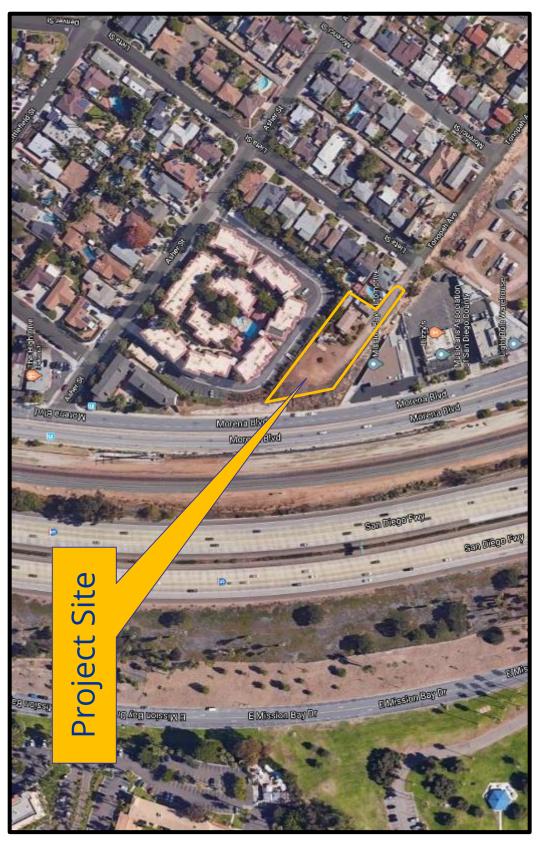

Aerial Photograph

1398 Lieta Street (to be re-addressed to 4200 Tonopah Avenue)

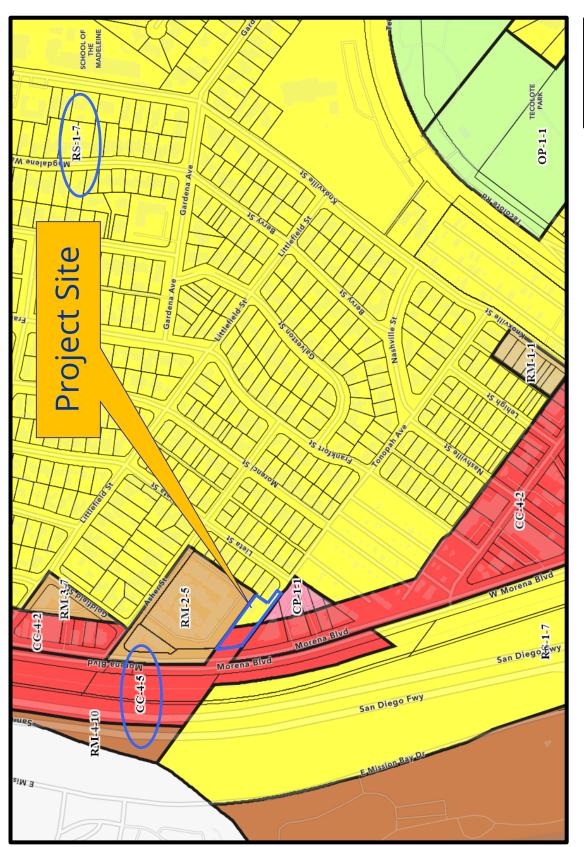




Zoning Map (RS-1-7 and CC-4-5 Zones)

1398 Lieta Street-Project 512890

1398 Lieta Street (to be re-addressed to 4200 Tonopah Avenue)

Clairemont Mesa Community Plan Land Use

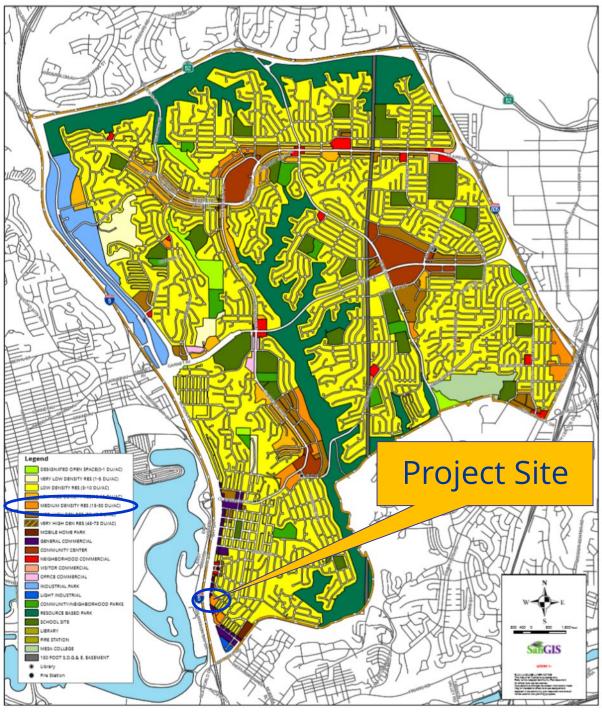




Community Plan Land Use Map

<u>1398 Lieta Street-Project 512890</u> 1398 Lieta Street




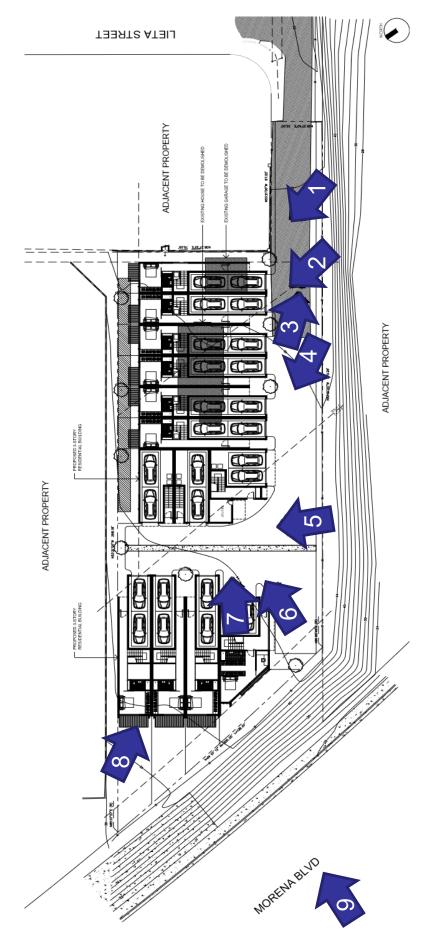

Site Photographic Survey-Location Map

1398 Lieta Street-Project 512890

1398 Lieta Street (to be re-addressed to 4200 Tonopah Avenue)

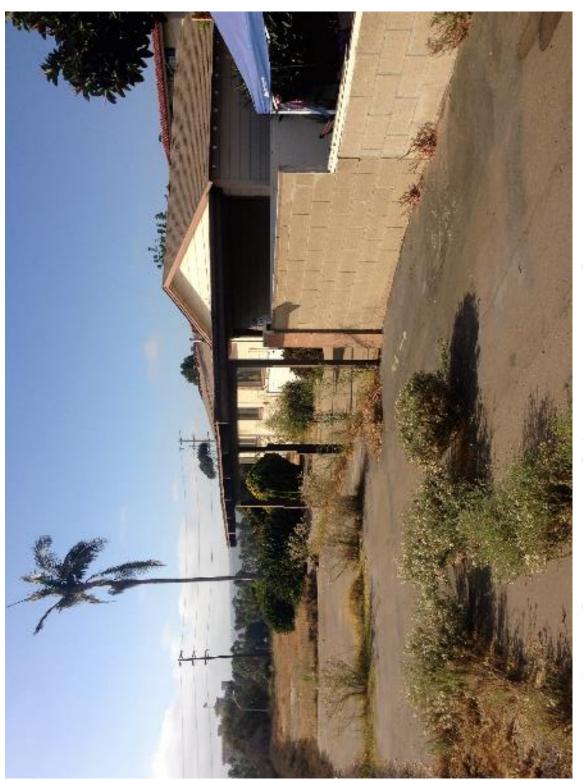


Site Photographic Survey-Photo#


1398 Lieta Street-Project 512890 1398 Lieta Street (to be re-addressed to 4200 Tonopah Avenue)




Site Photographic Survey-Photo # 2 1398 Lieta Street (to be re-addressed to 4200 Tonopah Avenue)

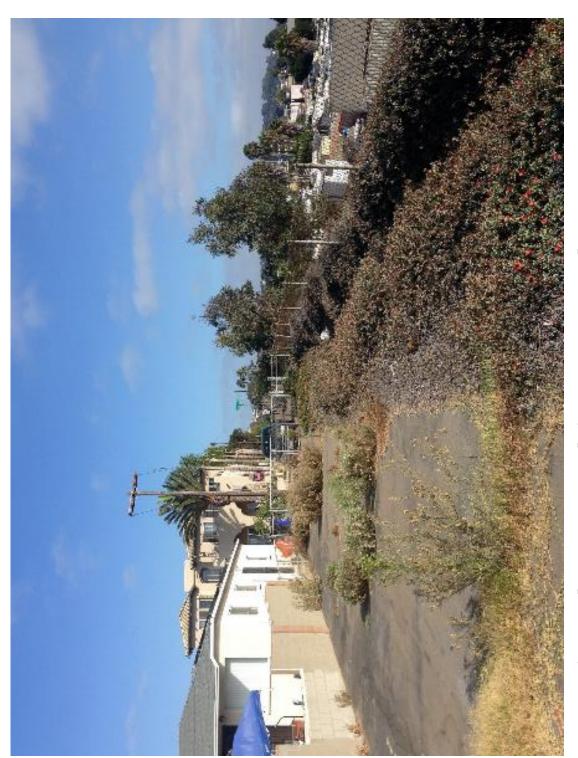

Site Photographic Survey-Photo # 3 1398 Lieta Street (to be re-addressed to 4200 Tonopah Avenue)

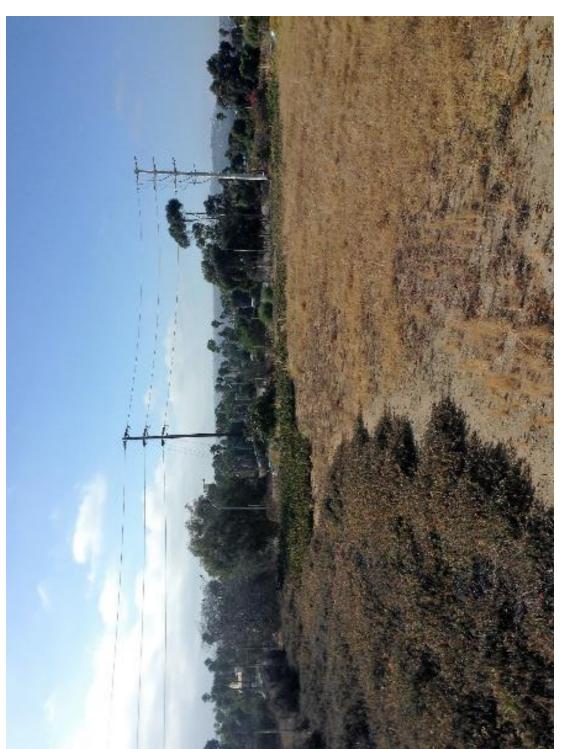


Site Photographic Survey-Photo # 4 1398 Lieta Street (to be re-addressed to 4200 Tonopah Avenue)

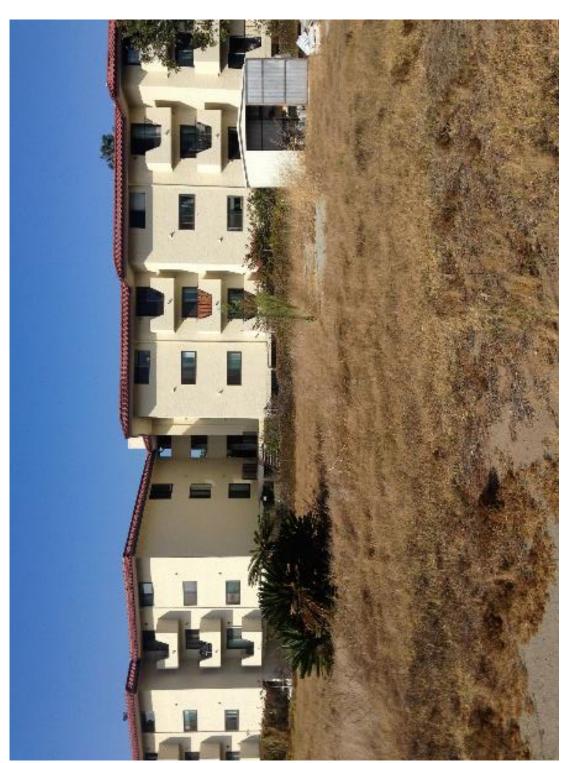


Site Photographic Survey-Photo # 5 1398 Lieta Street (to be re-addressed to 4200 Tonopah Avenue)



Site Photographic Survey-Photo # 6 1398 Lieta Street (to be re-addressed to 4200 Tonopah Avenue)

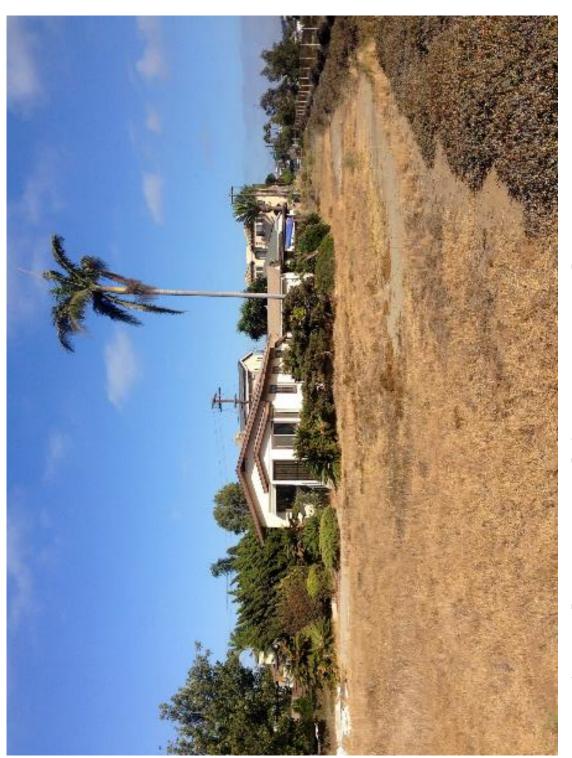

Site Photographic Survey-Photo # 7 1398 Lieta Street (to be re-addressed to 4200 Tonopah Avenue)

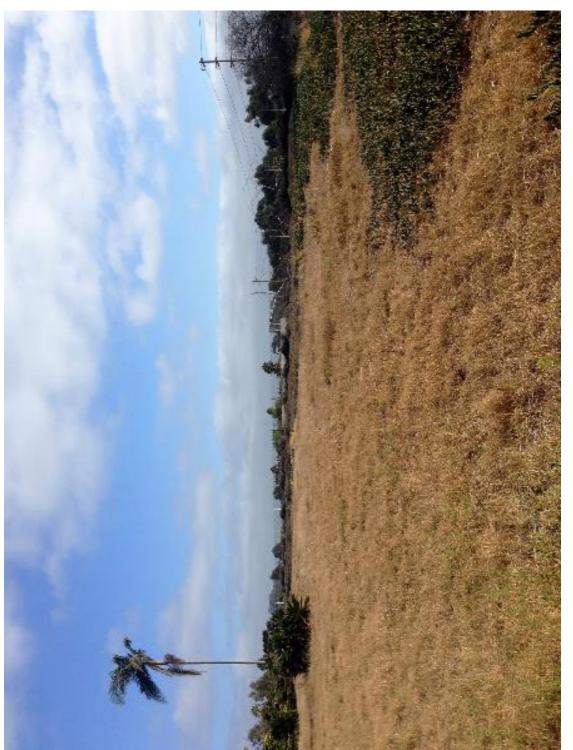

Site Photographic Survey-Photo # 8 1398 Lieta Street (to be re-addressed to 4200 Tonopah Avenue)



Site Photographic Survey-Photo # 9 1398 Lieta Street (to be re-addressed to 4200 Tonopah Avenue)

PLANNING COMMISSION RESOLUTION NO.

SITE DEVELOPMENT PERMIT NO. 1823446

NEIGHBORHOOD DEVELOPMENT PERMIT NO. 2011943

1398 LIETA STREET -PROJECT NO. 512890 [MMRP]

WHEREAS, ALMERIA INVESTMENTS, LP, a California Domestic Limited Partnership, Owner and Permittee, filed an application with the City of San Diego for a permit for the demolition of an existing single dwelling unit and the construction of 13 townhome-type detached dwelling units (as described in and by reference to the approved Exhibits "A" and corresponding conditions of approval for the associated Permit Nos. 1823446 and 2011943), on portions of a 0.615-acre site;

WHEREAS, the project site is located at 1398 Lieta Street (new address: 4200 Tonopah Avenue) in the CC-4-5 and RS-1-7 Zones within the Clairemont Mesa Community Plan area. The project site is also located in the Airport Influence Area (AIA) Review Area 2 for San Diego International Airport (SDIA), the Federal Aviation Administration (FAA) Part 77 Notification Area (SDIA - 155-feet MSL), and the Clairemont Mesa Height Limit Overlay Zone;

WHEREAS, the project site is legally described as: the southwesterly 100 feet of all that portion of Lot 5 of pueblo lot 225 according to referee's partition map files in the action of Morena Company, a corporation, vs. Franklin Steel, Jr., Case No. 3475 filed in the Superior Court of the County of San Diego, lying southwest the centerline of Asher Street, as said street existed on January 21, 1944. Excepting therefrom the following parcels: A. That portion of said lot, if any, lying within the right-of-way of the Atchison, Topeka and Santa Fe railway. B. That portion described in the deed to the City of San Diego recorded March 23, 1956, in book 6029, Page 122 of official records. C. That portion lying southeasterly of a line which is parallel with and distant 101.5 feet northwesterly from the southeasterly line of block 17 of first addition to Asher's cloverleaf terrace, according to Map thereof No. 1666, filed in the Office of the County Recorder of San Diego County, and the

northeasterly prolongation of said southeasterly line, and lying northeasterly of the northwesterly prolongation of the southwest line of Lot 17 in Block 17 of said First Addition to Asher's cloverleaf terrace. D. That portion lying within Lahoud Terrace, according to Map thereof No. 3134, filed in the Office of the County Recorder of San Diego County, October 4, 1954;

WHEREAS, on August 20, 2020, the Planning Commission of the City of San Diego considered Site Development Permit No. 1823446 and Neighborhood Development Permit No. 2011943 pursuant to the Land Development Code of the City of San Diego; NOW, THEREFORE,

BE IT RESOLVED by the Planning Commission of the City of San Diego, that it adopts the following findings with respect to Site Development Permit No. 1823446 and Neighborhood Development Permit No. 2011943:

A. <u>NEIGHBORHOOD DEVELOPMENT PERMIT [SDMC Section 126.0404]</u>

- 1. <u>Findings for all Neighborhood Development Permits [SDMC Section 126.0404(a)]:</u>
 - a. The proposed development will not adversely affect the applicable land use plan.

The subject property is a 0.615-acre parcel located at 1398 Lieta Street (to be readdressed to 4200 Tonopah Avenue), adjacent to the intersection of Lieta Street and Tonopah Avenue to the East and Morena Boulevard to the West. The site is located in the CC-4-5 and RS-1-7 zones within the Clairemont Mesa Community Plan area. The lot area zoned RS-1-7 is approximately 14,800 square feet and allows for one (1) dwelling unit. The lot area zoned CC-4-5 is approximately 12,000 square feet and allows for eight (8) dwelling units.

The subject property contains a single-family residence constructed in 1937 and garage constructed in 1956. The Minimal Traditional style house was originally located at the northwestern property boundary but was relocated in 1956 to the southwestern portion of the property. By 1938 the subject property was owned and occupied by the family of Aizo and Komume Sogo who farmed the land and sold their crops at the hakujin market. In 1942, at the beginning World War II, the family was sent to the Colorado River Relocation Center (Poston War Relocation Center). They remained at this internment camp until 1945, after which time, they returned to the Lieta Street property.

In July 1953, Aizo and Komume Sogo were among the first of five Japanese-born individuals to become naturalized citizens of the United States in San Diego. Previously, natives of Japan, except for World War II veterans, were one of the nationalities barred from citizenship until the passage of the Immigration and Nationality Act of 1952 (aka the McCarran Walter Act). In February 1954, as citizens, the Sogos obtained ownership of the Lieta Street property. In 1962, the Sogos sold three acres of the land which had been zoned residential and commercial. Aizo died in 1974 and Komume, who remained at the property after his death, died in 1983.

The site was reviewed by the Historical Resources Board (HRB) and the site was designated as HRB Site #1305 on July 26, 2018 under HRB Criterion A as a special element of the Issei/Japanese-American agricultural practices within the Mission Bay area during the 1930s through the 1950s and the restrictive property rights/ ownership measures taken against minorities, specifically Japanese nationals, during the 1930s through the 1950s. This designation did not include the structures located on the parcel.

The project proposes the demolition of the existing structures and development of 13 townhome-type detached dwelling units on the parcel. The project includes one very low-income unit which allows for a 38.75-percent density bonus of four additional units for a total of 13 dwelling units to be constructed and allows for two development incentives. Of the 13 detached dwelling units, 12 units will be market-rate for-sale town homes, and one will be retained for a very low-income affordable housing unit.

The Clairemont Mesa Community Plan designates the project site Medium Density Residential, 15-30 dwelling units per acre (du/ac). The total site acreage is 0.615-acres and would allow between 9 and 19 dwelling units. The project proposes 13 detached dwelling units consistent with the density range of the land use designation. The General Plan Urban Design Element states that building design should contribute to a positive neighborhood character and relate to neighborhood and community context. Building design is encouraged to be sensitive to the scale, form, rhythm, proportions, and materials in proximity to commercial areas and residential neighborhoods. The proposed project's three-story townhome-type design is consistent in scale with the adjacent three- and four-story multifamily apartment complex to the north and the recently approved three-story Morena Apartment Homes project to the southwest of the project site, which is currently under construction. The proposed project incorporates variation in material and color to articulate the buildings and add visual interest along the project frontage.

The proposed project site is adjacent to Morena Boulevard and is located just east of I-5. The proposed project would incorporate noise attenuation measures including dense materials for walls and doors, and insulation of windows to ensure interior noise levels in residences do not exceed General Plan standards.

While the use of this site for purposes other than its historic farm use will result in a loss of historic context, the proposed project will mitigate this impact to the historic setting, feeling and association of the site through the incorporation of a historic

interpretive storyboard on site that will detail the history and significance of the Aizo and Komume Sogo Farm for the benefit of the public and decorative fencing that will be placed above the slope on Morena Boulevard that will depict the property's historic use as a farm as it relates to the designation. Therefore, for these reasons, the development would not adversely affect the applicable land use plan.

b. The proposed development will not be detrimental to the public health, safety, and welfare.

The project proposes the demolition of the existing structures and development of 13 townhome-type detached dwelling units on the parcel. The project includes one very low-income unit which allows for a 38.75-percent density bonus of four additional units for a total of 13 dwelling units to be constructed and allows for two development incentives. Of the 13 detached dwelling units, 12 units will be market-rate for-sale town homes, and one will be retained for a very low-income affordable housing unit. Eleven dwelling units shall each have an attached two car garage, and Units No. 2 and 3 would include mechanical car lifts to allow for two parking spaces stacked vertically for a total of three spaces. In addition, each of the 13 detached dwelling units would include roof-mounted photovoltaic system consisting of solar panels sufficient to generate at least 50 percent of the proposed project's projected energy consumption. The project conforms to the Affordable/In-Fill Housing and Sustainable Buildings Expedite Program criteria by providing ten percent onsite affordable units and providing a roof-mounted photovoltaic system consistent with the requirements.

A Mitigated Negative Declaration, Project No. 512890, has been prepared for the project in accordance with State of California Environmental Quality Act (CEQA) guidelines. A Mitigation, Monitoring and Reporting Program has been prepared and will be implemented which will reduce impacts to below a level of significance for Historical Resources.

The permit for the Project includes various conditions and referenced exhibits of approval relevant to achieving compliance with the applicable regulations of the San Diego Municipal Code (SDMC) in effect for this Project. Such conditions within the permit have been determined as necessary to avoid adverse impacts upon the health, safety and general welfare of persons residing or working in the surrounding area. The Project will comply with the development conditions in effect for the subject property as described in Site Development Permit No. 1823446 and Neighborhood Development Permit No. 2011943, and other regulations and guidelines pertaining to the subject property per the SDMC for the site. Prior to issuance of any building permits for the proposed development, the plans will be reviewed for compliance with all Building, Electrical, Mechanical, Plumbing and Fire Code requirements, and the Owner/Permittee will be required to obtain a grading and public improvement permit. Therefore, the proposed development would not be detrimental to the public health, safety and welfare.

c. The proposed development will comply with the applicable regulations of the Land Development Code including any allowable deviations pursuant to the Land Development Code.

The project proposes the demolition of the existing structures and development of 13 townhome-type detached dwelling units on the parcel. The project includes one very low-income unit which allows for a 38.75-percent density bonus of four additional units for a total of 13 dwelling units to be constructed and allows for two development incentives. Of the 13 detached dwelling units, 12 units will be market-rate for-sale town homes, and one will be retained for a very low-income affordable housing unit. Eleven dwelling units shall each have an attached two car garage, and Units No. 2 and 3 would include mechanical car lifts to allow for two parking spaces stacked vertically for a total of three spaces. The parking regulations require 28 total parking spaces, and the proposed development provides 28 total parking spaces.

The proposed development will extend Tonopah Avenue from its existing dead end at the intersection of Lieta Street and Tonopah Avenue into the subject property. Each dwelling unit contains enclosed parking of two parking spaces per unit. The construction of a "T-Intersection" at the center of the subject property along with the installation of a new fire hydrant will allow for both pedestrian vehicles and emergency vehicles to safely access each unit from within the subject property. This center intersection would allow for access for emergency vehicles and trash/utility services as well as to allow for pedestrian vehicles to safely turnaround and exit the property.

The organization of separated, low-lying buildings as opposed to a single multi-family structure keeps the project consistent with the surrounding low-lying single-family nature of the adjacent neighborhood to the east. The structures would be under the 30-foot height restriction of the Clairemont Mesa Height Limit requirement, and sited on the northern portion of the parcel to ensuring that neighbors will have view access from and along Tonopah Avenue to the San Diego Bay to the west and downtown San Diego to the south.

The project is requesting two incentives for side setback in the RS-1-7 zone and floor area ratio (FAR), and three deviations for side setback in the CC-4-5 zone, angled building envelope plane requirements, and to remove the commercial component required for the CC-4-5 zone. The details of the incentives and deviations are as follows:

Incentive No. 1- A development incentive to SDMC Table 131-04D to reduce the side setback requirements of the RS-1-7 zone from eight feet to five feet. This ensures that each unit is provided with a minimum of two parking spaces within individual garages (two will have car lifts that will have three parking spaces).

Incentive No. 2- A development incentive to SDMC Section 131.0446(a), Table 131-04J and to SDMC Table 131-05E to increase the alloed FAR of the combined zones of the property from 31,400 square feet to 34,265 square feet, an increase of approximately nine percent.

Deviation No. 1- A deviation request to SDMC Section 131.0543(b) to allow for a five-foot side setback along the northern property line in the CC-4-5 portion of the property, where a minimum 10-foot side setback or the option for no side setbacks are required. This deviation provides relief for adjacent residential units along the property line as well as keeps the proposed dwelling units in the CC-4-5 portion of the property consistent with the location of the dwelling units in the RS-1-7 portion of the zone with the requested reduced side setback development incentive being requested (see Incentive No. 1 above).

Deviation No. 2- A deviation request to SDMC Section 131.0444(c) to remove the angled building envelope plane requirement along the reduced side setback line in the RS-1-7 zone as outlined in Incentive No. 1 above. This deviation is necessary to incorporate an Affordable Housing Density Bonus of four dwelling units, which is consistent with the land use designation and density with additional density allowed under the Affordable Housing Density Bonus provision in SDMC Chapter 14, Article 3, Division 7.

Deviation No. 3- A deviation request to SDMC Section 131.0540(b) to remove the commercial component requirement in the CC-4-5 zone. A commercial component doesn't fit with the residential nature of the surrounding neighborhood and would require consumers of the commercial component to enter via a residential neighborhood to the east or navigate up a 20-foot steep slope from Morena Boulevard. The subject property sits approximately 20 feet above Morena Boulevard, separated by a steep hillside in the public right of way.

Each of the requested incentives and deviations has been reviewed as they relate to the proposed design and use of the proposed project, the site layout, and the impact on the surrounding neighborhood. The requested incentives and deviations are appropriate at this location and will result in a better project that efficiently utilizes the subject property while meeting the purpose and intent of the SDMC and the Clairemont Mesa Community Plan and would respect the surrounding single-family and multi-family neighborhood. Therefore, the proposed development would comply with the applicable regulations, including any allowable deviations.

- 2. <u>Supplemental Findings Affordable Housing, In-Fill Projects, or Sustainable Buildings Deviation [SDMC Section 126.0404(f)]:</u>
 - a. The development will materially assist in accomplishing the goal of providing affordable housing, in-fill projects, or sustainable buildings opportunities.

The project proposes the demolition of the existing structures and development of 13 townhome-type detached dwelling units on the parcel. The project includes one very low-income unit which allows for a 38.75-percent density bonus of four additional units for a total of 13 dwelling units to be constructed and allows for two development incentives. Of the 13 detached dwelling units, 12 units will be market-rate for-sale town homes, and one will be retained for a very low-income affordable

housing unit. Eleven dwelling units shall have an attached two car garage, and Units No. 2 and 3 would include mechanical car lifts to allow for two parking spaces stacked vertically for a total of three spaces. In addition, each of the 13 detached dwelling units would include roof-mounted photovoltaic system consisting of solar panels sufficient to generate at least 50 percent of the proposed project's projected energy consumption. Therefore, the development would materially assist in accomplishing the goal of providing an affordable housing unit on-site and by providing roof-mounted photovoltaic systems on each unit would materially assist sustainable buildings opportunities.

b. Any proposed deviations are appropriate for the proposed location.

As outlined in Neighborhood Development Permit Finding (A)(1)(c) listed above, the project is requesting two incentives for side setback in the RS-1-7 zone and floor area ratio (FAR), and three deviations for side setback in the CC-4-5 zone, angled building envelope plane requirements, and to remove the commercial component required for the CC-4-5 zone. Each of the requested incentives and deviations has been reviewed as they relate to the proposed design and use of the proposed project, the site layout, and the impact on the surrounding neighborhood. The requested incentives and deviations are appropriate at this location and will result in a better project that efficiently utilizes the subject property while meeting the purpose and intent of the SDMC and the Clairemont Mesa Community Plan and would respect the surrounding single-family and multi-family neighborhood.

B. <u>SITE DEVELOPMENT PERMIT [SDMC Section 126.0505]</u>

- 1. Findings for all Site Development Permits [SDMC Section 126.0505(a)]:
 - a. The proposed development will not adversely affect the applicable land use plan.

As outlined in Neighborhood Development Permit Finding A.1.a. listed above, the proposed development would not adversely affect the applicable land use plan.

 The proposed development will not be detrimental to the public health, safety, and welfare.

As outlined in Neighborhood Development Permit Finding A.1.b. listed above, the proposed development would not be detrimental to the public health, safety and welfare.

c. The proposed development will comply with the applicable regulations of the Land Development Code including any allowable deviations pursuant to the Land Development Code.

As outlined in Neighborhood Development Permit Finding A.1.c. listed above, the proposed development would comply to the applicable regulations and the requested incentives and deviations are appropriate at this location and will result in

a better project that efficiently utilizes the subject property while meeting the purpose and intent of the LDC and the Clairemont Mesa Community Plan and would respect the surrounding single-family and multi-family neighborhood.

- 2. <u>Supplemental Findings Historical Resources Deviation for Substantial Alteration of a Designated Historical Resource or Within a Historical District [SDMC Section 126.0505(i)]:</u>
 - a. There are no feasible measures, including a less environmentally damaging alternative, that can further minimize the potential adverse effects on the designated historical resource.

The Aizo and Komume Sego Farm was designated, under Criterion A, as a special element of the Issei/Japanese-American agricultural practices within the Mission Bay area during the 1930s through the 1950s, and the restrictive property rights/ ownership measures taken against minorities, specifically Japanese nationals, during the 1930s through the 1950s. The designation excluded all of the structures on the property as they had limited association with the Farm itself. The vacant land at the site today retains the setting, feeling and association of the site as a farm, but the proposed development of this site, the Base Project, will eliminate those historic aspects of the property. However, the continued use of this site as a farm is not a feasible alternative, as no portion of the subject property is zoned AR, or as an Agricultural Residential Zone.

The eastern portion of the subject property, 14,800 square feet, is zoned RS 1-7, a Residential Single Unit Zone, pursuant to SDMC Section 131.0403. The purpose of RS zones is to provide appropriate regulations for the development of single dwelling units that accommodate a variety of lot sizes and residential dwelling types and which promote neighborhood quality, character, and livability. In addition, the western portion of the subject property, 12,000 square feet, is zoned CC-4-5. The purpose the CC or Community-Commercial zones is to accommodate community-serving commercial services, retail uses and limited industrial uses of moderate intensity and small to medium scale. The CC zones are intended to provide a range of development patterns from the pedestrian friendly commercial to shopping-centers and auto-oriented strip commercial streets. (SDMC Section 131.0507(a)) The CC-4-5 zone is intended to accommodate development with a high intensity, pedestrian orientation and permits maximum density of 1 dwelling unit for each 1500 square feet of lot area. (SDMC Section 131.0507(b)(4). Therefore, the site can no longer be used as a farm as it was historically.

While the use of this site for purposes other than its historic farm use will result in a loss of historic context, the proposed project will mitigate this impact to the historic setting, feeling and association of the site through the incorporation of a historic interpretive storyboard on site that will detail the history and significance of the Aizo and Komume Sogo Farm for the benefit of the public and etched glass panels that will be placed on the fencing above the slope on Morena Boulevard that will depict the property's historic use as a farm as it relates to the designation.

The proposed development, the Base Project, would remove the existing stuructures and improvements on the site and construct thirteen (13) new R-3 Class, three-story detached dwelling units in the form of townhomes, one of which will be affordable, and landscape improvements. The project will include a Historical Resources Storyboard at the southeast corner of the building facing east toward the incoming vehicular traffic. The Storyboard will contain a concise but thorough description of the history of the site. In addition, etched glass panels will be placed on the fencing above the slope on Morena Boulevard. The etching will depict the property's historic use as a farm as it relates to the designation. A preliminary design for the etching will be included on the project plans.

An economic feasibility analysis of the proposed Base Project has been prepared by London Moeder Advisors, a local firm with extensive experience in such analyses for the City of San Diego. The London Moeder Advisors analyzed the Base Project as demolishing the existing 962-square-foot home and constructing 13 new R-3 Class, three-story townhomes, one of which will be affordable, with an average net unit size of 1,912 square feet. The London Moeder Advisors analyzed Alternative 1 as rehabilitating the existing 962-square-foot home and returning the remaining land to a farm use.

The London Moeder Advisors analyzed Alternative 2 as demolishing the existing 962-square-foot home and constructing three standard single-family homes on the rest of the property with an average home size of 2,250 square feet. The London Moeder Advisors found that only the Base Project is economically feasible since this project is forecasted to generate a total profit of \$2.54 million. When compared to the total revenue of the project, the margin on revenue achieved is 19.2-percent and when compared to the total development costs of the project, the Margin on Cost achieved is 25.4-percent.

Alternative 1 would rehabilitate the existing non-historic house and garage on the property and return the land to a farming use. As discussed above, a farming use is not now permitted at this location by the zoning regulations of the Municipal Code, but the former farm area would be retained as a dormant area of land. Since the existing house and garage were found by the Historical Resources Staff and Board to not merit local historical designation in 2018, those structures could be rehabilitated as appropriate for a standard residential use resulting in a project site that would be partially developed and partially dormant, with only the dormant part having any historical significance.

An economic feasibility analysis of this Alternative and Alternative 2, as compared with the proposed Base Project, has been prepared by London Moeder Advisors for the purpose of this Site Development Permit. The London Moeder Advisors found that Alternative 1 is not economic feasible due to limited lot usage allowed and no new construction. The sale of one rehabilitated home for \$625,000 would not be sufficient to cover the land costs of \$860,000, let alone the rehabilitation costs. This

results in project costs exceeding revenues and a financial loss of \$716,433. This is a 128-percent reduction in profit when compared with the Base Project.

The London Moeder Advisors found that Alternative 2, which would demolish the existing structure and develop three single-family homes, is also not economic feasible due to the limited scale of development and lot usage allowed. The sale of three single-family homes for a total of \$3,300,000 is not sufficient to cover project costs of \$3,531,288. This would result in a financial loss for the developer of \$396,288 or a 116-percent reduction in profit when compared to the Base Project. There are no feasible measures, including a less environmentally damaging alternative, that can further minimize the potential adverse effects on the designated historical resource, can be made.

b. The deviation is the minimum necessary to afford relief and accommodate the development and all feasible measures to mitigate for the loss of any portion of the historical resource have been provided by the applicant.

As outlined in Site Development Permit Finding B.2.a. listed above, the continued use of this site as a farm is not a feasible alternative as the site is not legally capable of supporting a farm or any other agricultural use. The subject property and its surroundings are now in residential and commercial use consistent with a modern urban environment. While the use of this site for any purpose other than its historic use will result in a loss of historic context, the proposed project will mitigate this impact to the historic setting, feeling and association of the site. Historical Resource mitigation measures have been developed and incorporated within the Project's Final Mitigated Negative Declaration - conditioning issuance of building permits upon prior submittal of a plan showing the design and location of an Aizo and Komume Soga Farm interpretive Story Board to be placed at the location specified in the Final Mitigated Declaration to preserve the history of the site in the public realm along with etched glass panels depicting the property's historic use as a farm. Therefore, this deviation is the minimum necessary to afford relief and accommodate the development and all feasible measures to mitigate for the loss of any portion of the historical resource have been provided by the applicant.

c. The denial of the proposed development would result in economic hardship to the owner. For purposes of this finding, economic hardship means there is no reasonable beneficial use of a property and it is not feasible to derive a reasonable economic return from the property.

Denial of this proposed development would result in economic hardship to the owner. The continued use of this site, even partially as a farm, is not a feasible alternative, and no other passive use would generate an economic return. There is no reasonable beneficial use of this property that does not require its complete redevelopment consistent with the current zoning in order to generate an economic return from the property. The proposed project would remove the existing improvements on the site and construct 13 new R-3 Class, three-story Town Homes, one of which will be affordable. As outlined in Site Development Permit Finding B.2.a.

ATTACHMENT 6

listed above, the denial of the proposed development would result in economic

hardship to the owner can be made.

The above findings are supported by the minutes, maps and exhibits, all of which are

incorporated herein by this reference.

BE IT FURTHER RESOLVED that, based on the findings hereinbefore adopted by the Planning

Commission, Site Development Permit No. 1823446 and Neighborhood Development Permit No.

2011943 is hereby GRANTED by the Planning Commission to the referenced Owner/Permittee, in the

form, exhibits, terms and conditions as set forth in Permit Nos. 1823446 and 2011943, a copy of

which is attached hereto and made a part hereof.

Jeffrey A. Peterson

Development Project Manager

Development Services Department

Adopted On: August 20, 2020

IO#: 24006995

RECORDING REQUESTED BY

CITY OF SAN DIEGO DEVELOPMENT SERVICES PERMIT INTAKE, MAIL STATION 501

WHEN RECORDED MAIL TO PROJECT MANAGEMENT PERMIT CLERK MAIL STATION 501

INTERNAL ORDER NUMBER: 24006995

SPACE ABOVE THIS LINE FOR RECORDER'S USE

SITE DEVELOPMENT PERMIT NO. 1823446
NEIGHBORHOOD DEVELOPMENT PERMIT NO. 2011943
1398 LIETA STREET -PROJECT NO. 512890 [MMRP]
PLANNING COMMISSION

This Site Development Permit No. 1823446 and Neighborhood Development Permit No. 2011943 is granted by the Planning Commission of the City of San Diego to ALMERIA INVESTMENTS, LP, a California Domestic Limited Partnership, Owner and Permittee, pursuant to San Diego Municipal Code [SDMC] Sections 126.0505 and 126.0404. The 0.615-acre site is located at 1398 Lieta Street (new address: 4200 Tonopah Avenue) in the CC-4-5 and RS-1-7 Zones within the Clairemont Mesa Community Plan area. The project site is also located in the Airport Influence Area (AIA) Review Area 2 for San Diego International Airport (SDIA), the Federal Aviation Administration (FAA) Part 77 Notification Area (SDIA - 155-feet MSL), and the Clairemont Mesa Height Limit Overlay Zone. The project site is legally described as: The southwesterly 100 feet of all that portion of Lot 5 of pueblo lot 225 according to referee's partition map files in the action of Morena Company, a corporation, vs. Franklin Steel, Ir., Case No. 3475 filed in the Superior Court of the County of San Diego, lying southwest the centerline of Asher Street, as said street existed on January 21, 1944. Excepting therefrom the following parcels: A. That portion of said lot, if any, lying within the right-of-way of the Atchison, Topeka and Santa Fe railway. B. That portion described in the deed to the City of San Diego recorded March 23, 1956, in book 6029, Page 122 of official records. C. That portion lying southeasterly of a line which is parallel with and distant 101.5 feet northwesterly from the southeasterly line of block 17 of first addition to Asher's cloverleaf terrace, according to Map thereof No. 1666, filed in the Office of the County Recorder of San Diego County, and the northeasterly prolongation of said southeasterly line, and lying northeasterly of the northwesterly prolongation of the southwest line of Lot 17 in Block 17 of said First Addition to Asher's cloverleaf terrace. D. That portion lying within Lahoud Terrace, according to Map thereof No. 3134, filed in the Office of the County Recorder of San Diego County, October 4, 1954.

Subject to the terms and conditions set forth in this Permit, permission is granted to Owner/Permittee for the demolition of an existing single dwelling unit and the construction of 13 townhome-type detached dwelling units; described and identified by size, dimension, quantity, type, and location on the approved exhibits [Exhibit "A"] dated August 20, 2020, on file in the Development Services Department.

The project shall include:

a. The demolition of an existing single dwelling unit, and the construction of 13 townhome-type detached dwelling units, totaling 34,265 square-feet, which contains a 38.75-percent density bonus (four units in addition to what is permitted by the underlying zoning regulations). The units would range from 1,678 to 2,679 square feet, and the development includes one affordable unit on-site;

b. Incentives to the SDMC:

- 1. A development incentive to SDMC Table 131-04D_to reduce the side setback requirements of the RS-1-7 zone from eight feet to five feet;
- 2. A development incentive to SDMC Section 131.0446(a) and Table 131-04J and to SDMC Table 131-05E to increase the allowed floor area ratio (FAR) of the combined zones of the property from 31,400 square feet to 34,265 square feet, an increase of approximately nine percent;

c. Deviations to the SDMC:

- 1. A deviation request to SDMC Section 131.0543(b) to allow for a five-foot side setback along the northern property line in the CC-4-5 portion of the property, where a minimum 10-foot side setback or the option for no side setbacks would be required;
- 2. A deviation request to SDMC Section 131.0444(c) to remove the angled building envelope plane requirement along the reduced side setback line in the RS-1-7 zone as outlined in Incentive No. 1 above;
- 3. A deviation request to SDMC Section 131.0540(b) to remove the commercial component requirement in the CC-4-5 zone;
- d. Landscaping (planting, irrigation and landscape related improvements);
- e. Off-street parking;
- f. A roof-mounted photovoltaic system consisting of solar panels sufficient to generate at least 50 percent of the proposed project's projected energy consumption, in conformance with the criteria of the Affordable/In-Fill Housing and Sustainable Buildings Expedite Program; and
- g. Public and private accessory improvements determined by the Development Services Department to be consistent with the land use and development standards for this site in accordance with the adopted community plan, the California Environmental Quality Act [CEQA] and the CEQA Guidelines, the City Engineer's requirements, zoning regulations, conditions of this Permit, and any other applicable regulations of the SDMC.

STANDARD REQUIREMENTS:

- 1. This permit must be utilized within thirty-six (36) months after the date on which all rights of appeal have expired. If this permit is not utilized in accordance with Chapter 12, Article 6, Division 1 of the SDMC within the 36-month period, this permit shall be void unless an Extension of Time has been granted. Any such Extension of Time must meet all SDMC requirements and applicable guidelines in effect at the time the extension is considered by the appropriate decision maker. This permit must be utilized by September 3, 2023.
- 2. No permit for the construction, occupancy, or operation of any facility or improvement described herein shall be granted, nor shall any activity authorized by this Permit be conducted on the premises until:
 - a. The Owner/Permittee signs and returns the Permit to the Development Services Department; and
 - b. The Permit is recorded in the Office of the San Diego County Recorder.
- 3. While this Permit is in effect, the subject property shall be used only for the purposes and under the terms and conditions set forth in this Permit unless otherwise authorized by the appropriate City decision maker.
- 4. This Permit is a covenant running with the subject property and all of the requirements and conditions of this Permit and related documents shall be binding upon the Owner/Permittee and any successor(s) in interest.
- 5. The continued use of this Permit shall be subject to the regulations of this and any other applicable governmental agency.
- 6. Issuance of this Permit by the City of San Diego does not authorize the Owner/Permittee for this Permit to violate any Federal, State or City laws, ordinances, regulations or policies including, but not limited to, the Endangered Species Act of 1973 [ESA] and any amendments thereto (16 U.S.C. § 1531 et seq.).
- 7. The Owner/Permittee shall secure all necessary building permits. The Owner/Permittee is informed that to secure these permits, substantial building modifications and site improvements may be required to comply with applicable building, fire, mechanical, and plumbing codes, and State and Federal disability access laws.
- 8. Construction plans shall be in substantial conformity to Exhibit "A." Changes, modifications, or alterations to the construction plans are prohibited unless appropriate application(s) or amendment(s) to this Permit have been granted.
- 9. All of the conditions contained in this Permit have been considered and were determined necessary to make the findings required for approval of this Permit. The Permit holder is required to comply with each and every condition in order to maintain the entitlements that are granted by this Permit.

If any condition of this Permit, on a legal challenge by the Owner/Permittee of this Permit, is found or held by a court of competent jurisdiction to be invalid, unenforceable, or unreasonable, this Permit shall be void. However, in such an event, the Owner/Permittee shall have the right, by paying applicable processing fees, to bring a request for a new permit without the "invalid" conditions(s) back to the discretionary body which approved the Permit for a determination by that body as to whether all of the findings necessary for the issuance of the proposed permit can still be made in the absence of the "invalid" condition(s). Such hearing shall be a hearing de novo, and the discretionary body shall have the absolute right to approve, disapprove, or modify the proposed permit and the condition(s) contained therein.

The Owner/Permittee shall defend, indemnify, and hold harmless the City, its agents, officers, and employees from any and all claims, actions, proceedings, damages, judgments, or costs, including attorney's fees, against the City or its agents, officers, or employees, relating to the issuance of this permit including, but not limited to, any action to attack, set aside, void, challenge, or annul this development approval and any environmental document or decision. The City will promptly notify Owner/Permittee of any claim, action, or proceeding and, if the City should fail to cooperate fully in the defense, the Owner/Permittee shall not thereafter be responsible to defend, indemnify, and hold harmless the City or its agents, officers, and employees. The City may elect to conduct its own defense, participate in its own defense, or obtain independent legal counsel in defense of any claim related to this indemnification. In the event of such election, Owner/Permittee shall pay all of the costs related thereto, including without limitation reasonable attorney's fees and costs. In the event of a disagreement between the City and Owner/Permittee regarding litigation issues, the City shall have the authority to control the litigation and make litigation related decisions, including, but not limited to, settlement or other disposition of the matter. However, the Owner/Permittee shall not be required to pay or perform any settlement unless such settlement is approved by Owner/Permittee.

ENVIRONMENTAL/MITIGATION REQUIREMENTS:

- 11. Mitigation requirements in the Mitigation, Monitoring, and Reporting Program [MMRP] shall apply to this Permit. These MMRP conditions are hereby incorporated into this Permit by reference.
- 12. The mitigation measures specified in the MMRP and outlined in MITIGATED NEGATIVE DECLARATION NO. 512890 shall be noted on the construction plans and specifications under the heading ENVIRONMENTAL MITIGATION REQUIREMENTS.
- 13. The Owner/Permittee shall comply with the MMRP as specified in [Choose one:] MITIGATED NEGATIVE DECLARATION NO. 512890, to the satisfaction of the Development Services Department and the City Engineer. Prior to issuance of any construction permit, all conditions of the MMRP shall be adhered to, to the satisfaction of the City Engineer. All mitigation measures described in the MMRP shall be implemented for the following issue areas:

Cultural Resources-Designated Site

CLIMATE ACTION PLAN REQUIREMENTS:

14. The Owner/Permittee shall comply with the Climate Action Plan (CAP) Consistency Checklist stamped as Exhibit "A." Prior to issuance of any construction permit, all CAP strategies shall be noted within the first three (3) sheets of the construction plans under the heading "Climate Action Plan Requirements" and shall be enforced and implemented to the satisfaction of the Development Services Department.

AFFORDABLE HOUSING REQUIREMENTS:

- 15. Prior to issuance of any building permit, the Owner/Permittee shall demonstrate compliance with the provisions of Chapter 14, Article 3, Division 7 of the San Diego Municipal Code [SDMC] Affordable Housing Density Bonus Regulations.
- 16. The Owner/Permittee shall enter into a written agreement with the San Diego Housing Commission [Agreement], drafted and approved by the San Diego Housing Commission, executed by the Owner/Permittee, and secured by a deed of trust, that incorporates applicable affordability conditions consistent with the SDMC. Specifically including that, in exchange for the City's approval of the Project, which contains a 38.75-percent density bonus (four units in addition to what is permitted by the underlying zoning regulations), alone or in conjunction with any incentives or concessions granted as part of Project approval. The Owner/Permittee shall provide one (1) unit with a rent of no more than 30-percent of 50-percent of AMI, so as to be considered affordable to very-low income households, for no fewer than 55 years.
- 17. The Agreement referenced in the preceding paragraph will satisfy the requirements of SDMC Section 143.1303(g) and therefore, exempt the Project from Chapter 14, Article 2, Division 13 of the SDMC Inclusionary Affordable Housing Regulations.

AIRPORT REQUIREMENTS:

18. Prior to issuance of any building permits, the Owner/Permittee shall provide a copy of the signed agreement [DS-503] and show certification on the building plans verifying that the structures do not require Federal Aviation Administration [FAA] notice for Determination of No Hazard to Air Navigation, or provide an FAA Determination of No Hazard to Air Navigation as specified in Information Bulletin 520.

GEOLOGY REQUIREMENTS:

- 19. The Owner/Permittee shall submit a geotechnical investigation report or update letter that specifically addresses the proposed construction plans. The geotechnical investigation report or update letter shall be reviewed for adequacy by the Geology Section of the Development Services Department prior to issuance of any construction permits.
- 20. The Owner/Permittee shall submit an as-graded geotechnical report prepared in accordance with the City's "Guidelines for Geotechnical Reports" following completion of the grading. The asgraded geotechnical report shall be reviewed for adequacy by the Geology Section of the Development Services Department prior to exoneration of the bond and grading permit close-out.

ENGINEERING REQUIREMENTS:

- 21. This Site Development Permit No. 1823446 and Neighborhood Development Permit No. 2011943 shall comply with all Conditions of the Final Map for Tentative Map No. 2011944.
- 22. The project proposes to import material to the project site. All excavated material listed to be exported, shall be exported to a legal disposal site in accordance with the Standard Specifications for Public Works Construction (the "Green Book"), 2015 edition and Regional Supplement Amendments adopted by Regional Standards Committee.
- 23. The drainage system proposed for this development, as shown on the site plan, is private and subject to approval by the City Engineer.
- 24. Prior to the issuance of any building permits, the Owner/Permittee shall obtain an Encroachment Maintenance Removal Agreement, from the City Engineer, for the curb outlet systems in the Morena Boulevard Right-of-Way.
- 25. Prior to the issuance of any building permits, the Owner/Permittee shall assure, by permit and bond, the construction of a construct a current City Standard curb and gutter from the project site to the existing curb and gutter on Lieta Street, satisfactory to the City Engineer.
- 26. Prior to the issuance of any building permits, the Owner/Permittee shall assure, by permit and bond, to remove the existing streetlight and install a current City Standard Street Light at the northwest corner of Tonopah Avenue and Lieta Street, satisfactory to the City Engineer.
- 27. Prior to the issuance of any building permits, the Owner/Permittee shall assure, by permit and bond, to construct at the northwest corner of Tonopah Avenue and Lieta Street, a current City Standard curb ramp Standard Drawing SDG-130 and SDG-132 with Detectable/Tactile Warning Tile, satisfactory to the City Engineer.
- 28. Prior to the issuance of any construction permit, the Owner/Permittee shall enter into a Maintenance Agreement for the ongoing permanent Best Management Practices [BMPs] maintenance, satisfactory to the City Engineer.
- 29. Prior to the issuance of any construction permit, the Owner/Permittee shall incorporate any construction BMPs necessary to comply with Chapter 14, Article 2, Division 1 (Grading Regulations) of the SDMC, into the construction plans or specifications.
- 30. Prior to the issuance of any construction permit, the Owner/Permittee shall submit a Technical Report that will be subject to final review and approval by the City Engineer, based on the Storm Water Standards in effect at the time of the construction permit issuance.
- 31. Prior to the issuance of any construction permit the Owner/Permittee shall submit a Water Pollution Control Plan (WPCP). The WPCP shall be prepared in accordance with the guidelines in Part 2 Construction BMP Standards Chapter 4 of the City's Storm Water Standards.

LANDSCAPE REQUIREMENTS:

- 32. Prior to issuance of any grading permit, the Owner/Permittee shall submit complete construction documents for the revegetation and hydro-seeding of all disturbed land in accordance with the City of San Diego Landscape Standards, Storm Water Design Manual, and to the satisfaction of the Development Services Department. All plans shall be in substantial conformance to this permit (including Environmental conditions) and Exhibit "A," on file in the Development Services Department.
- 33. Prior to issuance of any public improvement permit, the Owner/Permittee shall submit complete landscape construction documents for right-of-way improvements to the Development Services Department for approval. Improvement plans shall show, label, and dimension a 40-square-foot area around each tree which is unencumbered by utilities. Driveways, utilities, drains, water and sewer laterals shall be designed so as not to prohibit the placement of street trees.
- 34. Prior to issuance of any building permit (including shell), the Owner/Permittee shall submit complete landscape and irrigation construction documents, which are consistent with the Landscape Standards, to the Development Services Department for approval. The construction documents shall be in substantial conformance with Exhibit "A," Landscape Development Plan, on file in the Development Services Department. Construction plans shall provide a 40-square-foot area around each tree that is unencumbered by hardscape and utilities unless otherwise approved per §142.0403(b)(5).
- 35. In the event that a foundation only permit is requested by the Owner/Permittee, a site plan or staking layout plan, shall be submitted to the Development Services Department identifying all landscape areas consistent with Exhibit "A," Landscape Development Plan, on file in the Development Services Department. These landscape areas shall be clearly identified with a distinct symbol, noted with dimensions, and labeled as 'landscaping area.'
- 36. The Owner/Permittee shall be responsible for the maintenance of all landscape improvements shown on the approved plans, including in the public right-of-way, unless long-term maintenance of said landscaping will be the responsibility of another entity approved by the Development Services Department. All required landscape shall be maintained consistent with the Landscape Standards in a disease, weed, and litter free condition at all times. Severe pruning or "topping" of trees is not permitted.
- 37. If any required landscape (including palms/trees on private property serving as street trees along Morena Boulevard, existing or new plantings, hardscape, landscape features, etc.) indicated on the approved construction documents is damaged or removed, the Owner/Permittee shall repair and/or replace in kind and equivalent size per the approved documents to the satisfaction of the Development Services Department within 30 days of damage or Certificate of Occupancy.

HISTORICAL REQUIREMENTS:

38. Prior to the issuance of the first building permit, the Owner/Permittee shall submit a plan showing the design and location of the interpretive story board to be placed proximate to the

terminus of Tonopah Avenue at the project's driveway to the satisfaction of the Design Assistance Subcommittee of the Historical Resources Board with subsequent Historical Resource staff approval.

- 39. Prior to the issuance of the first building permit, the Owner/Permittee shall submit a plan showing the design and location of the decorative fence element with etched pattern to mimic row planting to the satisfaction of the Design Assistance Subcommittee of the Historical Resources Board with subsequent Historical Resource staff approval.
- 40. Prior to submitting plans to the Design Assistance Subcommittee of the Historical Resources Board showing the design of the interpretive story board and fences, the Owner/Permittee shall work with a Historian that is versed in the Japanese American History for the design of the historical elements for the interpretive story board and fences.
- 41. Prior to the issuance of any construction permits, the Owner/Permittee shall execute and record a Public Access Easement which ensures public access to the interpretive story board to be placed proximate to the terminus of Tonopah Avenue at the project's driveway as shown on Exhibit "A."
- 42. Prior to the issuance of a Certificate of Occupancy, the Owner/Permittee shall install the interpretive story board and decorative fencing element in the locations identified on the previously approved plans for the Designated Historic Site. The Owner/Permittee shall be responsible for funding and implementing the long-term management of the story board and decorative fencing in perpetuity.

PLANNING/DESIGN REQUIREMENTS:

- 43. The automobile, motorcycle and bicycle parking spaces must be constructed in accordance with the requirements of the SDMC. All on-site parking stalls and aisle widths shall be in compliance with requirements of the City's Land Development Code and shall not be converted and/or utilized for any other purpose, unless otherwise authorized in writing authorized by the appropriate City decision maker in accordance with the SDMC.
- 44. A topographical survey conforming to the provisions of the SDMC may be required if it is determined, during construction, that there may be a conflict between the building(s) under construction and a condition of this Permit or a regulation of the underlying zone. The cost of any such survey shall be borne by the Owner/Permittee.
- 45. Prior to the issuance of building permits, construction documents shall fully illustrate the incorporation of a roof-mounted photovoltaic system consisting of solar panels sufficient to generate at least 50 percent of the proposed project's projected energy consumption, in conformance with the criteria of the Affordable/In-Fill Housing and Sustainable Buildings Expedite Program.
- 46. All signs associated with this development shall be consistent with sign criteria established by either the approved Exhibit "A" or City-wide sign regulations.

47. All private outdoor lighting shall be shaded and adjusted to fall on the same premises where such lights are located and in accordance with the applicable regulations in the SDMC.

TRANSPORTATION REQUIREMENTS

- 48. All automobile, motorcycle and bicycle parking spaces must be constructed in accordance with the requirements of the SDMC. All on-site parking stalls and aisle widths shall be in compliance with requirements of the City's Land Development Code and shall not be converted and/or utilized for any other purpose, unless otherwise authorized in writing by the appropriate City decision maker in accordance with the SDMC.
- 49. Prior to issuance of the first building permit, the Owner/Permittee shall assure by permit and bond the improvement of the project frontage along Tonopah Avenue/Lieta Street, with curb, gutter, sidewalk, and curb ramp consistent with City Standards, satisfactory to the City Engineer. All improvements shall be completed and accepted by the City Engineer prior to first occupancy.
- 50. Permittee must construct and maintain an accessible path from the building entrances to the public street.

PUBLIC UTILITIES DEPARTMENT REQUIREMENTS:

- 51. Prior to the issuance of any construction permit, the Owner/Permittee shall assure, by permit and bond the design and construction of an 8-inch public sewer mains within Lieta Street and portion of Tonopah Avenue as shown on the approved Exhibit "A," in a manner satisfactory to the Public Utilities Director and the City Engineer.
- 52. Prior to the issuance of any building permits, the Owner/Permittee shall assure, by permit and bond, the design and construction of new water and sewer service(s) outside of any driveway or drive aisle and the abandonment of any existing unused water and sewer services within the right-of-way adjacent to the project site, in a manner satisfactory to the Public Utilities Director and the City Engineer.
- 53. The Owner/Permittee shall apply for a plumbing permit for the installation of appropriate private back flow prevention device(s) [BFPDs], on each water service (domestic, fire and irrigation), in a manner satisfactory to the Public Utilities Director and the City Engineer. BFPDs shall be located above ground on private property, in line with the service and immediately adjacent to the right-ofway.
- 54. The Owner/Permittee shall design and construct all proposed public water and sewer facilities, in accordance with established criteria in the current edition of the City of San Diego Water and Sewer Facility Design Guidelines and City regulations, standards and practices.
- 55. No trees or shrubs exceeding three feet in height at maturity shall be installed within ten feet of any sewer facilities and five feet of any water facilities.

INFORMATION ONLY:

- The issuance of this discretionary permit alone does not allow the immediate commencement or continued operation of the proposed use on site. Any operation allowed by this discretionary permit may only begin or recommence after all conditions listed on this permit are fully completed and all required ministerial permits have been issued and received final inspection.
- Any party on whom fees, dedications, reservations, or other exactions have been imposed as conditions of approval of this Permit, may protest the imposition within ninety days of the approval of this development permit by filing a written protest with the City Clerk pursuant to California Government Code-section 66020.
- This development may be subject to impact fees at the time of construction permit issuance.

| APPROVED by the Planning | Commission of the Cit | ty of San Diego on | August 20, 2020, | and pursuant |
|--------------------------|-----------------------|--------------------|------------------|--------------|
| to Resolution No. | | | | |

ATTACHMENT 7

Permit Type/PTS Approval No.: Site Development Permit No. 1823446 and Neighborhood Development Permit No. 2011943 Date of Approval: August 20, 2020

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Jeffrey A. Peterson Development Project Manager Development Services Department

NOTE: Notary acknowledgment must be attached per Civil Code section 1189 et seq.

The undersigned Owner/Permittee, by execution hereof, agrees to each and every condition of this Permit and promises to perform each and every obligation of Owner/Permittee hereunder.

ALMERIA INVESTMENTS, LP

a California Domestic Limited Partnership Owner/Permittee

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Name: Title:

NOTE: Notary acknowledgments must be attached per Civil Code section 1189 et seq.

PLANNING COMMISSION RESOLUTION NUMBER R-

TENTATIVE MAP NO. 2011944, 1398 LIETA STREET -PROJECT NO. 512890 [MMRP]

WHEREAS, ALMERIA INVESTMENTS, LP, a California Domestic Limited Partnership, Subdivider, and CIVIL LANDWORKS, Engineer, submitted an application to the City of San Diego for a tentative map (Tentative Map No. 2011944). The project site is located at 1398 Lieta Street (new address: 4200 Tonopah Avenue) in the CC-4-5 and RS-1-7 Zones within the Clairemont Mesa Community Plan area. The project site is also located in the Airport Influence Area (AIA) Review Area 2 for San Diego International Airport (SDIA), the Federal Aviation Administration (FAA) Part 77 Notification Area (SDIA - 155-feet MSL), and the Clairemont Mesa Height Limit Overlay Zone. The property is legally described as; the southwesterly 100 feet of all that portion of Lot 5 of pueblo lot 225 according to referee's partition map files in the action of Morena Company, a corporation, vs. Franklin Steel, Jr., Case No. 3475 filed in the Superior Court of the County of San Diego, lying southwest the centerline of Asher Street, as said street existed on January 21, 1944. Excepting therefrom the following parcels: A. That portion of said lot, if any, lying within the right-of-way of the Atchison, Topeka and Santa Fe railway. B. That portion described in the deed to the City of San Diego recorded March 23, 1956, in book 6029, Page 122 of official records. C. That portion lying southeasterly of a line which is parallel with and distant 101.5 feet northwesterly from the southeasterly line of block 17 of first addition to Asher's cloverleaf terrace, according to Map thereof No. 1666, filed in the Office of the County Recorder of San Diego County, and the northeasterly prolongation of said southeasterly line, and lying northeasterly of the northwesterly prolongation of the southwest line of Lot 17 in Block 17 of said First Addition to Asher's cloverleaf terrace. D. That

portion lying within Lahoud Terrace, according to Map thereof No. 3134, filed in the Office of the County Recorder of San Diego County, October 4, 1954; and

WHEREAS, the Map proposes the Subdivision of a 0.615-acre site into one (1) lot for 13 residential condominium dwelling units; and

WHEREAS, the project complies with the requirements of a preliminary soils and/or geological reconnaissance report pursuant to Subdivision Map Act, California Government Code Sections 66490 and 66491(b)-(f) and San Diego Municipal Code Section 144.0220; and

WHEREAS, the subdivision is a condominium project as defined in California Civil Code
Section 4125 and filed pursuant to the Subdivision Map Act. The total number of condominium
dwelling units is 13; and

WHEREAS, on August 20, 2020, the Planning Commission of the City of San Diego considered Tentative Map No. 2011944, pursuant to San Diego Municipal Code Section 125.0440, and Subdivision Map Act, California Government Code Section 66428, received for its consideration written and oral presentations, evidence having been submitted, and testimony having been heard from all interested parties at the public hearing, and the Planning Commission having fully considered the matter and being fully advised concerning the same; NOW THEREFORE,

BE IT RESOLVED by the Planning Commission of the City of San Diego, that it adopts the following findings with respect to Tentative Map No. 2011944:

1. The proposed subdivision and its design or improvement are consistent with the policies, goals, and objectives of the applicable land use plan.

The subject property is a 0.615-acre parcel located at 1398 Lieta Street (to be re-addressed to 4200 Tonopah Avenue), adjacent to the intersection of Lieta Street and Tonopah Avenue to the East and Morena Boulevard to the West. The site is located in the CC-4-5 and RS-1-7 zones within the Clairemont Mesa Community Plan area. The lot area zoned RS-1-7 is approximately 14,800

square feet and allows for one (1) dwelling unit. The lot area zoned CC-4-5 is approximately 12,000 square feet and allows for eight (8) dwelling units.

The subject property contains a single-family residence constructed in 1937 and garage constructed in 1956. The Minimal Traditional style house was originally located at the northwestern property boundary but was relocated in 1956 to the southwestern portion of the property. By 1938 the subject property was owned and occupied by the family of Aizo and Komume Sogo who farmed the land and sold their crops at the hakujin market. In 1942, at the beginning World War II, the family was sent to the Colorado River Relocation Center (Poston War Relocation Center). They remained at this internment camp until 1945, after which time, they returned to the Lieta Street property.

In July 1953, Aizo and Komume Sogo were among the first of five Japanese-born individuals to become naturalized citizens of the United States in San Diego. Previously, natives of Japan, except for World War II veterans, were one of the nationalities barred from citizenship until the passage of the Immigration and Nationality Act of 1952 (aka the McCarran Walter Act). In February 1954, as citizens, the Sogos obtained ownership of the Lieta Street property. In 1962, the Sogos sold three acres of the land which had been zoned residential and commercial. Aizo died in 1974 and Komume, who remained at the property after his death, died in 1983.

The site was reviewed by the Historical Resources Board (HRB) and the site was designated as HRB Site #1305 on July 26, 2018 under HRB Criterion A as a special element of the Issei/Japanese-American agricultural practices within the Mission Bay area during the 1930s through the 1950s and the restrictive property rights/ ownership measures taken against minorities, specifically Japanese nationals, during the 1930s through the 1950s. This designation did not include the structures located on the parcel.

The project proposes the demolition of the existing structures and development of 13 townhome-type detached dwelling units on the parcel. The project includes one very low-income unit which allows for a 38.75-percent density bonus of four additional units for a total of 13 dwelling units to be constructed and allows for two development incentives. Of the 13 detached dwelling units, 12 units will be market-rate for-sale town homes, and one will be retained for a very low-income affordable housing unit.

The Clairemont Mesa Community Plan designates the project site Medium Density Residential, 15-30 dwelling units per acre (du/ac). The total site acreage is 0.615-acres and would allow between 9 and 19 dwelling units. The project proposes 13 detached dwelling units consistent with the density range of the land use designation. The General Plan Urban Design Element states that building design should contribute to a positive neighborhood character and relate to neighborhood and community context. Building design is encouraged to be sensitive to the scale, form, rhythm, proportions, and materials in proximity to commercial areas and residential neighborhoods. The proposed project's three-story townhome-type design is consistent in scale with the adjacent three- and four-story multifamily apartment complex to the north and the recently approved three-story Morena Apartment Homes project to the southwest of the project site, which is currently under construction. The proposed project incorporates variation in material and color to articulate the buildings and add visual interest along the project frontage.

The proposed project site is adjacent to Morena Boulevard and is located just east of I-5. The proposed project would incorporate noise attenuation measures including dense materials for walls and doors, and insulation of windows to ensure interior noise levels in residences do not exceed General Plan standards.

While the use of this site for purposes other than its historic farm use will result in a loss of historic context, the proposed project will mitigate this impact to the historic setting, feeling and association of the site through the incorporation of a historic interpretive storyboard on site that will detail the history and significance of the Aizo and Komume Sogo Farm for the benefit of the public and decorative fencing that will be placed above the slope on Morena Boulevard that will depict the property's historic use as a farm as it relates to the designation. Therefore, for these reasons, the proposed subdivision and its design or improvement would be consistent with the policies, goals, and objectives of the applicable land use plan.

2. The proposed subdivision complies with the applicable zoning and development regulations of the Land Development Code, including any allowable deviations pursuant to the land development code.

The project proposes the demolition of the existing structures and development of 13 townhome-type detached dwelling units on the parcel. The project includes one very low-income unit which allows for a 38.75-percent density bonus of four additional units for a total of 13 dwelling units to be constructed and allows for two development incentives. Of the 13 detached dwelling units, 12 units will be market-rate for-sale town homes, and one will be retained for a very low-income affordable housing unit. Eleven dwelling units shall have an attached two car garage, and Units No. 2 and 3 would include mechanical car lifts to allow for two parking spaces stacked vertically for a total of three spaces. The parking regulations require 28 total parking spaces, and the proposed development provides 28 total parking spaces.

The proposed development will extend Tonopah Avenue from its existing dead end at the intersection of Lieta Street and Tonopah Avenue into the subject property. Each dwelling unit contains an enclosed parking of two parking spaces per unit. The construction of a "T-Intersection" at the center of the subject property along with the installation of a new fire hydrant will allow for both pedestrian vehicles and emergency vehicles to safely access each unit from within the subject property. This center intersection would allow for access for emergency vehicles and trash/utility services as well as to allow for pedestrian vehicles to safely turnaround and exit the property.

The organization of separated, low-lying buildings as opposed to a single multi-family structure keeps the project consistent with the surrounding low-lying single-family nature of the adjacent neighborhood to the east. The structures would be under the 30-foot height restriction of the Clairemont Mesa Height Limit requirement, and sited on the northern portion of the parcel to ensuring that neighbors will have view access from and along Tonopah Avenue to the San Diego Bay to the west and downtown San Diego to the south.

The project is requesting two incentives for side setback in the RS-1-7 zone and floor area ratio (FAR), and three deviations for side setback in the CC-4-5 zone, angled building envelope plane requirements, and to remove the commercial component required for the CC-4-5 zone. The details of the incentives and deviations are as follows:

Incentive No. 1- A development incentive to SDMC Table 131-04D to reduce the side setback requirements of the RS-1-7 zone from eight feet to five feet. This ensures that each unit is provided with a minimum of two parking spaces within individual garages (two will have car lifts that will have three parking spaces).

Incentive No. 2- A development incentive to SDMC Section 131.0446(a) and Table 131-04J and to SDMC Table 131-05E to increase the allowed FAR of the combined zones of the property from 31,400 square feet to 34,265 square feet, an increase of approximately nine percent.

Deviation No. 1- A deviation request to SDMC Section 131.0543(b) to allow for a five-foot side setback along the northern property line in the CC-4-5 portion of the property, where a minimum 10-foot side setback or the option for no side setbacks would be required. This deviation provides relief for adjacent residential units along the property line as well as keeps the proposed dwelling units in the CC-4-5 portion of the property consistent with the location of the dwelling units in the RS-1-7 portion of the zone with the requested reduced side setback development incentive being requested (see Incentive No. 1 above).

Deviation No. 2- A deviation request to SDMC Section 131.0444(c) to remove the angled building envelope plane requirement along the reduced side setback line in the RS-1-7 zone as outlined in Incentive No. 1 above. This deviation is necessary to incorporate an Affordable Housing Density Bonus of four dwelling units which is consistent with the land use designation and density with additional density allowed under the Affordable Housing Density Bonus provision in SDMC Chapter 14, Article 3, Division 7.

Deviation No. 3- A deviation request to SDMC Section 131.0540(b) to remove the commercial component requirement in the CC-4-5 zone. A commercial component doesn't fit with the residential nature of the surrounding neighborhood and would require consumers of the commercial component to enter via a residential neighborhood to the east or navigate up a 20-foot steep slope from Morena Boulevard. The subject property sits approximately 20 feet above Morena Boulevard, separated by a steep hillside in the public right of way.

Each of the requested incentives and deviations has been reviewed as they relate to the proposed design and use of the proposed project, the site layout, and the impact on the surrounding neighborhood. The requested incentives and deviations are appropriate at this location and will result in a better project that efficiently utilizes the subject property while meeting the purpose and intent of the LDC and the Clairemont Mesa Community Plan and would respect the surrounding single-family and multi-family neighborhood. Therefore, the proposed development would comply with the applicable regulations, including any allowable deviations

3. The site is physically suitable for the type and density of development.

The subject property contains a single-family residence constructed in 1937 and garage constructed in 1956. The Minimal Traditional style house was originally located at the northwestern property boundary but was relocated in 1956 to the southwestern portion of the property. By 1938 the subject property was owned and occupied by the family of Aizo and Komume Sogo who farmed the land and sold their crops at the hakujin market. This site as a farm is not a feasible alternative as

the site is not legally capable of supporting a farm or any other agricultural use. The subject property and its surroundings are now in residential and commercial use consistent with a modern urban environment. The site is a large, mostly vacant, and mostly flat site except for along the western and southern property lines where it slopes down to either an adjacent property or towards the right-of-way of Morena Boulevard. The subject property and drainage does not provide suitable habitat to support special-status plant or wildlife species and has minimal function or value as a sensitive habitat.

The project proposes the demolition of the existing structures and development of 13 townhome-type detached dwelling units on the parcel. The project includes one very low-income unit which allows for a 38.75-percent density bonus of four additional units for a total of 13 dwelling units to be constructed and allows for two development incentives. Of the 13 detached dwelling units, 12 units will be market-rate for-sale town homes, and one will be retained for a very low-income affordable housing unit.

The Clairemont Mesa Community Plan designates the project site Medium Density Residential, 15-30 du/ac. The total site acreage is 0.615-acres and would allow between 9 and 19 dwelling units. The project proposes 13 detached dwelling units consistent with the density range of the land use designation. The proposed detached dwelling units would be constructed on mostly flat land away from any natural drainage features. Therefore, the subject site is physically suitable for the type and density of the proposed development.

4. The design of the subdivision or the proposed improvements are not likely to cause substantial environmental damage or substantially and avoidably injure fish or wildlife or their habitat.

The site is a large, mostly vacant, and mostly flat site except for along the western and southern property lines where it slopes down to either an adjacent property or towards the right-of-way of Morena Boulevard. The subject property and drainage does not provide suitable habitat to support special-status plant or wildlife species and has minimal function or value as a sensitive habitat. The project site does not contain sensitive biological resources on site or adjacent to the site. Onsite landscaping is non-native, and the project site does not contain any sensitive biological resources on-site nor does it contain any candidate, sensitive or special status species.

The project proposes the demolition of the existing structures and development of 13 townhome-type detached dwelling units on the parcel. The project includes one very low-income unit which allows for a 38.75-percent density bonus of four additional units for a total of 13 dwelling units to be constructed and allows for two development incentives. Of the 13 detached dwelling units, 12 units will be market-rate for-sale town homes, and one will be retained for a very low-income affordable housing unit.

The proposed development will extend Tonopah Avenue from its existing dead end at the intersection of Lieta Street and Tonopah Avenue into the subject property. Each dwelling unit contains an enclosed parking of two parking spaces per unit. The construction of a "T-Intersection" at the center of the subject property along with the installation of a new fire hydrant will allow for both pedestrian vehicles and emergency vehicles to safely access each unit from within the subject

property. This center intersection would allow for access for emergency vehicles and trash/utility services as well as to allow for pedestrian vehicles to safely turnaround and exit the property.

A Mitigated Negative Declaration, Project No. 512890, has been prepared for the project in accordance with State of California Environmental Quality Act (CEQA) guidelines. A Mitigation, Monitoring and Reporting Program has been prepared and will be implemented which will reduce impacts to below a level of significance for Historical Resources.

Therefore, for the reasons above, the design of the proposed subdivision and the proposed improvements would not cause substantial environmental damage or substantially and avoidably injure fish or wildlife or their habitat

5. The design of the subdivision or the type of improvement will not be detrimental to the public health, safety, and welfare.

The project proposes the demolition of the existing structures and development of 13 townhome-type detached dwelling units on the parcel. The project includes one very low-income unit which allows for a 38.75-percent density bonus of four additional units for a total of 13 dwelling units to be constructed and allows for two development incentives. Of the 13 detached dwelling units, 12 units will be market-rate for-sale town homes, and one will be retained for a very low-income affordable housing unit. Eleven dwelling units shall have an attached two car garage, and Units No. 2 and 3 would include mechanical car lifts to allow for two parking spaces stacked vertically for a total of three spaces. The parking regulations require 28 total parking spaces, and the proposed development provides 28 total parking spaces.

The proposed development will extend Tonopah Avenue from its existing dead end at the intersection of Lieta Street and Tonopah Avenue into the subject property. Each dwelling unit contains an enclosed parking of two parking spaces per unit. The construction of a "T-Intersection" at the center of the subject property along with the installation of a new fire hydrant will allow for both pedestrian vehicles and emergency vehicles to safely access each unit from within the subject property. This center intersection would allow for access for emergency vehicles and trash/utility services as well as to allow for pedestrian vehicles to safely turnaround and exit the property.

A Mitigated Negative Declaration, Project No. 512890, has been prepared for the project in accordance with State of California Environmental Quality Act (CEQA) guidelines. A Mitigation, Monitoring and Reporting Program has been prepared and will be implemented which will reduce impacts to below a level of significance for Historical Resources.

The permit for the Project includes various conditions and referenced exhibits of approval relevant to achieving project compliance with the applicable regulations of the SDMC in effect for this Project. Such conditions within the permit have been determined as necessary to avoid adverse impacts upon the health, safety and general welfare of persons residing or working in the surrounding area. The Project will comply with the development conditions in effect for the subject property as described in Tentative Map (TM) No. 2011944, and other regulations and guidelines pertaining to the subject property per the SDMC for the Project site. Prior to issuance of any building permits for the proposed development, the plans will be reviewed for compliance with all Building, Electrical, Mechanical, Plumbing and Fire Code requirements, and the owner/ permittee will be

required to obtain a grading and public improvement permit. Therefore, the design of the subdivision and the type of improvement would not be detrimental to the public health, safety and welfare.

6. The design of the subdivision or the type of improvements will not conflict with easements acquired by the public at large for access through or use of property within the proposed subdivision.

The project proposes the demolition of the existing structures and development of 13 townhome-type detached dwelling units on the parcel. The property does not contain any existing easements acquired by the public at large for access through or use of property within the proposed subdivision.

7. The design of the proposed subdivision provides, to the extent feasible, for future passive or natural heating and cooling opportunities.

The proposed subdivision of a 0.615-acre parcel for residential development will not impede or inhibit any future passive or natural heating and cooling opportunities. The design of the subdivision has taken into account the best use of the land to minimize grading and preserving environmentally sensitive lands. The project proposes the demolition of the existing structures and development of 13 townhome-type detached dwelling units on the parcel; however, they do not impede or inhibit any future passive or natural heating and cooling opportunities. Each of the 13 units would include roof-mounted photovoltaic system consisting of solar panels sufficient to generate at least 50 percent of the proposed project's projected energy consumption. With the independent design of the proposed subdivision each structure will have the opportunity through building materials, site orientation, architectural treatments, placement and selection of plant materials to provide to the extent feasible, for future passive or natural heating and cooling opportunities.

8. The decision maker has considered the effects of the proposed subdivision on the housing needs of the region and that those needs are balanced against the needs for public services and the available fiscal and environmental resources.

The Clairemont Mesa Community Plan designates the project site Medium Density Residential, 15-30 du/ac. The total site acreage is 0.615-acres and would allow between 9 and 19 dwelling units. The project proposes 13 townhome-type detached dwelling units consistent with the density range of the land use designation. The proposed 13 detached dwelling units include 12 market-rate units and one very low-income affordable housing unit. The affordable housing unit will be income-restricted to households with a combined annual gross income at or below 50 percent of the Area Median Income (AMI), subject to an affordable housing agreement with the San Diego Housing Commission (SDHC). There are currently 852 existing affordable housing units within this community planning area (active deed-restricted affordable units through the SDHC). The decision maker has reviewed the administrative record including the project plans, technical studies, environmental documentation and heard public testimony to determine the effects of the proposed subdivision on the housing needs of the region and; that those needs are balanced against the needs for public services and the available fiscal and environmental resources and found that the addition of 13

ATTACHMENT 8

dwelling units for private development is consistent with the housing needs anticipated for the

Clairemont Mesa Community Planning area.

The above findings are supported by the minutes, maps, and exhibits, all of which are herein

incorporated by reference.

BE IT FURTHER RESOLVED, that based on the Findings hereinbefore adopted by the Planning

Commission, Tentative Map No. 2011944, hereby granted to ALMERIA INVESTMENTS, LP, a California

Domestic Limited Partnership, Subdivider, and CIVIL LANDWORKS, Engineer, subject to the attached

conditions which are made a part of this resolution by this reference.

APPROVED:

Ву

Jeffrey A. Peterson

Development Project Manager Development Services Department

ATTACHMENT: Tentative Map Conditions

Internal Order No. 24006995

PLANNING COMMISSION CONDITIONS FOR TENTATIVE MAP NO. 2011944 FOR 1398 LIETA STREET -PROJECT NO. 512890 [MMRP]

| ADOPTED | BY RESOLUT | ION NO. R | _ ON |
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| 1. This Tentative Map No. 2011944 will expire on |
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- 2. Compliance with all of the following conditions shall be completed and/or assured, to the satisfaction of the City Engineer, prior to the recordation of the Final Map, unless otherwise noted.
- 3. Prior to the recordation of the Final Map, taxes must be paid on this property pursuant to Subdivision Map Act section 66492. To satisfy this condition, a tax certificate stating that there are no unpaid lien conditions against the subdivision must be recorded in the Office of the San Diego County Recorder.
- 4. The Tentative Map shall conform to the provisions of Site Development Permit No. 1823446 and Neighborhood Development Permit No. 2011943.
- 5. The Subdivider shall defend, indemnify, and hold the City (including its agents, officers, and employees [together, "Indemnified Parties"]) harmless from any claim, action, or proceeding, against the City and/or any Indemnified Parties to attack, set aside, void, or annul City's approval of this project, which action is brought within the time period provided for in Government Code section 66499.37. City shall promptly notify Subdivider of any claim, action, or proceeding and shall cooperate fully in the defense. If City fails to promptly notify Subdivider of any claim, action, or proceeding, or if City fails to cooperate fully in the defense, Subdivider shall not thereafter be responsible to defend, indemnify, or hold City and/or any Indemnified Parties harmless. City may participate in the defense of any claim, action, or proceeding if City both bears its own attorney's fees and costs, City defends the action in good faith, and Subdivider is not required to pay or perform any settlement unless such settlement is approved by the Subdivider.

ENGINEERING

- 6. The Subdivider shall ensure that all onsite utilities serving the subdivision shall be undergrounded with the appropriate permits. The subdivider shall provide written confirmation from applicable utilities that the conversion has taken place, or provide other means to assure the undergrounding, satisfactory to the City Engineer.
- 7. The Subdivider shall underground existing and/or proposed public utility systems and service facilities in accordance with the San Diego Municipal Code.
- 8. Conformance with the "General Conditions for Tentative Subdivision Maps," filed in the Office of the City Clerk under Document No. 767688 on May 7, 1980, is required. Only those exceptions to the General Conditions which are shown on the Vesting Tentative Map and

covered in these special conditions will be authorized. All public improvements and incidental facilities shall be designed in accordance with criteria established in the Street Design Manual, filed with the City Clerk as Document No. RR-297376.

HISTORICAL

9. Prior to the issuance of any construction permit, the Subdivider shall execute and record a Public Access Easement which ensures public access to the interpretive story board to be placed proximate to the terminus of Tonopah Avenue at the project's driveway as shown on Exhibit "A."

MAPPING

- 10. Prior to the expiration of the Tentative Map, a Final Map to subdivide Parcels/Lots shall be recorded in the office of the County Recorder.
- 11. Prior to the recordation of the Final Map, taxes must be paid or bonded for this property pursuant to section 66492 of the Subdivision Map Act. To satisfy this condition, a tax certificate stating that there are no unpaid lien conditions against the subdivision must be recorded in the Office of the San Diego County Recorder.
 - If a tax bond is required as indicated in the tax certificate, ensure that it is paid or posted at the County Clerk of the Board of Supervisors Office along with the associated \$34.00 compliance fee to avoid delaying the recordation of the Final Map.
- 12. The Final Map shall be based on field survey and all lot corners must be marked with durable survey monuments pursuant to Section 144.0311(d) of the City of San Diego Land Development Codes and Subdivision Map Act Section 66495.
 - All survey monuments shall be set prior to the recordation of the Final Map, unless the setting of monuments is deemed impractical due to the proposed improvements and/or grading associated with the project, in which case, delayed monumentation may be applied on the Final Map in accordance with Section 144.0130 of the City of San Diego Land Development Codes.
- 13. All subdivision maps in the City of San Diego are required to be tied to the California Coordinate System of 1983 (CCS83), Zone 6 pursuant to section 8801 through 8819 of the California Public Resources Code.
- 14. The Final Map shall:
 - a. Use the California Coordinate System for its "Basis of Bearings" and express all measured and calculated bearing values in terms of said system. The angle of grid divergence from a true meridian (theta or mapping angle) and the north point of said map shall appear on each sheet thereof. Establishment of said Basis of Bearings may be by use of existing Horizontal Control stations or astronomic observations.
 - b. Show two measured ties from the boundary of the map to existing Horizontal Control stations having California Coordinate values of First Order accuracy. These

tie lines to the existing control shall be shown in relation to the California Coordinate System (i.e., grid bearings and grid distances). All other distances shown on the map are to be shown as ground distances. A combined factor for conversion of grid-to-ground shall be shown on the map.

15. All private drives shall to be shown on a non-title sheet and names approved by BDR-Street Name Coordinator. The streets shall be dimensioned along centerline with a width clearly shown.

PUBLIC UTILITIES DEPARTMENT

- 16. Prior to the issuance of any construction permit, the Subdivider shall assure, by permit and bond the design and construction of an 8-inch public sewer mains within Lieta Street and portion of Tonopah Avenue as shown on the approved Exhibit "A," in a manner satisfactory to the Public Utilities Director and the City Engineer.
- 17. Prior to the issuance of any building permits, the Subdivider shall assure, by permit and bond, the design and construction of new water and sewer service(s) outside of any driveway or drive aisle and the abandonment of any existing unused water and sewer services within the right-of-way adjacent to the project site, in a manner satisfactory to the Public Utilities Director and the City Engineer.
- 18. Subdivider shall apply for a plumbing permit for the installation of appropriate private back flow prevention device(s) [BFPDs], on each water service (domestic, fire and irrigation), in a manner satisfactory to the Public Utilities Director and the City Engineer. BFPDs shall be located above ground on private property, in line with the service and immediately adjacent to the right-of-way.
- 19. Subdivider shall design and construct all proposed public water and sewer facilities, in accordance with established criteria in the current edition of the City of San Diego Water and Sewer Facility Design Guidelines and City regulations, standards and practices.
- 20. No trees or shrubs exceeding three feet in height at maturity shall be installed within ten feet of any sewer facilities and five feet of any water facilities.

GEOLOGY

- 21. Prior to the issuance of any construction permits (either grading or building), the Subdivider shall submit a geotechnical investigation report or update letter prepared in accordance with the City's "Guidelines for Geotechnical Reports" that specifically addresses the proposed construction plans. The geotechnical investigation report or update letter shall be reviewed for adequacy by the Geology Section of the Development Services Department prior to issuance of any construction permits.
- 22. The Subdivider shall submit an as-graded geotechnical report prepared in accordance with the City's "Guidelines for Geotechnical Reports" following completion of the grading. The asgraded geotechnical report shall be reviewed for adequacy by the Geology Section of the

Development Services Department prior to exoneration of the bond and grading permit close-out.

INFORMATION:

- The approval of this Tentative Map by the City Council of the City of San Diego does not authorize the subdivider to violate any Federal, State, or City laws, ordinances, regulations, or policies including but not limited to, the Federal Endangered Species Act of 1973 and any amendments thereto (16 USC § 1531 et seq.).
- All existing easements granted or dedicated to the City that are being shown and proposed on the Tentative Map Exhibit as to be vacated pursuant to Subdivision Map Act (SMA) requires Process 5 City Council approval.
- If the Subdivider makes any request for new water and sewer facilities (including services, fire hydrants, and laterals), the Subdivider shall design and construct such facilities in accordance with established criteria in the most current editions of the City of San Diego water and sewer design guides and City regulations, standards and practices pertaining thereto. Off-site improvements may be required to provide adequate and acceptable levels of service and will be determined at final engineering.
- Subsequent applications related to this Tentative Map will be subject to fees and charges based on the rate and calculation method in effect at the time of payment.
- Any party on whom fees, dedications, reservations, or other exactions have been imposed as conditions of approval of the Tentative Map, may protest the imposition within ninety days of the approval of this Vesting Tentative Map by filing a written protest with the San Diego City Clerk pursuant to Government Code sections 66020 and/or 66021.
- Where in the course of development of private property, public facilities are damaged or removed, the Subdivider shall at no cost to the City, obtain the required permits for work in the public right-of-way, and repair or replace the public facility to the satisfaction of the City Engineer (San Diego Municipal Code § 142.0607.

Internal Order No. 24006995

| RESOLUTION NUMBER R- | |
|----------------------|--|
| | |
| ADOPTED ON | |

A RESOLUTION ADOPTING MITIGATED NEGATIVE DECLARATION NO. 512890 AND ADOPTING THE MITIGATION, MONITORING, AND REPORTING PROGRAM FOR THE 1398 LIETA STREET -PROJECT NO. 512890 [MMRP]

WHEREAS, on April 4, 2017, ALMERIA INVESTMENTS, LP, a California Domestic Limited

Partnership submitted an application to the Development Services Department for a Site

Development Permit, Neighborhood Development Permit, and Tentative Map for the 1398 Lieta

Street (Project); and

WHEREAS, the matter was Planning Commission of the City of San Diego; and WHEREAS, the issue was heard by the Planning Commission on August 20, 2020; and

WHEREAS, the considered the issues discussed in Mitigated Negative Declaration No. 512890 (Declaration) prepared for this Project; NOW THEREFORE,

BE IT RESOLVED, by the Planning Commission that it is certified that the Declaration has been completed in compliance with the California Environmental Quality Act of 1970 (CEQA) (Public Resources Code Section 21000 et seq.), as amended, and the State CEQA Guidelines thereto (California Code of Regulations, Title 14, Chapter 3, Section 15000 et seq.), that the Declaration reflects the independent judgment of the City of San Diego as Lead Agency and that the information contained in said Declaration, together with any comments received during the public review process, has been reviewed and considered by the Planning Commission in connection with the approval of the Project.

BE IT FURTHER RESOLVED, that the Planning Commission finds on the basis of the entire record that project revisions now mitigate potentially significant effects on the environment previously identified in the Initial Study, that there is no substantial evidence that the Project will have a significant effect on the environment, and therefore, that said Declaration is hereby adopted.

ATTACHMENT 10

BE IT FURTHER RESOLVED, that pursuant to CEQA Section 21081.6, the Planning Commission

hereby adopts the Mitigation Monitoring and Reporting Program, or alterations to implement the

changes to the Project as required by this Planning Commission in order to mitigate or avoid

significant effects on the environment, which is attached hereto as Exhibit A.

BE IT FURTHER RESOLVED, that the Declaration and other documents constituting the record

of proceedings upon which the approval is based are available to the public at the office of the

Development Services Department, 1222 First Avenue, San Diego, CA 92101.

BE IT FURTHER RESOLVED, that Development Servicers Department is directed to file a

Notice of Determination with the Clerk of the Board of Supervisors for the County of San Diego

regarding the Project.

Ву:_____

Jeffrey A. Peterson

Development Project Manager Development Services Department

ATTACHMENT(S):

Exhibit A, Mitigation Monitoring and Reporting Program

EXHIBIT A

MITIGATION MONITORING AND REPORTING PROGRAM

SITE DEVELOPMENT PERMIT, NEIGHBORHOOD DEVELOPMENT PERMIT, AND TENTATIVE MAP

PROJECT NO. 512890

This Mitigation Monitoring and Reporting Program is designed to ensure compliance with Public Resources Code Section 21081.6 during implementation of mitigation measures. This program identifies at a minimum: the department responsible for the monitoring, what is to be monitored, how the monitoring shall be accomplished, the monitoring and reporting schedule, and completion requirements. A record of the Mitigation Monitoring and Reporting Program will be maintained at the offices of the Entitlements Division, 1222 First Avenue, Fifth Floor, San Diego, CA, 92101. All mitigation measures contained in the Mitigated Negative Declaration No. 512890 shall be made conditions of Site Development Permit, Neighborhood Development Permit, and Tentative Map as may be further described below.

A. GENERAL REQUIREMENTS – PART I: Plan Check Phase (prior to permit issuance)

- 1. Prior to the issuance of a Notice To Proceed (NTP) for a subdivision, or any construction permits, such as Demolition, Grading or Building, or beginning any construction related activity on-site, the Development Services Department (DSD) Director's Environmental Designee (ED) shall review and approve all Construction Documents (CD), (plans, specification, details, etc.) to ensure the MMRP requirements are incorporated into the design.
- In addition, the ED shall verify that the MMRP Conditions/Notes that apply ONLY to the construction phases of this project are included VERBATIM, under the heading, "ENVIRONMENTAL/MITIGATION REQUIREMENTS."
- 3. These notes must be shown within the first three (3) sheets of the construction documents in the format specified for engineering construction document templates as shown on the City website:
 - http://www.sandiego.gov/development-services/industry/standtemp.shtml
- 4. The **TITLE INDEX SHEET** must also show on which pages the "Environmental/Mitigation Requirements" notes are provided.
- 5. **SURETY AND COST RECOVERY –** The Development Services Director or City Manager may require appropriate surety instruments or bonds from private Permit Holders to ensure the long-term performance or implementation of required mitigation measures or programs. The City is authorized to recover its cost to offset the salary, overhead, and expenses for City personnel and programs to monitor qualifying projects.

- B. GENERAL REQUIREMENTS PART II: Post Plan Check (After permit issuance/Prior to start of construction)
 - PRE-CONSTRUCTION MEETING IS REQUIRED TEN (10) WORKING DAYS
 PRIOR TO BEGINNING ANY WORK ON THIS PROJECT. The PERMIT
 HOLDER/OWNER is responsible to arrange and perform this meeting by
 contacting the CITY RESIDENT ENGINEER (RE) of the Field Engineering
 Division and City staff from MITIGATION MONITORING COORDINATION
 (MMC). Attendees must also include the Permit holder's Representative(s),
 Job Site Superintendent and the following consultants: Not Applicable.

Note: Failure of all responsible Permit Holder's representatives and consultants to attend shall require an additional meeting with all parties present.

CONTACT INFORMATION:

- a) The PRIMARY POINT OF CONTACT is the **RE** at the **Field Engineering Division (858) 627-3200**
- b) For Clarification of ENVIRONMENTAL REQUIREMENTS, it is also required to call **RE and MMC at (858) 627-3360**
- 2. **MMRP COMPLIANCE:** This Project, Project Tracking System (PTS) No. 512890 and/or Environmental Document No. 512890 shall conform to the mitigation requirements contained in the associated Environmental Document and implemented to the satisfaction of the DSD's Environmental Designee (MMC) and the City Engineer (RE). The requirements may not be reduced or changed but may be annotated (i.e. to explain when and how compliance is being met and location of verifying proof, etc.). Additional clarifying information may also be added to other relevant plan sheets and/or specifications as appropriate (i.e., specific locations, times of monitoring, methodology, etc

Note: Permit Holder's Representatives must alert RE and MMC if there are any discrepancies in the plans or notes, or any changes due to field conditions. All conflicts must be approved by RE and MMC BEFORE the work is performed.

3. **OTHER AGENCY REQUIREMENTS:** Evidence of compliance with all other agency requirements or permits shall be submitted to the RE and MMC for review and acceptance prior to the beginning of work or within one week of the Permit Holder obtaining documentation of those permits or requirements. Evidence shall include copies of permits, letters of resolution or other documentation issued by the responsible agency.

Not Applicable

4. **MONITORING EXHIBITS:** All consultants are required to submit, to RE and MMC, a monitoring exhibit on a 11x17 reduction of the appropriate

construction plan, such as site plan, grading, landscape, etc., marked to clearly show the specific areas including the **LIMIT OF WORK**, scope of that discipline's work, and notes indicating when in the construction schedule that work will be performed. When necessary for clarification, a detailed methodology of how the work will be performed shall be included.

Note: Surety and Cost Recovery – When deemed necessary by the Development Services Director or City Manager, additional surety instruments or bonds from the private Permit Holder may be required to ensure the long-term performance or implementation of required mitigation measures or programs. The City is authorized to recover its cost to offset the salary, overhead, and expenses for City personnel and programs to monitor qualifying projects.

5. **OTHER SUBMITTALS AND INSPECTIONS:** The Permit Holder/Owner's representative shall submit all required documentation, verification letters, and requests for all associated inspections to the RE and MMC for approval per the following schedule:


| | DOCUMENT SUBMITTAL/INSPE | CTION CHECKLIST |
|--------------|---|--|
| Issue Area | Document Submittal | Associated Inspection/Approvals/Notes |
| General | Consultant Qualification Letters | Prior to Preconstruction Meeting |
| General | Consultant Construction Monitoring Exhibits | Prior to or at Preconstruction Meeting |
| Bond Release | Request for Bond Release Letter | Final MMRP Inspections Prior to Bond Release Letter |

C. SPECIFIC MMRP ISSUE AREA CONDITIONS/REQUIREMENTS

Cultural Resources - Designated Site

- Prior to the issuance of the first building permit, the Owner/Permittee shall submit a plan showing the design and location of the interpretive story board to be placed proximate to the terminus of Tonopah Avenue at the project's driveway to the satisfaction of the Design Assistance Sub-Committee of the Historical Resources Board with subsequent staff approval.
- 2. Prior to the issuance of the first building permit, the Owner/Permittee shall submit a plan showing the design and location of the decorative fence element with etched pattern to mimic row planting to the satisfaction of the Design Assistance Sub-Committee of the Historical Resources Board with subsequent staff approval. The landscape and planters shall not block the decorative fencing or create shadows onto or behind the decorative fence.

- 3. Prior to the issuance of a Certificate of Occupancy, the Owner/Permittee shall install the interpretive story board and decorative fencing element in the locations identified on the previously approved plans for the Designated Historic Site. The Owner/Permitee shall be responsible for funding and implementing the long-term management of the story board and decorative fencing in perpetuity.
- 4. Prior to submitting plans to the Design Assistance Subcommittee of the Historical Resources Board showing the design of the interpretive story board and fences, the Owner/Permittee shall work with a Historian that is versed in the Japanese American History for the design of the historical elements for the interpretive story board and fences.

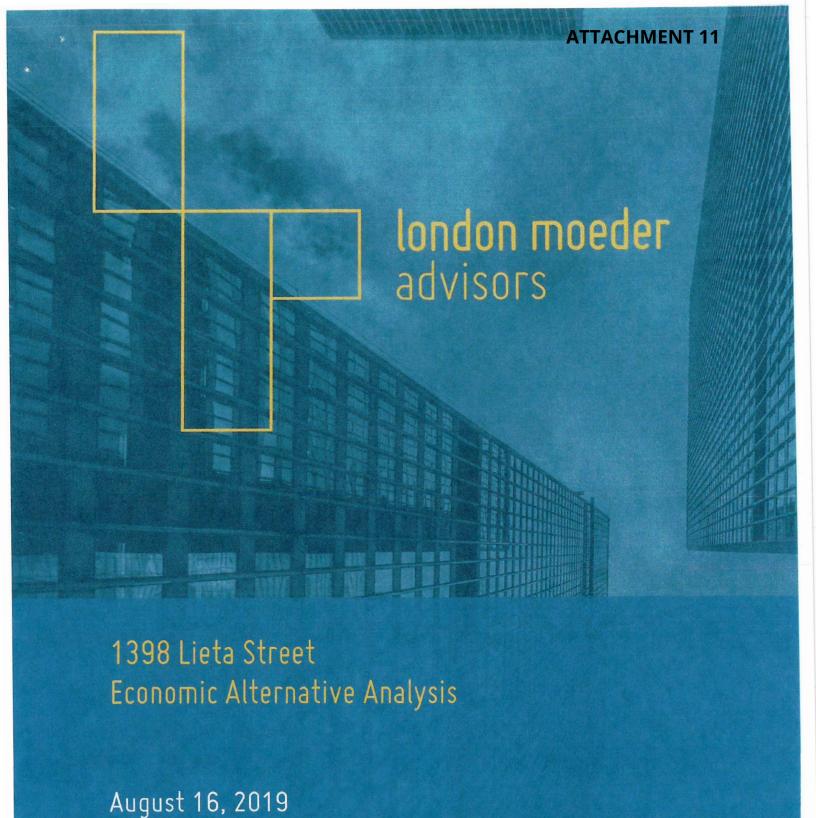

825 10th Avenue San Diego, CA 92101 619. 269.4010

2792 Gateway Road #104 Carlsbad, CA 92024 619.269.4012

londonmoeder.com



Via email: michael@almeriainv.com

1398 Lieta Street - Economic Alternative Analysis

London Moeder Advisors has completed an economic analysis of the three development options pertaining to the 26,800 square-foot property located at 1398 Lieta Street in the Bay Park neighborhood of San Diego. The property is located on the western end of Tonopah Avenue and bounded on the west by Morena Boulevard. The site currently contains a 962 square-foot non-historic single-family home and 25,838 square feet of undeveloped vacant land.

The purpose of this analysis is to analyze the proposed Base Project and the financial impacts and economic feasibility of the development alternatives.

We have analyzed three development options for the property, which include:

- ▶ <u>Base Project</u>: demolish the existing 962 square-foot home and construct 13 new R-3 Class 3-story townhomes, one of which will be affordable, with an average net unit size of 1,912 square feet.
- Alternative 1: rehabilitate the existing 962 square-foot home and return the remaining land to a farming use.
- ▶ <u>Alternative 2</u>: demolish the existing 962 square-foot home, retain the former farm area as a dormant site, and construct three standard single-family homes on the rest of the property, with an average home size of 2,250 square feet.

Conclusions of Economic Alternatives

We analyzed the project performance of the Base Project that is proposed for the property. The Base Project includes construction of 13 R-3 Class 3-story townhomes, one of which will be affordable. The average size of the townhomes is 1,912 square feet.

We have assumed a 12-month construction period with the 13 townhomes being sold when construction is completed. The following table summarizes the impacts to the Base Project under each of the two alternatives:

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| | | 1398 Lieta Street - San Summary of Scena | | | | | | | | | |
|----------------------------|--------------|---|---|---------------------------|---------------|--|--|--|--|--|--|
| Base Projec 13 Townhome | | Alternative 1 Rehab Existing Ho | Alternative 1 Alternative 2 Rehab Existing House 3 Single-Family Residentia | | | | | | | | |
| # of Units | 13 | # of Units | 2 | # of Units | 3 | | | | | | |
| For Sale Residential | 24,855 | For Sale Residential | 962 | For Sale Residential | 6,750 | | | | | | |
| | | Total Net Useable | 962 | Total Net Useable | 6,750 | | | | | | |
| Total Net Saleable | 24,855 | Garage S.F. | 0 | Garage S.F. | 0 | | | | | | |
| Miscallenous | 4,429 | Total S.F. | 962 | Total S.F. | 6,750 | | | | | | |
| Garage S.F. | 5.169 | Difference (Net S.F.) | (23,893) | Difference (S.F.) | (18,105) | | | | | | |
| Total S.F. | 34,453 | Difference (%) | -96% | Difference (%) | -73% | | | | | | |
| Profit | \$2,538,876 | Profit | (\$716,433) | Profit | (\$396,288) | | | | | | |
| | | Difference (\$) | (\$3,255,309) | Difference (\$) | (\$2,935,165) | | | | | | |
| | | Difference (%) | -128% | Difference (%) | -116% | | | | | | |
| Performance | | | | | | | | | | | |
| Total Gross Sales Revenue | \$13,213,000 | Total Gross Sales Revenue | \$625,300 | Total Gross Sales Revenue | \$3,300,000 | | | | | | |
| Margin On Revenue | 19.2% | Margin On Revenue | -114.6% | Margin On Revenue | -12.0% | | | | | | |
| Total Project Costs | \$10,013,474 | Total Project Costs | \$1,310,468 | Total Project Costs | \$3,531,288 | | | | | | |
| Margin On Cost | 25.4% | Margin On Cost | -54.7% | Margin On Cost | -11.2% | | | | | | |

Source: London Moeder Advisors

We have determined that only the Base Project is economically feasible. This project is forecasted to generate a total profit of \$2.54 million. When compared to the total revenue of the project the Margin on Revenue achieved is 19.2%. When compared to the total development costs of the project the Margin on Cost achieved is 25.4%.

Based on performing feasibility analyses and consulting services for real estate projects, it is our experience that a redevelopment project requires the Margin on Revenue to exceed 15% and Margin on Cost to exceed 18% for a project to be economically feasible and to qualify for project financing.

The Return on Investment (ROI) of the Base Project is forecasted to be 80%, which also demonstrates that the Base Project is economically feasible. In order for a project to be economically feasible, attract investors, and achieve financing, a project must reach at a minimum ROI of 50%.

Alternative 1 is not economically feasible. Due to limited lot usage allowed and no new construction, the sale of one rehabilitated home for \$625,000 would not be sufficient to cover land costs of \$860,000 let alone rehabilitation costs. This results in project costs exceeding revenues and a financial loss for the developer of \$716,433. This is a 128% reduction in profit when compared to the Base Project.

Alternative 2, which demolishes the existing structure and develops three single-family homes, is not economically feasible. Due to limited scale of development and lot usage allowed, the sale of

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three single-family homes for a total of \$3,300,000 is not sufficient to cover project costs of \$3,531,288. This would result in a financial loss for the developer of \$396,288, or a 116% reduction in profit when compared to the Base Project.

Approach to Analysis

To determine the impact to the project, we prepared financial proformas for the two alternatives and compared the performances to the Base Project. In each proforma, we assumed the following:

- Construction period of 12 months
- For-sale residential is sold immediately after construction is completed
- Construction costs are provided by the developer and London Moeder Advisors based on similar projects and construction types.
- Sales prices and revenue were established by our survey of market data for comparable sales in the area.

The following summarizes the financial proformas we have prepared for analyzing the project, which are included in the Appendix.

Base Project

The Base Project includes demolition of the existing structures and construction of 13 new R-3 Class 3-story Town Homes, one of which will be affordable. The 13 townhomes are assumed to be sold after construction is completed.

The 12 market rate units will average 1,908 square feet in size and the affordable unit is planned to be 1,954 square feet.

When the 12 market rate townhomes are sold after construction is completed, the average sale price is estimated to be \$1,044,833. The one affordable townhome is assumed to be sold after construction for \$350,000. The total gross profit generated from this investment is estimated to be \$2,538,876.

The gross profit of \$2.54 million represents a Margin on Revenue of 19.2% when divided by the Gross Sales Revenue of the project (\$13.2 million) and a Margin on Cost of 25.4% when divided by the Development Costs of the project (\$10.0 million). This suggests that the Base Project is economically feasible. It is our experience that a for-sale project requires a Margin on Cost of 18% and a Margin on Revenue of 15% for a project to be economically feasible and to qualify for project financing.



Alternative 1

Alternative 1 assumes rehabilitation of the existing single-family home (962 square feet) and returning the remaining land to a farming use. The single-family home is assumed to be sold immediately after construction is completed.

The anticipated sale price for the single-family home is estimated to be \$625,300 (\$650 per square foot). Total project costs are estimated to be \$1,310,468 while total gross sales revenue is forecasted at only \$625,300. This results in a financial loss for the project of \$716,433 and is therefore not economically feasible.

Compared to the Base Project, Alternative 1 represents a reduction of 23,893 net saleable square feet, or 96% less space. This has a direct impact to the overall achievable value of the project.

With a total forecasted value at disposition of \$625,300, Alternative 1 would generate approximately \$12,587,700 less revenue than the Base Project (95% reduction). But more importantly the project is not economically feasible because it results in a financial loss of \$716,433.

Alternative 2

Alternative 2 assumes demolition of the existing single-family home, retain the former farm area as a dormant site, and construction of three new for-sale single-family detached homes. The existing single-family home is 962 square feet and the newly constructed single-family homes would total 6,750 square feet (2,250 square feet each).

When the single-family homes are sold after construction is completed, the anticipated average sale price is estimated to be \$1,100,000 (\$489 per square foot). Total project costs are forecasted at \$3,531,288 while the total gross sales revenue is forecasted at only \$3,300,000. This results in a financial loss for the project of \$396,288 and is therefore not economically feasible.

Compared to the Base Project, Alternative 2 represents a reduction of 18,105 net saleable square feet, or 73% less space. This has a direct impact to the overall achievable value of the project.

With a total forecasted value at disposition of \$3,300,000, Alternative 2 would generate approximately \$9,913,000 less revenue than the Base Project (75% reduction). But more importantly the project is not economically feasible because it results in a financial loss of \$396,288.

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ENT 11

| | ATTACHM |
|---|--------------------------------|
| l <mark>ondon moeder</mark> advisors | |
| Should you have any questions regarding this analysis, please f | feel free to contact our firm. |
| Hay H. Ford | Nathan Mordin |

Tay H. Torl

Nathan Moeder

ATTACHMENT 11

london moeder
advisors

Appendix

londonmoeder.com Page 7 of 8

1398 Leita Street Base Project: For-Sale Townhomes

| FINANCING | |
|---------------|-----------------|
| Loan Amount | \$6.845,002 |
| Loan to Cost | %92,89 |
| Interest Rate | %00:50 %00:8 |

| LAND | |
|--------------------------------|----------------------|
| Land Value | 000 098\$ |
| Land S.F. | 26 800 S E |
| Land \$/S.F. | \$30 per CE |
| Land Value Per Unit | \$66 154 ner Hnit |
| Land Value Per Residential S.F | \$34.60 per FAR Foot |

| INVESTEMENT PERFORMANCE | | |
|----------------------------------|-----------|----------------|
| Gross Revenue: Affordable Unit | \$179 psf | \$350,000 |
| Gross Revenue: Market Rate Units | \$556 psf | \$12,863,000 |
| Total Gross Revenue | | \$13,213,000 |
| Cost of Sale | 5.0% | (\$660,650) |
| Total Net Revenue | | \$12,552,350 |
| Development Costs | | (\$10.013.474) |
| Gross Profit | | \$2,538,876 |
| Margin on Total Cost | | 25 4% |
| Margin on Gross Revenue | | 19.2% |
| Equity Investment | | \$3,168,472 |
| Return On Investment (ROI) | | 80% |
| NPV @ 10% for 3 Years | | \$1,907,495 |

| DEVELOPMENT SUMMARY | | | | |
|----------------------------|------------|-------------|-----------------|---------|
| Unit Type | # of Units | Avg. SF | Avg. Sale Price | \$/S.F. |
| 2 Bed TH | 3 | 1,308 | \$787,667 | \$602 |
| 3 Bed TH | 6 | 2,109 | \$1,166,667 | \$553 |
| 3 Bed TH (affordable) | 1 | 1,954 | \$350,000 | \$179 |
| Total/Average | 13 | 1,912 | \$1,016,385 | \$532 |
| Total Residential S.F. | | 24,855 S.F. | | |
| | | | 1 | |

| CONSTRUCTION BUDGE | | | | |
|----------------------|--------------|--------------|------------|-----------|
| | | | Cost Per | |
| | | Total Cost | Gross S.F. | Cost/Unit |
| Land Cost | | \$860,000 | \$34.60 | \$66,154 |
| Due Diligence | | \$18,800 | \$0.76 | \$1,446 |
| On Site Costs | | \$586,563 | \$23.60 | \$45,120 |
| Res. Construction | \$248.27 psf | \$6,170,806 | \$248.27 | \$474,677 |
| Soft Costs | \$52.85 psf | \$1,313,585 | \$52.85 | \$101,045 |
| Marketing | | \$5,000 | \$0.20 | \$385 |
| Const. Loan Fee | 2.0% | \$136,900 | \$5.51 | \$10,531 |
| Const. Loan Interest | | \$547,600 | \$22.03 | \$42,123 |
| Contingency | 2.0% | \$374,220 | \$15.06 | \$28,786 |
| Total Project Costs | | \$10,013,474 | \$402.88 | \$770,267 |
| Less: Loan Amount | | \$6.845,002 | | |
| Initial Investment: | | \$3,168,472 | | |
| | | | | |

1398 Leita Street

Alternative 1: For-Sale Rehab Single-Family Residential

| Loan Amount \$1,077,030 Loan to Cost 90.00% | FINANCING | |
|---|---------------|-------------|
| | -oan Amount | \$1.077.030 |
| | Loan to Cost | %UU U6 |
| | Interest Rate | %O : C |

| LAND | |
|--------------------------------|-----------------------|
| Land Value | \$860,000 |
| Land S.F. | 26800 S E |
| Land \$/S.F. | \$32 per S E |
| Land Value Per Unit | \$860.000 per Unit |
| Land Value Per Residential S.F | \$893.97 per FAR Foot |

| Total Gross Revenue \$650 p Cost of Sale Total Net Revenue Development Costs Gross Profit | \$650 psf 5.0% | \$625,300 |
|--|-------------------|---------------|
| evenue It Costs | 20% | |
| evenue It Costs | | (\$31.265) |
| <u>Development Costs</u> Gross Profit | | \$594.035 |
| Gross Profit | | (\$1,310,468) |
| | | (\$716.433) |
| Margin on Total Cost | | -54.7% |
| Margin on Gross Revenue | | -114.6% |
| Equity Investment | | \$233.438 |
| Return On Investment (ROI) | | -307% |
| NPV @ 10% for 3 Years | | (\$538,266) |

| DEVELOPMENT SUMMARY | | | | |
|------------------------|--------------|-------------|------------|-------------|
| Unit Type | # of Units | Avg. S.F | Sale Price | \$/S.F |
| Rehab | 1 | 962 | \$625,300 | \$650 |
| Total/Average | 1 | 962 | \$625,300 | \$650 |
| Total Residential S.F. | | 962 S.F. | | |
| | | | | |
| CONSTRUCTION BUDGET | | | | |
| | | | Cost Per | |
| | | Total Cost | S.F. | Cost/Unit |
| Land Cost | | \$860,000 | \$893.97 | \$860,000 |
| Due Diligence | | \$0 | \$0.00 | \$0 |
| Res. Construction | \$350.00 psf | \$336,700 | \$350.00 | \$336,700 |
| Soft Costs | \$0.00 psf | incl. | \$0.00 | \$0 |
| Marketing | | \$0 | \$0.00 | \$0 |
| Const. Loan Fee | 1.5% | \$16,155 | \$16.79 | \$16,155 |
| Const. Loan Interest | | \$80,777 | \$83.97 | \$80,777 |
| Contingency | 2.0% | \$16,835 | \$17.50 | \$16,835 |
| Total Project Costs | | \$1,310,468 | \$1,362.23 | \$1,310,468 |
| Less: Loan Amount | | \$1,077,030 | | |
| Initial Investment: | | \$233,438 | | |
| | | | | |

1398 Leita Street

Alternative 2: For-Sale Three Single-Family Residential

| FINANCING | |
|---------------|-------------|
| Loan Amount | \$2 414 033 |
| Loan to Cost | 88.36% |
| Interest Rate | %008 |

\$/S.F. \$489 **\$489**

Avg. Sale Price \$1,100,000 \$1,100,000

Avg. S.F 2,250 2,250 6,750 S.F.

of Units

DEVELOPMENT SUMMARY

Unit Type Single Family Total/Average Total Residential S.F.

| LAND | |
|--------------------------------|-----------------------|
| Land Value | 000 0985 |
| Land S.F. | 26 800 S E |
| Land S/S.F. | C22 202 CE |
| Land Value Per Unit | \$28 pel 3.F. |
| Land Value Per Residential S.F | \$127 41 ner FAR Foot |
| | AND IDD TH: / JTC |

| INVESTEMENT PERFORMANCE | Д. | |
|----------------------------|-----------|---------------|
| Total Gross Revenue | \$489 psf | \$3,300,000 |
| Cost of Sale | 5.0% | (\$165,000) |
| Total Net Revenue | | \$3,135,000 |
| Development Costs | | (\$3.531.288) |
| Gross Profit | | (\$396,288) |
| Margin on Total Cost | | -11.2% |
| Margin on Gross Revenue | | -12.0% |
| Equity Investment | | \$1,117,255 |
| Return On Investment (ROI) | | -35% |
| NPV @ 10% for 3 Years | | (\$297,737) |
| | | |

| CONSTRUCTION BUDGET | 1 | | | |
|----------------------|-----------|-------------|----------|-------------|
| | × | | Cost Per | |
| | | Total Cost | S.F. | Cost/Unit |
| Land Cost | | \$860,000 | \$127.41 | \$286,667 |
| Due Diligence | | \$0 | \$0.00 | \$0 |
| On Site Costs | | \$303,635 | \$44.98 | \$101,212 |
| Res. Construction | \$300 psf | \$2,025,000 | \$300.00 | \$675,000 |
| Soft Costs | %0 | incl. | \$0.00 | \$0 |
| Marketing | | \$0 | \$0.00 | \$0 |
| Const. Loan Fee | 2.0% | \$48,281 | \$7.15 | \$16,094 |
| Const. Loan Interest | | \$193,123 | \$28.61 | \$64,374 |
| Contingency | 2.0% | \$101,250 | \$15.00 | \$33,750 |
| Total Project Costs | | \$3,531,288 | \$523.15 | \$1,177,096 |
| Less: Loan Amount | | \$2,414,033 | | |
| Initial Investment: | | \$1,117,255 | | |
| | | | | |



Corporate Profile London Moeder Advisors

REPRESENTATIVE SERVICES

| Market and Feasibility Studies | Development Services | Litigation Consulting |
|--------------------------------|----------------------|-----------------------|
| Financial Structuring | Fiscal Impact | Workout Projects |
| Asset Disposition | Strategic Planning | MAI Valuation |
| Government Processing | Capital Access | Economic Analysis |

London Moeder Advisors (formerly The London Group) was formed in 1991 to provide real estate advisory services to a broad range of clientele. The firm principals, Gary London and Nathan Moeder, combine for over 60 years of experience. We have analyzed, packaged and achieved capital for a wide variety of real estate projects. Clients who are actively pursuing, developing and investing in projects have regularly sought our advice and financial analysis capabilities. Our experience ranges from large scale, master planned communities to urban redevelopment projects, spanning all land uses and development issues of all sizes and types. These engagements have been undertaken principally throughout North America and Mexico.

A snapshot of a few of the services we render for both the residential and commercial sectors:

- Market Analysis for mixed use, urban and suburban properties. Studies concentrate on market depth for specific
 products, detailed recommendations for product type, absorption and future competition. It also includes economic
 overviews and forecasts of the relevant communities.
- Financial Feasibility Studies for new projects of multiple types, including condominium, apartment, office, and masterplanned communities. Studies incorporate debt and equity needs, sensitivity analyses, rates of return and land valuations.
- Litigation support/expert witness services for real estate and financial related issues, including economic damages/losses, valuations, historic market conditions and due diligence. We have extensive deposition, trial, mediation and arbitration experience.
- Investment studies for firms acquiring or disposing of real estate. Studies include valuation, repositioning projects and portfolios, economic/real estate forecasts and valuation of partnerships. Often, the commercial studies include the valuation of businesses.
- Estate Planning services including valuation of portfolios, development of strategies for disposition or repositioning
 portfolios, succession planning and advisory services for high net worth individuals. We have also been involved in
 numerous marriage dissolution assignments where real estate is involved.
- Fiscal Impact, Job Generation and Economic Multiplier Effect Reports, traditionally prepared for larger commercial projects and in support of Environmental Impact Reports. We have been retained by both developers and municipalities for these reports. The studies typically relate to the tax revenues and employment impacts of new projects.

The London Group also draws upon the experience of professional relationships in the development, legal services, financial placement fields as well as its own staff. Clients who are actively investigating and investing in apartment projects, retail centers, commercial projects, mixed use developments and large master plans have regularly sought our advice and financial analysis capabilities.

San Diego: 825 10th Ave | San Diego, CA 92101 | (619) 269-4010 **Carlsbad:** 2792 Gateway Road #104 | Carlsbad, CA 92009 | (619) 269-4012



MEMORANDUM

DATE: Nov. 25, 2019

TO: Suzanne Segur, Senior Planner/ HRB Liaison, Development Services Department

FROM: Marcia Smith, Economic Development Specialist, Economic Development Department

SUBJECT: 1398 Lieta St., Peer Review of Economic Alternatives Analysis

INTRODUCTION

Per your request, the City of San Diego Economic Development Department (EDD) has undertaken a peer review of the Economic Alternative Analysis prepared by London Moeder Advisors pertaining to the three development scenarios at 1398 Lieta St., San Diego, CA 92110. Located in the Bay Park neighborhood of the Clairemont Mesa Community Planning Area, the 0.62-acre property (APN 430-680-09-00) currently contains a 962-square-foot single-story home and 25,838 square feet of undeveloped, dormant land. The elevated site is at the western end of Tonopah Avenue and southern end of Lieta Street, perched above Morena Boulevard on its west. It is bordered by single-family detached homes on its southeast side and a 70-unit apartment complex of the Sarn-Smith subdivision on its northeast side.

For context, the City of San Diego continues to face a critical need for housing, particularly affordable housing. Also, the City is in the process of comprehensively updating Clairemont's 30-year-old community plan with considerations for the City's housing shortage, transit-oriented development and mobility and sustainability goals. Each scenario of the proposed project is compatible with the Urban Design Element goals stated in the August 2019 working draft of the Clairemont Plan to enhance "the Clairemont's major attributes such as its canyons, distinct single-family neighborhoods, its connection to Mission Bay, and its commercial centers." According to the Clairemont Engaged website encouraging community outreach for and participation in the plan update, Clairemont's existing residents and growing population seeks greater variety in housing types and price ranges. The proposed project presents a scenario that aligns with those needs.

EDD has received the development proposal for the Base Project: the demolition of the existing 962-square-foot home and the construction of 12 R-3 Class, three-story, market-rate townhomes (two-

¹ Working Draft Urban Design Element. (Aug. 2019). Clairemont Community Plan. Retrieved from https://9ff67c5d-1cd1-49a0-b96c-ff60f299d49e.filesusr.com/ugd/a513cc 224d5eb202b04783b2134043e2644bca.pdf

² Clairemont Engaged. (2017). "About Clairemont Engaged." Retrieved from https://www.clairemontplan.org/about

and three-bedroom units) and one R-3 Class three-story, three-bedroom, affordable-rate townhome. The average net-unit size of the townhomes would be 1,912 square feet. Two alternatives were also provided: (Alternative 1) the rehabilitation of the 962-square-foot-home and the restoration of the undeveloped land to agricultural use; (Alternative 2) the demolition of the 962-square-foot home, the construction of three standard single-family homes with an average home size of 2,250 square feet, and the retaining of the remaining former farm land as a dormant site. London Moeder Advisors has prepared an Economic Alternative Analysis, which includes feasibility analyses, a statement of probable costs from unnamed developer and London Moeder Advisors, and projected sales prices based on market study of surrounding area comparable sales.

The City of San Diego Development Services Department (DSD) has asked that EDD conduct a peer review of London Moeder Advisors' Economic Alternative Analysis to determine 1) whether the assumptions and conclusions used in the analysis are acceptable; and 2) if any of the alternatives are economically feasible, that is, able to be financed and generate a reasonable rate of return.

KEY FINDINGS

Threshold Feasibility Questions (2)

- 1) EDD reviewed the assumptions and analyzed viability of the Base Project and two alternatives and finds the assumptions, estimates, valuation and conclusion to be reasonable and acceptable.
 - The 962-square-foot single-family home, according to the analysis, is a "non-historic" structure.³ But the 0.62-acre parcel upon which the structure stands, the Alzo and Komume Sogo Farm, is in the Register of Designated Historical Resources as Site No. 1305 under Criterion A:

The resource reflects a special element of the Issei/Japanese-American agricultural practices within the Mission Bay area during the 1930s through the 1950s and the restrictive property rights/ ownership measures taken against minorities, specifically Japanese nationals, during the 1930s through the 1950s.⁴

The designation, which excludes structures located on the parcel, is for the period of significance 1937-1983. Neither EDD nor London Moeder Advisors includes permit fees related to the historical review in the economic feasibility analyses. EDD therefore assumes that all three development scenarios are permissible at this location.

• The Base Project calls for one of 13 townhomes to be designated at affordable housing, which will be offered for sale at \$350,000. This more than satisfies the City of San Diego's Inclusionary Affordable Housing Ordinance⁵, which applies to new development of 2 or more units and requires at least 5% of the condominium conversions to be set aside for households earning no more than 100% of the area median income, subject to the San Diego Housing Commission. The Base Project sets aside 7.6% of dwelling units (1 of 13

³ London Moeder Advisors. (August 19, 2019). 1398 Lieta Street Economic Alternative Analysis. San Diego.

⁴ California Historical Resources Inventory Database. (n.d.). City of San Diego, 1398 Lieta St. Retrieved from http://sandiego.cfwebtools.com/search.cfm?local=true&res_id=17981&local_id=1&display=resource&key_id=334

⁵ City of San Diego Development Services Department. (July 2018). Information Bulletin 532: Requirements for Inclusionary Affordable Housing.

units). The \$350,000 sale price would entail a \$60,000 (17%) down payment, a 30-year fixed loan term (4.125%) and estimated \$1,996 monthly payments. The \$1,996 payments would be affordable, i.e., less than 30% of the owner's monthly income for a household earning the \$86,300 AMI in 2019, as designated by the San Diego Housing Commission 6 (\$86,300/12 * .30 = \$2,158). The proposal from Alternative 2, which calls for the construction of three standard single-family homes, does not appear to have a line item associated with an Inclusionary Affordable Housing Fee, which would make that alternative even more economically infeasible.

- The assumption of a 12-month construction period is reasonable considering other similar residential construction projects in the San Diego region.
- The Base Project's three-story design meets the 30-foot height limitation of the current and proposed Clairemont Mesa Community Plan. This limitation preserves public view of Mission Bay and allows homeowners to take advantage of the vista as well.
- The residential construction costs provided by the developer and London Moeder Advisors for the Base Project (\$248.27 per square foot), Alternative 1 (\$350 psf) and Alternative 2 (\$300 psf) are each above the most recent 2018 San Diego Area Chapter International Code Council Valuation Schedule⁷ for R-3 residential dwellings (\$201.82 psf). EDD, however, does not consider the projected costs to be excessive because these dwellings, either townhomes or single-family homes, are larger units averaging 1,908 square feet for the townhomes and 2,250 square feet for the single-family homes. Also, according the Economic Alternative Analysis, the homes, with the exception of the affordable-rate townhome, are expected to supplement Clairemont's housing stock selection as high-quality, 2-plus-bedroom offerings that warrant premium pricing (>\$850,000). Average buildable ranges for a custom residential dwelling or specialty build in San Diego run \$225-\$350 per square foot, according to several developers.
- Also, the expectation that the properties will be sold at the list price upon completion of construction is acceptable, barring a sudden economic downturn, a looming recession or drop in consumer confidence. Redfin scores the Bay Park market as "78 Very Competitive" within the past three months, with homes sold within 1% of their list price and go pending in between 9 and 16 days. New builds, especially 3-bedroom ones with expansive, unobstructed views of Mission Bay, within a 3-mile radius of the location are rare. Moreover, the Base Project's 3-bedroom townhomes can be expected to be in high demand because older neighboring multifamily units do not feature more than two bedrooms and single-family detached homes rarely hit this seller's market.
- The calculated sales prices for the townhomes are slightly high, and the calculated prices for single-family homes are modestly low—but all reasonable, competitive and corroborated by a survey of comparable sales in the surrounding market on Zillow.com, Redfin.com and CoStar. Redfin, for example, reports November's median list price for homes at \$850,000.

⁶ San Diego Housing Commission. San Diego Housing Commission Income and Rent Calculations. (2019). Retrieved from https://www.sdhc.org/wp-content/uploads/2018/06/AMI-Rent-Chart.pdf

⁷ San Diego Area Chapter International Code Council. (Feb. 2018). 2018 Valuation Schedule. Retrieved from https://iccsandiego.org/wp-content/uploads/2019/04/Valuation-Schedule-2018-ICCSD.pdf

⁸ Redfin website. (2019). 1398 Lieta St. Retrieved from https://www.redfin.com/CA/San-Diego/1398-Lieta-St-92110/home/5218681

London Moeder Advisors uses an average sales price for the 12 market-rate townhomes of \$1,044,833, or \$556 per square foot. That is 9% higher than Redfin's Bay Park market statistic of \$508 median per square foot, which is likely weighted down the area's older properties. Alternative 2's single-family homes are estimated to list at \$1,100,000 (\$489 per square foot), which appears to be significantly below what the market will bear. A market study using Zillow.com's Zestimates® shows four of 17 single-family detached homes in the 1400 block of Lieta Street at \$1.36 million, \$1.28 million, \$1.12 million and \$1.04 million. The 17 properties average \$608 per square foot, which is 24% higher than Alternative 2's asking price. Still, the pricing for both dwelling types can be considered acceptable.

- Given the preceding discussion on the reasonable and acceptable assumptions for the input data in all three scenarios, it follows that the projections for Margins on Revenue and Margins on Cost are accurate and reasonable. The Base Project, with its 19.2% Margin on Revenue and 25.4% Margin on Cost, is the only economic feasible project. It should be noted at that Base Project's 19.2% Margin on Revenue, which drops significantly to account for the sale of the affordable-rate townhome, is just above the 15% threshold that London Moeder Advisors considers economically feasible and worthy of financing. Industry construction data recommend a 21-25% gross margin on new construction. Both Alternative 1 and 2 create significant negative returns, even when raising the sales prices, rendering these options infeasible.
- 2) EDD considers the Base Project the only economically feasible option of the projects presented. Use of the 0.62-acre lot for single-family home construction exposes the developer potentially to significant reductions of project value and rising construction costs without bringing new types of housing to Bay Park.

For any questions about this review, please do not hesitate to contact me by phone at 619-236-6461 or by email at marcias@sandiego.gov.

Thank you,

Marcia C. Smith

Murcia C. Smitz

Economic Research Specialist

Economic Development Department

MCS

cc: Christina Bibler, Director, Economic Development Department
Lydia Moreno, Deputy Director, Economic Development Department



City of San Diego Development Services 1222 First Ave., MS-302 San Diego, CA 92101

Community Planning Committee Distribution Form Part 2

| Project Name: | 10 | | Proj | ect N | lumber: | Distribution Date: |
|---|-------------------------|---|-----------------------------------|----------------|----------------------------------|---|
| 1398 Lieta St SDP | | | 512890 | | 12890 | 4/5/2017 |
| Project Scope/Location: | | | | | | |
| CLAIREMONT MESA IO# 24006995 **SUSTAIN SDP & NDP to construct 13 dwelling units totaling affordable dwelling unit, a density bonus of 37.5-p Mesa Height Limit. The 0.61-acre site is located at Mesa Community Plan area within Council District | 34,9 ercen at 139 | 66 square t, request | e-feet ing th | on a | a single lot. F deviations ar | Project provides one and exceeding the Clairemont |
| Applicant Name: | | | | | Applicant P | hone Number: |
| Craig Howard | | | | | (619) 270-6 | 190 |
| Project Manager: | Pho | ne Numbe | r: | Fax | Number: | E-mail Address: |
| Jeff Peterson | (619 |) 446-523 | 7 | (619 |) 321-3200 | JAPeterson@sandiego.gov |
| Committee Recommendations (To be completed for | Initia | al Review) |): | | | |
| ☐ Vote to Approve | | Member | s Yes | M | lembers No | Members Abstain |
| ■ Vote to Approve With Conditions Listed Below | | Member | s Yes | M | embers No | Members Abstain |
| ■ Vote to Approve With Non-Binding Recommendations Listed Bel | ow | Member | s Yes | M | embers No | Members Abstain |
| ▼ Vote to Deny | | Member 10 | | M | lembers No | Members Abstain |
| ☐ No Action (Please specify, e.g., Need further info quorum, etc.) | ormat | ion, Split | vote, l | Lack | of | Continued |
| CONDITIONS: Not in keeping with the level of deparking (don't agree tandem and lifts will be utilized side inadequate. West slope needs to be landsc | zed). | Privacy is | ssues | for | adjacent res | idential. Landscaping on Sout |
| NAME: Kevin J. Carpenter, AIA | | | | | TITLE: C | nair, PRS |
| SIGNATURE: | | | | | DATE: 6/ | 30/2020 |
| Attach Additional Pages of Necessary. | 1 | Please return Project Ma City of San Diego, | nagen Diego nt Ser Avenu | vices e, MS | Department | |
| Printed on recycled paper. Visit of Upon request, this information is av | | | | | | |



Ownership Disclosure Statement

City of San Diego Development Services 1222 First Ave., MS-302 San Diego, CA 92101 (619) 446-5000

| Annual Type, Check analogic | to have for time of approval (a) required | atad. C Naishbanhard Usa Da | E Constal Development Development |
|--|--|--|--|
| | Permit Site Development Permit Vesting Tentative Map Map N | | ermit Coastal Development Permit Conditional Use Permit ndment • Other |
| Project Title | | TO THE RESIDENCE OF THE PROPERTY OF THE PROPER | Project No. For City Use Only |
| 1398 Lieta Street | | | 512890 |
| Project Address: | 450 might over a name of the 1900 might of a second of 1500 Might gray and a second of the 1500 Might gray and the 1500 Might gray and 1500 Might | The state of the s | |
| 1398 Lieta Street, San Dieg | go, 92110 | | |
| Part I - To be completed when | n property is held by Individua | ıl(s) | |
| above, will be filed with the City of below the owner(s) and tenant(s) (who have an interest in the property), individuals who own the property), from the Assistant Executive Direct Development Agreement (DDA) ha Manager of any changes in owners | San Diego on the subject property (if applicable) of the above reference, y, recorded or otherwise, and state of A signature is required of at least of the San Diego Redevelopment as been approved / executed by the ship during the time the application of days prior to any public hearing on the hearing process. | with the intent to record an ered property. The list must include the type of property interest (e.g. one of the property owners. Att Agency shall be required for a elective Council. Note: The apples being processed or considere | rmit, map or other matter, as identified noumbrance against the property. Please list de the names and addresses of all persons ., tenants who will benefit from the permit, all tach additional pages if needed. A signature ill project percels for which a Disposition and licant is responsible for notifying the Project d. Changes in ownership are to be given to to provide accurate and current ownership |
| / | Yes No | | |
| Name of Individual (type or pri | nt): | Name of Individual (type | oe or print): |
| Owner Tenant/Lessee | Redevelopment Agency | Owner Tenan | nt/Lessee Redevelopment Agency |
| Street Address: | Andrew Commence of the Commenc | Street Address: | THE PROPERTY OF THE PROPERTY O |
| City/State/Zip: | | City/State/Zip: | |
| Phone No: | Fax No: | Phone No: | Fax No: |
| Signature: | Dale: | Signature : | Date: |
| Name of Individual (type or pri | nt): | Name of Individual (typ | pe or print): |
| Owner Tenant/Lessee | Redevelopment Agency | Owner Tenant/ | Lessee Redevelopment Agency |
| Street Address: | | Street Address: | |
| City/State/Zip: | Activity - and addition of the state of the | City/State/Zip: | Administration in the Administration of the |
| Phone No: | Fax No: | Phone No: | Fax No: |
| Signature : | Date: | Signature : | Date: |
| | | | |

| Part II - To be completed when property is held by a corporation or partnership | Project Title: | Project No. (For City Use Only) |
|--|---|--|
| Legal Status (please check): Corporation | 1398 Lieta Street | 5/2870 |
| Corporation Limited Liability -or General) What State? Corporate Identification No. Partnership | Part II - To be completed when property is held by a | corporation or partnership |
| By signing the Ownership Disclosure Statement, the owner(s) acknowledge that an application for a permit, map or other matter, as identified above, will be filled with the City of San Diego on the subject property with the Intent to record an encumbrance against the property. Please list below the names, titles and addresses of all persons who have an interest in the property, recorded or otherwise, and state the type of property interest (e.g., tenants who will benefit from the permit, all corporate officers, and all partners in a partnership who own the property. Assignature is required of all least one of the corporate officers or partners who own the property. Assignature is required of all least one of the corporate officers or partners who own the property. Assignature is required of all least one of the corporate officers or partners who own the property and a partnership during the time the application is being processed or considered. Changes in ownership are to be given to the Project Manager of any changes in ownership during the time the application is being process. Additional pages attached in the property of the property and property and provided the property. Fallet the property accounts and current ownership information could result in a delay in the hearing not he subject property. Fallet the property accounts and current ownership information outdoor result in a delay in the hearing process. Additional pages attached Types Tonant/Lessee Tonant/Lessee Towner Tonant/Lessee Street Addresse: City/State/Zip: Phone No: Fax No: Corporate/Partnership Name (type or print): Title (type or print): | Legal Status (please check): | entral trave and the state of t |
| as identified above, will be filed with the City of San Diago on the subject property with the Intent to record an encumbrance saginst the property. Please list below the names, titles and addresses of all persons who have an interest in the property, recorded or otherwise, and state the type of property interest (e.g., tenants who will benefit from the permit, all corporate officers, and all partners in a partnership who own the property. A sload by the property interest (e.g., tenants who will benefit from the permit, all corporate officers or partnership own to be given by the property. Allsuch additional pages if needed. Note: The applicant is responsible for notifying the Project Manager of any changes in ownership during the time the application is being processed of considered. Changes in ownership are to be given to the Project Manager at least thirty days prior to any public hearing on the subject property. Failure to provide accurate and current ownership information could result in a delay in the hearing process. Additional pages attached the property of the property of the property of the property. Failure to provide accurate and current ownership information could result in a delay in the hearing process. Additional pages attached the property of the property of the property. Failure to provide accurate and current ownership information could result in a delay in the hearing process. Additional pages attached the property. Failure to provide accurate and current ownership information could result in a delay in the hearing process. Additional pages attached the property. Failure to property. Failure the property. Failure to pr | | What State? Corporate Identification No. |
| Almeria Investments, LP \tilde{\tiilde{\tilde{\tilde{\tilde{\tilde{\tilde{\tilde{\tilde{\tilde{\tii | as identified above, will be filed with the City of San Dieg the property. Please list below the names, titles and add otherwise, and state the type of property interest (e.g., to in a partnership who own the property). A signature is re property. Attach additional pages if needed. Note: The a ownership during the time the application is being process Manager at least thirty days prior to any public hearing of | on the subject property with the intent to record an encumbrance against dresses of all persons who have an interest in the property, recorded or enants who will benefit from the permit, all corporate officers, and all partners required of at least one of the corporate officers or partners who own the applicant is responsible for notifying the Project Manager of any changes in essed or considered. Changes in ownership are to be given to the Project on the subject property. Failure to provide accurate and current ownership as Additional pages attached Yes No |
| Street Address: PO Box 232628 [City/State/Zip: Encinitas, CA 92023 Phone No: (760) 207-3740 Name of Corporate/Partnership Name (type or print): Corporate/Partnership Name (type or print): Corporate/Partnership Name (type or print): Corporate/Partnership Name (type or print): Corporate/Partnership Name (type or print): Corporate/Partnership Name (type or print): Corporate/Partnership Name (type or print): Corporate/Partnership Name (type or print): Corporate/Partnership Name (type or print): Corporate/Partnership Name (type or print): Corporate/Partnership Name (type or print): Corporate/Partnership Name (type or print): City/State/Zip: Phone No: Fax No: Phone No: Fax No: Name of Corporate Officer/Partner (type or print): Title (type or print): Corporate/Partnership Name (type or print): Corporate/Partnership Name (type or print): Corporate/Partnership Name (type or print): Cover Tenant/Lessee Street Address: Street Address: | | Corporate/Partnership*Name (type or print): |
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| Phone No: Fax No: Phone No: Phone No: Fax No: Phone No: Fax No: Phone No: Phone No: Phone No: Phone No: Phone No: Phone No: Fax No: Phone No: Fa | | Street Address: |
| Phone No: Fax No: (760) 207-3740 Name of Corporate Officer/Partner (type or print): Michael Pulton Title (type or print): General Partner Signature: Date: 09/15/2016 Corporate/Partnership Name (type or print): Corporate/Partnership Name (type or print): Title (type or print): Signature: Date: 09/15/2016 Corporate/Partnership Name (type or print): Corporate/Partnership Name (type or print): Towner Tenant/Lessee Street Address: City/State/Zip: Phone No: Fax No: Phone No: Fax No: Name of Corporate Officer/Partner (type or print): Title (type or print): Title (type or print): Corporate/Partnership Name (type or print): Title (type or print): Corporate/Partnership Name (type or print): Fax No: Phone No: Fax No: Name of Corporate Officer/Partner (type or print): Title (type or print) | | City/State/Zip: |
| Michael Pritton Title (type or print): General Partner Signature: Date: 09/15/2016 Corporate/Partnership Name (type or print): City/State/Zip: Phone No: Fax No: Name of Corporate Officer/Partner (type or print): Title (type or print): Signature: Date: Corporate/Partnership Name (type or print): Title (type or print): Name of Corporate Officer/Partner (type or print): Title (type or print): Title (type or print): Title (type or print): | Phone No: Fax No: | Phone No: Fax No: |
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| City/State/Zip: Phone No: Fax No: Phone No: Fax No: Name of Corporate Officer/Partner (type or print): Name of Corporate Officer/Partner (type or print): Title (type or print): Title (type or print): | Owner Tenant/Lessee | Owner Tenant/Lessee |
| Phone No: Fax No: Phone No: Fax No: Name of Corporate Officer/Partner (type or print): Name of Corporate Officer/Partner (type or print): Title (type or print): | Street Address: | Street Address: |
| Name of Corporate Officer/Partner (type or print): Name of Corporate Officer/Partner (type or print): Title (type or print): | City/State/Zip: | City/State/Zip: |
| Title (type or print): Title (type or print): | Phone No: Fax No: | Phone No: Fax No: |
| | Name of Corporate Officer/Partner (type or print): | Name of Corporate Officer/Partner (type or print): |
| Signature: Date: Date: Date: | Title (type or print): | Title (type or print): |
| | Signature : Date: | Signature : Date: |

State of California

LP-1

201118900001



Secretary of State

endorsed - filed in the office of the Secretary of State of the State of California

JUL 07 2011 A \$70.00 filing fee must accompany this form. Important - Read instructions before completing this form. This Space For Filing Use Only Entity Name (End the name with the words "Limited Pertnership" or the abbreviation "LP" or "LP.") 1. NAME OF LIMITED PARTNERSHIP Almeria Investments, LP Initial Designated Office Address (Do not abbreviate the name of the city.) 2. ADDRESS OF INITIAL DESIGNATED OFFICE IN CALIFORNIA CITY ZIP CODE 2719 Loker Ave., W. Sulte B Carlsbad 92010 initial Agent For Service of Process (if the initial agent is an individual, the agent must reside in California and both items 3 and 4 must be completed. If the Initial agent is a corporation, the agent must have on file with the California Secretary of State a certificate pursuant to Corporations Codo section 1806 and Item 3 must be completed (leave Item 4 blank). 3. NAME OF INITIAL AGENT FOR SERVICE OF PROCESS The Amin Law Group, Ltd. 4. IF AN INDIVIDUAL, ADDRESS OF INITIAL AGENT FOR SERVICE OF PROCESS IN CA CITY STATE ZIP CODE CA General Partners (Enter the names and addresses of all the general partners. Attach additional pages, if necessary.) Ba, NAME ADDRESS CITY STATE ZIP CODE MJF Capital, Inc. 92010 2719 Loker Ave., W. Suite B Carlsbad CA 5b. NAME **ADDRESS** CITY ZIP CODE Additional Information 6. ADDITIONAL INFORMATION SET FORTH ON THE ATTACHED PAGES, IF ANY, IS INCORPORATED HEREIN BY THIS REFERENCE AND MADE A PART OF THIS CERTIFICATE. Execution (This certificate must be signed by all of the general partners. If additional signature space is necessary, the signatures may be made on an attachment to this cortificate.) 7. I DECLARE I AM THE PERSON WHO EXECUTED THIS INSTRUMENT, WHICH EXECUTION IS MY ACT AND DEED. July 6, 2011 DATE Michael Fulton, President of MJF Capital, Inc., GP SIGNATURE OF GENERAL PARTNER TYPE OR PRINT NAME OF GENERAL PARTNER SIGNATURE OF GENERAL PARTNER TYPE OR PRINT NAME OF GENERAL PARTNER LP-1 (REV 01/2010) APPROVED BY SECRETARY OF STATE

I hereby certify that the foregoing transcript of ______ page(s) is a full, true and correct copy of the original record in the custody of the California Secretary of State's office,

JUL 08 2011

Date:

Sm

DEBRA BOWEN, Secretary of State

LP-2 Amendment to Certificate of Limited Partnership (LP)

To change information of record for your LP, fill out this form, and submit for filing along with:

- A \$30 filling fee,
- A separate, non-refundable \$15 service fee, if you drop off the completed form.

Items 3–7: Only fill out the information that is changing. Attach extra pages if you need more space or need to include any other matters.

ATTACHMENT 14

14

FILED

In the Office of the Secretary of State of the State of California

JUN 07 2012

| ges if you need more space or need to include an | y other matters. | This Space F | or Office Use | Only |
|--|---|--|--|---|
| For questions about this form, | go to www.sos.ca.go | v/business/be/filing-tips.htm | n | |
| LP's File No. (issued by CA Secretary of State): 201118900001 | | Name (on file with CA Secr VESTMENTS, LP. | etary of Stal | e): |
| New LP Name: | V4s, A service of the control of August 1911 and the control of th | | | |
| The new contain "b | LP name: must end wi | in "Limited Partnership," "LP "frustee," "incorporated," "inc | ," or "L.P.," | and may no |
| New LP Office Address in California: 817 CLARK AVE | | CINITAS | CA | 9202 |
| street address | | city (no abbreviations) | state | zip |
| New Agent/Address for Service of Process: (a. Agent's name: MICHAEL FULTON | The agent must be a C. | A resident or qualified 1505 | corporation | In CA.) |
| h Agent's aridress: 817 CLARK AVE | F | ENCINITAS | CA | 9202 |
| b. Agent's address: 817 CLARK AVE street address (if agent is not a co | | city (no abbreviations) | state | zip |
| General Partner Changes: | | | | |
| a. New general partner: | Iress | city (no abbreviations) | state | zio |
| ,,,,,,,,,,,,,,,,,,,,,,,,,,,,,,,,,,,,,,, | ress | city (no approvious) | Julia | υp |
| b. Address change: | y add/ess | city (no abbreviations) | state | zip |
| c. Name change: Old name: | N | ew name: | | |
| d. Name of dissociated general partner. | | | | |
| Dissolved LP: (Either check box a or check box b a of Cancellation (Form LP-4/7), available at www.sos.ca. | nd complete the inform | ation. Note: To terminate th | | ile a Cartifica |
| a. The LP is dissolved and wrapping up its affairs | | | | |
| b. The LP is dissolved and has no general part | ners. The following pe | erson has been appointed | to wrap up | the affairs |
| the LP: | | | · | *************************************** |
| | | city (no abbreviations) | stata | 到的 |
| Read and sign below: This form must be signed and (3) by each person listed in item 6d if that person thecked, the person listed must sign, if a trust, assoct a www.ses.ca.gov/business/be/filing-tips.htm for multi-sided and an standard letter-sized paper (8 1/2° x 1). | on has not filed a Cer clation, attorney-in-fact ore information. If you in the stack of the sta | tificate of Dissociation (Fo t, or any other person not l ou need more space, atti are part of this amendment | rm LP-101) Isted above ach extra p | i. Ir dem 70 i is signing, |
| I declare that Lam the person who signed this | is form and that sig | ining this form is my a | ict. | 11 |
| | | , president of MJF Capi | | 19/12 |
| Sign here | Print your name | | Da | ble 7' |
|) . | parada wing-dispersance and a superior dispersance and a superior dispersan | and the state of t | ***** | |
| Sign here | Print your name | here | De | ate |
| ke check/money order payable to: Secretary of State | By N | fall . | Droj | o-Off |
| can give you up to 2 free certified copies of ir filed form if you submit up to 2 completed pies of this form (with all attachments). | Secretary Business Entities, f Sacramento, C | P.O. Box 944225, | Secretar 1500 11th S Secramento | |

State of California

Secretary of State

CERTIFICATE OF STATUS

ENTITY NAME: ALMERIA INVESTMENTS, LP

FILE NUMBER:

201118900001

FORMATION DATE:

07/07/2001

TYPE:

DOMESTIC LIMITED PARTNERSHIP

JURISDICTION:

CALIFORNIA

STATUS:

ACTIVE (GOOD STANDING)

I, DEBRA BOWEN, Secretary of State of the State of California, hereby certify:

The records of this office indicate the entity is authorized to exercise all of its powers, rights and privileges in the State of California.

No information is available from this office regarding the financial condition, business activities or practices of the entity.



IN WITNESS WHEREOF, I execute this certificate and affix the Great Seal of the State of California this day of July 30, 2012.

DEBRA BOWEN Secretary of State

Secretary of State Business Programs Division

Business Entities - Records, P.O. Box 944260, Sacramento, CA 94244-2600

July 30, 2012

MICHAEL FULTON

RE: ALMERIA INVESTMENTS, LP 201118900001

This letter is in response to your request for information.

The 'not to exceed' or blank check submitted with your request has been completed in the amount of \$6.50.

Certification and Records Business Entities Section

All ideas, arrangements, drawings and plans set

forth on this sheet are the original work product of, owned by and are the property of **dbr**ds and

use of this said work product is limited to a

PROPOSED INDIVIDUAL R-3 TOWN HOMES

4200 TONOPAH AVENUE, SAN DIEGO, CA 92110

LEGAL DESCRIPTION (APN: 430-680-90-00):

The southwesterly 100.00 feet (as measured at right angles from the southwesterly line of lot 5) of all that portion of lot 5 of pueblo lot 255, in the City of San Diego, County of San Diego, State of California; according to referee's partition map filed in the action of Morena Company, a corporation, vs. Franklin Steel, Jr., case no. 3475, filed in the superior court of the County of San Diego, lying southwest of the center line of Asher street, as said street existed on January 21, 1944.

Excepting therefrom the following parcels: A. That portion of said lot, if any, lying within the right-of-way of the Atchison, Topeka and Sante Fe railway.

- B. That portion described in the deed to the City of San Diego recorded March 23, 1956, in book 6029, page 122 of official records. C. That portion lying southeasterly of a line which is parallel with and distant 101.5 feet northwesterly from the southeasterly line of block 17 of first addition to Asher's cloverleaf terrace, according to map thereof no. 1666, filed in the office of the county recorder, and the northeasterly prolongation of said southeasterly line, and lying northeasterly of the northwesterly prolongation of the southwest line of lot
- 17 in block 17 of said first addition to Asher's cloverleaf terrace. D. That portion lying within Lahoud terrace, according to map thereof no. 3134, filed in the office of the county recorder of San Diego County, October 4, 1954.

1. DEMOLITION OF EXISTING SINGLE FAMILY RESIDENCE AND DETACHED GARAGE (YEAR BUILT: 1937)

- 2. CONSTRUCTION OF THIRTEEN (13) NEW R-3 CLASS 3 STORY TOWN HOMES (OF WHICH 1 WILL BE AFFORDABLE - VERY LOW INCOME)
- 3. LANDSCAPE IMPROVEMENTS

SCOPE OF WORK

XX

_ DETAIL NUMBER

SHEET LOCATION

- SHEET LOCATION

KEYNOTE

. WALL SECTION NUMBER

- (REMOVED)
- SUBMITTAL OF NEW TENTATIVE MAP

SITE DEVELOPMENT AND NEIGHBORHOOD DEVELOPMENT PERMIT

THIRTEEN (13) R-3 CLASS INDIVIDUAL TOWN HOMES

REVISION CLOUD

<4 | WALL TAG

_ MATERIAL TAG

FINISHED FLOOR ELEVATION

DRAWINGS SHALL BE BUILT TO COMPLY WITH CBC 2013 & ALL OTHER GOVERNING BUILDING & ADA CODES.

OVERLAPPING AND CONFLICTING REQUIREMENTS: Where compliance with 2 or more industry standards or sets of requirements is specified, and overlapping of those different standards or requirements establishes different or conflicting minimums or levels of quality, most stringent requirement (which is generally recognized to be also most costly) is intended and will be enforced, unless specifically detailed language written into contract documents (not by way of reference to an industry standard) clearly indicates that a less stringent requirement is to be fulfilled. Refer apparently-equal-but-different requirements, and uncertainties as to

which level of quality is more stringent, to architect/contractor for a decision before proceeding.

ALL ASPECTS OF THIS PROJECT REGARDLESS OF INCLUSIVE OR NOT WITHIN BUILDING PERMIT SUBMITTAL

MINIMUM QUALITY/QUANTITY:

In every instance, quality level or quantity shown or specified is intended as minimum for the work to be performed or provided, except as otherwise specifically indicated, actual work may either comply exactly with that minimum (within specified tolerances), or may exceed that minimum within reasonable limits. In complying with requirements, numeric values are either minimums or maximums as noted or as appropriate for context of requirements. Refer instances of uncertainty to architect for decision before proceeding.

NOTE TO CONTRACTOR:

Where contract documents (drawings and specifications) are incomplete, ambiguous or contain conflicting instructions, do not proceed until receiving clarification from the architect and designer in writing. Contractor to verify all dimensions in

FAA SELF-CERTIFICATION:

WATER:

SEWER:

DRAINAGE:

GENERAL NOTES

APPLICABLE CODES: CALIFORNIA RESIDENTIAL CODE, 2016 EDITION

do hereby certify that the structure(s) or modification to existing structures shown on these plans do not require Federal Aviation Administration notification because per Section 77.15(A) of Title 14 of the Code of Federal Regulations CFR Part 77, notification is not required."

CALIFORNIA BUILDING CODE (CBC), 2016 EDITION

CALIFORNIA PLUMBING CODE (CPC), 2016 EDITION

CALIFORNIA ELECTRICAL CODE (CEC), 2016 EDITION

CALIFORNIA GREEN BUILDING CODE, 2016 EDITION

BY CONNECTION TO EXISTING LOCATED IN MORENA BLVD

BY GRAVITY THROUGH PROPOSED GRADING TO MORENA BLVD

REGULATIONS AND ORDINANCES

BY GRAVITY TO EXISTING IN LIETA ST

OF THE CITY OF SAN DIEGO

(SEE CIVIL SHEET)

CALIFORNIA MECHANICAL CODE (CMC), 2016 EDITION

A1.00 Existing Site Plan | Demolition Plan CIVIL - CIVIL LANDWORKS Topographic Survey Tentative Map DESIGN - DE BARTOLO RIMANIC DESIGN STUDIO A1.01 Proposed Site Plan Fire Access Plan A1.03 Enlarged Site Plan A1.04 Pedestrian/Vehicular Access Plan Floor Plan | Level 1 A2.11 Floor Plan | Level 2 A2.12 Floor Plan | Level 3 A2.13 Roof Plan A3.00 Elevations | Building 1 Elevations | Building 2 A3.02 Site Elevations

DESIGN - DE BARTOLO RIMANIC DESIGN STUDIO

Development Calculations | FAR Diagrams

Title Sheet

Site Context Photos

Sections Materials Board

LANDSCAPE - STONE & GROVE LANDSCAPE ARCHITECTS

Planting Plan L-2 Planting Plan

Square Footage Plan L-3

LOCALITY MAP

PROJECT TITLE

SITE AREA: 26,800 SQ.FT. ZONING: RS-1-7 / CC-4-5

OVERLAYS: AIRPORT INFLUENCE AREA CLAIREMONT MESA HEIGHT LIMIT FAA PART 77 NOTIFICATION AREA

EXISTING USE: EXISTING SINGLE FAMILY HOUSE (TO BE DEMOLISHED) (YEAR BUILT):

GEOLOGICAL HAZARD CATEGORY: 53

PROPOSED USE: TYPE OF CONSTRUCTION: TYPE V-B

LOT AREA:

RS-1-7 CC-4-5 14,800sf (SEE A1.00) 12,000sf (SEE A1.00)

HEIGHT: 24'/30' ALLOWED 30' ALLOWED 30'-0" PROPOSED (PARAPET) 30'-0" PROPOSED (PARAPET) FRONT SETBACK: 6'-0" REQUIRED

SIDE SETBACK: 0.08 x LOT WIDTH (100'-0") 8'-0" MIN. REQUIRED

10'-0" or 0' 26'-0" and 5'-0' PROPOSED

4,442sf - LEVEL 1

REAR SETBACK 10'-0" PROPOSED FAR: 2.0 (24,000sf) ALLOWED 0.5 (7,400sf) ALLOWED

7,451sf - LEVEL 1

10'-2" & 5'-0" PROPOSED

4,032sf - LEVEL 2 7,187sf - LEVEL 2 7,141sf - LEVEL 3 4,012sf - LEVEL 3 1.47 FAR (21,779sf) 1.04 FAR (12,486sf)

TOTAL FAR ALLOWED: 31,400sqft (COMBINED ZONES)

TOTAL PROPOSED FAR: 34,265sqft (COMBINED ZONES)

NO REQUIREMENTS (41.49% PROPOSED) MIN. LOT COVERAGE: 35% (52.16% PROPOSED)

679sqft (REFER TO LANDSCAPE SHEETS) LANDSCAPE AREA: PARKING: 10 3-BED x 2.25 SPACES = 22.5 SPACES REQUIRED 2 2-BED x 2.0 SPACES = 4 SPACES REQUIRED

1 2-BED (AFFORDABLE) x 1.3 SPACES

27.8 SPACES TOTAL REQUIRED

28 SPACES PROPOSED

AFFORDABLE HOUSING: CC-4-5 ZONE: 1 UNIT / 1,500sqft (RESIDENTIAL DENSITY) 12,000sqft/1500sqft = 8 UNITS ALLOWED (MAX PRE-BONUS DENSITY = 9 UNITS)

11.1% VERY LOW INCOME ALLOWS FOR A 35% DENSITY BONUS

 $9 \times 12\% = 1.0 = 1 \text{ VERY LOW INCOME UNIT}$

9 DWELLING UNITS x 1.35 = 12.15, ROUNDED UP TO 13 13 TOTAL DWELLING UNITS ALLOWED

INCENTIVES: 1. PROPOSED 5'-0" SIDE SETBACK IN RS-1-7 ZONE (8'-0" REQUIRED) (2 ALLOWED) 2. PROPOSED FAR OF 34,265sqft IN COMBINED ZONES (31,400sqft MAX. REQUIRED)

DEVIATIONS: 1. DEVIATION FROM THE 30-DEGREE ANGLED BUILDING ENVELOPE PLANE ALONG SIDE SETBACK LINES FOR STRUCTURES WITHIN THE RS ZONE. 131.0444(c)

2. DEVIATION FROM THE COMMERCIAL COMPONENT REQUIRED FOR THE CC-4-5 ZONE TO ALLOW FOR RESIDENTIAL DEVELOPMENT. 131.0540(b)

3. DEVIATION FROM THE CC-4-5 SIDE SETBACK 0' OPTION TO ALLOW FOR A 5'-0" OPTION.

ARCHITECTURAL LEGEND

NEW DOOR/WINDOW NUMBER

- CEILING HEIGHT A.F.F.

CODE SUMMARY

GAS + ELECTRICAL: SDG&E

SHEET LIST

SHEET LIST

A0.00

A0.10

A0.20



specified project of the purchaser, and for the construction of one building, any use, reuse or disclosure of said plans, reproductions, ideas, lesigns and/or arrangements, other than by **dbr**ds, is strictly prohibited by law without the written permission of **dbr**ds. Written dimensions on these drawings shall have precedence over scaled dimensions; contractors shall verify, and be responsible for all dimensions and conditions on the job and this office must be notified of any variations from the dimensions and conditions shown these drawings.

> **DBR**DS DE BARTOLO + RIMANIC DESIGN STUDIO

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PROJECT TEAM

ALMERIA INVESTMENTS. LP

ENCINITAS, CA 92023 (760) 207-3740 PHONE: CONTACT: MICHAEL FULTON EMAIL: michael@almeriainvestments.com

DESIGN:

PO BOX 232628

DE BARTOLO + RIMANIC DESIGN STUDIO 363 5TH AVE, SUITE 203

SAN DIEGO CA 92101 PHONE: (858) 220 5262 CONTACT: PAULY DE BARTOLO EMAIL: pauly@dbrds.com

CIVIL & LAND SURVEYING

CIVIL LANDWORKS 110 COPPERWOOD WAY, SUITE P OCEANSIDE, CA 92058

CONTACT: DAVE CARRON, PE EMAIL: dave@civillandworks.com

ANDSCAPE ARCHITECT

STONE + GROVE LANDSCAPE ARCHITECTS 200 N CEDROS AVE

SOLANA BEACH, CA 92705

CONTACT: **BRIÁN GROVE** brian@stone-grove.co

GEOTECHNICAL ENGINEER **CHRISTIAN WHEELER ENGINEERING**

1980 HOME AVE SAN DIEGO, CA 92105

(619) 550-1700 CONTACT: DAVID R. RUSSELL

drussell@christianwheeler.com

FIRE PIPING CONSULTANT

PROTECTION DESIGN AND CONSULTING 851 CAMINO DEL RIO S. #210 SAN DIEGO, CA 92108

CONTACT: STEVE LEYTON steve@protectiondesign.com

10.18.2017 DRAWN BY: CH SDP & NDP - CYCLE ISSUES 2 01.08.2018 | DRAWN BY: CH SDP & NDP - CYCLE ISSUES 3

DRAWN BY: CH 11.14.2018 SDP & NDP - CYCLE ISSUES 4

05.28.2019 | DRAWN BY: CH SDP & NDP - CYCLE ISSUES 5 09.12.2019 | DRAWN BY: CH SDP & NDP - CYCLE ISSUES 6

06.12.2020 DRAWN BY: CH HISTORIC REVISIONS

TITLE SHEET

DRAWING TITLE:


PROPOSED INDIVIDUAL r-3 class town homes

4200 TONOPAH AVE SAN DIEGO, CA 92110

15066 DBRDS PROJECT NO: SEPTEMBER 2016 CH <u>DRAWN BY</u> A0.00

DEVELOPMENT SUMMARY

RENDERING (VIEW FROM THE SOUTHWEST)

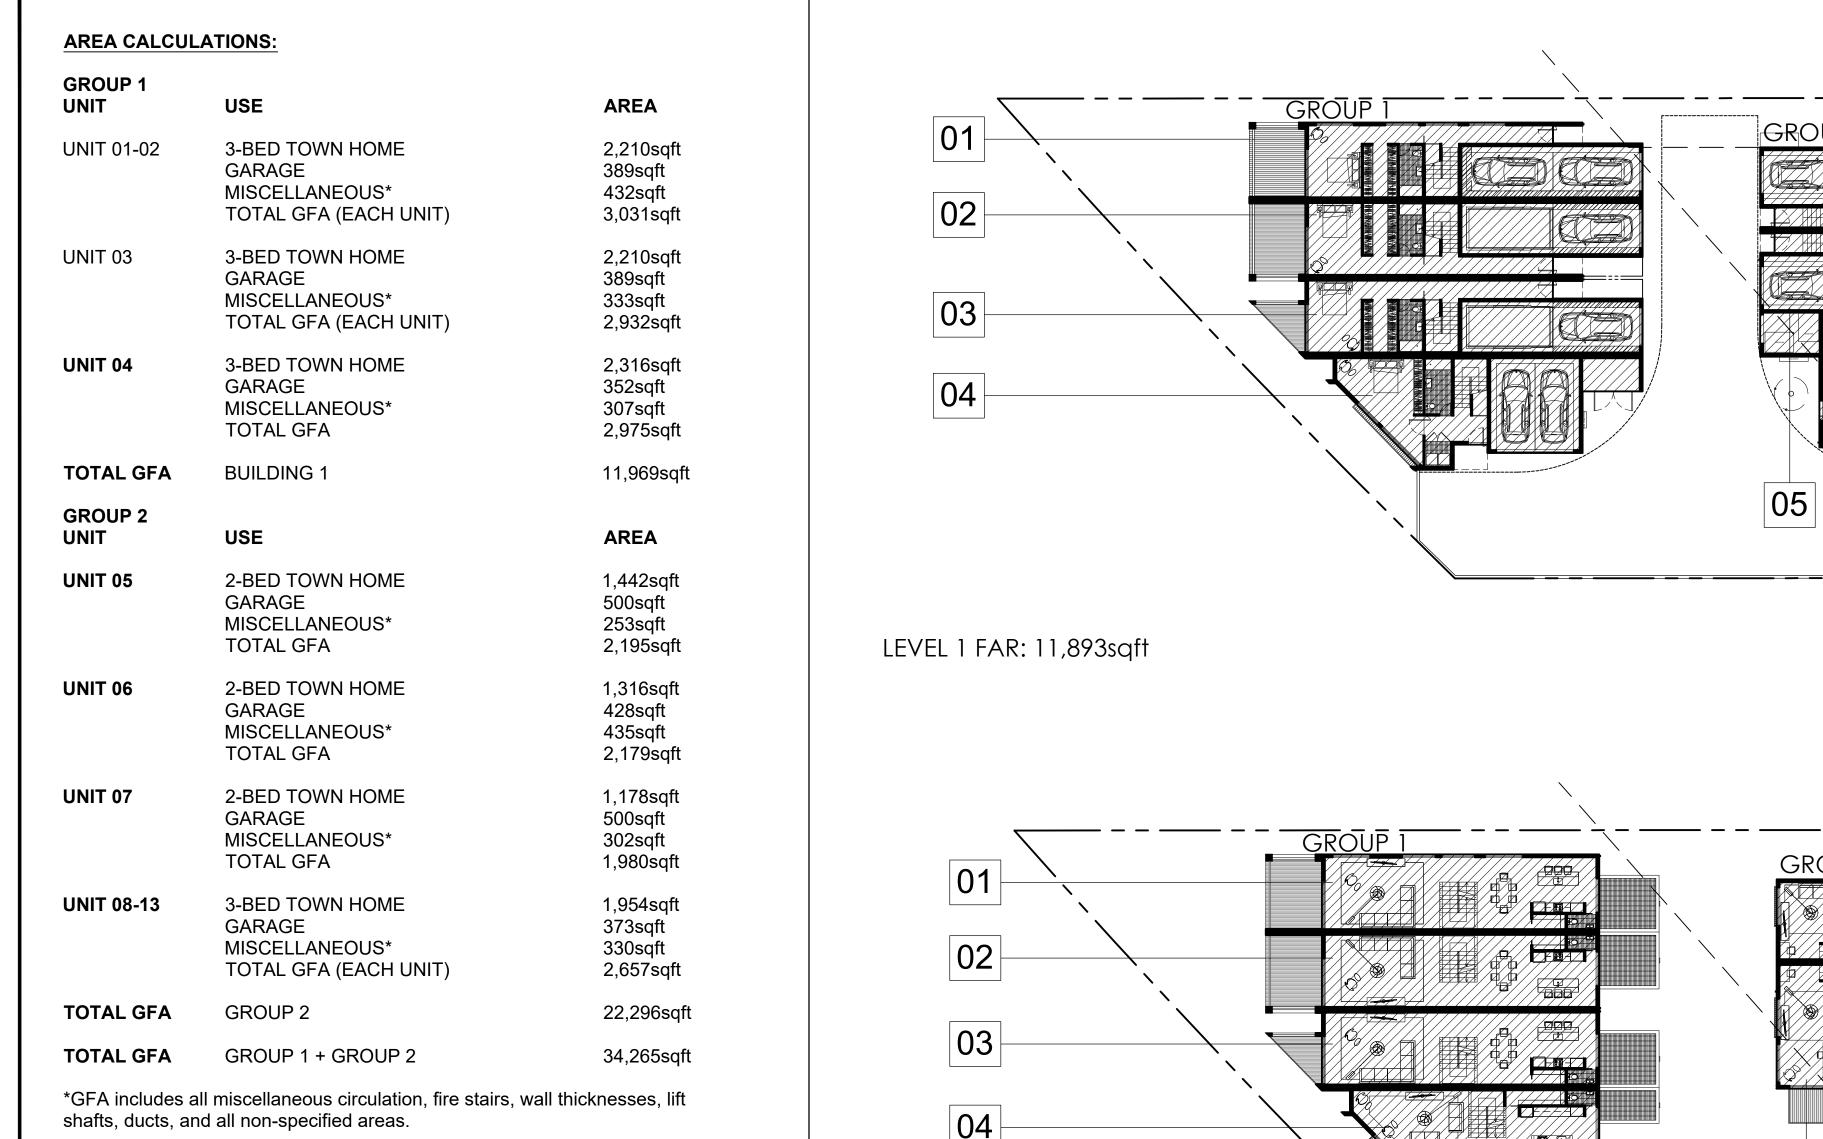

PRIVATE BALCONY CALCULATIONS:

GROUP 1 AREA 617sqft **TOWN HOME TOWN HOME 01-02 BALCONIES BALCONIES** 300sqft **TOWN HOME 03 BALCONIES TOWN HOME 04** 137sqft **GROUP 2 TOWN HOME AREA** 140sqft **TOWN HOME 05** BALCONIES BALCONIES **TOWN HOME 06** 130sqft **TOWN HOME 07 BALCONIES** 4sqft **BALCONIES** 207sqft **TOWN HOME 08-13**

BALCONIES

TOWN HOME BREAKDOWN:

TOTAL

| No. | UNIT TYPE | INT. AREA | EXT. AREA |
|---|--|---|---|
| TH 01-02 TH 03 TH 04 TH 05 TH 06 TH 07 TH 08-13 | 3 BEDROOM + GARAGE 3 BEDROOM + GARAGE 3 BEDROOM + GARAGE 2 BEDROOM + GARAGE 2 BEDROOM + GARAGE 2 BEDROOM + GARAGE 3 BEDROOM + GARAGE | 2,618sqft (EACH) 2,618sqft 2,679sqft 1,956sqft 1,744sqft 1,678sqft 2,327sqft (EACH) | 300sqft 137sqft 140sqft 130sqft 4sqft |
| | | | |


3,187sqft

TOTAL No. TOWN HOMES = 13 (10 x 3 BEDROOM + 3 x 2 BEDROOM)


AVERAGE TOWN HOME SIZE INT. AREA EXT. AREA 2 BEDROOM 91sqft 1,793sqft 3 BEDROOM 2,450sqft 291sqft

TOTAL AVERAGE TOWN HOME SIZE 2,298sqft

245sqft 70% OF AVERAGE TOWN HOME SIZE 1,607sqft

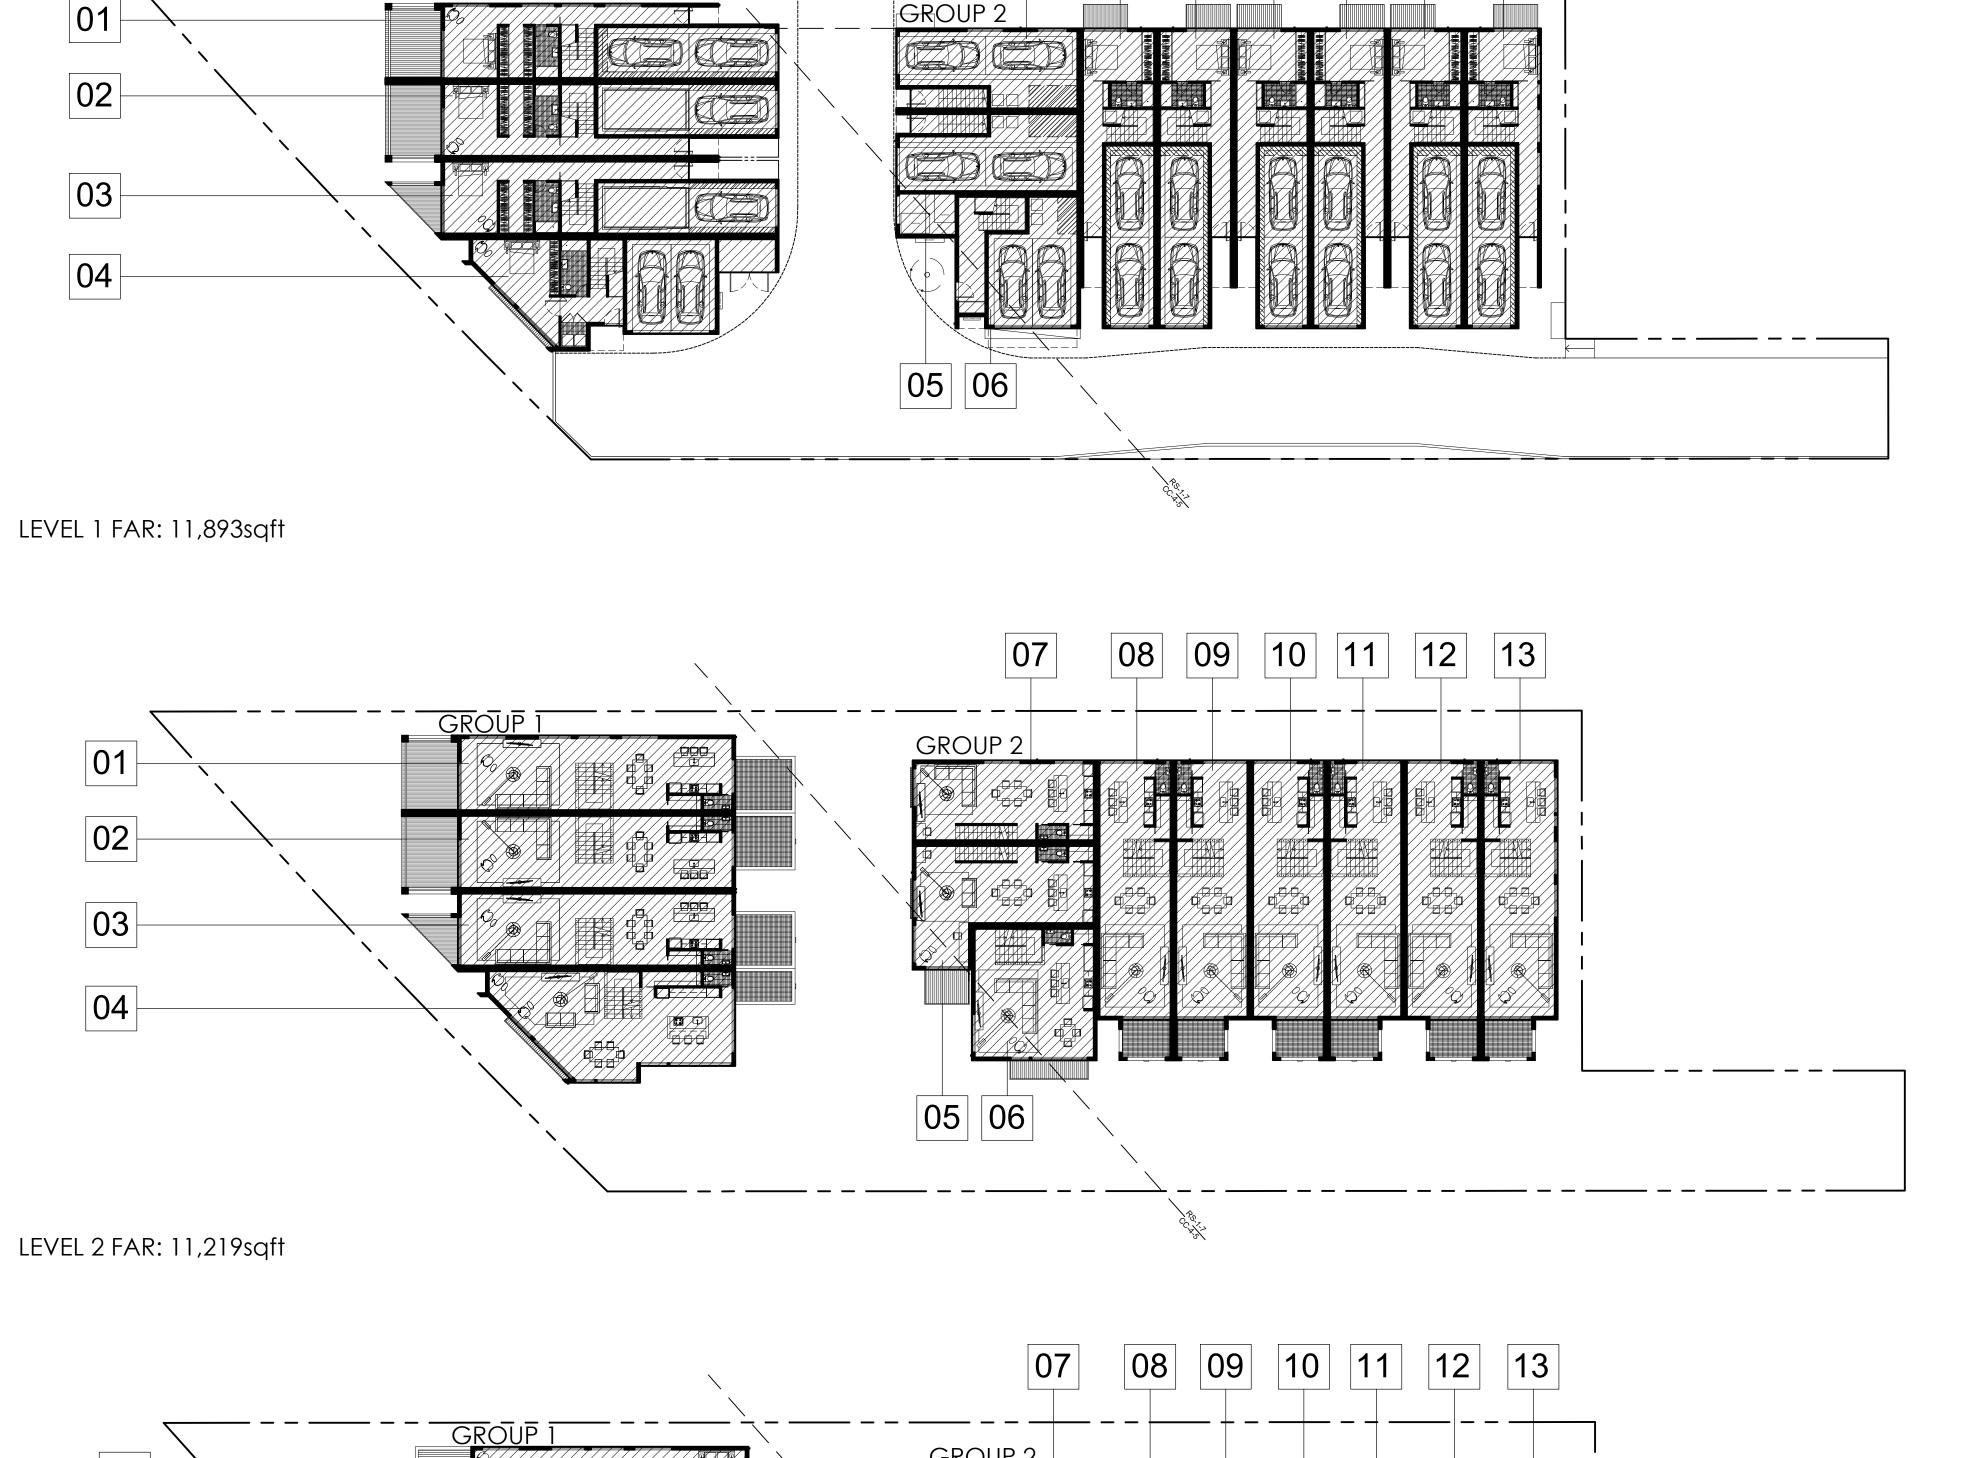

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All ideas, arrangements, drawings and plans set forth on this sheet are the original work product of, owned by and are the property of **dbr**ds and use of this said work product is limited to a specified project of the purchaser, and for the construction of one building, any use, reuse or disclosure of said plans, reproductions, ideas, lesigns and/or arrangements, other than by dbrds, is strictly prohibited by law without the written permission of **dbr**ds. Written dimensions on these drawings shall have precedence over scaled dimensions; contractors shall verify, and be responsible for all dimensions and conditions on the job and this office must be notified of any variations from the dimensions and conditions
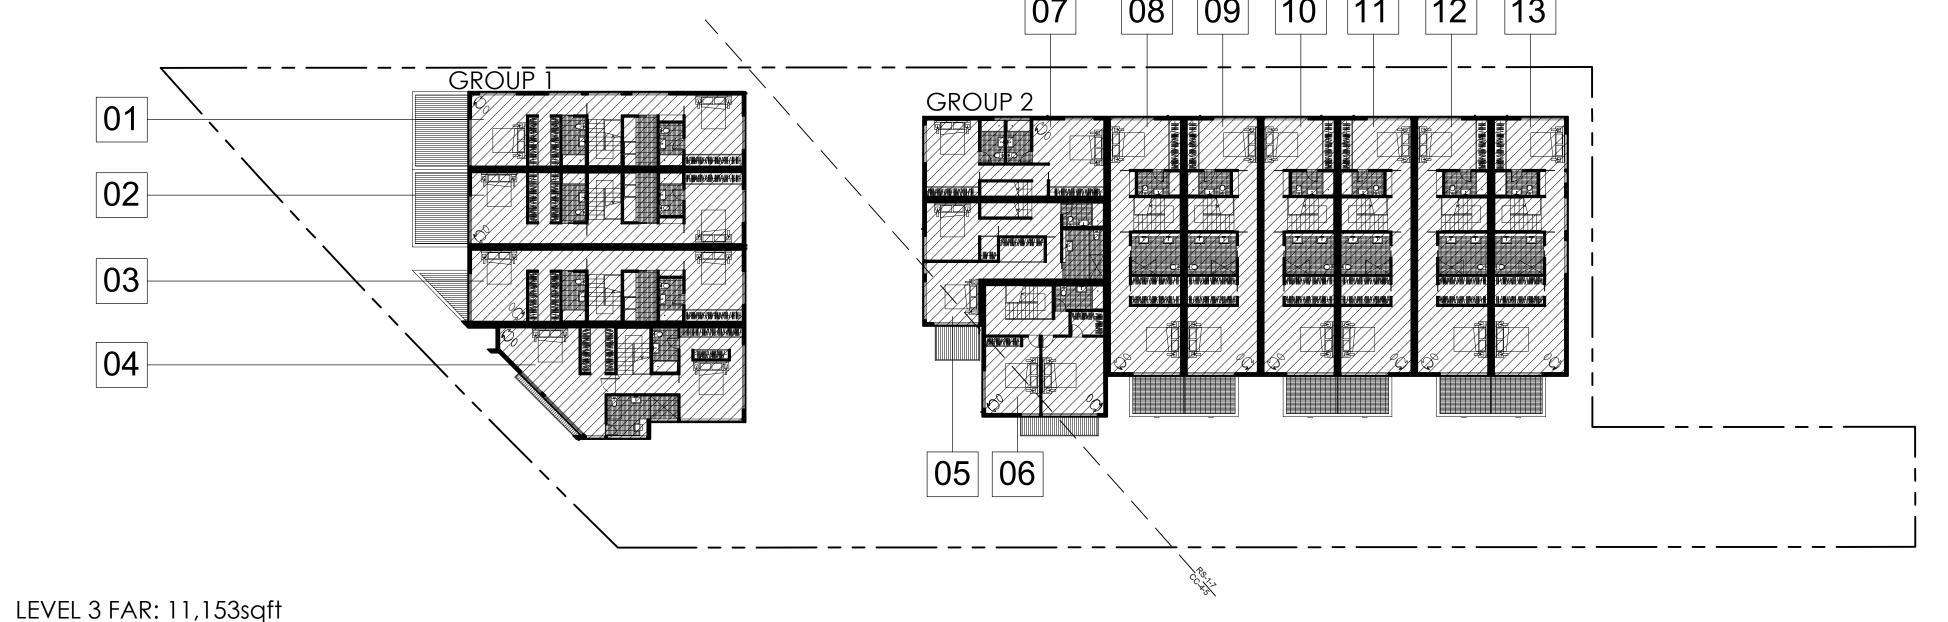
> **DBR**DS DE BARTOLO + RIMANIC DESIGN STUDIO

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A0.10

PROJECT TEAM

OWNER:

ALMERIA INVESTMENTS, LP PO BOX 232628

shown these drawings.

ENCINITAS, CA 92023 PHONE: (760) 207-3740

MICHAEL FULTON michael@almeriainvestments.com

DESIGN:

EMAIL:

CONTACT:

DE BARTOLO + RIMANIC DESIGN STUDIO

363 5TH AVE, SUITE 203 SAN DIEGO CA 92101

PHONE: (858) 220 5262 CONTACT: PAULY DE BARTOLO EMAIL: pauly@dbrds.com

CIVIL & LAND SURVEYING

CIVIL LANDWORKS

110 COPPERWOOD WAY, SUITE P OCEANSIDE, CA 92058

(760) 908-8745 CONTACT: DAVÉ CARRON, PE

ANDSCAPE ARCHITECT

STONE + GROVE LANDSCAPE ARCHITECTS

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FIRE PIPING CONSULTANT

PROTECTION DESIGN AND CONSULTING

2851 CAMINO DEL RIO S. #210 SAN DIEGO, CA 92108

CONTACT: STEVE LEYTON

steve@protectiondesign.com

REVISION:

10.18.2017 DRAWN BY: CH SDP & NDP - CYCLE ISSUES 2

01.08.2018 DRAWN BY: CH

SDP & NDP - CYCLE ISSUES 3

DRAWN BY: CH 11.14.2018 SDP & NDP - CYCLE ISSUES 4

05.28.2019 DRAWN BY: CH

SDP & NDP - CYCLE ISSUES 5

09.12.2019 DRAWN BY: CH

SDP & NDP - CYCLE ISSUES 6 06.12.2020 DRAWN BY: CH

HISTORIC REVISIONS

DRAWING TITLE: DEVELOPMENT CALCS.

& FAR DIAGRAMS

PROPOSED INDIVIDUAL R-3 CLASS TOWN HOMES

4200 TONOPAH AVE, SAN DIEGO, CA 92110

15066 DBRDS PROJECT NO: SEPTEMBER 2016 CH DRAWN BY: 1" = 20'-0" SCALE:

SHEET NO:

DEVELOPMENT CALCULATIONS

FAR DIAGRAMS

TOTAL FAR: 34,265sqft (31,400sqft REQUIRED, INCENTIVE 2)

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michael@almeriainvestments.com



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15066


CH


1/16" = 1'-0"

A0.20

SEPTEMBER 2016

ATTACHMENT 15 All ideas, arrangements, drawings and plans set forth on this sheet are the original work product of, owned by and are the property of **dbr**ds and use of this said work product is limited to a specified project of the purchaser, and for the construction of one building, any use, reuse or disclosure of said plans, reproductions, ideas, designs and/or arrangements, other than by dbrds, is strictly prohibited by law without the written permission of **dbr**ds. Written dimensions on these drawings shall have precedence over scaled dimensions; contractors shall verify, and be responsible for all dimensions and conditions on the job and this office must be notified of any variations from the dimensions and conditions shown these drawings. 90 **DBR**DS ADJACENT PROPERTY DE BARTOLO + RIMANIC DESIGN STUDIO ZONE: RM-2-5 PROJECT TEAM OWNER: ALMERIA INVESTMENTS, LP PO BOX 232628 ENCINITAS, CA 92023 (760) 207-3740 CONTACT: MICHAEL FULTON michael@almeriainvestments.com DESIGN: EXISTING SINGLE FAMILY STRUCTURE DE BARTOLO + RIMANIC DESIGN STUDIO TO BE DEMOLISHED 363 5TH AVE, SUITE 203 SAN DIEGO CA 92101 (858) 220 5262 PAULY DE BARTOLO CONTACT: EMAIL: pauly@dbrds.com CIVIL & LAND SURVEYING CIVIL LANDWORKS N85°07'57"E (R) ADJACENT PROPERTY N53'21'00"W 298.18' 110 COPPERWOOD WAY, SUITE P OCEANSIDE, CA 92058 ZONE: RS-1-7 (760) 908-8745 CONTACT: DAVÉ CARRON, PE EMAIL: dave@civillandworks.com LANDSCAPE ARCHITECT STONE + GROVE LANDSCAPE ARCHITECTS 200 N CEDROS AVE SOLANA BEACH, CA 92705 CONTACT: BRIÁN GROVE ZONE CC-4-5 brian@stone-grove.co - EXISTING STREET CORNER CONDITION TO BE IMPROVED 12,000sqft EXISTING GARAGE (SEE PROPOSED SITE PLAN, A1.01) GEOTECHNICAL ENGINEER TO BE DEMOLISHED CHRISTIAN WHEELER ENGINEERING 3980 HOME AVE SAN DIEGO, CA 92105 ZONE RS-1-7 14,800sqft N53*21'00"W 67.22' (619) 550-1700 CONTACT: EMAIL: DAVÍD R. RUSSELL drussell@christianwheeler.com VEHICLE ACCESS FIRE PIPING CONSULTANT **TONOPAH AVE** PROTECTION DESIGN AND CONSULTING 2851 CAMINO DEL RIO S. #210 SAN DIEGO, CA 92108 CONTACT: STEVE LEYTON steve@protectiondesign.com REVISION: NEIGHBORHC 10.18.2017 DRAWN BY: CH SDP & NDP - CYCLE ISSUES 2 01.08.2018 DRAWN BY: CH SDP & NDP - CYCLE ISSUES 3 11.14.2018 DRAWN BY: CH - CITY OF SAN DIEGO SDP & NDP - CYCLE ISSUES 4 ZONING LINE 05.28.2019 DRAWN BY: CH SDP & NDP - CYCLE ISSUES 5 09.12.2019 DRAWN BY: CH SDP & NDP - CYCLE ISSUES 6 06.12.2020 DRAWN BY: CH HISTORIC REVISIONS DRAWING TITLE: OPMENT EXISTING SITE PLAN PROPOSED INDIVIDUAL R-3 CLASS TOWN HOMES ADJACENT PROPERTY ZONE: CP-1-1 4200 TONOPAH AVE, 山 SAN DIEGO, CA 92110 DBRDS PROJECT NO: 15066 SEPTEMBER 2016 CH DRAWN BY: 1" = 20'-0" EXISTING SITE PLAN A1.00 SHEET NO:

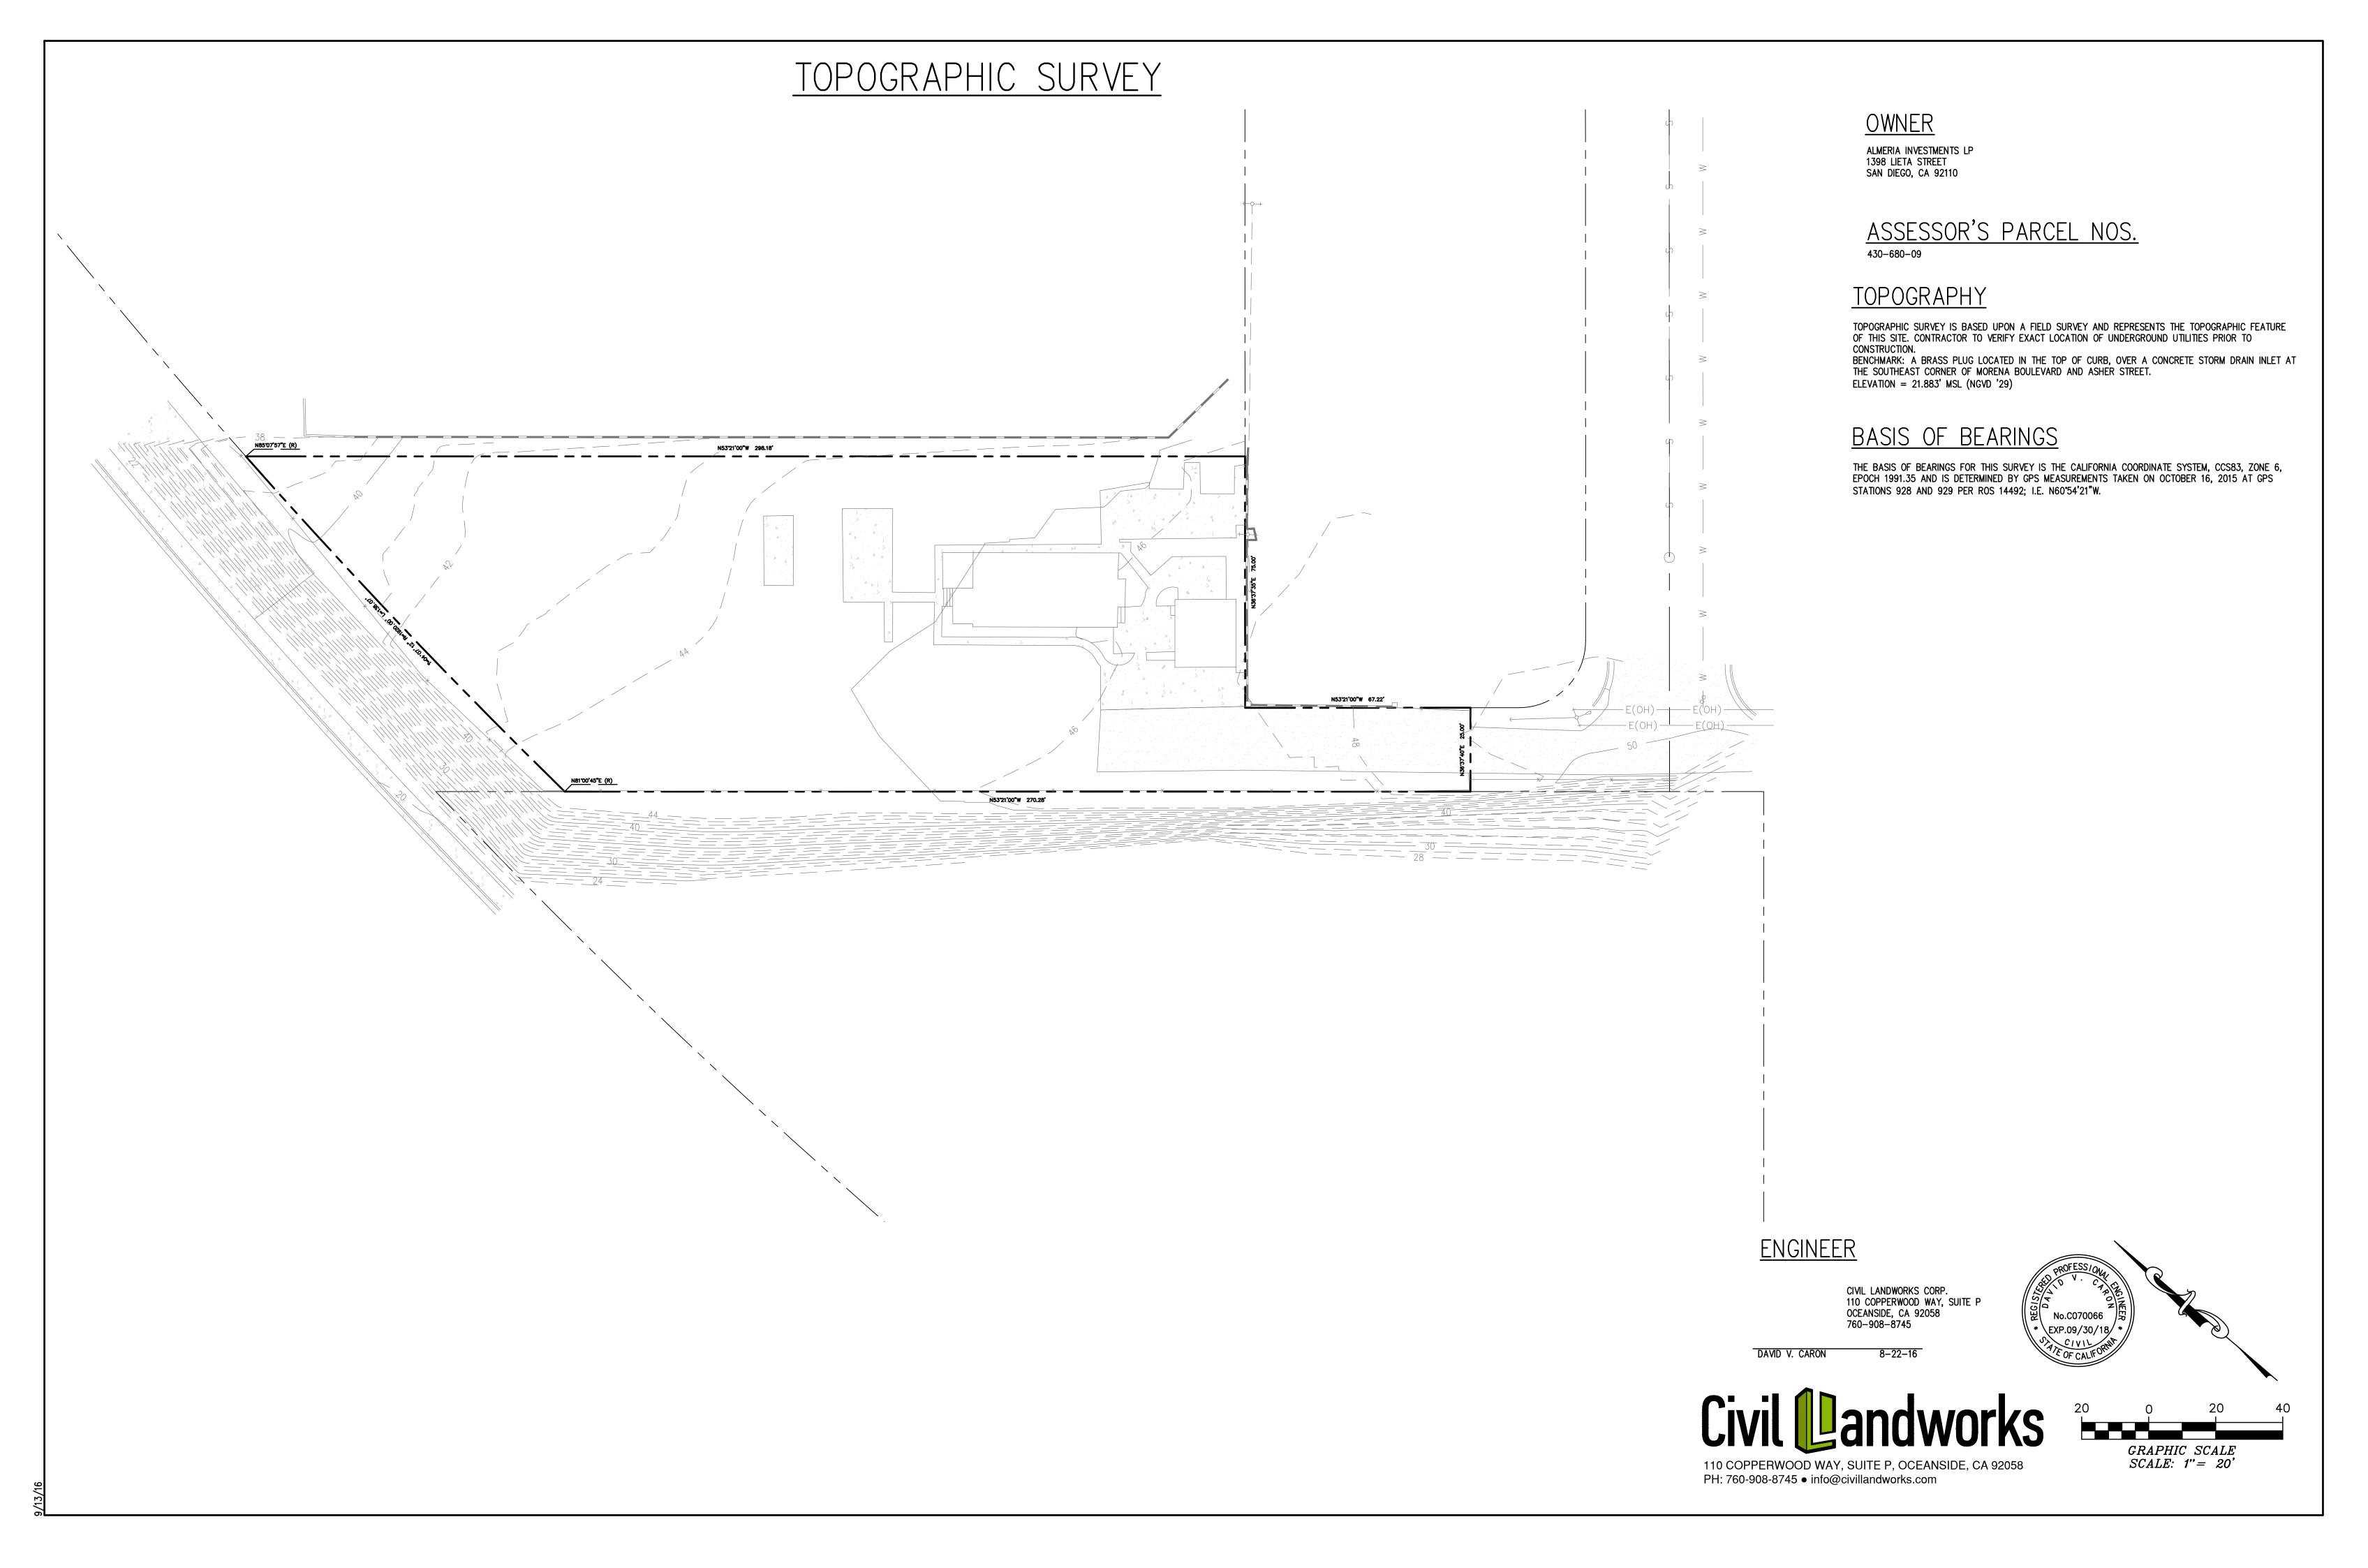

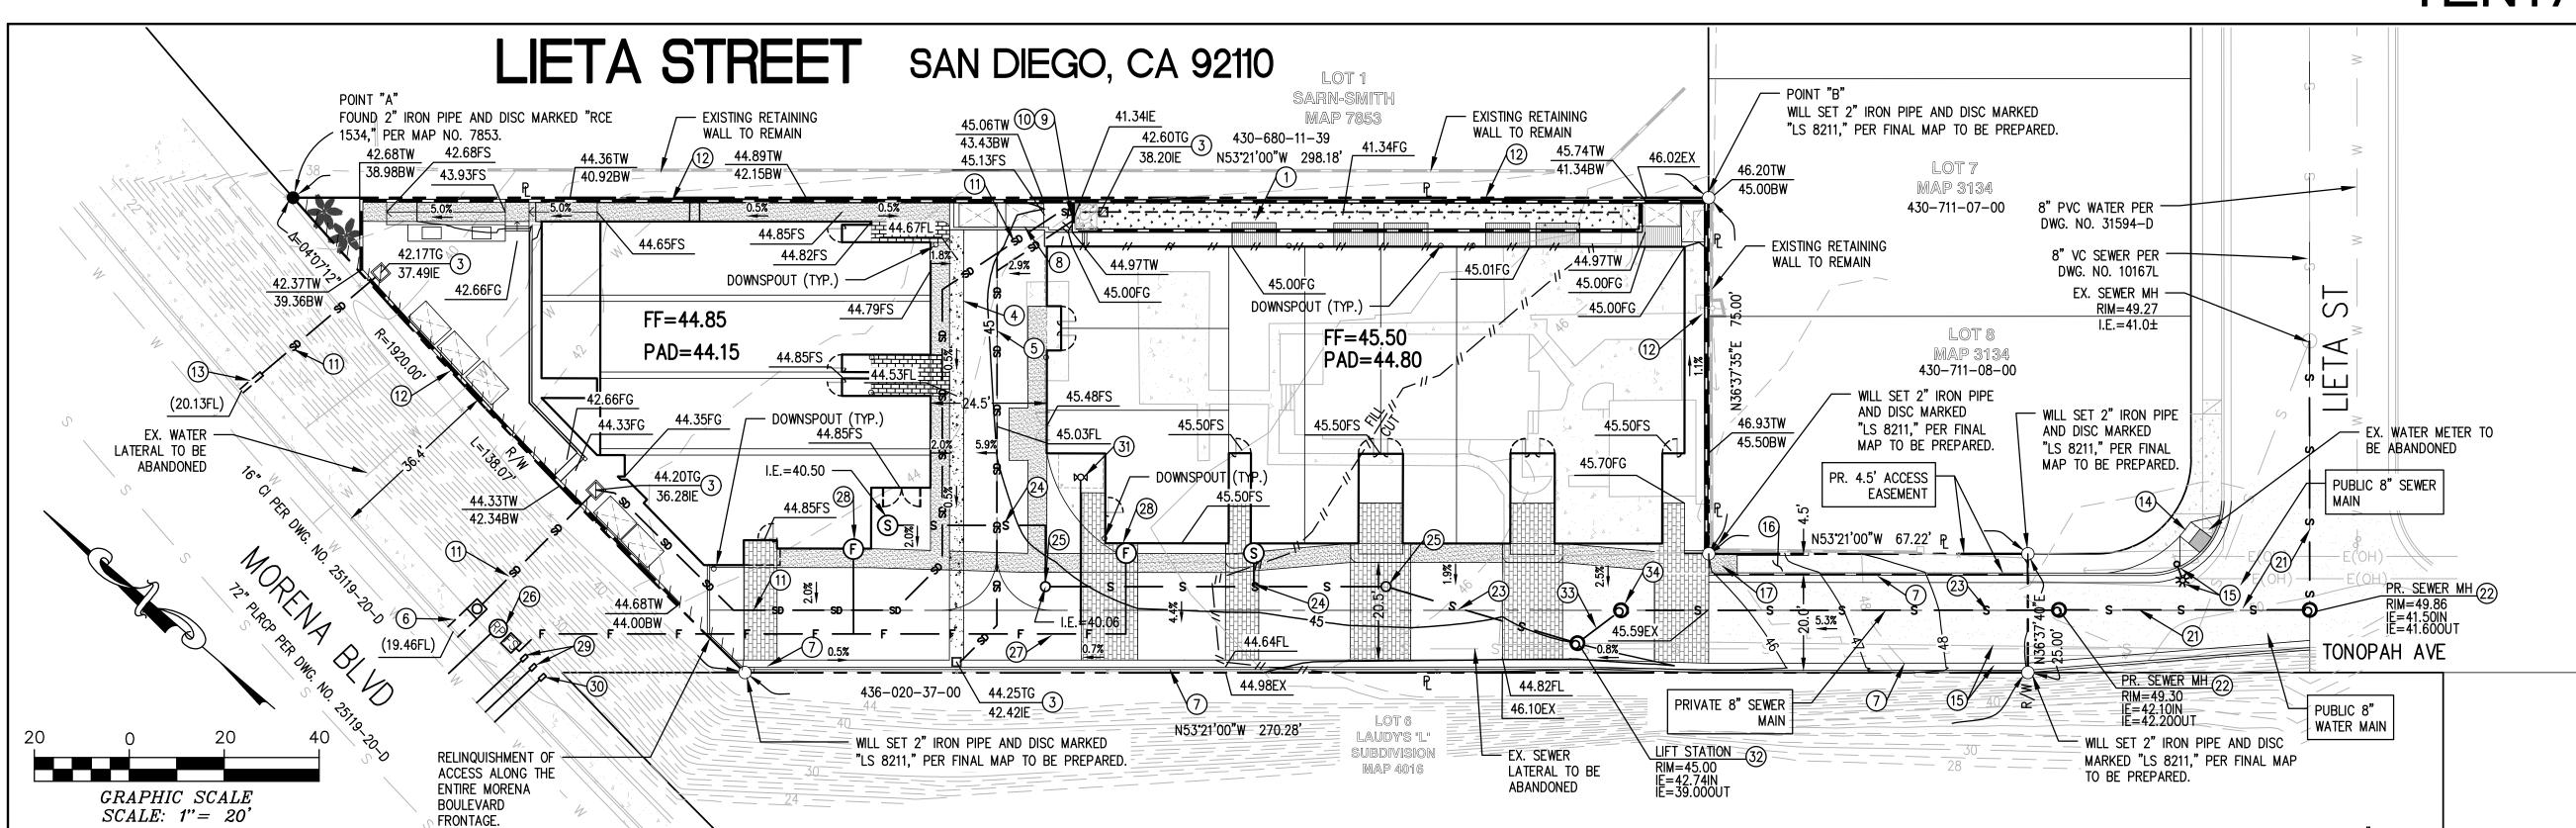

CONDOMINIUM NOTE

THIS IS A MAP OF A CONDOMINIUM PROJECT AS DEFINED IN SECTION 4125 OF THE CIVIL CODE OF THE STATE OF CALIFORNIA AND IS FILED PURSUANT TO THE SUBDIVISION MAP ACT. THE TOTAL NUMBER OF RESIDENTIAL UNITS IS 13.

MAPPING NOTE:

A FINAL MAP SHALL BE FILED AT THE COUNTY RECORDER'S OFFICE PRIOR TO THE EXPIRATION OF THE TENTATIVE MAP. A DETAILED PROCEDURE OF SURVEY WILL BE SHOWN ON THE FINAL MAP AND ALL PROPERTY CORNERS WILL BE SET ON THE FINAL PARCEL MAP.

ASSESSOR'S PARCEL NO.

430-680-09

SITE AREA & NO. OF UNITS

NUMBER OF LOTS PROPOSED = 1 (ONE) AREA WITHIN TM BOUNDARY = 26,856.7 SF (0.617 ACRES) NUMBER OF PROPOSED UNITS = 13

ZONING

RS-1-7 / CC-4-5 OVERLAYS

AIRPORT INFLUENCE AREA CLAIREMONT MESA HEIGHT LIMIT FAA PART 77 NOTIFICATION AREA GEOLOGICAL HAZARD CATEGORY: 53

EASEMENTS

EXISTING EASEMENT FOR PUBLIC UTILITIES SDG&E REC. 1-04-55 AS BOOK 5484, PAGE 164 - NOT PLOTABLE NO EASEMENTS WILL BE PROPOSED.

PRELIMINARY TITLE REPORT ISSUED BY FIRST AMERICAN TITLE COMPANY, ORDER NO. DIV-5624800, DATED NOVEMBER 2018

SEWER: CITY OF SAN DIEGO (UNDERGROUND) WATER: CITY OF SAN DIEGO (UNDERGROUND) GAS: SAN DIEGO GAS AND ELECTRIC (UNDERGROUND) ELECTRIC: SAN DIEGO GAS AND ELECTRIC (OVERHEAD)
TELEPHONE: AT&T (UNDERGROUND) CABLE: COX CABLE (UNDERGROUND)

LEGAL DESCRIPTION

THE SOUTHWESTERLY 100.00 FEET (AS MEASURED AT RIGHT ANGLES FROM THE SOUTHWESTERL LINE OF LOT 5) OF ALL THAT PORTION OF LOT 5 OF PUEBLO LOT 255, IN THE CITY OF SAN DIEGO, COUNTY OF SAN DIEGO, STATE OF CALIFORNIA; ACCORDING TO REFEREE'S PARTITION MAP FILED IN THE ACTION OF MORENA COMPANY, A CORPORATION, VS. FRANKLIN STEEL, JR., CASE NO. 3475, FILED IN THE SUPERIOR COURT OF THE COUNTY OF SAN DIEGO, LYING SOUTHWEST OF THE CENTER LINE OF ASHER STREET, AS SAID STREET EXISTED ON JANUARY 21, 1944.

EXCEPTING THEREFROM THE FOLLOWING PARCELS: A. THAT PORTION OF SAID LOT, IF ANY, LYING WITHIN THE RIGHT-OF-WAY OF THE ATCHISON, TOPEKA AND SANTE FE RAILWAY.

B. THAT PORTION DESCRIBED IN THE DEED TO THE CITY OF SAN DIEGO RECORDED MARCH 23 1956, IN BOOK 6029, PAGE 122 OF OFFICIAL RECORDS. C. THAT PORTION LYING SOUTHEASTERLY OF A LINE WHICH IS PARALLEL WITH AND DISTANT 101.5

FEET NORTHWESTERLY FROM THE SOUTHEASTERLY LINE OF BLOCK 17 OF FIRST ADDITION TO ASHER'S CLOVERLEAF TERRACE, ACCORDING TO MAP THEREOF NO. 1666, FILED IN THE OFFICE OF THE COUNTY RECORDER, AND THE NORTHEASTERLY PROLONGATION OF SAID SOUTHEASTERLY LINE, AND LYING NORTHEASTERLY OF THE NORTHWESTERLY PROLONGATION OF THE SOUTHWEST LINE OF LOT 17 IN BLOCK 17 OF SAID FIRST ADDITION TO ASHER'S CLOVERLEAF TERRACE. D. THAT PORTION LYING WITHIN LAHOUD TERRACE, ACCORDING TO MAP THEREOF NO. 3134, FILED IN THE OFFICE OF THE COUNTY RECORDER OF SAN DIEGO COUNTY, OCTOBER 4, 1954.

BASIS OF BEARINGS

THE BASIS OF BEARINGS FOR THIS SURVEY IS THE CALIFORNIA COORDINATE SYSTEM, CCS83, ZONE 6, EPOCH 1991.35 AND IS DETERMINED BY GPS MEASUREMENTS TAKEN ON OCTOBER 16, AT POINTS A & B WERE ESTABLISHED FROM GPS STATIONS 928 AND 929 PER ROS 14492.

THE BEARING FROM POINT A TO POINT B IS SOUTH 53°21'00" EAST.

THE COMBINED GRID FACTOR AT POINT \boxed{A} IS 1.0000045. GRID DISTANCE = GROUND DISTANCE X COMBINED GRID FACTOR. ELEVATION AT POINT \boxed{A} IS 38.97 FEET, M.S.L.

A = N 1864142.25, E 6267383.80

B = N 1863964.26, E 6267623.02

TOPOGRAPHY

ELEVATION = 21.883' MSL (NGVD '29)

TOPOGRAPHIC SURVEY IS BASED UPON A FIELD SURVEY AND REPRESENTS THE TOPOGRAPHIC FEATURE OF THIS SITE. CONTRACTOR TO VERIFY EXACT LOCATION OF UNDERGROUND UTILITIES PRIOR TO CONSTRUCTION. BENCHMARK: A BRASS PLUG LOCATED IN THE TOP OF CURB, OVER A CONCRETE STORM DRAIN INLET AT THE SOUTHEAST CORNER OF MORENA BOULEVARD AND ASHER STREET.

DATE

OWNER

ALMERIA INVESTMENTS LP 817 CLARK AVENUE ENCINITAS, CA. 92024 (760) 207-3740

NAME:

ENGINEER





CIVIL LANDWORKS CORP. 110 COPPERWOOD WAY, SUITE P OCEANSIDE, CA 92058 760-908-8745

DAVID V. CARON 6-29-20



BUILDINGS + PARKING RATE

| _ | | | |
|---|----------------|---|---|
| | ZONE: | RS-1-7 | CC-4-5 |
| | LOT AREA: | 14,800SF (SEE A1.00) | 12,000SF (SEE A1.00) |
| | HEIGHT: | 24'/30' ALLOWED 28'-6" PROPOSED (PARAPET) | 30' ALLOWED 30'-0" PROPOSED (PARAPE |
| | FRONT SETBACK: | 6'-0" REQUIRED | N/A |
| | SIDE SETBACK: | 0.08 X LOT WIDTH (100'-0") | 10'-0" OR 0' |
| | | 8'-0" MIN. REQUIRED 10'-2" & 5'-0" PROPOSED | 26'-0" AND 0' PROPOSED |
| | REAR SETBACK: | N/A | 10'-0" 10'-0" PROPOSED |
| | FAR: | 0.5 (7,400SF) ALLOWED | 2.0 (24,000SF) ALLOWED |
| | | 7,451SF — LEVEL 1 7,187SF — LEVEL 2 7,141SF — LEVEL 3 | 4,442SF — LEVEL 1 4,032SF — LEVEL 2 4,012SF — LEVEL 3 |
| | | 1.47 FAR (21,779SF) | 1.04 FAR (12,486SF) |
| | | | |

TOTAL FAR ALLOWED: 31,400SQFT (COMBINED ZONES)

TOTAL PROPOSED FAR: 34,265SQFT (COMBINED ZONES)

10 3-BED X 2.25 SPACES = 22.5 SPACES REQUIRED 2 2-BED X 2.0 SPACES = 4 SPACES REQUIRED 1 2-BED (AFFORDABLE) X 1.3 SPACES 27.8 SPACES TOTAL REQUIRED

28 SPACES PROPOSED

AFFORDABLE HOUSING: CC-4-5 ZONE: 1 UNIT / 1,500SQFT (RESIDENTIAL DENSITY) 12,000SQFT/1500SQFT = 8 UNITS ALLOWED (MAX PRE-BONUS DENSITY = 9 UNITS)

> 11.1% VERY LOW INCOME ALLOWS FOR A 35% DENSITY BONUS 9 X 12% = 1.0 = 1 VERY LOW INCOME UNIT

9 DWELLING UNITS X 1.35 = 12.15, ROUNDED UP TO 13

13 TOTAL DWELLING UNITS ALLOWED INCENTIVES: 1. PROPOSED 5'-0" SIDE SETBACK IN RS-1-7 ZONE (8'-0" REQUIRED)

(2 ALLOWED) 2. PROPOSED FAR OF 34,265SQFT IN COMBINED ZONES (31,400SQFT MAX. REQUIRED) **DEVIATIONS:** 1. DEVIATION FROM THE 30-DEGREE ANGLED BUILDING ENVELOPE PLANE ALONG SIDE


SETBACK LINES FOR STRUCTURES WITHIN THE RS ZONE. 131.0444(C) 2. DEVIATION FROM THE COMMERCIAL COMPONENT REQUIRED FOR THE CC-4-5 ZONE TO ALLOW FOR RESIDENTIAL DEVELOPMENT. 131.0540(B)

EARTHWORK DATA

CUT = 270 C.Y. FILL = 820 C.Y.IMPORT = 550 C.Y.

TOTAL LOT AREA = 26,855 S.F. TOTAL DISTURBED AREA = 25,102 S.F. DEPTH OF CUT = 5.0 FEET DEPTH OF FILL = 5.0 FEET

*DEPTH OF CUT AND FILL DO NOT INCLUDE GEOTECHNICAL REMEDIATION RECOMMENDATIONS THESE QUANTITIES DO NOT INCLUDE ANY LOSSES DUE TO SHRINKAGE, SUBSIDENCE, OVEREXCAVATION. OR ANY SPECIAL REQUIREMENTS THAT MAY BE SPECIFIED IN THE PRELIMINARY SOILS REPORT. THESE QUANTITIES ARE FOR PERMIT PURPOSES ONLY. ALL CONTRACTORS BIDDING ON THIS PROJECT SHOULD MAKE THEIR OWN DETERMINATION OF EARTHWORK QUANTITIES PRIOR TO SUBMITTING A BID.

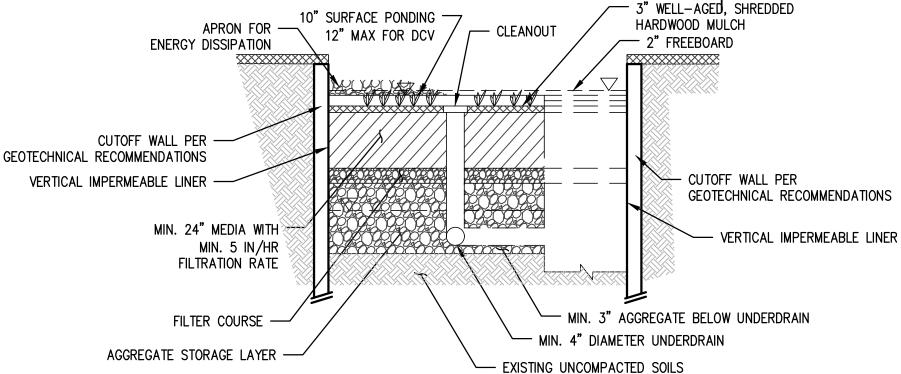

BIOFILTRATION BMP

0.5' 14.0 EX. PAVEMENT PR. CURB SIDEWALK — PR. CURB


TONOPAH AVE. TYPICAL CROSS-SECTION

STORM WATER NOTE

CONSTRUCTION PERMIT ISSUANCE.


- 1. PRIOR TO THE ISSUANCE OF ANY CONSTRUCTION PERMIT, THE OWNER/PERMITEE SHALL ENTER INTO A MAINTENANCE AGREEMENT FOR THE
- ONGOING PERMANENT BMP MAINTENANCE, SATISFACTORY TO THE CITY ENGINEER.
- 2. PRIOR TO THE ISSUANCE OF ANY CONSTRUCTION PERMIT, THE OWNER/PERMITTEE SHALL INCORPORATE ANY CONSTRUCTION BEST MANAGEMENT PRACTICES NECESSARY TO COMPLY WITH CHAPTER 14, ARTICLE 2, DIVISION 1 (GRADING REGULATIONS) OF THE SAN DIEGO
- MUNICIPAL CODE, INTO THE CONSTRUCTION PLANS OR SPECIFICATIONS. 3. PRIOR TO THE ISSUANCE OF ANY CONSTRUCTION PERMIT THE OWNER/PERMITTEE SHALL SUBMIT A WATER POLLUTION CONTROL PLAN (WPCP).
- THE WPCP SHALL BE PREPARED IN ACCORDANCE WITH THE GUIDELINES IN PART 2 CONSTRUCTION BMP STANDARDS CHAPTER 4 OF THE CITY'S STORM WATER STANDARDS 4. PRIOR TO THE ISSUANCE OF ANY CONSTRUCTION PERMIT, THE APPLICANT SHALL SUBMIT A TECHNICAL REPORT THAT WILL BE SUBJECT TO FINAL REVIEW AND APPROVAL BY THE CITY ENGINEER, BASED ON THE STORM WATER STANDARDS IN EFFECT AT THE TIME OF THE

- 1. THE OWNER/PERMITTEE SHALL OBTAIN AN ENCROACHMENT MAINTENANCE REMOVAL AGREEMENT. FROM THE CITY ENGINEER. FOR THE PORTION OF THE PROPOSED PRIVATE STORM DRAIN SYSTEM LOCATED WHERE THE OWNER/PERMITTEE IS NOT THE OWNER OF THE PROPERTY FRONTING THE ENCROACHMENT
- 2. THIS PROJECT WILL NOT DISCHARGE ANY INCREASE IN STORM WATER RUN-OFF ONTO THE EXISTING RIGHT-OF-WAY SLOPE AREAS. 3. IF A 3" OR LARGER METER IS REQUIRED FOR THIS PROJECT, THE OWNER/PERMITTEE SHALL CONSTRUCT THE NEW METER AND PRIVATE BACKFLOW DEVICE ON SITE, ABOVE GROUND, WITHIN AN ADEQUATELY SIZED WATER EASEMENT, IN A MANNER SATISFACTORY
- TO THE PUBLIC UTILITIES DIRECTOR AND THE CITY ENGINEER. 4. ALL ONSITE WATER AND SEWER FACILITIES WILL BE PRIVATE AND SHALL BE DESIGNED TO MEET THE REQUIREMENTS OF THE
- CALIFORNIA UNIFORM PLUMBING CODE AND SHALL BE REVIEWED AS PART OF THE BUILDING PERMIT PLAN CHECK. 5. THIS PROJECT WILL NOT DISCHARGE ANY INCREASE IN STORM WATER RUN-OFF ONTO THE EXISTING RIGHT-OF-WAY SLOPE AREAS.

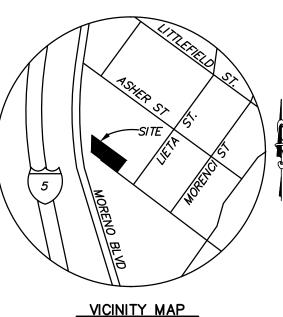

NOT TO SCALE

LEGEND:

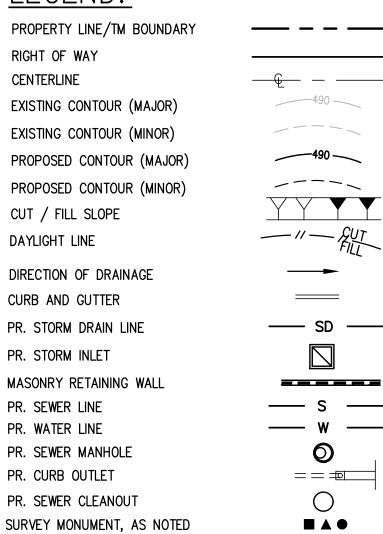

CONSTRUCTION NOTES:

- 1 CONSTRUCT BIOFILTRATION BASIN PER DETAIL HEREON 5 FOOT CUTOFF WALL PER GEOTECHNICAL RECOMMENDAITONS
- VERTICAL IMPERMEABLE LINER (2) CONSTRUCT STORM CONTROL VAULT

STREET LIGHT


- (3) CONSTRUCT 24" X 24" GRATE INLET
- (4) CONSTRUCT 3' WIDE CONCRETE RIBBON GUTTER
- (5) CONSTRUCT 10" HDPE STORM DRAIN
- (6) CONSTRUCT CURB OUTLET PER SDRSD D-25
- (7) CONSTRUCT CURB AND GUTTER PER SDG-151
- (8) CONSTRUCT CURB ONLY PER SDG-150
- (9) CONSTRUCT RIPRAP PER SDD-104, NO. 2 BACKING T=1.1'
- (10) CONSTRUCT HEADWALL PER SDRSD D-30
- (11) CONSTRUCT 12" HDPE STORM DRAIN
- (12) CONSTRUCT RETAINING WALL
- (13) CONSTRUCT SIDEWALK UNDERDRAIN PER SDRSD D-27
- (14) CONSTRUCT CURB RAMPS PER SDG-133, TYPE A
- (15) CONSTRUCT PAVEMENT PER SDG-113
- (16) CONSTRUCT SIDEWALK PER SDG-155
- (17) CONSTRUCT ADA RAMP

UTILITY NOTES:

- (21) CONSTRUCT PUBLIC 8" SEWER MAIN (PUBLIC)
- (22) CONSTRUCT SEWER MANHOLE PER SDRSD SM-01 (PUBLIC)
- (23) CONSTRUCT 6" GRAVITY SEWER MAIN (PRIVATE)
- (24) CONSTRUCT 6" SEWER LATERAL PER SDS-105 (PRIVATE)
- (25) CONSTRUCT SEWER CLEANOUT PER SDRSD SC-01
- (26) CONSTRUCT FIRE BACKFLOW PREVENTER PER SDW-105 (IN PUBLIC R/W)
- (27) CONSTRUCT PRIVATE 6" PVC C900 FIRE LINE
- (28) FIRE SERVICE POC
- (29) CONSTRUCT DOMESTIC WATER SERVICE (IN PUBLIC R/W)
- (30) CONSTRUCT IRRIGATION SERVICE (IN PUBLIC R/W)
- (31) CONSTRUCT FIRE HYDRANT
- (32) CONSTRUCT SEWER LIFT STATION (PRIVATE)
- (33) CONSTRUCT PRIVATE 2" SEWER FORCE MAIN (PRIVATE) (34) CONSTRUCT SEWER MANHOLE PER SDRSD SM-01 (PRIVATE)

SHEET 1 OF 1 SHEET

CCS 83: 1862–6265 LC: 222–1705 1.0: 24006995 PTS. 512890

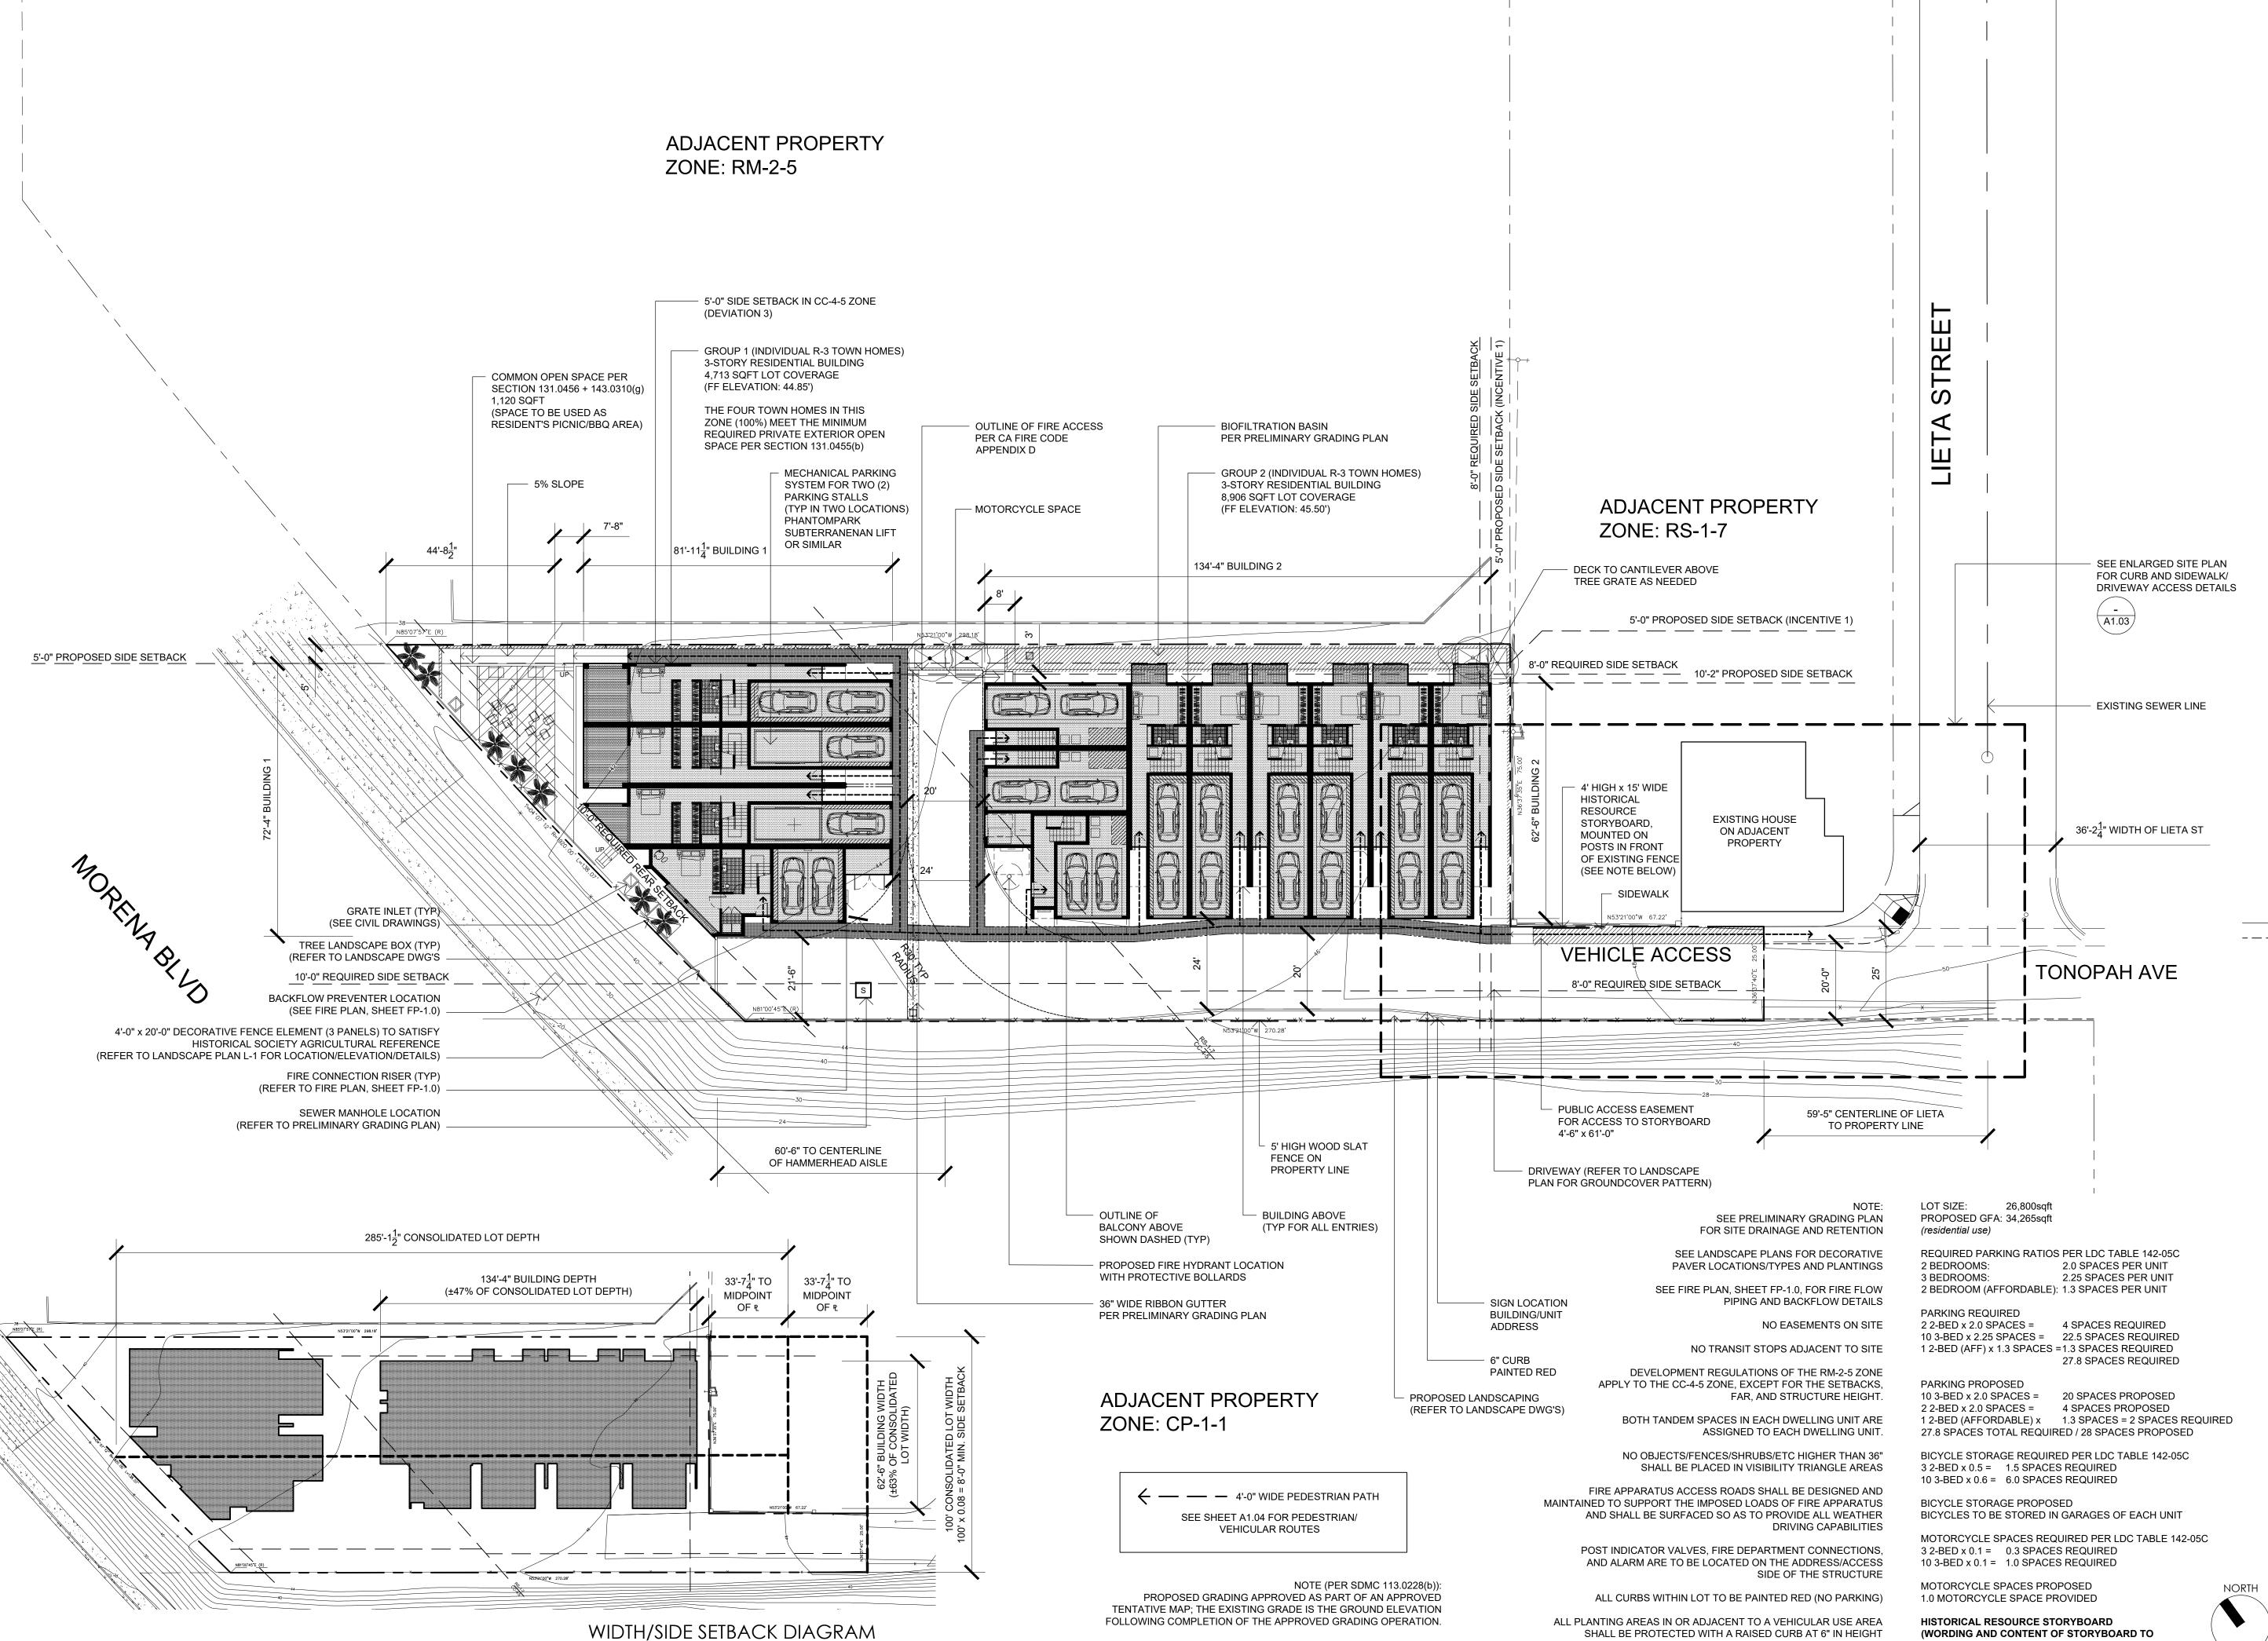

PROPOSED SITE PLAN

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DBRDS DE BARTOLO + RIMANIC DESIGN STUDIO

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10.18.2017 DRAWN BY: CH SDP & NDP - CYCLE ISSUES 2 01.08.2018 DRAWN BY: CH

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SDP & NDP - CYCLE ISSUES 3 DRAWN BY: CH 11.14.2018

SDP & NDP - CYCLE ISSUES 4 05.28.2019 DRAWN BY: CH

SDP & NDP - CYCLE ISSUES 5 09.12.2019 DRAWN BY: CH

SDP & NDP - CYCLE ISSUES 6

06.12.2020 DRAWN BY: CH HISTORIC REVISIONS

DRAWING TITLE: PROPOSED SITE PLAN


PROPOSED INDIVIDUAL R-3 CLASS TOWN HOMES

4200 TONOPAH AVE, SAN DIEGO, CA 92110

15066 DBRDS PROJECT NO: SEPTEMBER 2016 CH DRAWN BY: 1" = 20'-0"

SHEET NO:

BE APPROVED BY DAS AT A LATER DATE)

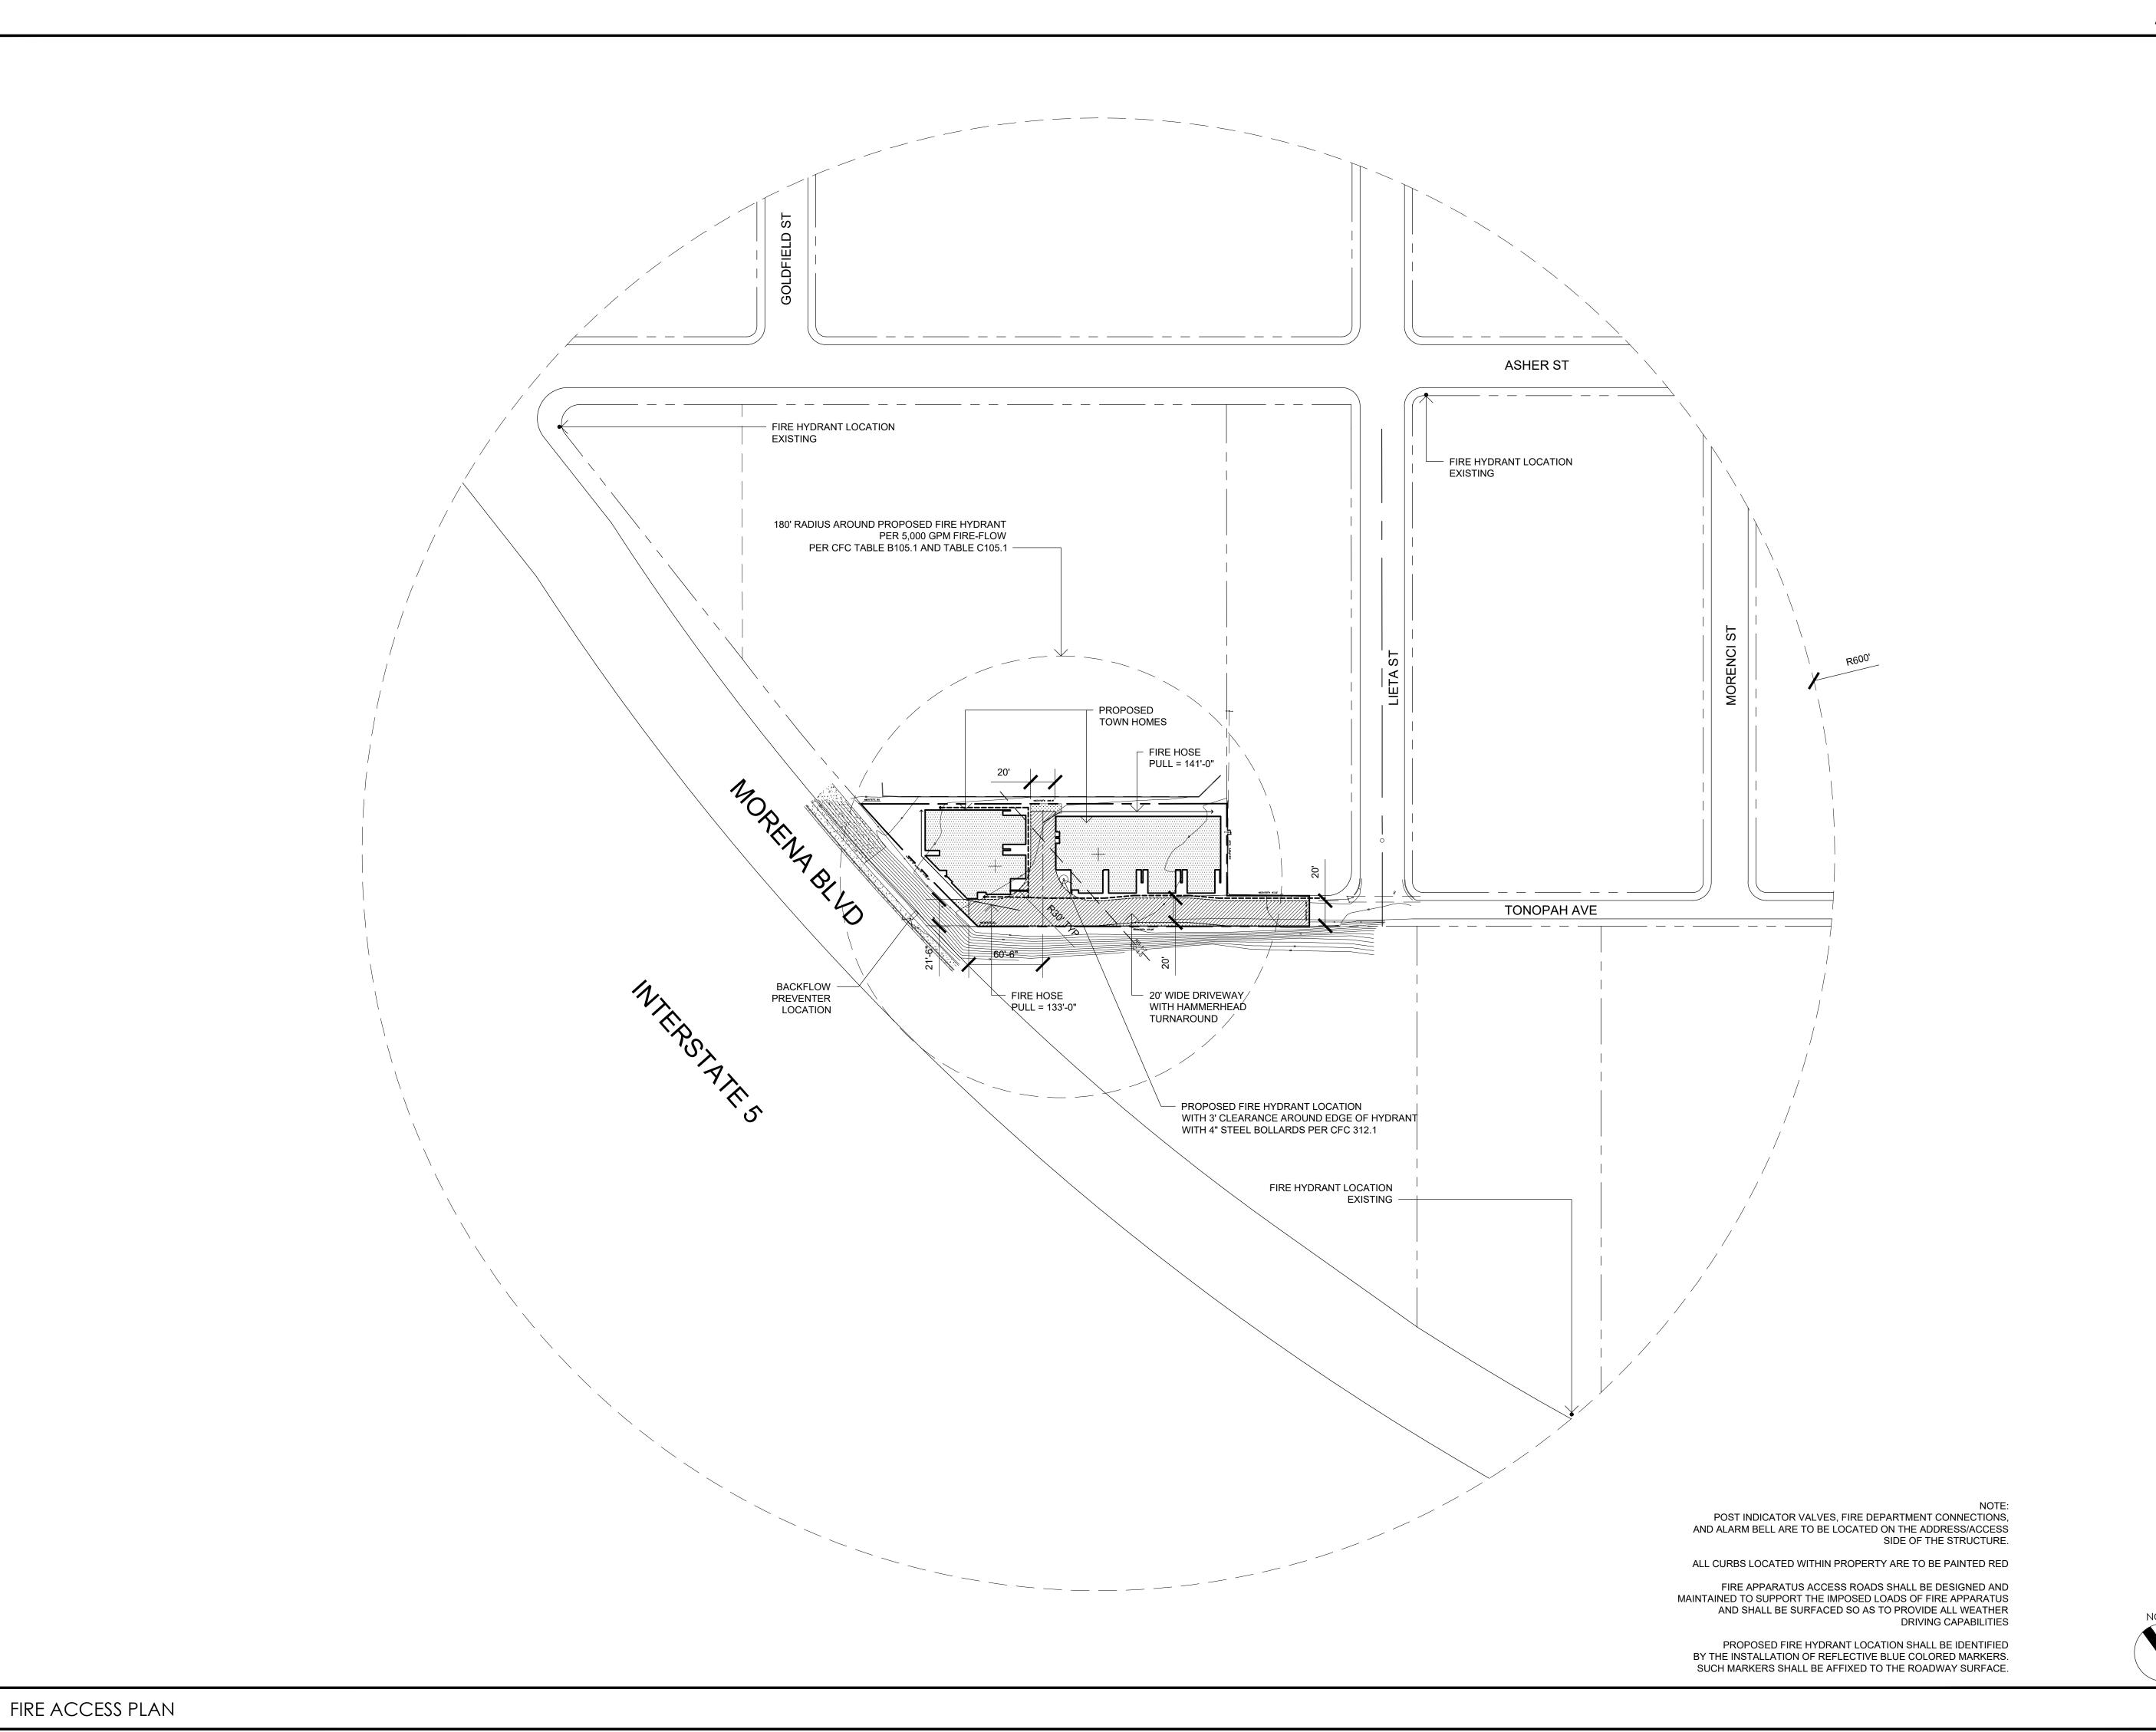

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DBRDS DE BARTOLO + RIMANIC DESIGN STUDIO

PROJECT TEAM

OWNER: ALMERIA INVESTMENTS, LP

shown these drawings.

PO BOX 232628 ENCINITAS, CA 92023

(760) 207-3740 CONTACT: MICHAEL FULTON

DESIGN:

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LANDSCAPE ARCHITECT

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REVISION:

10.18.2017 DRAWN BY: CH SDP & NDP - CYCLE ISSUES 2

01.08.2018 DRAWN BY: CH

SDP & NDP - CYCLE ISSUES 3

11.14.2018 DRAWN BY: CH SDP & NDP - CYCLE ISSUES 4

05.28.2019 DRAWN BY: CH SDP & NDP - CYCLE ISSUES 5

09.12.2019 DRAWN BY: CH

SDP & NDP - CYCLE ISSUES 6 06.12.2020 DRAWN BY: CH

HISTORIC REVISIONS

FIRE ACCESS PLAN

DRAWING TITLE:

PROPOSED INDIVIDUAL

4200 TONOPAH AVE,


SAN DIEGO, CA 92110

R-3 CLASS TOWN HOMES

DBRDS PROJECT NO: 15066 SEPTEMBER 2016 CH DRAWN BY:

1" = 60'-0" A1.02 SHEET NO:

ATTACHMENT 15 All ideas, arrangements, drawings and plans set forth on this sheet are the original work product of, owned by and are the property of **dbr**ds and use of this said work product is limited to a specified project of the purchaser, and for the construction of one building, any use, reuse or disclosure of said plans, reproductions, ideas, designs and/or arrangements, other than by dbrds, is strictly prohibited by law without the written permission of **dbr**ds. Written dimensions on these drawings shall have precedence over scaled dimensions; contractors shall verify, and be responsible for all dimensions and conditions on the job and this office must be notified of any variations from the dimensions and conditions shown these drawings. **DBR**DS PROJECT TEAM ALMERIA INVESTMENTS, LP PO BOX 232628 ENCINITAS, CA 92023 (760) 207-3740 CONTACT: MICHAEL FULTON michael@almeriainvestments.com DESIGN: DE BARTOLO + RIMANIC DESIGN STUDIO 363 5TH AVE, SUITE 203 SAN DIEGO CA 92101 (858) 220 5262 PAULY DE BARTOLO CONTACT: EMAIL: pauly@dbrds.com CIVIL & LAND SURVEYING CIVIL LANDWORKS 110 COPPERWOOD WAY, SUITE P OCEANSIDE, CA 92058 (760) 908-8745 CONTACT: DAVÉ CARRON, PE EMAIL: dave@civillandworks.com EXISTING DRIVEWAY CURB CUT FLANGE TO BE RE-SLOPED TO ANDSCAPE ARCHITECT MATCH MAX. 10% SLOPE OF NEW CURB RAMP FLANGE STONE + GROVE LANDSCAPE ARCHITECTS 200 N CEDROS AVE PROPOSED ACCESSIBLE SOLANA BEACH, CA 92705 CURB RAMP PER SDG-133, TYPE A (SEE CIVIL SHEETS) CONTACT: BRIÁN GROVE brian@stone-grove.co GEOTECHNICAL ENGINEER CHRISTIAN WHEELER ENGINEERING 3980 HOME AVE SAN DIEGO, CA 92105 (619) 550-1700 CONTACT: DAVID R. RUSSELL drussell@christianwheeler.com FIRE PIPING CONSULTANT PROTECTION DESIGN AND CONSULTING TONOPAH AVE 2851 CAMINO DEL RIO S. #210 SAN DIEGO, CA 92108 CONTACT: STEVE LEYTON steve@protectiondesign.com REVISION: 10.18.2017 DRAWN BY: CH SDP & NDP - CYCLE ISSUES 2 01.08.2018 DRAWN BY: CH SDP & NDP - CYCLE ISSUES 3 11.14.2018 DRAWN BY: CH SDP & NDP - CYCLE ISSUES 4 05.28.2019 DRAWN BY: CH SDP & NDP - CYCLE ISSUES 5 09.12.2019 DRAWN BY: CH SDP & NDP - CYCLE ISSUES 6 06.12.2020 DRAWN BY: CH HISTORIC REVISIONS DRAWING TITLE: ENLARGED SITE PLAN PROPOSED INDIVIDUAL R-3 CLASS TOWN HOMES 4200 TONOPAH AVE, Щ SAN DIEGO, CA 92110 15066 DBRDS PROJECT NO: SEPTEMBER 2016 NOTE (PER SDMC 113.0228(b)): CH DRAWN BY:

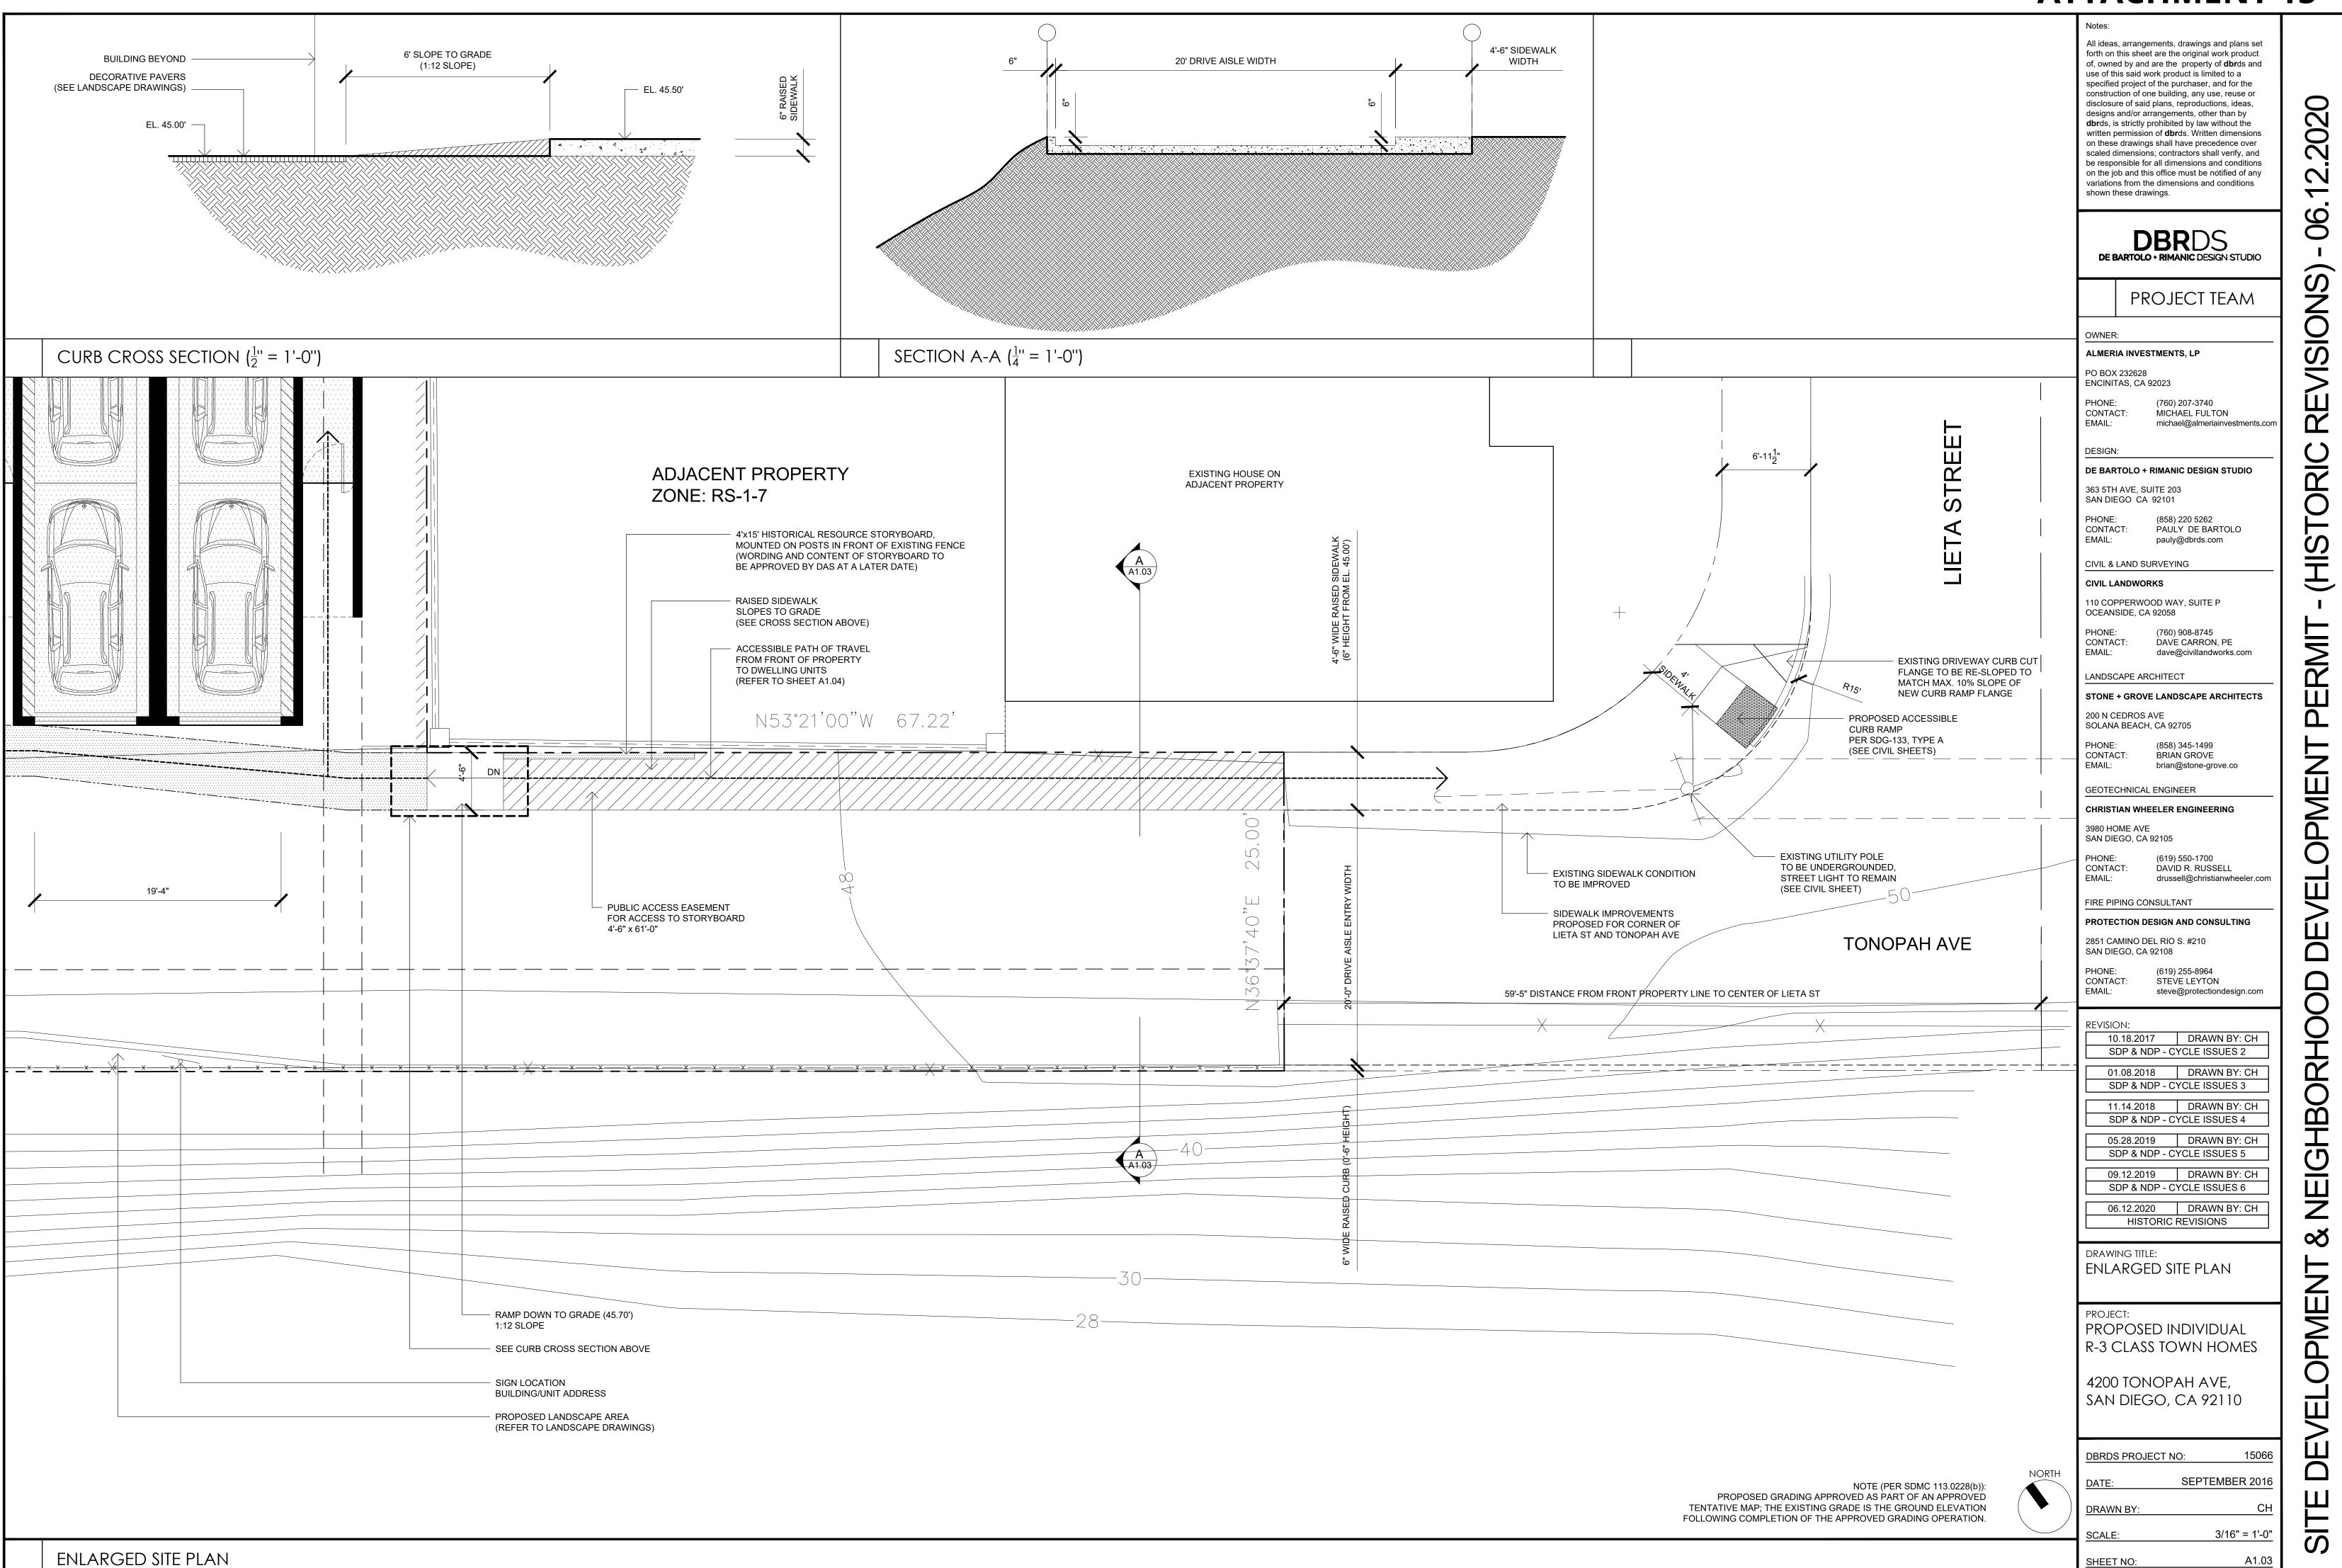

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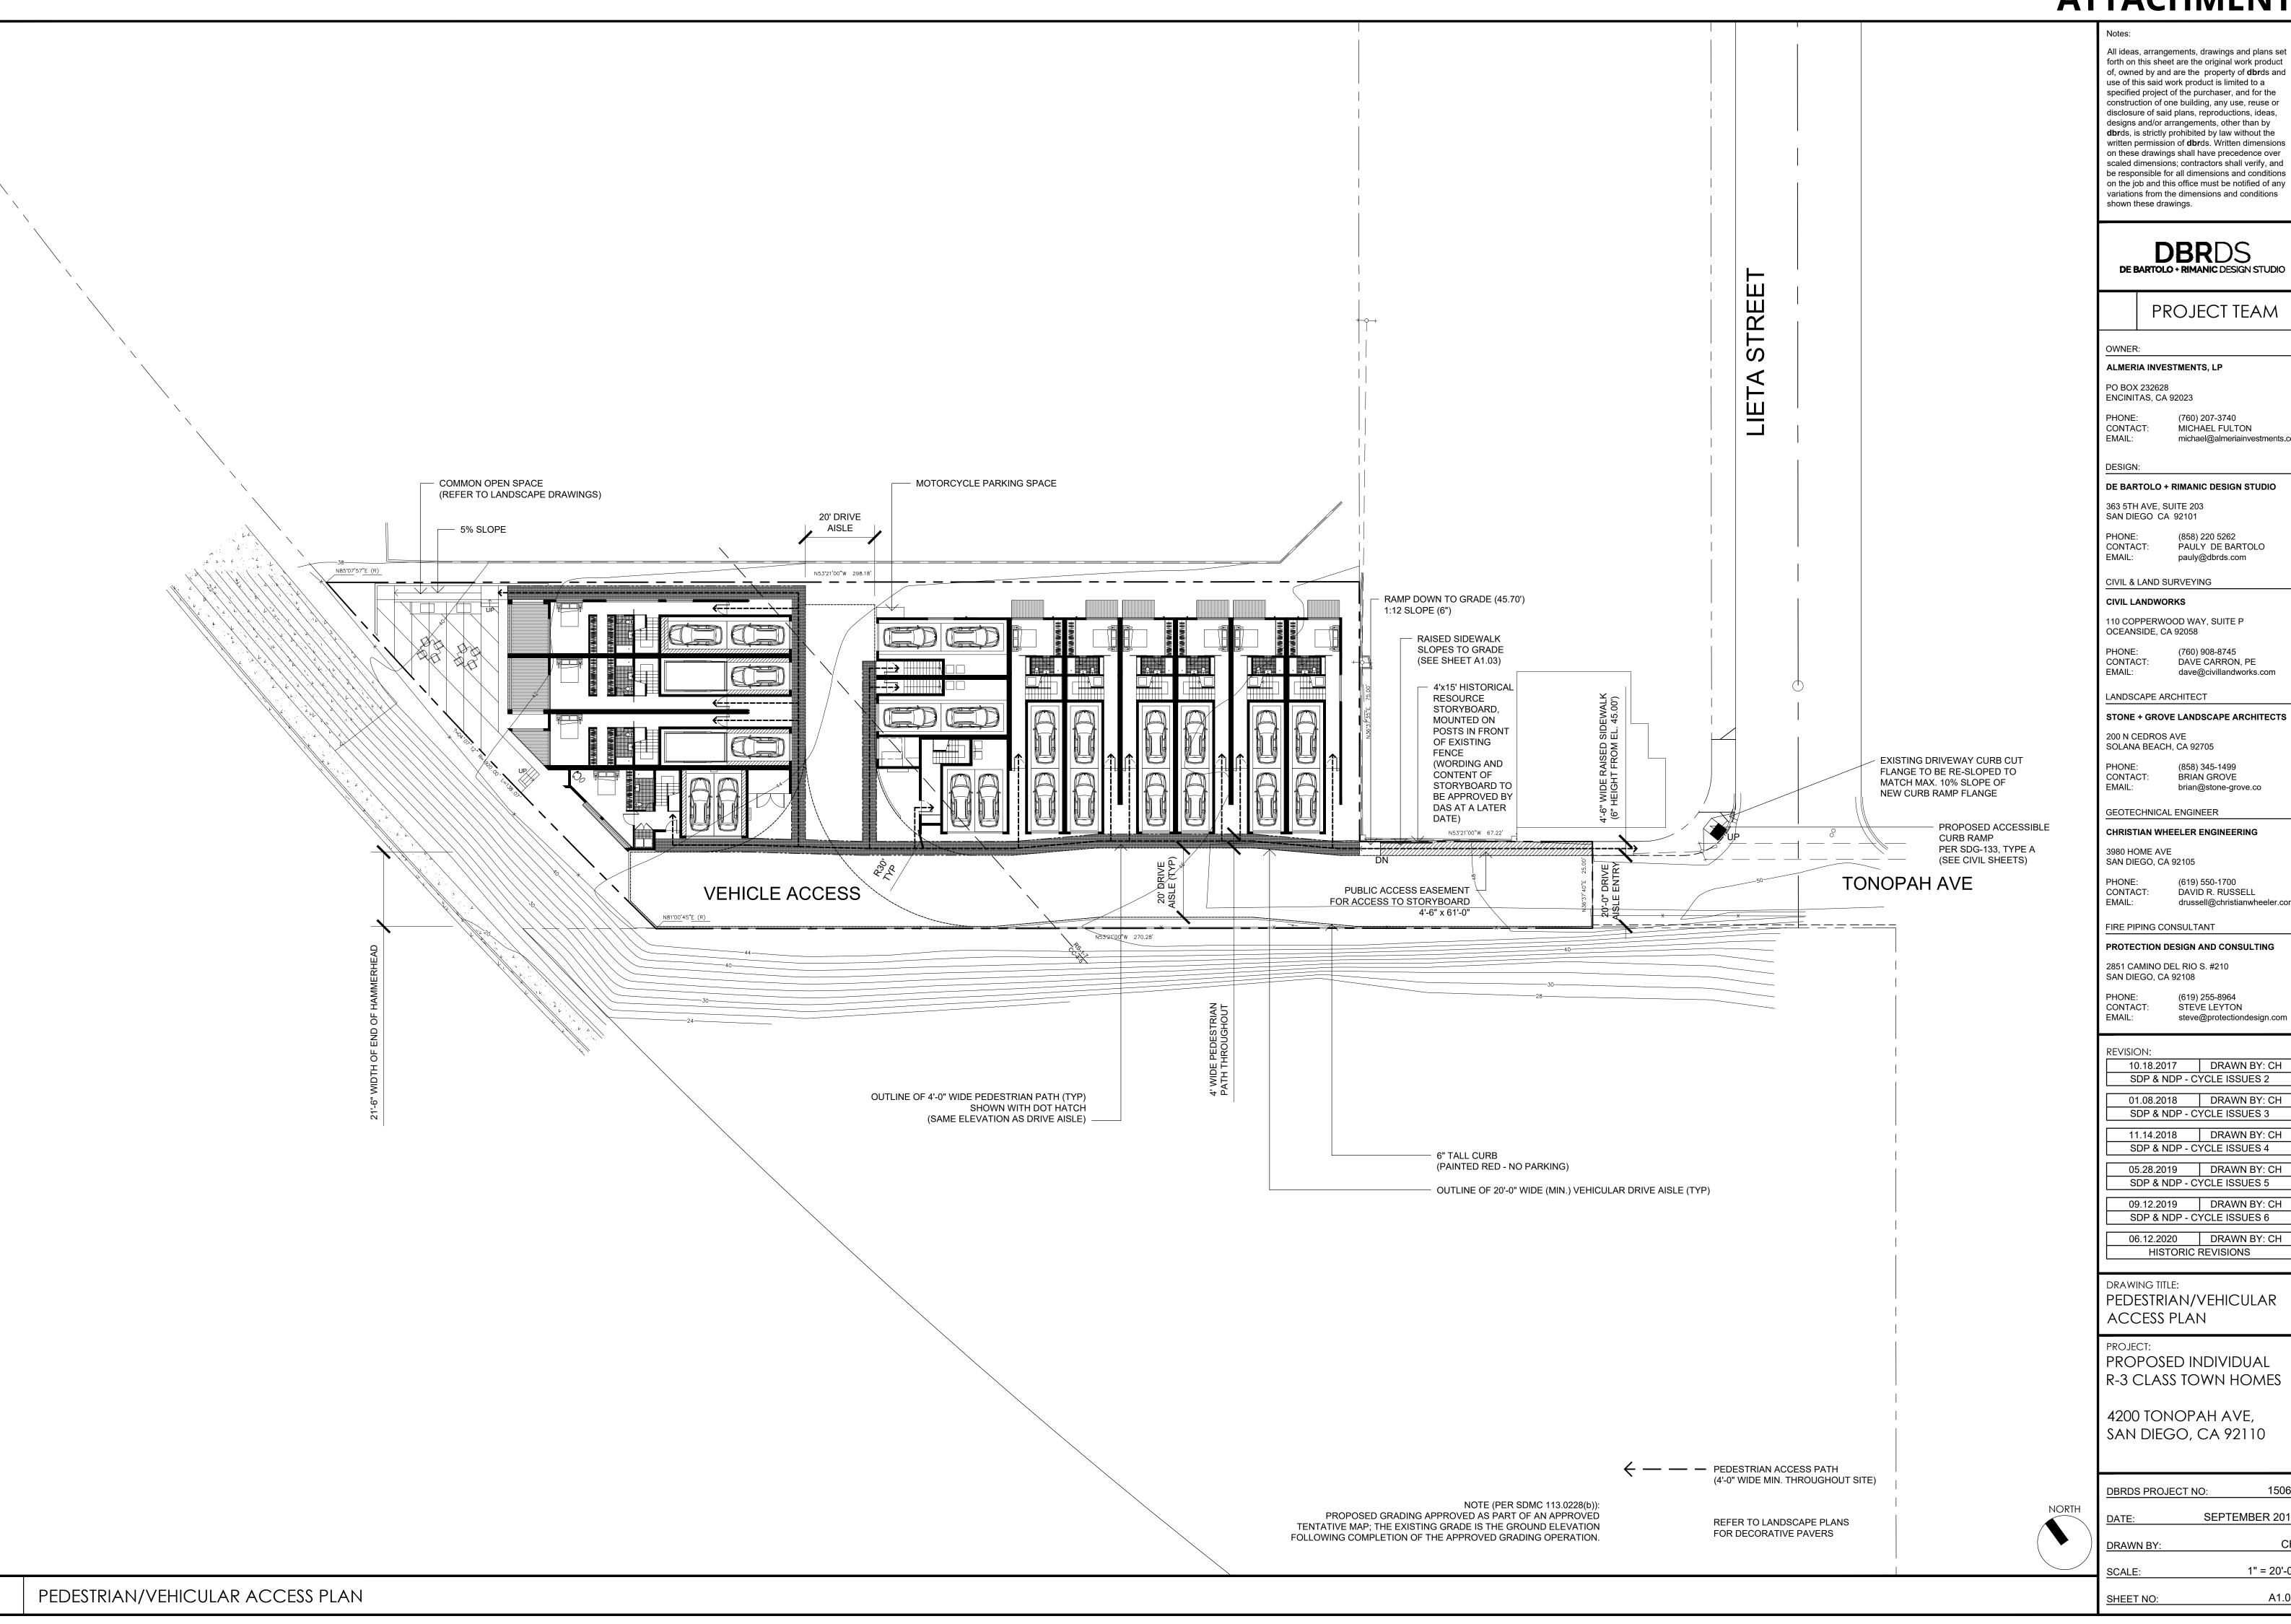
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pauly@dbrds.com

MICHAEL FULTON

michael@almeriainvestments.com



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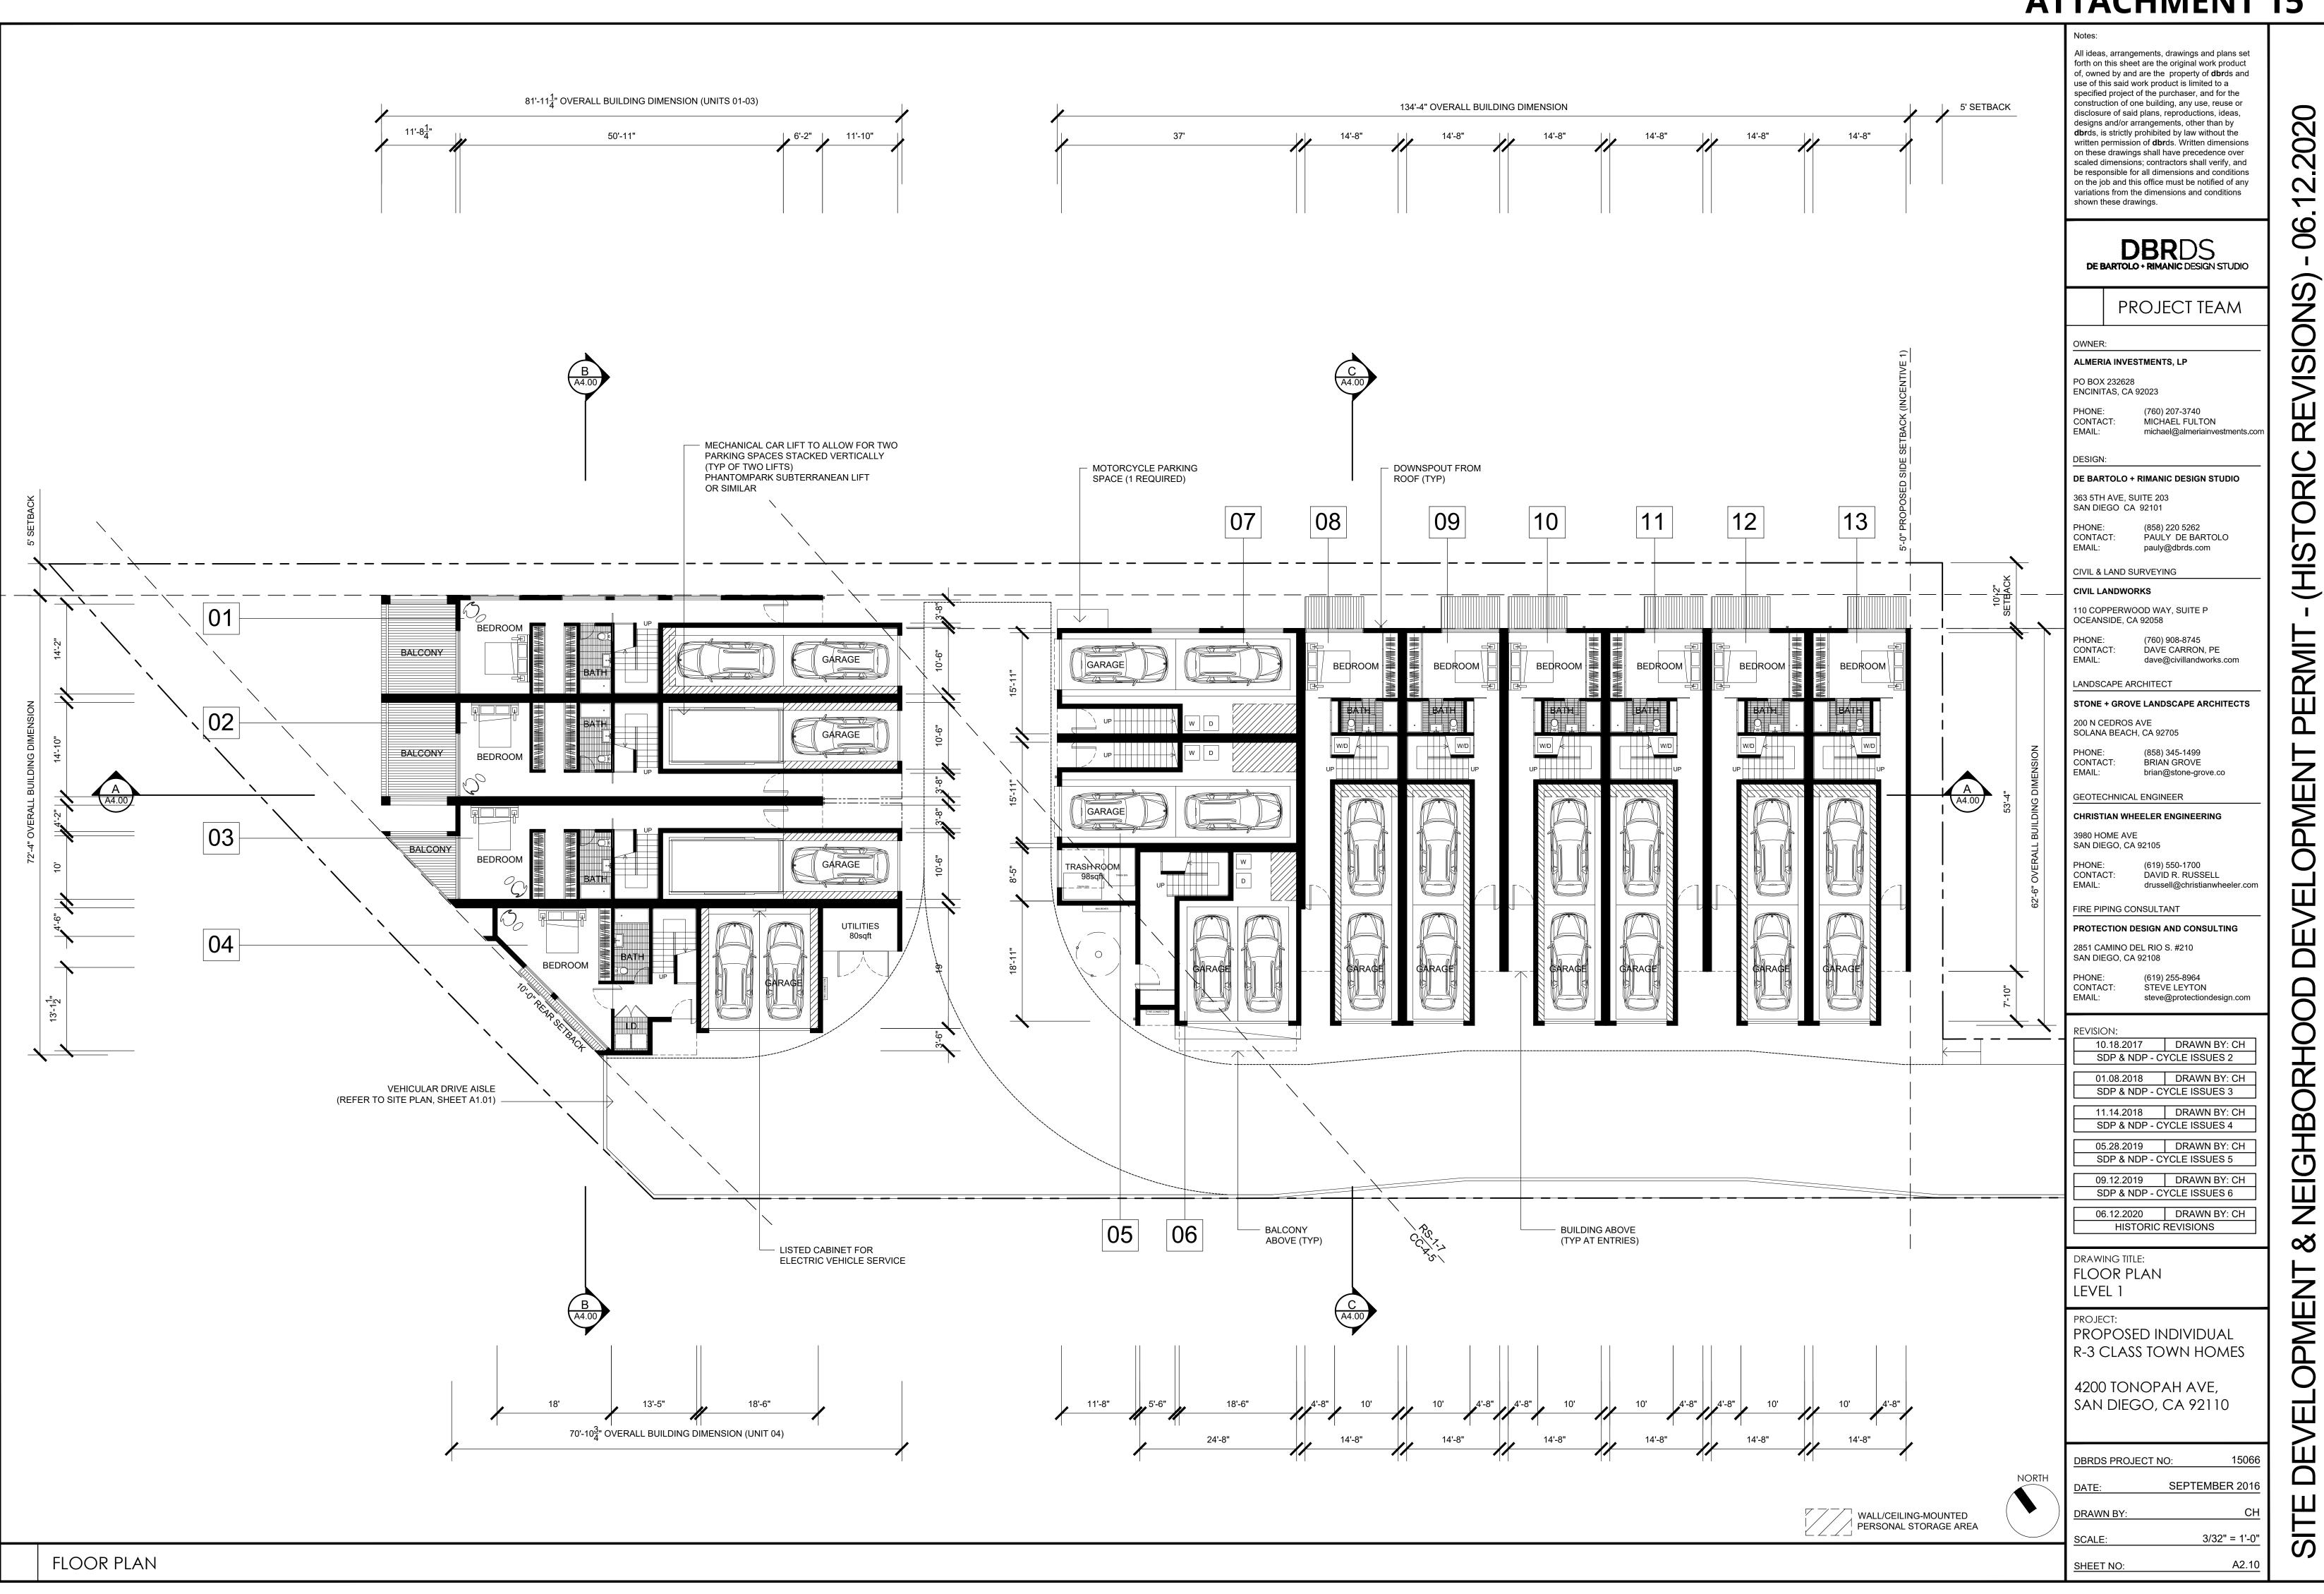
15066


CH

1" = 20'-0"

A1.04

SEPTEMBER 2016



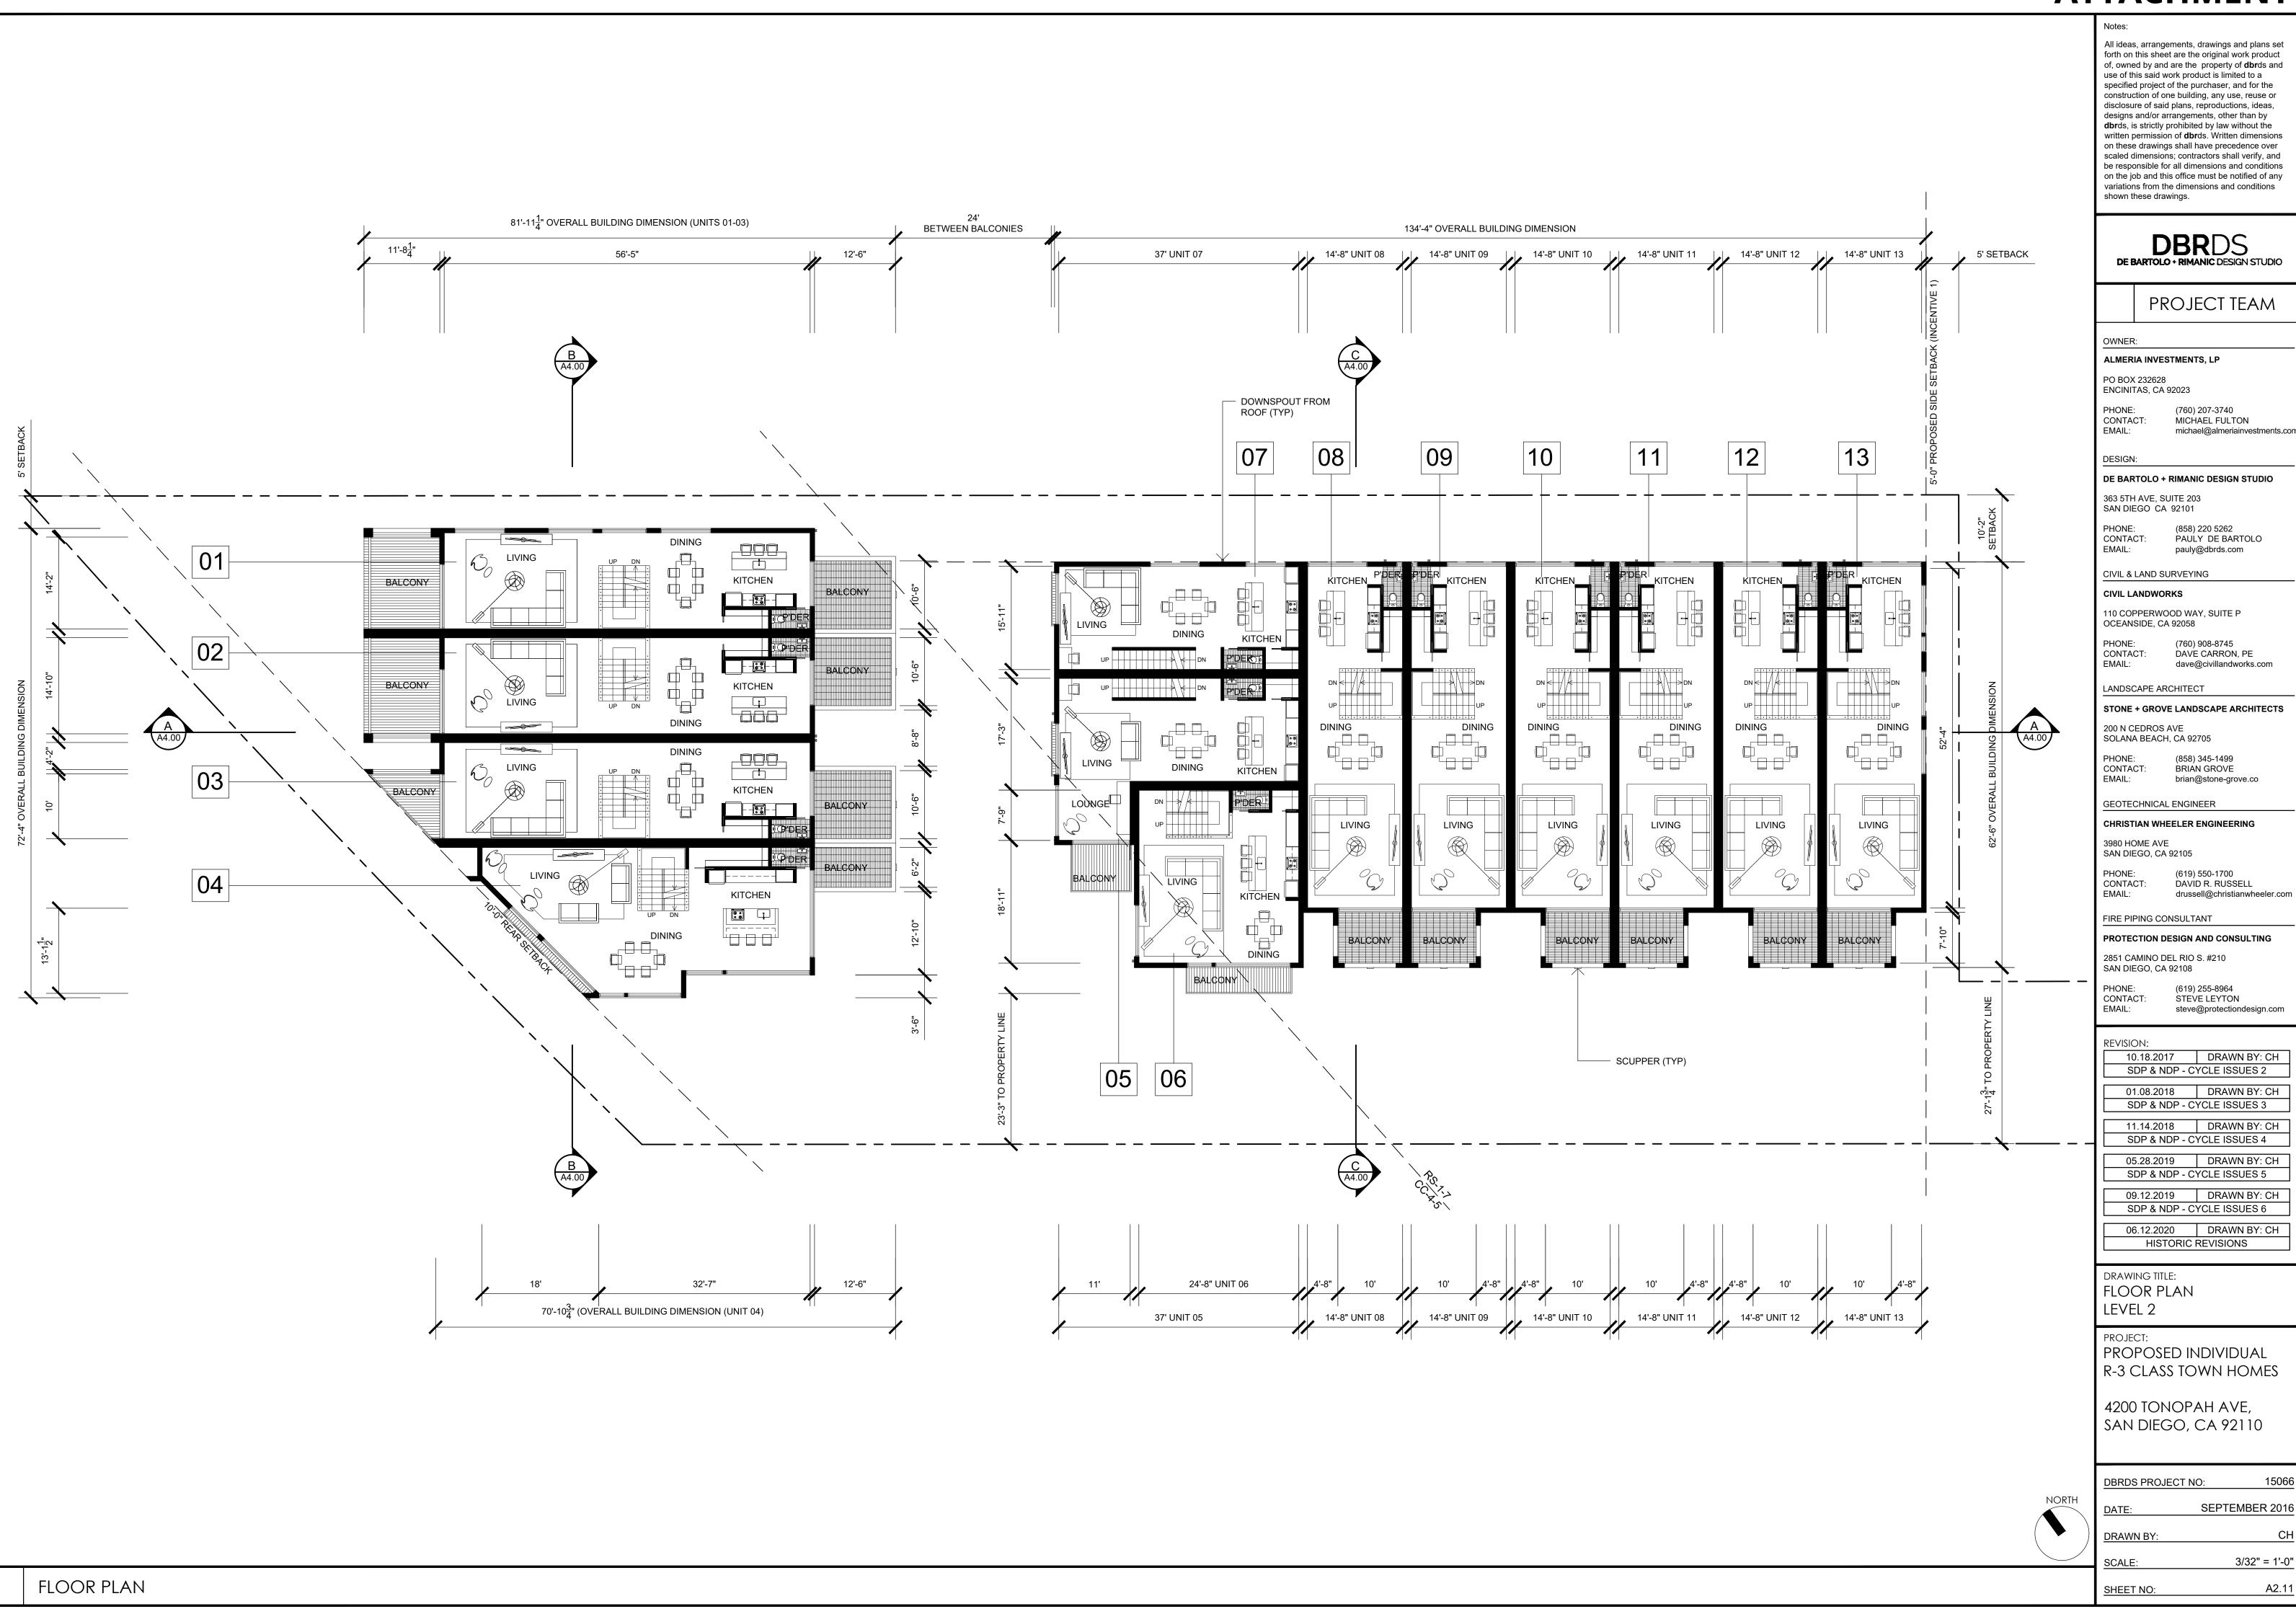



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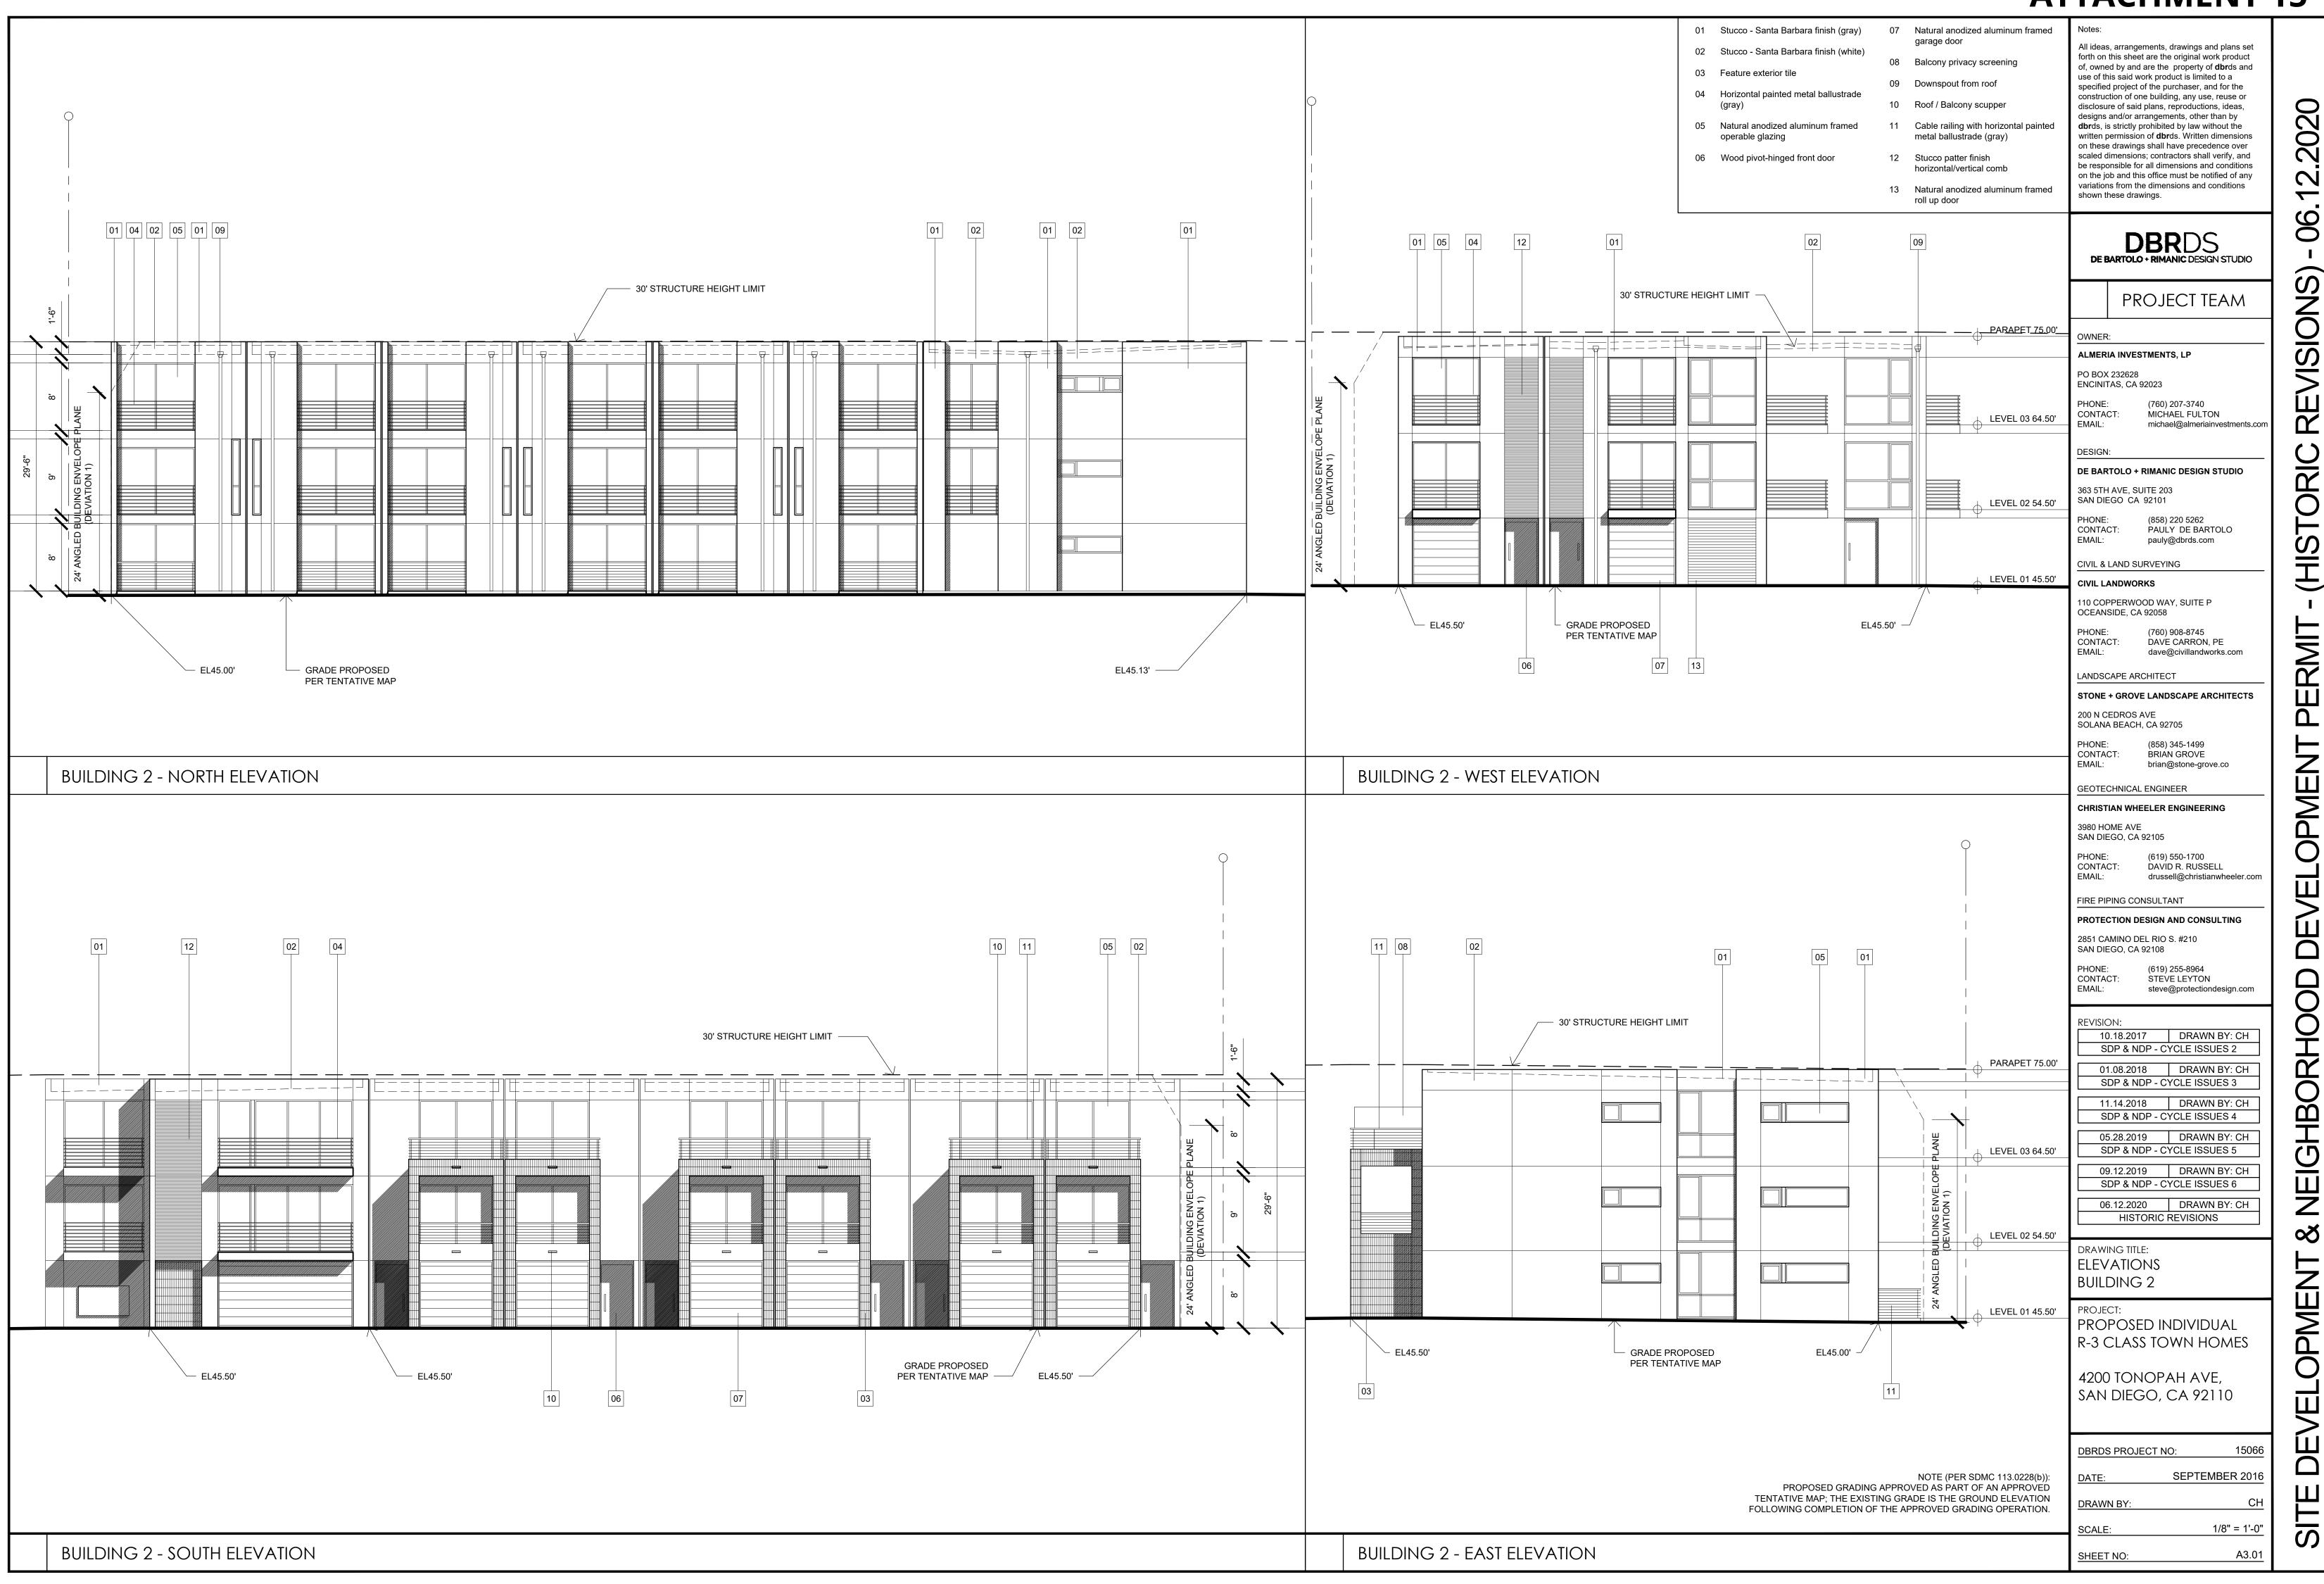
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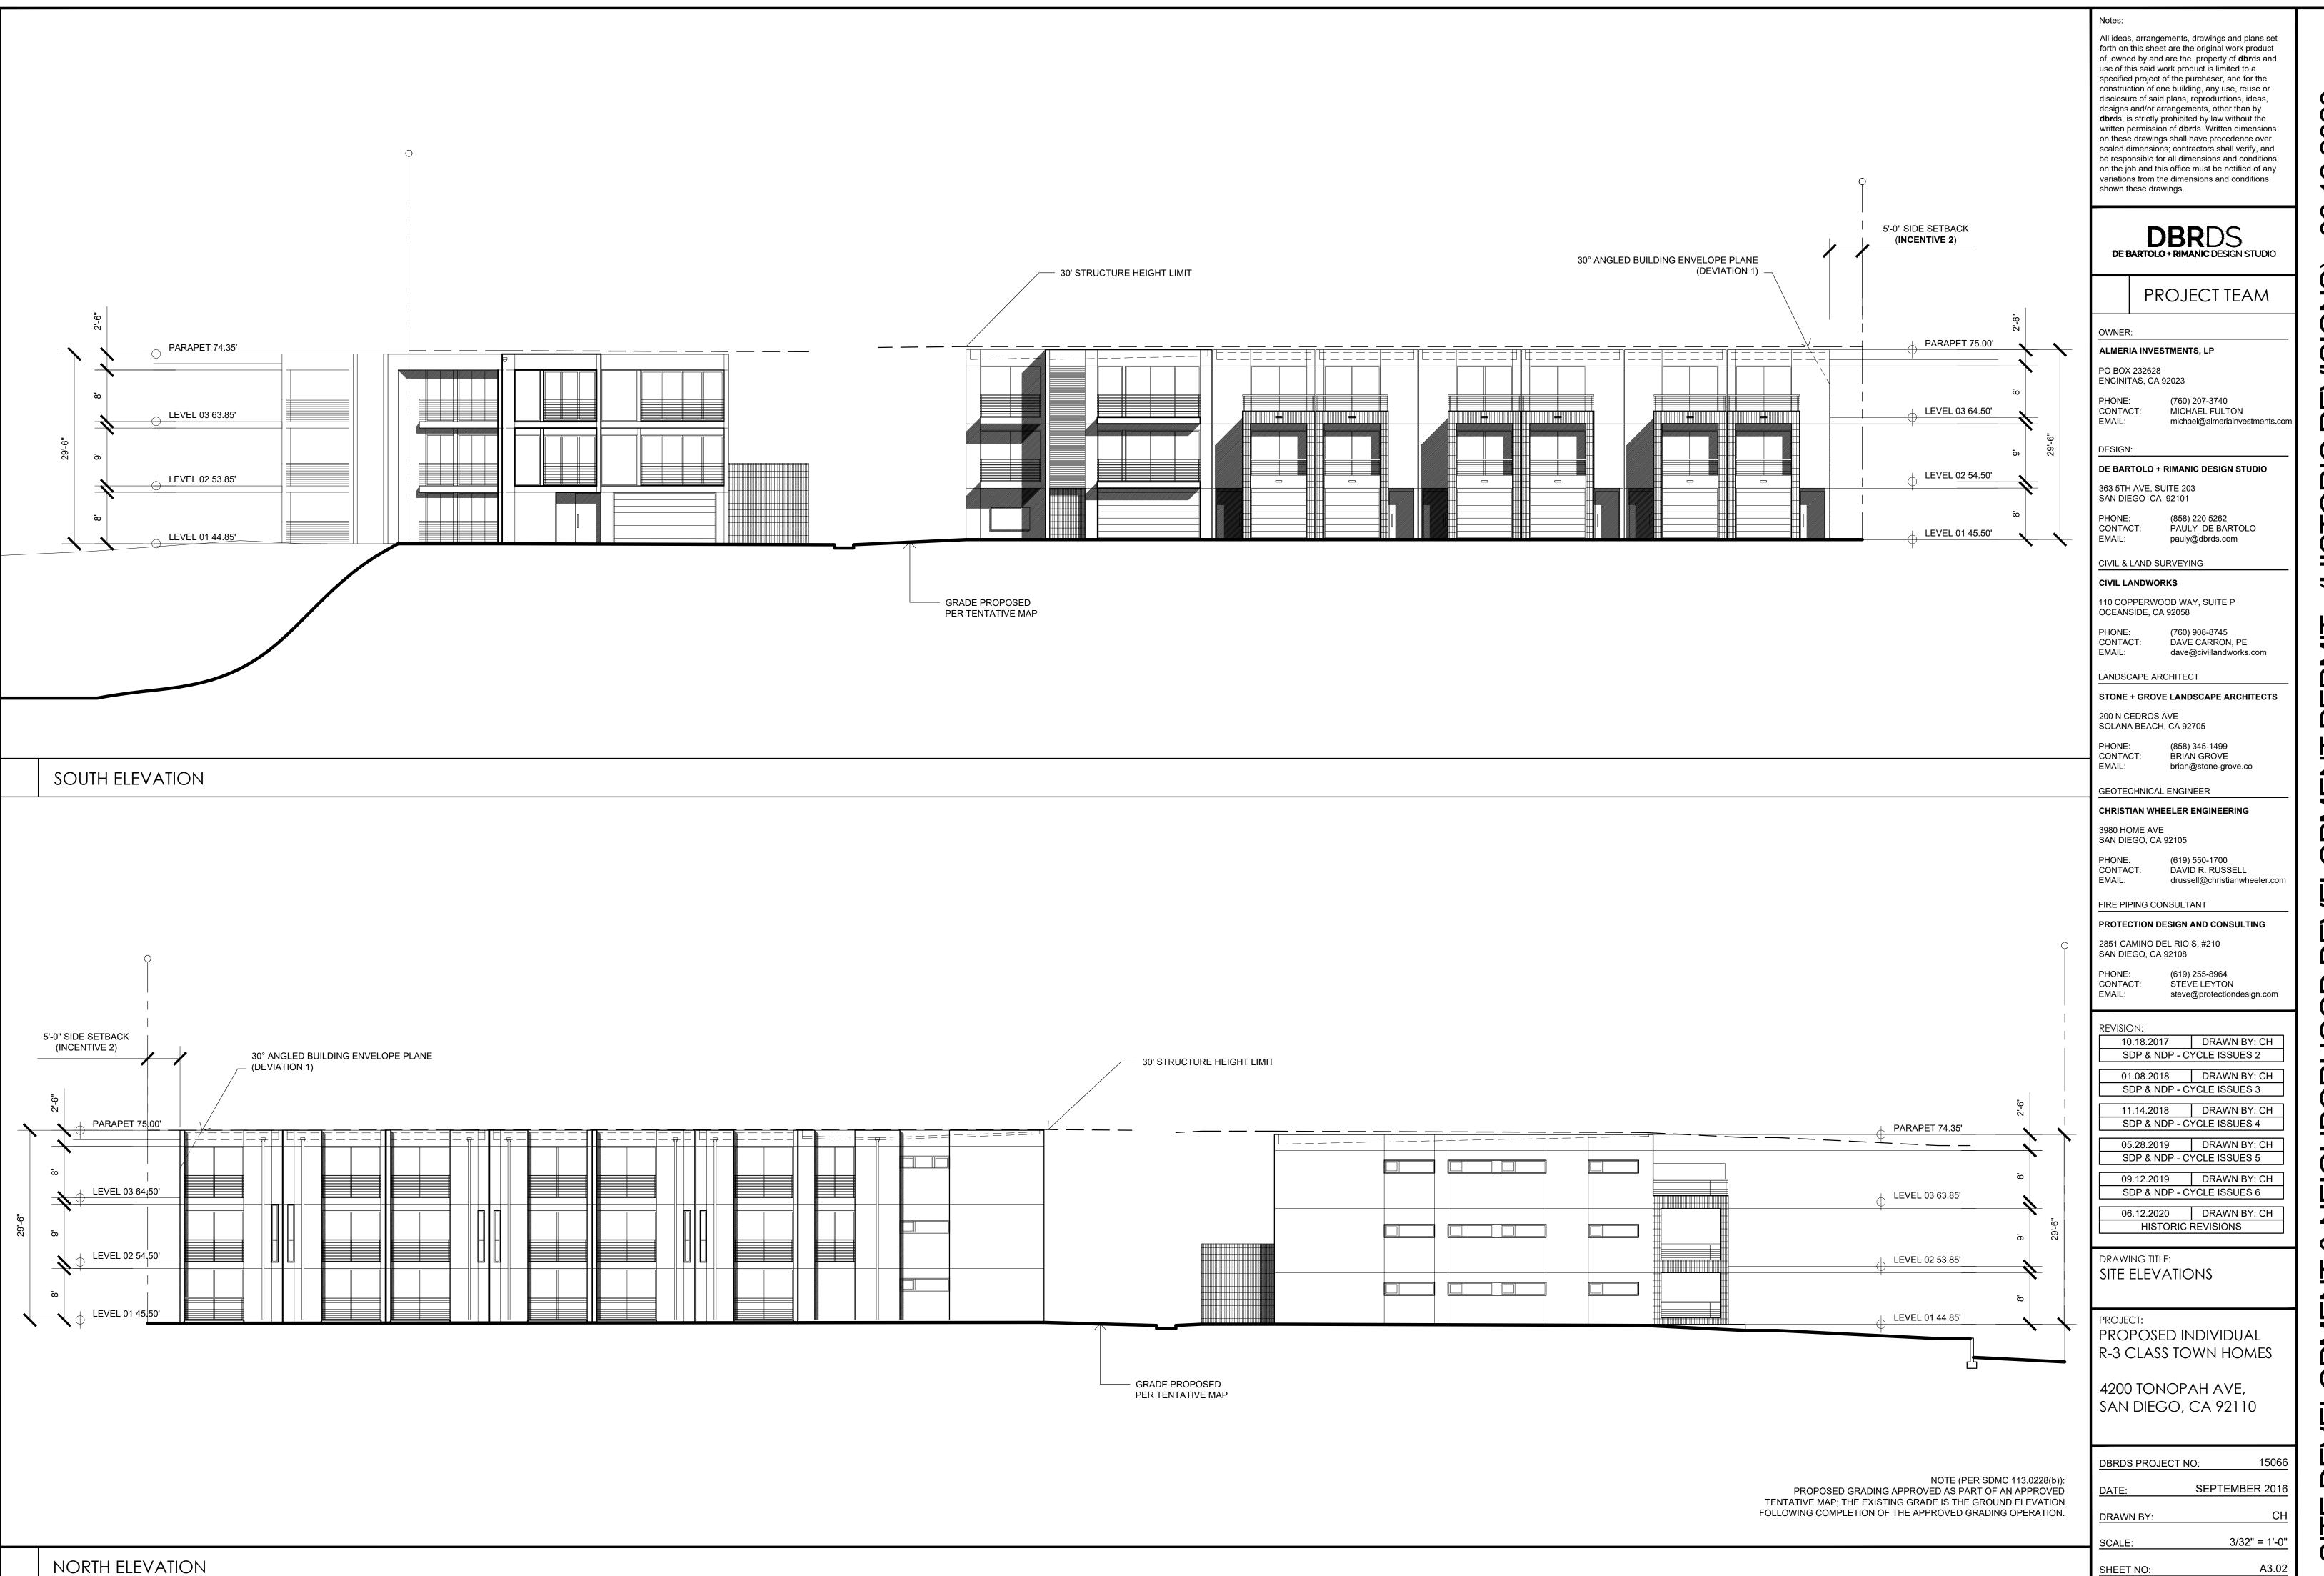
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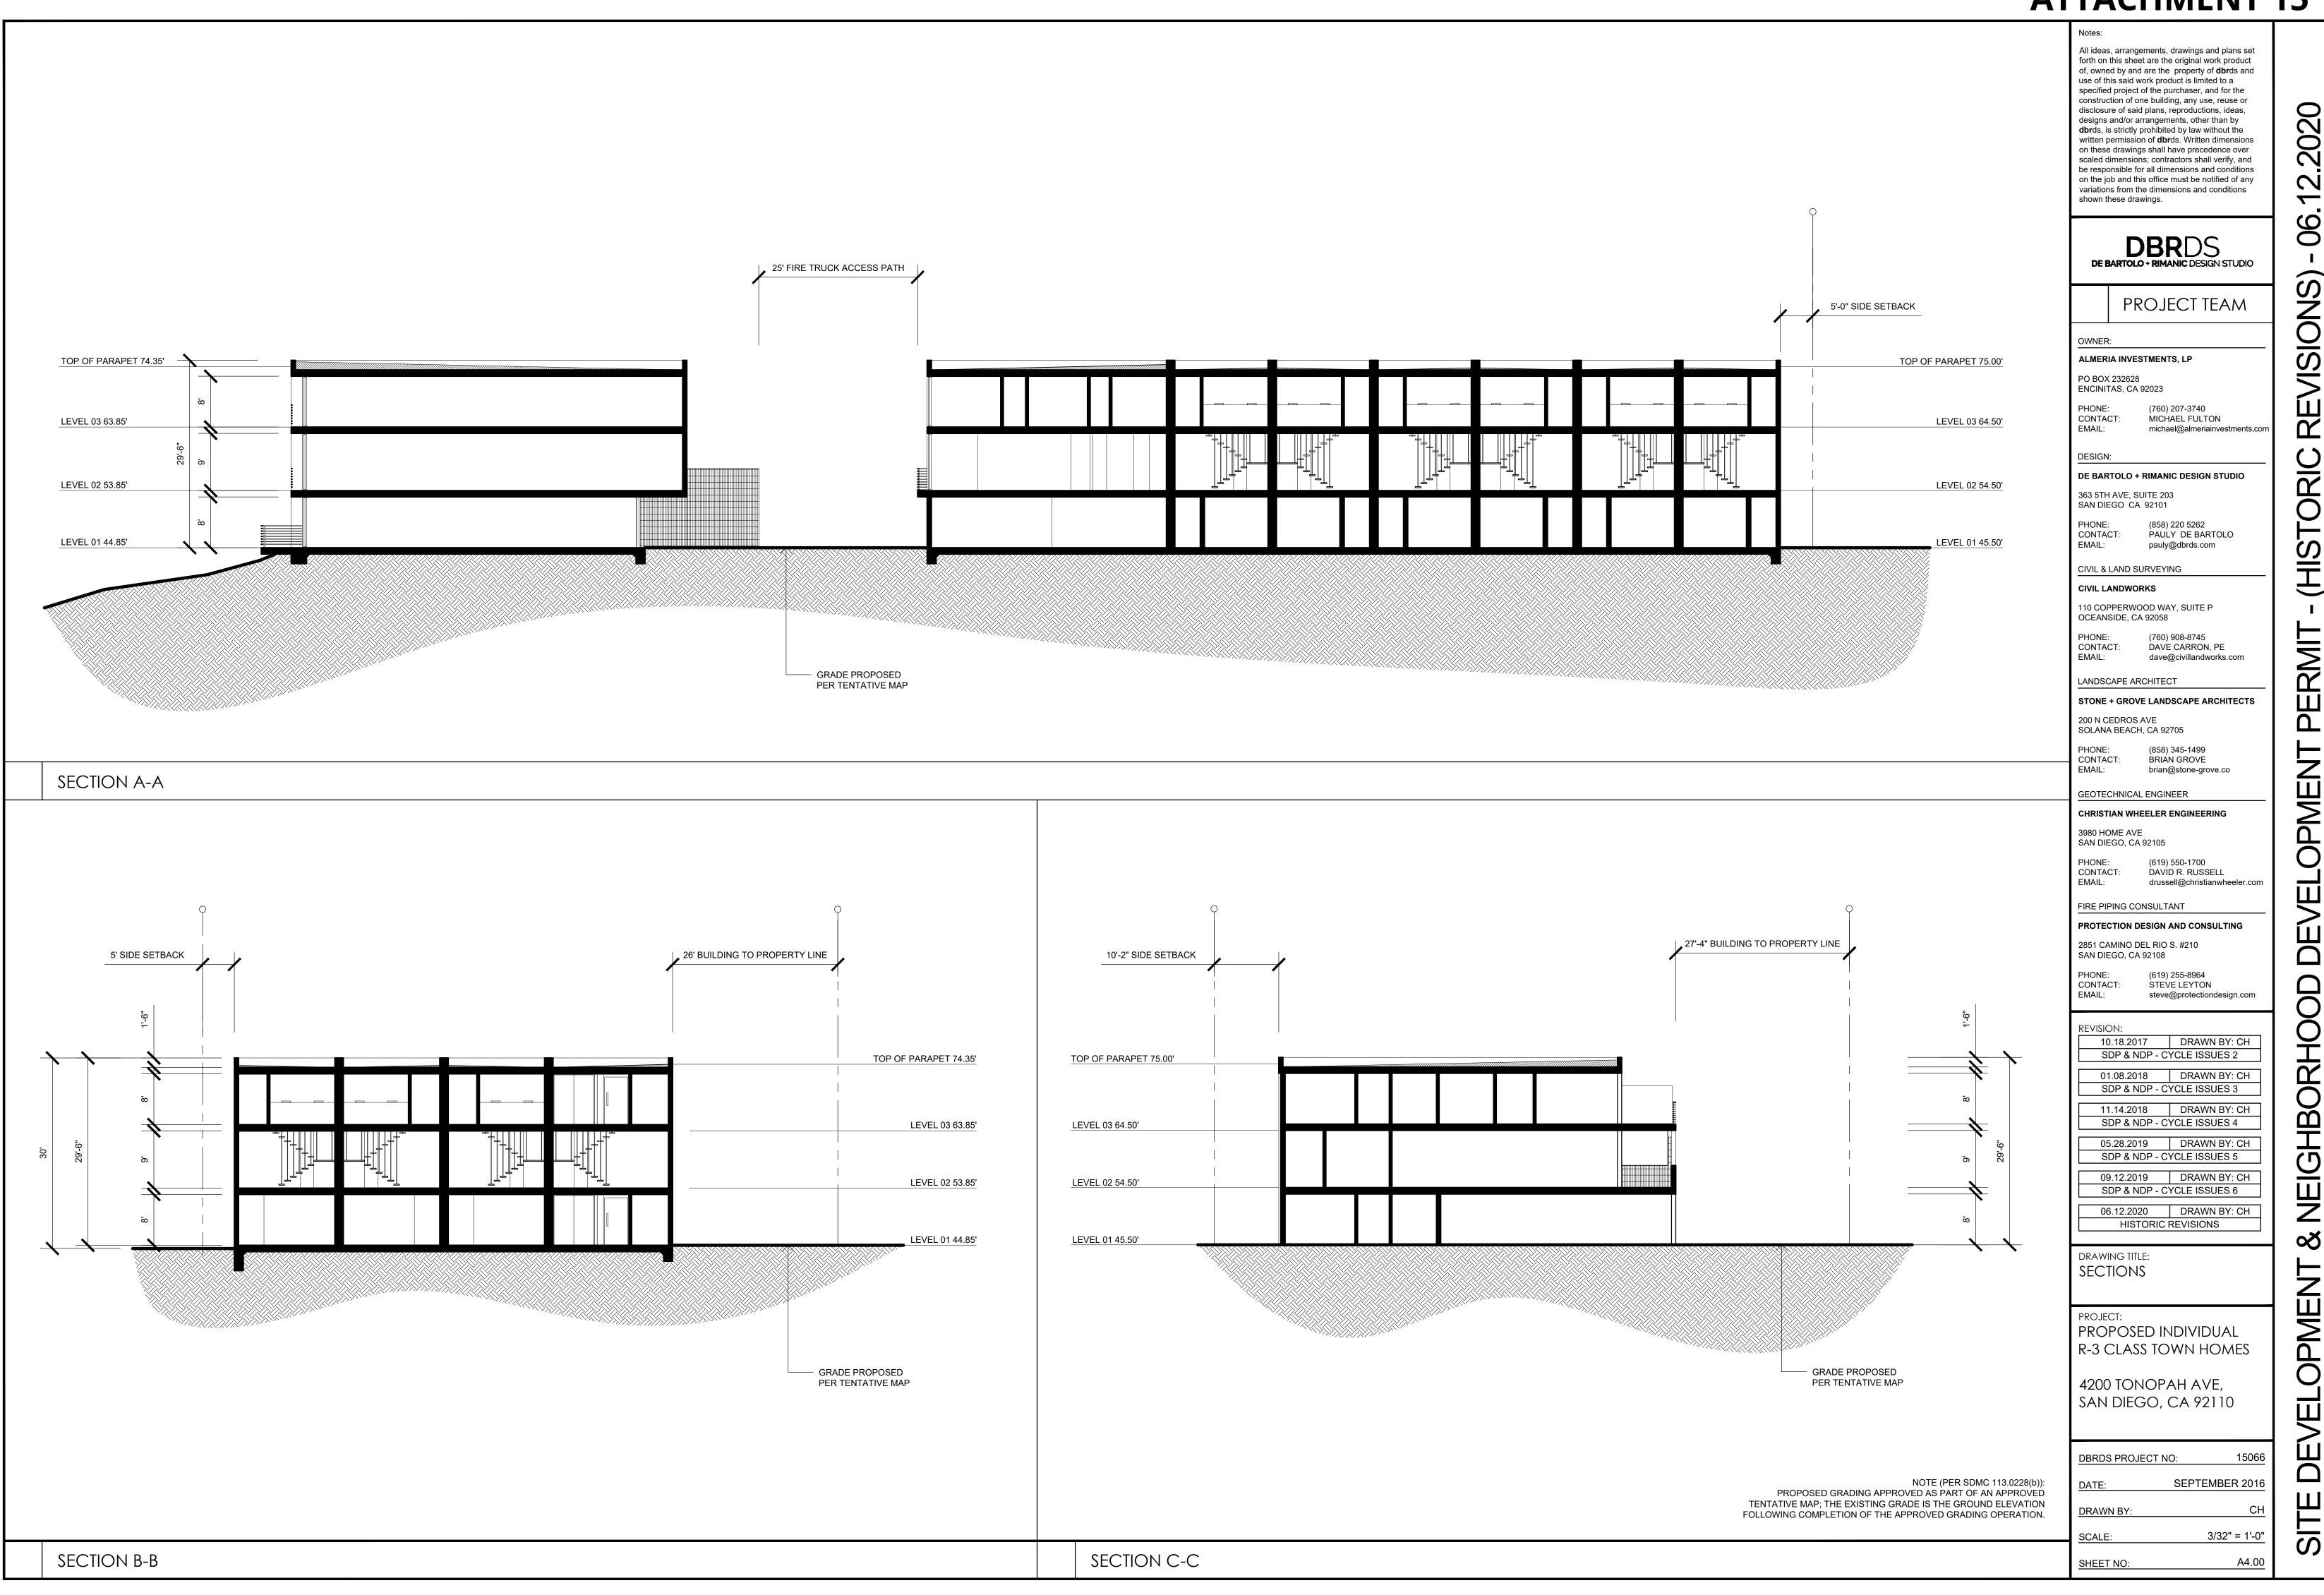
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ATTACHMENT 15 All ideas, arrangements, drawings and plans set forth on this sheet are the original work product of, owned by and are the property of **dbr**ds and use of this said work product is limited to a specified project of the purchaser, and for the construction of one building, any use, reuse or disclosure of said plans, reproductions, ideas, designs and/or arrangements, other than by dbrds, is strictly prohibited by law without the written permission of **dbr**ds. Written dimensions on these drawings shall have precedence over scaled dimensions; contractors shall verify, and be responsible for all dimensions and conditions on the job and this office must be notified of any variations from the dimensions and conditions shown these drawings. 90 5'-0" SIDE SETBACK **DBR**DS (INCENTIVE 2) DE BARTOLO + RIMANIC DESIGN STUDIO PROJECT TEAM OWNER: PARAPET 75.00' ALMERIA INVESTMENTS, LP PO BOX 232628 ENCINITAS, CA 92023 (760) 207-3740 LEVEL 03 64.50' CONTACT: MICHAEL FULTON michael@almeriainvestments.com EMAIL: DESIGN: DE BARTOLO + RIMANIC DESIGN STUDIO LEVEL 02 54.50' 363 5TH AVE, SUITE 203 SAN DIEGO CA 92101 PHONE: (858) 220 5262 CONTACT: PAULY DE BARTOLO LEVEL 01 45.50' EMAIL: pauly@dbrds.com CIVIL & LAND SURVEYING CIVIL LANDWORKS 110 COPPERWOOD WAY, SUITE P OCEANSIDE, CA 92058 (760) 908-8745 CONTACT: DAVÉ CARRON, PE EMAIL: dave@civillandworks.com LANDSCAPE ARCHITECT STONE + GROVE LANDSCAPE ARCHITECTS 200 N CEDROS AVE SOLANA BEACH, CA 92705 CONTACT: BRIÁN GROVE brian@stone-grove.co GEOTECHNICAL ENGINEER CHRISTIAN WHEELER ENGINEERING 3980 HOME AVE SAN DIEGO, CA 92105 (619) 550-1700 CONTACT: DAVID R. RUSSELL drussell@christianwheeler.com FIRE PIPING CONSULTANT PROTECTION DESIGN AND CONSULTING 2851 CAMINO DEL RIO S. #210 SAN DIEGO, CA 92108 CONTACT: STEVE LEYTON steve@protectiondesign.com 10.18.2017 DRAWN BY: CH SDP & NDP - CYCLE ISSUES 2 01.08.2018 DRAWN BY: CH SDP & NDP - CYCLE ISSUES 3 11.14.2018 DRAWN BY: CH SDP & NDP - CYCLE ISSUES 4 05.28.2019 DRAWN BY: CH SDP & NDP - CYCLE ISSUES 5 09.12.2019 DRAWN BY: CH SDP & NDP - CYCLE ISSUES 6 LEVEL 03 63.85' 06.12.2020 DRAWN BY: CH HISTORIC REVISIONS DRAWING TITLE: LEVEL 02 53.85' SITE ELEVATIONS LEVEL 01 44.85' PROPOSED INDIVIDUAL R-3 CLASS TOWN HOMES 4200 TONOPAH AVE, SAN DIEGO, CA 92110 回 15066 DBRDS PROJECT NO: NOTE (PER SDMC 113.0228(b)): SEPTEMBER 2016 CH DRAWN BY: 3/32" = 1'-0"





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NATURAL ANODIZED ALUMINUM FRAMED GARAGE DOOR

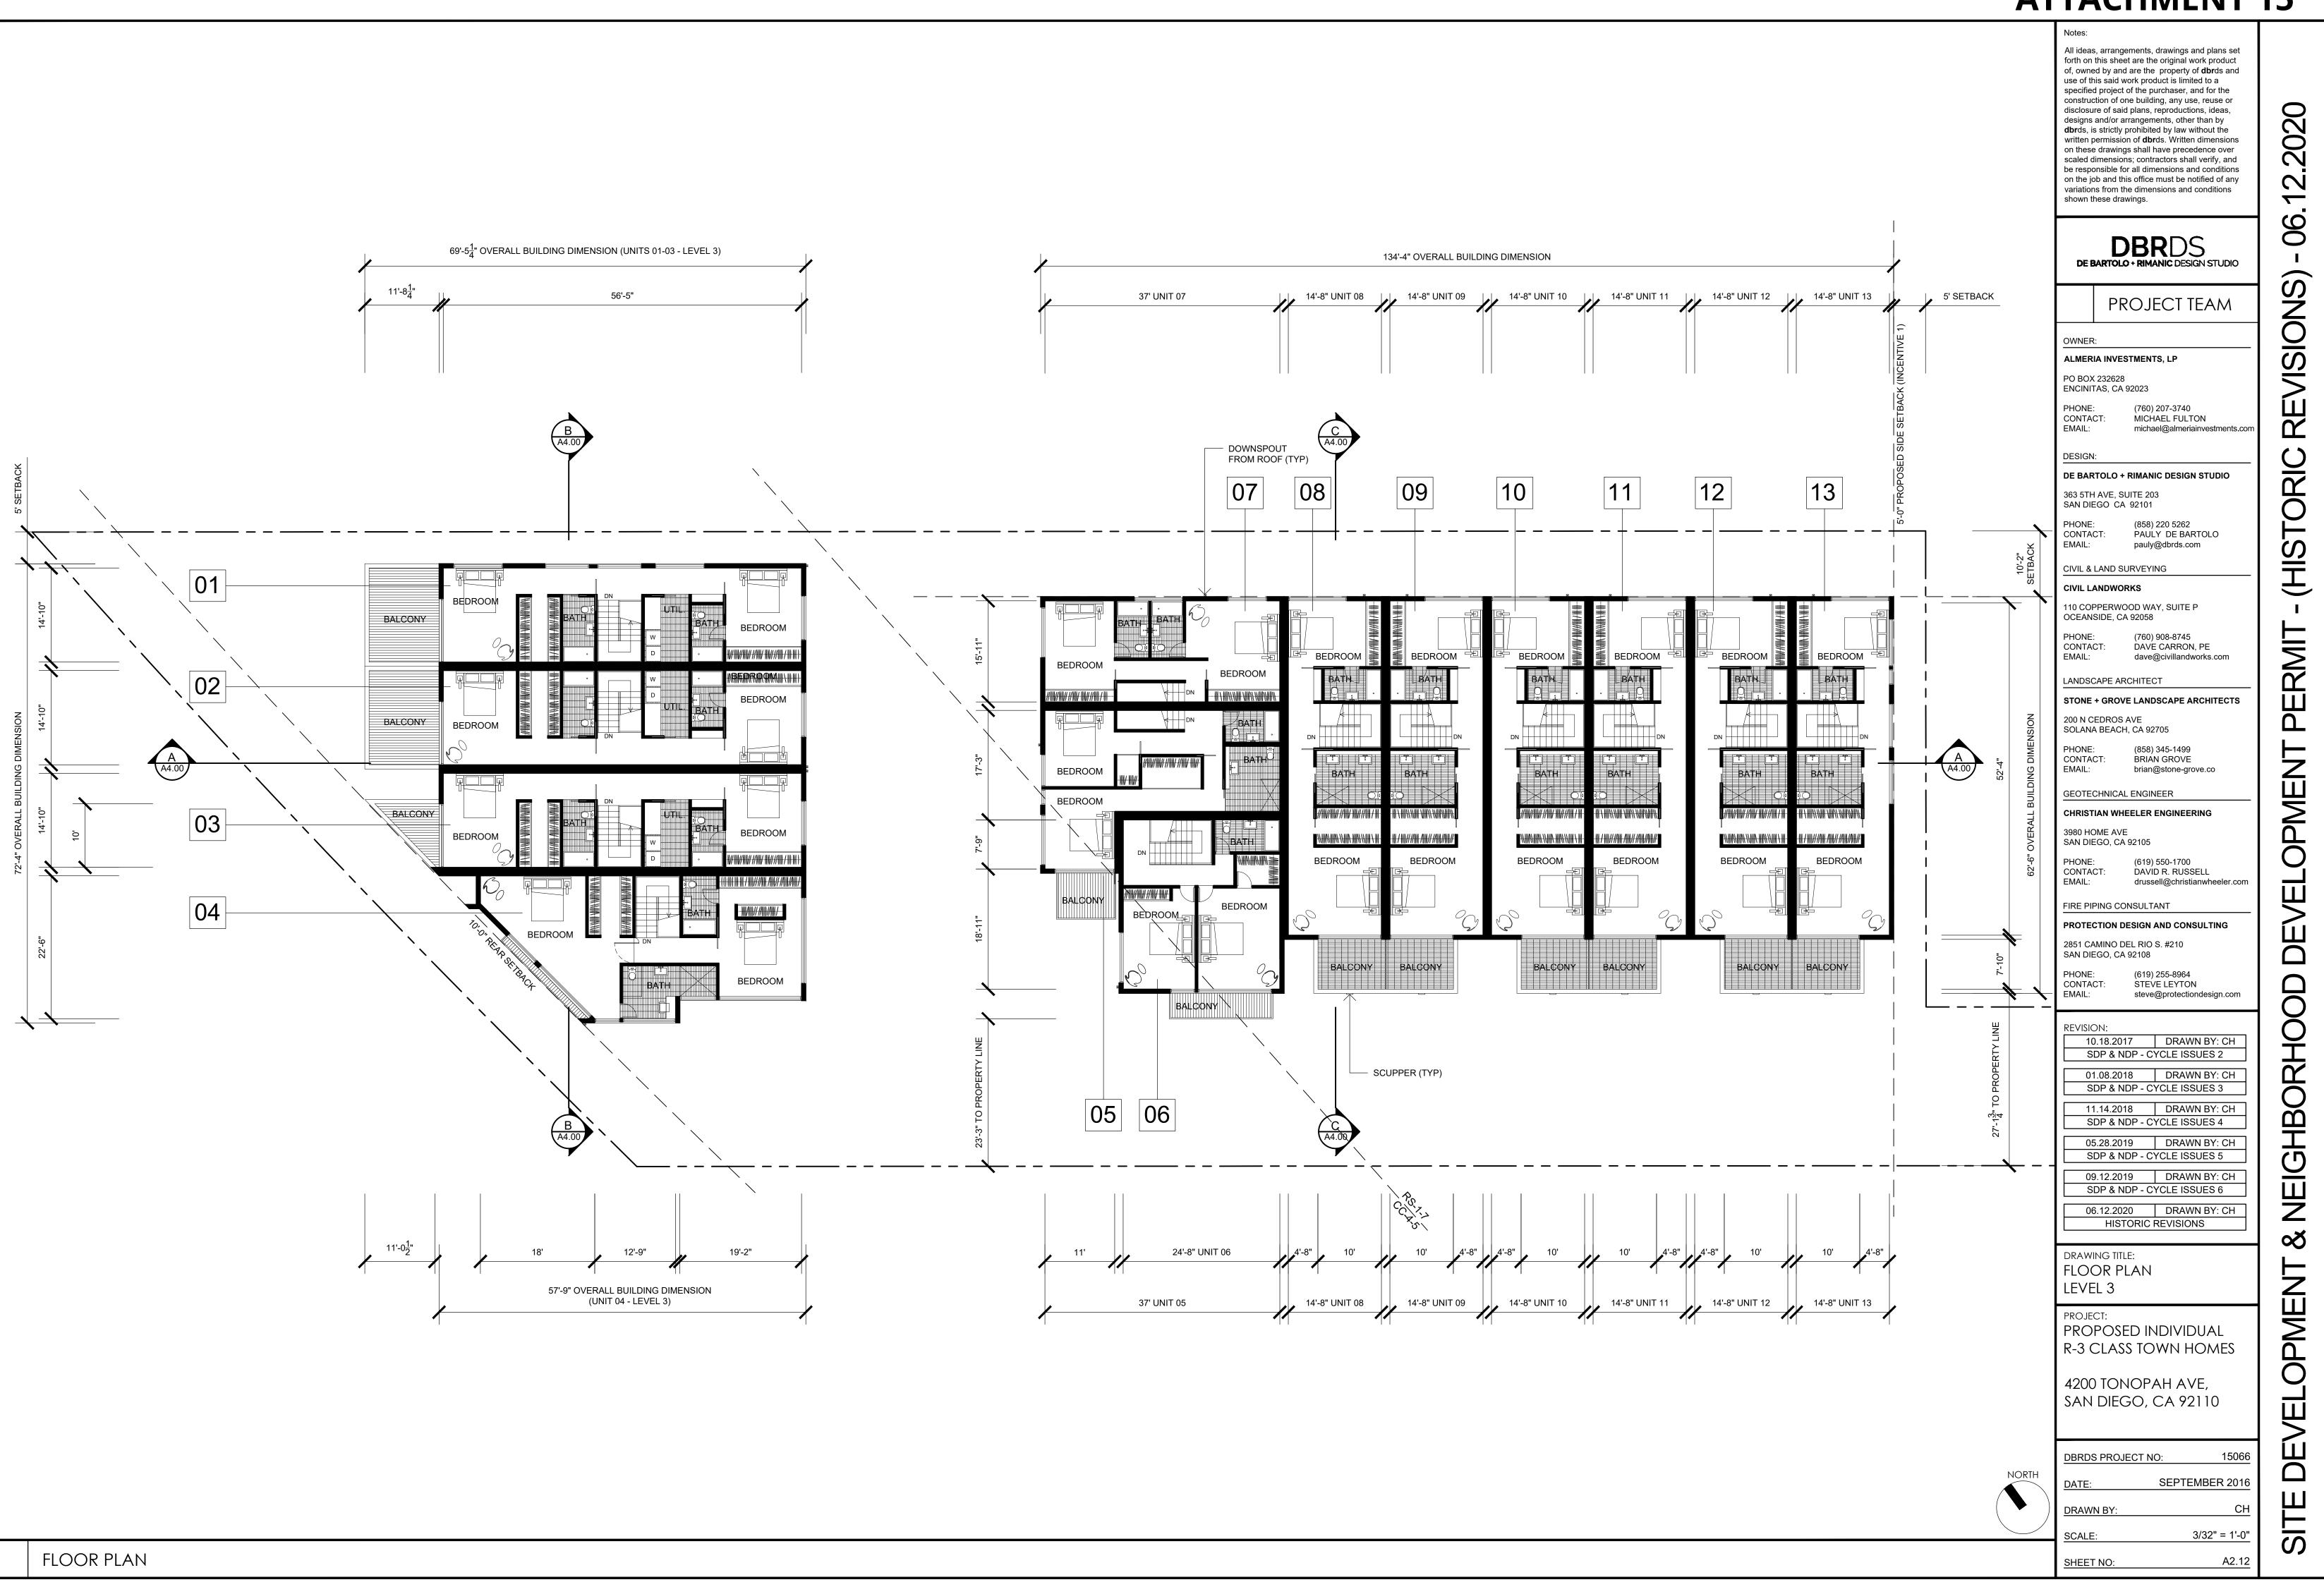PIVOT -HINGED FRONT DOOR

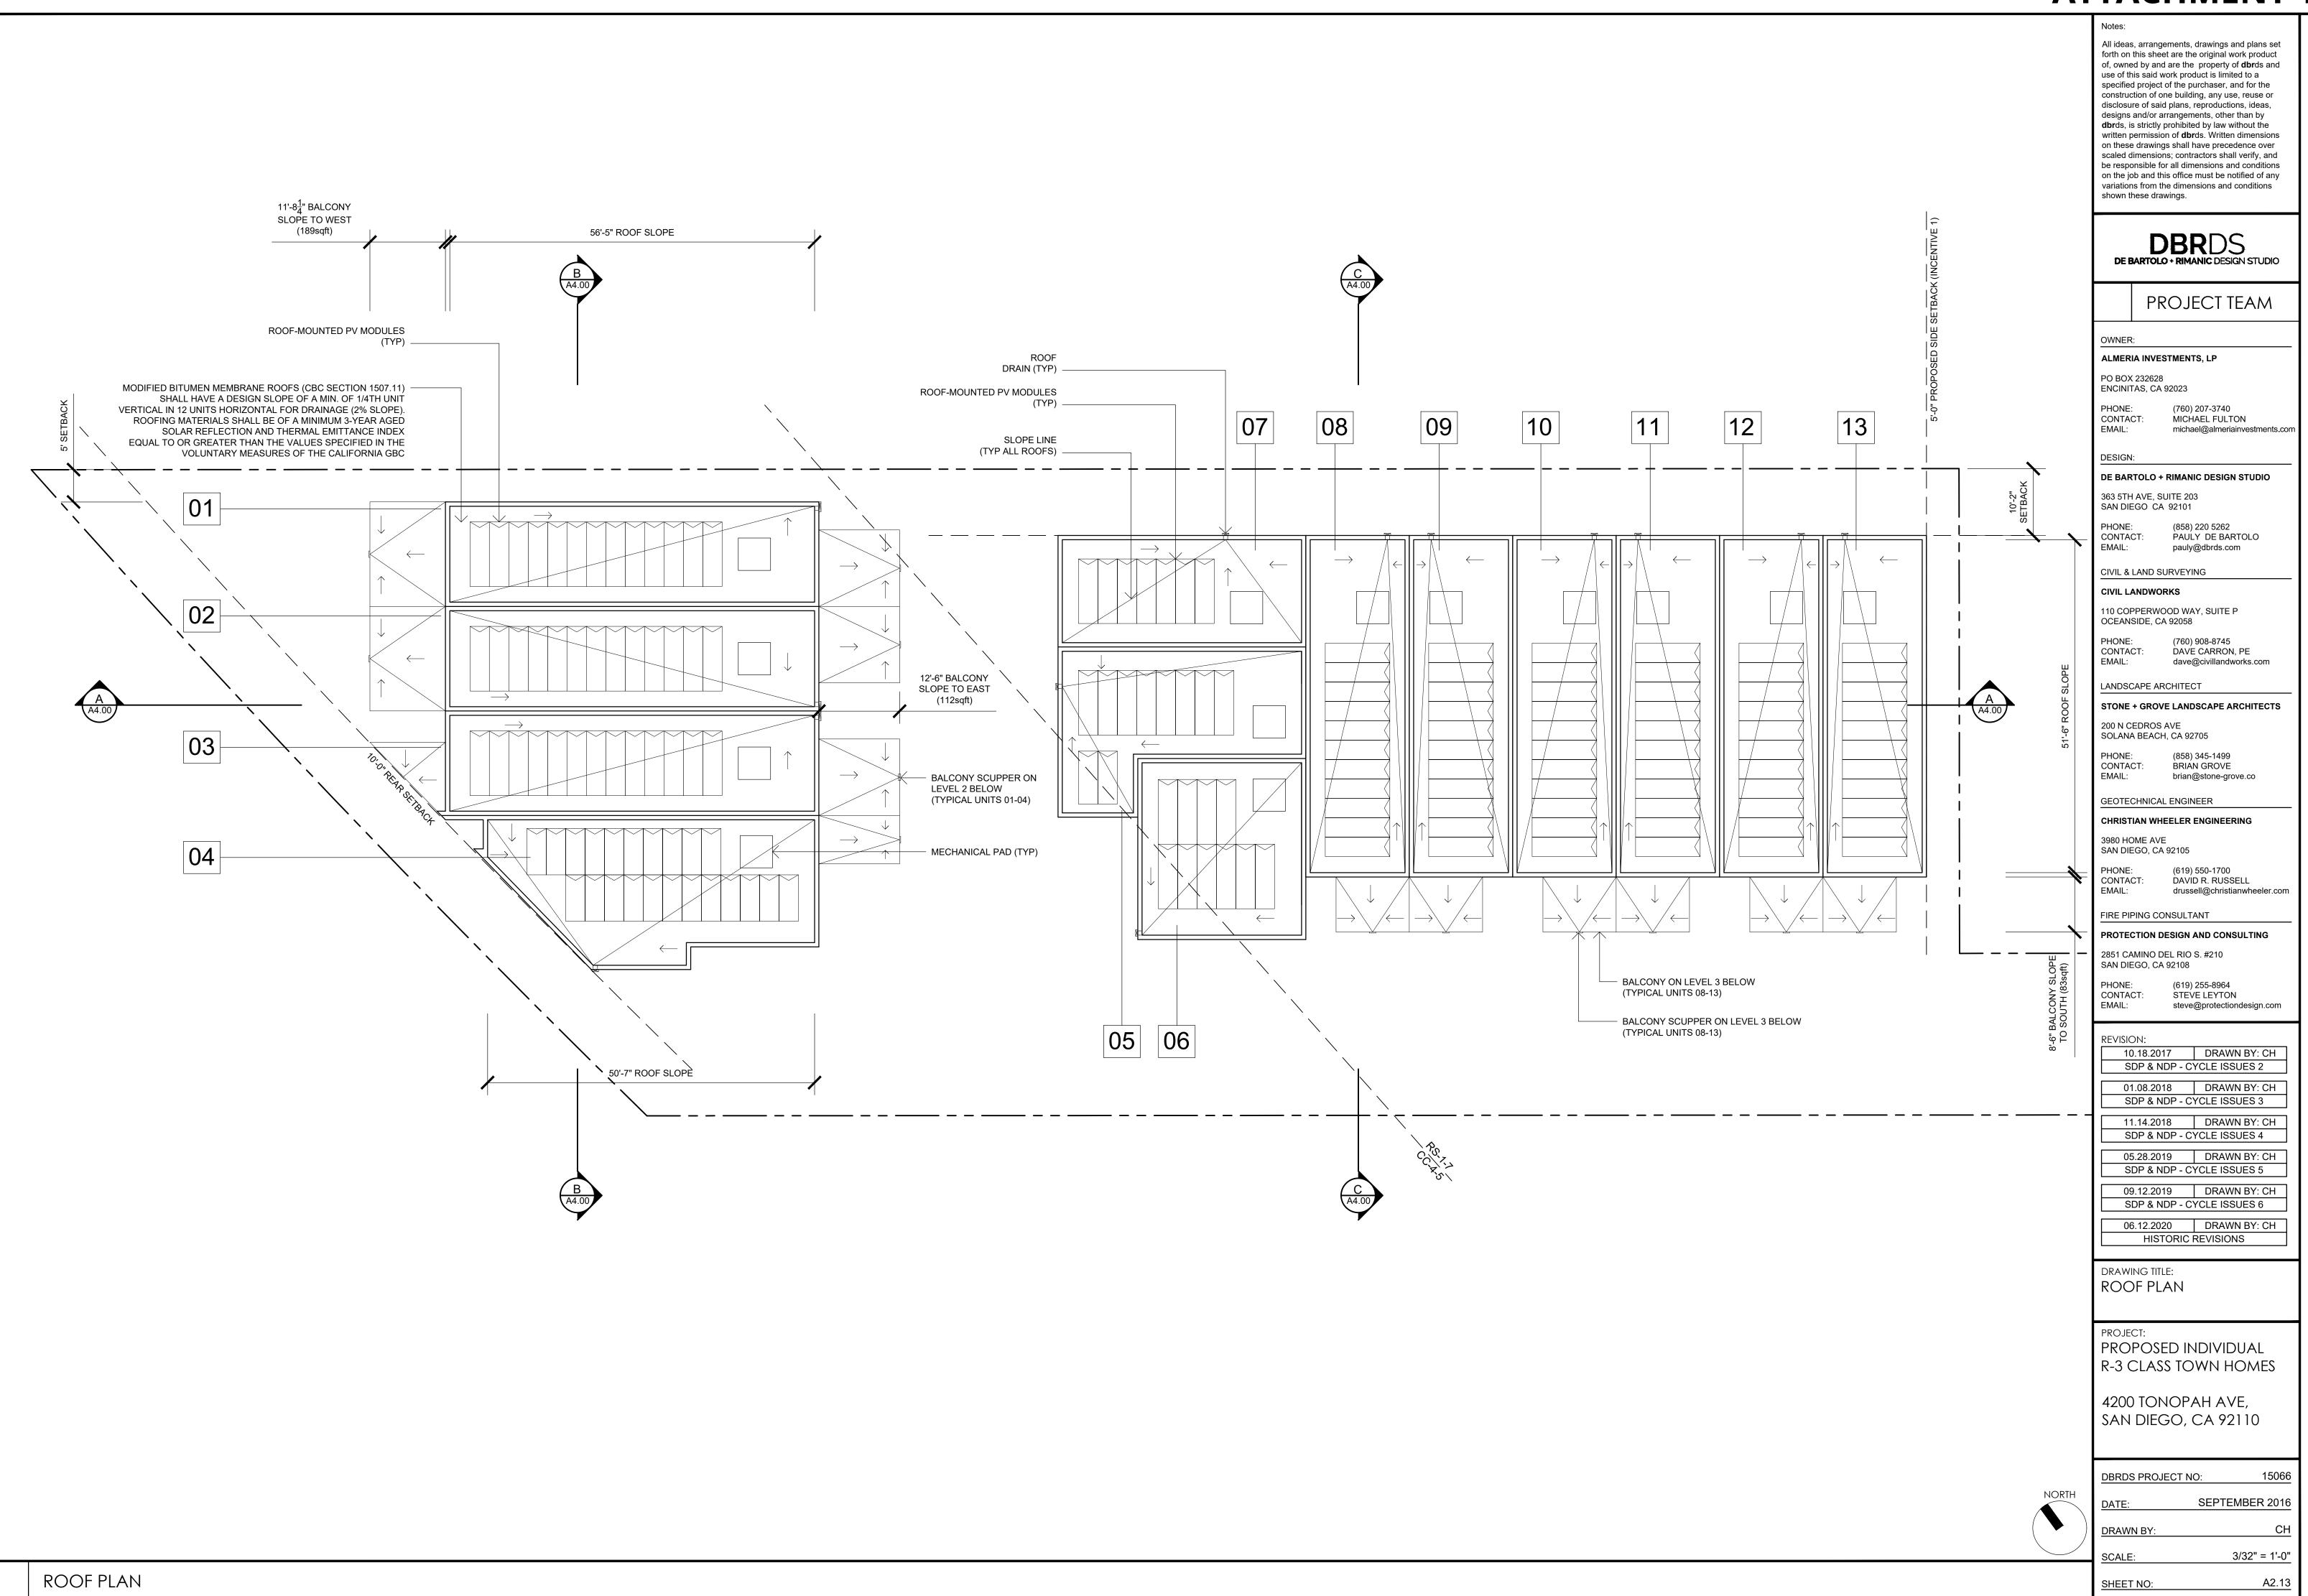STUCCO PATTERN FINISH HORIZONTAL / VERTICAL COMB

use of this said work product is limited to a specified project of the purchaser, and for the construction of one building, any use, reuse or disclosure of said plans, reproductions, ideas, designs and/or arrangements, other than by dbrds, is strictly prohibited by law without the written permission of **dbr**ds. Written dimensions on these drawings shall have precedence over scaled dimensions; contractors shall verify, and be responsible for all dimensions and conditions on the job and this office must be notified of any variations from the dimensions and conditions shown these drawings. **DBR**DS

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PROJECT TEAM

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REVISION:

10.18.2017 DRAWN BY: CH SDP & NDP - CYCLE ISSUES 2 01.08.2018 DRAWN BY: CH

SDP & NDP - CYCLE ISSUES 3 11.14.2018 DRAWN BY: CH

SDP & NDP - CYCLE ISSUES 4

05.28.2019 DRAWN BY: CH SDP & NDP - CYCLE ISSUES 5

NEIGHBORHO

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/ELOPMENT

A5.00

09.12.2019 DRAWN BY: CH SDP & NDP - CYCLE ISSUES 6

06.12.2020 DRAWN BY: CH HISTORIC REVISIONS

DRAWING TITLE: MATERIALS BOARD

PROPOSED INDIVIDUAL R-3 CLASS TOWN HOMES

4200 TONOPAH AVE, SAN DIEGO, CA 92110

DBRDS PROJECT NO: 15066 SEPTEMBER 2016 CH

DRAWN BY:

SHEET NO:

MATERIALS BOARD (SOUTH ELEVATION)



STUCCO - SANTA BARBARA FINISH

STUCCO - SANTA BARBARA FINISH

GRAY

WHITE

NOT USED

HORIZONTAL PAINTED METAL BALUSTRADE GRAY

NATURAL ANODIZED ALUMINUM FRAMED OPERABLE GLAZING

FEATURE EXTERIOR BRICK **BROWN/EARTH TONES**



Landscape Development Plan

1. ALL LANDSCAPE AND IRRIGATION SHALL CONFORM TO THE STANDARDS OF THE CITY-WIDE LANDSCAPE REGULATIONS, THE CITY OF SAN DIEGO LAND DEVELOPMENT MANUAL, LANDSCAPE STANDARDS, AND ALL OTHER LANDSCAPE RELATED CITY AND REGIONAL STANDARDS. 2. MAINTENANCE: ALL REQUIRED LANDSCAPE AREAS SHALL BE MAINTAINED BY THE OWNER. LANDSCAPE & IRRIGATION AREAS IN THE PUBLIC ROW

SHALL BE MAINTAINED BY THE OWNER. LANDSCAPE AREAS SHALL BE MAINTAINED FREE OF DEBRIS AND LITTER AND ALL PLANT MATERIAL SHALL BE MAINTAINED IN A HEALTHY GROWING CONDITION. DISEASED OR DEAD PLANT MATERIAL SHALL BE SATISFACTORILY TREATED OR REPLACED PER THE CONDITIONS OF THE PERMIT. 3. IRRIGATION: AN AUTOMATIC, ELECTRICALLY CONTROLLED IRRIGATION SYSTEM SHALL BE PROVIDED AS REQUIRED FOR PROPER IRRIGATION,

DEVELOPMENT, AND MAINTENANCE OF THE VEGETATION IN A HEALTHY, DISEASE-RESISTANT CONDITION. THE DESIGN OF THE SYSTEM SHALL PROVIDE ADEQUATE SUPPORT FOR THE VEGETATION SELECTED. THE PROPOSED IRRIGATION SYSTEM SHALL BE A COMBINATION OF POP-UP SPRAY

4. ALL GRADED, DISTURBED, OR ERODED AREAS THAT WILL NOT BE PERMANENTLY PAVED OR COVERED BY STRUCTURES SHALL BE PERMANENTLY REVEGETATED AND IRRIGATED AS SHOWN IN TABLE 142-04F AND IN ACCORDANCE WITH THE STANDARDS IN THE LAND DEVELOPMENT MANUAL [142.0411(a)]. 5. ARCHITECTURAL ELEVATIONS AND FEATURES SHALL BE CONSIDERED AND ENHANCED WITH PLANTINGS OF SIMILAR DESIGN CHARACTER.

6. LANDSCAPE FINISH GRADING OBJECTIVES WILL INCLUDE POSITIVE SURFACE DRAINAGE OF PLANTED AREAS THROUGHOUT THE SITE. 7. THE PLANT PALETTE LISTED PROVIDES A LIST OF PLANT MATERIAL TO SELECT FROM WHEN DESIGNING THE LANDSCAPE. HOWEVER, SUBSTITUTIONS MAY BE REQUIRED DUE TO AVAILABILITY, SOILS TEST RESULTS, OR OTHER INFLUENCES.

8. ALL PLANT MATERIAL SELECTED FOR USE WILL BE OF A TYPE KNOWN TO BE SUCCESSFUL IN THE AREA OR IN SIMILAR CLIMATIC AND SOIL CONDITIONS.

9. COLOR FROM PLANT FOLIAGE, BARK, OR FLOWERS WILL BE UTILIZED TO CREATE A FRIENDLY, WARM, AND VISUALLY EXCITING LANDSCAPE ENVIRONMENT. THEMATIC COLOR SCHEMES WILL BE UTILIZED IN DEVELOPING PROJECT IDENTITY.

10. A SOIL TEST BY A QUALIFIED AGRONOMIST SHALL FURTHER INFLUENCE PLANT MATERIALS AND INSTALLATION TECHNIQUES. 11. ALL SOILS WILL BE FERTILIZED, AMENDED, AND TILLED TO CONFORM TO RECOMMENDATIONS MADE BY A SOIL TESTING LABORATORY AND/OR LANDSCAPE ARCHITECT IN ORDER TO PROMOTE HEALTHY AND VIGOROUS PLANT GROWTH.

12. ALL PROPOSED PLANTING AREAS SHALL BE TREATED WITH SOIL CONDITIONERS TO INCREASE AND RETAIN SOIL MOISTURE.

13. MULCH: ALL REQUIRED PLANTING AREAS AND ALL EXPOSED SOIL AREAS WITHOUT VEGETATION SHALL BE COVERED WITH MULCH TO A MINIMUM DEPTH OF 3 INCHES, EXCLUDING SLOPES REQUIRING REVEGETATION PER SDMC 142.0411.

14. ALL PLANTING AREAS WILL BE MAINTAINED IN A WEED AND DEBRIS FREE CONDITION. 15. NON-BIODEGRADABLE ROOT BARRIERS SHALL BE INSTALLED ADJACENT HARDSCAPE FOR ALL STREET TREES. ROOT BARRIERS MAY BE

ELIMINATED WHERE THE COMBINATION OF TREE SPECIES, SOIL TYPE, SOIL AREA, AND DRAINAGE CONDITIONS CAN BE SHOWN TO AFFORD EQUIVALENT PROTECTION AGAINST TREE ROOT DAMAGE TO PUBLIC IMPROVEMENTS.

PLANT SCHEDULE

| TREES | BOTANICAL / COMMON NAME | CONT | <u>QTY</u> |
|---------------|--|---------|------------|
| | ARCHONTOPHOENIX CUNNINGHAMIANA / KING PALM | 15` BTH | 7 |
| (\cdot) | CERCIDIUM X `DESERT MUSEUM` / THORNLESS PALO VERDE | 48"BOX | 2 |
| $\overline{}$ | PYRUS CALLERYANA `CAPITAL` / CAPITAL CALLERY PEAR | 36"BOX | 2 |
| <u>SHRUBS</u> | BOTANICAL / COMMON NAME | SIZE | QTY |
| \odot | CAREX DIVULSA / BERKELEY SEDGE | 1 GAL | 9 |
| | CHONDROPETALUM TECTORUM 'EL CAMPO' / CAPE RUSH | 5 GAL | 66 |
| 2.2 | DODONAEA VISCOSA `PURPUREA` / GREEN HOPSEED BUSH | 15 GAL | 16 |
| | LEYMUS CONDENSATUS `CANYON PRINCE` / NATIVE BLUE RYE | 5 GAL | 19 |

| <u>′</u> | <u>(\$)</u> | MUHLENBERGIA CAPILLARIS 'REGAL MIST' TM / MUHLY | 5 GAL | | 3 |
|----------|---------------|---|--------|----------|------------|
| | | PODOCARPUS X `ICEE BLUE` / ICEE BLUE PODOCARPUS | 15 GAL | | 11 |
| | \odot | RHAPHIOLEPIS UMBELLATA `MINOR` / YEDDA HAWTHORN | 5 GAL | | 5 |
| | GROUND COVERS | BOTANICAL / COMMON NAME | CONT | SPACING | <u>QTY</u> |
| <u>′</u> | | ACACIA REDOLENS `DESERT CARPET` TM / BANK CATCLAW | 1 GAL | 48" o.c. | 80 SF |
| | | CAREX DIVULSA / EUROPEAN GREY SEDGE | 4" POT | 1" o.c. | 233 SI |

| FOUND 2" \$RONHPHPRIZANDAIDISCOIMARKEDICTRCE PER MAP NO. 1534," PER MAP NO. 131.0456+143.0310(g) 788 | | | "B" ET 2" IRON PIPE AND DISC MARKED 211," PER FINAL MAP TO BE PREPARED. LOT 7 MAP 3134 |
|--|--|--|---|
| PROPERTY LINE PROPERTY LINE | MOTORCYCLÉ PARKING | PROPERTY LINE | LOT 8 MAP 3134 WILL SET 2" IRON PIPE |
| DECORATIVE FÉNCE ÈLÈMENT TO SATISPY HISTORICAL SOCIETY AGRICULTURAL REFERENCE - 3 GLASS PANELS (20' LONG X 48" HIGH) - GLASS PANELS TO BE ETCHED FROSTED TO MIMIC ROWS OF CROPS (SEE ÈLEVATION BELOW) THE REPRESENTATIVE GLASS ETCHED PANELS WILL RUN PARALLEL TO MORENA BLVD WHICH WILL BE VISIBLE FROM THE STREET AS WELL AS INTERSTATE 5. THIS IS THE BUSIEST PORTION OF THE LOT FOR MAXIMUM VIEWING. 4' WIDE PATH TO COMMON USE AREA | 5.97 TRASH | | AND DISC MARKED "LS 8211," PER FINAL MAP TO BE PREPARED. PROXIMATE LOCATION OF HISTORICAL PLAQUE AND DISC MARKED "LS 8211," PER FINAL MAP TO BE PREPARED. E(OH) E(OH) |
| W/ BACKFLOW PREVENTER & WILL SET | TALL 3" DEPTH OF RIVER COBBLE W/ WEED CLOTH WN ENTIRE LENGTH OF DRIVEWAY KICAN SUNBURST' 3" DIA. OR EQUAL 1-2" IRON PIPE AND DISC MARKED 1-3" PER FINAL MAP TO BE PREPARED. MAP 401 | PROPERTY LINE INSTALL 3" DE DOWN ENTIR 'MEXICAN SUI | TONOP PTH OF RIVER COBBLE W/ WEED CLOTH LENGTH OF DRIVEWAY IBURST' 3" DIA. OR EQUAL WILL SET 2" IRON PIPE AND DISC MARKED "LS 8211," PER FINAL MAP TO BE PREPARED. |

MINIMUM TREE SEPARATION DISTANCE

TRAFFIC SIGNAL, STOP SIGN 20 FEET UNDERGROUND UTILITY LINES (except sewer) 5 FEET SEWER 10 FEET 10 FEET 10 FEET DRIVEWAYS INTERSECTIONS (INTERSECTION CURB LINES 25 FEET OF TWO STREETS)


ALL REQUIRED PLANTING AREAS AND ALL EXPOSED SOIL AREAS WITHOUT VEGETATION SHALL BE COVERED WITH MULCH TO A MINIMUM DEPTH OF 3 INCHES, EXLUDING SLOPES REQUIRING REVEGETATION PER SDMC 142.0411

ALL REQUIRED LANDSCAPE AS SHOWN ON THESE PLANS SHALL BE MAINTAINED BY THE OWNER IN A DISEASE, WEED AND LITTER FREE CONDITION AT ALL TIMES CONSISTENT WITH THE CITY OF SAN DIEGO'S LANDSCAPE REGULATIONS AND STANDARDS.

IF ANY LANDSCAPE INDICATED ON THE APPROVED CONSTRUCTION DOCUMENT PLAN IS DAMAGE OR REMOVED DURING DEMOLITION OR CONSTRUCTION, IT SHALL BE REPAIRED AND/OR REPLACED IN KIND AND EQUIVALENT SIZE PER APPROVED DOCUMENTS TO THE SATISFACTION OF THE DEVELOPMENT SERVICES DEPARTMENT WITHIN 30 DAYS OF DAMAGE.

A MINIMUM ROOT ZONE FO 40SF IN AREA SHALL BE PROVIDED FOR ALL TREES. THE MINIMUM DIMENSION FOR THIS AREA SHALL BE 5 FEET, PER SDMC 142.0403(b)(5).

TREES SHALL BE MAINTAINED SO THAT ALL BRANCHES OVER PEDESTRIAN WALKWAYS ARE 6 FEET ABOVE THE WALKWAY GRADE AND BRANCHES OVER VEHICULAR TRAVEL WAYS ARE 16 FEET ABOVE THE GRADE OF THE TRAVEL PER THE SAN DIEGO MUNICIPAL CODE, SECTION 142.0403 (b)(10).

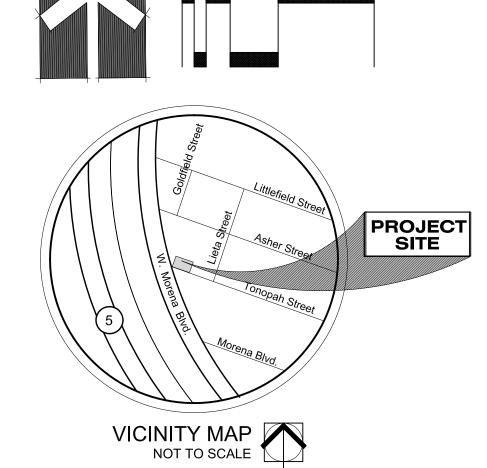



PLANTING PLAN

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DE BARTOLO + RIMANIC DESIGN STUDIO

PROJECT TEAM

OWNER:

CLIENT NAME

XXX@XXXX.XXX

CLIENT NAME CLIENT ADDRESS

CONTACT:

EMAIL:

CLIENT ADDRESS PHONE: (XXX) XXX-XXXX

DESIGN:

DE BARTOLO + RIMANIC DESIGN STUDIO

363 5TH AVE, SUITE 203 SAN DIEGO CA 92101

PHONE: (858) 220 5262 CONTACT: PAULY DE BARTOLO EMAIL: pauly@dbrds.com

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110 COPPERWOOD WAY, SUITE P OCEANSIDE, CA 92058

PHONE: (760) 908-8745 CONTACT: DAVE CARRON, PE EMAIL: dave@civillandworks.com

LANDSCAPE ARCHITECT

STONE + GROVE LANDSCAPE ARCHITECTS

200 N CEDROS AVE SOLANA BEACH, CA 92705

PHONE: (858) 345-1499 CONTACT: **BRIAN GROVE** brian@stone-grove.co EMAIL:

GEOTECHNICAL ENGINEER

CHRISTIAN WHEELER ENGINEERING

SAN DIEGO, CA 92105

CONTACT: DAVID R. RUSSELL

drussell@christianwheeler.com



DRAWN BY: CH 09.13.2016 SITE DEVELOPMENT PERMIT XX.XX.XX DRAWN BY: XX **REVISION LABEL** XX.XX.XX DRAWN BY: XX **REVISION LABEL** XX.XX.XX DRAWN BY: XX REVISION LABEL

DRAWING TITLE: PLANTING PLAN

PROPOSED MULTI-FAMILY RESIDENTIAL APARTMENTS 1398 LIETA STREET, SAN DIEGO, CA 92110

DBRDS PROJECT NO: 15066 **OCTOBER 6 2016** 1"=20'-0"

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> > PROJECT TEAM

OWNER: **CLIENT NAME**

CLIENT ADDRESS **CLIENT ADDRESS**

(XXX) XXX-XXXX CONTACT: CLIENT NAME EMAIL: XXX@XXXX.XXX

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SAN DIEGO CA 92101

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GEOTECHNICAL ENGINEER CHRISTIAN WHEELER ENGINEERING

SAN DIEGO, CA 92105

CONTACT:

STAMP:



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SITE DEVELOPMENT PERMIT

XX.XX.XX DRAWN BY: XX **REVISION LABEL** DRAWN BY: XX XX.XX.XX **REVISION LABEL**

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PLANTING PLAN

DRAWING TITLE:


PROPOSED MULTI-FAMILY RESIDENTIAL APARTMENTS 1398 LIETA STREET, SAN DIEGO, CA 92110

OCTOBER 6 2016 DRAWN BY 1"=20'-0" SCALE:

FENCE ELEVATION 858.345.1499 | www.STONE-GROVE.co. 200 N. CEDROS AVENUE. SOLANA BEACH, CA. 92075 SHEET NO:

\3/8" GLASS PANEL (ETCHED / FROSTED)


ETCHING PATTERN TO MIMIC ROW PLANTING

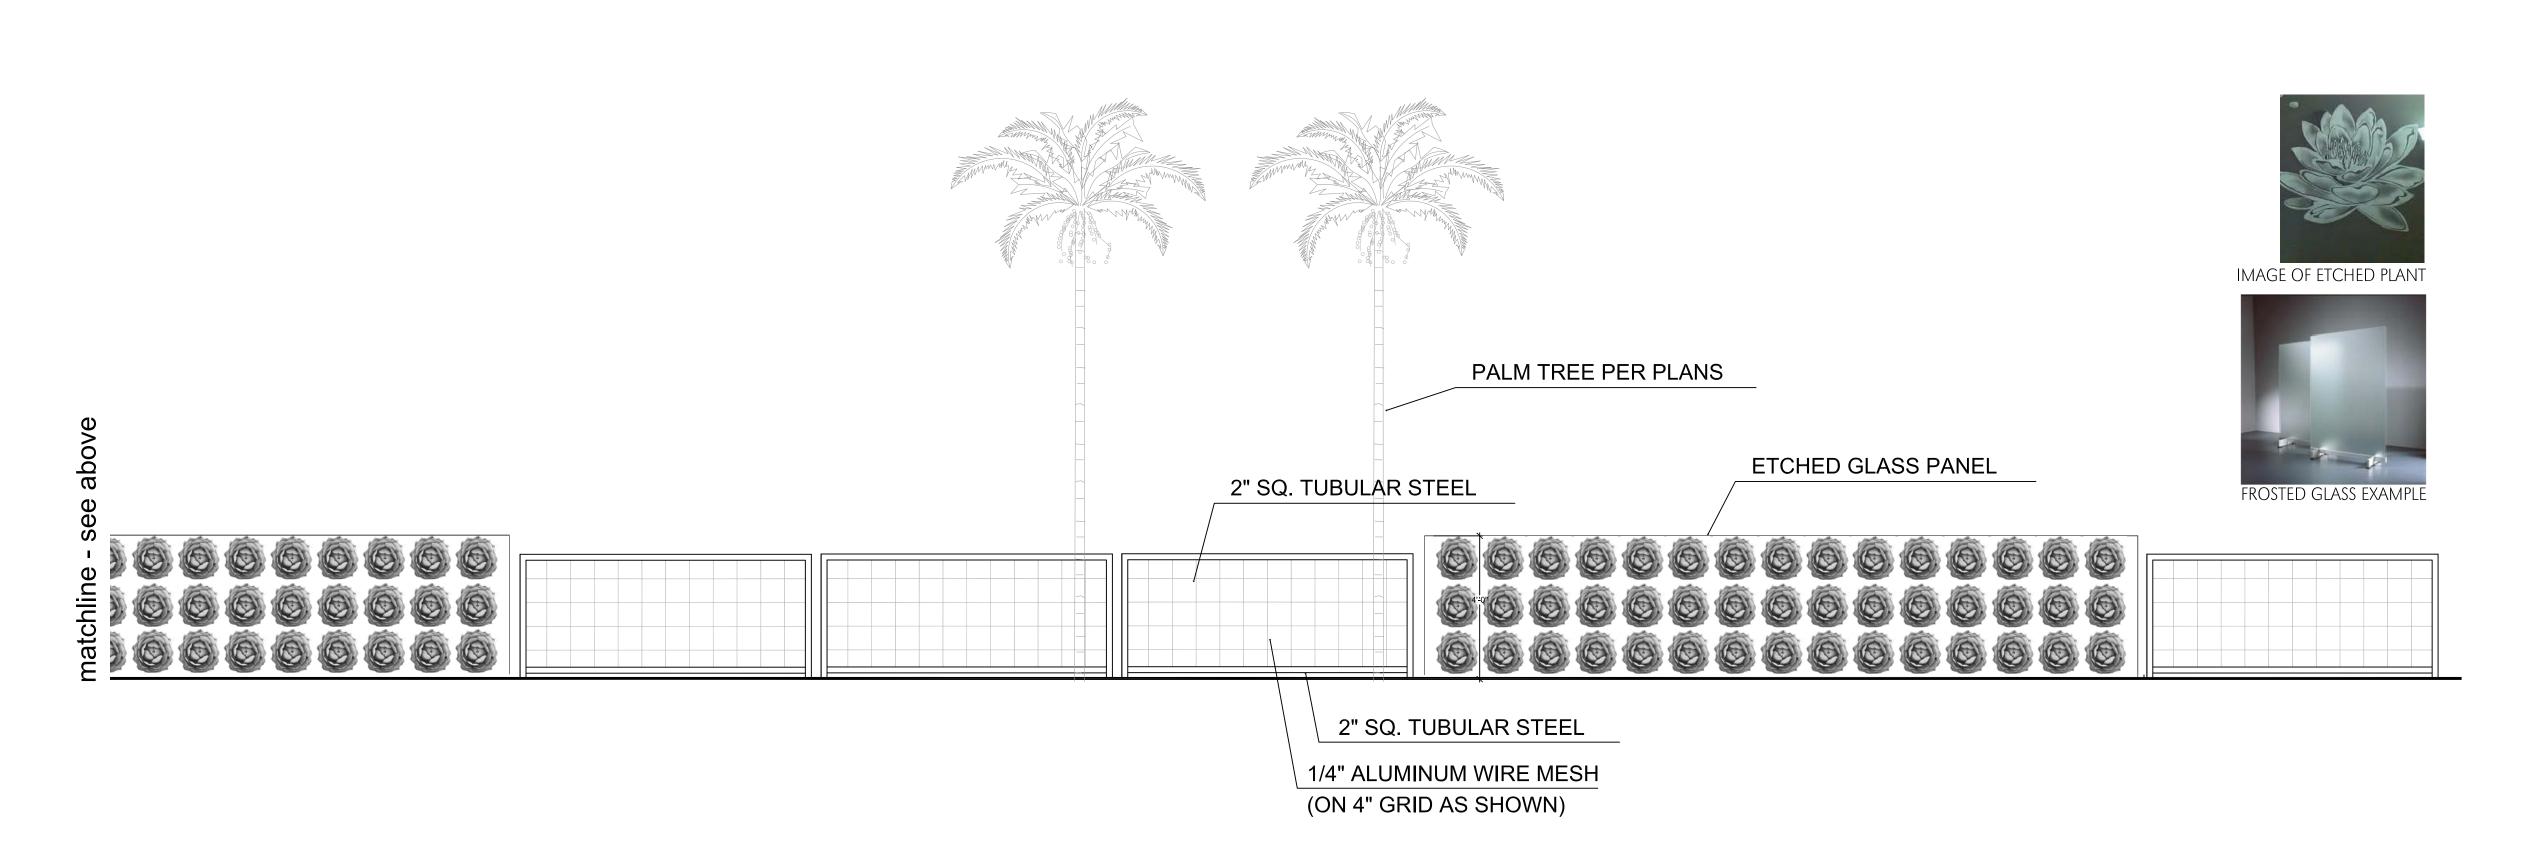

FENCE & GLASS PANEL (elevation along west property line) (ACTUAL DESIGN WILL BE BROUGHT TO THE DESIGN ASSISTANCE SUB-COMMITTEE FOR FURTHER REVIEW AND FINALIZATION OF DESIGN)

Landscape Development Plan



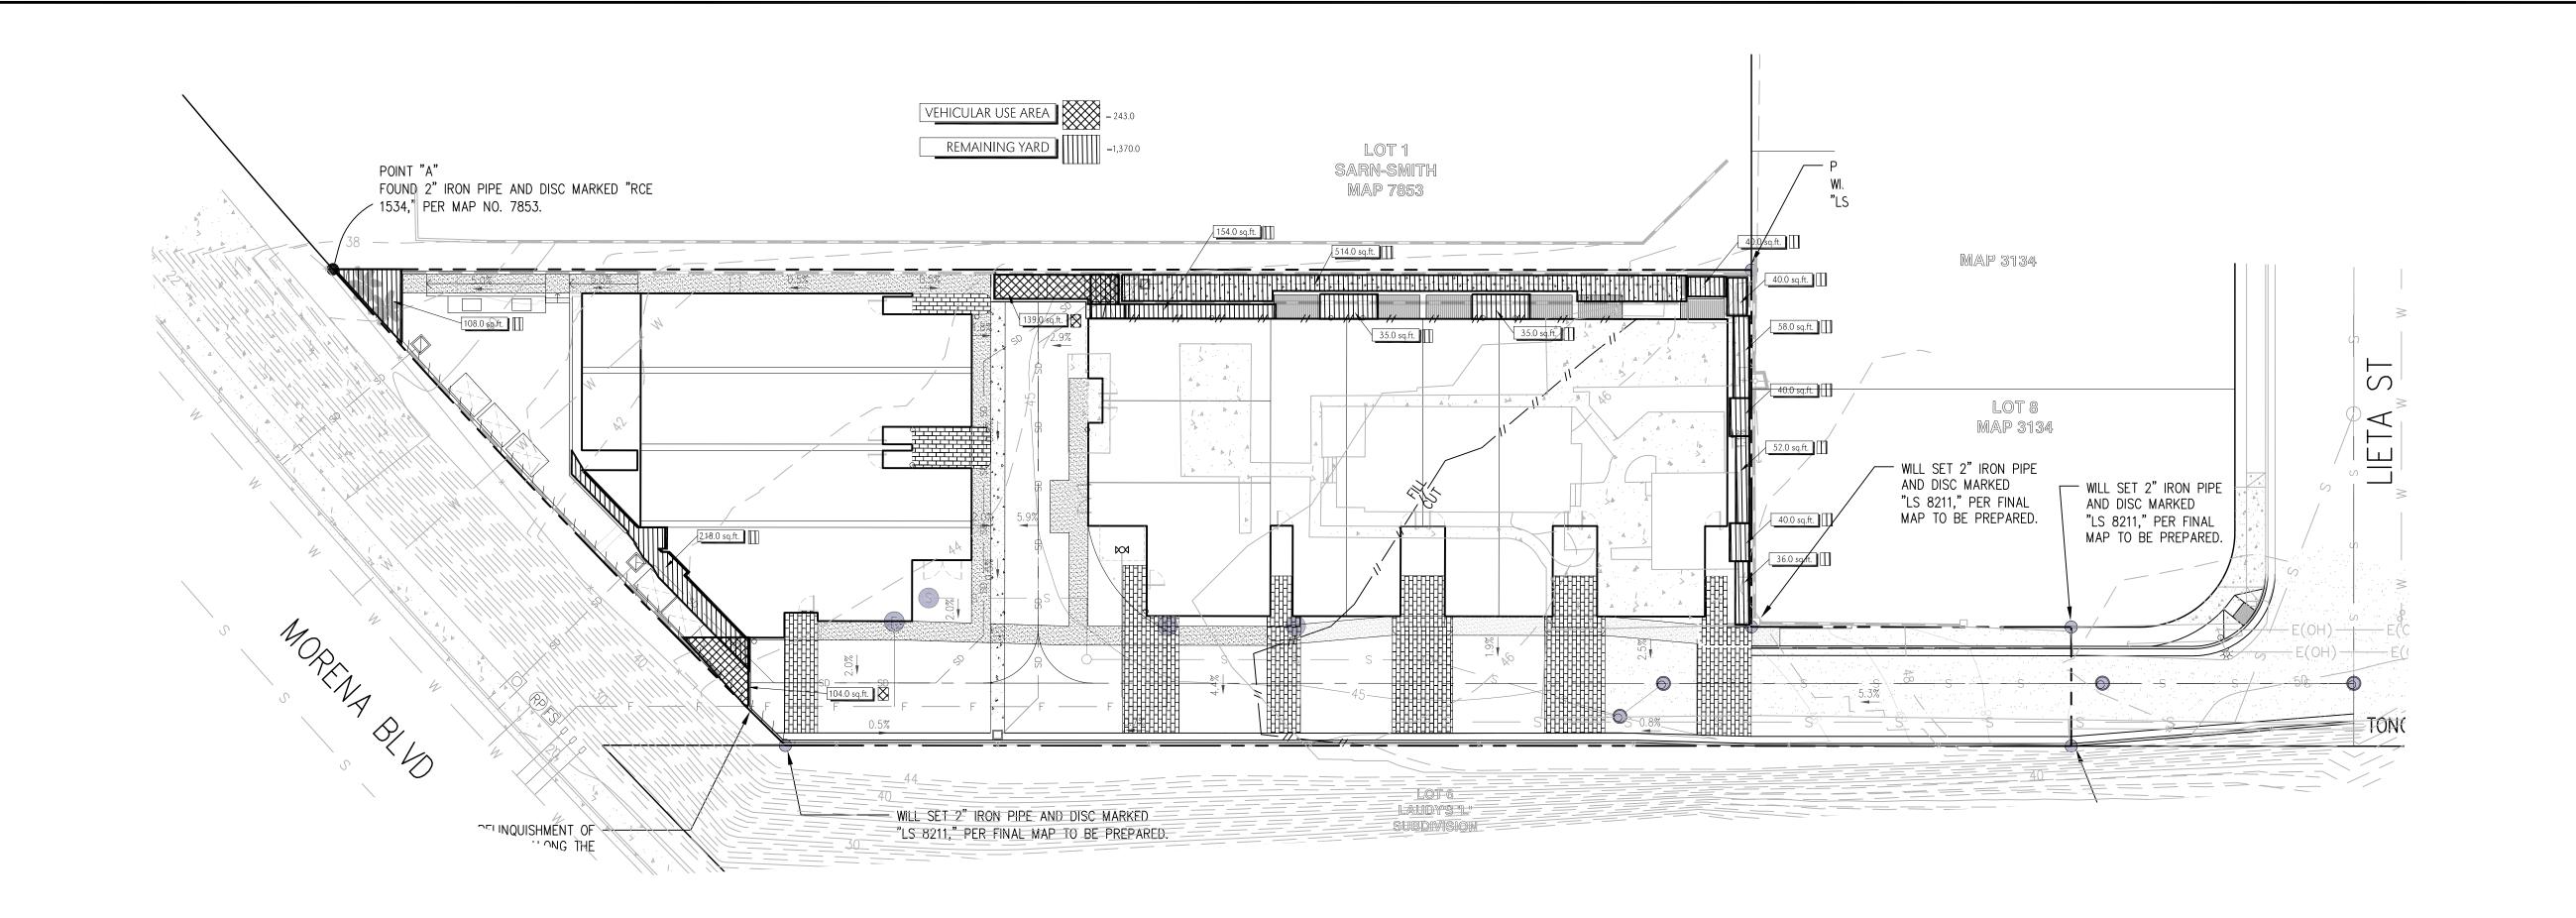

BUILDING $\dot{\mathcal{S}}$ LOT 8 MAP 3134 BUILDING - WILL SET 2" IRON PIPE AND DISC MARKED - WILL SET 2" IRON PIPE AND DISC MARKED "LS 8211," PER FINAL "LS 8211," PER FINAL MAP TO BE PREPARED. MAP TO BE PREPARED. LAUDY'S "L" WILL SET 2" IRON PIPE AND DISC MARKED RELINQUISHMENT OF "LS 8211," PER FINAL MAP TO BE PREPARED. MARKED "LS 8211," PER FINAL MAP

LOT 1

SARN-SMITH

MAP 7853

SUMMARY OF LANDSCAPE CALCULATIONS (RESIDENTIAL)

STREET YARD
PROJECT DOES NOT HAVE A STREET FRONTAGE ALONG LIETA STREET. THE PAD OF THE DEVELOPMENT IS SET ABOVE THE MORENA BOULEVARD FRONTAGE, LEAVING NO VISUAL STREET YARD ON THE PARCEL. THEREFORE, STREET YARD CALCULATIONS ARE NOT REQUIRED.

TOTAL AREA: 7,803 S.F

PLANTING AREA REQUIRED: $7,803 \times .03 = 234.0$ S.F. PROVIDED: 243.0 S.F. EXCESS AREA PROVIDED: 9.0 S.F. PLANTING points REQUIRED: 7,803 x .03 = 234.0 PROVIDED: 750.0 2 - 48" box tree @ 100 pts. each = 200 pts.

0 - 24" box tree @ 20 pts. each = 0 pts. 55 - 15 gal. shrubs @ 10 pts. each = 550 pts. 0-5 gal. shrubs @ 2 pts. each = 0 pts.


0 - 1 gal. shrubs @ 1 pts. each = 0 pts. EXCESS POINTS PROVIDED: 516 POINTS ACHIEVED THROUGH TREES: 200

REMAINING YARD - MULTI-DWELLING UNIT DEVELOPMENT.

PLANTING POINTS REQUIRED: 60 POINTS/UNIT=780 PROVIDED: 789 2 - 36" box tree @ 50 pts. each = 100 pts. 7 - 15' BTH Palms @ 3pts/15' each = 315 pts 27 - 15 gal. shrubs @ 10 pts. each = 270 pts. 52-5 gal. shrubs @ 2 pts. each = 104 pts.

0 - 1 gal. shrubs @ 1 pts. each = 0 pts. EXCESS POINTS PROVIDED: 9 POINTS ACHIEVED THROUGH TREES: 415

STREET YARD AREA RESIDENTIAL = 0

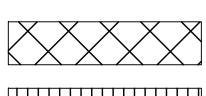

VEHICLE USE AREA RESIDENTIAL = 7,803

ACCESS ALONG THE

ENTIRE MORENA


ROULEVARD

FOUND 2" IRON PIPE AND DISC MARKED "RCE

1534," PER MAP NO. 7853.



SQUARE FOOTAGE PLAN

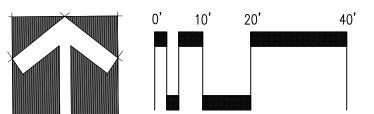

- POINT "B"

WILL SET 2'

"LS 8211," F



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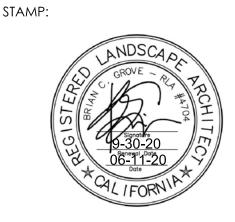
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SQUARE FOOTAGE PLAN

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15066 DBRDS PROJECT NO: **OCTOBER 6 2016** СН DRAWN BY: 1"=20'-0" SCALE: L-3 SHEET NO: