

Report to the Hearing Officer

DATE ISSUED:

March 8, 2017

REPORT NO. HO-17-011

HEARING DATE:

March 15, 2017

SUBJECT:

GOLDEN HILL B STREET HOMES. Process Three Decision

PROJECT NUMBER:

422242

OWNER/APPLICANT: GH3, LLC/Matthew Gordon

SUMMARY

Issue: Should the Hearing Officer approve the construction of 11 (for-rent) residential dwelling units on a vacant 0.59-acre site located at 2871-2877 B Street in the Greater Golden Hill Community Planning area?

Staff Recommendations:

- 1. ADOPT Negative Declaration No. 422242; and
- 2. APPROVE Site Development Permit No. 1487345; and
- 3. APPROVE Fasement Vacation No. 1487342.

Community Planning Group Recommendation: On November 11, 2015, the Greater Golden Hill Planning Committee (GGHPC) voted 7-1-2 to recommend approval of the project with no conditions (Attachment 12).

Environmental Review: Negative Declaration No. 422242 has been prepared for the project in accordance with State of California Environmental Quality Act (CEQA) Guidelines. Based on the Initial Study, it was determined that the proposed project will not have a significant effect on the environment.

BACKGROUND

The vacant 0.59-acre site is located at 2871-2877 B Street (formally listed as 2881 1/3 B Street) in the GHPD-GH-1500 Zone of the Golden Hill Planned District within the Greater Golden Hill Community Plan (Attachments 1-4). The project site is also located within the Residential Tandem Parking Overlay Zone, the Transit Area Overlay Zone, the Airport Influence Area Review Area 1 for the San

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Diego International Airport as depicted in the adopted 2014 Airport Land Use Compatibility Plan (ALUCP), the 65 to 70 decibel (dB) Community Noise Equivalent Level as depicted in the ALUCP, and within the Federal Aviation Administration Part 77 Notification area.

The site lowers from 200 feet above sea level (ASL) along B Street and changes to 168 feet ASL at the southeastern corner of the property (an approximate 32-foot differential). The site is located above the 100-year floodplain, and is not located within or adjacent to the City's Multiple Habitat Planning Area and does not contain any Environmentally Sensitive Lands as defined in San Diego Municipal Code (SDMC) Section 113.0103.

On November 13, 1989, a portion of 29th Street located between B Street and C Street, and a portion of the alley abutting the property along the southern property line were vacated pursuant to City Council Resolution No. R-274719, adopted November 13, 1989. A 15-foot easement for pedestrian uses was reserved along the vacated portion of 29th Street and a 20-foot general utility easement was reserved over the vacated alley, and was recorded on December 18, 1989, as File No. 89-683492, O. R. On December 18, 1989, a 15-foot drainage easement was recorded over Lots 1-3 and portions of the vacated portion of 29th Street as File No. 89-683490, O. R. An existing 36-inch Reinforced Concrete Pipe (RCP) and an 18-inch Corrugated Metal Pipe (CMP) City storm drains enter the property from the north along B Street and empty into the 15-foot drainage easement on site. The storm water then continues to an existing basin located north of C Street that ties into the storm drain system to the south. In addition, an existing 10-inch Rehabilitated Concrete Pipe (CP) City sewer main enters the property from the north and runs south along the lot line between Lots 5 and 6. On January 25, 1909, a 10-foot sewer easement was deeded to the City over portions on Lot 6, but the location was not specified in the deed documents.

The subject property is immediately surrounded by a multi-family development to the west and south, and a single dwelling unit to the east. The 20-unit multi-family development to the south was approved by the Planning Commission on August 30, 2007, pursuant to Report No. PC-07-092 (Project No. 104554). Land use designations for the areas adjacent to the site on the north, east and west are residential (medium residential density of 15-29 dwelling units per acre), and are zoned GH-1500, a multi-family residential zone. The land use designations for the properties immediately south are residential (medium-high residential density of 29-44 dwelling units per acre), and are zoned GH-1000.

DISCUSSION

Community Plan and Zone Updates:

On December 1, 2016 (date of final passage), the City Council adopted an updated Greater Golden Hill Community Plan pursuant to Resolution No. R-310756, and a rezone of the properties within the community planning area to citywide zones pursuant to Ordinance No. O-20757 N.S. However, the project application was deemed complete on August 10, 2015, and the project is utilizing the Greater Golden Hill Community Plan and the Golden Hill Planned District regulations that were in effect at the time of the submittal.

Project Description:

The project proposes the construction of 11 (for-rent) residential units on a vacant 0.59 acre site. Five of the dwelling units will provide three bedrooms and range in size from 1,725 to 1,800 square feet, and the remaining six units will provide two bedrooms and range in size from 1,328 to 1,725 square feet. All of the units will contain attached two car garages. The zoning designation provides for residential development and allows for one-unit per 1,500 square feet of lot area. The Greater Golden Hill Community Plan allows medium residential density of 15-29 dwelling units per acre. The proposed project site, occupying 0.59-acres, could accommodate 17 dwelling units based on the underlying zone and 9-17 dwelling units based on the community plan.

As part of the project, a 30-foot sewer easement will be dedicated, Drawing No. 39441-B, within Lot 5-6 for the existing 10-inch Rehabilitated CP City sewer main, and a trapezium-shaped drainage easement will be dedicated, Drawing No. 39442-B, for the existing 36-inch RCP and new 18-inch RCP City storm drain pipes on site. The width of the easements are to accommodate the accessibility and depth of the sewer main and drainage pipes. In addition, a new 42-inch RCP drainage pipe will be installed within the existing 15-foot drainage easement to allow for the storm water to go through the property and to the existing basin located north of C Street. To allow for the new drainage pipe to line up with the existing basin, the southwestern portion of the 15-foot drainage easement will be vacated, Drawing No. 39378-B, and new portions dedicated, Drawing No. 39442-B, on the southeastern side of the easement that will allow for a 15-foot wide easement. All of the encroachments within the existing and proposed easements have been reviewed and determined appropriate for the proposed development.

Development of the project requires a Process Three Site Development Permit (SDP) for residential development of more than three units within the Golden Hill Planned District and for deviations to the base zone regulations, and a Process Two Easement Vacation for portions of the existing 15-foot drainage easement. Deviations within the Golden Hill Planned District may be granted through a Process Three SDP in accordance with SDMC Section 158.0206(a)(3). In accordance with SDMC Section 112.0103 governing the Consolidation of Processing, the applications have been consolidated for processing at the highest level of authority for that development. The project incorporates a roof-mounted photovoltaic system consisting of solar panels sufficient to generate at least 50-percent of the project's projected energy consumption, and qualifies as a Sustainable Building. As such the land use approvals have been processed through the Affordable/In-Fill Housing and Sustainable Buildings Expedite Program.

Project-Related Issues:

<u>Climate Action Plan (CAP) Consistency</u>- A CAP Consistency Checklist was prepared by the applicant and the project was determined to be in conformance with the CAP. CAP Implementation Strategies, include a combination of roofing materials with solar reflection and thermal emittance. The project has been designed to have an energy budget that shows a 15-percent energy improvement to the Title 24, Part 6 Energy Budget. This energy demand reduction will be provided through a combination of on-site renewable energy generation (photovoltaic) and energy performance design elements. The project conserves water by using use low-flow fixtures/appliances and also

accommodates for future installation of electric vehicle supply equipment in the parking garages to provide an electric vehicle charging station.

<u>Airport Land Use Compatibility</u> - On September 17, 2015, the San Diego County Regional Airport Authority, serving as the Airport Land Use Commission (ALUC), voted 7-0-1 on a determination that the project is conditionally consistent with the 2014 SDIA-ALUCP, pursuant to Resolution No. 2015-0022 (Attachment 6). The conditions outlined in the resolution have been included in the Permit (Attachment 8).

<u>Deviations</u> - An applicant may request deviations from the applicable development regulations pursuant to a Process Three Site Development Permit within the Golden Hill Planned District provided that findings can be made and the deviation results in a more desirable project. The applicant requests three deviations. The following are the requested deviations with justifications:

1. Rear Yard Setback – A deviation from SDMC Section 158.0301(b)(2)(B) and Table 158-03C to allow for a 12-foot rear yard setback for the Level 2 balconies in lieu of the required 15-foot setback.

Justification: On November 13, 1989, the portion of the alley abutting the property along the southern property line was vacated pursuant to City Council Resolution No. R-274719, and a 20-foot general utility easement was reserved over the vacated alley. This portion of the general utility easement will be improved with permeable paving and will provide access to Units 1-6 and Units10 and 11; therefore, the easement will function as an alley for the residential development and regulations require only a one-foot setback if there is an alley.

2. Residential Vehicular Access – A deviation from SDMC Section 158.0302(c)(8)(A) to allow for access to Units 7, 8, and 9 from a 14-foot driveway off of B Street, where it is required that vehicular access for the residential units must be provided from the alley, where alley access exists:

Justification: The site lowers from 200 feet AML along B Street to 168 feet AML at the southeastern corner of the property (an approximate 32-foot differential). As stated above, the portion of the alley abutting the property along the southern property line was vacated and the general utility easement is functioning as an alley and meets the intent of the regulations to take access from the rear of the property. Due to the site constraints, Units 7, 8, and 9 have been designed to take access from one driveway on B Street, which is the minimum needed to allow for access to the required parking for the units.

3. Transparency Requirement – A deviation from SDMC Section 158.0303(e)(1) to provide 13-percent transparency in the street wall affording views into living space of Units 7 and 9, where at least 15-percent is required.

Justification: Including the garage window, the units would provide approximately 13-percent transparency in the street wall; however, the garage window cannot be used to meet any of the transparency requirement in accordance with SDMC Section 158.0303(e)(3), since it is

- not living space. The proposed project meets the intent of the regulations by not having a solid wall along the façade and to have eyes on and toward the public right-of-way.
- 4. Building Height A deviation from SDMC Section 158.0301(b)(3) and Table 158-03D to allow for a 36-foot maximum structure height above proposed grade, where structure height is limited to 30 feet.

Justification: The site lowers from 200 feet AML along B Street to 168 feet AML at the southeastern corner of the property (an approximate 32-foot differential). In addition, the portion of the site containing the existing City storm drain pipes has a steeper hillside than other portions of the site. The site will require an extensive amount of grading to allow for access to the existing City storm drain pipes and the installation of the new 42-inch RCP and 18-inch RCP storm drain pipes on site. Therefore, as part of the installation of the pipes, the site will be terraced to allow for the residential development. The structure height along B-Street will be a maximum of 27 feet five inches and will increase as the development steps down the property toward the southern property line with a maximum 36-foot high structure height above proposed grade.

Each of the requested deviations has been reviewed as they relate to the proposed design of the project, the property configuration, and the surrounding development. The deviations are appropriate and will result in a more desirable project that efficiently utilizes the site and achieves the revitalization of the existing vacant parcel for the creation of 11 rental residential units, while meeting the purpose and intent of the development regulations.

Affordable and Inclusionary Housing - This project is subject to the requirements of the Affordable Housing Requirements of the City's Inclusionary Housing Ordinance (SDMC §142.1301 et seq.). The applicant has elected to pay an in-lieu fee to meet these requirements. Prior to receiving the first residential building permit the applicant must pay the entire in-lieu fee amount.

CONCLUSION:

With the approval of the requested deviations, the proposed project meets all applicable regulations and policy documents, and staff finds the project consistent with the recommended land use, design guidelines, and development standards in effect for this site per the adopted Greater Golden Hill Community Plan, the Golden Hill Planned District regulations, the SDMC, and the General Plan.

ALTERNATIVES

- 1. ADOPT Negative Declaration No. 422242 and APPROVE Site Development Permit No. 1487345 and Easement Vacation No. 1487342, with modifications.
- 2. DO NOT ADOPT Negative Declaration No. 422242 and DENY Site Development Permit No. 1487345 and Easement Vacation No. 1487342, if the findings required to approve the project cannot be affirmed.

Respectfully submitted,


Jeffrey A. Peterson

Development Project Manager

Attachments:

- 1. Location Map
- 2. Aerial Photograph
- 3. Zoning Map
- 4. Community Plan Land Use Map
- 5. Project Data Sheet
- 6. ALUCP Resolution No. 2015-0022
- 7. Draft Resolution with Findings
- 8. Draft Permit with Conditions
- 9. Draft Easement Vacation Resolution
- 10. Easement Vacation and Dedication B-Sheets
- 11. Environmental Resolution (ND)
- 12. Community Planning Group Recommendation
- 13. Ownership Disclosure Statement
- 14. Project Plans

Internal Order No: 24005877

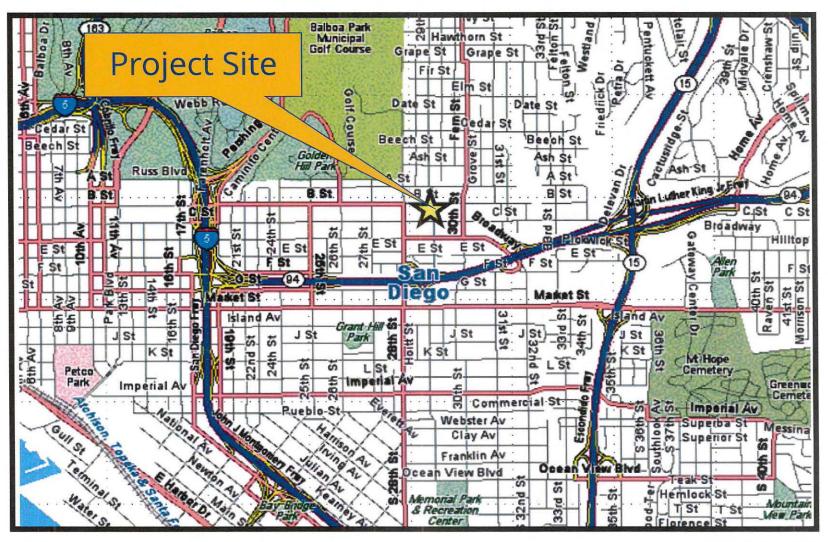




Location Map

Golden Hill B Street Homes-Project No. 422242 2871-2877 B Street North



Aerial Photograph (Current)

Golden Hill B Street Homes-Project No. 422242 2871-2877 B Street

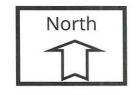




Zoning Map

Golden Hill B Street Homes-Project No. 422242


2871-2877 B Street

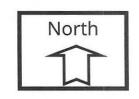



1988 Community Land Use Map

Golden Hill B Street Homes-Project No. 422242 2871-2877 B Street

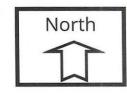

	PROJECT DATA SHEET			
PROJECT NAME:	Golden Hill B Street Homes –Project No. 422242			
PROJECT DESCRIPTION:	Construction of 11 (for rent) residential dwelling units on a vacant 0.59-acre site located at 2871-2877 B Street.			
COMMUNITY PLAN AREA:	Greater Golden Hill			
DISCRETIONARY ACTIONS:	Site Development Permit and Ea	sement Vacatio	on	
COMMUNITY PLAN LAND USE DESIGNATION:	Medium Residential density of 15-29 dwelling units per acre			
	ZONING INFORMATION:			
ZONE: HEIGHT LIMIT: LOT SIZE: FLOOR AREA RATIO: LOT COVERAGE: FRONT SETBACK: SIDE SETBACK: STREETSIDE SETBACK: REAR SETBACK: PARKING:	30 Feet 20,000 Square Feet 0.06 35-Percent 10 Feet 6 Feet NA			
ADJACENT PROPERTIES:	LAND USE DESIGNATION & ZONE	EXISTING LAND USE		
NORTH:	Medium Residential, GHPD-GH- 1500	Multi-Family Residential		
SOUTH:	Medium High Residential, GHPD-GH-1000	Multi-Family Residential		
EAST:	Medium Residential, GHPD-GH- 1500	Single Family Dwelling Unit		
WEST:	Medium Residential, GHPD-GH- 1500	Multi-Family Residential		
DEVIATIONS	Deviations for rear yard setback, residential vehicular access, transparency requirement, and building height.			
COMMUNITY PLANNING GROUP RECOMMENDATION:	On November 11, 2015, the Greater Golden Hill Planning Committee (GGHPC) voted 7-1-2 to recommend approval of the project with no conditions.			

RESOLUTION NO. 2015-0022 ALUC

A RESOLUTION OF THE AIRPORT LAND USE COMMISSION FOR SAN DIEGO COUNTY MAKING A DETERMINATION THAT THE PROPOSED PROJECT: CONSTRUCTION OF 11 ATTACHED AND DETACHED RESIDENTIAL UNITS AT B STREET AT 29TH STREET, CITY OF SAN DIEGO, IS CONDITIONALLY CONSISTENT WITH THE SAN DIEGO INTERNATIONAL AIRPORT - AIRPORT LAND USE COMPATIBILITY PLAN.

WHEREAS, the Board of the San Diego County Regional Airport Authority, acting in its capacity as the Airport Land Use Commission (ALUC) for San Diego County, pursuant to §21670.3 of the California Public Utilities Code, was requested by the City of San Diego to determine the consistency of a proposed project: Construction of 11 Attached and Detached Residential Units at B Street at 29th Street, City of San Diego, which is located within the Airport Influence Area (AIA) for the San Diego International Airport (SDIA) Airport Land Use Compatibility Plan (ALUCP), adopted and amended in 2014; and

WHEREAS, the plans submitted to the ALUC for the proposed project indicate that it would involve the subdivision of a vacant property and construction of 11 attached and detached residential units; and

WHEREAS, the proposed project would be located within the 65-70 decibel (dB) Community Noise Equivalent Level (CNEL) noise contour, and the ALUCP identifies residential uses located within the 65-70 dB CNEL noise contour as compatible with airport uses, provided that the residences are sound attenuated to 45 dB CNEL interior noise level and that an avigation easement is recorded on each new property with the County Recorder; and

WHEREAS, the proposed project is located outside the SDIA Threshold Siting Surface (TSS) and is in compliance with the ALUCP airspace protection surfaces because the project sponsor has certified that notice of construction is not required to the Federal Aviation Administration (FAA); and

WHEREAS, the proposed project is located outside all Safety Zones; and

WHEREAS, the proposed project is located within the overflight notification area, and the ALUCP requires recordation of an overflight notification with the County Recorder for new residential land uses, but does not require an additional overflight notification where an avigation easement is required; and

Resolution No. 2015-0022 ALUC Page 2 of 3

WHEREAS, the ALUC has considered the information provided by staff, including information in the staff report and other relevant material regarding the project; and

WHEREAS, the ALUC has provided an opportunity for the City of San Diego and interested members of the public to present information regarding this matter.

NOW, THEREFORE, BE IT RESOLVED that the ALUC determines that the proposed project: Construction of 11 Attached and Detached Residential Units at B Street at 29th Street, City of San Diego, is conditionally consistent with the SDIA ALUCP, which was adopted and amended in 2014, based upon the following facts and findings:

- (1) The proposed project involves the subdivision of a vacant property and construction of 11 attached and detached residential units.
- (2) The proposed project is located within the 65-70 dB CNEL noise contour. The ALUCP identifies residential uses located within the 65-70 dB CNEL noise contour as compatible with airport uses, provided that the residences are sound attenuated to 45 dB CNEL interior noise level and that an avigation easement is recorded with the County Recorder. Therefore, as a condition of project approval, the residence must be sound attenuated to 45 dB CNEL interior noise level and an avigation easement on each new property must be recorded with the County Recorder.
- (3) The proposed project is located outside the TSS. The proposed project is in compliance with the ALUCP airspace protection surfaces because the project sponsor has certified that notice of construction is not required to the FAA because the project is located within an urbanized area, is substantially shielded by existing structures or natural terrain, and cannot reasonably have an adverse effect on air navigation.
- (4) The proposed project is located outside all Safety Zones.
- (5) The proposed project is located within the overflight notification area. The ALUCP requires recordation of an overflight notification with the County Recorder for new residential land uses, but does not require an additional overflight notification where an avigation easement is required.
- (6) Therefore, if the proposed project contains the above-required conditions, the proposed project would be consistent with the SDIA ALUCP.

Resolution No. 2015-0022 ALUC Page 3 of 3

BE IT FURTHER RESOLVED that the ALUC finds this determination is not a "project" as defined by the California Environmental Quality Act (CEQA), Cal. Pub. Res. Code §21065, and is not a "development" as defined by the California Coastal Act, Cal. Pub. Res. Code §30106.

PASSED, ADOPTED AND APPROVED by the ALUC for San Diego County at a regular meeting this 17th day of September, 2015, by the following vote:

AYES:

Commissioners: Boling, Desmond, Gleason, Hubbs, Janney,

Robinson, Sessom

NOES:

Commissioners: None

ABSENT: Commissioners: Alvarez, Cox

ATTEST:

DIRECTOR, CORPORATE & INFORMATION GOVERNANCE /

AUTHORITY CLERK

APPROVED AS TO FORM:

GENERAL COUNSEL

HEARING OFFICER RESOLUTION NO. _____ SITE DEVELOPMENT PERMIT NO. 1487345 GOLDEN HILL B STREET HOMES -PROJECT NO. 422242

WHEREAS, GH3, LLC, a California Limited Liability Company, Owner/Permittee, filed an application with the City of San Diego for a permit to construct 11 (for-rent) residential units on a vacant site (as described in and by reference to the approved Exhibits "A" and corresponding conditions of approval for the associated Permit No. 1487345), on portions of a 0.59-acre site;

WHEREAS, the project site is located at 2871-2877 B Street (formally listed as 2881 1/3 B Street) in the GHPD-GH-1500 Zone of the Golden Hill Planned District within the Golden Hill Community Plan, Residential Tandem Parking Overlay Zone, and the Transit Area Overlay Zone. The project site is also located within the Airport Influence Area Review Area 1 for the San Diego International Airport as depicted in the adopted 2014 Airport Land Use Compatibility Plan (ALUCP), the 65 to 70 decibel (dB) Community Noise Equivalent Level as depicted in the ALUCP, and within the Federal Aviation Administration Part 77 Notification area;

WHEREAS, the project site is legally described as: Lots 1 through 5, inclusive and the East 16 2/3 feet of Lot 6, in Block 63 of E.W. Morse's Subdivision of Pueblo Lot 1150, in the City of San Diego, County of San Diego, State of California, according to Map thereof No. 547, filed in the Office of the County Recorder of San Diego County, December 30, 1971. Also including the Northerly Half of the alley lying Southerly of Lots 1 through 5 and a portion of Lot 6 and the West ½ of 29th Street adjoining Lot 1, as closed and vacated to public use per Resolution of the City of San Diego, a certified copy of which recorded December 18, 1989 as file No. 89-683492 of Official Records;

WHEREAS, on March 15, 2017, the Hearing Officer of the City of San Diego considered Site Development Permit No. 1487345 pursuant to the Land Development Code of the City of San Diego; NOW, THEREFORE,

BE IT RESOLVED by the Hearing Officer of the City of San Diego as follows:

That the Hearing Officer adopts the following written Findings, dated March 15, 2017.

FINDINGS:

- I. <u>Site Development Permit Section §126.0504</u>
 - A. Findings for all Site Development Permits
 - 1. The proposed development will not adversely affect the applicable land use plan.

The vacant 0.59-acre site is located at 2871-2877 B Street in the GHPD-GH-1500 Zone of the Golden Hill Planned District within the Greater Golden Hill Community Plan. The Greater Golden Hill Community Plan allows medium residential density of 15-29 dwelling units per acre. The proposed project site, occupying 0.59-acres, could accommodate 17

dwelling units based on the underling zone and 9-17 dwelling units based on the community plan. The project proposes the construction of 11 (for-rent) residential units on the vacant site. Five of the dwelling units will provide three bedrooms and range in size from 1,725 to 1,800 square feet, and the remaining six units will provide two bedrooms and range in size from 1,328 to 1,725 square feet. All of the units will contain attached two car garages.

Four deviations are requested as part of the development proposal that relate to rear yard setback, residential vehicular access, transparency requirement, and building height. As proposed, the project would incorporate varying façade offsets including breaks in the buildings massing to allow views through the project, varying building and textures, sustainable development features such as photovoltaic panels, and outdoor recreation space. Notwithstanding these deviations, the project as proposed would be consistent with the policies of Greater Golden Hill Community Plan and the General Plan, and therefore would not adversely impact the applicable land use plans.

2. The proposed development will not be detrimental to the public health, safety, and welfare.

The project proposes the construction of 11 (for-rent) residential units on the vacant site. Five of the dwelling units will provide three bedrooms and range in size from 1,725 to 1,800 square feet, and the remaining six units will provide two bedrooms and range in size from 1,328 to 1,725 square feet. All of the units will contain attached two car garages.

In addition to the on-site construction, a 30-foot sewer easement will be dedicated, Drawing No. 39441-B, within Lot 5-6 for the existing 10-inch Rehabilitated Concrete Pipe (CP) City sewer main, and a trapezium-shaped drainage easement will be dedicated, Drawing No. 39442-B, for the existing 36-inch Reinforced Concrete Pipe (RCP) and a new 18-inch RCP City storm drain pipes on site. The width of the easements are to accommodate the accessibility and depth of the sewer main and drainage pipes. In addition, a new 42-inch RCP drainage pipe will be installed within the existing 15-foot drainage easement to allow for the storm water to go through the property and to the existing basin located north of C Street. To allow for the new drainage pipe to line up with the existing basin, the southwestern portion of the 15-foot drainage easement will be vacated, Drawing No. 39378-B, and new portions dedicated, Drawing No. 39442-B, on the southeastern side of the easement that will allow for a 15-foot wide easement.

The City of San Diego conducted an environmental review of this site in accordance with State of California Environmental Quality Act (CEQA) guidelines and a Negative Declaration No. 422242 has been prepared for the project. Based on the Initial Study, it was determined that the proposed project will not have a significant effect on the environment.

The project will be required to obtain building permits and a public improvement permit prior to the construction of the residential development. The building plans and public improvement plans will be reviewed, permitted, and inspected by the City for

compliance with all applicable building, mechanical, electrical, fire code, and development regulations. The permit for the project includes various conditions and referenced exhibits of approval relevant to achieving project compliance with the applicable regulations of the San Diego Municipal Code (SDMC) in effect for this project. Such conditions are necessary to avoid adverse impacts upon the health, safety and general welfare of persons residing or working in the surrounding area. The project will comply with the development conditions in effect for the subject property as described in Site Development Permit No. 1487345, and other regulations and guidelines pertaining to the subject property per the SDMC. Therefore, the proposed development will not be detrimental to the public health, safety, and welfare.

3. The proposed development will comply with the applicable regulations of the Land Development Code, including any allowable deviations pursuant to the Land Development Code.

The project proposes the construction of 11 (for-rent) residential units on the vacant site. Five of the dwelling units will provide three bedrooms and range in size from 1,725 to 1,800 square feet, and the remaining six units will provide two bedrooms and range in size from 1,328 to 1,725 square feet. All of the units will contain attached two car garages. The project incorporates a roof-mounted photovoltaic system consisting of solar panels sufficient to generate at least 50-percent of the project's projected energy consumption on each of the dwelling units.

An applicant may request deviations from the applicable development regulations pursuant to a Process Three Site Development Permit within the Golden Hill Planned District provided that findings can be made and the deviation results in a more desirable project. The following are the requested deviations with justifications:

1. Rear Yard Setback – A deviation from SDMC Section 158.0301(b)(2)(B) and Table 158-03C to allow for a 12-foot rear yard setback for the Level 2 balconies in lieu of the required 15-foot setback.

Justification: On November 13, 1989, the portion of the alley abutting the property along the southern property line was vacated pursuant to City Council Resolution No. R-274719, and a 20-foot general utility easement was reserved over the vacated alley. This portion of the general utility easement will be improved with permeable paving and will provide access to Units 1-6 and Units 10 and 11; therefore, the easement will function as an alley for the residential development and regulations require only a one-foot setback if there is an alley.

2. Residential Vehicular Access – A deviation from SDMC Section158.0302(c)(8)(A) to allow for access to Units 7, 8, and 9 from a 14-foot driveway off of B Street, where it is required that vehicular access for the residential units must be provided from the alley, where alley access exists.

Justification: The site lowers from 200 feet above sea level (ASL) along B Street changes to 168 feet ASL at the southeastern corner of the property (an approximate

32-foot differential). As stated above, the portion of the alley abutting the property along the southern property line was vacated and the general utility easement is functioning as an alley and meets the intent of the regulations to take access from the rear of the property. Due to the site constraints, Units 7, 8, and 9 have been designed to take access from one driveway on B Street, which is the minimum needed to allow for access to the required parking for the units.

3. Transparency Requirement – A deviation from SDMC Section 158.0303(e)(1) to provide 13- percent transparency in the street wall affording views into living space of Units 7 and 9, where at least 15-percent is required.

Justification: Including the garage window, the units would provide approximately 13-percent transparency in the street wall; however, the garage window cannot be used to meet any of the transparency requirement in accordance with SDMC Section 158.0303(e)(3), since it is not living space. The proposed project meets the intent of the regulations by not having a solid wall along the façade and to have eyes on and toward the public right-of-way.

4. Building Height – A deviation from SDMC Section 158.0301(b)(3) and Table 158-03D to allow for a 36-foot maximum structure height above proposed grade, where structure height is limited to 30 feet.

Justification: The site lowers from 200 feet AML along B Street to 168 feet AML at the southeastern corner of the property (an approximate 32-foot differential). In addition, the portion of the site containing the existing City storm drain pipes has a steeper hillside than other portions of the site. The site will require an extensive amount of grading to allow for access to the existing City storm drain pipes and the installation of the new 42-inch RCP and 18-inch RCP storm drain pipes on site. Therefore, as part of the installation of the pipes, the site will be terraced to allow for the residential development. The structure height along B-Street will be a maximum of 27 feet five inches and will increase as the development steps down the property toward the southern property line with a maximum 36-foot high structure height above proposed grade.

Each of the requested deviations has been reviewed as they relate to the proposed design of the project, the property configuration, and the surrounding development. The deviations are appropriate and will result in a more desirable project that efficiently utilizes the site and achieves the revitalization of the existing vacant parcel for the creation of 11 residential units. Other than the requested deviations, the project meets all applicable regulations and policy documents, and is consistent with the recommended land use, design guidelines, and development standards in effect for this site per the Land Development Code (LDC).

II. Golden Hill (PDO) -Section 158.0206(d)

1. The proposed project design meets the general purpose and intent of the Golden Hill Planned District Ordinance and will be compatible with the goals and objective of

the Golden Hill Community Plan (1988), the City's Progress Guide and General Plan, the Golden Hill Planned District Design Criteria and Guidelines (as adopted by council with this ordinance) and the design studies listed in Section 158.0201 paragraph of the Municipal Code.

The vacant 0.59-acre site is located at 2871-2877 B Street in the GHPD-GH-1500 Zone of the Golden Hill Planned District within the Greater Golden Hill Community Plan. The Greater Golden Hill Community Plan allows medium residential density of 15-29 dwelling units per acre. The proposed project site, occupying 0.59-acres, could accommodate 17 dwelling units based on the underling zone and 9-17 dwelling units based on the community plan. The project proposes the construction of 11 (for-rent) residential units on the vacant site. Five of the dwelling units will provide three bedrooms and range in size from 1,725 to 1,800 square feet, and the remaining six units will provide two bedrooms and range in size from 1,328 to 1,725 square feet. All of the units will contain attached two car garages.

Four deviations are requested as part of the development proposal that relate to rear yard setback, residential vehicular access, transparency requirement, and building height. As proposed, the project would incorporate varying façade offsets including breaks in the buildings massing to allow views through the project, varying building and textures, sustainable development features such as photovoltaic panels, and outdoor recreation space. Notwithstanding these deviations, the project as proposed would be consistent with the policies of Golden Hill Planned District Ordinance, the Greater Golden Hill Community Plan and the General Plan, and therefore, the proposed development meets the general purpose and intent of the Golden Hill Planned District Ordinance.

2. The proposed development will be compatible with existing and planned land uses on adjoining properties, will not constitute a disruptive element to the neighborhood or community, and will create architectural harmony with the preferred character of the neighborhood and surrounding community.

The vacant 0.59-acre site is located at 2871-2877 B Street in the GHPD-GH-1500 Zone of the Golden Hill Planned District within the Greater Golden Hill Community Plan. The Greater Golden Hill Community Plan allows medium residential density of 15-29 dwelling units per acre. The project proposes the construction of 11 (for-rent) residential units on the vacant site.

The subject property is immediately surrounded by a multi-family development to the west and south, and a single dwelling unit to the east. The 20-unit multi-family development to the south was approved by the Planning Commission on August 30, 2007, pursuant to Report No. PC-07-092 (Project No. 104554). Land use designations for the areas adjacent to the site on the north, east and west are residential (medium residential density of 15-29 dwelling units per acre), and are zoned GH-1500, a multi-family residential zone. The land use designations for the properties immediately south are residential (medium-high residential density of 29-44 dwelling units per acre), and are zoned GH-1000. As proposed, the project would incorporate varying façade offsets including breaks in the buildings massing to allow views through the project, varying building and textures, sustainable development features such as photovoltaic panels, and outdoor recreation space. Therefore,

the proposed development has been designed to be compatible with existing and planned land uses on adjoining properties and to be in architectural harmony with the preferred character of the neighborhood and surrounding community. It will not constitute a disruptive element to the neighborhood or community.

3. The proposed development, because of conditions that have been applied to it, will not be detrimental to the health, safety and general welfare of persons residing or working in the area, and will not adversely affect other property in the vicinity.

The project proposes the construction of 11 (for-rent) residential units on the vacant site. Five of the dwelling units will provide three bedrooms and range in size from 1,725 to 1,800 square feet, and the remaining six units will provide two bedrooms and range in size from 1,328 to 1,725 square feet. All of the units will contain attached two car garages.

In addition to the on-site construction, a 30-foot sewer easement will be dedicated, Drawing No. 39441-B, within Lot 5-6 for the existing 10-inch Rehabilitated CP City sewer main, and a trapezium-shaped drainage easement will be dedicated, Drawing No. 39442-B, for the existing 36-inch RCP and a new 18-inch RCP City storm drain pipes on site. The width of the easements are to accommodate the accessibility and depth of the sewer main and drainage pipes. In addition, a new 42-inch RCP drainage pipe will be installed within the existing 15-foot drainage easement to allow for the storm water to go through the property and to the existing basin located north of C Street. To allow for the new drainage pipe to line up with the existing basin, the southwestern portion of the 15-foot drainage easement will be vacated, Drawing No. 39378-B, and new portions dedicated, Drawing No. 39442-B, on the southeastern side of the easement that will allow for a 15-foot wide easement.

The City of San Diego conducted an environmental review of this site in accordance with State of CEQA guidelines and a Negative Declaration No. 422242 has been prepared for the project. Based on the Initial Study, it was determined that the proposed project will not have a significant effect on the environment.

The project will be required to obtain building permits and a public improvement permit prior to the construction of the residential development. The building plans and public improvement plans shall be reviewed, permitted, and inspected by the City for compliance with all applicable building, mechanical, electrical, fire code, and development regulations. The permit for the project includes various conditions and referenced exhibits of approval relevant to achieving project compliance with the applicable regulations of the SDMC in effect for this project. Such conditions are necessary to avoid adverse impacts upon the health, safety and general welfare of persons residing or working in the surrounding area. The project shall comply with the development conditions in effect for the subject property as described in Site Development Permit No. 1487345, and other regulations and guidelines pertaining to the subject property per the SDMC. Therefore, the proposed development will not be detrimental to the public health, safety, and welfare of persons residing or working in the area, and would not adversely affect other property in the vicinity.

4. The proposed development complies with all other relevant regulations in the City of San Diego Municipal Code in effect for this site.

The project proposes the construction of 11 (for-rent) residential units on the vacant site. Five of the dwelling units will provide three bedrooms and range in size from 1,725 to 1,800 square feet, and the remaining six units will provide two bedrooms and range in size from 1,328 to 1,725 square feet. All of the units will contain attached two car garages. The project incorporates a roof-mounted photovoltaic system consisting of solar panels sufficient to generate at least 50-percent of the project's projected energy consumption on each of the dwelling units.

An applicant may request deviations from the applicable development regulations pursuant to a Process Three Site Development Permit within the Golden Hill Planned District provided—that findings can be made and the deviation results in a more desirable project. The following are the requested deviations with justifications:

1. Rear Yard Setback – A deviation from SDMC Section 158.0301(b)(2)(B) and Table 158-03C to allow for a 12-foot rear yard setback for the Level 2 balconies in lieu of the required 15-foot setback.

Justification: On November 13, 1989, the portion of the alley abutting the property along the southern property line was vacated pursuant to City Council Resolution No. R-274719, and a 20-foot general utility easement was reserved over the vacated alley. This portion of the general utility easement will be improved with permeable paving and will provide access to Units 1-6 and Units 10 and 11; therefore, the easement will function as an alley for the residential development and regulations require only a one-foot setback if there is an alley.

2. Residential Vehicular Access – A deviation from SDMC Section158.0302(c)(8)(A) to allow for access to Units 7, 8, and 9 from a 14-foot driveway off of B Street, where it is required that vehicular access for the residential units must be provided from the alley, where alley access exists.

Justification: The site lowers from 200 feet above sea level (ASL) along B Street changes to 168 feet ASL at the southeastern corner of the property (an approximate 32-foot differential). As stated above, the portion of the alley abutting the property along the southern property line was vacated and the general utility easement is functioning as an alley and meets the intent of the regulations to take access from the rear of the property. Due to the site constraints, Units 7, 8, and 9 have been designed to take access from one driveway on B Street, which is the minimum needed to allow for access to the required parking for the units.

3. Transparency Requirement – A deviation from SDMC Section 158.0303(e)(1) to provide 13-percent transparency in the street wall affording views into living space of Units 7 and 9, where at least 15-percent is required.

Justification: Including the garage window, the units would provide approximately 13-percent transparency in the street wall; however, the garage window cannot be used to meet any of the transparency requirement in accordance with SDMC Section

158.0303(e)(3), since it is not living space. The proposed project meets the intent of the regulations by not having a solid wall along the façade and to have eyes on and toward the public right-of-way.

4. Building Height – A deviation from SDMC Section 158.0301(b)(3) and Table 158-03D to allow for a 36-foot maximum structure height above proposed grade, where structure height is limited to 30 feet.

Justification: The site lowers from 200 feet AML along B Street to 168 feet AML at the southeastern corner of the property (an approximate 32-foot differential). In addition, the portion of the site containing the existing City storm drain pipes has a steeper hillside than other portions of the site. The site will require an extensive amount of grading to allow for access to the existing City storm drain pipes and the installation of the new 42-inch RCP and 18-inch RCP storm drain pipes on site. Therefore, as part of the installation of the pipes, the site will be terraced to allow for the residential development. The structure height along B-Street will be a maximum of 27 feet five inches and will increase as the development steps down the property toward the southern property line with a maximum 36-foot high structure height above proposed grade.

Each of the requested deviations has been reviewed as they relate to the proposed design of the project, the property configuration, and the surrounding development. The deviations are appropriate and will result in a more desirable project that efficiently utilizes the site and achieves the revitalization of the existing vacant parcel for the creation of 11 residential units. Other than the requested deviations, the project meets all applicable regulations and policy documents, and is consistent with the recommended land use, design guidelines, and development standards in effect for this site per the SDMC.

BE IT FURTHER RESOLVED that, based on the findings hereinbefore adopted by the Hearing Officer, Site Development Permit No. 1487345 is hereby GRANTED by the Hearing Officer to the referenced Owner/Permittee, in the form, exhibits, terms and conditions as set forth in Permit No. 1487345, a copy of which is attached hereto and made a part hereof.

Jeffrey A. Peterson
Development Project Manager
Development Services Department

Adopted on: March 15, 2017

Internal Order No. 24005877

RECORDING REQUESTED BY
CITY OF SAN DIEGO
DEVELOPMENT SERVICES
PERMIT INTAKE, MAIL STATION
501

WHEN RECORDED MAIL TO PROJECT MANAGEMENT PERMIT CLERK MAIL STATION 501

INTERNAL ORDER NUMBER: 24005877

SPACE ABOVE THIS LINE FOR RECORDER'S USE

SITE DEVELOPMENT PERMIT NO. 1487345 GOLDEN HILL B STREET HOMES -PROJECT NO. 422242 HEARING OFFICER

This Site Development Permit No. 1487345 is granted by the Hearing Officer of the City of San Diego to GH3, LLC, a California Limited Liability Company, Owner and Permittee, pursuant to San Diego Municipal Code [SDMC] Sections 126.0504 and 158.0206. The 0.59-acre site is located at 2871-2877 B Street (formally listed as 2881 1/3 B Street) in the GHPD-GH-1500 Zone of the Golden Hill Planned District within the Golden Hill Community Plan, Residential Tandem Parking Overlay Zone, and the Transit Area Overlay Zone. The project site is also located within the Airport Influence Area Review Area 1 for the San Diego International Airport as depicted in the adopted 2014 Airport Land Use Compatibility Plan (ALUCP), the 65 to 70 decibel (dB) Community Noise Equivalent Level as depicted in the ALUCP, and within the Federal Aviation Administration Part 77 Notification area. The project site is legally described as: Lots 1 through 5, inclusive and the East 16 2/3 feet of Lot 6, in Block 63 of E.W. Morse's Subdivision of Pueblo Lot 1150, in the City of San Diego, County of San Diego, State of California, according to Map thereof No. 547, filed in the Office of the County Recorder of San Diego County, December 30, 1971. Also including the Northerly Half of the alley lying Southerly of Lots 1 through 5 and a portion of Lot 6 and the West ½ of 29th Street adjoining Lot 1, as closed and vacated to public use per City Council Resolution No. R-274719, adopted November 13, 1989, a certified copy of which recorded December 18, 1989 as file No. 89-683492 of Official Records.

Subject to the terms and conditions set forth in this Permit, permission is granted to Owner/Permittee to construct 11 (for-rent) residential units on a vacant 0.59-acre site, described and identified by size, dimension, quantity, type, and location on the approved exhibits [Exhibit "A"] dated March 15, 2017, on file in the Development Services Department.

The project shall include:

a. Construction of 11 (for-rent) residential units on a vacant 0.59 acre site. Five of the dwelling units will provide three bedrooms and range in size from 1,725 to 1,800 square feet, and the remaining six units will provide two bedrooms and range in size from 1,328 to 1,725 square feet. All of the units will contain attached two car garages;

b. Deviations:

- a. Deviation from SDMC Section 158.0301(b)(2)(B) and Table 158-03C to allow for a 12-foot rear yard setback for the Level 2 balconies, where a 15-foot setback is otherwise required;
- b. Deviation from SDMC Section 158.0302(c)(8)(A) to allow for vehicular access for units 7, 8 and 9 to be taken off B Street via a new 14-foot driveway, where vehicular access is otherwise required to be from the alley;
- c. Deviation from SDMC 158.0303(e)(1) to provide 13-percent transparency in the street wall affording views into living space of Units 7 and 9; where at least 15-percent is otherwise required;
- d. Deviation from SDMC Section 158.0301(b)(3) and Table 158-03D to allow for a 36-foot height limit above proposed grade, where a 30-foot height limit otherwise applies;
- c. Landscaping (planting, irrigation and landscape related improvements);
- d. Off-street parking;
- e. A roof-mounted photovoltaic system consisting of solar panels sufficient to generate at least 50 percent of the project's projected energy consumption, in conformance with the criteria of the Affordable/In-Fill Housing and Sustainable Buildings Expedite Program; and
- f. Public and private accessory improvements determined by the Development Services Department to be consistent with the land use and development standards for this site in accordance with the adopted community plan, the California Environmental Quality Act [CEQA] and the CEQA Guidelines, the City Engineer's requirements, zoning regulations, conditions of this Permit, and any other applicable regulations of the SDMC.

STANDARD REQUIREMENTS:

- 1. This permit must be utilized within thirty-six (36) months after the date on which all rights of appeal have expired. If this permit is not utilized in accordance with Chapter 12, Article 6, Division 1 of the SDMC within the 36 month period, this permit shall be void unless an Extension of Time has been granted. Any such Extension of Time must meet all SDMC requirements and applicable guidelines in effect at the time the extension is considered by the appropriate decision maker. This permit must be utilized by March 29, 2020.
- 2. No permit for the construction, occupancy, or operation of any facility or improvement described herein shall be granted, nor shall any activity authorized by this Permit be conducted on the premises until:

- a. The Owner/Permittee signs and returns the Permit to the Development Services Department; and
- b. The Permit is recorded in the Office of the San Diego County Recorder.
- 3. While this Permit is in effect, the subject property shall be used only for the purposes and under the terms and conditions set forth in this Permit unless otherwise authorized by the appropriate City decision maker.
- 4. This Permit is a covenant running with the subject property and all of the requirements and conditions of this Permit and related documents shall be binding upon the Owner/Permittee and any successor(s) in interest.
- 5. The continued use of this Permit shall be subject to the regulations of this and any other applicable governmental agency.
- 6. Issuance of this Permit by the City of San Diego does not authorize the Owner/Permittee for this Permit to violate any Federal, State or City laws, ordinances, regulations or policies including, but not limited to, the Endangered Species Act of 1973 [ESA] and any amendments thereto (16 U.S.C. § 1531 et seq.).
- 7. The Owner/Permittee shall secure all necessary building permits. The Owner/Permittee is informed that to secure these permits, substantial building modifications and site improvements may be required to comply with applicable building, fire, mechanical, and plumbing codes, and State and Federal disability access laws.
- 8. Construction plans shall be in substantial conformity to Exhibit "A." Changes, modifications, or alterations to the construction plans are prohibited unless appropriate application(s) or amendment(s) to this Permit have been granted.
- 9. All of the conditions contained in this Permit have been considered and were determined necessary to make the findings required for approval of this Permit. The Permit holder is required to comply with each and every condition in order to maintain the entitlements that are granted by this Permit.

If any condition of this Permit, on a legal challenge by the Owner/Permittee of this Permit, is found or held by a court of competent jurisdiction to be invalid, unenforceable, or unreasonable, this Permit shall be void. However, in such an event, the Owner/Permittee shall have the right, by paying applicable processing fees, to bring a request for a new permit without the "invalid" conditions(s) back to the discretionary body which approved the Permit for a determination by that body as to whether all of the findings necessary for the issuance of the proposed permit can still be made in the absence of the "invalid" condition(s). Such hearing shall be a hearing de novo, and the discretionary body shall have the absolute right to approve, disapprove, or modify the proposed permit and the condition(s) contained therein.

10. The Owner/Permittee shall defend, indemnify, and hold harmless the City, its agents, officers, and employees from any and all claims, actions, proceedings, damages, judgments, or costs, including attorney's fees, against the City or its agents, officers, or employees, relating to the issuance of this permit including, but not limited to, any action to attack, set aside, void, challenge, or annul this development approval and any environmental document or decision. The City will promptly notify Owner/Permittee of any claim, action, or proceeding and, if the City should fail to cooperate fully in the defense, the Owner/Permittee shall not thereafter be responsible to defend, indemnify, and hold harmless the City or its agents, officers, and employees. The City may elect to conduct its own defense, participate in its own defense, or obtain independent legal counsel in defense of any claim related to this indemnification. In the event of such election, Owner/Permittee shall pay all of the costs related thereto, including without limitation reasonable attorney's fees and costs. In the event of a disagreement between the City and Owner/Permittee regarding litigation issues, the City shall have the authority to control the litigation and make litigation related decisions, including, but not limited to, settlement or other disposition of the matter. However, the Owner/Permittee shall not be required to pay or perform any settlement unless such settlement is approved by Owner/Permittee.

CLIMATE ACTION PLAN (CAP) REQUIREMENTS:

- 11. The Owner/Permittee shall comply with The Climate Action Plan (CAP) Consistency Checklist stamped as Exhibit "A." Prior to issuance of any construction permit, all CAP strategies shall be noted within the first three (3) sheets of the construction plans under the heading "Climate Action Plan Requirements."
- 12. The Climate Action Plan strategies as identified on Exhibit "A" shall be enforced and implemented to the satisfaction of the Development Services Department.

AFFORDABLE HOUSING REQUIREMENTS:

13. Prior to the issuance of any building permits, the Owner/Permittee shall comply with the affordable housing requirements of the City's Inclusionary Affordable Housing Regulations (SDMC §142.1301 et seq.).

AIRPORT REQUIREMENTS:

14. Prior to the issuance of any building permits, the Owner/Permittee shall assure that all structures shall be sound attenuated to 45 decibel (dB) Community Noise Equivalent Level interior noise level.

ENGINEERING REQUIREMENTS:

15. The project proposes to export no material from the project site. Any excavated material that is exported, shall be exported to a legal disposal site in accordance with the Standard Specifications for Public Works Construction (the "Green Book"), 2015 edition and Regional Supplement Amendments adopted by Regional Standards Committee.

- 16. The drainage system proposed for this development, as shown on the site plan, is subject to approval by the City Engineer.
- 17. Prior to the issuance of any building permits, the Owner/Permittee shall obtain a bonded grading permit for the grading proposed for this project. All grading shall conform to the requirements of the City of San Diego Municipal Code in a manner satisfactory to the City Engineer.
- 18. Prior to the issuance of any building permits, the Owner/Permittee shall obtain an Encroachment Maintenance Removal Agreement, from the City Engineer, for all private improvements within the City right-of- way and storm drain easements.
- 19. Prior to the issuance of any building permits, the Owner/Permittee shall assure, by permit and bond, the construction of a current City Standard 14-foot wide driveway, adjacent to the site on B Street, satisfactory to the City Engineer.
- 20. Prior to the issuance of any building permits, the Owner/Permittee shall assure, by permit and bond, the reconstruction the existing curb with current City Standard curb and gutter, adjacent to the site on B Street, satisfactory to the City Engineer.
- 21. Prior to the issuance of any building permits, the Owner/Permittee shall assure, by permit and bond, the reconstruction of the existing sidewalk with current City Standard sidewalk, maintaining the existing sidewalk scoring pattern and preserving the contractor's stamp, satisfactory to the City Engineer.
- 22. Prior to the issuance of any building permits, the Owner/Permittee shall assure, by permit and bond, the reconstruction of existing curb ramp adjacent to the site on B Street, with current City Standard curb ramp, satisfactory to the City Engineer.
- 23. Prior to issuance of any building permits, the Owner/Permittee shall assure, by permit and bond, the installation of a City standard storm drain system as shown on approved Exhibit "A," satisfactory to the City Engineer.
- 24. Prior to issuance of any building permits, the Owner/Permittee shall dedicate a drainage easement as shown on approved Exhibit "A," satisfactory to the City Engineer.
- 25. Prior to the issuance of any construction permit, the Owner/Permittee shall enter into a Maintenance Agreement for the ongoing permanent Best Management Practices (BMP) maintenance, satisfactory to the City Engineer.
- 26. Prior to the issuance of any construction permit, the Owner/Permittee shall incorporate any construction BMPs necessary to comply with Chapter 14, Article 2, Division 1 (Grading Regulations) of the SDMC, into the construction plans or specifications.
- 27. Prior to the issuance of any construction permit, the applicant shall submit a Technical Report that will be subject to final review and approval by the City Engineer, based on the Storm Water Standards in effect at the time of the construction permit issuance.

28. Prior to the issuance of any construction permit the Owner/Permittee shall submit a Water Pollution Control Plan (WPCP). The WPCP shall be prepared in accordance with the guidelines in Part 2 Construction BMP Standards Chapter 4 of the City's Storm Water Standards.

STORM DRAIN EASEMENT VACATION REQUIREMENTS:

- 29. The following will be Conditions of the Storm Drain Easement Vacation Resolution that the Owner/Permittee will need to satisfy/assure before the quitclaim for the Storm Drain Easement Vacation Exhibit is recorded:
 - a. The Owner/Permittee shall assure, by permit, bond and As-built completion, the removal of portions of the existing Public Storm Drain system and construction of a current City Standard Public Storm Drain system per approved Exhibit "A," adjacent to the site on B Street, satisfactory to the City Engineer.

GEOLOGY REQUIREMENTS:

- 30. The Owner/Permittee shall submit a geotechnical investigation report or update letter that specifically addresses the proposed construction plans. The geotechnical investigation report or update letter shall be reviewed for adequacy by the Geology Section of the Development Services Department prior to issuance of any construction permits.
- 31. The Owner/Permittee shall submit an as-graded geotechnical report prepared in accordance with the City's "Guidelines for Geotechnical Reports" following completion of the grading. The asgraded geotechnical report shall be reviewed for adequacy by the Geology Section of the Development Services Department prior to exoneration of the bond and grading permit close-out.

LANDSCAPE REQUIREMENTS:

- 32. Prior to issuance of any engineering permits for grading, the Owner/Permittee shall submit complete construction documents for the revegetation and hydroseeding of all disturbed land in accordance with the Landscape Standards and to the satisfaction of the Development Services Department. All plans shall be in substantial conformance to this permit (including Environmental conditions) and Exhibit "A," on file in the Office of the Development Services Department.
- 33. Prior to issuance of any engineering permits for right-of-way improvements, the Owner/Permittee shall submit complete landscape construction documents for right-of-way improvements to the Development Services Department for approval. Improvement plans shall show, label, and dimension a 40 sq-ft area around each tree which is unencumbered by utilities. Driveways, utilities, drains, water and sewer laterals shall be designed so as not to prohibit the placement of street trees.
- 34. In the event that a foundation only permit is requested, the Owner/Permittee shall submit a site plan or staking layout plan identifying all landscape areas consistent with Exhibit "A," Landscape

Development Plan, on file in the Office of the Development Services Department. These landscape areas shall be clearly identified with a distinct symbol, noted with dimensions and labeled as "landscaping area."

- 35. Prior to issuance of any construction permits for structures, the Owner/Permittee shall submit complete landscape and irrigation construction documents consistent with the Landscape Standards to the Development Services Department for approval. The construction documents shall be in substantial conformance with Exhibit "A," Landscape Development Plan, on file in the Development Services Department. Construction plans shall show, label, and dimension a 40 square-foot area around each tree which is unencumbered by hardscape and utilities as set forth under SDMC 142.0403(b)(5).
- 36. Prior to issuance of any construction permits for structures, the Owner/Permittee shall submit a water budget in accordance with the Water Conservation Requirements per SDMC 142.0413, Table 142-04I, to be included with the construction documents. An irrigation audit shall be submitted consistent with Section 2.7 of the Landscape Standards of the Land Development Manual at final inspection. The irrigation audit shall certify that all irrigation systems have been installed and operate as approved by the Development Services Department.
- 37. The Owner/Permittee shall be responsible for the maintenance of all landscape improvements shown on the approved plans, including in the right-of-way, consistent with the Landscape Standards unless long-term maintenance of said landscaping will be the responsibility of a Landscape Maintenance District or other approved entity. All required landscape shall be maintained in a disease, weed and litter free condition at all times. Severe pruning or "topping" of trees is not permitted unless specifically noted in this Permit.
- 38. If any required landscape (including existing or new plantings, hardscape, landscape features, etc.) indicated on the approved construction document plans is damaged or removed during demolition or construction, the Owner/Permittee shall repair and/or replace it in kind and equivalent size per the approved documents to the satisfaction of the Development Services Department within 30 days of damage.

PLANNING/DESIGN REQUIREMENTS:

- 39. A topographical survey conforming to the provisions of the SDMC may be required if it is determined, during construction, that there may be a conflict between the building(s) under construction and a condition of this Permit or a regulation of the underlying zone. The cost of any such survey shall be borne by the Owner/Permittee.
- 40. Prior to the issuance of building permits, construction documents shall fully illustrate the incorporation of a roof-mounted photovoltaic system consisting of solar panels sufficient to generate at least 50 percent of the proposed project's projected energy consumption, in conformance with the criteria of the Affordable/In-Fill Housing and Sustainable Buildings Expedite Program.

- 41. All signs associated with this development shall be consistent with sign criteria established by either the approved Exhibit "A" or City-wide sign regulations.
- 42. All private outdoor lighting shall be shaded and adjusted to fall on the same premises where such lights are located and in accordance with the applicable regulations in the SDMC.

TRANSPORTATION REQUIREMENTS

43. No fewer than 22 parking spaces shall be maintained on the property at all times in the approximate locations shown on Exhibit "A." All on-site parking stalls and aisle widths shall be in compliance with requirements of the City's Land Development Code and shall not be converted and/or utilized for any other purpose, unless otherwise authorized in writing by the Development Services Department.

PUBLIC UTILITIES DEPARTMENT REQUIREMENTS:

- 44. Prior to the issuance of any building permits, the Owner/Permittee shall apply for a plumbing permit for the installation of appropriate private back flow prevention device(s) [BFPDs], on each water service (domestic, fire and irrigation), in a manner satisfactory to the Public Utilities Director and the City Engineer. BFPDs shall be located above ground on private property, in line with the service and immediately adjacent to the right-of-way. The Public Utilities Department will not permit the required BFPDs to be located below grade or within the structure.
- 45. Prior to the issuance of any building permits, the Owner/Permittee shall assure, by permit and bond, the design and construction of all public water and sewer facilities are to be in accordance with established criteria in the most current City of San Diego Water and Sewer Design Guides.
- 46. All public water and sewer facilities are to be in accordance with the established criteria in the most current City of San Diego Water and Sewer Design Guides.
- 47. All proposed private water and sewer facilities located within a single lot are to be designed to meet the requirements of the California Uniform Plumbing Code and will be reviewed as part of the building permit plan check.
- 48. No trees or shrubs exceeding three feet in height at maturity shall be installed within ten feet of any sewer facilities and five feet of any water facilities.
- 49. Prior to the issuance of any building permits, the Owner/Permittee shall assure, by permit and bond, to cap (abandon) at the property line any existing unused sewer lateral and install new sewer lateral(s) which must be located outside of any driveway or vehicular use area.
- 50. Prior to the issuance of any building permits, the Owner/Permittee shall assure, by permit and bond, to remove (kill) at the main any existing unused water service.
- 51. Prior to issuance of any building permits, the Owner/Permittee shall obtain an Encroachment, Maintenance and Removal Agreement (EMRA) for proposed improvements of any kind, including

utilities, landscaping, enriched paving, curb, gutter and sidewalk, and electrical conduits to be installed within the public sewer easement.

- 52. Prior to issuance of any building permits, the Owner/Permittee shall obtain an Encroachment, Maintenance and Removal Agreement (EMRA) for proposed 6-inch PVC private sewer main in the 30-foot sewer easement.
- 53. Prior to the issuance of any building permits, the Owner/Permittee shall assure, by permit and bond, the design and construction of the deep footings adjacent to the required 30-foot sewer easement. Due to the depth existing sewer main, the Owner/Permittee will be required to construct deep footings to ensure that the pressure of the structure is outside of the 45 degree influence zone measured from the bottom of the pipe to the surface. Structural calculation shall be required at the time of Ministerial review.
- 54. Prior to the issuance of any building permits, the required 30-foot sewer easement dedication shall be recorded per drawing 39441-1-B.

INFORMATION ONLY:

- This property is located in the Overflight Area for the Airport Land Use Compatibility Plan for San Diego International Airport. For that reason, the property may be subject to some of the annoyances or inconveniences associated with proximity to an airport and aircraft operations (for example, noise, vibration, overflights or odors). Individual sensitivities to those annoyances can vary from person to person. The San Diego County Regional Airport Authority may be contacted for information regarding hours of operation, master plans, and other relevant information regarding airport operations. The FAA has sole and exclusive regulatory authority over the operation of aircraft.
- The issuance of this discretionary permit alone does not allow the immediate commencement or continued operation of the proposed use on site. The operation allowed by this discretionary use permit may only begin or recommence after all conditions listed on this permit are fully completed and all required ministerial permits have been issued and received final inspection.
- Any party on whom fees, dedications, reservations, or other exactions have been imposed as conditions of approval of this Permit, may protest the imposition within ninety days of the approval of this development permit by filing a written protest with the City Clerk pursuant to California Government Code-section 66020.
- This development may be subject to impact fees at the time of construction permit issuance.

APPROVED by the H	earing Officer of the City	of San Diego on March 1:	5, 2017, and Resolution
Number			

Permit Type/PTS Approval No.: SDP No. 1487345

Date of Approval: March 15, 2017

ALITHENTICATED	RV THE CITY	OF SAN DIEGO	DEVELODMENT	CEDVICES	TEDADTMENIT

Jeffrey A. Peterson
Development Project Manager

NOTE: Notary acknowledgment must be attached per Civil Code section 1189 et seq.

The undersigned Owner/Permittee, by execution hereof, agrees to each and every condition of this Permit and promises to perform each and every obligation of Owner/Permittee hereunder.

GH3, LLC, a California Limited Liability Company Owner/Permittee

By _____ Name: Title:

NOTE: Notary acknowledgments must be attached per Civil Code section 1189 et seq.

RESOLUTION NUMBER R
DATE OF FINAL PASSAGE

A RESOLUTION VACATING PORTIONS OF A DRAINAGE EASEMENT-EASEMENT VACATION NO. 1487342 FOR GOLDEN HILL B STREET HOMES -PROJECT NO. 422242

WHEREAS, California Streets and Highways Code section 8320 *et seq.* and San Diego Municipal Code section 125.1001 *et seq.* provide a procedure for the vacation of public service easements; and

WHEREAS, GH3, LLC, a California Limited Liability Company (Applicant), filed an application to vacate a portion of a15-foot drainage easement granted to the City of San Diego and reserved per City Council Resolution No. R-274719, adopted November 13, 1989, recorded as File No. 89-683492 onm December 18, 1989 and designated as Parcels "F" and "D" per City Drawing No. 15862-B, respectively, being described as Easement Vacation No. 1487342; and

WHEREAS, Easement Vacation No. 1487342 is located on property owned by GH3, LLC, a California Limited Liability Company; and specifically described and illustrated in the attached Exhibits "A" and "B", respectively; and

WHEREAS, the matter was set for public hearing on March 15, 2017, testimony having been heard, evidence having been submitted, and the Hearing Officer having fully considered the matter and being fully advised concerning the same; NOW, THEREFORE,

BE IT RESOLVED, by the Hearing Officer of the City of San Diego, that with respect to Easement Vacation No.1487342, the Hearing Officer finds that:

(a) There is no present or prospective public use for the easement, either for the facility or purpose for which it was originally acquired, or for any other public use of a like nature that can be anticipated.

An existing 36-inch Reinforced Concrete Pipe (RCP) and an 18-inch Corrugated Metal Pipe (CMP) City storm drains enter the property from the north along B Street and empties into the 15-foot drainage easement on site, which the storm water continues to the an existing basin located north of C Street that ties into the storm drain system to the south. A new 42-inch RCP drainage pipe will be installed within the existing 15-foot drainage easement to allow for the storm water to go through the property and to the existing basin located north of C Street. To allow for the new drainage pipe to line up with the existing basin, the Southwesterly portion of the 15-foot drainage easement as described and illustrated in the attached Exhibits "A" and "B", respectively, will be vacated, and new portions will be dedicated as shown on City Drawing No. 39442-B on the Northerly and Southeasterly sides of the existing drainage easement that will allow for a 15-foot wide easement. There is no prospective use for the easement to be vacated because it will be replaced with a new drainage easement that will serve the same function as the one being vacated.

(b) The public will benefit from the action through improved utilization of the land made available by the vacation.

A trapezoidal shaped drainage easement on the Northerly side and a triangular shaped drainage easement on the Southeasterly side of the existing drainage easement will be dedicated as shown on City Drawing No. 39442-B for the existing 36-inch RCP and new 18-inch RCP City storm drain pipes on site as part of the City storm drainage system. The width of the easement is to accommodate the accessibility and depth of the sewer main and drainage pipes. In addition, a new 42-inch RCP drainage pipe will be installed within the existing 15-foot drainage easement to allow for the storm water to go through the property and to the existing basin located north of C Street, as part of the City storm drainage system. To allow for the new drainage pipe to line up with the existing basin, the Southwesterly portion of the 15-foot drainage easement will be vacated as shown on City Drawing No. 39378-B, and new portions will be dedicated as shown on City Drawing No. 39442-B that will allow for a 15-foot wide easement. The public will benefit from the action through improved storm water management and utilization of the land to allow for the development 11 rent residential units within the Greater Golden Hill Community Planning area.

(c) The vacation is consistent with any applicable land use plan.

The vacant 0.59-acre site is located at 2871-2877 B Street in the GHPD-GH-1500 Zone of the Golden Hill Planned District within the Greater Golden Hill Community Plan. The zoning designation provides for residential development and allows for one-unit per 1,500 square foot of lot area. The Greater Golden Hill Community Plan allows medium residential density of 15-29 dwelling units per acre. The proposed project site, occupying 0.59-acres, could accommodate 17 dwelling units based on the underling zone and 9-17 dwelling units based on the community plan.

An existing 36-inch RCP and an 18-inch CMP City storm drains enter the property from the north along B Street and empties into the 15-foot drainage easement on site, which the storm water continues to the an existing basin located north of C Street that ties into the storm drain system to the south. A new 42-inch RCP drainage pipe will be installed within the existing 15-foot drainage easement to allow for the storm water to go through the property and to the existing basin located north of C Street. To allow for the new drainage pipe to line up with the existing basin, the Southwesterly portion of the 15-foot drainage easement will be vacated as shown on City Drawing No. 39378-B, and new portions will be dedicated as shown on City Drawing No. 39442-B that will

allow for a realigned 15-foot wide easement. Therefore, the proposed drainage easement will be vacation and dedication is consistent with any applicable land use plan.

(d) The public facility or purpose for which the easement was originally acquired will not be detrimentally affected by the vacation or the purpose for which the easement was acquired no longer exists.

A trapezoidal shaped drainage easement on the Northerly side and a triangular shaped drainage easement on the Southeasterly side of the existing drainage easement will be dedicated as shown on City Drawing No. 39442-B for the existing 36-inch RCP and new 18-inch RCP City storm drain pipes on site. The width of the easement is to accommodate the accessibility and depth of the drainage pipes. In addition, a new 42-inch RCP drainage pipe will be installed within the existing 15-foot drainage easement to allow for the storm water to go through the property and to the existing basin located north of C Street. To allow for the new drainage pipe to line up with the existing basin, the Southwesterly portion of the 15-foot drainage easement will be vacated as shown on City Drawing No. 39378-B, and new portions will be dedicated as shown on City Drawing No. 39442-B that will allow for a 15-foot wide easement. Therefore, the public facility and purpose for which the easement was originally acquired will not be detrimentally affected by the vacation.

BE IT FURTHER RESOLVED, that Easement Vacation No. 1487342, as more particularly described and illustrated in the attached Exhibits "A" and "B", respectively, which are by this reference incorporated herein and made a part hereof, is ordered vacated.

BE IT FURTHER RESOLVED, that the Development Services Department shall record a certified copy of this resolution with attached exhibits, attested by the City Clerk under seal, in the Office of the County Recorder.

APPROVED: By the Hearing Officer on March 15, 2017

Jeffrey A. Peterson
Development Project Manager

Development Services Department

EXHIBIT "A" LEGAL DESCRIPTION DRAINAGE EASEMENT VACATION

THOSE PORTIONS OF PARCELS "D" AND "F" AS SHOWN ON CITY OF SAN DIEGO DRAWING NO. 15826-B, AND SAID PARCELS "D" AND "F" BEING A DRAINAGE EASEMENT RESERVATION AND A DRAINAGE EASEMENT ACQUISITION RESPECTIVELY, IN FAVOR OF THE CITY OF SAN DIEGO, RECORDED DECEMBER 18, 1989 AS FILE NO. 89-683492 O.R. IN THE CITY OF SAN DIEGO, COUNTY OF SAN DIEGO, STATE OF CALIFORNIA, BEING MORE PARTICULARLY DECRIBED AS FOLLOWS:

BEGINNING AT THE NORTHEAST CORNER OF LOT 1, IN BLOCK 63 OF MAP NO. 547, THENCE EASTERLY ALONG THE NORTHERLY LINE OF VACATED 29TH STREET, PER FILE NO. 89-683492, RECORDED DECEMBER 18, 1989, ADJACENT TO SAID BLOCK 63, SOUTH 89°54′37″, EAST 30.01 FEET TO THE CENTERLINE OF SAID VACATED 29TH STREET; THENCE SOUTHERLY ALONG SAID CENTERLINE SOUTH 00°00′23″ EAST 149.20 FEET TO THE EASTERLY EXTENSION OF THE CENTERLINE OF THE VACATED ALLEY ADJACENT TO SAID BLOCK 63, PER FILE NO. 89-683492, RECORDED DECEMBER 18, 1989; THENCE WESTERLY ALONG SAID EASTERLY EXTENSION LINE, SOUTH 89°53′10″ WEST, 19.76 FEET TO THE TRUE POINT OF BEGINNING; THENCE SOUTH 42°41′26″ EAST, 11.54 FEET; THENCE SOUTH 52°25′40″ WEST, 7.46 FEET TO A POINT ON THE SOUTHWESTERLY LINE OF SAID EASEMENT PARCEL "D"; THENCE NORTHWESTERLY ALONG THE SOUTHWESTERLY LINE OF SAID PARCEL "D" AND PARCEL "F", NORTH 37°34′20″ WEST, 83.24 FEET; THENCE LEAVING SAID SOUTHWESTERLY LINE, SOUTH 42°41′26″ EAST, 72.03 FEET TO THE TRUE POINT OF BEGINNING.

CONTAINS 310.31 SQUARE FEET, MORE OF LESS.

ATTACHED HERETO IS A DRAWING NO. 39378-B LABELED EXHIBIT "B" AND BY THIS REFERENCE MADE A PART HEREOF.

PTS, 422242 I.O NO, 24005877 DWG, NO, 39378-B

ANTONY K. CHRISTENSEN


PLS 7508

09-29-16

DATE

JN 2015-07

EXHIBIT "B"

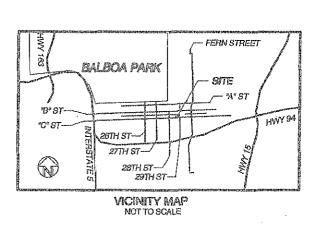

	=(3	7	V	
Her.	***	201	722.0	-91	<u> </u>

INDICATES DRAINAGE EASEMENT VACATION CONTAINS 310.31 SQUARE FEET (0.007 AC)

) INDICATED REC. DATA PER CITY DWG. NO 15826-B] INDICATES REC. DATA PER MAP NO. 547

BASIS OF BEARINGS

THE NORTHERLY LINE OF THE VACATED ALLEY IN BLOCK 63 OF MAP NO, 547 AS SHOWN ON CITY OF SAN DIEGO DRAWING NO. 16826-B. I.E.NORTH 89*5340" EAST

REFERENCE DRAWINGS

15926-B MAP NO. 547 MAP NO. 16049

apn

539-521-01-00 539-521-25-00



A2015-07

CHRISTENSEN ENGINEERING

& SURVEYING

7888 SILVERTON AVENUE, SUITE J SAN DIEGO, CA 92128 (858) 271-9901

(858) 271-9801, 171 (Million)

09/29/2016

DATE

ANTONY K. CHRISTENSEN L.S. 7508. EXPIRES 12-31-1


RESOLUTION	NO.


ADOPTED: DOCUMENT NO.: RECORDED:

DRAINAGE EASEMENT VACATION

IN LOTS 1-3, IN BLOCK 69 OF MAP NO. 547 VACATED ALLEY AND 29TH STREET PER DOC NO.89-683492, REC. 12/16/1989, AND LOT 1 OF MAP 16049

Under William Control			 				*****
DESCRIPTION	BY	APPROVED	FILMED	CITY OF SAN DIE	GO, CALIFORNIA	P.T.S.	422242
ORIĞINAL :	CEAS			SHEET1	OF 2 SHEET	ю но.	24005877
				Vinley R. S. Par FOR CITY ENGINEER	4/15/17 DATE	,	870-625 5 S 83 COORDINATES
				DIVISION HEAD	,		230-1625 ERT COORDINATES
			STATUS	SECTION HEAD		3	9378-1-B

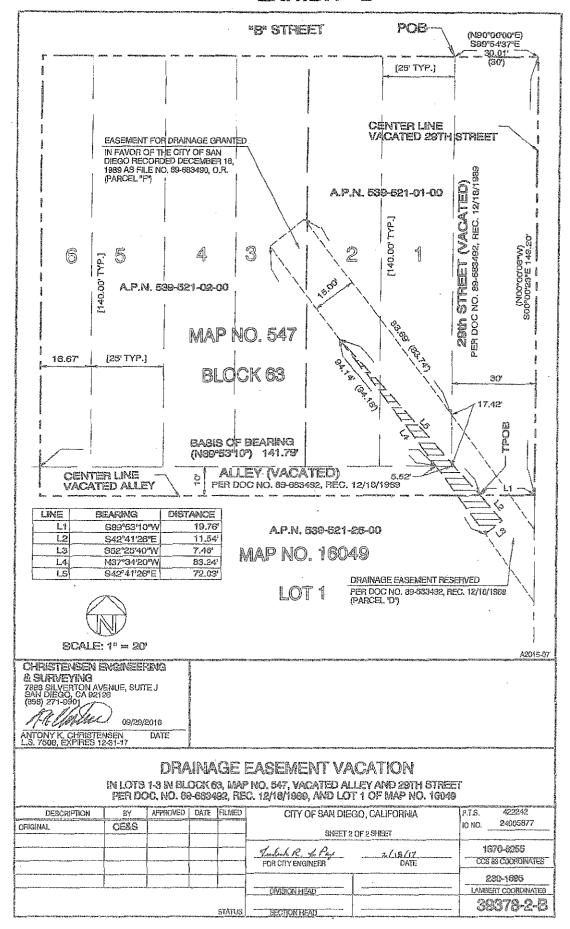

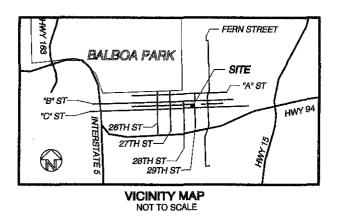

Ļ	GEND
E	INDICATES DRAINAGE EASEMENT ACQUIRED CONTAINS 1,812.95 SQUARE FEET (0.042 AC)
_	PARCEL "A" AREA: 1461.43 SQ FT (0.034 AC) PARCEL "B" AREA: 351.52 SQ FT (0.008 AC)
)). INDICATES REC. DATA PER CITY DWG NO. 15826-B INDICATES REC. DATA PER MAP NO. 547

BASIS OF BEARINGS

THE NORTHERLY LINE OF VACATED ALLEY IN BLOCK 63 OF MAP NO. 547 AS SHOWN ON CITY OF SAN DIEGO DRAWING NO. 15826-B. I.E.NORTH 89°53'10" EAST

LINE	BEARING	DISTANCE
L1	S00°00'23"E	12.32'
L2,	N37°34'20"W	93.61'
L3	\$42°41'26"E	84.18'
L4	\$00°10'53"W	55.55'
L5	\$52°25'40"W	15,00
L6	N19°31'21"W	66.63
L7	N89°59'28"E	35.00

REFERENCE DRAWINGS

15826-B MAP NO. 547 MAP NO. 16049

APN

539-521-01-00 539-521-02-00 539-521-25-00



A2015-07

CHRISTENSEN	ENGINEERING
& SURVEYING	

7888 SILVERTON AVENUE, SUITE J SAN DIEGO, CA 92126 (858) 271-9601

ANTONY K. CHRISTENSEN L.S. 7508, EXPIRES 12-31-17

DATE


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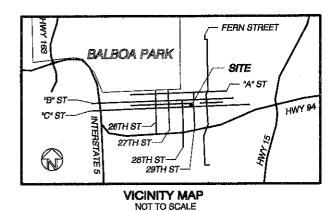
DOCUMENT	NO.:	
RECORDED:		

DRAINAGE	FASEMENT	DEDICATION

IN LOTS 1-4, IN BLOCK 63 OF MAP NO. 547 VACATED ALLEY AND 29TH STREET PER DOC NO. 89-683492, REC. 12/18/1989, AND LOT 1 OF MAP 16049

DESCRIPTION	BY	APPROVED	DATE	FILMED	CITY OF SAN DIEC	GO, CALIFORNIA	P.T.S. 422242
ORIGINAL	CEAS				SHEET 1	OF 2 SHEET	IO NO. <u>24005877</u>
					FOR CITY ENGINEER	DATE	1870-6255 CCS 83 COORDINATES
1100					DIVISION HEAD		230-1695 LAMBERT COORDINATES
				STATUS	SECTION HEAD		39442-1-B



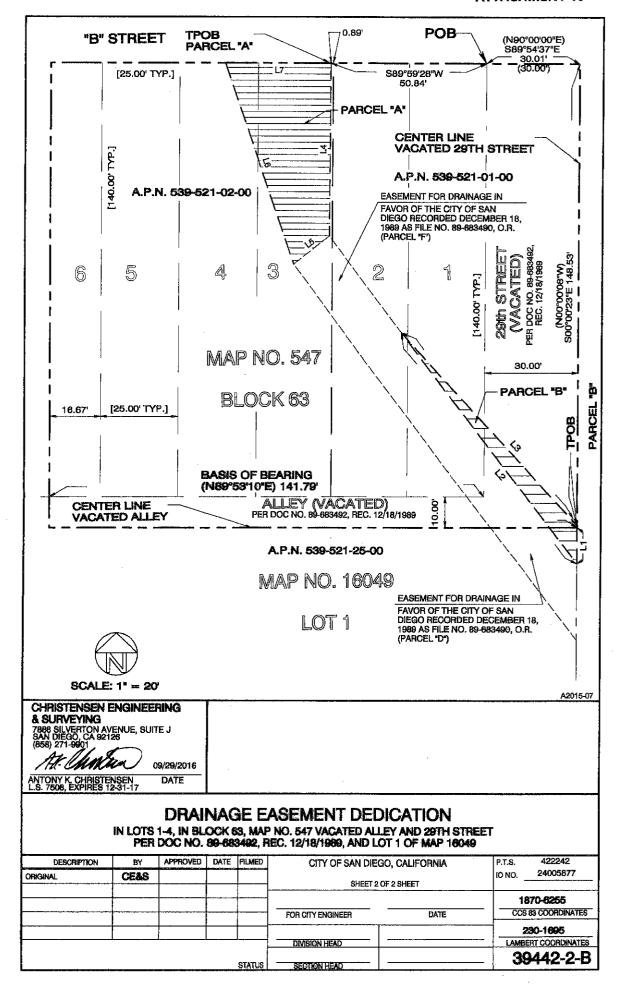

,	LEC	<u> END</u>		
			INDICATES SEWER EASEMENT ACQUIRED CONTAINS 4,185.91 SQUARE FEET (0.096 AC	C)
1	()		ES REC. DATA PER CITY DWG, NO. 15826-B ES REC. DATA PER MAP NO. 547	

BASIS OF BEARINGS

THE NORTHERLY LINE OF THE VACATED ALLEY IN BLOCK 63 OF MAP NO. 547 AS SHOWN ON CITY OF SAN DIEGO DRAWING NO. 15826-B.
I.E.NORTH 89°53°10" EAST

REFERENCE DRAWINGS

15826-B MAP NO. 547 MAP NO. 16049

APN 539-521-02-00



A2	Ωí	5	07	

CHRISTENSEN ENGINEERING

8 SURVEYING
7888 SILVERTON AVENUE, SUITE J
SAN DIEGO. CA 92126
(858) 271-9901
AL./JANAW
09/29 ANTONY K. CHRISTENSEN LS. 7508, EXPIRES 12-31-17


09/29/2016 DATE

DOCUMENT NO.:	
RECORDED:	

SEWER EASEMENT DEDICATION

IN LOTS 5-6, IN BLOCK 63, MAP NO. 547

DESCRIPTION	BY.	APPROVED	DATE	FILMED	CITY OF SAN DIEGO, CALIFORNIA	P.T.S. 422242
ORIGINAL	CE&S				SHEET 1 OF 2 SHEET	IO NO. <u>24005877</u>
	<u> </u>					1870-6255
		<u> </u>		 	FOR CITY ENGINEER DATE	CCS 83 COORDINATES
•		<u> </u>		 		230-1695
	*		·	-l	DIMISION HEAD	LAMBERT COORDINATES
				STATUS	SECTION HEAD	3944 1-1-B

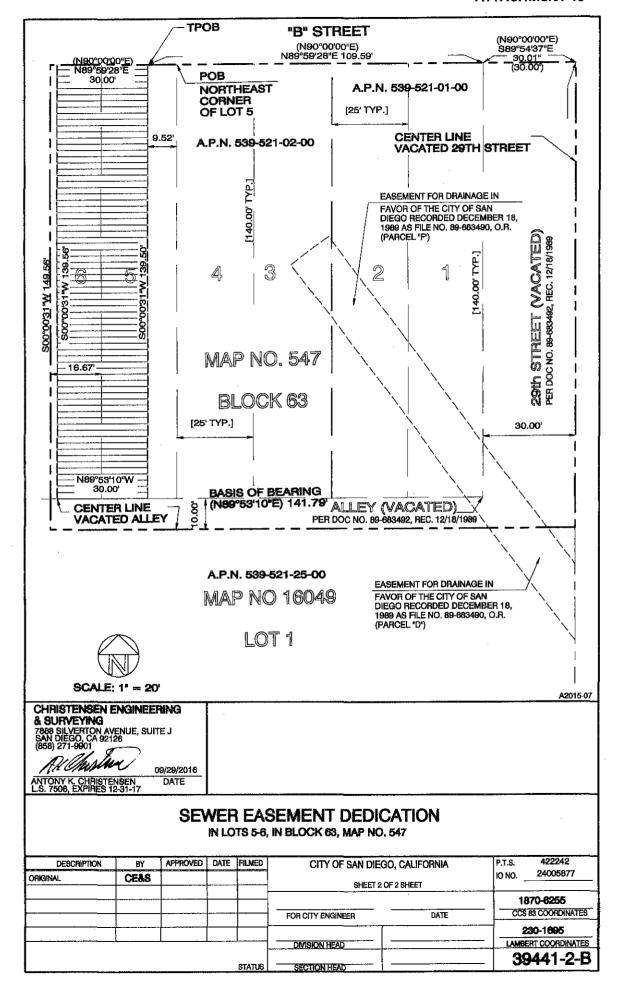

HEARING OFFICER RESOLUTION NUMBER _____ A RESOLUTION ADOPTING NEGATIVE DECLARATION NO. 422242 GOLDEN HILL B STREET HOMES -PROJECT NO. 422242

WHEREAS, on August 10, 2015, David Hawkins submitted an application to Development Services Department for a Site Development Permit and Easement Vacation for the Golden Hill B Street Homes (Project); and

WHEREAS, the matter was set for a public hearing to be conducted by the Hearing Officer of the City of San Diego; and

WHEREAS, the issue was heard by the Hearing Officer on March 15, 2017; and

WHEREAS, the Hearing Officer considered the issues discussed in Negative Declaration No. 422242 (Declaration) prepared for this Project; NOW THEREFORE,

BE IT RESOLVED, by the Hearing Officer that it is certified that the Declaration has been completed in compliance with the California Environmental Quality Act of 1970 (CEQA) (Public Resources Code Section 21000 et seq.), as amended, and the State CEQA Guidelines thereto (California Code of Regulations, Title 14, Chapter 3, Section 15000 et seq.), that the Declaration reflects the independent judgment of the City of San Diego as Lead Agency and that the information contained in said Declaration, together with any comments received during the public review process, has been reviewed and considered by the Hearing Officer in connection with the approval of the Project.

BE IT FURTHER RESOLVED, that the Hearing Officer finds on the basis of the entire record, including the Initial Study and any comments received, that there is no substantial evidence that the Project will have a significant effect on the environment, and therefore, that said Declaration is hereby adopted.

BE IT FURTHER RESOLVED, that the Declaration and other documents constituting the record of proceedings upon which the approval is based are available to the public at the office of the DEVELOPMENT SERVICES DEPARTMENT, 1222 FIRST AVENUE, SAN DIEGO, CA 92101.

BE IT FURTHER RESOLVED, that Development Services Staff is directed to file a Notice of Determination with the Clerk of the Board of Supervisors for the County of San Diego regarding the Project.

APPROVED: By the Hearing Officer on March 15, 2017

Зу:	
•	Jeffrey A. Peterson
	Development Project Manager
	Development Services Department

Peterson, Jeff

From:

goldenhillplanning@sbcglobal.net Friday, April 29, 2016 9:07 AM

Sent: To:

Peterson, Jeff; Chris@H2asandiego.com; Turgeon, Bernard

Subject:

B Street Town Homes at Greater Golden Hill Community Planning Committee

Hello.

I am the new chair of the Greater Golden Hill Community Planning Committee, and had received requests from both City staff and the developer relative to our action of support on this project.

The following is an extract from the draft minutes of our meeting of 11/11/16 at which this project was considered.

I have not been able to confirm when these minutes were adopted, but I do not recall any change which affected this action of the group.

I did correct one spelling- "space" in place of "speace".

Please let me know if you have any further inquiry.

Yours, David Swarens. Chair, GGHCPC

VI. Project Approval Request from B Street Town Homes (David Hawkins, Matthew Gordon, Chris Varone, Sirma Saddiq, Tony Christensen, Jim Neri.)

The project consists of 11 units on the South Side of "B" Street, at 29th Street (vacated). This is a "Cloud Condo", the first City project under the new Small Lot Subdivision that went into effect in June. There were extensive questions from GGHPC members about environmental issues, parking for residents and guests, traffic impact, access, crime, drainage/flooding, paleontological findings, landscaping, maintenance of common space, solar, flyways, species impact, animal corridor, adjacent canyon, public pedestrian easement, future price of homes, and other matters.

The Chair also invited members of the public to address the project. One man ("Kenny") also had concerns about traffic and parking.

Brierton indicated that at the City Training 9/29/15, "What to Know When Reviewing Public and Private Development Projects", presented Paul Godwin (Development Project Manager) indicated that reasons/findings had to be stated in voting on project. The Chair indicated, however, that she was told at the Chairs' meeting that this requirement was only when projects were disapproved, and not when they were approved.

Swarens moved, Baldwin seconded. Approve the project as presented. Motion carried. 7-yes (Alvarez, Baldwin, Brierton, Lee, Serocki, Sims, Swarens); 1-no (Zakarian); 2-abstain (Curran, Davis).



City of San Diego Development Services 1222 First Ave., MS-302 San Diego, CA 92101 (619) 446-5000

Ownership Disclosure Statement

Tim Corp or Ting thee,

Project Title		Project No. For City Use Only		
B.St.Homes		42242		
Project Address:		The state of the s		
B St in Golden I	HIL 92102 Lot 1-APN 539	9-521-0100 & Lot 2- APN 539-521-0200		
art I - To be completed w	hen property is held by Individua	il(s)		
cove, will be filed with the City elow the owner(s) and tenant(ho have an interest in the prop dividuals who own the proper om the Assistant Executive Dia evelopment Agreement (DDA) anager of any changes in own	y of San Diego on the subject property s) (if applicable) of the above reference terty, recorded or otherwise, and state to ty). A signature is required of at least of rector of the San Diego Redevelopment o has been approved / executed by the tership during the time the application if irty days prior to any public hearing of y in the hearing process.	edge that an application for a permit, map or other matter, as identified a with the intent to record an encumbrance against the property. Please liked property. The fist must include the names and addresses of all person the type of property interest (e.g., tenants who will benefit from the permit, a one of the property owners. Attach additional pages if needed. A signatural Agency shall be required for all project parcels for which a Disposition at Agency shall be required for all project parcels for which a Disposition are City Council. Note: The applicant is responsible for notifying the Proje is being processed or considered. Changes in ownership are to be given the subject property. Failure to provide accurate and current ownership		
lame of Individual (type or	print):	Name of Individual (type or print):		
Respond to the first of the second se	probability of the second seco	1 Produce of the second of the		
Owner Tenant/Less	see Redevelopment Agency	Owner Tenant/l_esses Redevelopment Agency		
treet Address:		Street Address:		
tty/State/Zip:		City/State/Zip:		
hone No:	Fax No:	Phone No: Fax No:		
	Date:	Signature : Date:		
ignature :				
		Name of Individual (type or print):		
		Name of Individual (type or print): Owner Tenant/Lessee Redevelopment Agency		
ame of Individual (type or) Owner Tenant/Lesse	·			
ame of Individual (type or Owner Tenant/Lesse	·	Cowner Tenant/Lessee Redevelopment Agency		
ame of Individual (type or of Owner Tenant/Lesse treet Address:	·	Cowner Tenant/Lessee Redevelopment Agency Street Address:		
ignature : ame of Individual (type or) Owner Tenant/Lesse treet Address: ity/State/Zip: hone No: gnature :	e Redevelopment Agency	Owner Tenant/Lessee Redevelopment Agency Street Address: City/State/Zip:		

B St Homes	422242
Part II - To be completed when property is held by a corpora	tion or partnership
Legal Status (please check):	
X Corporation X Limited Liability -or- General) What State Partnership	te? Ca Corporate Identification No. 20-3656600
the property Please list below the names, titles and addresses of	subject property with the intent to record an encumbrance against of all persons who have an interest in the property, recorded or the will benefit from the permit, all corporate officers, and all partners of at least one of the corporate officers or partners who own the is responsible for notifying the Project Manager of any changes in considered. Changes in ownership are to be given to the Project opect property. Failure to provide accurate and current ownership
Corporate/Partnership Name (type or print):	Corporate Parties and Name (type or print):
Owner Tenant/Lessee	Cowner [Tenant/Lessee
Street Address: 814 Morena Blvd, Suite #310	Street Address: 814 Morena Blvd Suite #310
City/State/Zip:	City/State/Zip: San Diego, CA 92110
Phone No:	Phone No: 619-246-3509 Fax No:
Matthew Gordon Name of Corporate Officer/Partner (type or print): Manager	Name of Corporate Officer/Partner RyChorPin Montano
Manager Tille (type or manager)	Title (type or print): Manager
Signature : Date:	Signature: Date: 11/5/2015 12:13 PM
Corporate/Earlnership Name (type or print):	ComvateApriteishin dape (type or print):
X Owner Tenant/Lessee	X Owner Tenant/Lessee
Street Address: 814 Morena Blvd #310	Street Address: 814 Morena Blvd #310
City/State/Zip: San Diego, CA 92110	City/State/Zip: San Diego, CA 92110
Phone No: 619-246-3509 Fax No:	Phone No: 619-246-3509 Fax No:
Name of Copperate Officer/Bartings (type or print):	Name of Regitate Office Healing (type or print):
Title (type or print): Manager	Title (type or print):
Signature: Date: 11/5/2015 12	: Fight Me in The Date: 11/5/2015 12:13 PM Richard Montano
Corporate/Partnership Name (type or print):	Corporate/Partnership Name (type or print):
Owner Tenant/Lessee	Owner Tonant/Lossee
Street Address:	Street Address:
City/State/Zip:	City/State/Zip:
Phone No: Fax No:	Phone No: Fax No:
Name of Corporate Officer/Partner (type or print):	Name of Corporate Officer/Partner (type or print):
Title (type or print)	Title (type or print):
Signature : Date:	Signature : Date:





PROJECT DEVELOPMENT INFORMATION

BUILDING CODE ANALYSIS

REGULATING CODES: 2013 CALIFORNIA BUILDING CODE

(BASED ON 2012 INTERNATIONAL BUILDING CODE (IBC))
2013 CALIFORNIA FIRE CODE (BASED ON 2012 INTERNATIONAL FIRE CODE (IFC)) 2013 CALIFORNIA ELECTRICAL CODE (BASED ON 2011 NATIONAL ELECTRIC CODE (NEC))
2013 CALIFORNIA MECHANICAL CODE

(BASED) ON 2012 UNIFORM MECHANICAL CODE (UMC)) 2013 CALIFORNIA PLUMBING CODE

(BASED ON 2012 UNIFORM PLUMBING CODE (UPC))
2010 CALIFORNIA GREEN BUILDING STANDARDS CODE RESIDENTIAL AND PRIVATE GARAGES PROPOSED USE:

R-3 = RESIDENTIAL (PER SECTION 310) OCCUPANCY: R-2 = RESIDENTIAL (PER SECTION 310 U = PRIVATE GARAGE (PER SECTION 312)

TYPE VB. FULLY SPRINKLERED PER NEPA 13D (UNITS 1, 2, 10 & 11) CONSTRUCTION TYPE: TYPE VA, FULLY SPRINKLERED PER NFPA 13D (UNITS 3, 4, 5, 6, 7, 8 & 9)

ALLOWABLE BUILDING HEIGHT: R-3 = 60'-0" (PER SECTION 504.2)

R-2 = 50'-0" (PER TABLE 503) U = 40'-0" (PER SECTION 503)

PROPOSED BUILDING HEIGHT: 36' MAXIMUM

R-3 = 3 STORIES (PER SECTION 504.2) ALLOWABLE STORIES: R-2 = 3 STORIES (PER TABLE 503) U = 1 STORY (PER SECTION 406.1.1)

PROPOSED STORIES: R-3 = 3 STORIES (MAXIMUM)

R-2 = 3 STORIES (MAXIMUM) U = 1 STORY

ALLOWABLE FLOOR AREA:

R-3 = UNLIMITED (PER TABLE 503) = 12,000 SF (PER TABLE 503) U = 5,500 SF (PER TABLE 503) PROPOSED FLOOR AREA: R-3 = CONFIRM AREA

R-2 = CONFIRM AREA 1 U = CONFIRM AREA *

REFER TO AREA SUMMARY BELOW, NO INDIVIDUAL UNIT EXCEEDS THE ALLOWABLE AREA FOR R-2, R-3 AND U OCCUPANCIES

REFER TO "PROJECT SUMMARY" ON SHEET BUILDING AREA ANALYSIS TO.1 FOR BUILDING/PROJECT AREAS.

FIRE RESISTIVE REQUIREMENTS: PRIMARY STRUCTURAL FRAME: NON-RATED (PER TABLE 601) BEARING WALLS (EXTERIOR): NON-RATED

BEARING WALLS (INTERIOR): NON-RATED PARTITIONS (INTERIOR): NON-RATED FLOOR CONSTRUCTION AND SECONDARY MEMBERS NON-RATED

ROOF CONSTRUCTION AND SECONDARY MEMBERS:

EXTERIOR WALL: (PER TABLE 602, ITEM H)

GROUP R-3 AND GROUP U OCCUPANCIES. WHEN USED AS ACCESSORY TO GROUP R-3 OCCUPANCIES, SHALL NOT BE REQUIRED TO HAVE A FIRE RESISTANCE RATING WHERE THE FIRE SEPARATION DISTANCE IS 5 FEET OR MORE; OR WHEN EQUIPPED THROUGHOUT WITH AN AUTOMATIC RESIDENTIAL FIRE SPRINKLER SYSTEM INSTALLED IN ACCORDANCE WITH SECTION 903.3 THE FIRE RESISTANCE RATING SHALL NOT BE REQUIRED

1,677

WHERE THE FIRE RESISTANCE RATING IS 3 FEET OR MOR

NUMBER OF EXITS: 1 PER SECTION 1015.1, EXCEPTION 1

RESIDENTIAL / PARKING AREA SUMMARY

INTE	RIOR LIVIN	G AREA				INTERIOR	PARKING	EXTERIOR
UNIT	BEDROOMS	BASEMENT	LEVEL 1	LEVEL 2	LEVEL 3	TOTAL	TOTAL	TOTAL
		(SF)	(SF)	(SF)	(SF)	(SF)	(SF)	(SF)
1	3		397	733	670	1,800	411	209
2	3	-	357	733	701	1,791	418	154
3	3	254	103	713	699	1,769	391	177
4	3	245	100	696	681	1,725	381	167
5	3	245	100	696	681	1,725	381	167
6	2 2	185	130	661	694	1,670	391	129
7	2		424	431	710	1,565	408	225
8	2 2	288	288	148	711	1,435	419	
9	2		424	431	710	1,565	408	225
10	2	-	135	621	572	1,328	411	112
11	2	*	135	621	572	1,328	411	112
BASE	MENT ARE	A 1,217]					

TOTAL INTERIOR LIVING AREA

4,430 TOTAL PARKING AREA TOTAL EXTERIOR LIVING AREA (DECKS)

TOTAL ENCLOSED AREA 22,131

ZONING ANALYSIS

"GOLDEN HILL PLANNED DISTRICT"

APPLICABLE OVERLAY ZONES: TRANSIT AREA

TANDEM PARKING AIRPORT INFLUENCE AREA (REVIEW AREA 1) FOR THE SAN DIEGO INTERNATIONAL AIRPORT (SDIA), 65-70 CNEL NOISE CONTOUR AS DEPICTED IN THE ALUC, AND THE FAA PART 77 NOTIFICATION AREA.

BRUSH ZONES (300 FT) ZONE: GH-1500

LOT AREA 25.664 SF (0.59 ACRES) DENSITY ALLOWED: 17 UNITS = 1 UNIT / 1500 14 MAX. PER 158.0303(b) DENSITY PROPOSED 11 UNITS (1 PER 2.333 SF)

F.A.R. ALLOWED: 17,601 SF = 25,664(0.6) + 2,215 SF (50% ENCLOSED PARKING) F.A.R. PROPOSED: 16,484 SF (DOES NOT INCLUDE 1,217 SF OF BASEMENT) COVERAGE ALLOWED: 11 197 SF = 25.664 SF X (35) + 2.215 SF OF ENCLOSED PARKING

COVERAGE PROPOSED: 6.484 SF HEIGHT ALLOWED:

REQUIRED SETBACKS:

MAX DIA. DIM. PROVIDED:

30'-0" (MEASURED FROM PROPOSED GRADE OR EXISTING GRADE WHICHEVER IS LOWER.)

HEIGHT PROPOSED: 36'-0" MAX (WITHIN SITE AS MEASURED FROM PROPOSED GRADE)

10 FT (7' EACH STORY ABOVE 2ND) 6 FT (3' EACH STORY ABOVE 2ND) 15 FT

PROPOSED SETBACKS: 10'-0" (10'-6" ABOVE 2ND

STREET SIDE: 5 (3 PER 50' OF BUILDING ELEVATION)
INTERIOS SIDE: 2 (1.5 PER 50' OF BUILDING ELEVATION OFFSETTING PLANES REQUIRED:

OFFSETTING PLANES PROVIDED: STREET YARD REQUIRED: 4,300 SF = (172 FT x 25 FT) STREET YARD PROVIDED: 4 734 SE

MAX DIA. DIM. ALLOWED: 178 FT = (172 FT X .85)

TRANSPARENCY: 15 % FACH STORY OF STREET WALL

STREET DESIGN REQUIREMENTS: CONTEMPORARY STYLE

MANDATORY EXTERIOR MATERIAL: EXTERIOR CEMENT PLASTER

EXTERIOR FEATURES

1. A MINIMUM OF ONE CLERESTORY WINDOW PER 50 FEET OF

A MINIMOM OF ONE CLERESTORY WINDOW STREET ELEVATION
A MINIMUM OF ONE TRANSOM WINDOW
AN ENTRY PORCH
WINDOWS RECESSED AT LEAST 2 INCHES
EAVES WITH A MINIMUM 18 INCHES OVERHA

REQUESTED DEVIATIONS

12'-0" REAR SETBACK TO LEVEL 2 BALCONY (BUILDINGS AT 15'-0" SETBACK) ACCESS TO UNITS 7, 8 & 9 FROME NEW 14' DRIVEWAY OFF OF "B STREET"

TRANSPARENCY INTO GARAGES AT UNITS 7 & 9

BUILDING HEIGHT TO EXCEED 30' FROM EXISTING GRADE BY AS MUCH AS 27 FT. BUILDING HEIGHT TO EXCEED PROPOSED GRADE BY A MAXIMUM OF 36 FT)

REQUIRED DEVELOPMENT PERMITS

PROCESS 3 - A SITE DEVELOPMENT PERMIT (SDP) FOR A DEVELOPMENT WITHIN THE GOLDEN HILLS PLANNED DISTRICT THAT EXCEEDS THE THRESHOLD UNITS (3 UNITS). PROCESS 3 - A SITE DEVELOPMENT PERMIT FOR DEVIATIONS FROM THE DEVELOPMENT REGULATIONS

PROCESS 2 - ABANDONMENT OF PORTION OF EXISTING DRAINAGE EASEMENTS.

PREVIOUS REVIEWS

PROJECT WAS PREVIOUSLY REVIEWED AS PART OF A "PRELIMINARY REVIEW" PTS NO. 341728

PARKING REQUIREMENTS

TRANSIT AREA OVERLAY ZONE (PRELIMINARY REVIEW ASSESSMENT LETTER) TANDEM PARKING OVERLAY ZONE (PRELIMINARY REVIEW ASSESSMENT LETTER)

			UANT, BEDROOMS	PRO	/IDED	REQUIRED		
	UNIT	QUANT.		SPACES (PER UNIT)	SPACE (PROVIDED)	SPACES (PER UNIT)	SPACES (REQUIRE	
	1-6	(6)	3	2	12	2	12	
	7-9	(3)	2	2	6	2	6	
	10-11	(2)	2	2	4	2	4	
	TOTAL	20			22		22	

SUSTAINABLE EXPEDITE PROGRAM SUSTAINABLE, CLEAN & GREEN BLDG DEVELOPMENT TECHNIQUES:

- INFRASTRUCTURE TO ACCOMODATE & SUPPORT ROOFTOP PHOTOVOLTAIC PANELS WHICH PROVIDE 50%
- LOW-E GLAZING DROUGHT TOLERANT LANDSCAPE
- RAIN-SENSING SPRINKLERS
- LOW VOC PAINTS
- NATURAL LIGHTING

PROJECT DESCRIPTION

THE PROJECT CONSISTS OF 11 R-2 & R-3 TOWN HOMES ON A 25,664 S.F. LOT IN THE GOLDEN HILL PLANNED DISTRICT GH-1500 ZONE TOTALING 17,701 S.F. OF RESIDENTIAL AND 4,430 S.F. OF PARKING, ALL UNITS ARE THREE STORIES MAXIMUM IN HEIGHT.

PROJECT INFORMATION

PROJECT ADDRESS: B STREET - LOTS 1 & 2

LEGAL DESCRIPTION:

LOTS 1-5 AND EASTERLY 16.67' OF LOT 6, PLUS WESTERLY HALF OF 29TH STREET R.O.W. PLUS NORTHERNLY HALF OF VACATED ALLEY ON BLOCK 63 OF E.W. MORSE'S MAP 547

PROJECT TEAM

CONTACT: MATTHEW GORDON (619) 572-3556 ARCHITECT INS + HAWKINS ARCHITECTS, INC. CONTACT:

H2 - HAWKINS + HAWKI 141 14TH STREET SAN DIEGO, CA 92101 LANDSCAPE NERI LANDSCAPE ARCHITECTURE 928 HORNBLEND STREET, SUITE #3 SAN DIEGO, CA 92109

CIVIL ENGINEER CHRISTENSEN ENGINEERING AND SURVEYING 7888 SILVERTON AVENUE, SUITE J SAN DIEGO, CA 92126

GEOTECHNICAL ENGINEER

HETHERINGTON ENGINEERING INC 5365 AVENIDA ENCINAS, SUITE A CARL SBAD, CA 92008

CONTACT: TONY CHRISTENSEN (858) 271-9901

MARK HETHERINGTON (760) 931-1917

CONTACT:

JIM NERI (858) 274-3222

SHEET INDEX

GENERAL (1 SHEET) ARCHITECTURAL (11 SHEETS) A0.1 SITE PLAN A0.F FIRE ACCESS A1.1 LEVEL 1 PLAN A1.2 LEVEL 2 PLAN II.3 LEVEL 3 PLAN II.4 ROOF PLAN TO.1 TITLE SHEET A2.1 BUILDING ELEVAT A2.2 BUILDING ELEVAT A2.3 BUILDING ELEVAT A2.4 BUILDING ELEVAT A2.5 BUILDING ELEVAT LANDSCAPE (2 SHEETS)

L1.0 LANDSCAPE DEVELOPMENT PLAN L1.1 LANDSCAPE DEVELOPMENT PLAN AIRPORT NOTES:

ADEQUATE NOISE ATTENUATION WILL BE PROVIDED TO ENSURE AN INTERIOR NOISE DECIBEL OF 4548 CNEL FOR ALL HABITABLE ROOMS.

NEAREST TRANSPORTATION STOP IS APPROXIMATELY 750' EAST ON 30TH STREET.






GOLDEN HILL

B STREET HOMES

619.232.7700 fax 619.232.7770

COMPLETENESS CHECK SITE DEVELOPMENT PERMIT SUBMITTAL SITE DEVELOPMENT PERMIT SUBMITTAL TITLE SHEET SITE DEVELOPMENT PERMIT SUBMITTAL T0.1 SITE DEVELOPMENT PERRITS URBANIALAL 10-12-2016



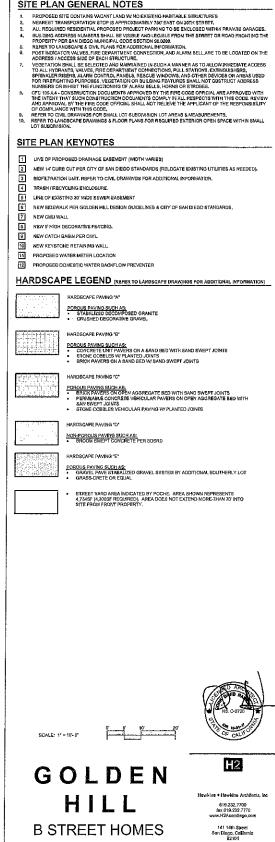


SITE PLAN GENERAL NOTES



Hawkins + Hawkins Architects, Inc.

		HANNING - HANNING ARCHITECTS, IN
ISSUE / REVISION DATES;		JOB NUMBER: 1306
COMPLETENESS CHECK	04-28-2015	
SITE DEVELOPMENT PERMIT SUBMITTAL 1	06-27-2016	
SITE DEVELOPMENT PERMIT SUBMITTAL 2	08-05-2016	SITE PLAN
SITE DEVELOPMENT PERMIT SUBMITTAL 3	11-04-2016	
SITE DEVELOPMENT PERMIT SUBMITTAL 4	04-06-2016	
SITE DEVELOPMENT PERMIT SUBMITTAL 5	07-18-2016	
SITE DEVELOPMENT PERMIT SUBMITTAL 7	10-12-2016	A0.1
	SHEET 7 OF 17	8GA1F: 1" = 10"+0"

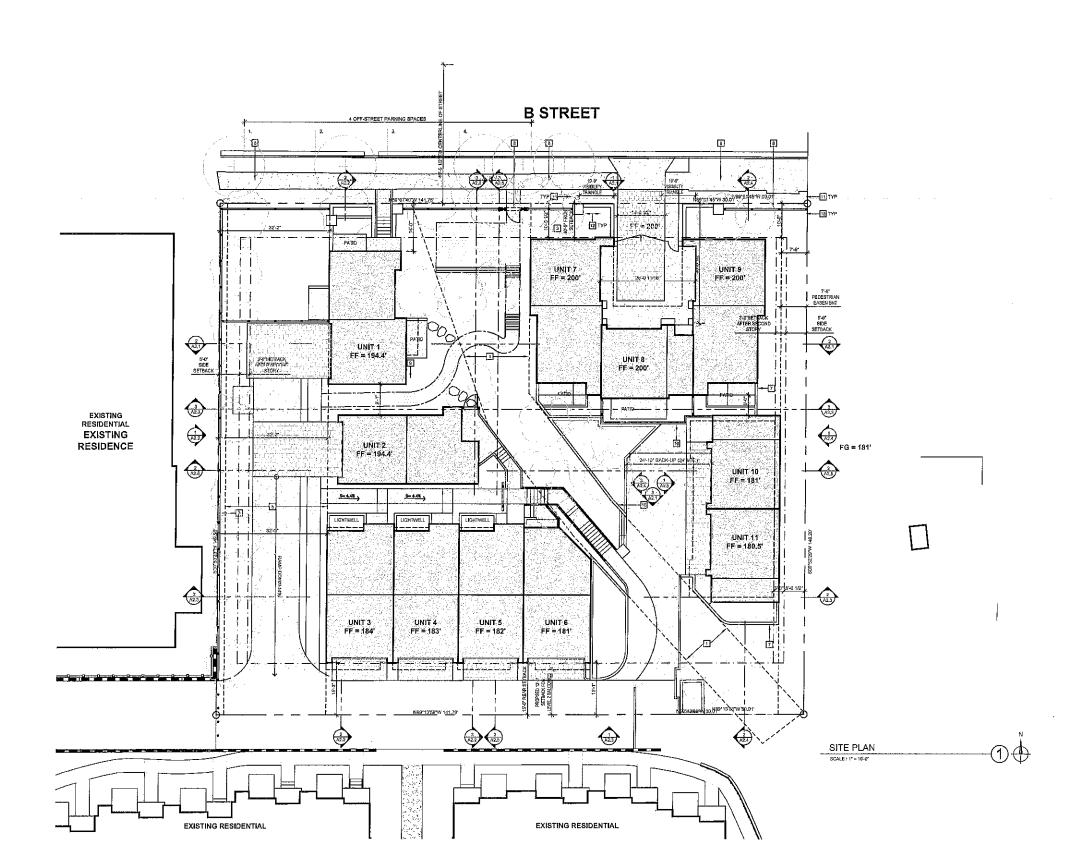

ATTACHMENT 14

FIRE ACCESS PLAN NOTES

- BUILDING ADDRESS NUMBERS SHALL BE VISILE AND EXISTE FROM THE STREET OR ROAD FRONTING THE PROPERTY PER SAN DIEGO MUNICIPAL COOR SECTION 36.000.

 PROPERTY PER SAN DIEGO MUNICIPAL COOR SECTION 36.000.

 ADDRESS ACCESS SISTE OF EACH STRUCTURE:


 ADDRESS ACCESS SISTE OF EACH STRUCTURE.

 YEGETATION SHALL BE SELECTED AND MANTANED IN SUCH A MANNER AS TO ALLOW RIMEDIATE ACCESS TO ALL HYDRANTS, VAMUES, FIRE DEPARTMENT CONNECTIONS, PULL STATIONS, EXTRIGUISHERS.

 SPRINLER BISSERS, ALARM CONTROL PANELS, RESCUE WINDOWS, AND OTHER DEVICES OR AREAS USED FOR REPROVITION PURPOSES, VEGETATION OF BUILDING FEATURES SHALL NOT DISTRUCT ADDRESS NUMBERS OR PRIEST THE TRUCTONING OF ALARM BILLS, HORNE OR STRUCES.

 CET 104.4 CONSTRUCTIONS OF CONTROL SEPROVED BY THE FIRE CODE OFFICIAL REAPPROVED UNTH AND APPROVAL BY THE FIRE CODE OFFICIAL SHALL NOT HE RESPONSIBILITY OF COMPLANCE WITH THIS CODE.



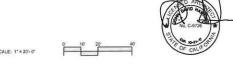

GOLDEN HILL

B STREET HOMES

		HANKS - HANKS ARCHITCTS INC
ISSUE / REVISION DATES:		JOB NUMBER: 1306
COMPLETENESS CHECK	04-28-2015	
SITE DEVELOPMENT PERMIT SUBMITTAL 1	05-27-2015	FIRE ACCESS
SITE DEVELOPMENT PERMIT SUBMITTAL 2	08-05-2015	SITE PLAN
SITE DEVELOPMENT PERMIT SUBMITTAL 3	11-04-2015	SHEPLAN
SITE DEVELOPMENT PERMIT SUBMITTAL 4	04-06-2016	
SITE DEVELOPMENT PERMIT SUBMITTAL 5	07-18-2016	
SITE DEVELOPMENT PERMIT SUBMITTAL 6	08-30-2016	A0.F
SITE DEVELOPMENT PERMIT SUBMITTAL 7	10-12-2016	7 1011
	SHEET 8 OF 17	SCALE: 1" = 10" - 0"

FLOOR & ROOF PLAN GENERAL NOTES

FLOOR & ROOF PLAN KEYNOTES

- 1 CLASS 'A' BUILT UP ROOF OR TPO ROOF
- ROOF TOP PHOTOVOLTAG PANELS DESIGNED TO PROVIDE 60% OF PROJECTED ENERGY OF FOR EACH UNIT.
 CONDENSER LOGATION
 ROOF AND OVERFLOW DRAIN

B STREET

UNIT 7

TYPE D1

UNIT 6
TYPE G3
F.F. = 181,50'
GARAGE
F.F. = 81,00'

UN|T 5

UNIT 8 TYPE E F.E. = 189,86'

UNIT 1

TYPE A F.F. = 194,90

UNIT 2 TYPE B F.F. = 194.90'

S= 4,4%

UNIT 3

UN|T4

(2) (A2.1)

(A2.3)

1 A22

A2.3

N89°01 45 W 30,01

UNIT 9

UNIT 10 TYPE F F.F. = 181.50* GARAGE F.F. = 181.00

UNIT 11 TYPE F.

(2) (A2.4)

LEVEL 1 FLOOR PLANS

- 5 24 SF MIN COVERED PORCH AREA
- 5 100 CUBIC FEET MIN STORAGE AREA @ # AFF WHERE INTRUDING IN PARKING SPACE
 7 PRIVATE EXTERIOR USABLE OPEN SPACE (SF AS NOTED)




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B STREET HOMES

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141 14(5 Street San Disgo, Cellfomia

		HACKING + HAMPHUS PROHITESTS, INC.
ISSUE / REVISION DATES:		JOB NUMBER: 1306
COMPLETENESS CHECK	04-28-2015	
SITE DEVELOPMENT PERMIT SUBMITTAL 1	05-27-2015	LEVEL 1
SITE DEVELOPMENT PERMIT BUBMITTAL 2	Q8-05-2016	
SITE DEVELOPMENT PERMIT BUBMITTAL 3	11-04-2015	FLOOR PLANS
SITE DEVELOPMENT PERMIT SUBMITTAL 4	04-08-2016	
SITE DEVELOPMENT PERMIT SUBMITTAL 5	07-18-2016	
SITE DEVELOPMENT PERMIT SUBMITTAL 6	DB-30-2016	A1.1
SITE DEVELOPMENT PERMIT SUBMITTAL 7	10-12-2016	· · · · · · · · · · · · · · · · · · ·
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FLOOR & ROOF PLAN KEYNOTES

- CLASS 'A' SULT UP ROOF OR TPO PROOF
 CROOF TOP PHOTOVOLTALO PANELS DESIGNED TO PROVIDE 60% OF PROJECTED ENFOREMENT OF PROJECTED ENFOREMENT OF PROJECTED ENFOREMENT OF PROJECTED ENFORCEMENT OF PROJEC

B STREET

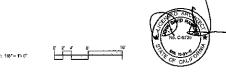UNIT 7

TYPE D1 F,F, = 200,50°

UNIT 6

TYPE 68 F.F. = 191.14

UNIT 5

TYPE C2 F.F. = 192.14"

UNIT 8

TYPE E

F.F. = 200.50'

GAPAGE

F.F. = 60.00'

UNIT 9

UNIT 10

UNIT 11
TYPE P
F.F.= 191,14"
LIVING

LEVEL 2 FLOOR PLANS

SCALE: 1/8"= 1'-0"

53 SF

UNIT 1

S=4.4X >

UNIT 3

UNIT 2 TYPE B F.F. = 204:64'


S= 4.47 >

UNIT 4

A2.3

1 A2.2

- 100 CUBIC FEET MIN STORAGE AREA @ 4" AFF WHERE INTRUDING IN
- 100 QUBIO FEET MIN STORAGE AREA @ 4" AFF WHERE INTRU
 PRIVATE EXTERIOR USABLE OPEN SPACE (BF AS NOTED)

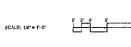





GOLDEN HILL

B STREET HOMES

		Tedaricidas « NANCARO UNCALERAS NIC Managoram AL Hara Hara con Ambo in Expansia Amband Reseason Tedaricia del Constala NA Costi del Manago Reseason Tedaricia del Constala NA Costi del Manago Reseason Tedaricia del Constala NA Costi del Manago
SSUE / REVISION DATES:		JOB NUMBER: 1308
OMPLETENESS CHECK	84-28-2015	
ITE DEVELOPMENT PERMIT SUBMITTAL 1	05-27-2015	LEVEL 2
ITE DEVELOPMENT PERMIT SUBMITTAL 2	08-05-2015	
ITE DEVELOPMENT PERMIT SUBMITTAL 3	11-04-2015	FLOOR PLANS
ITE DEVELOPMENT PERMIT SUBMITTAL 4	04-05-2016	
ITE DEVELOPMENT PERMIT SUBMITTAL 6	07-18-2018	
ITE DEVELOPMENT PERMIT SUBMITTAL B	06-30-2018	⊢ A1.2

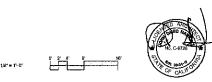



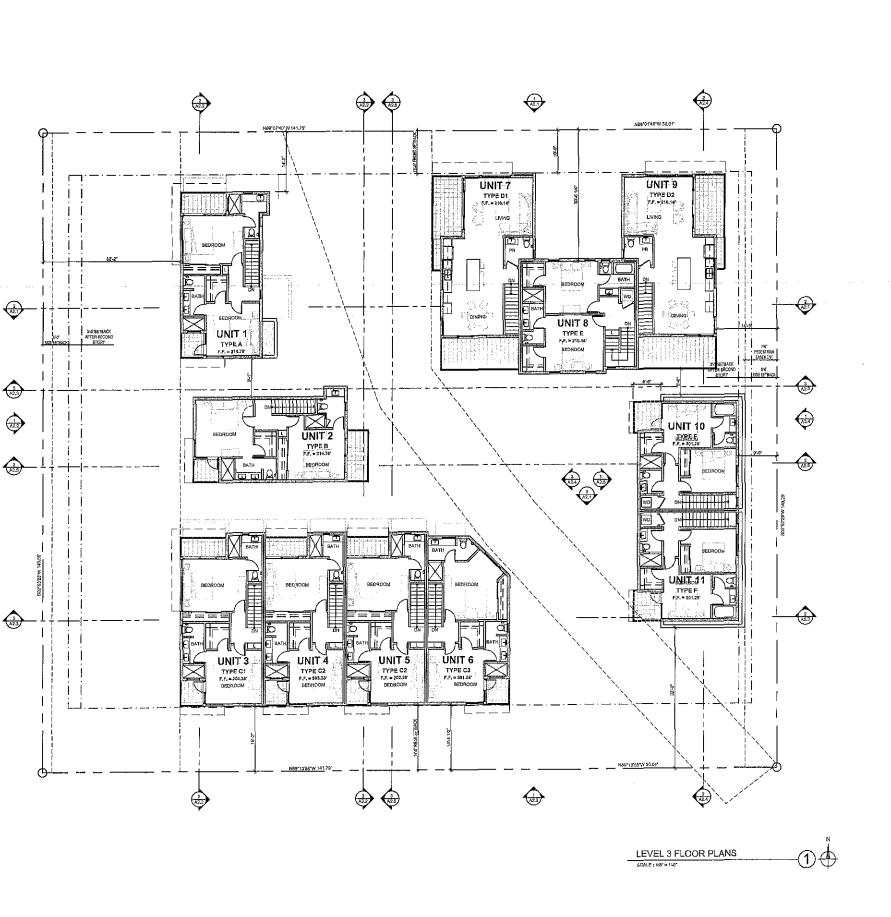



GOLDEN HILL

FLOOR & ROOF PLAN GENERAL NOTES

1. REFER TO CIVIL & LANDSCAPE PLANS FOR ADDITIONAL INFORMATION.
2. REFER TO SITE PLANS FOR ADDITIONAL INFORMATION REGARDING GRADING.

FLOOR & ROOF PLAN KEYNOTES

6 100 CUBIC FEET MIN STORAGE AREA @ 4' AFF WHERE INTRUDIN 7 PRIVATE EXTERIOR USABLE OPEN SPACE (SF AS NOTEO)

CLASS "A BUILT UP ROOF OR TPO ROOF
COURT OF PHOTOVOLTAIC PARKS DESIGNATED ROOF AND OVERFLOW DRAIN
COMPAND OVERFLOW DRAIN
E 24 SF MIN COVERED PORCHAREA

B STREET HOMES

Hewkins + Hawkins Architects, in 618.232,7730 fex 619.232,7730 www.Hz/Assardego.com 141 148h Straet

H2

San Ellogo, Callfornia 92101 PRIXINS - INVINIS PROITECTS, ISG SIR COVICE LAVORATION AND ATT AREIT

		TACHTER THESE A MICHTELS PLACE AND DOWN TASKET IN ACT TO EX SERVICIONETO CHIPPACO DE ORDER MAY PORT OR MANAGE WARTSOLVER WITHOUT PIET OT TANAMAN DE CENTRES WITHOUT PERIODES KLAMING CONSERVED. PAR HORNAND & HANNING MICHTELS PAR
ISSUE / REVISION DATES:		JOB NUMBER: 1308
COMPLETENESS CHECK	04-28-2016	
SITE DEVELOPMENT PERMIT SUBMITTAL 1	05-27-2015	LEVEL 3
SITE DEVELOPMENT PERMIT SUBMITTAL 2	08-05-2015	FLOOR PLANS
SITE DEVELOPMENT PERMIT SUBMITTAL 3	11-04-2015	FLOOR PLANS
SITE DEVELOPMENT PERMIT SUBMITTAL 4	04-06-2016	
SITE DEVELOPMENT PERMIT SUBMITTAL 6	07-18-2018	
SITE DEVELOPMENT PERMIT SUBMITTAL 8	U8-30-2018	1 A1.3
SITE DEVELOPMENT PERMIT SUBMITTAL 7	10-12-2016	
	SHEET 11 OF 17	SCALE: 1/8" = 1'-9"

1 1/222 (1)25

T,O,P, 226,

3 A2.3

1 A222

UNIT 1 TYPE A

UNIT 3 TYPE C1 FF = 214.67

(2) (2)

T,D,P, 216,42

UNIT 2

UNIT 4 TYPE C2 FF - 214-42

T.O.P. 215.42

N89*13'68"W 141.78'

UNIT 7

TYPE D1 . F.F. = 221.20

T.O.P. 218.42

UNIT 6... TYPE G3 F.F. = 211.42

(1) (A2.3)

T.O.P. 216.42

UNIT 5 Type C2

T.O.P. 214.42

(a) (a)

UNIT 9

TYPE D2

UNIT 10 1 TYPE F FF.=210.92

UNIT 11

ROOF PLANS SCALE : 1/8" = 1'-0"

T.O.R. 220,28

T.O.P. 214.42

тур[3]— TYP 2

3 A2.4 A2.5 A2.5

T.O.P. 222.28

UNIT 8 TYPE E FF = 220 281


ATTACHMENT 14

FLOOR & ROOF PLAN GENERAL NOTES

REFER TO CIVIL & LANDSCAPE PLANS FOR ADDITIONAL INFORMATION.
 REFER TO SITE PLAN FOR ADDITIONAL INFORMATION REGARDING GRADI

FLOOR & ROOF PLAN KEYNOTES

- CLASS "A" BUILT UP ROOF OR TPD ROOF
 ROOP TOP PROTOFOLITAD PARKES DESIGNED TO PROVIDE 60% OF PROJECTED ENERGY CONSUMPT FOR EACH UNIT.
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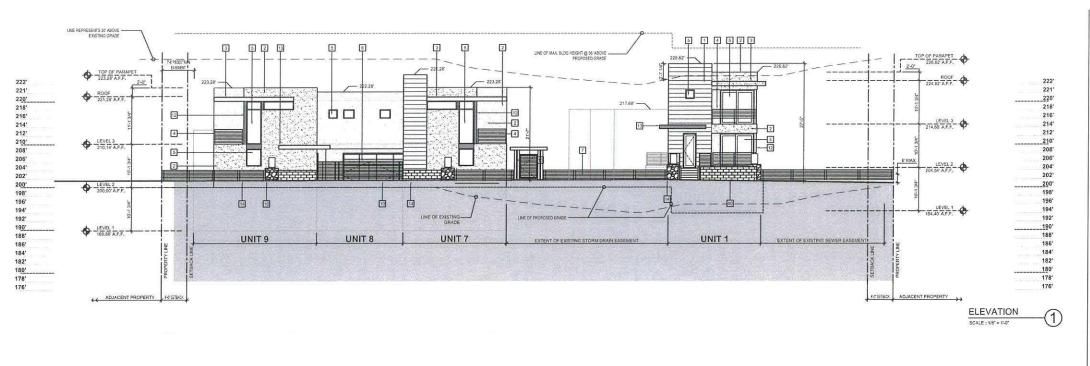
GOLDEN HILL **B STREET HOMES**

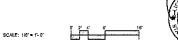
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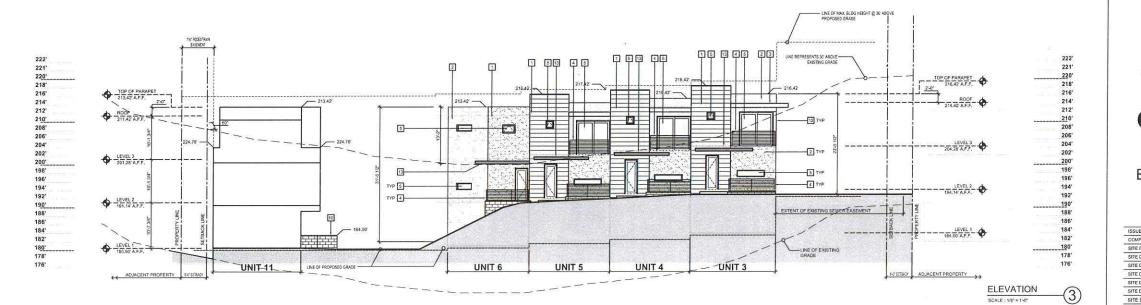
141 14th Street San Diego, California

	92101
	AND
	JOB NUMBER: 1906
3-2015	

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ISSUE / REVISION DATES;		JOB NUMBER: 1986
COMPLETENESS CHECK	04-28-2015	·
BITE DEVELOPMENT PERMIT SUBMITTAL 1	05-27-2016	
SITE DEVELOPMENT PERMIT SUBMITTAL 2	08-05-2016	ROOF PLANS
SITE DEVELOPMENT PERMIT SUBMITTAL 3	11-04-2015	
SITE DEVELOPMENT PERMIT SUBMITTAL 4	04-06-2016	
SITE DEVELOPMENT PERMIT GUBIAITTAL 5	07-18-201G	- 4 4
SITE DEVELOPMENT PERMIT SUBMITTAL 6	08-30-2018	A1.4
SITE DEVELOPMENT PERMIT SUBMITTAL 7	10-12-2018	, , , , ,
	SHEET 12 OF 17	SCALE: 1/8" # 1' • 0"





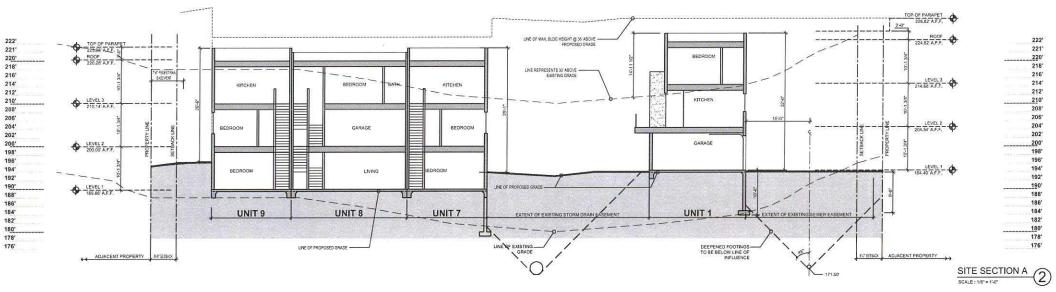

ELEVATION & SECTION GENERAL NOTES

REFER TO CIVIL & LANDSCAPE PLANS FOR ADDITIONAL INFORMATION.
 REFER TO SITE PLAN FOR ADDITIONAL INFORMATION REGARDING GRADING.
 REFER TO ROOF PLAN FOR ROOFTOP PHOTOVOLTAIC PANEL INFORMATION.

ELEVATION & SECTION KEYNOTES

1 METAL PANELS
2 "SAND" FINISH CEMENT PLASTER, COLOR TBD.

3 "SAND" FINISH CEMENT PLASTER CANOPY COLOR TBD. 4 GALVANIZED, PAINTED STEEL GUARDRAIL, COLOR TBD.

5 VINYL WINDOW / DOOR SYSTEM

6 GALVANIZED, PAINTED STEEL ENTRY GATE

7 GALVANIZED, PAINTED STEEL FENCE.

8 VINYL FRENCH ENTRY DOOR 9 KEYSTONE RETAINING WALL WITH ANTI-GRAFITTI COATING COLOR TED.

11 PAINTED GARAGE DOOR, COLOR TED 12 METAL PANEL, COLOR TBD.

13 GALVANIZED, PAINTED STEEL CANOPY, COLOR TED 3' TALL FREE STANDING WALL WI LAMP PER LANDSCAPE DRAW

15 WOOD ARBOR PER LANDSCAPE DRAWINGS

16 MODULAR GABION CHECK DAM CAPPED W/ DETACHABLE PEDESTRIAN BOARDWALK.

ELEVATION & SECTION KEYNOTES

KEYSTONE NULL WITH ANTI GRAFITTI
CONTING FER REVIOLE 9

GROUND FACE CMU, WITH ANTI GRAFITTI
CONTING FER REVIOLE 10

GRAVEL FORY STACKED STONE IN METAL
CACE.





GOLDEN HILL


B STREET HOMES


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H2

UE / REVISION DATES:		JOB NUMBER: 1306
APLETENESS CHECK	04-28-2015	
DEVELOPMENT PERMIT SUBMITTAL 1	05-27-2015	SITE SECTIONS &
DEVELOPMENT PERMIT SUBMITTAL 2	08-05-2015	
DEVELOPMENT PERMIT SUBMITTAL 3	11-04-2015	ELEVATIONS
DEVELOPMENT PERMIT SUBMITTAL 4	04-06-2016	1
DEVELOPMENT PERMIT SUBMITTAL 5	07-18-2016	
DEVELOPMENT PERMIT SUBMITTAL 6	08-30-2016	Δ21
DEVELOPMENT PERMIT SUBMITTAL 7	10-12-2016	/ 12-11
	SHEET 13 OF 17	SCALE: 1/8" = 1' - 0"





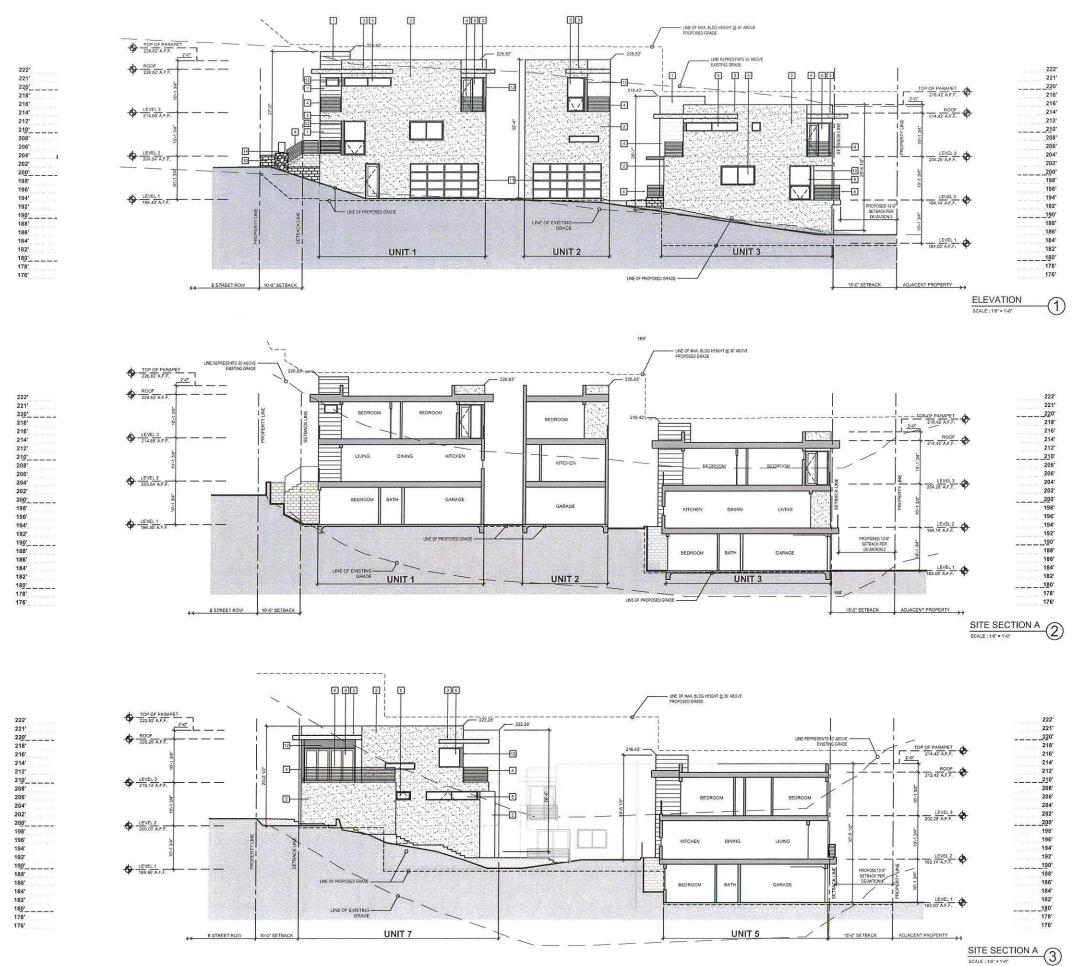

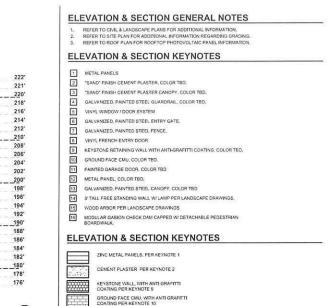GRAVEL / DRY STACKED STONE IN METAL CAGE.





GOLDEN HILL

B STREET HOMES

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H2


141 14th Street
San Diego, California
92101

JOB N		ISSUE / REVISION DATES:
	04-28-2015	COMPLETENESS CHECK
SI	05-27-2015	SITE DEVELOPMENT PERMIT SUBMITTAL 1
31	08-05-2015	SITE DEVELOPMENT PERMIT SUBMITTAL 2
- 1	11-04-2015	SITE DEVELOPMENT PERMIT SUBMITTAL 3
	04-06-2016	SITE DEVELOPMENT PERMIT SUBMITTAL 4
	07-18-2016	SITE DEVELOPMENT PERMIT SUBMITTAL 5
	08-30-2016	SITE DEVELOPMENT PERMIT SUBMITTAL 6
	10.12.2016	CITE DEVELOPMENT DEBNIT CURNITTAL 7

ITE SECTIONS & ELEVATIONS

08-30-2016 10-12-2016 SHEET 14 OF 17 SCALE: 1/8" = 1'-0"



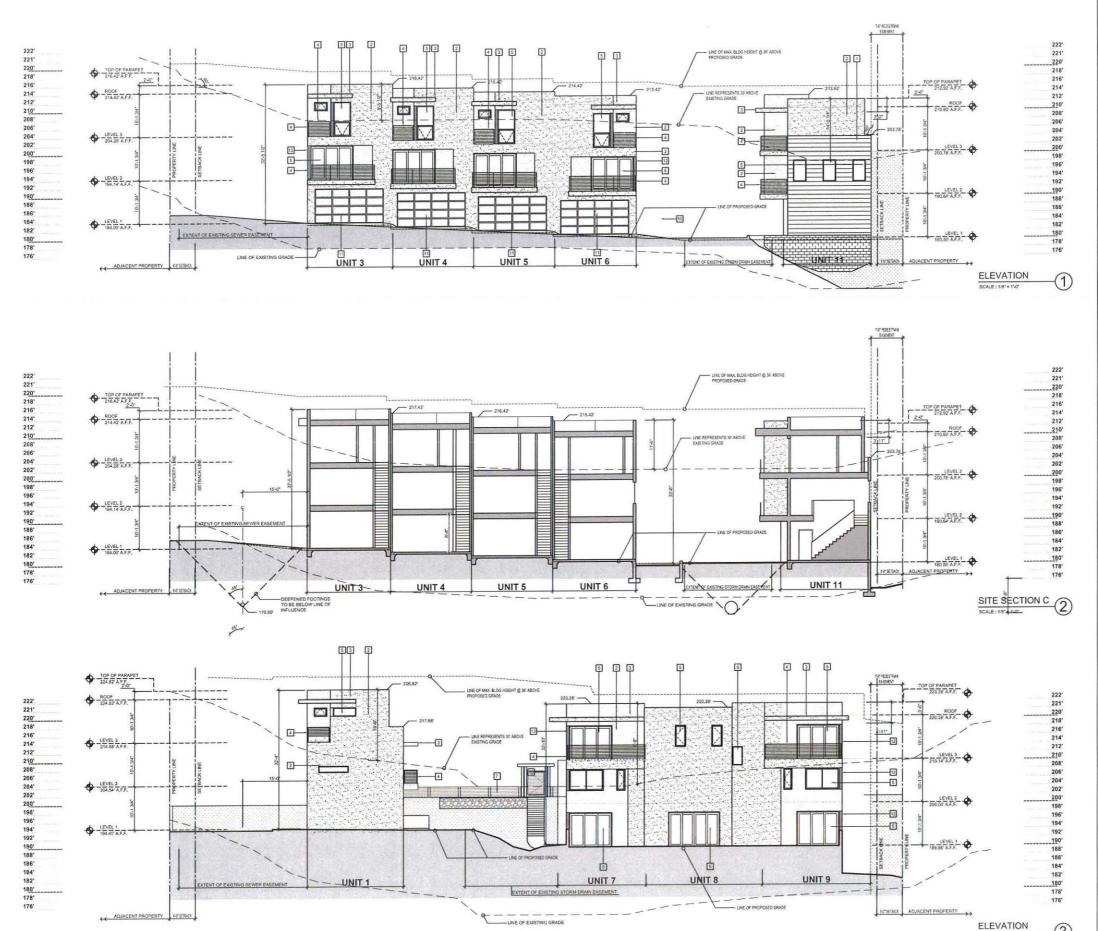

ELEVATION & SECTION GENERAL NOTES REFER TO CIVIL & LANDSCAPE PLANS FOR ADDITIONAL INFORMATION. REFER TO SITE PLAN FOR ADDITIONAL INFORMATION REGARDING GRADING. REFER TO ROOF PLAN FOR ROOFTOP PHOTOVOLTAIC PANEL INFORMATION. **ELEVATION & SECTION KEYNOTES** "SAND" FINISH CEMENT PLASTER, COLOR TBD. "SAND" FINISH CEMENT PLASTER CANOPY, COLOR TBD. VINYL WINDOW / DOOR SYSTEM GALVANIZED PAINTED STEEL ENTRY GATE. GALVANIZED, PAINTED STEEL FENCE. KEYSTONE RETAINING WALL WITH ANTI-GRAFITTI COATING, COLOR TBD. GROUND FACE CMU, COLOR TED. PAINTED GARAGE DOOR, COLOR TED METAL PANEL, COLOR TBO. GALVANIZED, PAINTED STEEL CANDPY, COLOR TBD 14 3' TALL FREE STANDING WALL W/ LAMP PER LANDSCAPE DR WOOD ARBOR PER LANDSCAPE DRAWINGS MODULAR GABION CHECK DAM CAPPED W/ DETACHABLE PEDESTRIAN **ELEVATION & SECTION KEYNOTES** ZINC METAL PANELS, PER KEYNOTE 1 CEMENT PLASTER PER KEYNOTE 2

GROUND FACE CMU, WITH ANTI GRAFITTI COATING PER KEYNOTE 10

GRAVEL / DRY STACKED STONE IN METAL CAGE.



GOLDEN

B STREET HOMES

COMPLETENESS CHECK SITE DEVELOPMENT PERMIT SUBMITTAL

SITE DEVELOPMENT PERMIT SUBMITTAL 3
SITE DEVELOPMENT PERMIT SUBMITTAL 4

SITE DEVELOPMENT PERMIT SUBMITTAL !


SITE DEVELOPMENT PERMIT SUBMITTAL

619.232.7700 fax 619.232.7700 www.H2Asandlego.com

141 14th Street San Diego, California 92101

RESERVES THESE COMMENTS RESERVES COMMENTS RESERVES COMMENTS RESERVES COMMENTS RESERVES COMMENTS RESERVES RESERV	AN CONTROL FINE CONCENTRATED FOR THE MET TO CONCENTRATE AND FORMOR MET MET TO CONCENTRATE AND FORMOR MET MET TO CONCENTRATE OF EARLIEST MET TO MEMORIA APPORTECTS INC.
JOB NUMBER:	1306
	ECTIONS &

A2.3

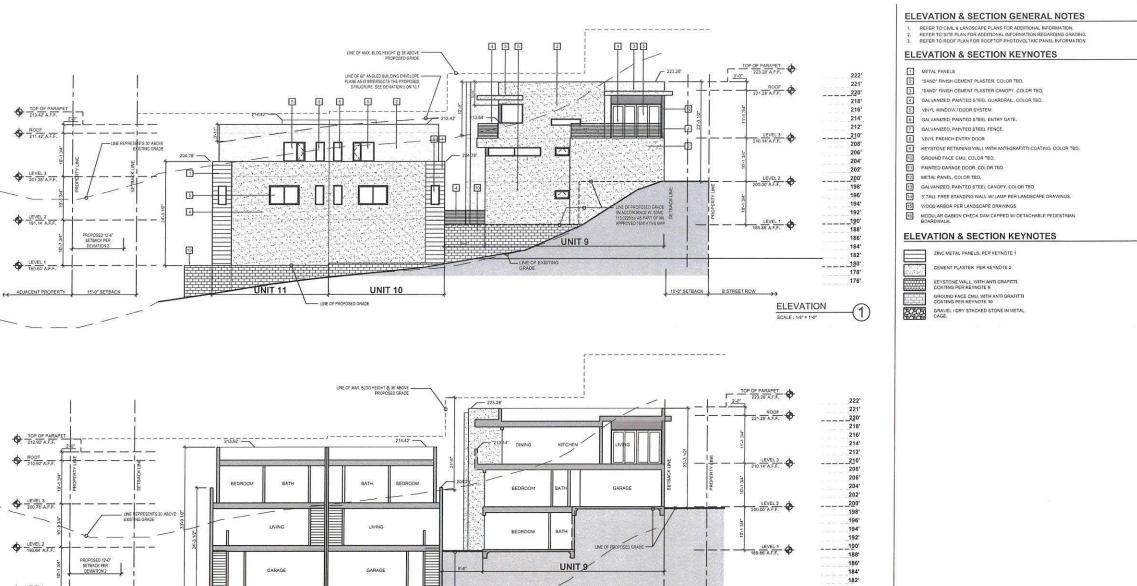

4 3 5

UNIT 1

UNIT 10

453 1513

UNIT 2

222' 221'

220' 218' 216' 214'

210'____

200' 198' 196' 194'

18<u>0'</u> 178'

222' 221' 220' 218' 216' 214' 212'

210' 208' 206'

200' 198' 196' 194' 192'

220' 218' 216' 214'

212'
210'
208'
206'
204'
202'
200'
196'

190' 188' 186' 184' 182' 180' 178'

190' 188' 186' 184' 182' 180' 178'

180.50 A.F.F.

ADJACENT PROPERTY

TOP OF PARAPET

ROOF 212.42 A.F.F.

1 LEVEL 3 202,28' A.F.F.

192,14 A.F.F.

LEVEL 1 182,00 A.F.F.

ADJACENT PROPERTY

UNIT 5

TALE: 1/6" = 1'-0"

GOLDEN HILL

180' 178' 176'

222'
221'
220'
218'
216'
214'
212'

210' 208' 206' 204' 202'

186' 184' 182' __180' 178'

SITE SECTION D

10'-0" SETBACK

5 1 13

B STREET ROW

TOP OF PARAPET 226.82 A.F.F.

ROOF 224.82 A.F.F.

214.68' A.F.F.

LEVEL 2 204.54' A.F.F.


194.40' A.F.F.


ELEVATION

B STREET HOMES

	232,7700 9.232,7770
www.H2A	sandlego.com
San Die	4th Street go, California 32101
HAWKING + HAW	KINS ARCHITECTS, INC.
THER COMMON LA	A COMMISSION INCOMES INCOMESTO
"HESEPLANS THE!	OF THE SHADONAM SHAPE NOT TO
coucie p-avoito	PROUPED BY MAY FORM OF MANAGE
EVER WITHOUT FIRS	COLUMN SE CAPOLIS MATTER

		92101	
		MISONS THANKS ARCHITECTS INC. MISONS THE COMMUNICATION OF THE PROPERTY OF THE	
ISSUE / REVISION DATES:		JOB NUMBER: 1306	
COMPLETENESS CHECK	04-28-2015		
SITE DEVELOPMENT PERMIT SUBMITTAL 1	05-27-2015	SITE SECTIONS &	
SITE DEVELOPMENT PERMIT SUBMITTAL 2	08-05-2015		
SITE DEVELOPMENT PERMIT SUBMITTAL 3	11-04-2015	ELEVATIONS	
SITE DEVELOPMENT PERMIT SUBMITTAL 4	04-06-2016		
SITE DEVELOPMENT PERMIT SUBMITTAL 5	07-18-2016		
SITE DEVELOPMENT PERMIT SUBMITTAL 6	08-30-2016	Δ2.4	
SITE DEVELOPMENT PERMIT SUBMITTAL 7	10-12-2016	/	
	SHEET 16 OF 17	SCALE: 1/8" = 1'-0"	

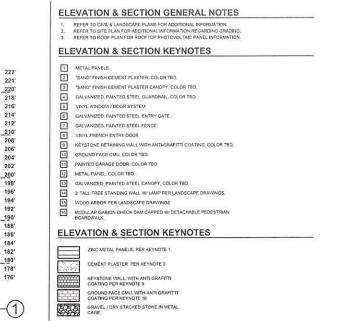

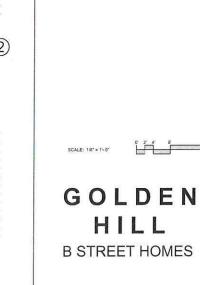


ISSUE / REVISION DATES:

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		JOB NUMBER: 1306
	04-28-2015	
1	05-27-2015	SITE SECTIONS &
2	08-05-2015	
3	11-04-2015	ELEVATIONS
4	04-06-2016	
5	07-18-2016	
5	08-30-2016	A2.5
1.7	10-12-2016	, , , , , ,



SITE DEVELOPMENT

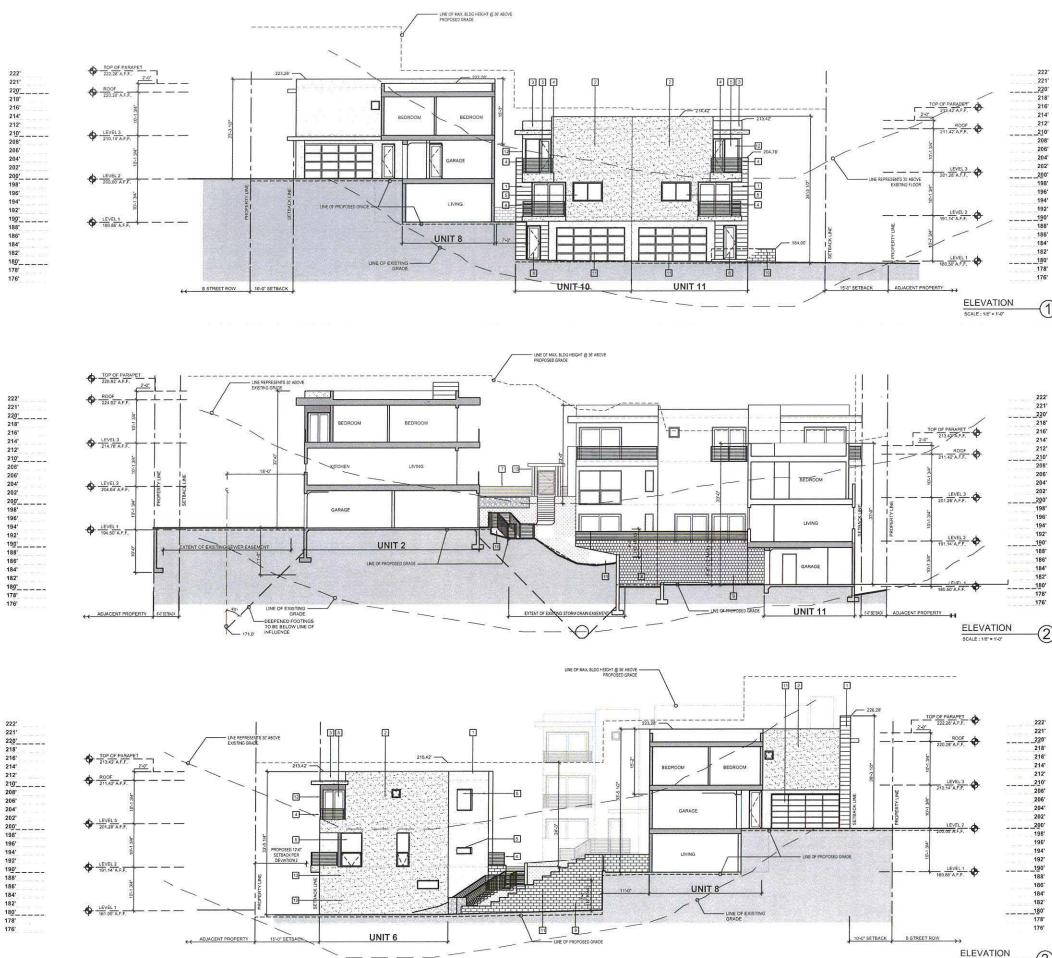PRELIMINARY GRADING PLAN

BASIS OF BEARINGS
THE WESTERLY LINE OF BLOCK SR, MAP NO, 647 AS SHOWN ON RECORD OF SURVEY NO. 16501. LE, NO.079229' E.

1. THE SOURCE OF THE TOPOGRAPHIC INFORMATION SHOWN HEREON IS PHOTGRAMMETRIC SURVEY BY CHRISTENSEN ENGINEERING & SURVEYING IN JULY 15, 2004.

3. THE SUBJECT PROPERTY IS SERVED BY CITY OF SAN DIEGO SANITARY SEWER AND WATER

8. DEVELOPER SHALL PROVIDE BUILDING ADDRESS NUMBERS, VISIBLE AND LEGIBLE FROM THE STREET FRONTING THE PROPERTY PER FHPS POLICY P-05-5 (UFC 8014.4)

8. PRIOR TO ISSUANCE OF ANY CONSTRUCTION PERMIT, THE SUBDIVIDER SHALL ENTER INTO A MAINTENANCE AGREEMENT FOR THE OXIGOING PERMANIENT BMP MAINTENANCE,

R. PRIOR TO THE ISSUANCE OF ANY CONSTRUCTION PERMIT, THE SUBDIVIDER SHALL INCORPORATE ANY CONSTRUCTION BEST MANAGEMENT PRACTICES NECESSARY TO COMPLY WITH CHAPTER 14, AFFICILE 2, DIMISION 1 (GRADONG REGULATIONS) OF THE SAN DIEDO MUNICIPAL CODE, INTO THE CONSTRUCTION PLOR SPECIFICATIONS.

10. AN ENCROACHMENT MANTENANCE AND REMOVAL AGREEMENT WILL BE REQUIRED FOR PRIVATE IMPROVING AND PROPOSED EASEMENTS, INCLUDING PRIVATE STORM DRAIN AND SEWER LATERAL CONNECTION.

13, THE DEVELOPER OF THIS SITE IS ALSO IS THE DEVELOPER OF THE PROJECT LOCATED SOUTHERLY OF THIS PROJECT,

14. THE DESIGN OF SIDEWALKS SHALL MATCH THE HISTORIC SIDEWALK PATTERN ON THE ADJACENT PROPERTIES, INCLUDING LOCATION, WIDTH, ELEVATION, SCORING PATTERN, COLOR AND MATERIAL

6. THE DEVELOPMENT PROPOSES TO PROVIDE 22 ENGLOSED PARKING SPACES.

7. NAD27 COORDINATES = 230-1695, NAD83 COORDINATES = 1870-8266.

11. SEE ARCHITECTURAL PLAN FOR VARIANCE AND DEVIATION REQUESTS.

15. EXISTING WATER SERVICES NOT BE RETAINED WILL BE KILLED AT MAIN.

12, THE ASSESOR PARCEL NUMBERS ARE: 539-521-01-00 & 639-521-02-00.

CITY OF SAN DIEGO BRASS PLUG IN TOP OF CURB AT THE NORTHWEST OWNER OF 26TH STREET AND B STREET, ELEVATION 203,075 MEAN SEA LEVEL N.G.Y.D. 1929.

2. THE USE OF PROPOSED PROJECT IS FOR 11 APARTMENTS.

BENCHMARK

ATTACHME Z

SITE DEVELOPMENT

LEGAL DESCRIPTION:

COTS 1 THROUGH & INCLUSIVE AND THE EAST 16 28 FEET OF LOT SIN BLOCK 69 OF E.W. MORSES SUBDIVISION OF FUER ID. COT 1109, IN THE CITY OF SAN DISCO, STATE OF COLLYYOF AS DISCO, STATE OF CALLEDRING, ACCORDING TO AN THE RECO. PLACE AND ASSESSED AS THE OFFICE OF THE COLUMY RECORDING FOR AN DECOLOUNTY. ASSOCIATED AS THE THROUGH AS DISCOURT AS DISCOURT OF SAND LOTS 1 THROUGH AS DAD PORTION OF LOT 8 AND THE WEST SOLD AS OF CONTROL OF SAND LOTS 1 THROUGH AS DAD PORTION OF LOT 8 AND THE WEST CONTROL OF SAND LOTS 1 THROUGH AS DAD PORTION OF LOT 8 AND THE WEST CONTROL OF SAND LOTS 1 THROUGH AS DAD PORTION OF LOT 8 AND THE WEST CONTROL OF SAND LOTS 1 THROUGH AS DAD PORTION OF LOT 8 AND THE WEST CONTROL OF SAND LOTS 1 THROUGH AS DAD PORTION OF LOT 8 AND THE WEST CONTROL OF SAND LOTS 1 THROUGH AS DAD PORTION OF LOT 8 AND THE WEST CONTROL OF SAND LOTS 1 THROUGH AS DAD PORTION OF LOTS 8 AND THE WEST CONTROL OF SAND LOTS 1 THROUGH AS DAD PORTION OF LOTS 1 AND THE WEST CONTROL OF SAND LOTS 1 AND THE WEST CONTROL OF SAND LOTS 1 THROUGH AS DAD PORTION OF LOTS 1 AND THE WEST CONTROL OF SAND LOTS 1 THROUGH AS DAD PORTION OF LOTS 1 AND THE WEST CONTROL OF SAND LOTS 1 AND THROUGH SAND LOTS 1 AND THE WEST CONTROL OF SAND LOTS 1 AND THROUGH SAND LOTS

ASSESSOR'S PARCEL NUMBERS; 599-521-01,02,

OWNER: JANCO, LLC P.O. BOX 291446 ENCINITAS, CA 82028

AREA: SITE AREA: 0,589 ACRES (25,684 SOUARE FEET)

TITLE NOTES:

PRELIMINARY TITLE REPORT PROVIDED BY STEWART TITLE COMPANY, ORDER NO. 01160-164050 DATED MARCH 19, 2016.

ITEMS EXIST IN SCHEDULE B OF THE PRELIMINARY TITLE REPORT THAT CAN NOT BE PLOTTED SEE TITLE REPORT.

UTILITY TABLE

TELE (AT&T): UNDERGROUND DATY (COX): UNDERGROUND ELEC (SDG&E); UNDERGROUND

MAP NO. 547 MAP NO. 547 BLOCK 82 BLOCK 89 EXISTING ELECTRICAL LINE EXISTING GAS LINE EXISTING SEWER LINE EXISTING TELEPHONE LINE "B" STREET EXISTING WATER LINE EXISTING CATY LINE FIRE HYDRANT MANHOLE PROPOSED PVT 4" PVC SEWER LATERAL PROPOSED WATER SERVICE PROPOSED CATCH BASIN FOR ROOF DRAINAGE (SOLID COVER) PROPOSED CATCH BASIN PROPOSED AREA DRAIN (PERVIOUS SURFACES) PVC DRAIN FOR IMPERVIOUS BURFACES PROPOSED SO SEWER PVC DRAIN FOR PERVIOUS BURFACES CONCRETE SUBFACE LANDSCAPE SURFACE CONCRETE DITCH MAP NO. 547 PROPOSED DRAINAGE EASEMENT TO BE DEDICATED MAP NO. 647 Brack 63 BLOCK 88 8 7 **4**į, 24 23 EASEMENT FOR DRAINAGE I FAVOR OF THE CITY OF SAN PORTION OF EXISTING PORTION OF PROPOSED DRAINAGE EASEMENT TO BE DEDICATED SCALE: 1" = 20" ALLEY P ALLEY (VACATED) N89°13'88'W 30,01'---LOT 1 MAP NO. 16049 PROPOSED EASEMENT OVER SOUTHERLY 10 PORTION OF EXISTING GENERAL UTILITY EASEMENT FRONTING SITE FROM OWNER OF LOT 1 CONTIGUOUS OWNERSHIP INCLUDES LOT 1 OF MAP NO. 16049 EASEMENT FOR DRAIMAGE IN FAVOR OF THE CITY OF SAN DIEGO RECORDED DECEMBER 18, 1989 AS FILE NO. 89-663490, O.R. 25 26

"C" STREET

BALSOA PARK 267H ST

VICINITY MAP

CHRISTENSEN ENGINEERING & SURVEYING CIVIL ENGINEERIS 7986 SILVENTON AVENUE, 7986 SILVENTON AVENUE, 1868) 271-6901 EACH OF THE REPHONE: (688) 271-6901

CHRISTENSEN ENGINEERING & SURVEYING 7888 SILVERTON AVENUE, SUITE "J" SAN DIEGO, CA 92120 PHONE (858) 271-8901 FAX (858) 271-8912

Project Address:

"B" STREET AT 20TH STREET SAN DIEGO, CA 92101

'E" STREET ROW HOMES

Original Date: APRIL 08, 2015

Revision 4: 07-18-18 REVISE DESIGN Revision 3; 04-02-18 REVISE DESIGN Revision 2: 10-15-15 ADDRESS CITY COM

Sheet 1 of 3 Sheets


Revision 5:


PRELIMINAY GRADING PLAN

16, EXISTING LINUSED SEWER LATERALS WILL BE REQUIRED TO BE ABANDONED AT P/L. 17, BUILDING FOOTINGS SHALL BE DEEPENED, AS REQUIRED, SO NOT TO EXERT ANY INFLUENCE ON EXISTING SEWER IMPROVEMENTS.

LEGEND PROPERTY LINE ____т___т___т___



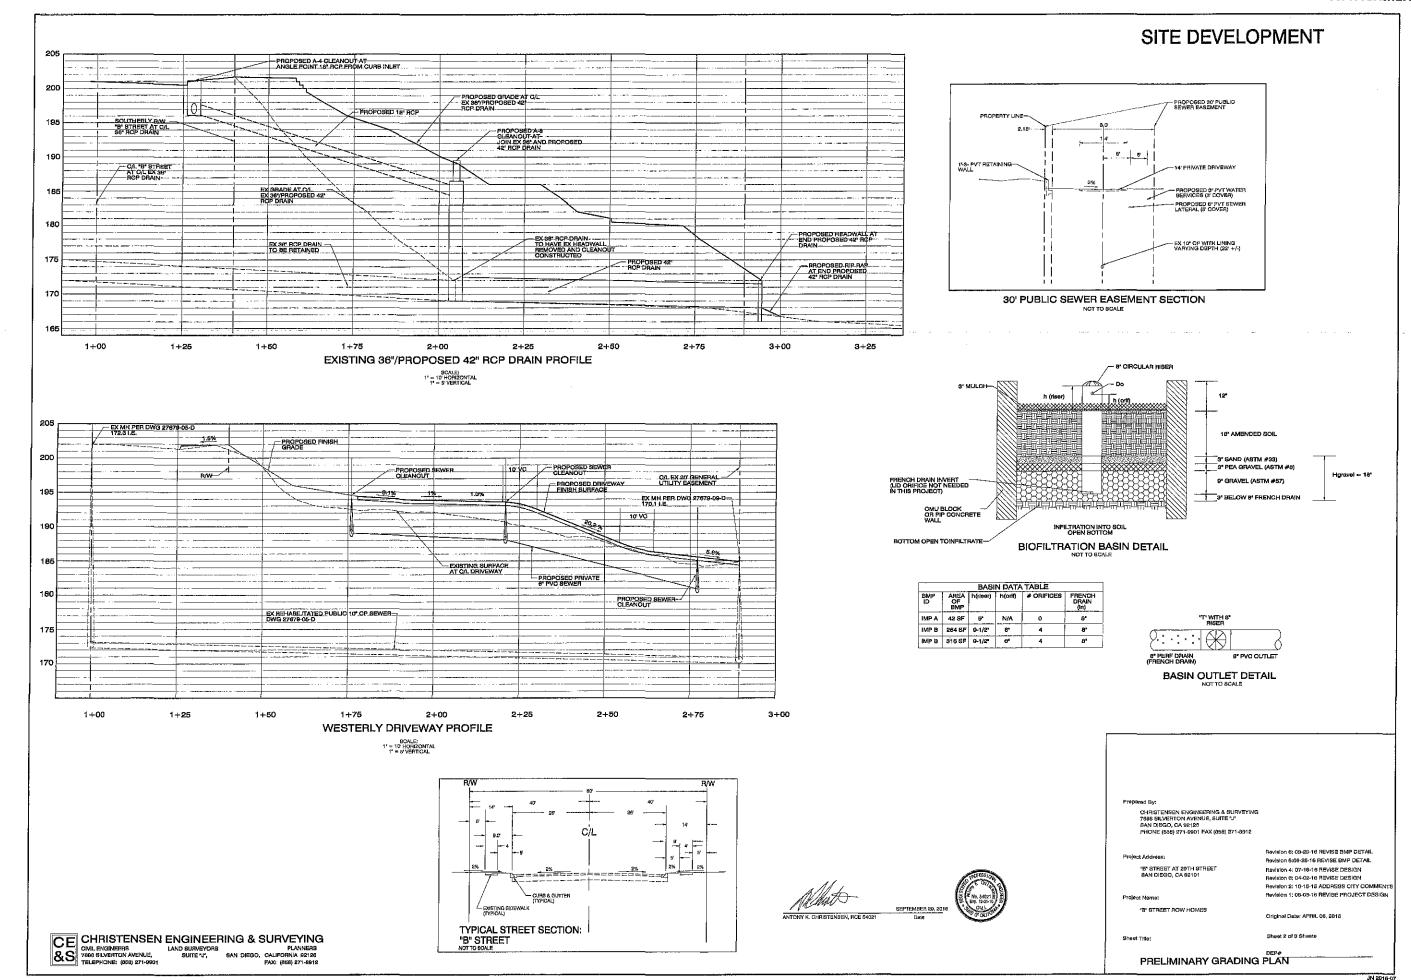

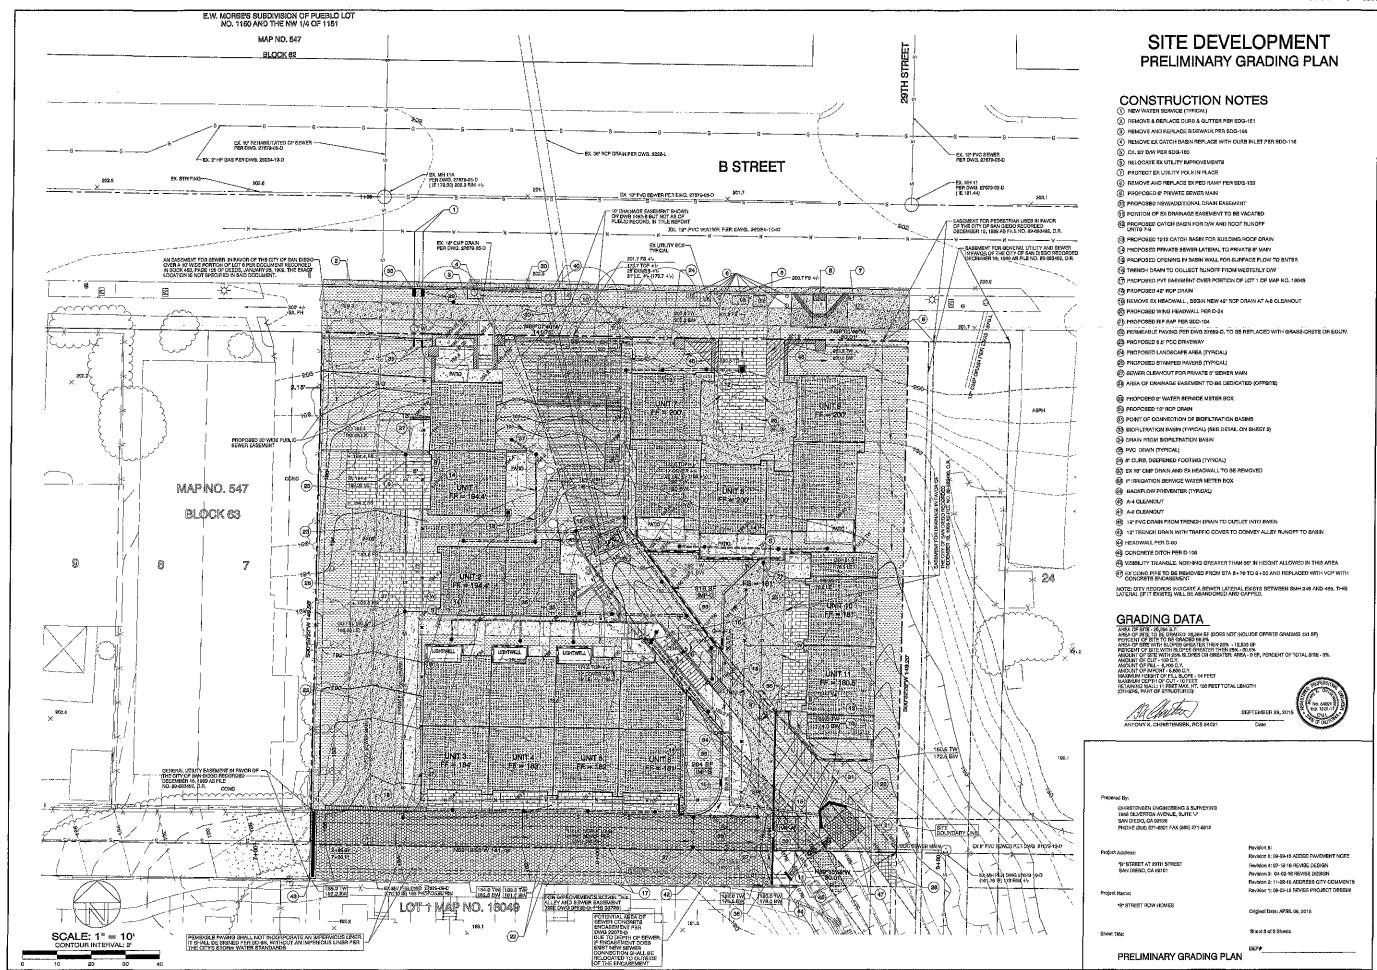

1. THIS PLAN IS FOR GENERAL SITE REFERENCE ONLY. REFER TO OTHER DOCUMENTS FOR COMPLETE SCOPE OF

2. BEFORE COMMENCING ANY SITE EXCAVATION, VERFLY LOCATIONS OF ALL EXISTING SITE UTILITIES, INCLUDING WATER SEWER, GAS AND ELECTRICAL LINES. FLAG OR OTHERWISE MARK ALL LOCATIONS AND INDICATE UTILITY

TYPE.

3. GRADE SITE TO DIRECT GROUND WATER AWAY FROM BUILDING AND NEW ADDITIONS AND LANDSCAPE DRAINS SHALL BE INSTALLED AT LOW POINTS TO REDUCE RUNOFF CROSSING PATHS AND PAVING.

4. LOCATE REFUSE BUT AN AT APPROVED ON-SHITE LOCATION. CONTRACTOR SHALL DISPOSE OF ALL SITE REFUSE AT CITY-APPROVED LOCATIONS.

5. ALL REQUIRED PLANTING AREAS SHALL BE COVERED WITH MULCH TO A MINIMUM DEPTH OF 2 INCHES, EXCLUDING SLOPES REQUIRING REVEGETATION AND AREAS TO BE PLANTED WITH GROUND COVER. ALL EXPOSED SOIL AREAS WITHOUT VEGETATION SHALL ALSO BE MILLOHED TO THIS MINIMUM DEPTH.

5. ALL REQUIRED TREES SHALL HAVE AT LEAST FOR WELL DEFINED TRUNK AND SHALL NORMALLY ATTAIN A MATURE HEIGHT AND SPREAD OF AT LEAST 16 FEET.

MATURE HEIGHT AND SPREAD OF AT LEAST 15 FEET.

7. PROPOSED LANGSCAPING SHALL NOT CONFLICT WITH EXISTING UTILITIES.

8. PROPOSED LANGSCAPING SHALL NOT CONFLICT WITH PROPOSED LANGSCAPING.

9. TREE ROOT BARRIERS SHALL BE INSTALLED WHERE TREES ARE PLACED WITHIN 5 FEET OF PUBLIC IMPROVEMENTS ARE PLACED STREET PAVEMENTS OR WHERE NEW PUBLIC IMPROVEMENTS ARE PLACED ADJACENT TO EXISTING TREES, THE ROOT BARRIER WILL NOT WIKAP AROUND THE ROOT BALL IN 10. MANTENANCE: ALL REQUIRED LANGSCAPE AREAS SHALL BE MAINTAINED FREE OF DEBRIS AND LITTER AND ALL PLANT MATERIAL SHALL BE MAINTAINED SHALE OF DEBRIS AND LITTER AND ALL PLANT MATERIAL SHALL BE MAINTAINED FREE OF DEBRIS AND LITTER AND ALL PLANT MATERIAL SHALL BE MAINTAINED FREE OF DEBRIS AND LITTER AND ALL PLANT MATERIAL SHALL BE MAINTAINED FREE OF DEBRIS AND LITTER AND ALL PLANT MATERIAL SHALL BE MAINTAINED FREE OF DEBRIS AND LITTER AND ALL PLANT MATERIAL SHALL BE SAFETED OR SPETA ACTOR PER THE CONDITIONS OF THE DEBRIST OF THE PROPERTY OF T

11. THE PERMITTEE OR SUBSEQUENT OWNER SHALL BE RESPONSIBLE FOR THE LONG-TERM MAINTENANCE OF ALL

11. The PERMITTEE OR SUBSEQUENT OWNER BHALL BE RESPONSIBLE FOR THE LONG-TERM MARKTENANCE OF ALL REQUIRED LANGSAGE IMPROVEMENTS, INCLUDING IN THE RIGHT OF WAY.
12. ALL LANDSCAPE AND IRRIGATION SHALL CONFORM TO THE CITY OF SAM DIEGO'S LAND DEVELOPMENT MANUAL, LANDSCAPE STANDARDS, AND ALL OTHER CITY AND REGIONAL STANDARDS.
13. ALL REQUIRED LANDSCAPE BHALL BE MAINTAINED IN A DISEASE, WEED AND LITTER FREE CONDITION AT ALL TIMES, SEVERE PRUNING OR "TOPPING" OF TREES IS NOT PERMITTED UNLESS SPECIFICALLY NOTED IN THIS DEBUT

PERMIT.

1. IF ANY RECURRED LANDSCAPE (INCLUDING EXISTING OR NEW PLANTINGS, HARDSCAPE, LANDSCAPE
FEATURES, ETC.) INDICATED ON THE APPROVED CONSTRUCTION DOCUMENT PLANS IS DAMAGED OR REMOVED
DURING DEMOLITION OR DONSTRUCTION, IT SHALL BE REPARED ANDIOR REPLACED IN KIND AND EQUIVALENT SIZE
FER THE APPROVED DOCUMENTS TO THE SATISFACTION OF THE DEVELOPMENT SERVICES DEPARTMENT WITHIN 30
DAYS OF DAMAGE OR FINAL INSPECTION.

1. ALL GRADED, DISTURED DO REPORTED AREAS THAT WILL NOT BE PERMANENTLY PAVED OR COVERED BY
STRUCTURES SHALL BE PERMANENTLY REVEGETATED AND DRIGHTED AS SHOWN IN TABLE 142-OFF AND IN
ACCORDANCE WITH THE STANDARDS IN THE LAND DEVELOPMENT MANIAL.

16. A MEMBURIA FOOT ZOILE OF 405F IN AREA SHALL BE PROVIDED FOR ALL TREES. THE MINIMUM DIMENSION
FOR THIS AREA SHALL BE SEPTED FOR SIZE AND GRINGING.

16. A MINIMUM ROUT ZUNE OF 403P IN AREA SPINEL DE TROVIDES FOR THIS AREA SHALL BE 6 FEET, PER SDMC 142.0403(0)(6)

1. ALL PLANTING AREAS SHALL BE IRRIGATED BY A DEDICATED, BACKFLOW-PREVENTED IRRIGATION SYSTEM ACCORDING TO PLANT TYPE AND ENVIRONMENTAL EXPOSURE AND SHALL RECEIVE 1. ALT PLANTING AREAS SHALL BE IRRIGATED BY A DEDICATED, BACKPLOW-PREVENTED REIGATION SYSTEM ACCORDING TO PLANT TYPE AND EXPRONMENTAL EXPOSURE AND SHALL RECEIVE INFORM WARTER COXPERAGE BY MEANS OF A WHATEN CONTROLLED, ELECTRICALLY ACTION, UNDERGROUND PPED SPRINKINGER SYSTEM. FOR WATER CONSERVATION AND TO MINIMIZE EROSION, STATE OF THE ART LOW PRECIPITATION RATE SPRINKILER EQUIPMENT SHALL BE USED. IRRIGATION MAINLINE FIRING SHALL BE EVEN PLANT OF THE ART LOW PRECIPITATION AND TO MINIMIZE EROSION, STATE OF THE ART LOW PRECIPITATION RATE SPRINKILER PIEVE, PRESSURE INES SHALL BE INSTALLED 10 MINIMIZE AND EACH HOSE BIS MAINLED TO MINIMIZE ORANGE IN THE CASE OF A VALVE FAILURE OF MAINLINE SHALL BE INSTALLED TO MINIMIZE ORANGE IN THE CASE OF A VALVE FAILURE OF MAINLINE SHALL BE INSTALLED TO MINIMIZE ORANGE IN THE CASE OF A VALVE FAILURE OF MAINLINE SHALL BE INSTALLED TO MINIMIZE ORANGE IN THE CASE OF A VALVE FAILURE OF MAINLINE SHALL BE INSTALLED TO MINIMIZE ORANGE IN THE MASTER VALVE AND FACH HOSE BIS MAINLINE SHALL BE INSTALLED UPSTREAM OF THE MASTER VALVE AND FACH HOSE BIS MAINLE SHALL BE INSTALLED LOW THAN AN ATMOSPHERIC VACUUM BREAKER.

2. ALL PROPOSED IRRIGATION SYSTEMS WILL USE AN APPROVED FAIN SENSOR SHUTOFF DEVOCE.

3. EXISTING STREET TREES LOCATED IN THE PUBLIC RIGHTOF-MAY SHALL BE RRIGATED BY A HOMEOWNER-FUNDED AND MAINTAINED, DEEP-MATERING, LOW-VOLUME BUBBLER.

4. ALL PROPOSED IRRIGATION SYSTEMS WILL USE AN APPROVED FLOW SENSOR DEVICE.


THE DRAINAGE SYSTEM FOR THIS PROJECT SHALL BE PRIVATE AND WALL BE SUBJECT TO APPROVAL BY THE CITY ENGINEER.

2. ALL DEVELOPMENT SHALL BE CONDUCTED TO PREVENT EROSION AND STOP SEDIMENT AND POLLUTANTS FROM LEAVING THE PROPERTY TO MAXIMUM EXTENT PRACTICABLE.

3. ALL ROOF DRAIN BAD PLATFORM SHALL DRAIN POSTITIEN INTO STORM DRAINAGE SYSTEM. SURFACE RUNOFF SHALL NOT DRAIN DIRECTLY INTO THE ADJOINING PROPERTY, AND CONSTRUCTION RUNOFF MAY NOT DRAIN NOT OTHER STORMWATER CONVEYANCE SYSTEM.

LANDSCAPE CONCEPT STATEMENT

LANDOSCAPE CONCEPT FOR THE APARTMENT OF SUMMITY RESPECTS THE EXISTING SLOPING TERPAIN, PROTECTING IT FROM EROSION WITH WATER-CONSERVING, LOW-MAINTENANCE NATIVE AND ROMBINASHE PLANTS THAT SLOW, SPREAD AND RILTER STORMMATER RUNOFF FROM PREVIOUS AND IMPERVIOUS SURFACES. VERTICAL PLANTINGS ARE STRATEGICALLY PLACED TO PROVIDE PRIVACY FOR EACH RESIDENT WHILE LARGE-SCALE CANOPY TREES SHADE THE SHAPED COMMUNITY SPACES. NEW STREET THESE DIVE SHADE TO PEDESTRIANS, AVOID CONFLICTS WITH UTILITIES, AND PRESERVE VEHICULAR ISIAT LINES IN CONFORMANCE WITH THE LAND CEVELOPMENT CODE. ALL LANDSCAPE WILL BE MAINTAINED BY THE OWNER.

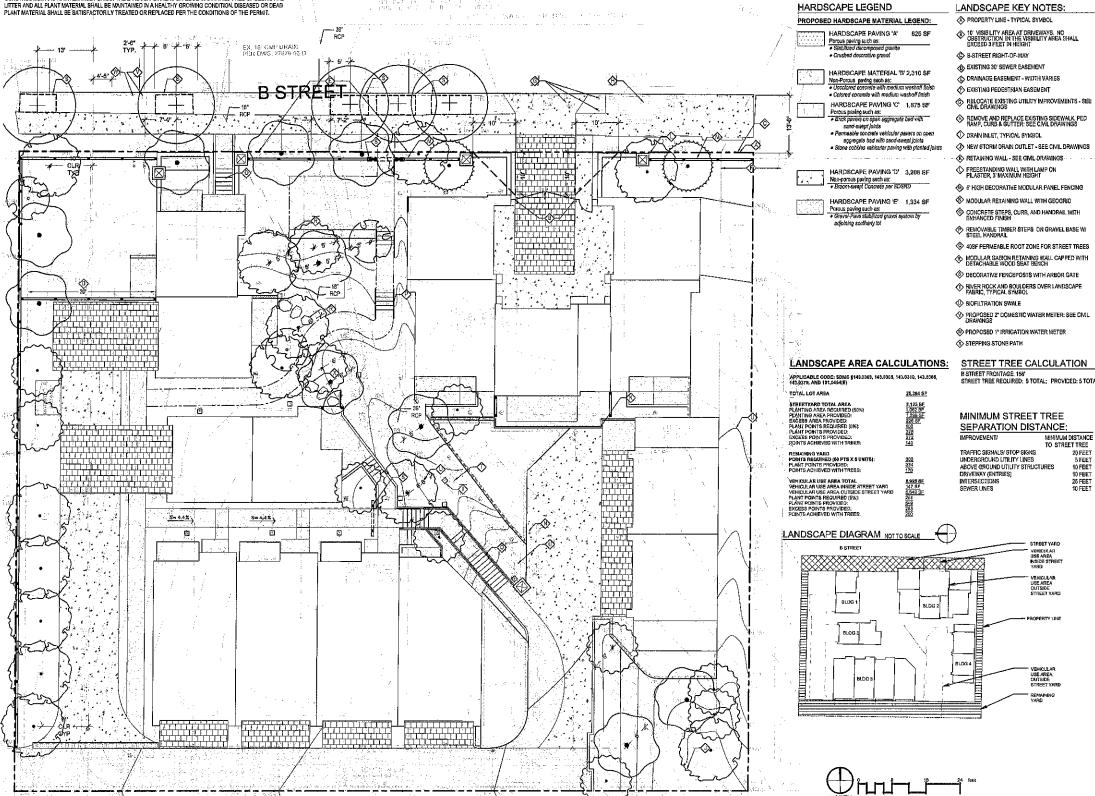



LANDSCAPE
ARCHITECTURE
928 HORNMAND STREET, SUITE #S
5AN DIEGO, CA 92 109



GOLDEN HILL

B STREET HOMES

SUE / REVISION DATES:		JOB NUMBER: 1306
OMPLETENESS CHECK	04-28-2015	
TE DEVELOPMENT PERMIT SUBMITTAL 1	05-27-2015	LANDSCAPE
TE DEVELOPMENT PERMIT SUBMITTAL 2	06-05-2015	DEVELOPEMENT
TE DEVELOPMENT PERMIT SUBMITTAL 3	11-04-2015	PLAN
TE DEVELOPMENT PERMIT SUBMITTAL 4	04-05-2018	LEAN
IE DEVELOPMENT PERMIT SUBMITTAL S	07-18-2016	
TE DEVELOPMENT PERMIT SUBMITTAL 6	08-30-2016	1 11N
TE DEVELOPMENT PERMIT SUBMITTAL 7	10-12-2016	L 1.0
		SCALE) " = 1'-0"

CHME

WATER BUDGET CALCULATIONS: TOTAL LANDSCAPE AREA (LA) = 8.504 SF SPECIAL LANDSCAPE AREA (SLA) = 0 SF


MAXIMUM APPLIED WATER ALLOWANCE (MAWA): MAWA = (ETO)(0.62)((0.55 x LA) + (0.45 x SLA)] (47)(0.62) ((.55 x 9.504) + (0.45 x 0)) =

ETWU = (ETo)(0.62) [(PF x HA/IE) + (SLA)]

ESTIMATED TOTAL WATER USE (ETWU):

EX. 181 CMP DRAIN PER DWG, 27879-05-D

ES	TIMATED TO	DTAL W	ATER US	Ε				
	HYDROZONE	PLANT FACTOR	HYDROZONE AREA IN S.F.	IRRIGATION METHOD	IRRIGATION EFFICIENCY	ETAF (PF/IE)	ETAF X HA	RESULT IN GALLONS PER Y
	1	0,7	2,448	DRIP	,B1	0,66	2,115.6	61,647
	2	0.5	1,434	DRIP	.81	0.62	665.2	25,794
	3	0.3	2,335	DRIP	.81	0.37	864.8	25,201
	4	0,2	2,887	DRIP	.81	0.25	546.7	16,445
		:						
	TOTAL,	:	8,504					128,097

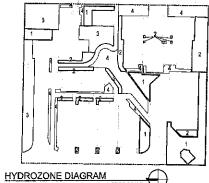

	Chilopals linearis	Desert Willow
\sim	EVERGREEN SHADE TREES Medium scale tree - 20' tall x 20' wide, such as:	10 / 100% / 24" BOX
\mathcal{C}	Acecia stenophylia Quercus agrifolia	"Shoestring Acada" "Coast Live Oak"
(')	Quercus virginiane	"Southern Live Oak"
\sim	ACCENT TREES	44 140001 145 011
~~~~	Small scale tree - 15' Iali x 15' wide, such as:  Acer palmatum 'Bloodgeed'	11 / 100% / 15 GAL "Japanese Maple"
{ ·	Cercis canadensis 'Forest Pansy'	Eastern Redbud
A	Arbutus 'Marina'	"Strawberry Tree"
45.	EVERGREEN ACCENT TREES Medium scale tree - 20' tell x 20' wide, such as:	3 / 100% / 15 GAL
(","2	Cupressus cashmeriona	"Keshmir Cypress"
- り゜ブ	Juniperus scopularum "Tolleson's Weeping" Cedrus atlantica glauca "Pendula"	"Blue Weeping Juniper" "Weeping Blue Atlas Cedar
~~	•	Meabing pine Witas Canar
	SHADE TREES/ \ Lerge scale Iree - 30' Leff x 30' wide, such as:	13 / 100% / 24* BOX
{ •	Ginkga biloba	13 / 100% / 24" BOX "Meldenhair Tree"
ر ک	5 Pialenus recemose Quercus egrifolie	"Western Sycamore" "Coast Live Oak"
	EVERGREEN ACCENT TREE	
2	Medium scale Iree - 20' tall x 20' wide, such as: Thuja occidentalis	2 / 100% / 15 GAL "America Arborvitae"
₹ •	Helerometes arbutifolia	"Tayon"
, A	Arclostaphylos 'Dr. Hurd' مُر	"Dr. Hurd Munzenite"
بمممس	ACCENT SHRUBS/BIORETENTION	00 / 4000/ 145 (24)
	Large scale shrub - 5' fall x 8' wide, such as: Heteromeles arbutifolia	20 / 100% / 15 GAL "Toyon"
· '	Sambuce moxicana	"Mexican Elderberry"
1	Myrica californica Corcis occidentalis	"Pacific Wax Myrtle" "Western Redbud"
$\wedge$	EVERGREEN ACCENT SHRUBS	#0 1400V 14 OA
( <b>*</b> }	Medium scele shrub - 3' tall x 4' wkfe, such as:	"Golden Breath of Heaven"
J	Coprosma repens 'Reinbow Surprise'	"Relebow Surprise Mirror Plant"
	Ericameria ericoides	"California Goldenbush"
(~)	EVERGREEN HEDGE Medium spale shrub - 3' tell x 3' wide, such as:	67/ 100% / 5 GAL
Name of Street	Nandina domestica 'Gulf Stream'	"Heavenly Bamboo"
	Mahonia aquifolium "Compacta" Ribes vibumifolium	"Oregon Grape" "Catalina Periume"
Action Ac	EVERGREEN SHRUB	
$\odot$	Tell clipped shrub - 12' lell x 4' wide, such as: Podocarpus etongatus 'icee Blue'	11 / 100% / 15 GAL "Icee Blue Podocarpus"
	Potoscarpus erongatus 1cae Biue: Pittosparum tenuifolium 'Silver Sheen'	"Silver Sheen Pittosporum"
	Thuja 'Smaragd'	"Emerald Green Ceder"
المريدي	GROUNDCOVER SHRUBS Low-growing strub = 3" (all x 6" wide, such as:	4 / 100% / 1 GAL
٠ ۶	Rhamnus 'Mound San Bruno'	"Coffeberry"
ξ ₂ , , ,		"Catatina Perlume" "Island Snapotegon"
JOIN 1.	LOW PRIVACY HEDGE	lora a annhara San
**+**	Large Upright Grass-like plants - 6' tall x 6' wide, such as:	53/ 100% / 5 GAL
$\bar{z}_{y_{+}\sqrt{\epsilon}}$	Bambuse multiplex 'Riviereorum' Indocelemnus letifolius	"Chinese Goddess" "Broad-leef Bamboo"
	Сурегия реругия	"Papyrus"
Miller	TALL SCREENING HEDGE Large scrie bamboo - 30' tall x 6' wide, such as:	21/ 100% / 5 GAL
10	Phyliostachys viridis	"Green Bamboo"
Thomas .	Bembuse oldhamii Pilylioslachys aurea	"Glant Timber Bamboo" "Gokren Bamboo"
	EVERGREEN GRASSES	Collon Damppo
( )	Medium scale clumping grass - 3' tall x 3' wide, such as:	228 / 100% / 1 GAL
***	Festuca mairei Miscanthus trensmontsonensis	"Atlas Fescue" "Evergreen Eulelie"
	Muhlenbergle rigens	Deer Grass
يامر	GRASSY GROUNDCOVER	470 / 4000/ / 4 CAL
يممرر	Smetl scele grass-like plants - 2' tall x 2' wide, such as: Lomandra longifolia 'Breeze'	178 / 100% / 1 GAL "Dwarf Mat Rush"
	Dianella (asmenice variegate	VareigatedFtax Lify
	Cerex turnulicola	"Berkley Sedge"
$\bigcirc$	LOW SHRUBS/ BIORETENTION Large scele shrubs - 3' tell x 3' wide, such as:	34 / 100% / 1 GAL
$\mathcal{C}$	Mahonte aquifotium 'Gompacte'	Oregon Grape
	Rhamnus çelifomiçe 'Litte Sur' Ribes virbumitaljum	'Coffsberry' 'Catelina Pertume'
	CASCADING VINE	
-	Fast-growing vine, such as:	12 / 100% / 15 GAL
. ALAKAN MERINGA	Macfadyena unguls-call Pessificre caerulea	"Cat's-claw vine" "Passionflower"
•	Ciemalis amendil	"Evergreen Clentatis"
	EVERGREEN FLOWERING GROUNDCOVER	
	TATIONELINA DOMENING OROGINDGOVER	
	Low-growing groundcover - 2' tall x 4' wide, such as:	797SF / 100% / 1 GAL
	Arctostaphylos 'Pacific Mist'	"Pacific Mist Manzanita"
	Low-growing groundcover - 2' tall x 4' wide, such as: Arctostaphylos "Pacific Mist" Coanothus 'Anchor Boy' Salvia 'Bee's Bijss'	
	Arctostephylos "Pecific Mist" Councidus 'Anchor Bay' Salvia 'Bee's Bibs' EVERGREEN GROUNDCOVER	"Pacific Mist Manzanita" "California Lilac" "Beo's Bliss Sage"
	Arctostephylos "Pacific Mist" Coanothus 'Anchor Bay' Snivle 'Bee's Bliss' EVERGREEN GROUNDCOVER Low-growing groundcover - 1' tell ¼ 4' ¼dde, such as:	"Pacific Mist Manzanita" "California Liac" "Beo's Bliss Sage"  928 SF / 100% / 1 GAL
	Arcisstaphylos Pacific Mist' Councitus Ancho Bay' Sarlvia Say's Silss' EVERGREEN GROUNDCOVER Low-gowing groundcover - I'tell x 4' wide, such ast: Arcisstaphylos Emeraid Carpol' Cotnessater 'Undest'	"Pacific Mist Manzarda" "Catifornia Litac" "Beo's Bitas Sage" 928 SF / 100% / 1 GAL "Manzarita" Bearbary Coloneaster
	Arcisatephylos Pacifir Mist" Councitus Auchin Buy" Sinhie Bey's Billist EVERGREEN GROUNDCOVER Low-growing proundcover - 11 tell x 4" wide, such as: Arcisatephylos Emerald Carpor" Cottonessias" Bacchania piluteria Pilgeon Point"	"Pacific Mist Manzarita" "Catifornia Litec" "Beo's Bitse Sego"  928 SF / 100% / 1 GAL "Manzarita"
	Arcisatephylos Pacific Mist' Councitus Anchor Bay' Sarlvin Bey's 8889' EVERGREEN GROUNDCOVER Low-growing groundcover - 1 tell x 4' wide, such se: Arcitatephylos Erwest' Carpor' Cotromester Fundas' Bacchamis piluteira Pigeon Point' BACChamis piluteira Pigeon Point' GRASSY GROUNDCOVER'S BIORETENTION	"Pacific Mist Manzanita" "Calliomia Lited" "Bed's Bliss Gage"  928 SF / 100% / 1 GAL "Manzanita" "Bearberry Coloneaster" "Coyote Brush"
	Arcistaphylos Pacific Mist' Councitus Anchor Bay' Sarivis Bey's 889s' EVERGREEN GROUNDCOVER Low-growing groundcover - 11 tail x 4' wide, such set: Arcistaphylos Emersid Carpol' Cotenesatior Loudest' Baccharis pilularis Pigeon Point' GRASSY GROUNDCOVER/BIORETENTION Grass - 6' tail x spreading, such as:	Pacific birst Manzanita"  California Litac"  California Litac"  "Bor's Blass Sago"  928 SF / 100% / 1 GAL  "Manzanita"  "Bestimeny Coloneasier"  Coyoto Busch'  2,448 SF / 100% / SOD  "Cresping Red Festuer"
	Arcisatephylos Pacific Mist' Councitus Ancho Bay' Sarlvia Say's Silss' EVERGREEN GROUNDCOVER Low-growing groundcover - I'tell x 4' wide, such ast: Arcisatephylos Emeraid Carpol' Coteneaster (wates') Baccharis plutatie Pigeon Point' GRASSY GROUNDCOVER/ BIORETENTION Gress - 6' lell x spreading, such ast: Fostore nitre Agrossis pallens	Pacific birst Manzanta*  California Lista  Beo's Bilas Sago*  928 SF / 100% / 1 GAL  **Manzanta*  **Caloreaster*  Coyote Brush*  2.448 SF / 100% / SOD  **Creoping Red Fescue*  **Native Bent Grass*
	Arcistaphylos Pacific Mist' Councilus Ancho Bay' Sarlvia Sea's Bliss' EVERGREEN GROUNDCOVER Lov-growing groundcover - I'tell x 4' wide, such ast: Arcistaphylos Emeraid Cappa' Cotnenseter Lovergrowing groundcover Baccharis plutinis Pigeon Point' Baccharis plutinis Pigeon Point' GRASSY GROUNDCOVER/ BIORETENTION Gress - 6' fell' x spreading, such as: Fosicior nütre Agrostis pailons Carcy panes Achilba millefolium	Pacific birst Manzanta*  California Liade  Beo's Bilas Sago*  928 SF / 100% / 1 GAL  **Manzanta*  **Calorine Liade  **Peatherly Colorieaster*  **Coyote Brush*  2.448 SF / 100% / SOD  **Creeping Red Fescue*  **Native Bent Crasss*  **Duns Sedge*  **Tamow*  *
	Arcisatephylos Pacific Mist' Coenothus Anchor Buy' Shinia 'Bey's Billias' EVERGREEN GROUNDCOVER Low-growing proundcover - 11 tell x 4' wide, such as: Arcisatephylos Emerald Carpor' Cottonestes' Bacchant pulment Pigeon Point' GRASSY GROUNDCOVER/ BIORETENTION GRASSY GROUNDCOVER/ BIORETENTION Gress - 6' tell x spreading, such as: Fesicon rubra Agrassis patiens Carex pansa	Pacific Mist Manzanta*  "Ca56min Late"  "Beo's Bilas Sage"  928 SF / 100% / 1 GAL  "Manzanta"  "Bestiveny Coloneasier*  "Coyolo Brusti*  "Cresping Red Fescue*  "Native Bent Crass*
	Arcistaphylos Pacific Mist' Councitus Anchor Bay' Sahini Bey's Bills' EVERGREEN GROUNDCOVER Low-growing groundcover - 11 tail x 4' wide, such as: Arcistaphylos Emeral Carpot' Coloneaties Loudes' Saccharis plutiente Pigeon Point' GRASSY GROUNDCOVER/BIORETENTION Grass - 6' tail x spreading, such as: Aproxis patiens Carrox pansa Achilica milliofaitum Baccharis plutieris Pigeon Point' Baccharis plutieris Pigeon Point'	Pacific birst Manzante  Calfornia List  Beo's Bilas Sago*  928 SF / 100% / 1 GAL  **Manzante  **Pacific Bilas Sago*  928 SF / 100% / 1 GAL  **Manzante  **Pacific Bilas Sago*  **Cooping Red Fiscue*  **Native Bent Crass*  **Duns Sedge*  **Tanov*  *
	Arcisatephylos Pacific Mist' Councilus Ancho Bay' Sarlvia Bay's Bliss' EVERGREEN GROUNDCOVER Lov-growing groundcover - I'tell x 4' wide, such as; Arcisatephylos Emersid Carpot' Cotenesses: Challes' Baccharis pitulante Pigeon Point' Baccharis pitulante Pigeon Point' Grass - 6' tell x spreading, such as; Fosicior nütra Agrostis pailens Carice panes Achilba millefülium Baccharis pitulante 'Pigeon Point' ACCENT GROUNDCOVER	Pacific birst Manzanta*  California Liar  Beo's Bilas Sago*  928 SF / 100% / 1 GAL  **Manzanta*  **Pacific birst Coloneaster*  Coyote Brush*  Cayote Brush*  Coyote Brush*  Coyote Brush*  Coyote Brush*  Coyote Brush*
	Arcisatephylos Pacific Mist' Coanothus Anchor Bay' Sarlvia Beer's Bilas' EVERGREEN GROUNDCOVER Low-growing groundcover-1' tell x 4' wide, such as; Arcisatephylos Emeraid Cappa' Cotinensater Low-growing Plagen Point' Baccharis pilulante Pigeon Point' GRASSY GROUNDCOVER BIORETENTION Gress - 6' tell x yeseading, such as; Fasicion ratira Agrossis pallans Carter panes Achibia milledifium Baccharis pilulante 'Pigeon Point' ACCENT GROUNDCOVER Low-growing succiont - 6' tell x 1' wide, such as; Sadam appaster Angelina'	Pacific birst Manzanta*  California Lista  Beo's Bilas Sage*  928 SF / 100% / 1 GAL  **Manzanta*  **Pacific birst Coloneaster*  Coyote Brush*  2.448 SF / 100% / SOD  **Creeping Ked Festuer*  **Native Bent Grass*  **Duns Sedge*  **Coyote Brush*  **Coyote Brush*  **Angolins Sedenta*  **Angolins Sedenta*  **Angolins Sedenta*  **Angolins Sedenta*  **Angolins Sedenta*  **Angolins Sedenta*
	Arcisstaphylos Pacific Mist' Councitus Anchor Bay' Sahini Bey's Bills' EVERGREEN GROUNDCOVER Low-growing groundcover - 11 tell x 4' wide, such as: Arcisstaphylos Emeral Carpet' Cotenepater Londest' Saccharis plutient Pigeon Point' GRASSY GROUNDCOVER BIORETENTION Grass - 6' lell x spreading, such as: Apricals pallens Cartex panes Baccharis plutient's Pigeon Point' ACCENT GROUNDCOVER Low-growing suitoris Cartex panes Sacharis plutient's Pigeon Point' ACCENT GROUNDCOVER Low-growing succulont - 6' tell x 1' wide, such as: Sadum speakter Angelina' Sadum speakter Angelina' Sadum speakter Angelina' Sadum speakter Angelina'	Pacific Mist Manzanta*  "Calfornia List"  "Beo's Bilas Sage"  928 SF / 100% / 1 GAL  "Manzanta"  "Beatherny Coloneaster  "Coyola Brust"  "Cresping Red Fescue*  "Native Bent Crass*  "Duns Sedge*  "Yarrow."  "Coyola Brust"  "Angoline Sedum"  "Angoline Sedum"
	Arcisatephylos Pacific Mist' Councitus Anchor Baj' Sahini Bey's Billis' EVERGREEN GROUNDCOVER Low-growing groundcover - 1' tell x 4' wide, such sei: Aratisatephylos Emersit Carpori Cotineasiate Tudesa' Saccharis piluleris Pigeon Point' Baccharis piluleris Pigeon Point' GRASSY GROUNDCOVER/BIORETENTION Grass - 6' tell x spreading, such as: Poelutin nitra Agnasis patiens Carex paras Achillos millichilium Bacchoris piluleris Pigeon Point' ACCENT GROUNDCOVER Low-growing succulent - 6' tell x 1' wide, such as: Sadum apastar 'Angelina' Sadum Abrotincium	Pacific birst Manzanta*  California Lista  Beo's Bilas Sage*  928 SF / 100% / 1 GAL  **Manzanta*  **Pacific birst Coloneaster*  Coyote Brush*  2.448 SF / 100% / SOD  **Creeping Ked Festuer*  **Native Bent Grass*  **Duns Sedge*  **Coyote Brush*  **Coyote Brush*  **Angolins Sedenta*  **Angolins Sedenta*  **Angolins Sedenta*  **Angolins Sedenta*  **Angolins Sedenta*  **Angolins Sedenta*
	Arcisatephylos Pacific Mist' Councitus Anchor Bajr' Seria Biss' EVERGREEN GROUNDCOVER Low-growing groundcover - 11 tell x 4' wide, such as: Arcisatephylos Emerals Cappa' Coteneaster Lowbar' Baccharis piluteis Pigeon Point' Baccharis piluteis Pigeon Point' GRASSY GROUNDCOVER BIORETENTION Grass - 6' tell x spreading, such as: Posicion mitter Agnasis patiens Carex pames Achillos millifolium Baccharis piluteis Pigeon Point' ACCENT GROUNDCOVER Low-growing succulent - 6' tell x 1' wide, such as: Sadum apatielium Capp Bisnoo' Sedum aubiculium Capp Bisnoo'	Pacific birst Manzanta*  California Lista  Beo's Bilas Sage*  928 SF / 100% / 1 GAL  **Manzanta*  **Pacitary Coloneaster*  Coyote Brush*  2.448 SF / 100% / SOD  **Creoping Red Festue*  **Native Bent Grass*  **Duns Sedge*  **Yarrow*  **Coyote Brush*  **Angolins Sedden*  **Capo Blanco Sodum*  *Port in Besne*  **Port in
	Arcisatephylos Pacific Mist' Councitus Anchor Baj' Sahini Bey's Billis' EVERGREEN GROUNDCOVER Low-growing groundcover - 1' tell x 4' wide, such sei: Aratisatephylos Emersit Carpori Cotineasiate Tudesa' Saccharis piluleris Pigeon Point' Baccharis piluleris Pigeon Point' GRASSY GROUNDCOVER/BIORETENTION Grass - 6' tell x spreading, such as: Poelutin nitra Agnasis patiens Carex paras Achillos millichilium Bacchoris piluleris Pigeon Point' ACCENT GROUNDCOVER Low-growing succulent - 6' tell x 1' wide, such as: Sadum apastar 'Angelina' Sadum Abrotincium	Pacific Nist Manzanta*  "Ca56min List Ca56min Ca

PROPOSED PLANT MATERIAL LEGEND: STREET TREES
Large scale tree - 60' lall x 30' -40' wide, such as:
Boulhids blaksarae
Gegera peniflorae
Aganis flexuosa



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## GOLDEN HILL

**B STREET HOMES** 

MAY A CONTRACT PART COMMAND THE CAPACES MENTED PLANFELS I HAVE NO ACCOUNTED BY NO	
	JOB NUMBER: 1308
2015	
2015	LANDSCAPE DEVELOPEMENT PLAN
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