BARRIO LOGAN COMMUNITY PLANNING GROUP NOTICE OF PUBLIC MEETING AGENDA 2212 MAIN STREET, SAN DIEGO CA 92113

6:00 PM - 8:00 PM November 18, 2015

1.	Call to C	Order-	Brent Beltran,	Vice-	Chairperson
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- 2. Approval of the minutes of the October 21, 2015 meeting
- 3. Adoption of the Agenda
- 4. Staff Reports
- 5. Comments from the public
- 6. Comments and discussion from the Planning Group: Maintenance assessment District, light and noise, logo design, and other considerations.
- 7. Information Item: John Alvarado Good Neighbor Initiative
- 8. Information item. Kyle Bike San Diego bike parking
- 9. Information item: Clay Company future plans for the Chevron Station at Main and Division
- 10. Action item: T-Mobile installation at 2393 Newton Ave at 26th Street
- 11. Adjournment: Next meeting December 16, 2015

Brent Beltran, Vice Chair David Favela, Secretary **Rafael Castellanos** Mario Chacon **Tim Fraser Catherine Herbst** Fernando Hernandez Capt. Curt Jones Juanita Lopez **Elvia Martinez Teresa Montero Erick Ortega Hector Perez** Tom Rvan Josie Talamantez **Hector Villegas**

Mark Steele, Chair

Barrio Logan Planning Group contact: Mark Steele mark@mwsteele.com



26TH & NEWTON













26TH & NEWTON













26TH & NEWTON













26TH & NEWTON











F-Mobile®

ZONING DRAWING

IF USING 11"X17" PLOT, DRAWINGS WILL BE HALF SCALE

SITE NUMBER: SD06358


26TH & NEWTON SITE NAME:

SITE TYPE: ROOFTOP CITY: **SAN DIEGO COUNTY: SAN DIEGO JURISDICTION: CITY OF SAN DIEGO**

PROJECT SUMMARY: SITE ADDRESS: 2393 NEWTON AVENUE SAN DIEGO, CA 92113 PROPERTY OWNER: PI PROPERTIES No 86 LLC 610 N. SANTA ANITA AVE ARCADIA, CA 91006 CONTACT: ERIK PARKER PHONE: (619) 696-8330 E-MAIL: erik.parker@cbre.com PROJECT DESCRIPTION: PROJECT ENTAILS THE FOLLOWING: -INSTALL (4) PROPOSED FRP SCREENED ANTENNA ENCLOSURES -INSTALL (8) PROPOSED AIR 21 4 PANEL ANTENNAS @ POSITIONS 1&4 -INSTALL (8) PROPOSED KATHREIN 6' PANEL ANTENNAS @ POSITIONS 2&3 -INSTALL (16) PROPOSED TMA/RRU'S -INSTALL HCS CABLES -INSTALL (1) PROPOSED GPS ANTENNA -INSTALL (1) PROPOSED 8' HIGH CMU WALL EQUIPMENT ENCLOSURE -INSTALL (1) PROPOSED TELCO CABINET -INSTALL) PROPOSED PPC CABINET -INSTALL PROPOSED ERICSSON RBS 6201 OUTDOOR CABINETS ZONING: BLPD-SUBD-B, BARRIO LOGAN PLANNED DISTRICT SUB B LATITUDE: 32° 41° 45 9096" N LONGITUDE: 117° 8' 17.8800" W FOUIPMENT LEASE AREA: ±134.40 SQ. FT. ANTENNA LEASE AREA: ±506.40 SQ. FT. +640.80 SO FT TOTAL LEASE AREA: LOCATION INFORMATION LEGAL DESCRIPTION: ALL OF ALLEY CLSD ADJ & LOTS 29 THRU 44 BLK 99 TR 379 COUNTY: SAN DIEGO CA SUBDIVISION: S D LAND & TOWN CO ADD CENSUS TRACT/BLOCK: 50.00/ TRACT: 379 LEGAL BOOK/PAGE: 538-74 SCHOOL DISTRICT: SAN DIEGO LEGAL LOT: 29-44 LEGAL BLOCK: 99

SHEET:	DESCRIPTION:
T-1	TITLE SHEET
RF-1	RF SIGNAGE A
LS-1	TOPOGRAPHIC SURVEY
LS-2	TOPOGRAPHIC SURVEY
A-1	SITE PLAN
A-2	ENLARGED SITE PLAN
A-3	PROPOSED EQUIPMENT AND ANTENNA LAYOUT PLANS
A-4	ARCHITECTURAL ELEVATIONS
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> L−1	PLANTING PLANS
> L−1.1	IRRIGATION PLANS
> L−3	PLANTING DETAILS AND NOTES $\langle$ 🕭
≻ L-4	IRRIGATION DETAILS & NOTES {
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**SHEET INDEX:** 

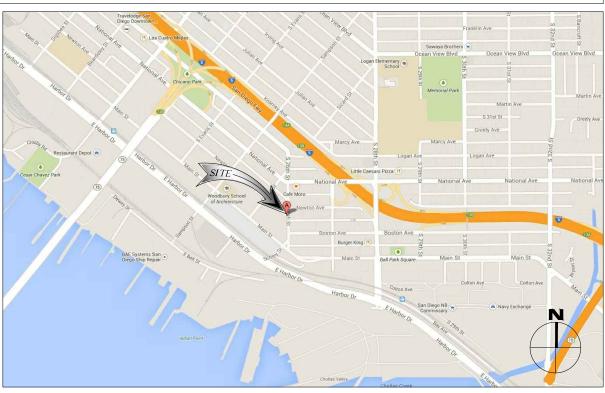

#### CONSULTING TEAM:

PROJECT MANAGER: SMARTLINK 18301 VON KARMAN AVE., STE 910 IRVINE, CA 92612 CONTACT: ROCKI LAM PHONE: (949) 387-1265 MOBILE: (801) 603-2052

(410) 263-5470 rocki.lam@smartlin

SITE ACQUISITION:

APN: 538-741-07-00

SMARTLINK
18301 VON KARMAN AVE., STE 910
IRVINE, CA 92612
CONTACT: JERROD PLOOF
PHONE: (858) 344-4444 (949) 387-1275

RF ENGINEER: T-MOBILE USA 10509 VISTA SORRENTO PARKWAY

SUITE 206 SAN DIEGO, CA 92121 CONTACT: PEDRO ABE PHONE: (858) 334-6135 EMAIL: pedro.abe@t-mob

ARCHITECTURAL ENGINEERING: NATIONAL ENGINEERING & CONSULTING, INC. 27 ORCHARD LAKE FOREST, CA. 92630 PHONE: (949) 716-9990 FAX: (949) 716-9997

ZONING: SMARTLINK

IR301 VON KARMAN AVE., STE 910 IRVINE, CA 92612 CONTACT: JERROD PLOOF PHONE: (858) 344-4444 (949) 387-1275

CONSTRUCTION MANAGER: T-MOBILE 10509 VISTA SORRENTO PARKWAY

SUITE 206 SAN DIEGO, CA 92121 CONTACT: KIRT BABCOCK PHONE: EMAIL: (858) 334-6139 kirt.babcock@t-mobile.com

#### APPROVALS:

THE FOLLOWING PARTIES HEREBY APPROVE AND ACCEPT THESE DOCUMENTS AND AUTHORIZE THE CONTRACTOR TO PROCEED WITH THE CONSTRUCTION DESCRIBED HEREIN. ALL CONSTRUCTION DOCUMENTS ARE SUBJECT TO REVIEW BY THE LOCAL BUILDING DEPARTMENT AND ANY CHANGES AND MODIFICATIONS THEY MAY IMPOSE.

	PRINT NAME	SIGNATURE	DATE
LANDLORD			
ZONING REP.			
DEVELOP. MGR			
CONST. MGR			
PROJECT MGR			
ZONING MGR.			
RF ENGINEER			
OPERATIONS			
SAC REP			

## DIRECTIONS FROM SAN DIEGO T-MOBILE OFFICE:

- . HEAD NORTHWEST ON VISTA SORRENTO PKWY TOWARD LUSK BLVD
- TURN LEFT ONTO SORRENTO VALLEY BLVD TURN RIGHT ONTO ROSELLE ST
- 4. TURN LEFT TO MERGE ONTO 1-5 S
- 5. TAKE THE 28TH STREET EXIT TOWARD NATIONAL AVENUE SD
- 6. KEEP RIGHT AT THE FORK, FOLLOW SIGNS FOR 28TH ST N/NATIONAL AVE AND MERGE ONTO S 27TH ST  $\,$
- 7. TURN LEFT ONTO NATIONAL AVE
- 8. TAKE THE 1ST LEFT ONTO S 26TH ST
- 9 TURN RIGHT ONTO NEWTON AVE
- DESTINATION WILL BE ON THE LEFT
- 2393 NEWTON AVE SAN DIEGO, CA 92113

## **APPLICABLE CODES**

ALL WORK AND MATERIALS SHALL BE PERFORMED AND INSTALLED IN ACCORDANCE WITH THE CURRENT EDITIONS OF THE FOLLOWING CODES AS ADOPTED BY THE LOCAL GOVERNING AUTHORITIES. NOTHING IN THESE PLANS IS TO BE CONSTRUED TO PERMIT WORK NOT CONFORMING TO THE LATEST EDITIONS OF THE FOLLOWING CODES.

- 2013 CALIFORNIA ADMINISTRATIVE CODE. 9. 2013 CALIFORNIA FIRE CODE. (CFC) 2013 CALIFORNIA BUILDING CODE (CBC). 10. 2013 CALIFORNIA GREEN CODE
- 2013 CALIFORNIA ELECTRICAL CODE (CEC). 2013 CALIFORNIA ENERGY CODE.
- 2013 CALIFORNIA MECHANICAL CODE (CMC)
- 2013 CALIFORNIA MECHANICAL CODE (CMC).
  2013 CALIFORNIA PLUMBING CODE (CPC).
  ANSI/TIA-222-G LIFE SAFETY CODE NFPA-101
  LOCAL BUILDING CODE.



#### **POWER & TELCO UTILITY CONTACTS**

POWER COMPANY SDG&F CUSTOMER SERVICE

PHONE: (800) 411-7343

PHONE COMPANY: T-MOBILE CONTACT: CUSTOMER SERVICE (800) 222-0400

SAN DIEGO, CA 92121

#### PLANS PREPARED BY:



#### CONSULTANT



18301 VON KARMAN AVENUE SUITE. 910 IRVINE, CA 92612 PHONE: (949) 387-1265 FAX: (949) 387-1275

NO	DATE:	DESCRIPTION:	BY:
1	08/26/14	90% ZONING	SA
2	09/18/14	CLIENT REVISIONS	SA
3	10/31/14	100% ZONING	EVT
4	04/20/15	CLIENT REVISION	EVT
<u>\$</u>	09/02/15	CITY REVISIONS	DP

#### SITE INFORMATION:


## SD06358


## **26TH & NEWTON**

2393 NEWTON AVENUE SAN DIEGO, CA 92113

#### SEAL

**TITLE SHEET** 

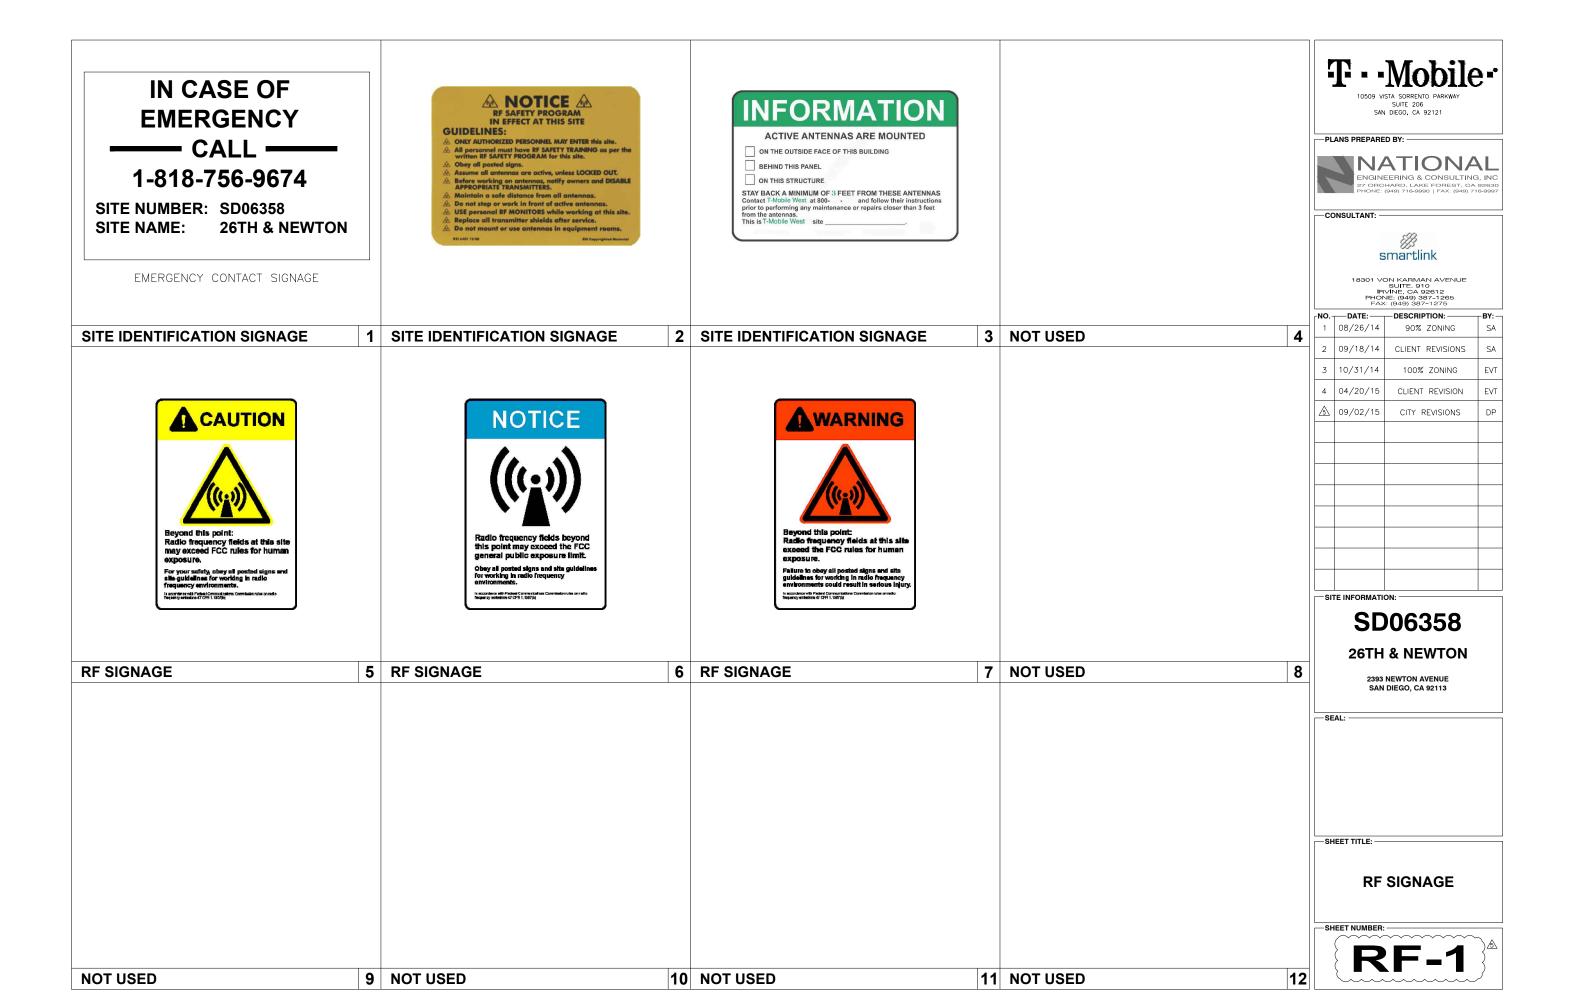

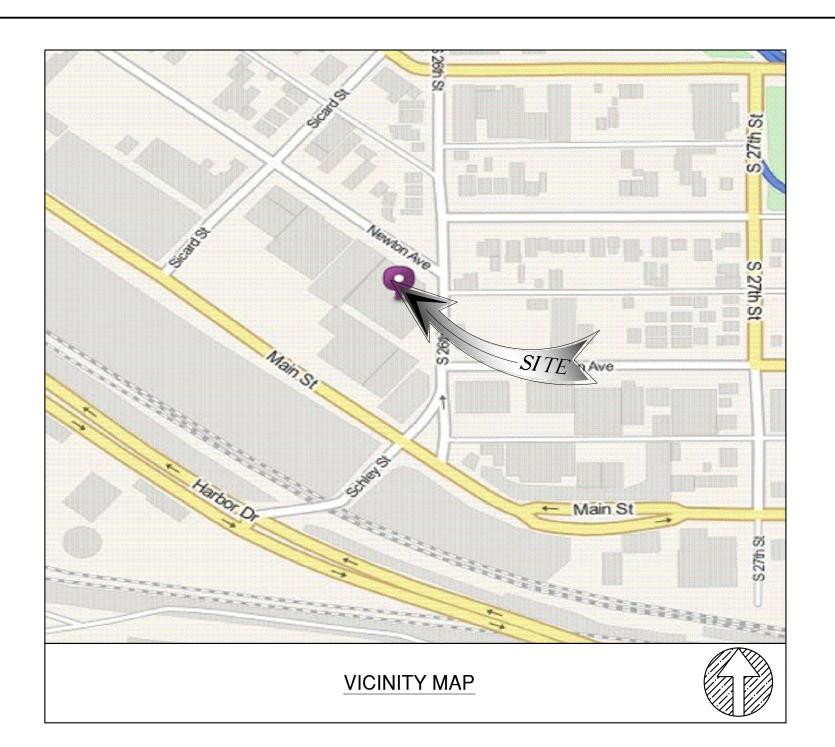

## LEGAL DESCRIPTION

ALL THAT CERTAIN REAL PROPERTY SITUATED IN THE COUNTY OF SAN DIEGO, STATE OF CALIFORNIA, DESCRIBED AS FOLLOWS:

LOTS 29 THROUGH 44, INCLUSIVE, BLOCK 99 OF SAN DIEGO LAND AND TOWN COMPANY ADDITION, IN THE CITY OF SAN DIEGO, COUNTY OF SAN DIEGO, STATE OF CALIFORNIA, ACCORDING TO MAP NO. 379, FILED IN THE OFFICE OF THE COUNTY RECORDER OF SAN DIEGO COUNTY, OCTOBER 30, 1886. TOGETHER WITH THE ALLEY ADJOINING SAID LOTS ON THE SOUTHWEST.

ASSESSOR'S PARCEL NUMBER: 538-741-07

## SITE ADDRESS

2393 NEWTON AVENUE SAN DIEGO, CA 92113 APN

538-741-07-00

## RECORD OWNER

RANCHO SFF, LP, A CALIFORNIA LIMITED PARTNERSHIP

# TITLE REPORT

LEGAL DESCRIPTION AND EXCEPTIONS WERE TAKEN FROM PRELIMINARY TITLE REPORT PREPARED BY COMMONWEALTH LAND TITLE COMPANY ORDER NO. 08023538 DATED AUGUST 13, 2014.

# SCHEDULE B EXCEPTION

ITEMS A, B, AND C ARE TAXES AND LIEN RELATED ITEM 1 IS WATER RIGHTS RELATED ITEMS 2, 3, 7, 8 ARE AGREEMENT RELATED ITEM 10 IS COVENANT AGREEMENT RELATED

ITEM 11 IS REDEVELOPMENT AGENCY RELATED ITEM 12 IS DEED OF TRUST RELATED

EASEMENT(S) FOR THE PURPOSE(S) SHOWN BELOW AND RIGHTS INCIDENTAL THERETO, AS GRANTED IN A DOCUMENT:

GRANTED TO: DEWITT TRANSFER & STORAGE CO., A CALIFORNIA CORPORATION ACCESS TO AND MAINTENANCE OF THE BUILDINGS AND FENCES PURPOSE:

RECORDING DATE: JUNE 14, 1976

RECORDING NO: AS INSTRUMENT NO. 76-182930 OF OFFICIAL RECORDS AFFECTS: PORTIONS OF THE LAND, THE EXACT LOCATION OF WHICH CAN BE DETERMINED BY EXAMINATION OF THE ABOVE-MENTIONED INSTRUMENT, WHICH CONTAINS A COMPLETE

LEGAL DESCRIPTION OF THE AFFECTED PORTIONS OF SAID LAND. DOES NOT AFFECT THE CONSTRUCTION AREA.

/5\ EASEMENT(S) FOR THE PURPOSE(S) SHOWN BELOW AND RIGHTS INCIDENTAL THERETO, AS GRANTED IN A DOCUMENT:

GRANTED TO: SAN DIEGO GAS AND ELECTRIC COMPANY, A CORPORATION

PIPELINE, UTILITIES, INGRESS AND EGRESS

RECORDING DATE: JUNE 16, 1976

RECORDING NO: AS INSTRUMENT NO. 76-186269 OF OFFICIAL RECORDS PORTIONS OF THE LAND, THE EXACT LOCATION OF WHICH CAN BE DETERMINED BY

EXAMINATION OF THE ABOVE-MENTIONED INSTRUMENT, WHICH CONTAINS A COMPLETE LEGAL DESCRIPTION OF THE AFFECTED PORTIONS OF SAID LAND.

DOES NOT AFFECT THE CONSTRUCTION AREA.

6 EASEMENT(S) FOR THE PURPOSE(S) SHOWN BELOW AND RIGHTS INCIDENTAL THERETO, AS GRANTED IN A DOCUMENT:

GRANTED TO: SAN DIEGO GAS AND ELECTRIC COMPANY

PURPOSE: POLE LINES, UNDERGROUND CONDUITS AND INCIDENTAL PURPOSES WITH THE RIGHT OF INGRESS AND EGRESS RECORDING DATE: MAY 03, 1989

RECORDING NO: AS INSTRUMENT NO. 89-231920 OF OFFICIAL RECORDS

THE EXACT LOCATION AND EXTENT OF SAID EASEMENT IS NOT DISCLOSED OF RECORD. MAY OR MAY NOT AFFECT THE CONSTRUCTION AREA.

/9\ EASEMENT(S) FOR THE PURPOSE(S) SHOWN BELOW AND RIGHTS INCIDENTAL THERETO AS RESERVED IN A DOCUMENT;


RESERVED BY: RAMSER DEVELOPMENT

PURPOSE: SANITARY SEWERS AND INCIDENTAL PURPOSES RECORDING DATE: JUNE 01, 1989

RECORDING NO: AS INSTRUMENT NO. 89-289240 OF OFFICIAL RECORDS AFFECTS:

PORTIONS OF THE LAND, THE EXACT LOCATION OF WHICH CAN BE DETERMINED BY EXAMINATION OF THE ABOVE-MENTIONED INSTRUMENT, WHICH CONTAINS A COMPLETE LEGAL DESCRIPTION OF THE AFFECTED PORTIONS OF SAID LAND.

SAID EASEMENT HAS BEEN GRANTED AND/OR RESERVED IN VARIOUS INSTRUMENTS OF RECORD. DOES NOT AFFECT THE CONSTRUCTION AREA.

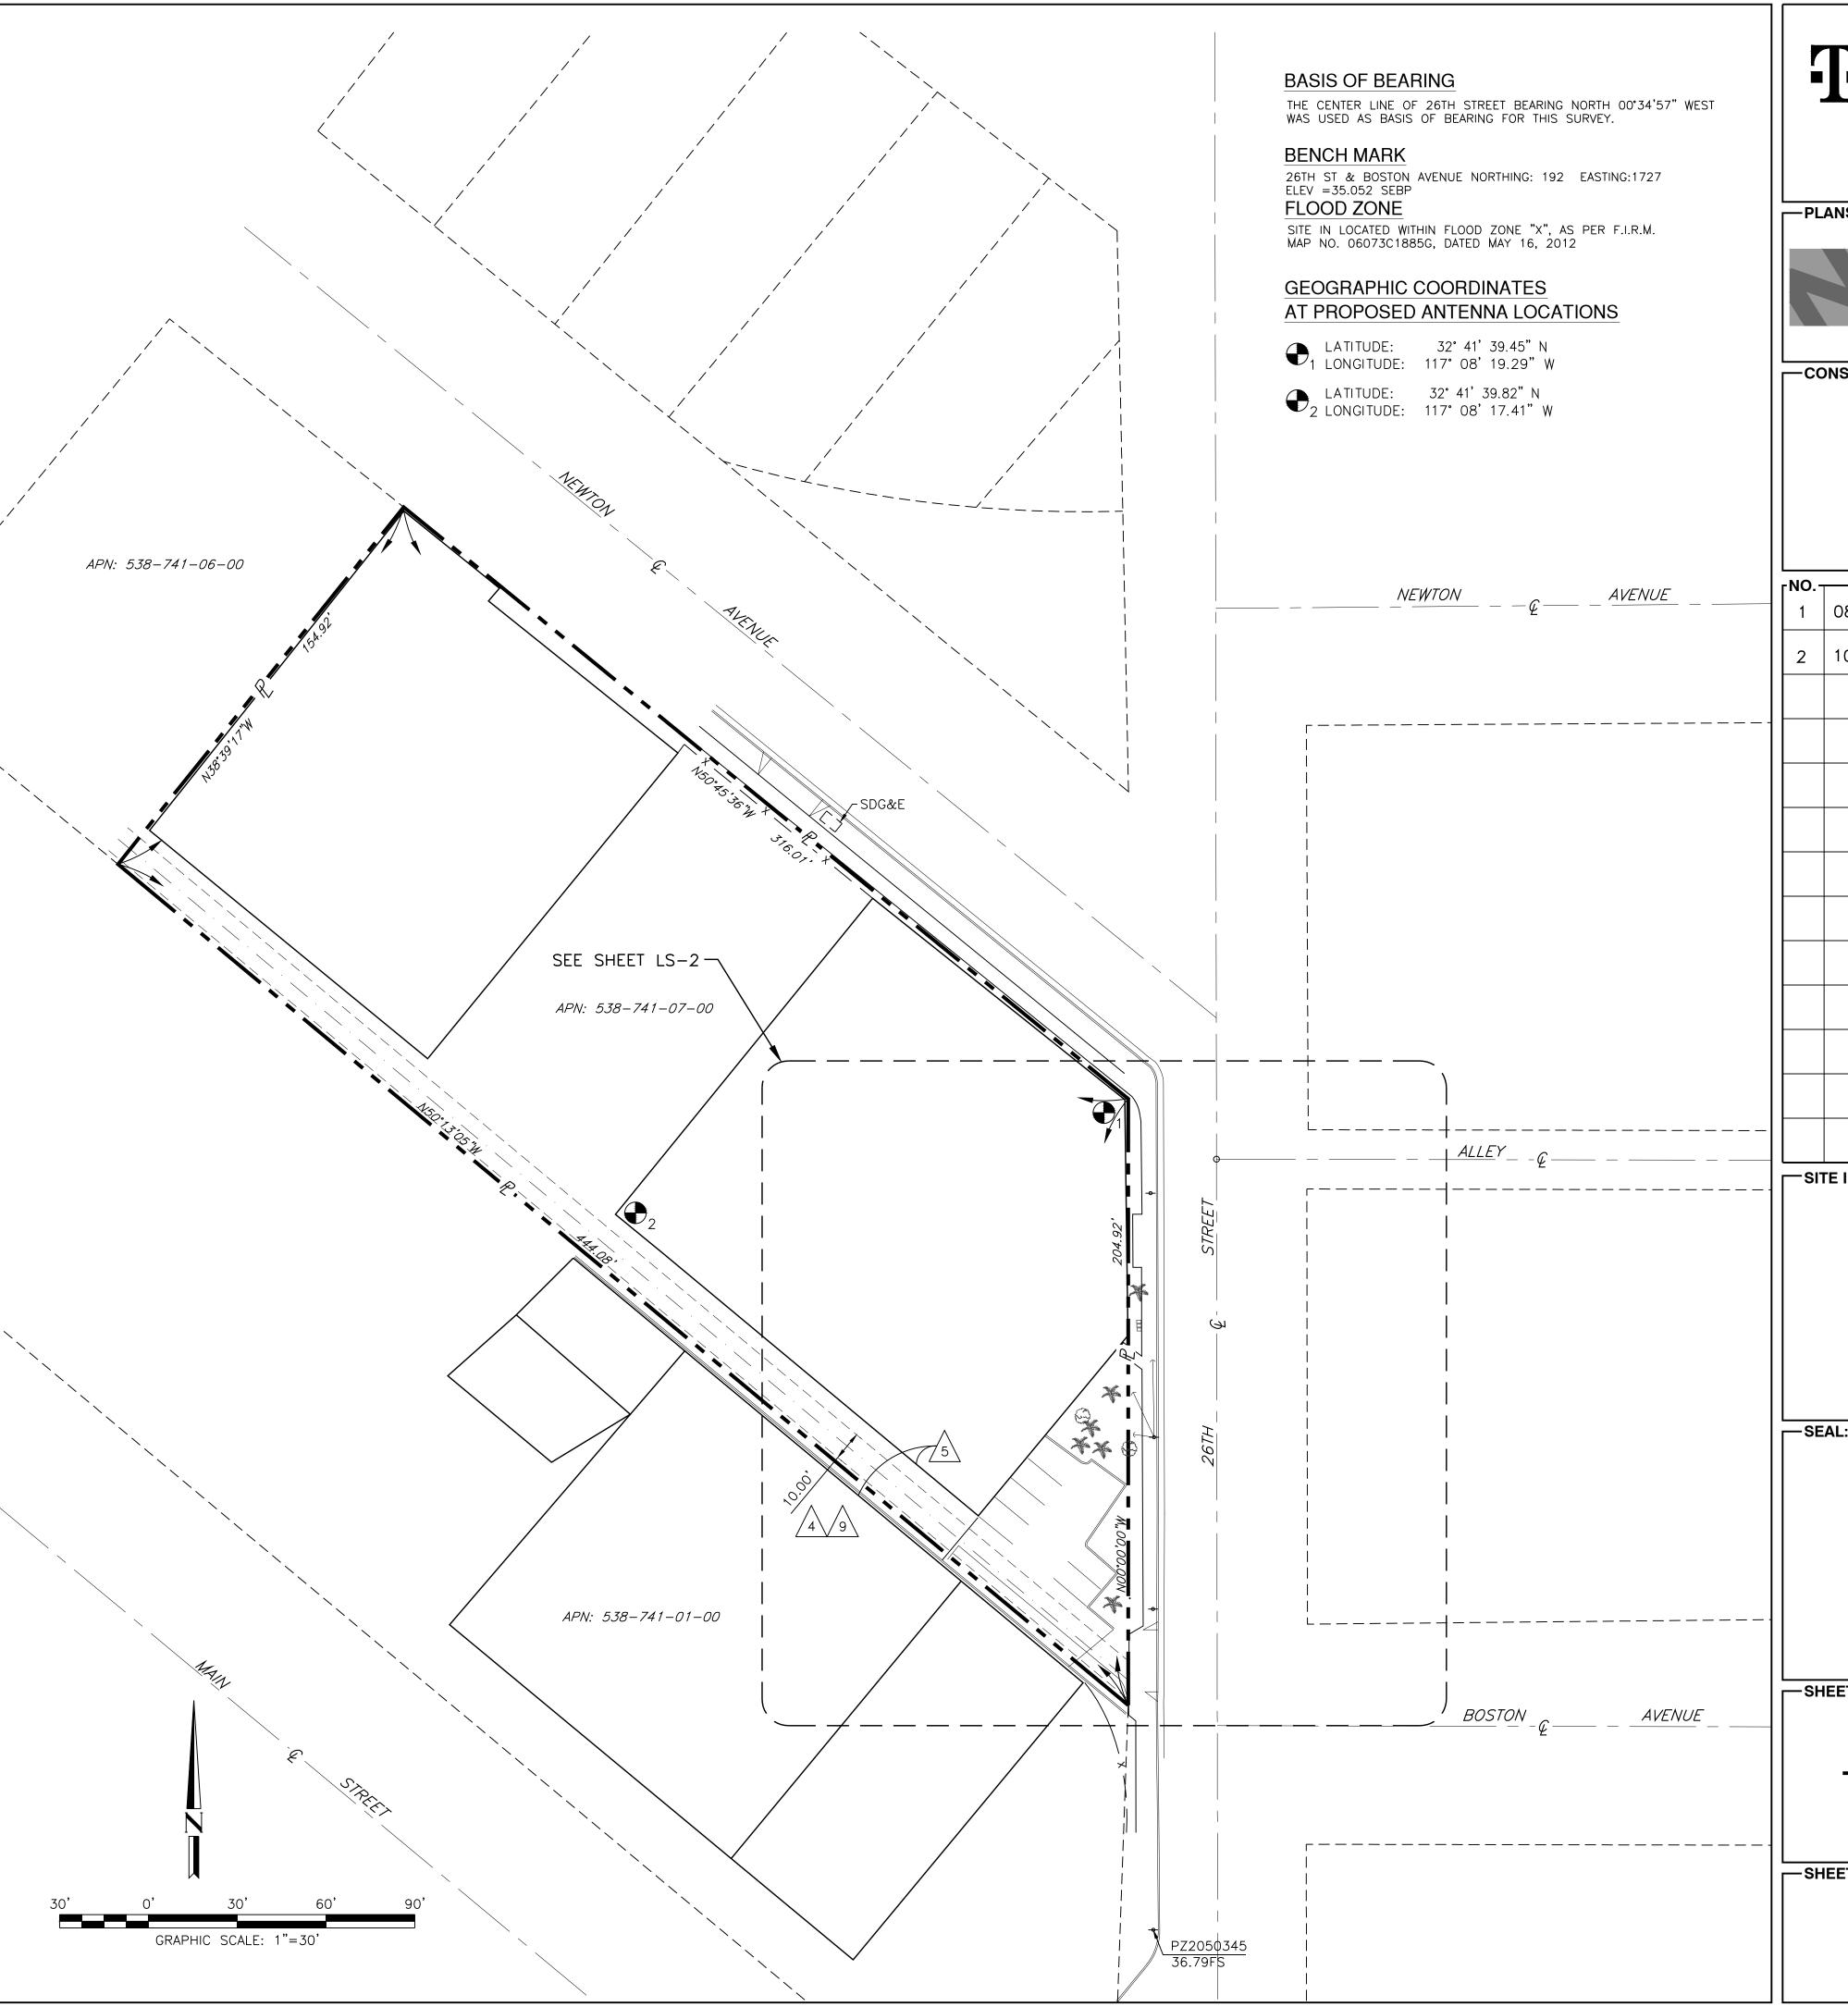

10509 VISTA SORRENTO PARKWAY

SUITE 206 SAN DIEGO, CA 92121

—PLANS PREPARED BY:—



-CONSULTANT:



PHONE: (949) 387-1265 FAX: (949) 387-1275

rno. ← DATE: ← DESCRIPTION: -08/15/14 PRELIM 2 | 10/29/14 FINAL


SITE INFORMATION:

SD06358

**26TH & NEWTON** 

2393 NEWTON AVENUE SAN DIEGO, CA 92113

—SEAL: —

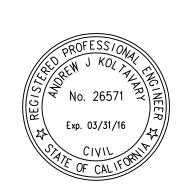


-SHEET TITLE:-

TOPOGRAPHIC SURVEY

-SHEET NUMBER:-

SHEET 1 OF 2

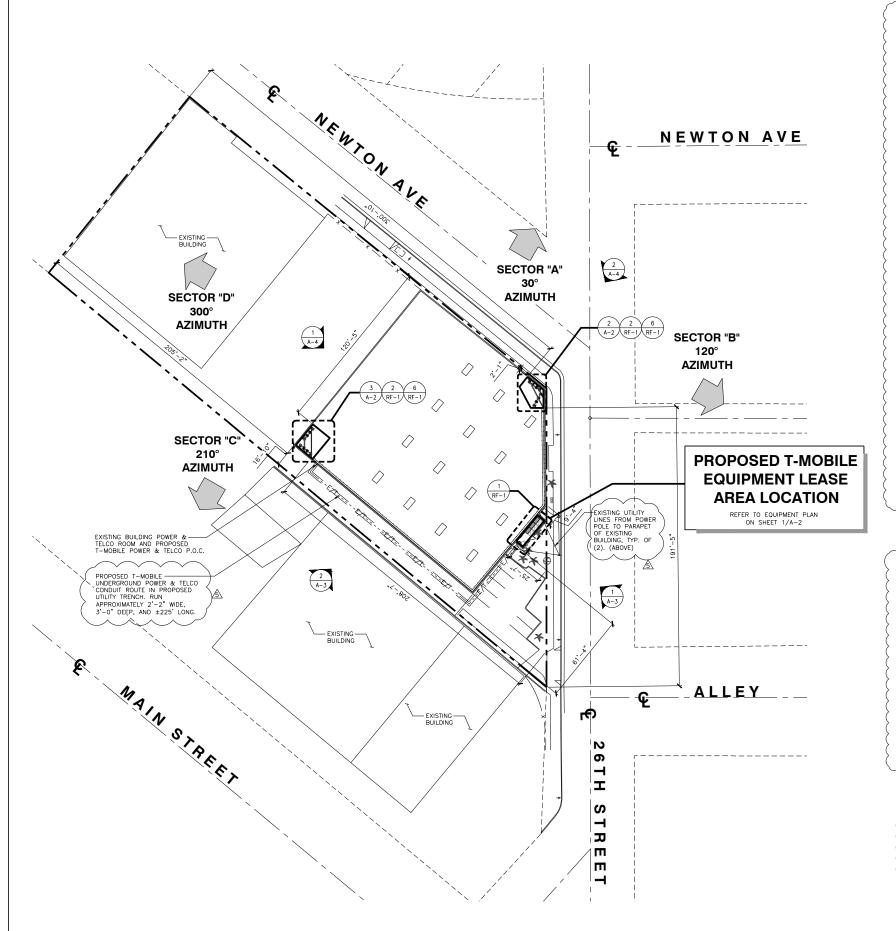

Lessee's Certificate Standard Wireless Facility Project for Post Construction BMPs

I / we the understance as Lessee(s) of the property described as 2393 Newton Ave., San Diego, CA 92113

understand that in accordance with the San Diego Municipal Code, Land Development Manual - Storm Water Standards, this project is required to "Identify Pollutants from the Project Area" and incorporate "Site Design" and "Source

I/We certify to the best of my knowledge, pollutants anticipated by the proposed

Nutrients Trash & debris Oxygen Demanding Substance Oil & Grease Bacteria & Viruses Pesticides

I/We will incorporate the following into the site design -

- Maintain pre-development runoff characteristics Minimize impervious foot print by constructing walkways, patios and driveways with permeable surfaces.
- Conserve natural areas Use natural drainage systems as opposed to lined swales or underground
- Drain roof tops, walkways, patios and driveways into adjacent landscaping Protect all slopes from erosion

Additionally I/we will;

Minimize the use of pesticides

Use efficient irrigation systems and landscape design - incorporating rain shutoff devices and flow reducers

I/we will maintain the above Standard Permanent BMPs for the duration of the

Lessee Jerrod Ploof, as agent for T-Mobile Company Name

Smartlink LLC, as agent for T-Mobile

6/12/2015

1. THIS PROJECT PROPOSES NO WORK WITHIN THE PUBLIC RIGHT OF WAY

2. NO EXISTING PARKING SPACE WILL BE USED OR REMOVED BY THIS PROJECT.

3. PRIOR TO THE ISSUANCE OF ANY CONSTRUCTION PERMIT, THE PERMITTEE SHALL INCORPORATE ANY CONSTRUCTION BEST MANAGEMENT PRACTICES NECESSARY TO COMPLY WITH CHAPTER 14, ARTICLE 2, DIVISION 1 (GRADING REGULATIONS) OF THE SAN DIEGO MUNICIPAL CODE, INTO THE CONSTRUCTION PLANS OR SPECIFICATIONS.

4. PRIOR TO THE ISSUANCE OF ANY CONSTRUCTION PERMIT, THE PERMITTEE SHALL SUBMIT A WATER POLLUTION CONTROL PLAN (WPCP) THE WPCP SHALL BE PREPARED IN ACCORDANCE WITH THE GUIDELINES IN APPENDIX E OF THE CITY'S STORM WATER STANDARDS.

5. NOTICE SIGNS AND MAP, DRAWINGS OR SKETCH OF ANTENNA LOCATIONS SHOULD BE POSTED AT EACH ROOFTOP ACCESS POINT (AT LOWER LADDER LEVEL).

## DRAINAGE NOTE:

THE PROPOSED EQUIPMENT SHELTER WILL NOT BLOCK OR ALTER THE EXISTING DRAINAGE PATTERN. THE ELEVATION BEGINS AT A HIGH POINT OF 41.44' AND 42.12' ALONG THE PARALLEL EXISTING BUILDING. MOVING PERPENDICULAR TO 26TH STREET. THERE ARE SPOT ELEVATIONS OF 40.58' AND 40.88', CONFIRMING POSITIVE DRAINAGE TO THE STREET AND CURB.

GRADING DATA TABLE

CUT & FILL TOTAL FOR PROPOSED CONSTRUCTION FILL = 0 CU. YD. / CUT = ±4.54 CU. YD. IMPORT = 0 CU. YD. / EXPORT = ±4.54 CU. YD.



SAN DIEGO, CA 92121

-PLANS PREPARED BY: -



-CONSULTANT: -



18301 VON KARMAN AVENUE SUITE. 910 IRVINE, CA 92612 PHONE: (949) 387-1265 FAX: (949) 387-1275

FAX: (949) 387-1275							
NO	DATE:	DESCRIPTION:	⊤BY:-				
1	08/26/14	90% ZONING	SA				
2	09/18/14	CLIENT REVISIONS	SA				
3	10/31/14	100% ZONING	EVT				
4	04/20/15	CLIENT REVISION	EVT				
<u>∕</u> \$\	09/02/15	CITY REVISIONS	DP				

-SITE INFORMATION: -

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**SD06358 26TH & NEWTON** 

> 2393 NEWTON AVENUE SAN DIEGO, CA 92113

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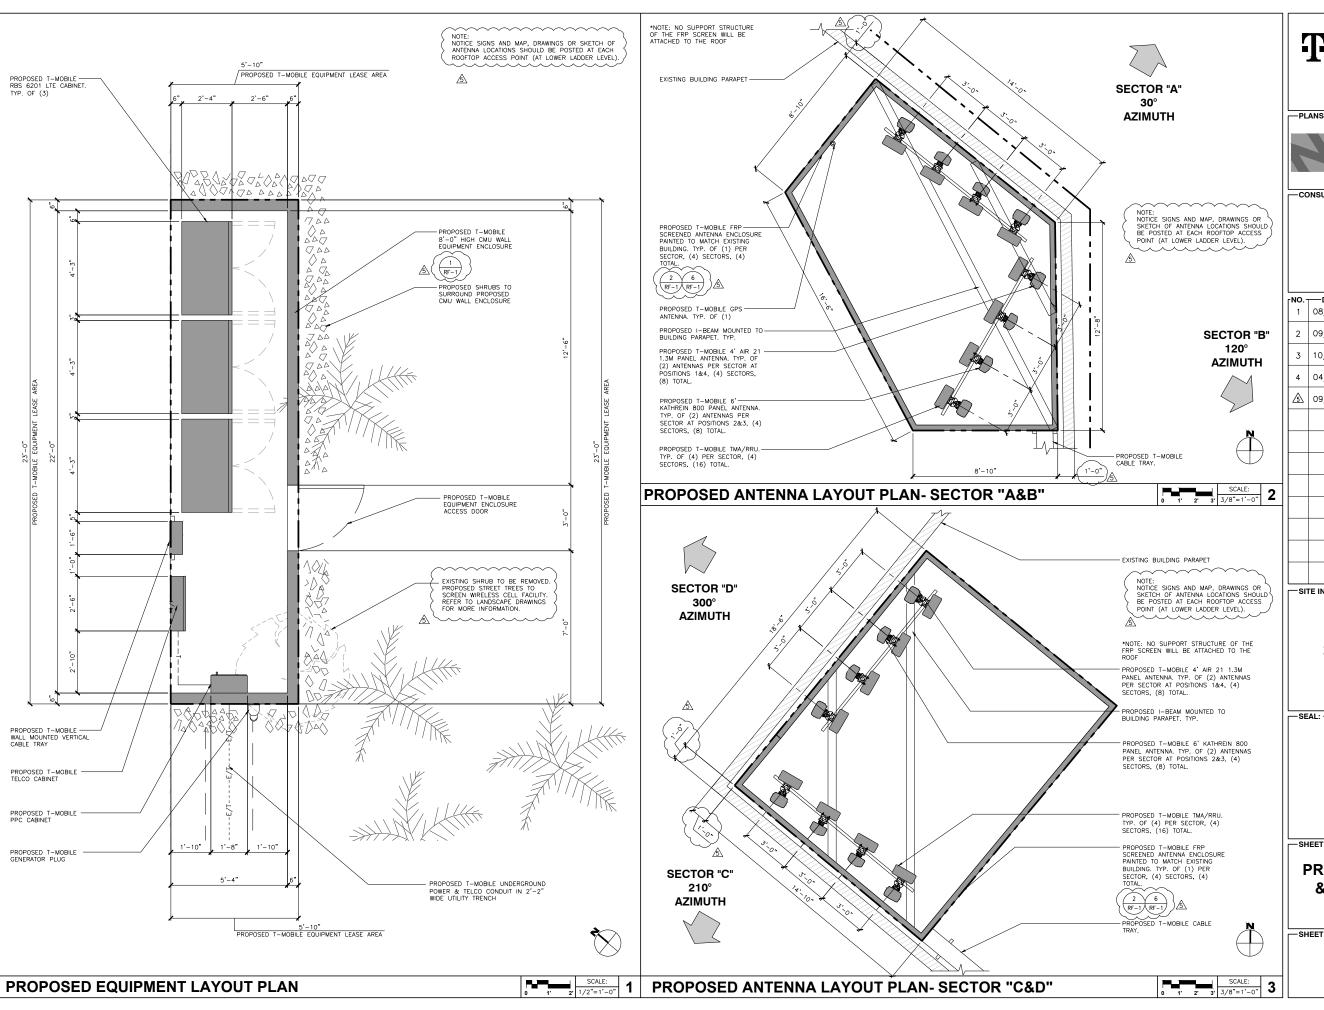
-SHEET TITLE: -

**SITE PLAN** 

-SHEET NUMBER:

SITE PLAN

SCALE: 0 15' 30' 1"=30'



SAN DIEGO, CA 92121

-PLANS PREPARED BY: -



-CONSULTANT: -



18301 VON KARMAN AVENUE SUITE. 910 IFVINE, CA 92612 PHONE: (949) 387-1265 FAX: (949) 387-1275

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08/26/14	90% ZONING	SA					
09/18/14	CLIENT REVISIONS	SA					
10/31/14	100% ZONING	EVT					
04/20/15	CLIENT REVISION	EVT					
09/02/15	CITY REVISIONS	DP					
	08/26/14 09/18/14 10/31/14 04/20/15	08/26/14 90% ZONING 09/18/14 CLIENT REVISIONS 10/31/14 100% ZONING 04/20/15 CLIENT REVISION					

-SITE INFORMATION: -

**SD06358** 

**26TH & NEWTON** 


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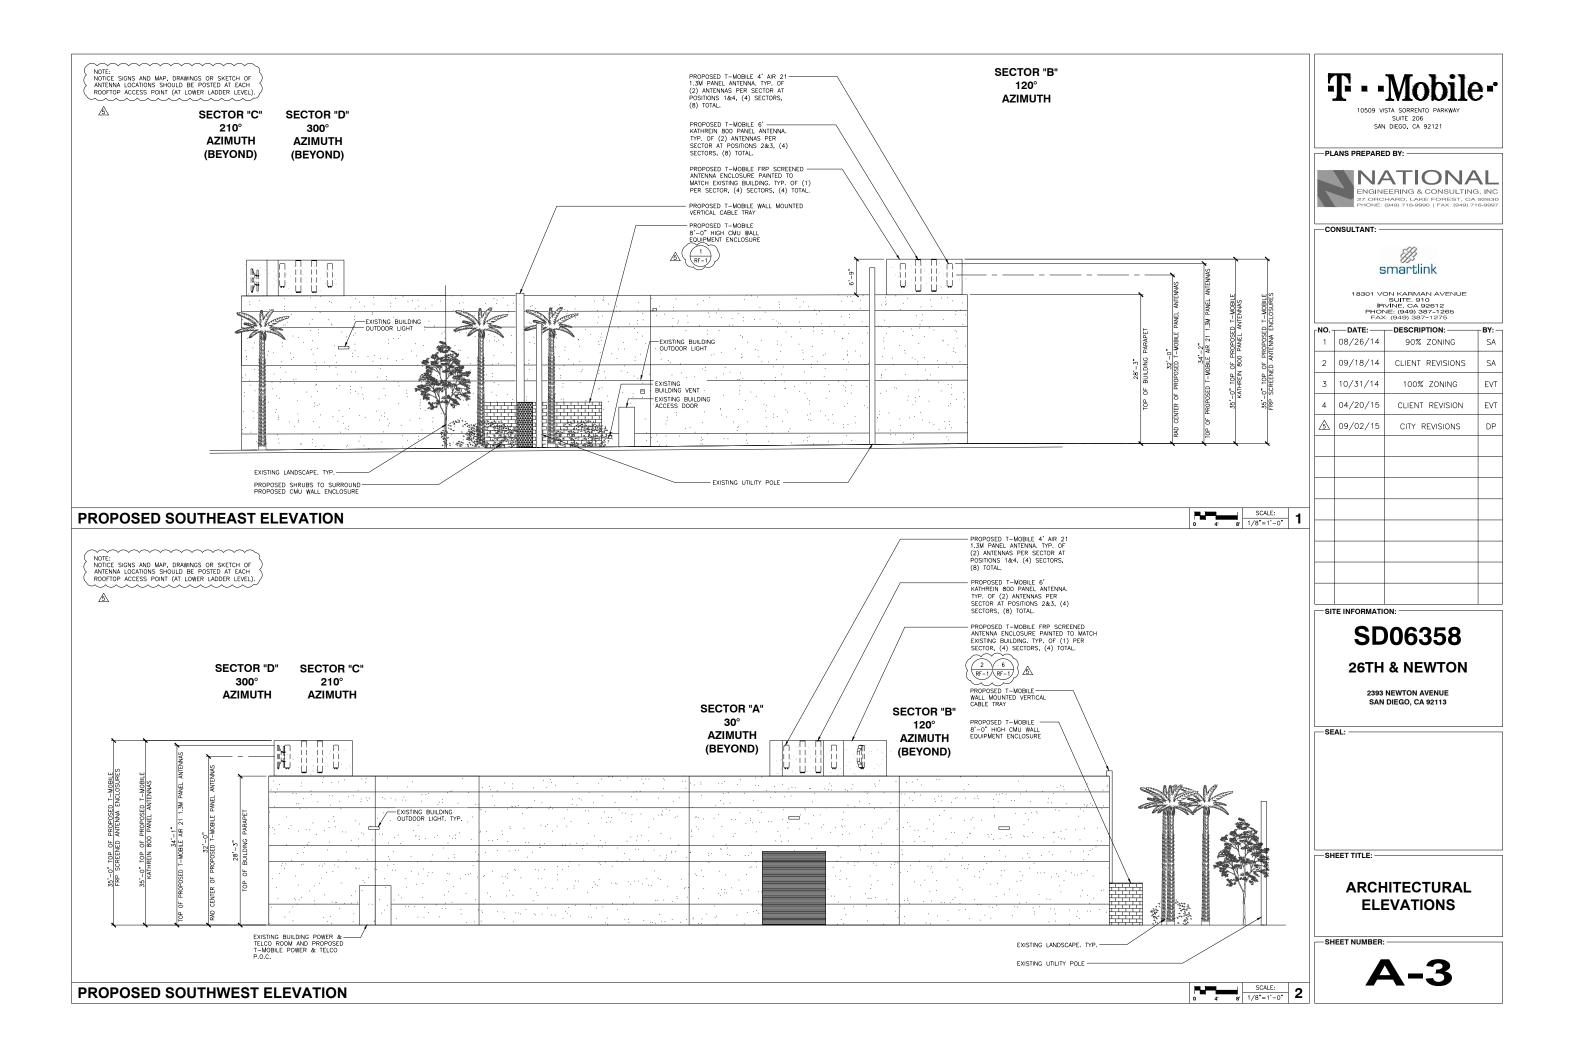
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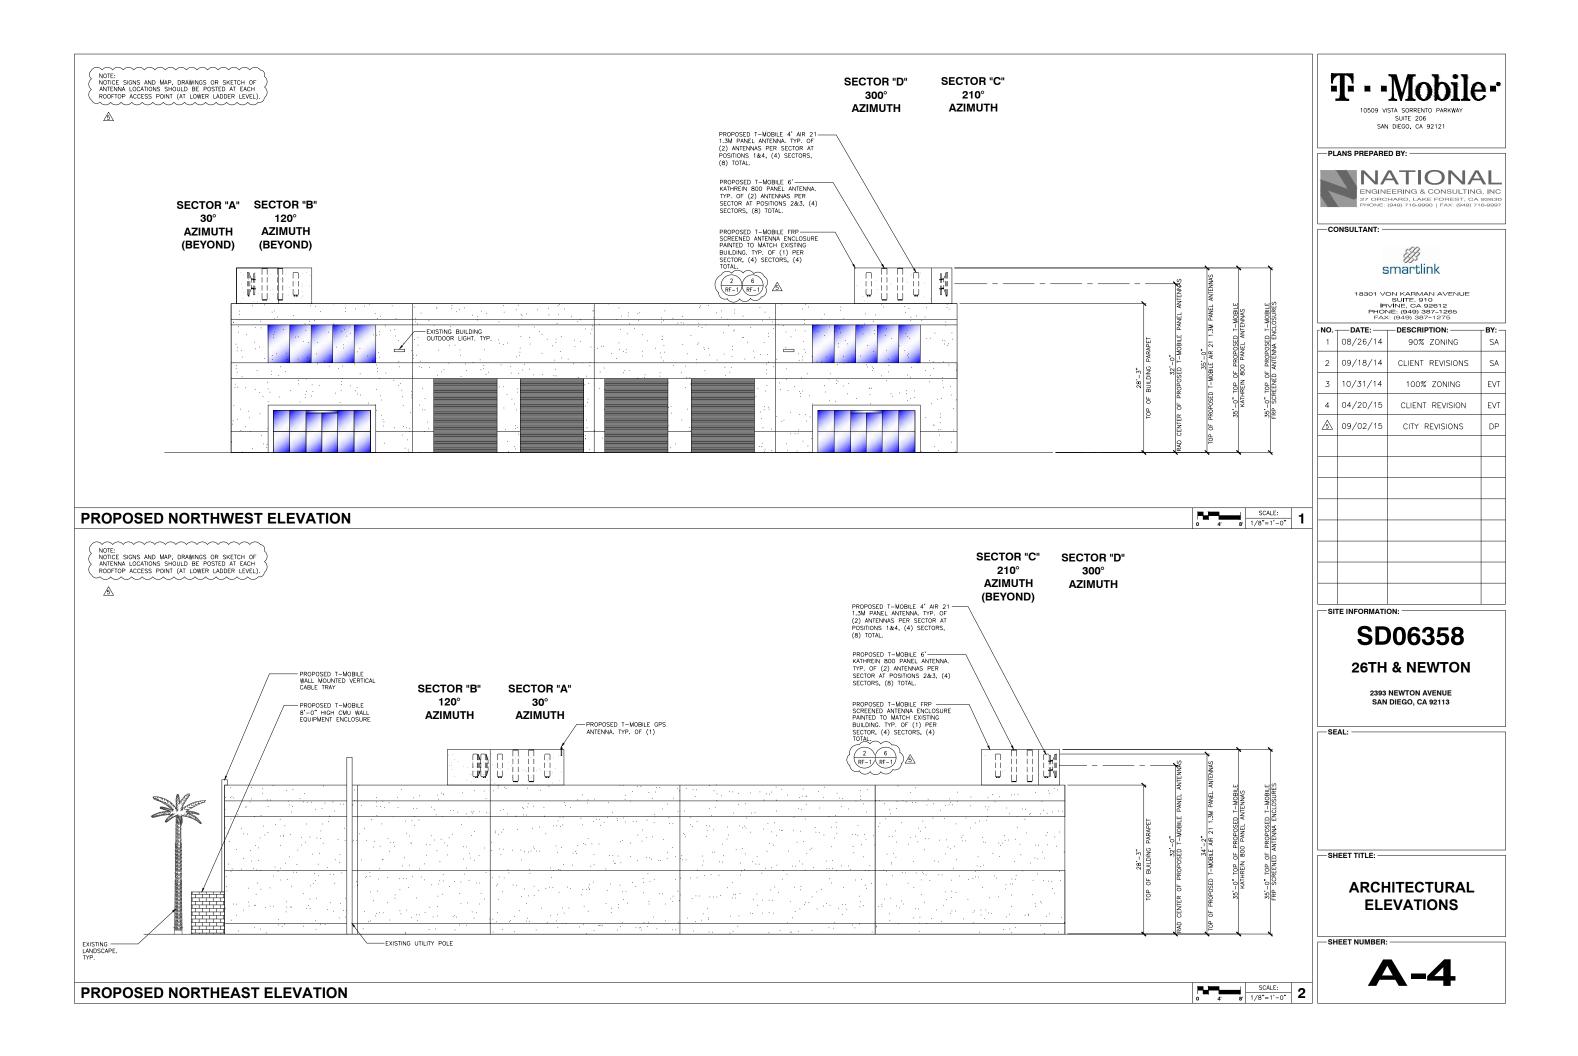
PROPOSED EQUIPMENT & ANTENNA LAYOUT **PLANS** 


-SHEET NUMBER:

**A-2** 





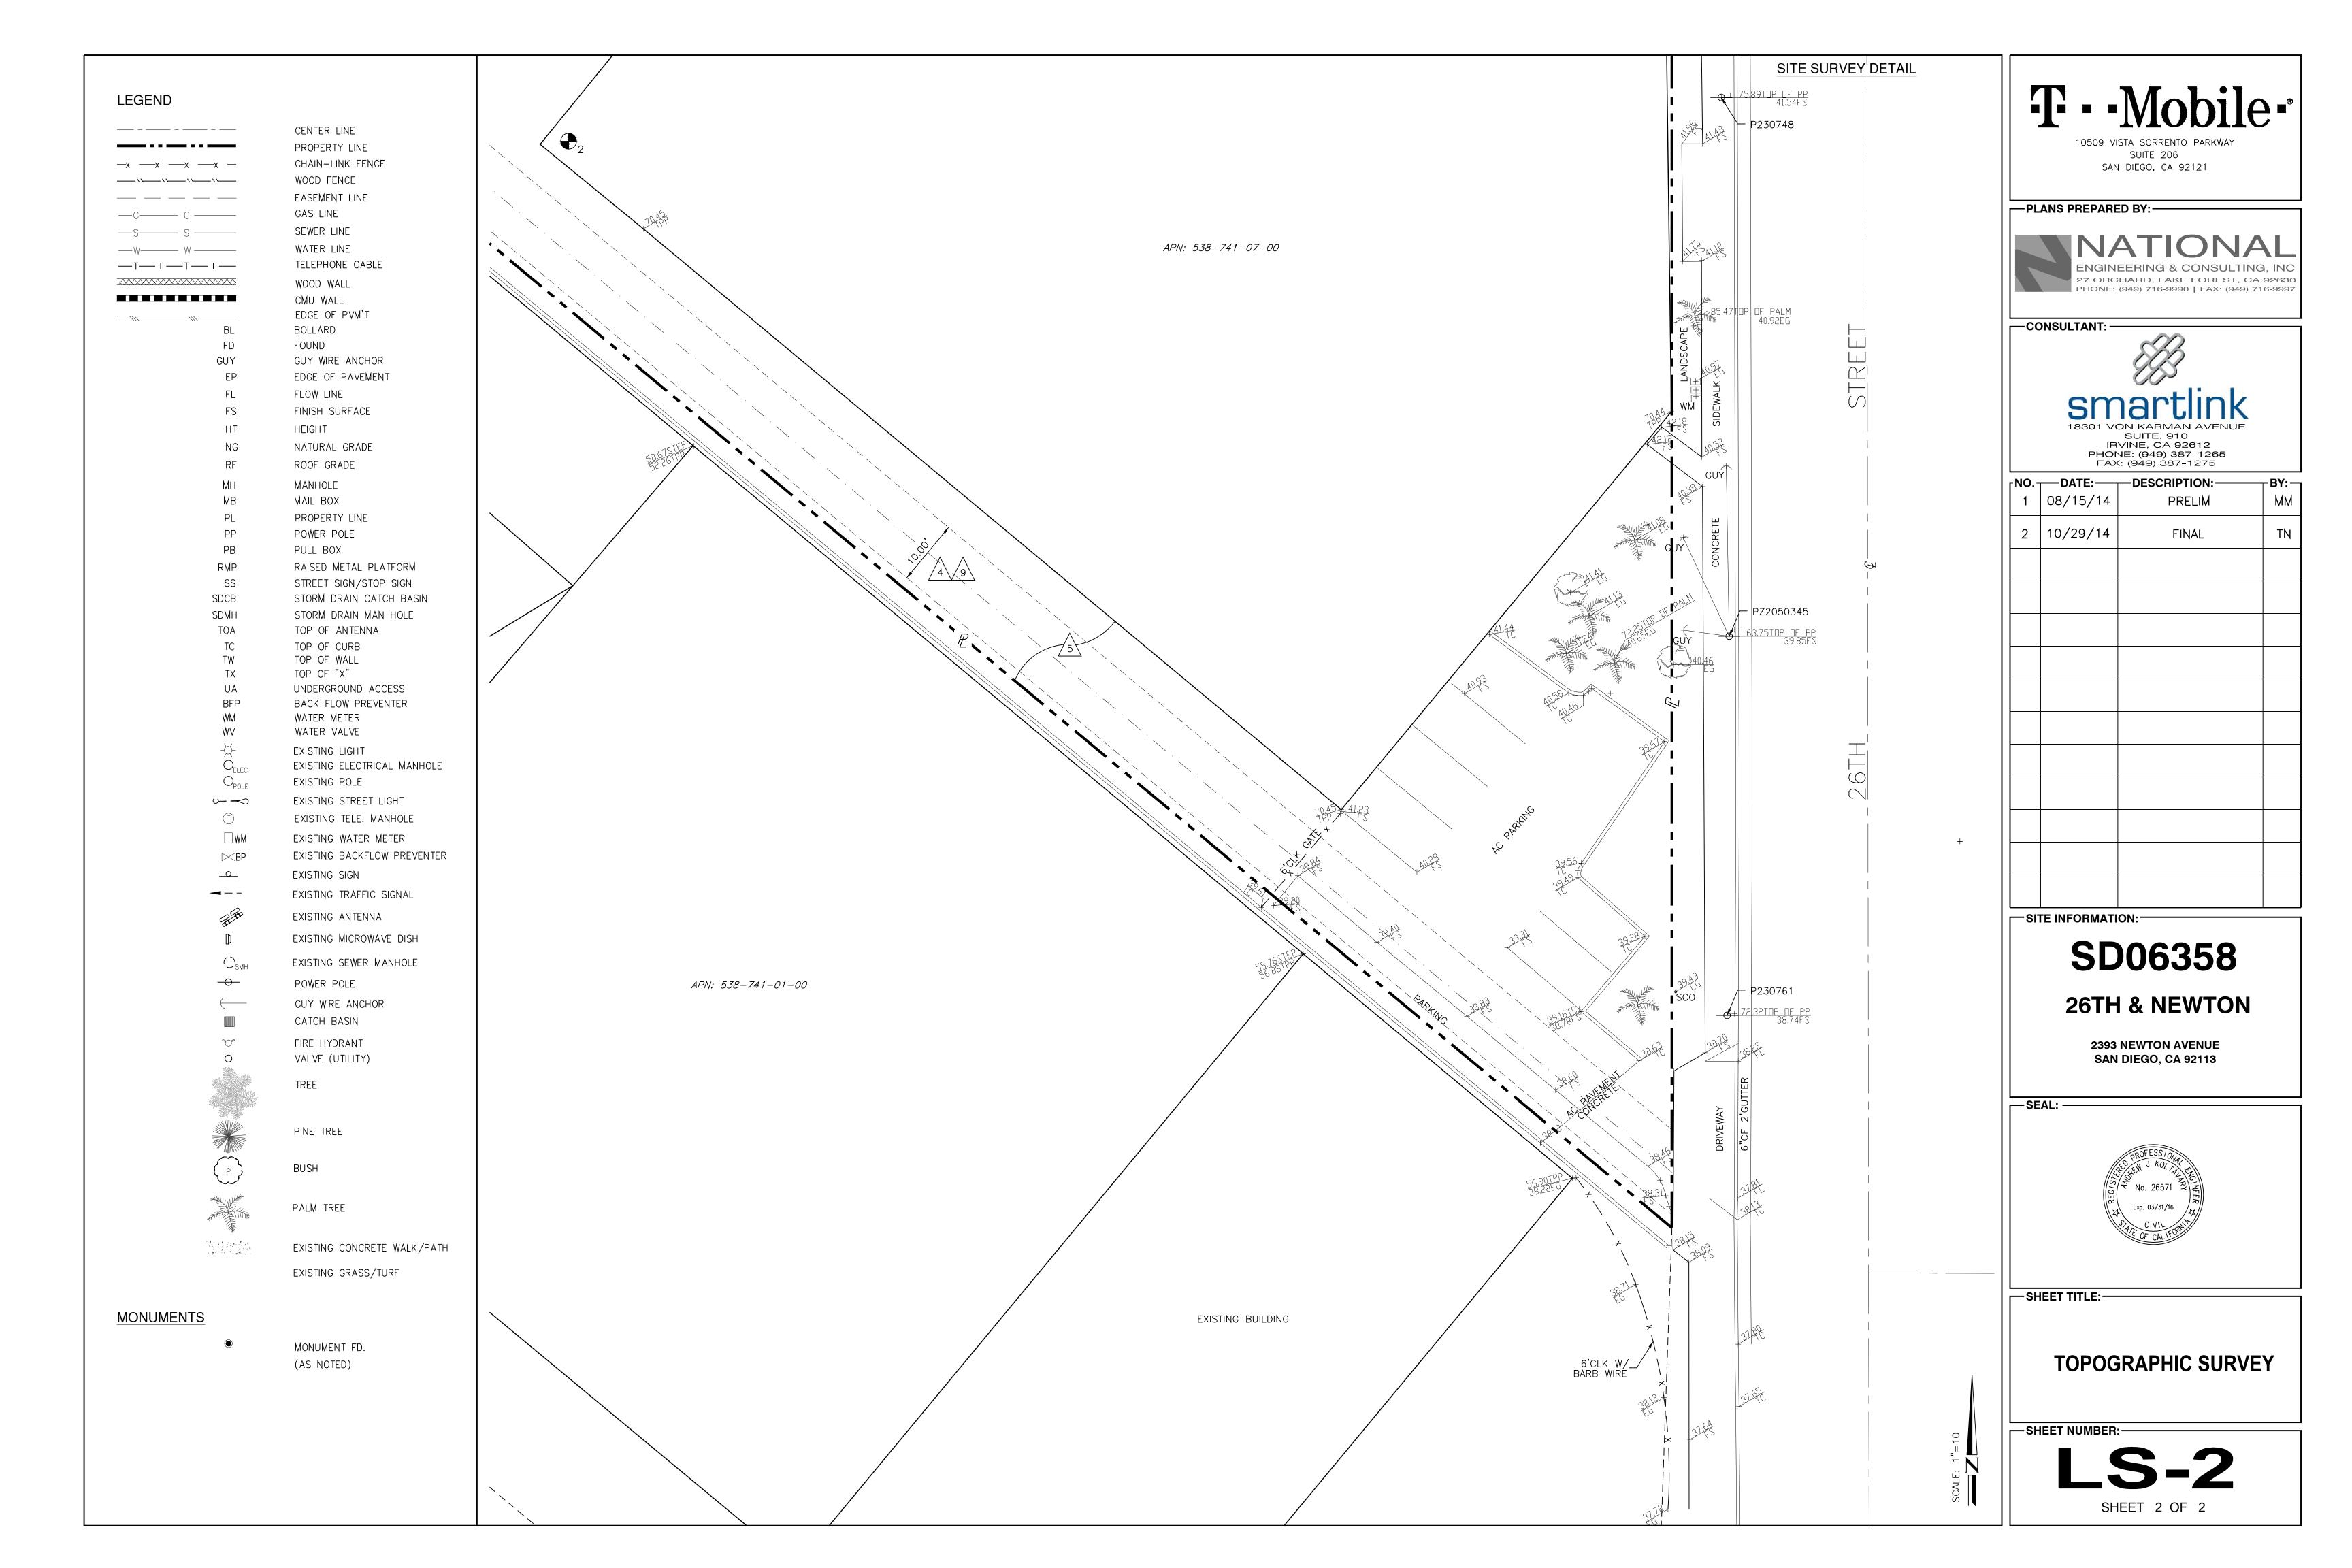

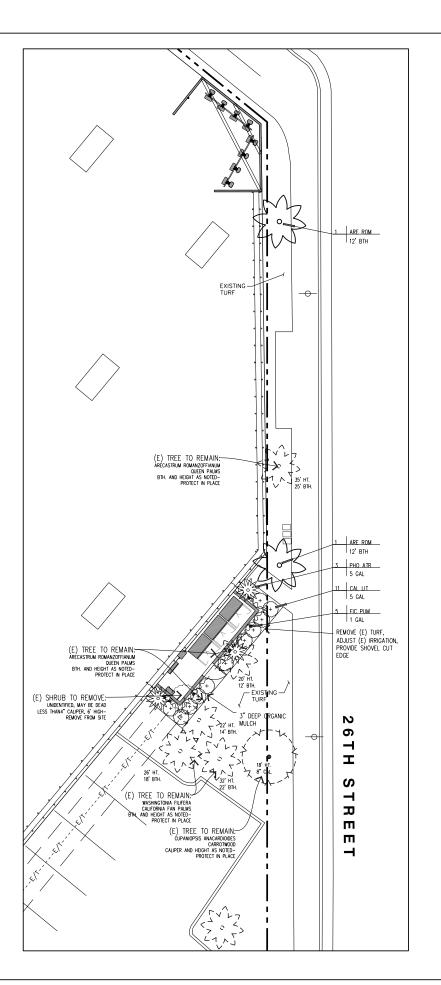

CITY NOTES

IMPROVEMENT/ MINIMUM DISTANCE TO STREET TREE TRAFFIC SIGNALS (STOP SIGN)-20 FEET UNDERGROUND UTILITY LINES - FEET (10' FOR SEMER)
ABOVE GROUND UTILITY STRUCTURES - 10 FEET
INTERSECTIONS (INTERSECTING CURB LINES OF TWO STREETS) - 25 FEET
INTERSECTIONS (INTERSECTING CURB LINES OF TWO STREETS) - 25 FEET

"ALL LANDSCAPE AND IRRIGATION SHALL CONFORM TO THE STANDARDS OF THE CITY-WIDE LANDSCAPE REGULATIONS AND THE CITY OF SAN DEED LAND DEVOLUTIONENT MANUAL LANDSCAPE STANDARDS AND ALL OTHER LANDSCAPE RELIED OITY AND REDOWNLE STANDARDS.

"BRIGATION: AN AUTOMATIC, ELECTRICALLY CONTROLLED IRRIGATION SYSTEM SHALL BE PROVIDED AS REQUIRED FOR PROPER RERCATION, DEVELOPMENT, AND MAINTENANCE OF THE MECETATION IN A HEALTHY, DESEASE-RESISTANT CONDITION. THE DESIGN OF THE SYSTEM SHALL PROVIDE ADEQUATE SUPPORT FOR THE MECETATION SELECTED."

IRRIGATION TYPE:
THE IRRICATION SYSTEM SHALL BE AUTOMATICALLY CONTROLLED BUBBLER SYSTEM WITH AN AUTOMATIC RAIN SHUT-OFF DEWICE.

MAINTENANCE:
*ALL REQUIRED LANDSCAPE AREAS SHALL BE MAINTAINED BY:

LANDSCAPE & IRRIGATION AREAS IN THE PUBLIC R.O.W. SHALL BE MAINTAINED BY:

THE LANDSCAPE AREAS SHALL BE MAINTAINED FREE OF DEBRIS AND LITTER AND ALL PLANT MATERIAL SHALL BE MAINTAINED IN A HEALTHY GROWING CONDITIONISES. SEED OF DEAD PLANT MATERIAL SHALL BE SATISFACTORILLY TREATED OR REPLACED PER THE CONDITIONS OF THE PERMIT."

"IF ANY LANDSCAPE MATERIAL OR IRRIGATION SYSTEMS ARE DAMAGED DURING CONSTRUCTION, THEY SHALL BE REPLACED AND REPAIRED IN-KNO"

"A MINIMUM ROOT ZONE OF 40SF IN AREA SHALL BE PROVIDED FOR ALL TREES. THE MINIMUM DIMENSION FOR THIS AREA SHALL BE 5 FEET, PER SMDC 142.0403(B)(5)."

EXISTING TREES TO REMAIN ON SITE WITHIN THE AREA OF WORK WILL BE PROTECTED IN PLACE. THE FOLLOWING PROTECTION MEASURES WILL BE PROVIDED:

1. A BRIGHT YELLOW OR ORANGE TEMPORARY FENCE WILL BE PLACED AROUND EXISTING TREES AT THE DRIP LINE. 2. STOCKPILING, TOPSOIL DISTURBANCE, VEHICLE USE, AND MATERIAL STORAGE OF ANY KIND IS PROHIBITED WITHIN THE DRIP LINE.

3. A TREE WATERING SCHEDULE WILL BE MAINTAINED AND DOCUMENTED DURING CONSTRUCTION.

4. ALL DAMAGED TREES WILL BE REPLACED WITH ONE OF EQUAL OR GREATER SIZE.

"MULCH: ALL REQUIRED PLANTING AREAS AND ALL EXPOSED SOIL AREAS WITHOUT VEGETATION SHALL BE COVERED WITH MULCH TO A MINIMUM DEPTH OF 2 INCHES, EXCLUDING SLOPES REQUIRING REVEGETATION PER SMICH 120,411.

*Tree root barriers shall be installed where trees are placed within 5 feet of public improvements incloding walks, curbs, or street parsents or where new public improvements are placed adjacent to existing trees. The root barrier will not warp around the root ball "places clearly dentify the installation of root barriers in the locations subject to these conditions fer 142,0403(8).

"TREES SHALL BE MANITANED SO THAT ALL BRANCHES OVER PEDESTRIAN WALKWAYS ARE 6 FEET ABOVE THE WALKWAY GRADE AND BRANCHES OVER VEHICULAR TRAVEL WAYS ARE 16 FEET ABOVE THE GRADE OF THE TRAVEL WAY, PER SDMC 142.0403(b)(10)"

"IF ANY REQUIRED LANDSCAPE INDICATED ON THE APPROVED CONSTRUCTION DOCUMENT PLANS IS DAMAGED OR REWORD DURING DEMOLITION OF CONSTRUCTION, IT SHALL BE REPARED AND/OR REPLACED M-HAND AND COUNTAINS TO THE PER THE APPROVED DOCUMENTS TO THE SATISFACTION OF THE DEVELOPMENT SERVICES DEPARTMENT WITHIN 30 DAYS OF THE DAMAGE."

PLANTING LEGEND

	SHRU	BS and VINES						
SYMBOL	KEY	BOTANICAL/ COMMON NAME	REMARKS	SIZE	QTY.	DETAIL	MATURE HxW	WUCOLS REG-RING
$\odot$	CAL LIT	CALLISTEMON "LITTLE JOHN" DWARF BOTTLE BRUSH		5 gal	11	к	3' × 5'	3-L
	PHO ATR	PHORMIUM T. "ATROPURPREUM" RED FLAX		5 gal	3	к	6' x 5'	3- <b>M</b> /L
~~~	FIC PUM	FICUS PUMILA CREEPING FIG		1 gal	9	L	SPREADS TO 10'+	3-M

MULCH BARE GROUND BETWEEN ALL SHRUBS AND TREES 3" DEEP, BETWEEN GROUND COVERS 1-1/2" DEEP- USE PARTIALLY COMPOSTED, NITROGEN STABILIZED TREE TRIMMINGS. 0-2 INCH SCREENED COMPOST OR PRE- APPROVED EQUAL.



SUITE 206 SAN DIEGO, CA 92121

-PLANS PREPARED BY:-



-CONSULTANT: -

Smartlink.jpg

	FAX	(: (949) 387-1275	
LNO.	DATE:	- DESCRIPTION:	_BY:-
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SD06358 **26TH & NEWTON**

2393 NEWTON AVENUE SAN DIEGO, CA 92113

-SEAL: -




-SHEET TITLE: -

PLANTING PLANS

-SHEET NUMBER: -

PLANTING PLANS

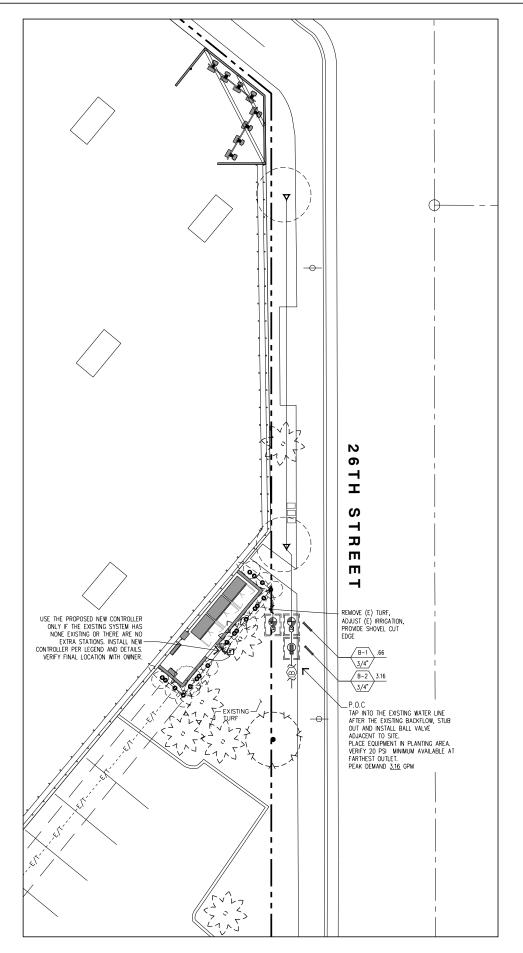

NOTES FOR MODIFYING EXISTING SYSTEMS

THIS PROJECT IS A MODIFICATION OF AN EXISTING SYSTEM. THE CONTRACTOR IS RESPONSIBLE FOR FIELD VERFICATION OF ALL EXISTING SITE CONDITIONS AND EQUIPMENT RELATED TO THIS SYSTEM. THIS VERFICATION SHALL INCLUDE, BUT IS NOT LIMITED TO: THE EXISTING PRESURE AND FOM WANDLABLE, THE MAINLES SEE AND LOCATION, THE EXISTENCE, LOCATION AND FUNCTION OF VALVES, MASTER VALVES, BACKFLOW AND CONTROLLER. CONTRACTOR SHALL NOTIFY THE O.A.R. (OMMER'S AUTHORIZED REPRESENTATIVE) AMMEDIATELY OF ANY DISCREPANCIES AND/OR CONFLICTS BETWEEN THE FIELD VERFICATION AND THE DRAWNGS.

WATER MISTS EPROVIDED TO ALL PLANT MATERIAL DURING AND AFERE CONSTRUCTION. THE TIMING AND AMOUNT OF WATER APPLIED SHALL MANTAIN THE VECETATION IN A HEALTHY, DISCASE RESISTANT CONDITION.

THE CONTRACTOR SHALL CUT, CAP AND OR DIVERT IRRIGATION LINES PRIOR TO ANY SITE DEMOLITION OR EXCAVATION IN ORDER TO PRESERVE WATERING TO THE REMAINING SITE AREAS DURING AND AFTER CONSTRUCTION.

THE CONTRACTOR SHALL ADD NEW HEADS TO MATCH THE EXISTING SYSTEM AND ADJUST/ RELOCATE EXISTING SPRINKLER HEADS TO ACCOMMODATE THE PROPOSED INSTALLATION AND INSURE 100% COVERAGE OF THE EXISTING AND NEW PLANTINGS. NEW HEADS WAY HE ADDOED IN ONE OF THE OLDIONNOW MAY.

COUNCET TO AN EXISTING LATERAL LINE PROVIDING SIMILAR WAITERING REQUIREMENTS AS THE PLANT MATERIAL PROPOSED AND DOE NEW HEADS TO MATCH THE EXISTING HEADS, OR THE HEADS THAT HAVE BEEN REMOVED.

- CONNECT TO THE PRESSURE MANUNE* OF THE EXISTING IBRIGATION SYSTEM AFTER THE EXISTING BACKFLOW DEVICE AND RUN A CONTROL WIRE FROM THE EXISTING CONTROLLER TO THE NEW VALVE(S), ONLY POSSIBLE IF THERE ARE AVAILABLE STATION(S) ON THE EXISTING CONTROLLER OR THE CONTROLLER'S AVAILABLE STATIONS CAN BE INCREASED (UPGRADED).
- CONNECT TO THE EXISTING IRRIGATION WATER SOURCE* OR MAINLINE* AND PROVIDE A NEW BACKFLOW DEVICE AND AUTOMATIC CONTROLLER TO CONTROL. THE VALVES.


DO NOT EXCED THE MAXIMUM CALLONS PER MINUTE AN EXISTING PIPE CAN PROVIDE (FLOW VELOCITY SHALL NOT BE GREATER THAN 5 FEET PER SECOND).

THE CONTRACTOR SHALL VERIFY IF THE EXISTING SYSTEM USES A MASTER VALVE - ANY NEW VALVES MUST BE CONNECTED BY WIRE TO THE MASTER VALVE AND CONTROLLER.

IRRIGATION LEGEND

SYMBOL	DESCRIPTION	REMARKS	DETAIL
М	EXISTING WATER METER AND SERVICE LINE	E (VERIFY SIZES AND FUNCTION IN THE FIELD)	
	EXISTING BACKFLOW PREVENTER (VERIFY	SIZES AND FUNCTION IN THE FIELD)	
₩	NIBCO T580A BALL VALVE (LINE SIZE)		В
	RAIN BIRD XCZF-PRF SERIES CONTROL ZON FILTER. INSTALL IN SHRUB BEDS WHEREVER	NE ASSEMBLY WITH REMOTE CONTROL LOW FLOW DVF VALVES AND PRF PRESSURE REGULAT R POSSIBLE IN RECTANGULAR VALVE BOX.	TING D
<u></u>	RAINBIRD ESP-SMTe CONTROLLER (4 STATI PROVIDE AND INSTALL RAIN SWITCH AND A SENSOR TO HAVE CLEAR 'VIEW' OF SKY USE NEW CONTROLLER ONLY IF THE EXISTII		A
	PVC WATER PIPE CL. 315 (MAINLINE 2" A PVC WATER PIPE SCH. 40 (MAINLINE 1-1)	/2" AND SMALLER)	
	PVC WATER PIPE CL. 200 3/4"-1-1/2"	•	
	ALL STREET OR DRIVE CROSSINGS	2X DIA. OF PIPE OR WIRE BUNDLE, INSTALL WHERE SHOWN AND	
SPRINKI	ER HEADS		

Q	S'	YMB0 H	ТТ	TQ	F	DESCRIPTION	Q	ī	DISCHA	ARGE - TT	GPM TQ	F	PSI	RADIUS	PRECIP RATE	DETA
				0		RAINBIRD PFR-FRA SERIES POLY-FLEX RISER AND ADAPTER WITH COMPENSATING MODULES: RAINBIRD PC-05-1032 OUTLETS FOR SHRUBS (2) PER PLANT	ONE (OF THE	FOLLOW	ING PF		GPH				E
				$\mathbf{\nabla}$		RAINBIRD PC-10-1032 OUTLETS FOR TREES (2) PER PLANT					10.	O GPH				Ε

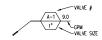

GENERAL WATERING GUIDELINE AS FOLLOWS: WARM WEATHER- FILL BASIN 2X/ WEEK COOL WEATHER- FILL BASIN 1X/ WEEK

CONTRACTOR SHALL CHECK SOL MOSTURE AT LEAST WEEKY WITH MOSTURE PROBE SAMPLE THE ROOTBALL AND SURROUNDING SOLL SOLL SHOULD BE MOST THROUGHOUT THE SOLL PROFILE. THE ROOTBALL MUST MOT BE ALLOWED TO DRY OUT OR BE ALLOWED TO STY OF THE STANDARD WATER—EVER.



SCALE: 1/8"=1'-0"



SAN DIEGO, CA 92121

-- PLANS PREPARED BY: --



-CONSULTANT: -



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rNO	DATE:	—DESCRIPTION:	-BY:-					
1	08/26/14	90% ZONING	SA					
2	09/18/14	CLIENT REVISIONS	SA					
3	10/31/14	100% ZONING	EVT					
4	04/20/15	CLIENT REVISION	EVT					

SITE INFORMATION: -

SD06358 **26TH & NEWTON**

> 2393 NEWTON AVENUE SAN DIEGO, CA 92113



-SHEET TITLE: -

IRRIGATION PLANS

-SHEET NUMBER: -

I. GENERAL

THE OWNER OR LESSEE WILL ENGAGE A MAINTENACE CONTRACTOR FOR THE MAINTENANCE OF THE SITE LANDSCAPE FOR THE LEFE OF THE LEASE.

MAINTENANCE CONTRACTOR SHALL FURNISH ALL SUPERVISION, LABOR, MATERIALS AND EQUIPMENT NECESSARY FOR THE COMPLETE MAINTENANCE OF ALL LANDSCAPE AREAS. ALL LANDSCAPE AREAS SHALL BE WATERED AS NECESSARY FOR THE PROPER DEVELOPMENT AND MAINTENANCE OF THE VECETATION.

PLANT MATERIALS SHALL BE MAINTAINED IN A HEALTHY AND VIGOROUS CONDITION, IRRIGATION AND DRAINAGE SYSTEMS KEPT IN GOOD WORKING ORDER, AND THE CENERAL SITE KEPT CLEAN AND WEED FREE.

MANIENANCE CONTRACTOR SHALL ROUTINELY CHECK FOR BLOCKED DRAIN INLETS, AND KEEP SWALES FREE OF LEAVES AND OTHER CEBRS.

OTHER DEBMS.

ALL LITTER AND TRASH INCLUDING WEEDS, LEAVES, BOTTLES AND OTHER DEBMS SHALL BE REMOVED FROM ALL AREAS OF THE SITE AND DISPOSED OF OFF-SITE. MAINTENANCE CONTRACTOR SHALL REPAIR OR REPLACE ALL DEAD, DAMAGED OR DISEASED PLANT MATERIAL.

A QUALIFIED PERSON SHALL BE COMPLETEIRESPONSIBLE FOR OPERATING THE IRRIGATION S STEMS, WITH THE DUTIES OF ADJUSTING CONTROLLERS, OBSERVING THE EFFECTIVENESS OF THE IRRIGATION S STEM, AND MAKING MINOR ADJUSTMENTS TO

THE IRRIGATION SYSTEM SHALL BE MAINTAINED FOR OPTIMUM PERFORMANCE. THIS INCLUDES CLEANING AND ADJUSTING ALL SPRINKLER HEADS AND VALVES FOR PROPER COVERAGE.

A CHART SHALL BE MAINTAINED TO RECORD CURRENT IRRIGATION PROGRAMS, INCLUDING DAY, TIME, AND LENGTH OF WATERING FOR EACH STATION AND PROGRAM FOR EACH CONTROLLER. INSPECTIONS OF THE IRRIGATION'S STEM, IN OPERATION, SHALL BE MADE WEEKLY DURING SUMMER MONTHS, APRIL THROUGH OCTOBER, AND BI-WEEKLY NOVEMBER THROUGH MARCH, TO DETECT A MALFUNCTIONING OF THE SYSTEM.

CHECK FOR LEAKS OR WET SPOTS.

TURN ON EACH SYSTEM WITH THE CONTROLLER AND CHECK IT TO ENSURE THAT IT OPERATES CORRECTLY --OPENING AND CLOSING.
WISHALLY OBSERVE EACH SPRINGER HEAD IN NOZZEE FOR PROPER OPERATION, SPRAY PATTERN, PRESSURE AND WATER DISTRIBUTION.

A SOIL SAMPLING PROBE AND/OR A TENSIOMETER SHALL BE USED REGULARLY TO EVALUATE ACTUAL SOIL MOISTURE LEVELS AND IRRIGATION SCHEDULE.

CHECK AT LEAST WEEKLY TO MAKE SURE AREAS ARE NOT BEING OVER OF UNDER WATERD. ADJUST THE SCHEDULE AS NEEDED TO CORRECT FOR BIHER OF THESE STILATIONS. REST THE SCHEDULE ON OUR CONTROLLER AT LEAST MONTHLY, AT THIS TIME, CHECK THE TIME ON THE CONTROLLER TO MAKE SURE THAT IT IS CORRECT.

CHECK THE WATER BILL FOR EXCESSIVE CONSUMPTION. COMPARE MONTH TO MONTH AND YEAR TO YEAR, PAY SPECIAL ATTENTION TO LARGE FEE SWINGS.

LOOK AT THE GENERAL HEALTH AND "LOOK" OF THE PLANT MATERIAL.

MAKE DESIGN ADJUSTMENTS (ADDING/ DELETING OR MOVING OF HEADS, CHANGING NOZZLE TYPES, TRIMMING OR MOVING OF PLANT MATERIAL) SO THAT PROBLEMS CAN BE ELIMINATED INSTEAD OF TEMPORARILY FIXED.

ALL MALFUNCTIONING EQUIPMENT MUST BE REPAIRED PRIOR TO THE NEXT SCHEDULED IRRIGATION. ALL REPLACEMENT HEADS SHALL BE OF THE SAME MANUFACTURER, TYPE, AND APPLICATION RATES.

III. PLANTINGS

PALM TREE, TRIM FRONDS AND TIE FOR 30 DAYS WITH ORGANIC TWINE

AUGER 8" DIA. HOLE 6' DEEP OR

4" OBSERVATION STANDPIPE WITH REMOVABLE CAP.

6. MULCH LAYER

11 FINISH CRADE

8 ROOTBALL TRIMMED

7. 21 GRAM FERTILIZER TABLETS

NATIVE SOIL, SCARIFY 6"-10" OR COMPACTED BACKFILL SLOPE BOTTOM TO DRAIN

10. NATIVE GRADE OR COMPACTED

PALM TRUNK, TRIMMED AND SET VERTICAL


ALL AREAS MUST BE KEPT WED FREE, BY THE USE OF ORGANIC MULCHES, HAND REMOVAL CHEMICAL CONTROLS— NUMBER OF MUST BE REPLENSIVED AS MULCH DECOMPOSES.

FERTILIZER SHALL BE APPLIED AS NEEDED USING SLOW RELEASE, ORGANIC BASED MATERIALS IN APRIL AND OCTOBER. USE AS INDICATED BY SOILS TEST ANALYSIS.

GROUND COVERS BORDERING WALKS AND CURBS SHALL BE EDGED AS NECESSARY TO PROVIDE A CLEAN CRISP LINE. VINES SHALL BE KEPT "PINNED" TO ADJACENT WALLS AS NECESSARY AND TRIMMED TO CONTROL EXCESSIVE GROWTH, NOT ALLOWING VINE TO GROW OVER WINDOWS, DOORS, GATES OR OTHER ARCHITECTURAL ELEMENTS AND EQUIPMENT. TREE PRUNING SHALL BE PERFORMED AS NEEDED TO MAINTAIN A NATURAL APPEARANCE.

SHRUB PRUNING SHALL BE PERFORMED AS NEEDED TO MAINTAIN A NATURAL APPEARANCE. SHRUBS ARE INTENDED TO FILL THE PLANTING SPACE AS MUCH AS POSSIBLE. DO NOT POWER PRUNE SHRUBS INTO ODD TOPIARY SHAPES. TREES AND SHRUBS SHALL BE PRUNED TO CORRECT ANY STRUCTURAL DEFECTS, REMOVE SUCKERS, CRISS-CROSSING BRANCHES, DEAD AND DISEASED LIMBS AND FOLIAGE AND THINNING OF THE CROWN TO REDUCE WIND DAMAGE.

SPARSE GROUND COVER AREAS SHALL BE CHECKED FOR, AS THEY MAY INDICATE A FAILURE OF IRRIGATION S STEM OR THE NEED FOR FERTILIZER AND SOIL. AMENDMENT, BARE AREAS SHALL BE RE-PLANTED TO MATCH ORIGINAL DESIGN. 4" DIA PERFORATED PVC PIPE, DRAIN TOWARDS OBSERVATION STANDPIPE

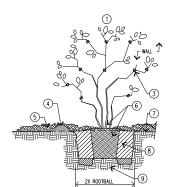

VINE PLANTING- SELF CLIMBING

SECTION VIEW - N.T.S.

2. NOT USED 3. ADHESIVE TIES

4. BASIN FORMED AROUND ROOTBALL BELOW FINISH GRADE

5. MULCH LAYER- EXTENDS PAST 6. TRUNK AND ROOTBALI

7. FINISH GRADE

8. AMENDED BACKFILL, (MIX PRIOR TO PLACING IN PLANT PIT) 9. NATIVE GRADE OR COMPACTED

1. MAINI TENTANCE CONTRACTOR SHALL INCLIDE IN THEIR BID FOR A 90 DAY MAINTENANCE PERIOD AFTER FINAL LANDSCAPE ACCEPTANCE BY THE OWNER. THIS MAINTENANCE SHALL INCLUDE, BUT IS NOT LIMITED TO, KEEPING ALL AREA WEED FREE, WATERED, PEST "AND USEASE," BEER AND ANY OTHER WORK INCESSARY FOR HEALITY, WOORQUS PLANT GROWTH AND APPEARANCE.

I GENERAL

THESE DRAWINGS ARE DIAGRAMMATIC, SHOWING INTENDED LOCATIONS AND RELATIONSHIPS OF PLANTING ELEMENTS. FINAL SITE CONDITIONS, ALTERED DURING CONSTRUCTION MAY REQUIRE ADJUSTMENTS TO THE LAYOUT. THE IRRIGATION SYSTEM SHALL BE FULLY OPERATIONAL, TESTED AND INSPECTED PRIOR TO PLANTING.

ANY SUBSTITUTIONS MUST BE APPROVED BY THE LANDSCAPE ARCHITECT OR O.A.R. PRIOR TO PURCHASE AND INSTALLATION.

II. PLANT MATERIAL/QUALITY ASSURANCE

THE CONTRACTOR SHALL MAINTAIN A QUALIFIED SUPERVISOR, FAMILIAR WITH THE TYPE OF WORK AND THE CONTRACT DOCUMENTS, ON SITE AT ALL TIMES DURING INSTALLATION OF THE WORK AND PRIMARY MAINTENANCE.

ALL PLANT MATERIAL SHALL BE SUBJECT TO THE APPROVAL BY THE OWNER'S AUTHORIZED REPRESENTATIVE (O.A.R.), THE CONTRACTOR SHALL SUBMIT A LIST OF AVAILABILITY FOR ALL BOXED TREES THIRTY (30) DAYS BEFORE SCHEDULED PLANTING FOR APPROVAL AT THE NURSERY BY THE O.A.R.

CONTRACTOR IS RESPONSIBLE FOR FURNISHING PLANT MATERIAL FREE OF PESTS OR DISEASES AND NORMAL IN FORM FOR THE SPECIES AND DESIGN CALLED FOR IN THE PLANS ONLY AS MANY PLANTS AS CAN BE PLANTED AND WATERED THAT SAME DAY SHALL BE DISTRIBUTED IN A PLANTING AREA

THE CONTRACTOR SHALL NOT INSTALL PLANT MATERIAL THAT IS WILTED OR HAS A DAMAGED ROOT BALL

CONTRACTOR SHALL NOT INSTALL TREES WITHIN TEN (10) FEET OF ROTORS/ IMPACT HEADS OR WITHIN THREE (3) FEET OF STREAM/ SPRAY HEADS.
ALL TIEZES WITHIN A SPECIES SHALL HAVE MATCHING FORM, SIZE AND TEXTURAL DENSITY.

SOIL AMENDMENT AND BACKFILL MX AS DESCRIBED HEREN ARE FOR BODDING PURPOSES ONLY. SPECIFIC AMENDMENTS AND FERFILIZER MILL BE SELECTED AND SPECIFIED AFTER ROUGH GRANDING IS COMPILET AND SOILS SAMPLES CAN BE TESTED. AMENDMENT AND FERTILIZER AMOUNT AND TYPE SHALL BE AS RECOMMENDED IN THE AGRONOM COSLS REPORTS.

WEED ABAITEMENT SHALL BEGIN AFTER ROUGH GRADING, CONTRACTOR TO IRRICATE PLANTING AREA FOR THREE (3) WEEKS OR UNILL SUFFICIENT WEED SEEDS HAVE GERMANTED, AFTER HINGH A CONTACT HERBEIDER IS SPRAYED BY A LICENSED PEST CONTROL APPLICATOR, IRRICATION IS STOPPED FOR FORTY—EIGHT (48) HOURS, THE DEAD WEEDS ARE THEN REMOVED AND AFTER SJOCH TIME AS INCESSARY FOR THE HERBEIDER TO DISSPARLE, PLANTING MAY BEGIN.

IV. SOIL PREPARATION NO SOIL PREPARATION SHALL BE DONE UNTIL ROUGH GRADING HAS BEEN APPROVED BY THE O.A.R.

CROSS RIP ALL PLANTING AREAS TO DEPTH OF TWELVE (12) INCHES AND UNIFORMLY BLEND THE FOLLOWING AMENDMENTS INTO THE TOP SIX (6) INCHES AS PART OF THE FINISH GRADING WORK.

PER THOUSAND (1,000) SQUARE FEET:
TWO HUNDRED (200) POUNDS "GRO-POWER PLUS" SIX (6) CUBIC YARDS NITROGEN STABILIZED ORGANIC AMENDMENT TWO HUNDRED (200) POUNDS AGRICULTURAL GYPSUM

V. FINISHED GRADING

AFTER ROUGH GRADING, WEED ABATEMENT AND SOIL PREPARATION ALL PLANTING AREAS SHALL BE SMOOTHLY GRADED. THE GRADE SHALL BE UNIFORM AND SMOOTH WITH NO ABRUPT CHANCE OF SURFACE.

GRADING SHALL PROVIDE FOR NATURAL RUNOFF WITHOUT LOW SPOTS, FLOW LINES SHALL BE ACCURATLEY SET BY INSTRUMENT AT TWO (2) PERCENT MINIMUM SLOPE. CONTRACTOR SHALL REMOVE FROM PLANTING AREAS ALL DEBRIS, WEEDS AND ROCK LARGER THAN ONE (1) INCH IN

DIAMETER FROM THE TOP SIX (6) INCHES OF SOIL AND DISPOSED OF OFF-SITE

VI. INSTALLATION

THE IRRIGATION SYSTEM SHALL BE FULLY OPERATIONAL, TREES INSTALLED AND A COVERAGE TEST COMPLETED PRIOR TO ANY CONTAINER OR GROUND COVER MATERIAL INSTALLATION. EXCAVATION FOR PLANTING SHALL INCLUDE THE STOCKPLING OF TOPSOIL FROM WITHIN AREAS TO BE EXCAVATED FOR TRENCHES TREE HOLLS, PLANT PHIS AND BEDS. ALL EXCAVATED PLANTING HOLES SHALL HAVE VERTICAL, SCARFED SDES, TWOC (2X) T

EXCESS SOIL GENERATED FROM THE EXCAVATIONS AND NOT USED AS BACKFILL OR IN ESTABLISHING FINAL GRADES SHALL OF REMOVED PHOM HE SHE.

NESPECT ROTTERLA AND GENTLY LOOSEN OR UNTANGE MATTED ROOTS, DO NOT CRACK ROOTBALL REPLACE ANY PLANTS WITH ROOTS GROUND. THE ROOTBALL

THE CROWN AREA OF TREES AND SHRUBS SHALL BE 2" HIGHER AFTER SETTLING, THAN ADJACENT FINISH GRADE.

THE APPROVED BACKFILL FOR PLANT PITS SHALL CONSIST OF THE FOLLOWING MIX. PLANT PITS SHALL BE FILLED TO THE REQUIRED GRADE AND THOROUGHLY SETTLED BY WATER APPLICATION AND TAMPING.

PER CUBIC YARD OF MIX: UNIFORMLY BLENDED.
SIX (6) PARTS BY VICLUME ON-SITE SOIL or NON SALINE, NON SODIC, LOW BORON CONTENT SANDY TEXTURED TOP SOL FOUR (4) PARTS by VICLUME NITROCEN STABILIZED ORGANIC AMENDMENT THENTY (20) POUNDS "EXPL-POWER PLUS"

TWENTY (20) POUNDS AGRICULTURAL GYPSUM

BACKFILL PIT HALFWAY THEN PLACE "GRO-POWER" SEVEN (7) GRAM OR "AGRIFORM" TWENTY ONE (21) GRAM SLOW RELEASE PLANTING TABLETS SPREAD EVENLY AROUND ROOTBALL. THE NUMBER OF TABLETS PER PLANT SHALL BE PER THE MANUFACTURER

UNTIE VINES AND REMOVE ALL STAKES AND TRELLISES THEN SECURELY FASTEN AND TRAIN AGAINST WHATEVER STRUCTURE NEXT TO WHICH THEY ARE PLANTED. TREES MUST BE STAKED AND/OR GUYED AT THE TIME OF PLANTING.

LAY SOD WITHIN TWO (2) DAYS OF DELIVERY AND DO NOT STORE IN HOT SUN. SET IN A STAGGERED PATTERN ON PRE-IRRIGATED MOIST GROUND AND SET FIRMLY AGAINST OTHER SOD PIECES. WATER THOROUGHLY AFTER PLANTING UNLESS NOTED OTHERWISE, CONTRACTOR SHALL PLANT GROUND COVERS IN STRAIGHT ROWS, EVENLY SPACED IN A TRIANQULAR PATTERN AT THE INTERVALS LISTED IN THE DRAWINGS.

AFTER ALL PLANTING IS COMPLETED, TOP DRESS ALL LANDSCAPED AREAS, EXCLUDING TURF, WITH A 2" LAYER OF SINGLE GRIND SHREDDED BARK MULCH. THIS LAYER IS IN ADDITION TO SOIL AMENDMENT MATERIALS. UNLESS DIRECTED OTHERWISE BY THE O.A.R., PRUNE ONLY TO REMOVE DEAD OR BROKEN BRANCHES AND SUCKER GROWTH.

V11. GUARANTEE

COMPACTIVE SHALL PROVIDE A NINETY (90) DAY CUARANTEE FOR ALL PLANTS EXCLUDING TREES WHICH SHALL BE CUARANTEED FOR ONE IT OF FULL YEAR DURING THE GUARANTEE PERIOD THE CONTRACTOR SHALL REPLACE, IN A TIMELY MANARIE, AND YPLANTS THAT ARE UNDELITH, MISSING OF DEAD, THIS CUARANTEE SHALL NOT INCLUDE DAMAGE TO GROUND COVER FROM EXCESSIVE RAIN RUN-OFF AND EXTREME WINDS. SUCH "NATURAL" DAMAGE SHALL BE REPARED FOR TIME AND MATERIALS.

A. THE LANDSCAPE ARCHITECT WILL INTERPRET THE MEANING OF ANY PART OF THE PLANS AND SPECIFICATIONS ABOUT WHICH ANY MISUNDERSTANDING MAY ARISE, AND HIS DECISION WILL BE FINAL.

B. THE CONTRACTOR SHALL OBTAIN CLARIFICATION TO QUESTIONS RELATIVE TO THE DRAWING BEFORE SUBMITTING A BID.

THE CONTRACTOR SHALL PROVIDE ALL LABOR, MATERIALS, EQUIPMENT AND LABOR NECESSARY TO COMPLETE THE WORK SHOWN ON THE DRAWINGS.

THE CONTRACTOR SHALL CARRY NECESSARY CAUFORNIA STATE CONTRACTORS LICENSE OR CERTIFICATE FOR TYPE OF WORK LISTED, SUCH AS C-27.

THE CONTRACTOR SHALL CARRY ALL NECESSARY COMPENSATION AND LIABILITY INSURANCE TO COVER HIS WORKMEN AND WORK TO FULLY PROTECT THE OWNER FROM ANY POSSIBLE SUIT OR LIEN.

THE CONTRACTOR SHALL MAINTAIN A QUALIFIED SUPERVISOR, FAMILIAR WITH THE TYPE OF WORK AND THE CONTRACT DOCUMENTS, ON SITE AT ALL TIMES DURING INSTALLATION OF THE WORK AND PRIMARY MAINTENANCE.

THE CONTRACTOR SHALL PROVIDE ALL NECESSARY PERMITS AND LICENSES AND ASSURE THAT ALL WORK TO BE PERFORMED MEETS ON EXCEDS ALL APPLICABLE CODES AND ORDINANCES OF PRIVATE OR COVERNMENTAL AGENCIES HAVING JURISDICTION OVER THE PROJECT.

JURISILIUM VICK IR: PROJECT. IT IS THE REPORTSHELT OF THE CONTRACTOR TO FAMILIARIZE HINGELF WITH ALL GRADE DIFFERENCES, LOCATION OF WALLS, RETAINING WALLS, STRUCTURES AND UNLIFIES. THE CONTRACTOR SHALL REPAIR OR REPLACE ALL ITEMS DAMAGED BY HIS WORK AT NO EXPENSE TO THE OWNER. HE SHALL COMBINATE HIS WORK WITH OTHER CONTRACTORS FOR THE COLTROL AND INSTALLATION OF PIPE SLEENES AND LATERAL LINES THROUGH WALLS LUCKER PROJUMNES, DRIVES AND PAVING, ETC.

THE CONTRACTOR SHALL USE ONLY NEW MATERIALS, OF BRANDS AND TYPES SHOWN AND DESCRIBED IN THESE DRAWINGS

THE CONTRACTOR SHALL EXERCISE CARE IN HANDLING, LOADING, UNLOADING AND STORING ALL EQUIPMENT AND MATERIALS. ALL MATERIALS AND EQUIPMENT THAT IS DAMAGED WILL BE RESPARED OF REPLACED AT THE OSCIPTION OF THE OWNER'S. AUTHORIZED REPRESENTATIVE (O.A.R.) AT NO EXPENSE TO THE OWNER.

K. THE CONTRACTOR SHALL PROTECT ALL PLANTING AREAS FROM EXCESSIVE COMPACTION WHEN TRUCKING MATERIALS AND EQUIPMENT TO AND WITHIN THE SITE.

L. THE CONTRACTOR SHALL BE RESPONSIBLE FOR ALL THEFTS OR DAMAGE TO MATERIALS ONCE DELIVERED TO JOB SITE.

THE CONTRACTOR SHALL BE RESPONSIBLE FOR COORDINATION BETWEEN SUB-CONTRACTORS AS REQUIRED TO ACCOMPUS-ALL CONSTRUCTION OFFERATIONS. ALL PIPMG, CONDUIT, SLEEVES, ETC. SHALL BE IN PLACE PRIOR TO INSTALLATION OF CONSTRUCTION ITEMS.

ALL PROGRESS INSPECTIONS SHALL BE COMPLETED BEFORE SUCCEDING WORK IS STARTED. ANY WORK COVERED UP BEFORE REQUIRED INSPECTIONS ARE COMPLETED WILL BE EXPOSED FOR REVIEW AT THE CONTRACTOR'S EXPENSE.

CLEAN-UP SHALL BE DONE AS EACH PORTION OF THE WORK PROCRESSES. REFUSE AND EXCESS DIRT SHALL BE REMOVED FROM THE SITE, ALL WALKS AND PAYING SHALL BE BROOMED AND ANY DAMAGE OCCURRING TO THE WORK OF OTHERS SHALL BE REPORTED TO GROBINAL CONDITION.

REFER TO THE SPECIFICATIONS FOR ADDITIONAL DETAILED INFORMATION.

THE CONTRACTOR'S WORK SHALL BE FULLY GUARANTEED FOR ONE (1) FULL YEAR FROM THE DATE OF ACCEPTANCE BY THE OWNER. ANY DETECTIVE MATERIALS OR POOR WORKWAINSHIP SHALL BE REPLACED OR CORRECTED AT NO COST TO THE OWNER.

UNLESS NOTED OTHERWISE ALL STRUCTURAL IMPROVEMENTS SHALL BE INSTALLED PRIOR TO IRRIGATION AND PLANTING OPERATIONS. S. IN THE CASE WHERE EXTRA WORK OR CHANGES WILL RESULT IN ANY INCREASED COSTS OVER THE CONTRACT FEE, THE CONTRACTOR SHALL FIRST RECEIVE THE OWNER'S EXPRESSED WRITTEN APPROVAL FOR SUCH ADDITIONAL FUNDS PRIOR PURCHASING METERIALS OR BOOK THE WORK/CHANGES.

MULCHED AREA 24 BASIN 12"-15 9 SCARIFY SIDES OF PLANT PIT

SHRUB, SET TOP OF ROOTBALL 1" ABOVE FINISH GRADE, TYP.

2"-3" DEEP SHALLOW BASIN 24" DIA. FORMED AROUND ROOTBALL

3. MULCH LAYER- 48" DIA. AREA AROUND PLANTINGS

4. FERTILIZER TABLETS

6. NATIVE SOIL, SCARIFY 6"-10"

7. NATIVE GRADE

8. FINISH GRADE

10. AMENDED BACKFILL, USE SAME SOIL REMOVED FROM PLANT PIT. REMOVE ROCKS BREAK-UP CLODS, ADD AMENDMENTS PER CURRENT SOILS REPORT SPECIFICATIONS

PLANTING PITS

SECTION VIEW - N.T.S



SAN DIEGO, CA 92121

-PLANS PREPARED BY: -



-CONSULTANT: -



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NO. TO DATE: --- DESCRIPTION: ⊤BY:-08/26/14 SA 90% 70NING 2 09/18/14 CLIENT REVISIONS SA .3 10/31/14 100% 70NING EVT 04/20/15 CLIENT REVISION EVT

-SITE INFORMATION:

SD06358 26TH & NEWTON

2393 NEWTON AVENUE SAN DIEGO, CA 92113

-SEAL



-SHEET TITLE: -

PLANTING DETAILS AND **NOTES**


-SHEET NUMBER:

(14)-

(M) PALM TREE PLANTING

-(2)

6

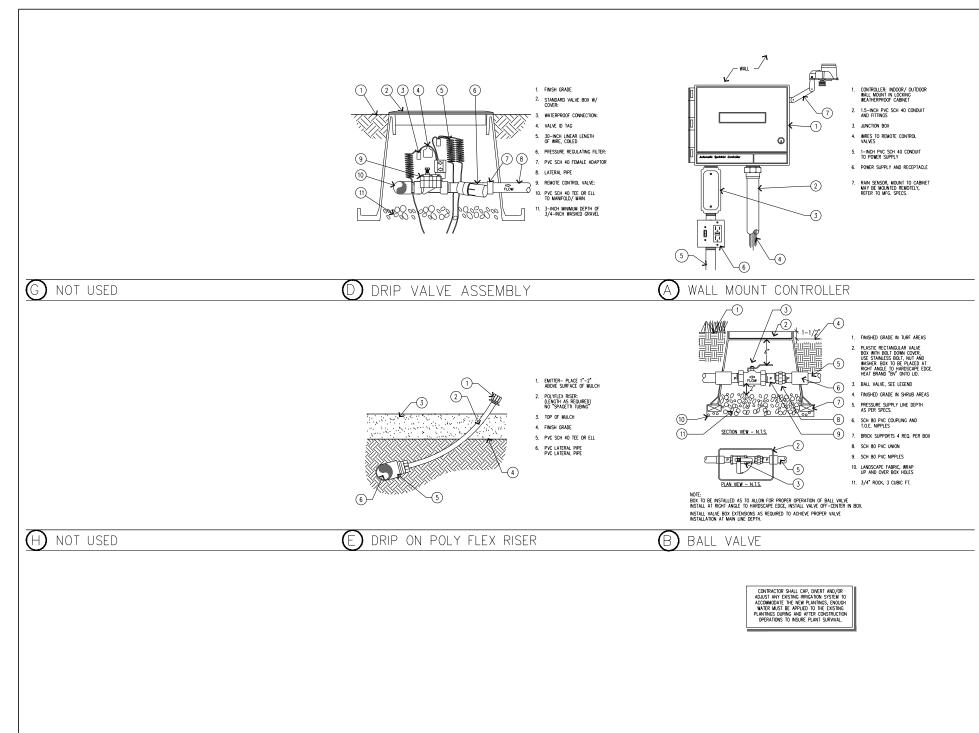

(I) NOT USED (F) NOT USED (C) NOT USED IRRIGATION SPECS.

I. GENERAL CONDITIONS
THE CONTRACTOR SHALL FELD VERIFY THE EXISTING WATER PRESSURE (P.S.L) AND AVAILABLE FLOW (C.P.M.) PRIOR TO CONSTRUCTION, NOTIFY THE OWNER'S AUTHORIZED REPRESENTATIVE (O.A.R.) MINEDIATELY OF ANY DISCREPANCES BETWEEN THE ACTUAL PRESSURE AND FLOW AVAILABLE WITH THOSE SHOWN IN THESE DRAWINGS.
THIS OSIGN IS DIAGRAMABLE, ALL, PIPMS, TRAVES, ETC., SHOWN WITHIN PAYED AREAS IS FOR DESIGN CLARITY ONLY AND SHALL BE INSTALLED IN PLANTING AREAS WHERE POSSIBLE.

SYMAL BE INSTALLED IN PLANING AREAS WHERE POSSIBLE.

ON ON HILIPLY INSTALL HE SPRINKER SYSTEM AS SYMMN ON THE DRAWNGS WHEN IT IS OBVIOUS IN THE FIELD THAT THERE ARE UNKNOWN OBSTRUCTIONS, GRADE DEFERENCES OR DEFERENCES IN THE AREAS SZE AND LAYOUT THAT WARE NOT CONSIDERED IN THE ORDINAL DESIGN ADDIT FLAT OR OR OR STRUCTIONS AND DEFERENCES INMIDITALEY.

IN THE EVENT THAT THE NOTIFICATIONS REQUIRED BY THESE NOTES ARE NOT PERFORMED, THE IRRIGATION CONTRACTOR SHALL ASSUME RESPONSIBILITY FOR ANY REVISION NECESSARY.

II. QUALITY ASSURANCE AND REQUIREMENTS

THE CONTRACTOR SHALL MAINTAIN A QUALIFIED SUPERVISOR, FAMILIAR WITH THE TYPE OF WORK AND THE CONTRACT DOCUMENTS, ON SITE AT ALL TIMES DURING INSTALLATION OF THE WORK AND PRIMARY MAINTENANCE. ALL SPRINKLER COUPMENT NOT OTHERWISE DETAILED OR SPECIFIED SHALL BE INSTALLED PER THE MANUFACTURER'S RECOMMENDATIONS.

III. MATERIALS/ INSTALLATION

THE MAINLINE PIPE SHALL BE INSTALLED AND ROUTED TO AVOID UNFORSEEN OBSTACLES BELOW GRADE. TREE LOCATIONS TAKE PRIORITY OVER IRRIGATION PIPING. STAKE TREE LOCATIONS PRIOR TO TRENCHING.

THE AUTOMATIC CONTROLLER AND THE BACKFLOW DEVICE SHALL BE FACTORY ASSEMBLED AND INSTALLED PER

FINAL LOCATION OF THE AUTOMATIC CONTROLLER AND THE BACKFLOW DEVICE SHALL BE APPROVED BY THE O.A.R. PRIOR TO NOTALLATION.

INSTALLATION.

THE 120 VOLT ELECTRICAL CONNECTION FOR THE CONTROLLER SHALL BE FURNISHED BY OTHERS. THE CONTRACTOR SHALL COORDINATE THE ROUTE OF THE ELECTRICAL SERVICE TO THE APPROVED CONTROLLER LOCATION WITH THE GENERAL CONTRACTOR. THE SERVICE TO THE CONTROLLER JUSTICAL SERVICE TO THE CONTROLLER JUSTICAL SERVICE TO THE CONTROLLER SHALL MAKE THE FINAL CONNECTIONS TO THE AUTOMATIC CONTROLLERS FROM THE PROVIDED JUNCTION BOX.

ALL WIRES FROM THE CONTROLLER TO THE AUTOMATIC VALVES SHALL BE COPPER, DIRECT BURIAL, MINIMUM #14 GUAGE, NISTALL IN THE SAME TRENCH AS THE MANUINE WHERE POSSBILE. COMMON WIRE TO BE MINTE IN CO.OR. CONTROL WIRES TO BE A DIFFERNT COLOR FOR EACH CONTROLLER USED. BUNDLE AND TAPE WIRES A MINIMUM OF TEN (10) FEET ON CENTER.

CONIEK.

THE CONTRACTOR SHALL RUN THREE (3) SPARE WRES AND ONE (1) COMMON WREE FROM THE CONTROLLER TO EACH END OF THE MAIN LINE FOR FULLINE USE. EXTEND THE WRES AN EXTRA TEN (10) FEET, MAKE A COLL AND PLACE IN A RECTAMBULAR PLUE DOL LABLE. THE LID "SW".

ALL MANNIE PIPING AND CONTROL WRES WINDER PAVING SHALL BE MISTALLED IN STRAPART SLEEPES STANLINE SLEEPES STALL BE A MINIMUM OF TWICE (2). THE OMBOR SELECES OF THE WRES ARE NOT BOUND IN PIPE. MINIMUM COVERAGE FOR SLEEVES SHALL BE INVENTY FOUR (24) NICHES FOR SLEEVED LATERAL UNES. THRETY (3) INCHES FOR 120 VOLT WIRRING IN COMPOUNT AND THRETY SIX (36) NICHES FOR SLEEVED MAINLINE AND/OR CONTROL WRITER.

ALL LATERAL LINE PIPING UNDER PAVEMENT NOT SLEEVED, SHALL BE PVC SCHEDULE 40 AND SHALL BE INSTALLED PRIOR TO

DIG TRENCHES STRAIGHT AND SUPPORT PIPE CONTINUOUSLY ON BOTTOM. TRENCH MUST BE FREE OF ROCKS, DEBRIS OR ANY SHARP OBJECTS, SNAKE PLASTIC PIPE IN TRENCH, MINIMUM COVERAGE FOR MAINLINE SIZES 1-1/2" AND SMALLER IS EIGHTEEN (18) INCHES, FOR SIZES 2" AND LARGER COVERAGE IS TWENTY FOUR (24) INCHES, FOR LATERAL LINES TWELVE (12) INCHES, 120 VOLT WIRING IN CONDUIT THIRTY (30) INCHES AND LOW VOLTAGE CONTROL WIRE TWELVE (12) INCHES MINIMUM OR THE SAME DEPTH AS THE MAINLINE. DO NOT INSTALL ANY PIPE OR WIRING DIRECTLY OVER ANOTHER.

BALL VALVES, CATE VALVES, REMOTE CONTROL VALVES (EXCEPT FOR ANTI-SPHON TYPE) AND QUICK COUPLERS SHALL BE INSTALLED IN BELOW GRADE LOCKABLE 'BOXES' MANUFACTURED BY AMETIC OR CARSON. USE ROUND BOXES FOR CATE VALVE, BALL VAVES AND QUICK COUPLERS AND RECTANGULAR BOXES FOR REMOTE CONTRO

SET VALVE BOXES ONE (1) INCH ABOVE FINISH GRADE, SET VALVES AT SUFFICIENT DEPTH TO PROVIDE APPROPRIATE CLEARANCE BETWEEN THE COVER AND THE VALVE. MISTALL IRRICATION EQUIPMENT SO THE VALVE BOXES OF IT WITHOUT UNTING THE WALLS OF THE VALVE BOXES. OUT VALVE BOXES SHOT AND EXPECTED AND COST TO THE OWNER. THE CONTRACTOR SHALL LOCATE ALL VALVES IN SHRUB AREAS, UNLESS DIRECTED OTHERWISE BY THE O.A.R. ALL SPRINKLER HEADS SHALL BE SET PERPENDICULAR TO FINISH GRADE.

INSTALL ALL SPRINKLERS ON RISERS TWELVE (12) INCHES AWAY FROM WALLS AND STRUCTURES. ALL POP-UP THE SPRINKLER HEADS INSTALLED IN SPRING AND GROUNDCOVER AREAS SHALL BE INSTALLED SO THAT THE TOP OF THE SPRINKLER HEAD IS ONE (1) MICH ABOVE FINSHS GRADE.

ALL POP-UP TYPE SPRINKLER HEADS INSTALLED IN TURF AREAS SHALL BE INSTALLED SO THAT THE TOP OF THE SPRINKLER HEAD IS FLUSH WITH ADJACENT PAVING.

AFTER RECEIVING NOTIFICATION BY THE O.A.R., THE CONTRACTOR, WITHIN TEN (10) DAYS SHALL ADJUST ALL LAWN HEADS SO THAT THE TOP OF THE SPRINKLER HEAD IS ONE OURRIER $({\it M}_{\rm A})$ INCH ABOVE FINISH GRADE.

INSTALL ANTI DRAIN VALVES TO ELIMINATE LOW HEAD DRAINAGE. ANTI DRAIN VALVE (ANY) UNITS MAY MOT BE REQUIRED ON ALL HEADS., PRIOR TO INSTALLATION, CONTRACTOR SHALL VERIFFY WITH ON SITE GRADES IF THERE IS AN ELEVATION OFFERENCE OF TWO (2) FEET OR MORE BETWEEN THE HIGHEST AND LOWEST SPRINKLER HEAD ON A SYSTEM, INSTALL THE ADV WHETER NECESSARY.

ALL SOLVENT WELD PVC PRESSURE LINES AND FITTINGS MUST RECEIVE PRIMER BEFORE SOLVENT WELDING.

IV. ADJUSTING AND TESTING THE SYSTEM

AFTER PIPELINE ASSEMBLY THE CONTRACTOR SHALL THOROUGHLY FLUSH THE SYSTEM, WITH OPEN ENDS ALL CAPPED

PRESSURE IEST FOR FOUR (4) HOURS AT 150 P.S.I.
AFTER COVERAGE AND PRESSURE IESTING THE CONTRACTOR SHALL INSTALL ALL IERMINAL FIXTURES AND PERFORM A
COVERAGE IEST.

COVERAGE LESS.

THE CONTRACTOR SHALL ADJUST ALL SPRINGER HEADS AND VALVES FOR OPTIMAN COVERAGE AND TO PREVENT OVERSPRAY. THIS SHALL INCLIDE THE LISE OF VARIABLE ARC NOZZLES (VAN) AND PRESSURE COMPENSATING SCREENS (PCS), THE SELECTION OF THE BEST DECREE OF ARC TO BIT HE SITE AND THROTTLING OF THE FLOW CONTROL AT EACH VALVE TO FROM THE OPTIMAN OPERATING PRESSURE FOR EACH SYSTEM.

THE ENTIRE SYSTEM SHALL BE IN FULL AUTOMATIC OPERATION FOR ONE SEVEN (7) DAYS PRIOR TO ANY PLANTING.

V. SUBMITTALS

JOURNILLALS.

HEND COMPLETION THE CONTRACTOR SHALL SUPPLY THE OWNER WITH A COMPLETE SET OF REPRODUCIBLE "AS-BUILT" DRAWNES. THESE AS-BUILTS SHALL SHOW THE LOCATIONS OF OLIP POINTS OF COMPLETON WALKS, CROSSINISS, DUICK COUPLERS AND OTHER MANINE. COMPONENTS IN DISCHOLUTED ACCURATELY FROM THE (2) PERMANENT STE DESECTION. ADDITION THE CONTRACTOR SHALL SUPPLY THE (2) CONTROLLER CHARTS SHOWING EACH VALVE'S COVERAGE AREA COLOR CODED TO THE COMPRESSOR SHOULD SHOW THE CONTROLLER SHALL SUPPLY THE (2) CONTROLLER SHALL SHOW THE CONTROLLER SHALL SUPPLY THE (2) CONTROLLER SHALL SHOW THE CONTROLLER SHALL SHOW THE COLOR CODED TO THE COMPRESSOR SHALL SHOW THE COLOR CODE TO THE COMPRESSOR SHALL SHOW THE CONTROLLER SHALL SHOW THE COLOR SHALL SHOW THE CONTROLLER SHALL SHOW THE COLOR SHAL

THE CONTRACTOR MUST ALSO PURNISH TWO (2) SETS EACH OF THE FOLLOWING, ANY SPECIAL VALVE OR SPRINKLER ADJUSTMENT TOOLS, KEYS FOR THE CONTROLLER ENCLOSURES, QUICK COUPLER KEYS AND ANY OPERATION MANUALS FOR THE COUPLENT INSTALLED.

VI. GUARANTEE

THE CONTRACTOR'S WORK SHALL BE FULLY GUARANTEED FOR ONE (1) FULL YEAR FROM THE DATE OF ACCEPTANCE BY THE OWNER, ANY DEFECTIVE MATERIALS OR POOR WORKNAMSHIP SHALL BE REPLACED OR CORRECTED AT NO COST TO THE OWNER.

VII. MAINTENANCE

MAINTELEMENCE.

A QUALIFIED SUPPRISOR SHALL BE RESPONSIBLE FOR OPERATING THE IRRIGATIONS SYSTEMS, ADJUSTING THE CONTROLLERS
AND OBSERVING THE EFFECTIVENESS OF THE IRRIGATION SYSTEM.

CHART ALL CONTROLLER PROGRAMS, RECORDING DATE, TIME, LENGHT OF WATERING FOR EACH STATION. RESET

CONTROLLER AT LEAST MONTHLY TO ACCOUNT FOR SEASONAL VARIATIONS.

CONTROLLER AT LEAST MATHET, TO ALLOCATE FOR SEASONAL VARIATIONS.

NEPCCT AND ADJUST THE ENTIRE REGISTROOT SYSTEM AND ADJUST APPLICATION APPLITATION OF THE REST OF THE YEAR. CHECK FOR LEAKS, WET AND DRY SPOTS, USE A MOSTURE SENSING DEVICE TO EVALUATE ACTUAL SOL. MOSTURE. OSSERVE MOZIZES FOR PROFER PATIENTS MOD PRESSURE.



SAN DIEGO, CA 92121

-PLANS PREPARED BY: -



-CONSULTANT: -



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_Γ NO	DATE:	DESCRIPTION:	⊤BY:-
1	08/26/14	90% ZONING	SA
2	09/18/14	CLIENT REVISIONS	SA
3	10/31/14	100% ZONING	EVT
4	04/20/15	CLIENT REVISION	EVT

SITE INFORMATION:

SD06358 **26TH & NEWTON**

2393 NEWTON AVENUE SAN DIEGO, CA 92113

-SEAL:



-SHEET TITLE: -

IRRIGATION DETAILS AND NOTES

-SHEET NUMBER: