LANDSCAPE ARCHITECT: STANTEC CONSULTING INC. ATTN: MARK LARUE

- 277 RANCHEROS DRIVE, SUITE 300 SAN MARCOS, CA 92069
- T. (760)891-3200 F. (760)891-3201

F. (760)891-3201

CIVIL ENGINEER: STANTEC CONSULTING INC. 277 RANCHEROS DRIVE, SUITE 300 SAN MARCOS, CA 92069 T. (760)891-3200

ESA / SOUTHERN CALIFORNIA REGIONAL ATTN: ERIC RUBY 9191 TOWNE CENTRE DRIVE, SUITE 340 SAN DIEGO, CA 92122 (858)638-0920

F. (858)638-0901

GEOTECHNICAL: NINYO & MOORE ATTN: TODD SCHMITZ **5710 RUFFIN ROAD SAN DIEGO, CA 92123** T. (858)576-1000 F. (858)576-9600

HYDROLOGY:

STANTEC CONSULTING INC. 19 TECHNOLOGY DRIVE **IRVINE, CA 92618** T. (949)923-6000 F. (949)923-6121


CONSTRUCTION INSPECTION

PARK CONSTRUCTION INSPECTION STAGES:

- 1. PRE-CONSTRUCTION MEETING
- 2. ROUGH GRADING AND DRAINAGE
- 3. IRRIGATION MAINLINE PRESSURE TEST 4. WIRING PRIOR TO BACKFILLING TRENCHES
- 5. HARDSCAPE AT TIME OF FINISHED STAKING AND LAYOUT
- 6. FINISH GRADING AND SOIL PREPARATION
- 7. IRRIGATION COVERAGE TEST (COVERAGE ONLY AS SHOWN ON THE PLAN)
- 8. PLANT MATERIAL (WHEN DELIVERED) AND PLACEMENT APPROVAL
- 9. PLAY GROUND INSPECTION (NONE REQUIRED)
- 10.PROJECT CONSTRUCTION 90% COMPLETE (DEVELOP PUNCH LIST AND SUBMIT RED-LINE AS-BUILTS).
- 11.90-DAY PLANT MAINTENANCE PERIOD. (THIS INSPECTION TO BE HELD WHEN THE PUNCH LIST ITEMS ARE COMPLETE, IF LAWN AREA IS SEEDED, IT IS A 120-DAY PLANT MAINTENANCE
- 12. FINAL WALK-THROUGH, ACCEPTANCE BY THE CITY. (CONTRACTOR TO SUBMIT FINAL APPROVED AS-BUILTS TO THE CITY.)


THE CONTRACTOR SHALL REQUEST CONSTRUCTION OBSERVATIONS BY THE RESIDENT ENGINEER NO LESS THAN FORTY-EIGHT HOURS IN ADVANCE.

CONTRACTOR SHALL BE CHARGED BY THE CITY FOR THE RESIDENT ENGINEER'S TIME AT REPRESENTATIVE'S CONTRACT RATE WHEN CONSTRUCTION OBSERVATIONS ARE CALLED FOR AND WORK IS NOT READY FOR OBSERVATION, OR THE APPOINTMENT IS NOT KEPT.

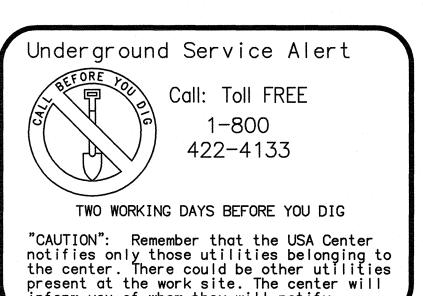

inform you of whom they will notify.

LOCATION MAP

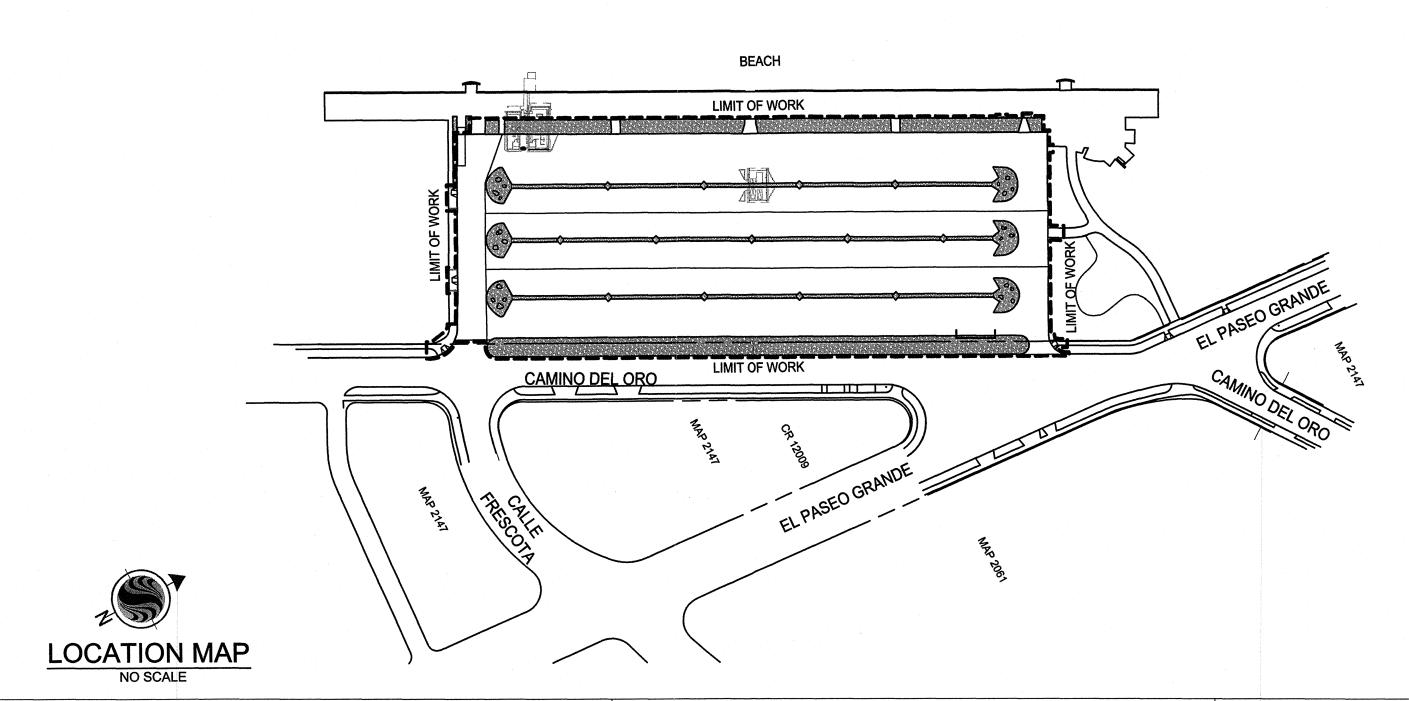

CALLE DEL ORO **VICINITY MAP** SAN DIEGO AVENIBA DE LA PLAYA

VICINITY MAP

PROJECT DATA

PROJECT ADDRESS: 8200 CAMINO DEL ORO **LA JOLLA, CA 92037**

LEGAL DESCRIPTION:

BLOCKS 28 & 37 OF LA JOLLA SHORES UNIT 2

SURVEY DATA:

CITY OF SAN DIEGO - ENGINEERING & CAPITAL PROJECTS INSTR: BROWN INDEX: 252-1689 DATE: 10/02/2008

W.O.: 121593

BASIS OF BEARINGS/ COORDINATES:

THE BASIS OF BEARINGS FOR THIS PROJECT WAS DERIVED FROM A PREVIOUS STATIC GPS SURVEY USING GPS 134 AND GPS 135 AS SHON ON R.OF S. 14492 I.E. S 18°04'39" W, NAD 83 FEET, ZONE 6 (EPOCH 91.35), UTILIZING RTK/GPS FIELD PROCEDURES WITH THE BASE STATION LOCATED AT AN AUTONOMOUS POSITION, CONSTRINING TO GPS 134, GPS 135.

NWBP LA JOLLA SHORES DR. & VALLECITOS, ELEV=18.984 MSL, BASED ON NGVD 29 FEET AS SHOWN IN THE CITY OF SAN DIEGO BENCH BOOK.

WATER DATA:

EXSITING WATER SUPPLY, METER, BACKFLOW PREVENTOR, PRESSURE REDUCER, ISOLATION VALVE AND ANY OTHER IRRIGATION RELATED EQUIPMENT LOCATED BETWEEN THE METER AND THE INDIVIDIAL VALVE IS NOT TO BE MODIFED.

SITE DATA:

AREAS ARE APPROXIMATE ESTIMATES ONLY RIVER ROCK MULCH: 1220 SF 4000 SF SHRUB AREA: PERMEABLE PAVING: 17900 SF **ASPHALT PAVING:** 93500 SF TOTAL ACRES: 3.6 ACRES

SHEET INDEX

-1	COVER SHEET	1
-2	GENERAL NOTES	2
	CIVIL	
:-1	DEMOLITION PLAN & NOTES	3
;-2	CONSTRUCTION PLAN	4
		-
:-3	CONSTRUCTION DETAILS	5
-4	PEDESTRIAN ACCESS DETAILS	6
-5	GRADING & DRAINAGE PLAN	7
-6	DRAINAGE DETAILS	8
:-7	INTERIM ADA ACCESS/STRIPING PLAN	9
:-8	STRIPING & SIGNAGE PLAN	10
	LANDSCAPE	
-1	IRRIGATION PLAN	11
-2 & L-3	PLANTING PLANS	12 & 13

REFERENCE DRAWINGS:

25502-D; 32673-D; 32873-D

DECLARATION OF RESPONSIBLE CHARGE:

I HEREBY DECLARE THAT I AM THE CIVIL ENGINEER FOR THIS PROJECT, THAT I HAVE EXERCISED RESPONSIBLE CHARGE OVER DESIGN OF THIS PROJECT AS DEFINED IN SECTION 6703 OF THE BUSINESS AND PROFESSIONS CODE, AND THAT THE DESIGN IS CONSISTENT WITH CURRENT STANDARDS. I UNDERSTAND THAT THE CHECK OF PROJECT DRAWINGS AND THE SPECIFICATIONS BY THE CITY OF SAN DIEGO IS CONFINED TO A REVIEW ONLY AND DOES NOT RELIEVE ME, AS ENGINEER OF WORK OF MY RESPONSIBILITIES FOR PROJECT DESIGN.

KEVIN BRANDT CA. RCE#54873 **EXPIRATION DATE: 6-30-10**

DATE

DESCRIPTION OF WORK:

ELEMENTS OF IMPROVEMENT INCLUDE: DRAINAGE MODIFICATIONS: CURB & GUTTER MODIFICATIONS: PAVER INSTALLATION: IRRIGATION REPAIR AND INSTALLATION; PLANT INSTALLATION AND OTHER ELEMENTS AS NOTED WITHIN THIS PLAN SET.



Stantec Consulting, Inc. 277 Rancheros Drive Suite 300 San Marcos, CA 92069

GREEN

OF CALIFORNIA

Tel. (760) 891-3200 Fax. (760) 891-3201 www.stantec.com

PLANS FOR THE CONSTRUCTION OF

KELLOGG PARK GREEN LOT

KEVIN BYRON BRANDT RCE 54873 EXP. 6-30-10 DATE WBS NO. B-00603

T-1

PERMIT:	PERMIT NO.
PERMIT:	PERMIT NO.
PERMIT:	PERMIT NO.
FUNDING: WBS NO. B-00603	SPEC. NO.

COVER SHEET CITY OF SAN DIEGO, CALIFORNIA

			ENGINEERING AND CAPITAL PROJECTS DEPARTMENT SHEET 1 OF 13 SHEETS				W.O. NO. 121593
	CONST	RUCTION CHANGE TABLE	APPROVED:				SUBMITTED BY: JEFF SORIANO
CHANCE		SHEET NUMBERS REVISED OR ADDED THIS CHANGE	FOR CITY ENGINEER	· .	DATE	·	ASSOCIATE ENGINEER
CHANGE	DATE	SHEET NUMBERS REVISED OR ADDED THIS CHANGE	DESCRIPTION	DRAWN BY	DATE	FILMED	WILLIAM MEREDITH
			ORIGINAL	STANTEC	<u> </u>		PROJECT ENGINEER
							CONTROL CERTIFICATION
							252-1689
Process of the Control							LAMBERT COORDINATES
			CONTRACTOR	DATE STARTE	D		35278- 1 -D

SHEET SIZE AND SCALE: "IF SHEET SIZE IS LESS THAN 24" X 36", IT IS A REDUCED PRINT SCALE ACCORDINGLY."

JONATHAN GOODMACHER, C.E.G. 2136

SPECIAL NOTES:

1. THE FOLLOWING NOTES ARE PROVIDED TO GIVE DIRECTIONS TO THE CONTRACTOR BY THE ENGINEER OF WORK. THE CITY ENGINEER'S SIGNATURE ON THESE PLANS DOES NOT CONSTITUTE APPROVAL OF ANY OF THESE NOTES. AND THE CITY WILL NOT BE RESPONSIBLE FOR THEIR ENFORCEMENT.

DATE:

- 2. PRIOR TO THE START OF CONSTRUCTION, THE CONTRACTOR SHALL EXAMINE ALL PLANS AND CONTRACT DOCUMENTS AND SHALL INSPECT THE CONDITIONS IN THE FIELD AND SHALL REPORT IN WRITING ANY DISCREPANCY THUS NOTED TO THE RESIDENT ENGINEER.
- 3. THE CONTRACTOR SHALL DESIGN, CONSTRUCT AND MAINTAIN ALL SAFETY DEVICES INCLUDING SHORING AND SHALL BE SOLELY RESPONSIBLE FOR CONFORMING TO ALL LOCAL, STATE AND FEDERAL SAFETY AND HEALTH STANDARDS, LAWS AND REGULATIONS.
- 4. ALL LABOR AND MATERIALS FOR THIS PROJECT SHALL BE FURNISHED AND INSTALLED BY THE CONTRACTOR, UNLESS OTHERWISE SPECIFIED.
- 5. ALL GRADING OPERATIONS INCLUDING BUT NOT LIMITED TO ROUGH GRADING, FINE GRADING, CONCRETE WORK, LANDSCAPING AND DRAINAGE DEVICES SHALL BE STAKED BY A CITY SURVEYOR.
- 6. THE CONTRACTOR SHALL BE RESPONSIBLE FOR IMPORTING AND/OR EXPORTING ALL MATERIAL AS REQUIRED TO PROPERLY GRADE THIS PROJECT TO THE FINISHED GRADES SHOWN HEREIN IN ACCORDANCE WITH THE APPROVED PLANS, SPECIFICATIONS AND THE SOILS ENGINEER'S (NINYO & MOORE) RECOMMENDATIONS.
- 7. THE CONTRACTOR SHALL TAKE PROTECTIVE MEASURES TO PREVENT THE ACCUMULATION OF MUD AND SILT ON PUBLIC STREETS, AND SHALL CONTROL DUST.
- 8. THE CONTRACTOR SHALL TAKE ALL NECESSARY PRECAUTIONS REQUIRED TO PROTECT ADJACENT PROPERTIES AND/OR FACILITIES DURING GRADING OPERATIONS. ANYTHING DISTURBED, DAMAGED, OR DESTROYED SHALL BE ADJUSTED, REPAIRED OR REPLACED TO THE CONDITION EXISTING AND TO THE SATISFACTION OF THE RESIDENT ENGINEER PRIOR TO GRADING AT THE CONTRACTOR'S EXPENSE.
- 9. ELEVATIONS AND CONTOURS SHOWN HEREON ARE TO FINISH GRADE UNLESS OTHERWISE NOTED. DURING GRADING. THE CONTRACTOR SHALL MAKE ALLOWANCES IN PAVED AREAS, AND LANDSCAPE AREAS TO ACCOMMODATE STRUCTURAL SECTIONS AND TOPSOIL LAYERS WHICH CONFORM TO THE THICKNESSES AS SHOWN ON THE ARCHITECTURAL AND LANDSCAPE DRAWINGS.
- 10. ALL GRADED SURFACES SHALL PROVIDE POSITIVE DRAINAGE AND PREVENT PONDING OF WATER. THE CONTRACTOR SHALL CONTROL ALL SURFACE WATER TO AVOID DAMAGE TO ADJOINING PROPERTIES OR TO FINISH WORK ON THE SITE, AND SHALL TAKE REMEDIAL MEASURES TO PREVENT EROSION OF FRESHLY GRADED AREAS UNTIL PERMANENT DRAINAGE CONTROL MEASURES HAVE BEEN INSTALLED. (SEE SWPPP)
- 11. GRADING TOLERANCES: VERTICAL + 0.1', HORIZONTAL + 0.5'. THESE LIMITS DO NOT RELIEVE THE CONTRACTORS RESPONSIBILITY FOR PROVIDING A FINISHED SURFACE THAT WILL NOT POND WATER.

UNDERGROUND FACILITIES:

- 1. IT SHALL BE THE CONTRACTOR'S RESPONSIBILITY TO NOTIFY THE RESIDENT ENGINEER OF THE UTILITIES AND VERIFY DEPTH AND LOCATION PRIOR TO EXCAVATION OR PRIOR TO STARTING WORK. IF IT IS DETERMINED THAT A POSSIBLE CONFLICT EXISTS, THE CONTRACTOR IS RESPONSIBLE FOR ARRANGING WITH THE RESIDENT ENGINEER. THE RELOCATION OF ANY UTILITIES AND/OR ANY MODIFICATION OF THE PLANS.
- 2. SECTION 44216/4217 OF THE GOVERNMENT CODE, REQUIRES A DIG ALERT IDENTIFICATION NUMBER BE ISSUED BEFORE A "PERMIT TO EXCAVATE" WILL BE VALID. BEFORE EXCAVATING, VERIFY THE LOCATION OF UNDERGROUND UTILITIES. AT LEAST TWO (2) WORKING DAYS PRIOR TO EXCAVATION, THE CONTRACTOR SHALL REQUEST MARKOUT OF UNDERGROUND UTILITIES BY CALLING THE BELOW LISTED REGIONAL NOTIFICATION CENTER FOR AN INQUIRY IDENTIFICATION NUMBER:

UNDERGROUND SERVICE ALERT 800/422-4133 (GAS, ELECTRIC, TELEPHONE, WATER, SEWER, LIGHTING, AND TV)

BEFORE EXCAVATING, CONTRACTOR SHALL VERIFY LOCATION OF UNDERGROUND UTILITIES AND

COORDINATE HIS WORK WITH COMPANY REPRE	SENTATIVES.
UNDERGROUND SERVICE ALERT:	(800) 422-4133
STREET DIVISION:	(619) 527-7500
FACILITIES MAINTENANCE DIV. (BUILDINGS):	(619) 525-8540
PARK & REC. DEPARTMENT (IRRIGATION):	(619) 235-1179
GAS & ELECTRIC COMPANY:	(619) 527-7500
TELEPHONE & FIRE ALARM:	(800) 422-4133
CABLE T.V. (SOUTHWESTERN):	(619) 453-1460
IRRIGATION SYSTEMS	(619) 235-1179
IRRIGATION CONTROL WIRE:	(619) 235-1179

- a. THE EXISTING UTILITIES OR STRUCTURES REPORTED BY THE RESIDENT ENGINEER OR OTHERS, AND THOSE SHOWN ON THESE PLANS, ARE INDICATED IN THEIR APPROXIMATE LOCATION. PRIOR TO COMMENCEMENT OF WORK, ALL SERVICES AND UTILITIES SHALL BE LOCATED BY CONTRACTOR PRECISE LOCATION AND ELEVATIONS ARE NOT KNOWN FOR SOME OF THE EXISTING UNDERGROUND UTILITIES. CONTRACTOR SHALL MAKE SUFFICIENT EXPLORATIONS TO LOCATE UTILITIES BEFORE COMMENCING CONSTRUCTION AND SHALL NOTIFY THE ENGINEER OF WORK OF ANY POTENTIAL CONFLICTS. CONTRACTOR SHALL BE RESPONSIBLE FOR THE PROTECTION OF EXISTING UTILITIES.
- b. THE EXISTENCE AND LOCATION OF UNDERGROUND UTILITIES OR STRUCTURES SHOWN ON THESE PLANS WERE OBTAINED FROM A SEARCH OF THE AVAILABLE RECORDS. TO THE BEST OF OUR KNOWLEDGE THERE ARE NO OTHER EXISTING UTILITIES EXCEPT AS SHOWN ON THESE PLANS. THE CONTRACTOR IS REQUIRED TO TAKE PRECAUTIONARY MEASURES TO PROTECT THE UTILITY LINES SHOWN HEREON AND ANY OTHERS NOT OF RECORD OR NOT SHOWN ON THESE PLANS. ALL DAMAGES THERETO CAUSED BY THE CONTRACTOR SHALL BE REPAIRED TO THE APPROPRIATE SPECIFICATIONS AND STANDARDS AT THE EXPENSE OF THE CONTRACTOR.
- c. CONTRACTOR SHALL NOTIFY THE SAN DIEGO GAS & ELECTRIC COMPANY PRIOR TO STARTING WORK NEAR COMPANY FACILITIES AND SHALL COORDINATE HIS WORK WITH A COMPANY REPRESENTATIVE.
- d. CONTRACTOR SHALL NOTIFY THE PACIFIC BELL TELEPHONE COMPANY PRIOR TO STARTING WORK NEAR COMPANY FACILITIES AND SHALL COORDINATE HIS WORK WITH A COMPANY REPRESENTATIVES.

CONSTRUCTION NOTES:

1. SPECIAL NOTE

FOLLOWING NOTES ARE PROVIDED TO GIVE DIRECTIONS TO THE CONTRACTOR BY THE ENGINEER OF WORK. THE CITY ENGINEER'S SIGNATURE ON THESE PLANS DOES NOT CONSTITUTE APPROVAL OF THESE NOTES, AND THE CITY WILL NOT BE RESPONSIBLE FOR THEIR ENFORCEMENT.

2. DEFINITIONS

ENGINEER OR RESIDENT ENGINEER - CITY OF SAN DIEGO PROJECT MANAGER - JEFF SORIANO - CITY OF SAN DIEGO (858) 533-5140 CIVIL ENGINEER - KEVIN BRANDT - STANTEC CONSULTING INC. (949) 923-6211 LANDSCAPE ARCHITECT - MARK LARUE - STANTEC CONSULTING INC. (760) 891-3220 CONTRACTOR - THE LEGAL ENTITY HAVING A CONTRACT WITH THE CITY TO PERFORM THE WORK.

3. GOVERNING AGENCY REQUIREMENTS

WHEN THESE SPECIFICATIONS AND PLANS CALL FOR MATERIALS OF A HIGHER STANDARD THAN THOSE REQUIRED TO CONFORM WITH MINIMUM LOCAL AND STATE CODES, THE SPECIFICATIONS AND DRAWINGS SHALL PREVAIL.

4. PLANS

CONTRACTOR SHALL MAINTAIN ONE COMPLETE SET OF PLANS (JOB SET) ON SITE UNTIL CONTRACT INSTALLATION IS COMPLETE.

IDEAS, CONCEPTS AND SPECIFIC TECHNIQUES USED IN THESE PLANS ARE THE PROPERTY OF THE LANDSCAPE ARCHITECT. CHANGES WITHOUT WRITTEN CONSENT OF THE LANDSCAPE ARCHITECT RELIEVE THE LANDSCAPE ARCHITECT OF ALL RESPONSIBILITY AND THE INTENDED AESTHETIC QUALITY. THE CITY RESERVES THE RIGHT TO SUBSTITUTE, ADD, OR DELETE ANY MATERIAL OR LABOR AS THE WORK PROGRESSES.

5. EXISTING SITE CONDITIONS

THE CONTRACTOR IS TO PROTECT AT ALL TIMES ALL EXISTING UTILITIES. STRUCTURES. PLANT MATERIAL AND OTHER FEATURES INTENDED TO REMAIN ON AND ADJACENT TO THE JOB SITE. SHOULD DAMAGE BE INCURRED WHICH IS CAUSED BY CONTRACTOR'S OPERATIONS OR NEGLIGENCE, THE CONTRACTOR SHALL REPAIR THE DAMAGE TO ITS ORIGINAL CONDITION OR THE ELEMENT SHALL BE REPLACED (EITHER AT THE PREROGATIVE OF THE RESIDENT ENGINEER) IN KIND WITH EQUIVALENT SIZE AT HIS OWN EXPENSE.

6. EQUIPMENT & MATERIALS

ALL MATERIAL AND EQUIPMENT SPECIFIED SHALL BE NEW, WITHOUT DEFECTS, AND SHALL BE INSTALLED IN ACCORDANCE WITH DETAILS SHOWN IN THESE PLANS.

THE CONTRACTOR SHALL SUBMIT TO THE RESIDENT ENGINEER A LIST OF ANY ITEMS HE WISHES TO SUBSTITUTE AS "EQUAL" WITH ACCOMPANYING CATALOG DATA. ALL SUBSTITUTIONS MUST BE SUBMITTED WITHIN 10 DAYS AFTER CONTRACTOR IS AWARDED THE CONTRACT. THE RESIDENT ENGINEER SHALL DETERMINE THE EQUALITY OF PROPOSED SUBSTITUTE MATERIALS. SUBSTITUTED EQUIPMENT INSTALLED WITHOUT THE PRIOR APPROVAL OF THE RESIDENT ENGINEER MAY BE REJECTED, AND THE CONTRACTOR REQUIRED TO REMOVE SUCH MATERIALS FROM THE SITE AT HIS OWN EXPENSE.

CONTRACTOR SHALL SUBMIT SAMPLES IN THE FORM OF ACTUAL MATERIALS, OR PHOTOGRAPHS AND ADDRESS OF SAME MATERIAL INSTALLATION. FOR THE FOLLOWING CONTRACT ITEMS: LANDSCAPE **BOULDERS: ROCK MULCH**

7. SITE CONDITIONS

DURING CONSTRUCTION, THE CONTRACTOR SHALL MAINTAIN THE SITE IN AN ORDERLY AND SAFE CONDITION.

ALL AREAS SHALL BE LEFT CLEAN, FREE OF DEBRIS, AND WASHED DOWN UPON COMPLETION OF WORK

8. NOTIFICATION

THE CONTRACTOR SHALL NOTIFY THE RESIDENT ENGINEER PRIOR TO BEGINNING WORK, AND SHALL BE RESPONSIBLE FOR COORDINATING HIS WORK WITH THE RESIDENT ENGINEER AND OTHER CONSTRUCTION TRADES, AND GOVERNING AGENCIES.

9. RECORD PLANS

CONTRACTOR SHALL PROVIDE THE OWNER WITH RECORD PLANS, IN THE FORM OF REDLINE CORRECTED BLUEPRINTS. (SUBMIT ONE COPY PER PLAN PER SHEET.) THE FOLLOWING SHALL BE DIMENSIONED FROM TWO PERMANENT POINTS OF REFERENCE (I.E. BUILDING CORNERS, SIDEWALKS, ETC.):

DRAINAGE SYSTEM DRAIN INLETS **CATCH BASINS** SUBSURFACE DRAIN LINES OUTLETS IRRIGATION VALVES

SPECIAL TOPOGRAPHICAL/SURVEY NOTE:

SPOT ELEVATIONS SHOWN WERE DERIVED THROUGH INTERPELLATION USING SURVEY DATA SUPPLIED BY THE CITY OF SAN DIEGO. CONTRACTOR SHALL BE RESPONSIBLE FOR VERIFYING ALL SPOT ELEVATIONS WITHIN TEN (10) DAYS OF BEING AWARDED THE CONTRACT AND SHALL NOTIFY THE RESIDENT ENGINEER OF ANY DISCREPANCY BETWEEN THE PLANS AND EXISTING CONDITIONS.



KEVIN BYRON BRANDT

WBS NO. B-00603

Stantec Consulting, Inc. 277 Rancheros Drive Suite 300 San Marcos, CA 92069

Tel. (760) 891-3200 Fax. (760) 891-3201 www.stantec.com

RCE 54873 EXP. 6-30-10 DATE

CIVIL

GREEN L


PARK


PLANS FOR THE CONSTRUCTION OF KELLOGG PARK GREEN LOT


GENERAL NOTES


			·	
CITY OF SAN DIEGO, CALIFORNIA ENGINEERING AND CAPITAL PROJECTS DEPARTMENT SHEET 2 OF 13 SHEETS				w.o. NO. 121593
APPROVED: FOR CITY ENGINEER		DATE		SUBMITTED BY: JEFF SORIANO ASSOCIATE ENGINEER
DESCRIPTION ORIGINAL	STANTEC	DATE	FILMED	WILLIAM MEREDITH PROJECT ENGINEER
				CONTROL CERTIFICATION 252-1689 LAMBERT COORDINATES
CONTRACTOR	DATE STARTE	D D		35278- 2 -D

T-2

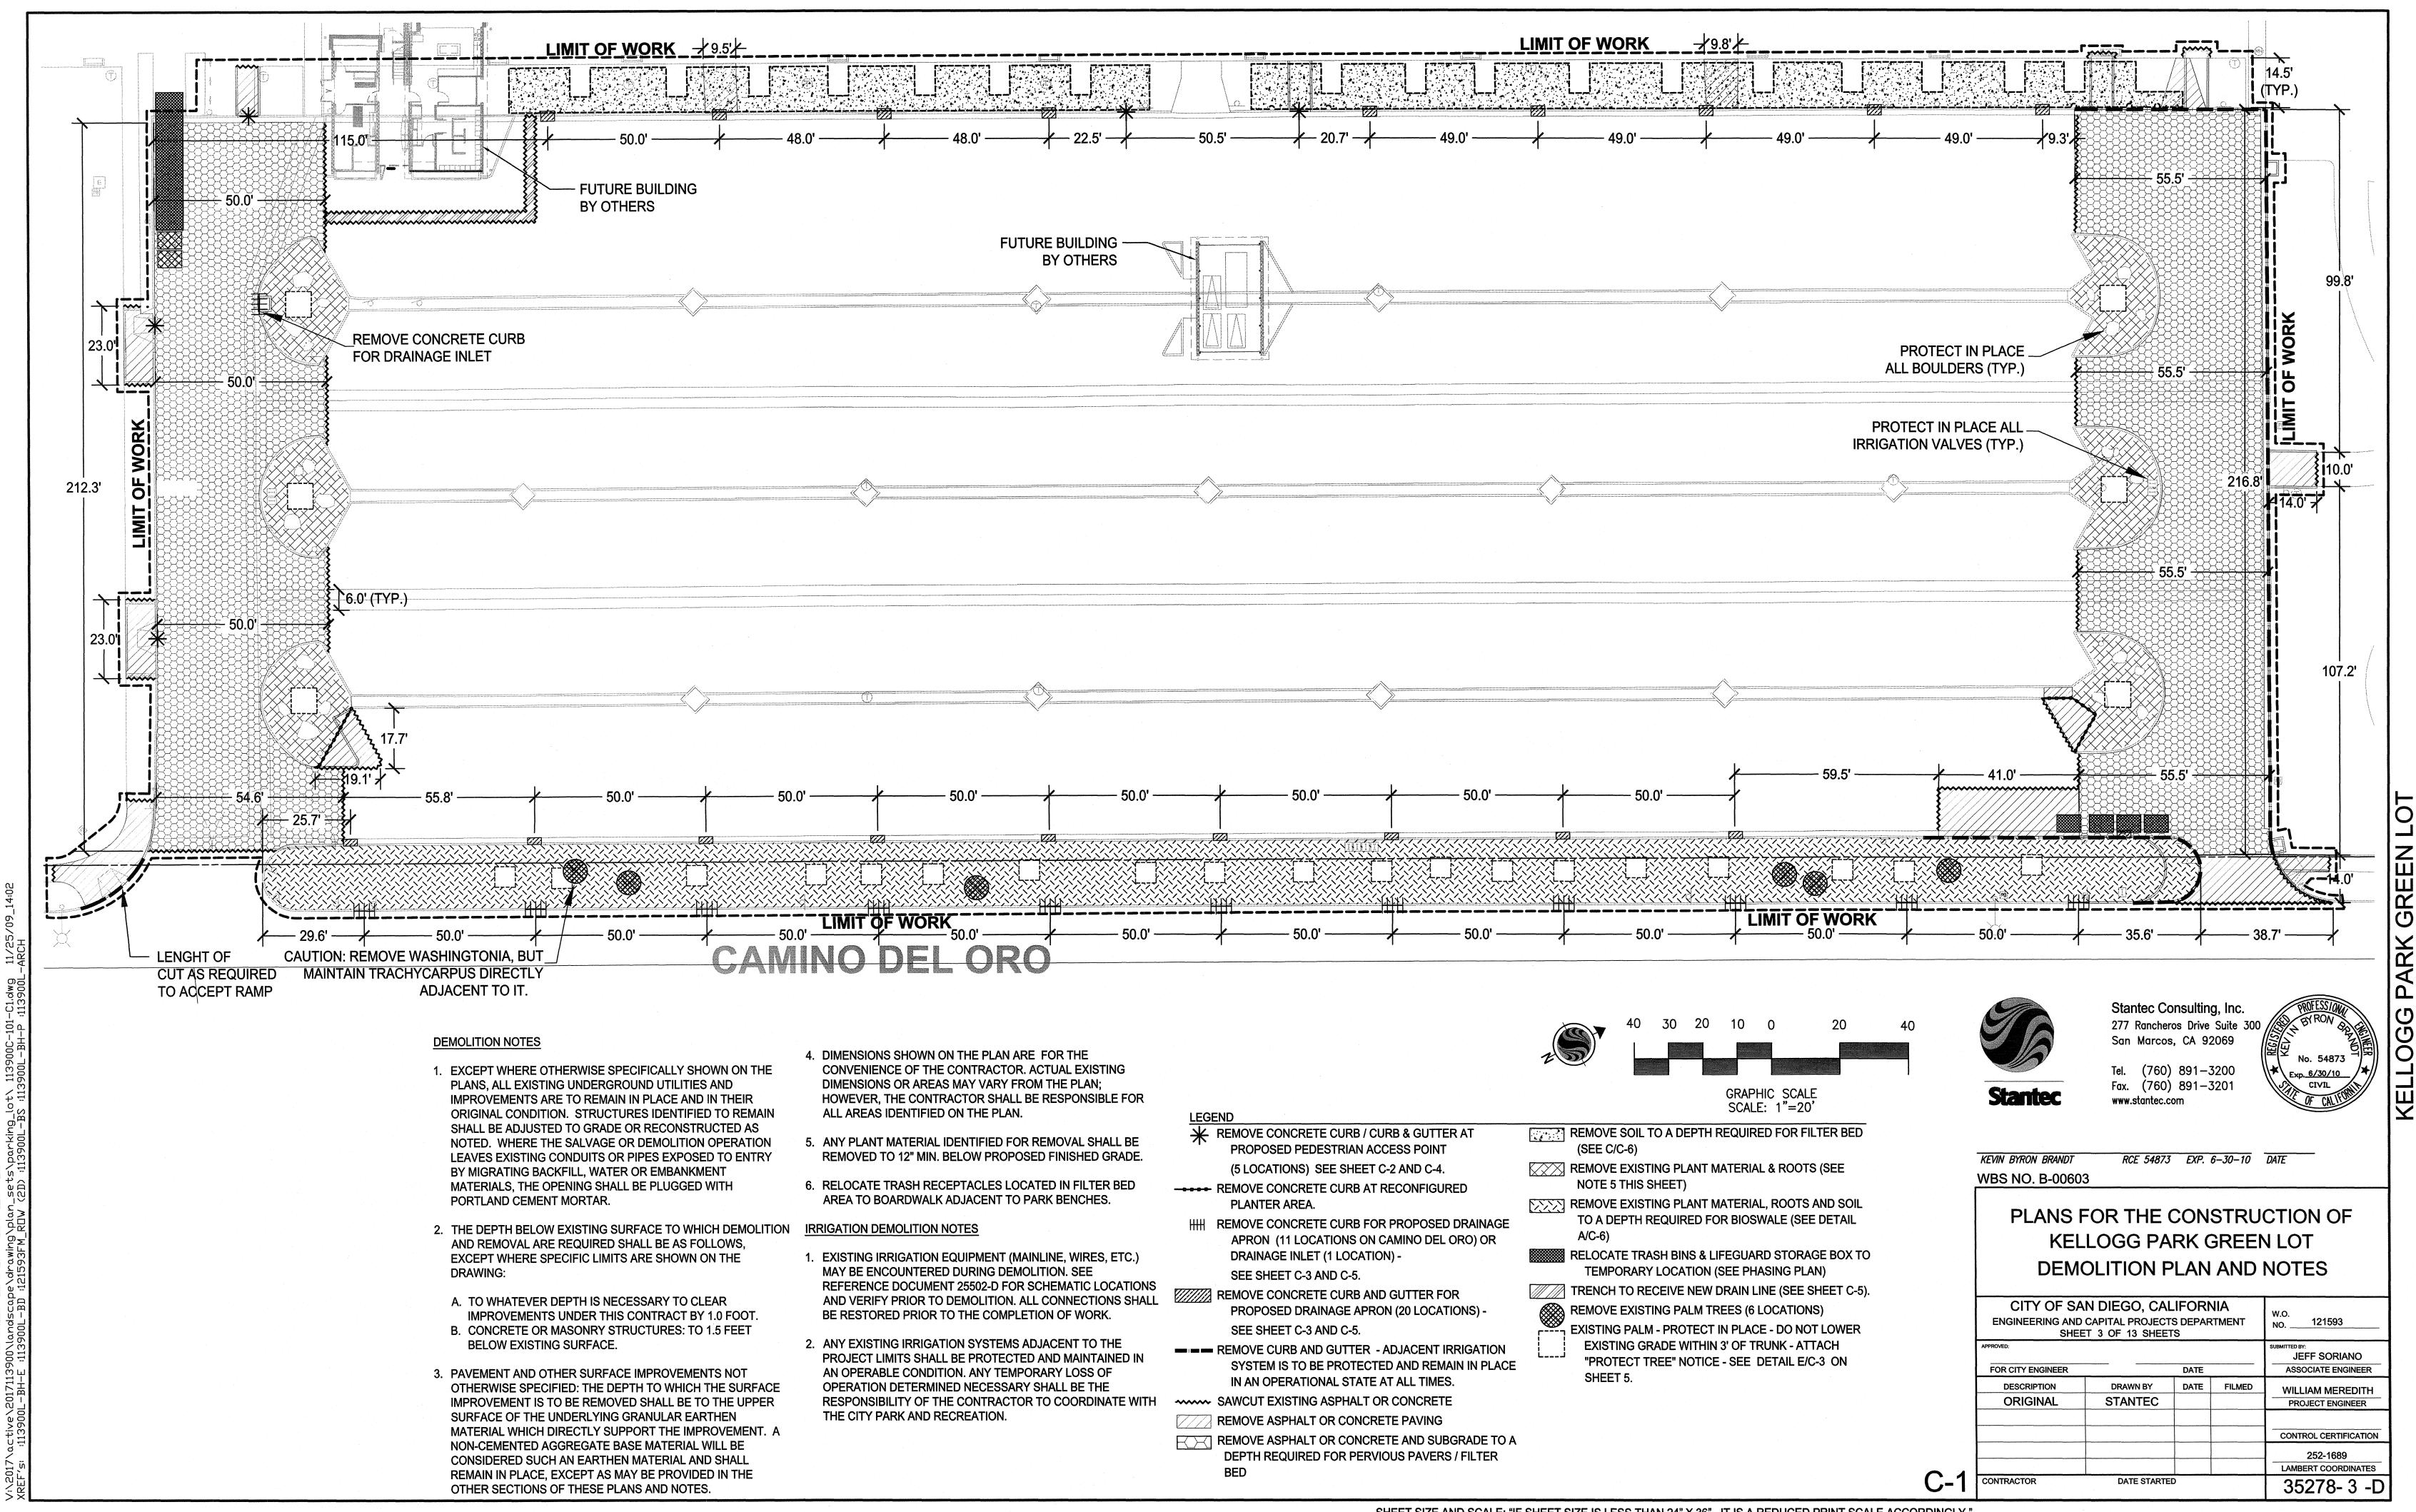

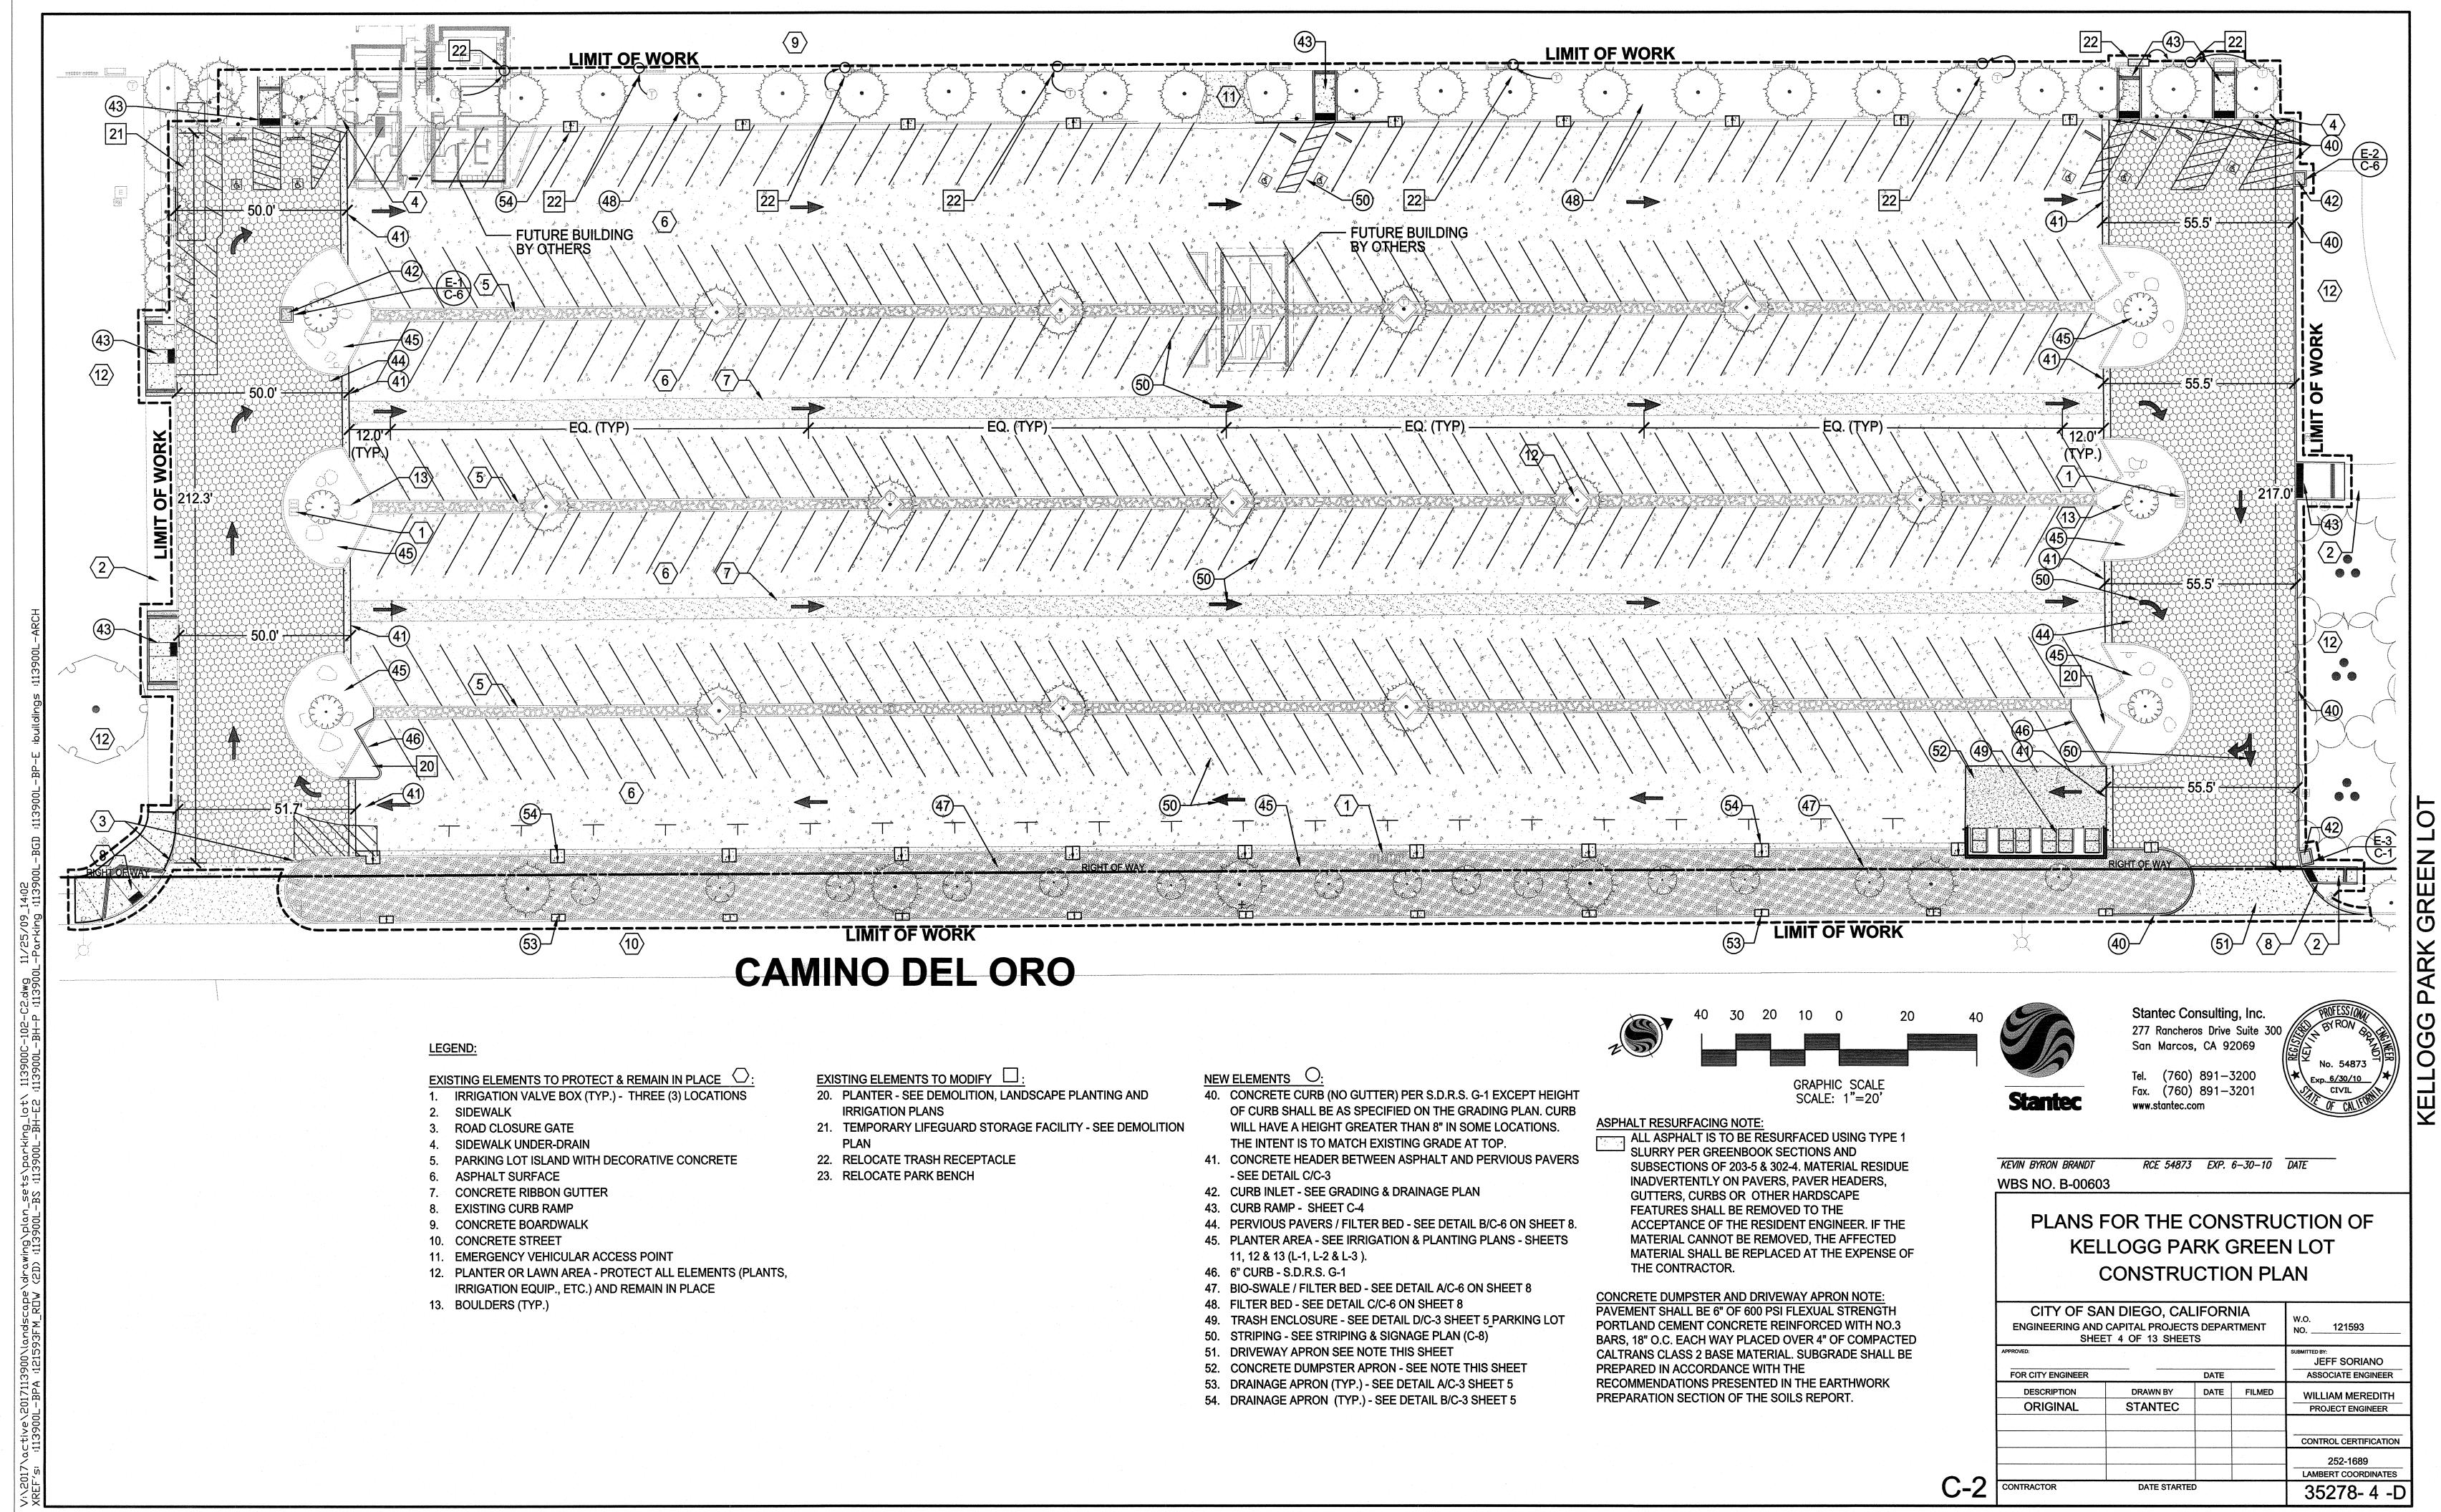

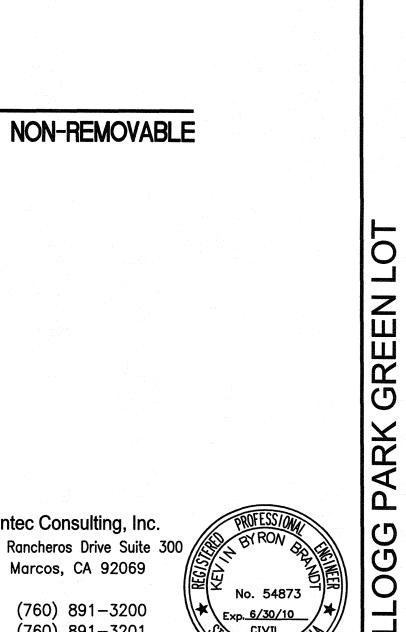

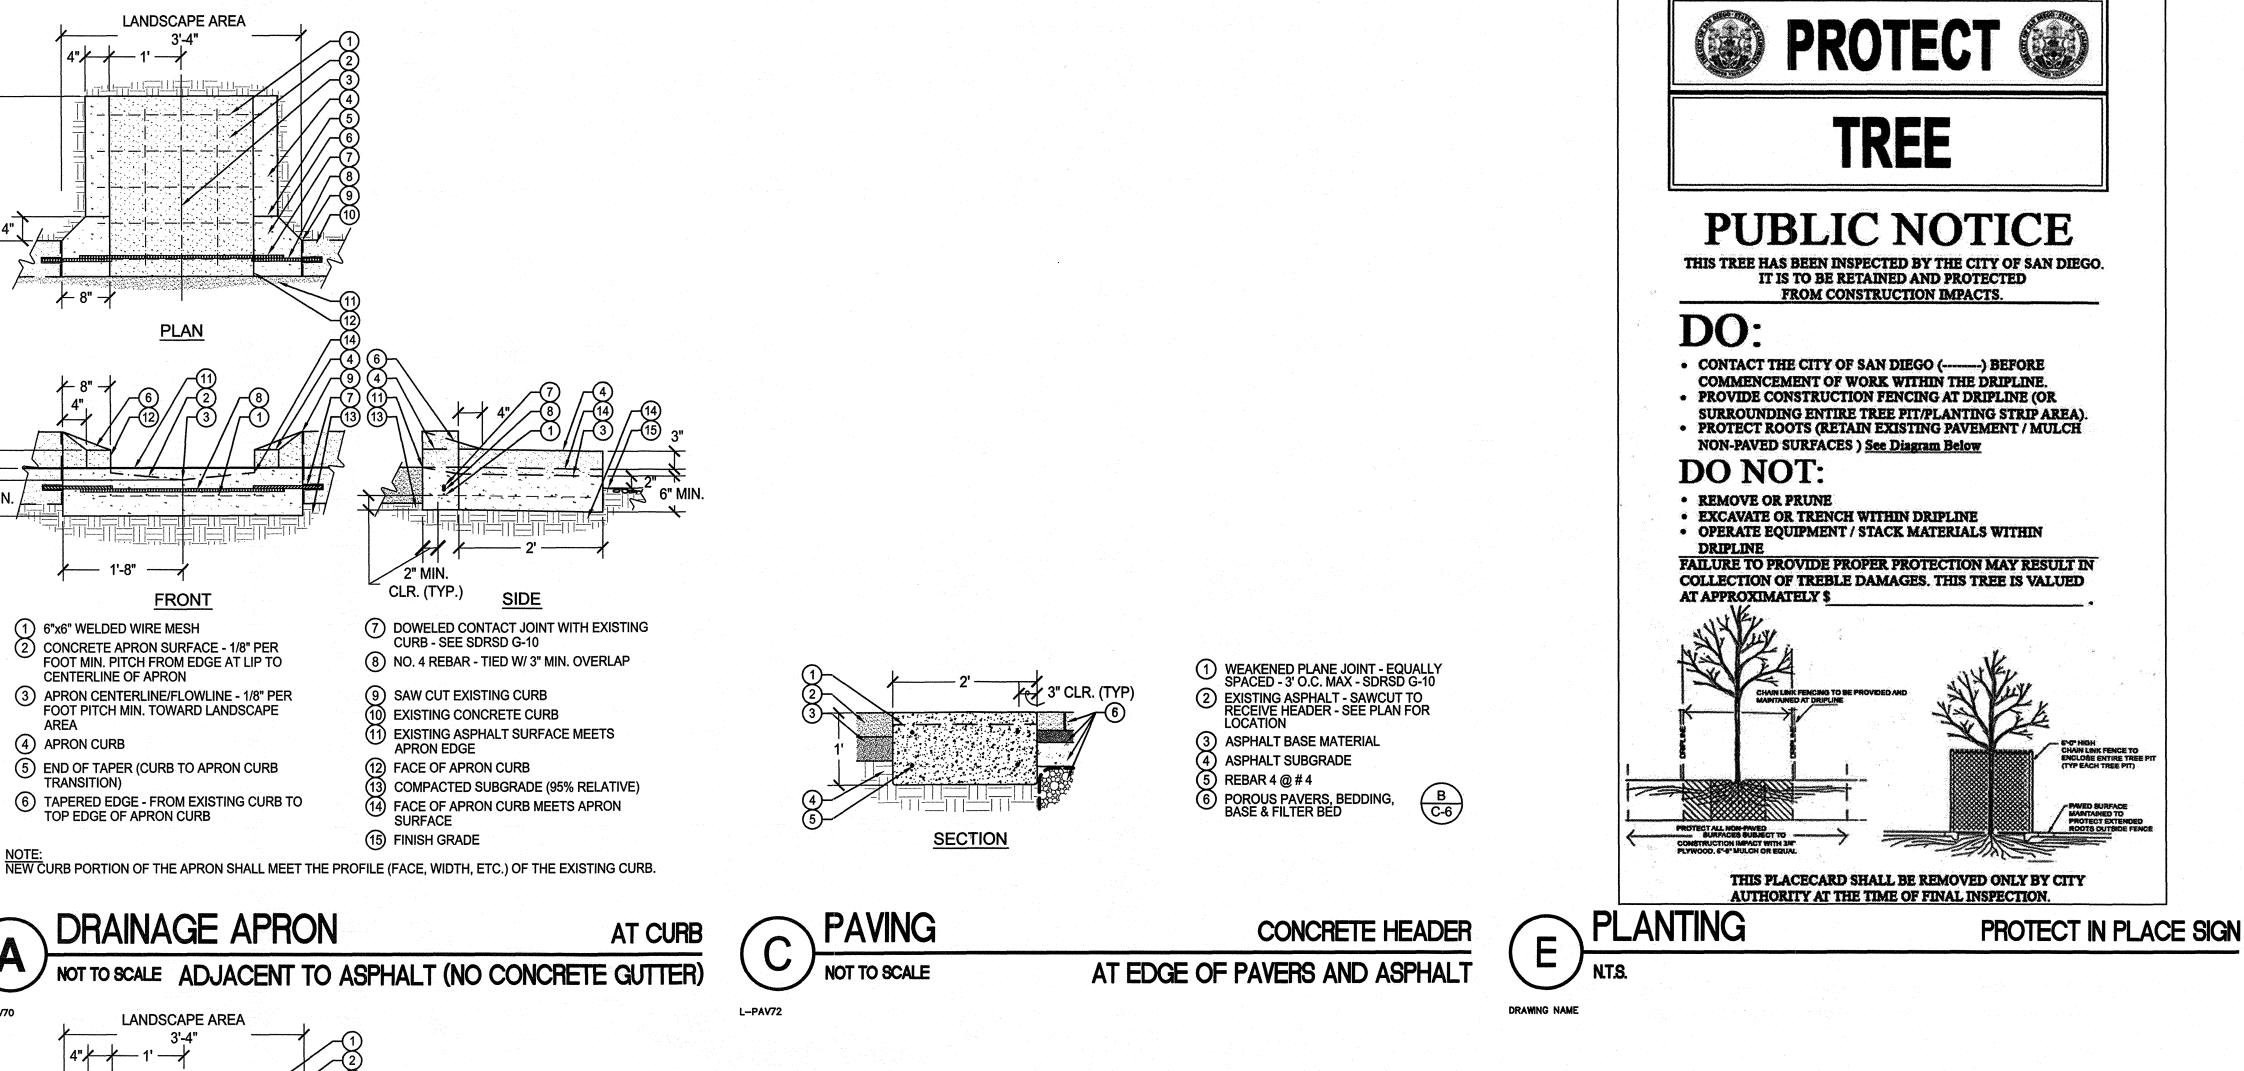

(8) NO. 4 REBAR - TIED W/ 3" MIN. OVERLAP

EXISTING GUTTER FLOW LINE MEETS NEW FLOW LINE AT EDGE

3) COMPACTED SUBGRADE (95% RELATIVE)

WITH CONCRETE GUTTER

AT CURB

NO SCALE

(14) FACE OF APRON CURB MEETS APRON

16 EXISTING GUTTER (SEE NOTE 1.)

(17) NEW GUTTER (SEE NOTE 1.)

9 SAW CUT EXISTING CURB & GUTTER

(10) EXISTING CONCRETE CURB

(12) FACE OF APRON CURB

(15) FINISH GRADE

NEW CURB PORTION OF THE APRON AND THE GUTTER SHALL MEET THE PROFILE (FACE, WIDTH, FLOW LINE, ETC.) OF THE EXISTING CURB & GUTTER.

1) 6"x6" WELDED WIRE MESH - 2" CLR. (TYP.)

2 CONCRETE APRON SURFACE - 1/8" PER FOOT MIN. PITCH FROM EDGE AT LIP TO CENTERLINE OF APRON

3 APRON CENTERLINE/FLOWLINE - 1/8" PER FOOT PITCH MIN. TOWARD LANDSCAPE

(5) END OF TAPER (CURB TO APRON CURB


6 TAPERED EDGE - FROM EXISTING CURB TO TOP EDGE OF APRON CURB

7 DOWELED CONTACT JOINT WITH EXISTING CURB - SEE SDRSD G-10

DRAINAGE APRON

4 CURB OF APRON

NOT TO SCALE

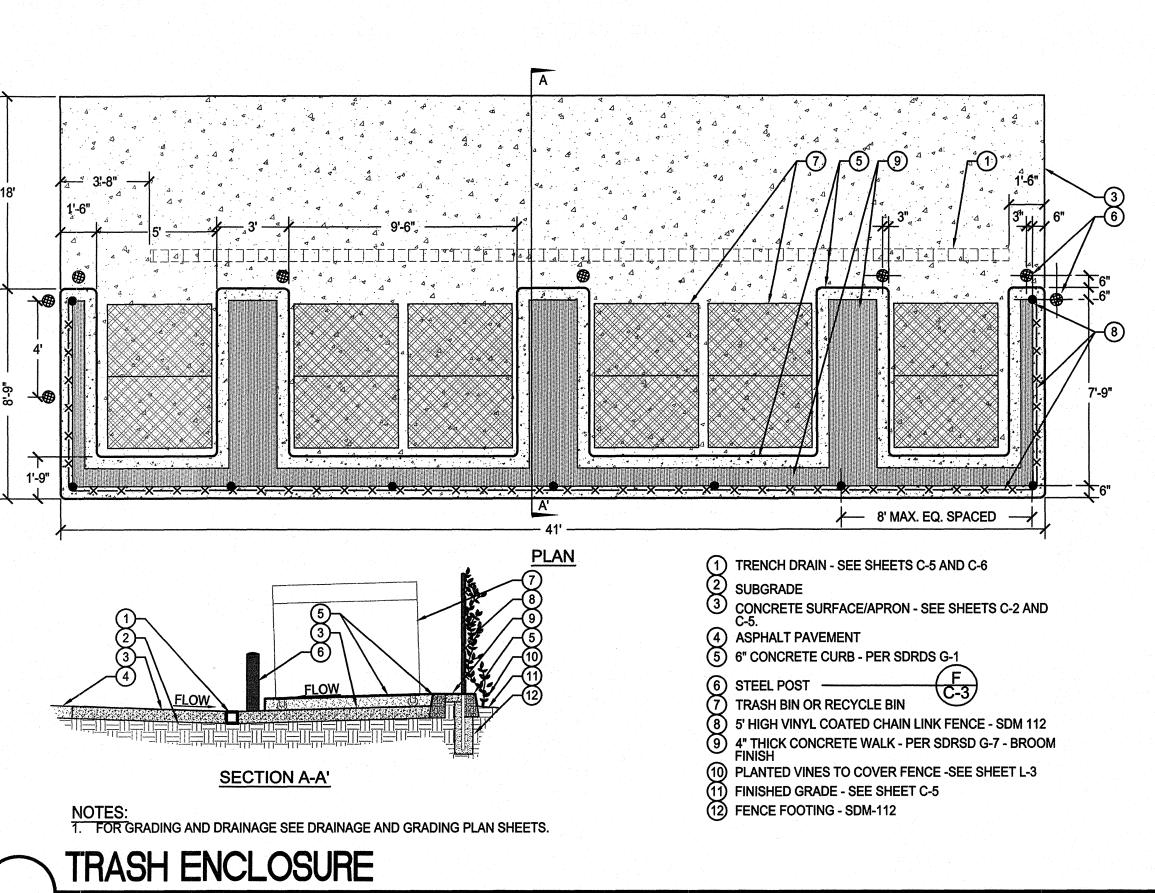

6 DUMPSTERS • 4 CUYD EA.

Stantec Consulting, Inc. 277 Rancheros Drive Suite 300 San Marcos, CA 92069

1) POSITIVE WASH CAP ALL AROUND

(3) FINISHED SURFACE

(4) 12"CONCRETE FOOTING

4"Ø (4.5" O.D.) SCHED 40 GALVANIZED STEEL PIPE FILLED WITH CONCRETE

Tel. (760) 891-3200 Fax. (760) 891-3201 www.stantec.com

RCE 54873 EXP. 6-30-10 DATE WBS NO. B-00603

PLANS FOR THE CONSTRUCTION OF KELLOGG PARK GREEN LOT **CONSTRUCTION DETAILS**

CITY OF SA ENGINEERING AND SHEE	W.O. NO. 121593			
APPROVED: FOR CITY ENGINEER		DATE		JEFF SORIANO ASSOCIATE ENGINEER
DESCRIPTION ORIGINAL	DRAWN BY STANTEC	DATE	FILMED	WILLIAM MEREDITH PROJECT ENGINEER
				CONTROL CERTIFICATION
				252-1689 LAMBERT COORDINATES
CONTRACTOR	DATE STARTED)		35278- 5 -D

C-3

STEEL POST



Exp. 6/30/10 CIVIL

121593

JEFF SORIANO

ASSOCIATE ENGINEER

WILLIAM MEREDITH

PROJECT ENGINEER

CONTROL CERTIFICATION

252-1689 LAMBERT COORDINATES

35278-6 -D

DATE


DATE STARTED

DATE FILMED

(F) C-4

(E) C-4

 $\begin{pmatrix} D \\ C-4 \end{pmatrix}$

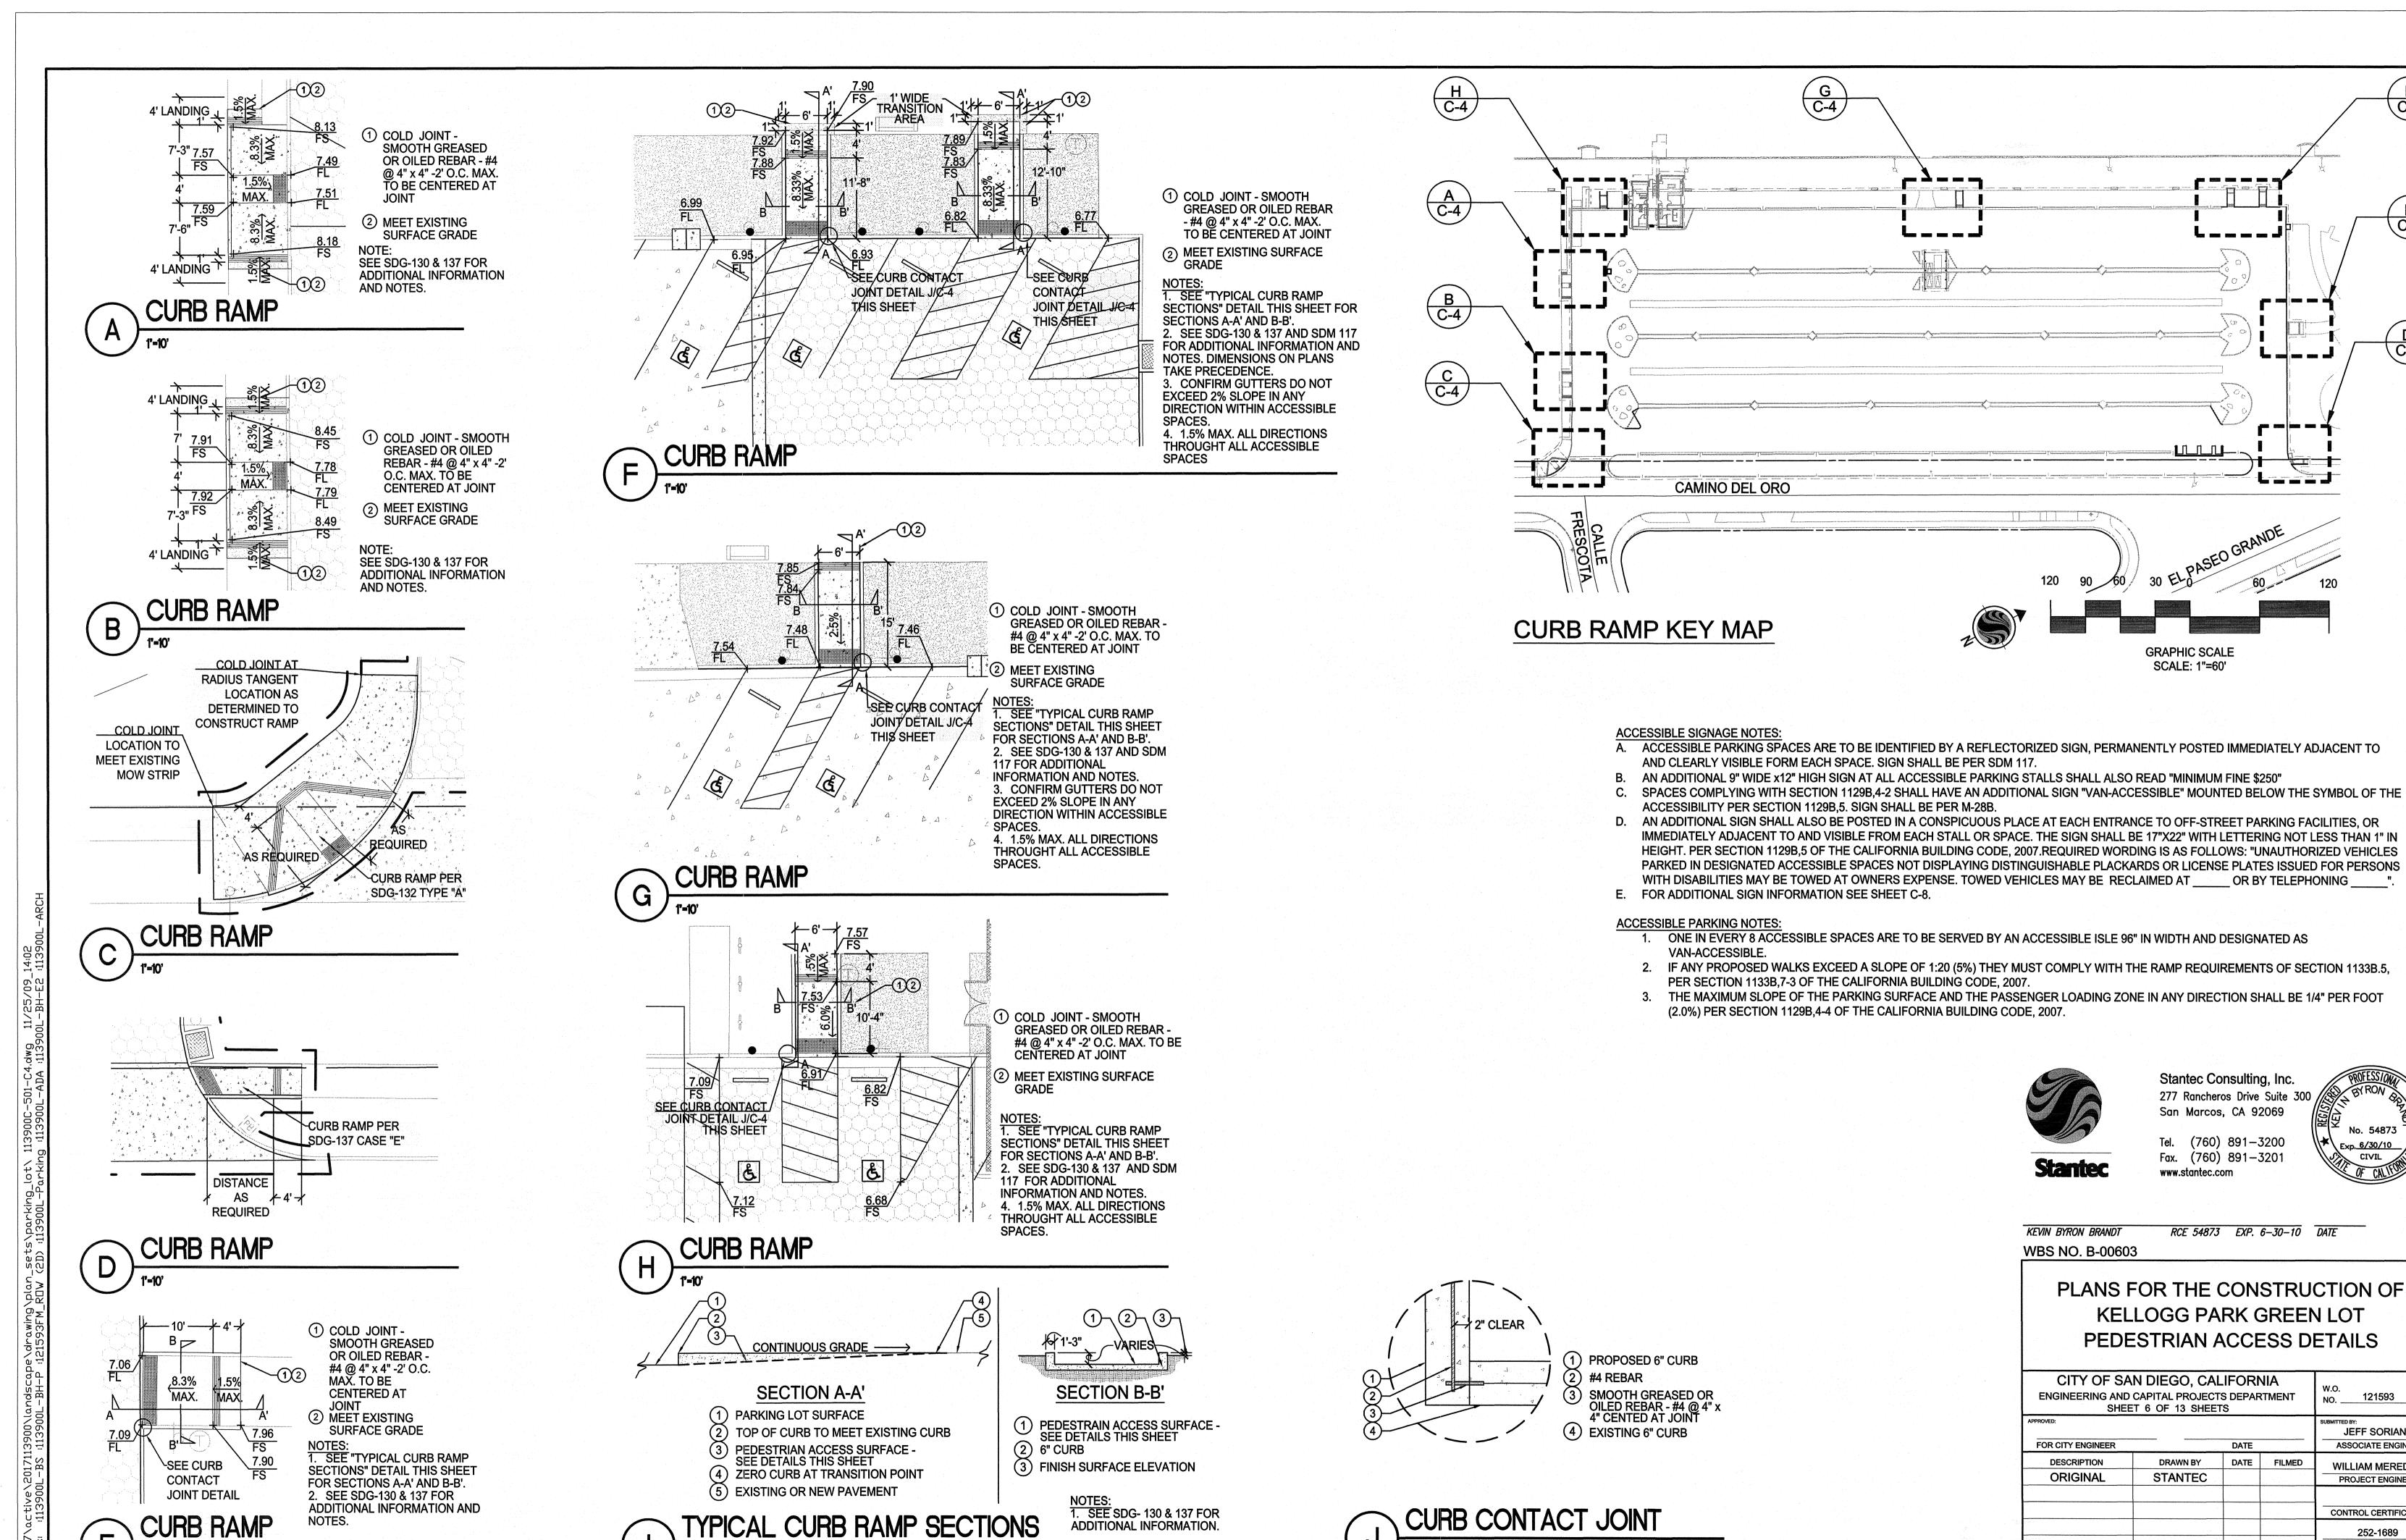



NO SCALE

SHEET SIZE AND SCALE: "IF SHEET SIZE IS LESS THAN 24" X 36", IT IS A REDUCED PRINT SCALE ACCORDINGLY."

NO SCALE

CONTRACTOR

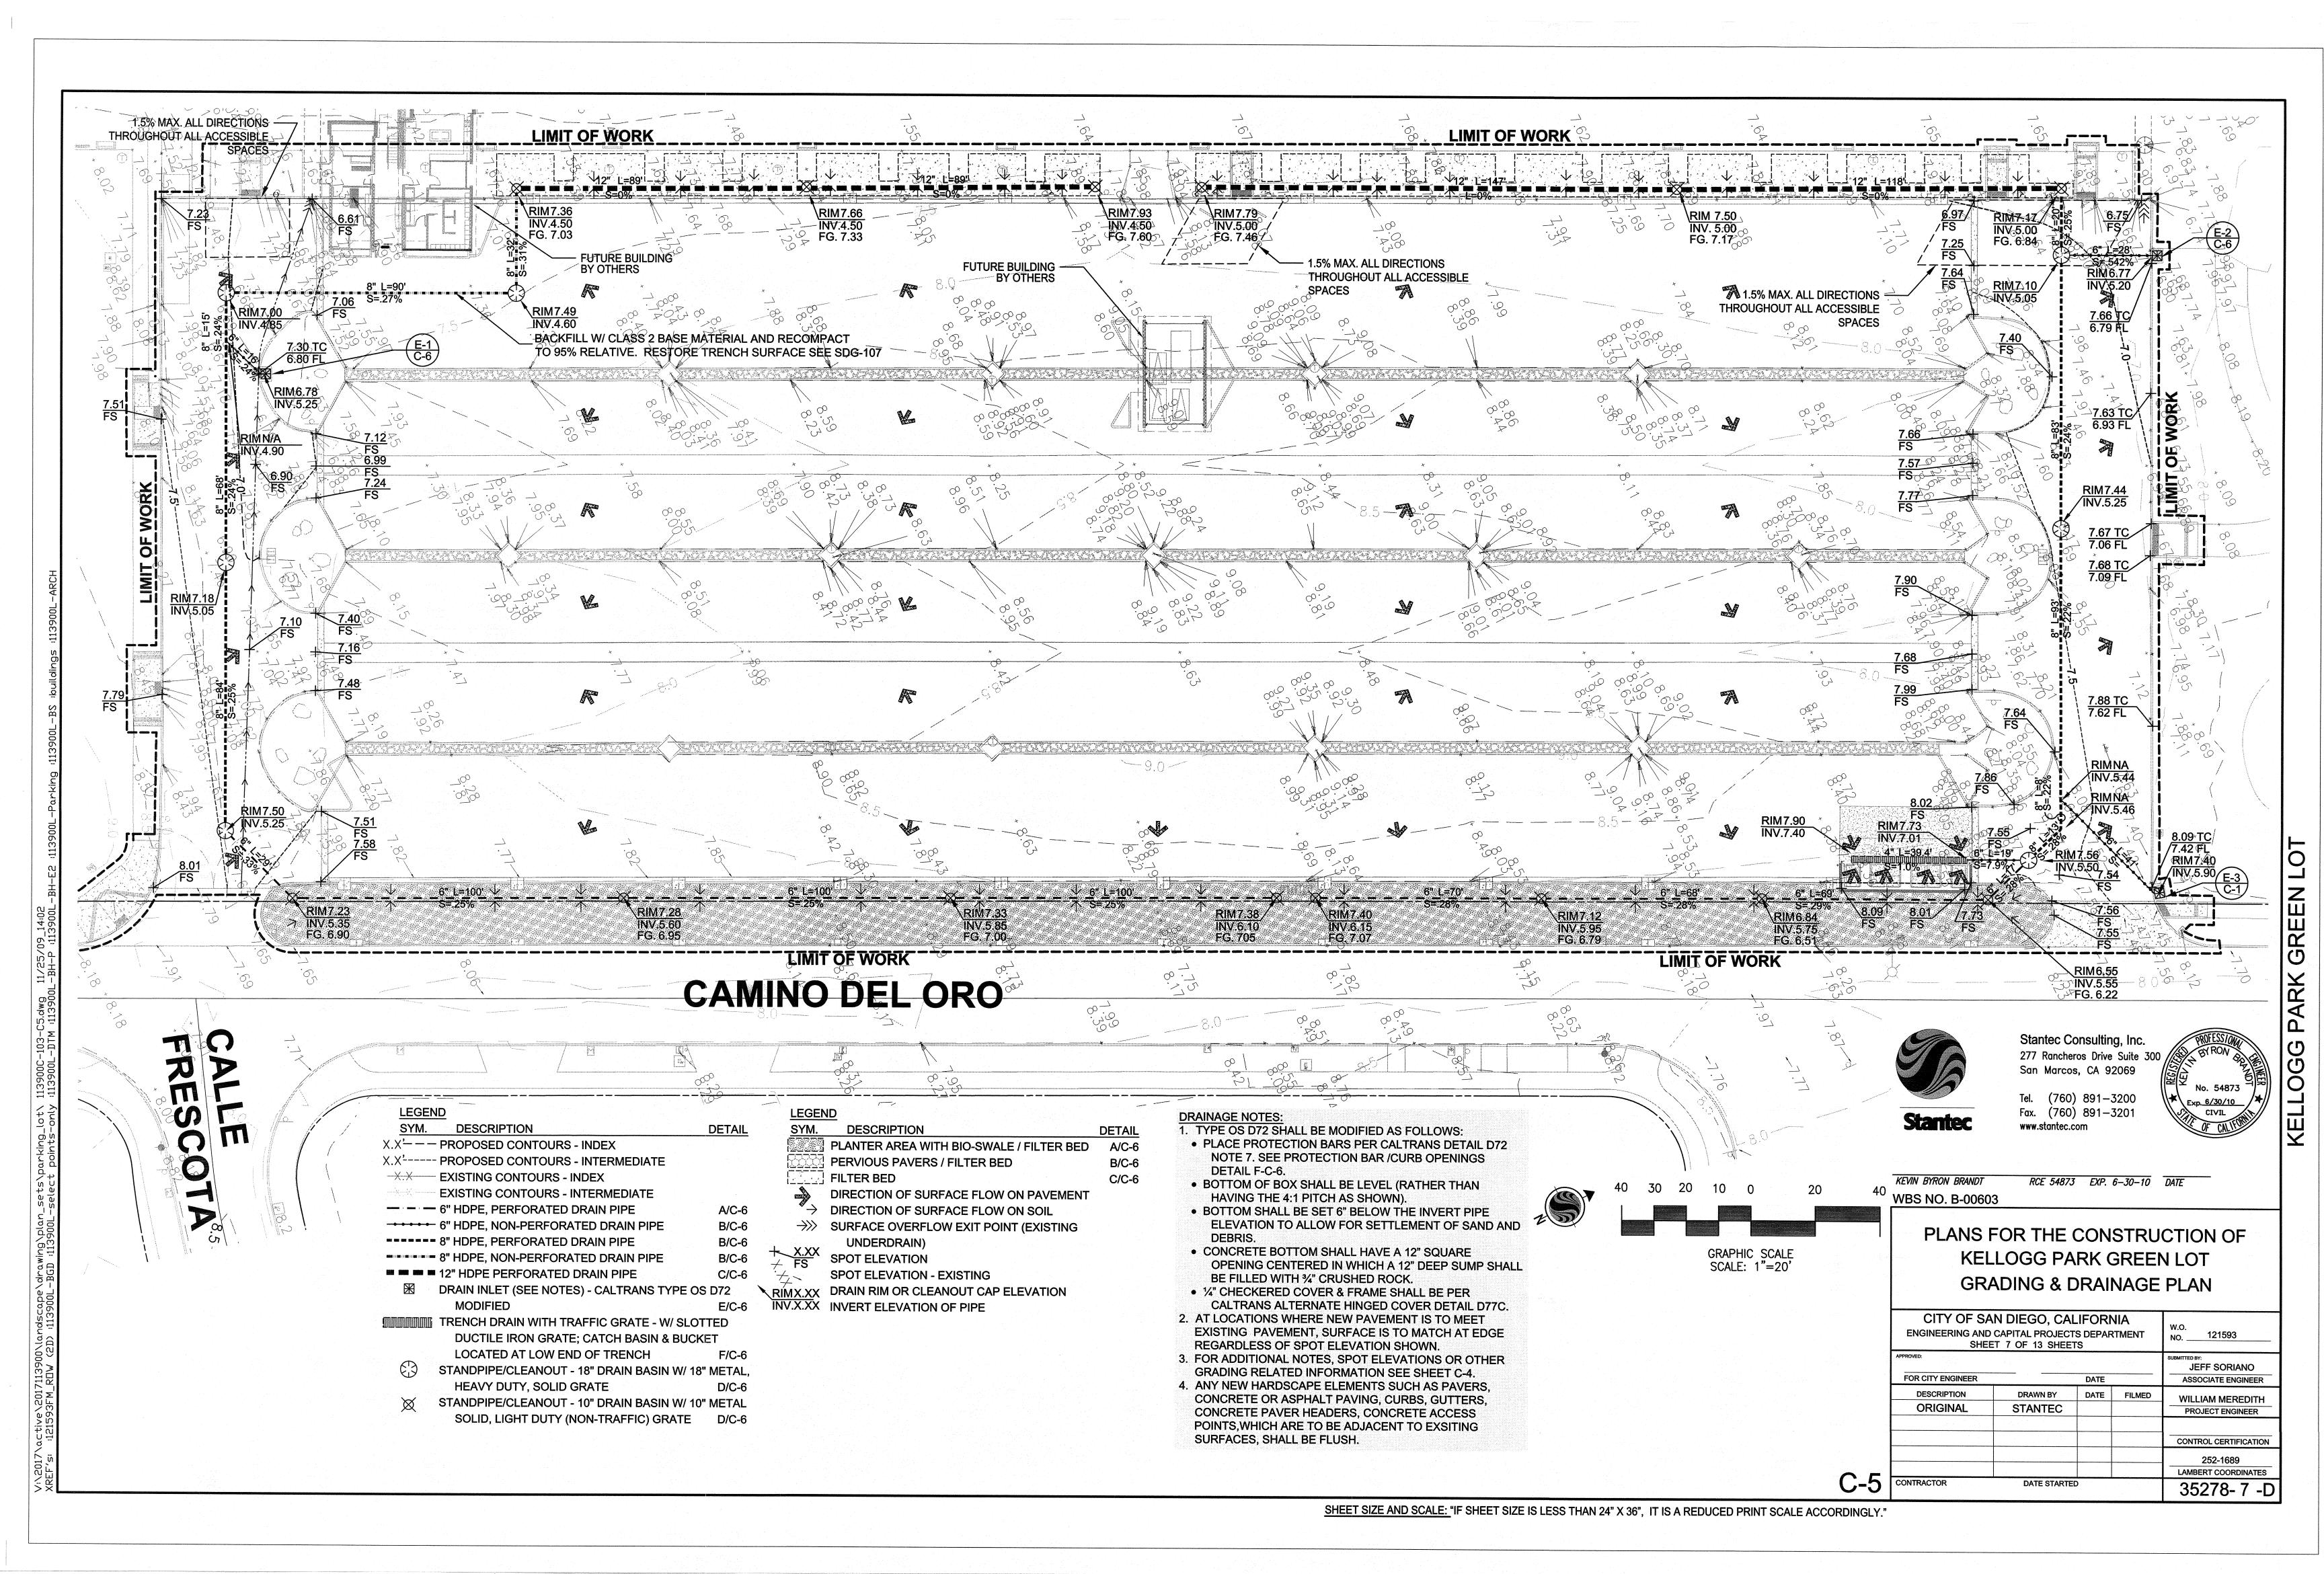

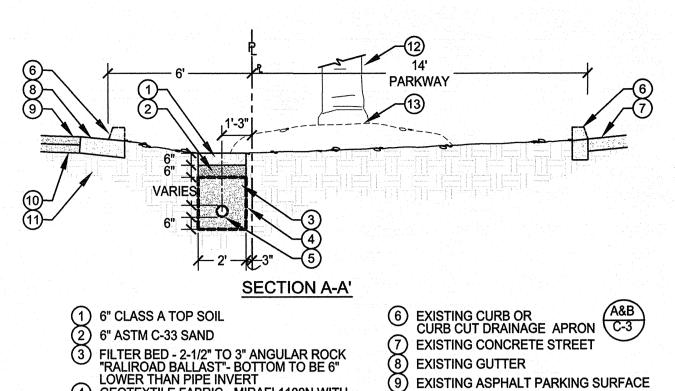

3 FILTER BED - 2-1/2" TO 3" ANGULAR ROCK "RALIROAD BALLAST"- BOTTOM TO BE 6" LOWER THAN PIPE INVERT
4 GEOTEXTILE FABRIC - MIRAFI 1100N WITH AN OPENTING OF 0.15MM (100 SEIVE)- 24"

10) EXISTING ASPHALT BASE MATERIAL 1) EXISTING SUB-GRADE 5 HDPE CORRUGATED, PERFORATED PIPE SEE PLAN FOR SIZE & ELEVATION 12) EXISTING PALM TREE

(13) EXISTING GRADE AT PALM TREE - DO NOT DISTURB GRADE W/IN 3' OF TRUNK NOTES:


1. SEE PLAN AND SPECIFICATIONS FOR ADDITIONAL INFORMATION.

DRAINAGE

INFILTRATION/FILTER BED

NOT TO SCALE

AT BIO-SWALE

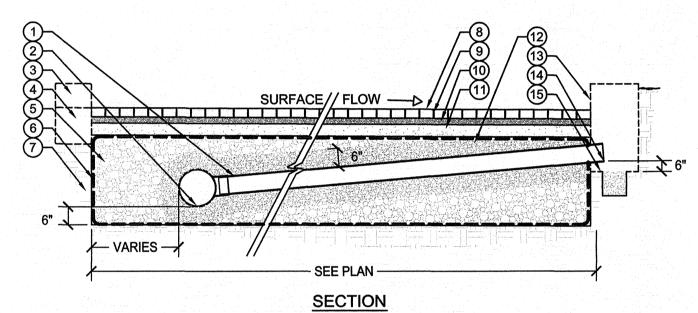

(8) PERVIOUS PAVERS

9 VOID FILL - 1/8" - 1/4" PERMEABLE CHIP
10 2" BEDDING - OPEN GRADE AGGREGATE - 1/4" TO 3/8"
MATERIAL

11) 4" BASE - AGGREGATE - 1/4" TO 3/8" MATERIA 2) 6" BUFFER - AGGREGATE - 1" TO 2" MATERIAL

DRAINAGE CURB INLET - CALTRANS D72 OS

CONCRETE BOTTOM SHALL HAVE A 12" SQUARE OPENING CENTERED IN WHICH A 12" DEEP SUMP SHALL BE FILLED WITH 3/4" CRUSHED ROCK

(1) 6" HDPE NON PERFORATED PIPE (2) 8" HDPE PERFORATED PIPE INVERT ELEVATION 3 EXISTING CURB WHERE SHOWN ON PLAN
4 NEW CONCRETE HEADER C
WHERE SHOWN ON PLAN
C-3

5 SUB-BASE /FILTER BED - 2-1/2" TO 3" ANGULAR ROCK "RALIROAD BALLAST"- BOTTOM TO BE 6" LOWER THAN PIPE INVERT

6 GEOTEXTILE FABRIC - MIRAFI 1100N WITH AN OPENING OF 0.15 MM (100 SIEVE). - 24" MIN. OVERLAP (7) COMPACTED SUBGRADE (95% RELATIVE)


NOTES:

1. SEE PLAN FOR ADDITIONAL INFORMATION.

DRAINAGE NOT TO SCALE

L-DRAI46

PERVIOUS PAVEMENT FILTER BED

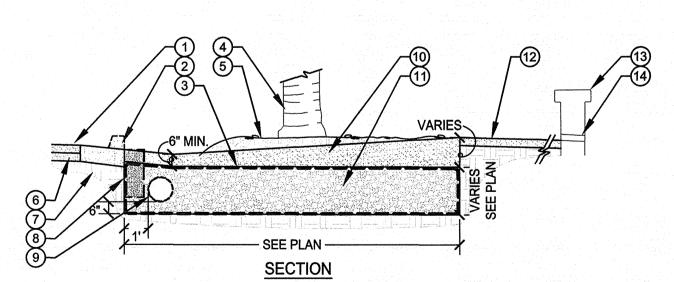

(1) EXISTING ASPHALT PARKING SURFACE EXISTING CURB OR CURB CUT DRAINAGE APRON

3 GEOTEXTILE FABRIC - MIRAFI 1100N WITH AN OPENING OF 0.15 MM (100 SIEVE). - 24" MIN. OVERLAP (4) EXISTING PALM TREE EXISTING GRADE TO BE MAINTAINED WITHIN 3' MIN. OF EXISTING TREE (6) EXISTING ASPHALT BASE MATERIAL

8 10" Ø SONOTUBE AND CONCRETE FOOTING FOR SIGN WHERE SHOWN ON THE PLAN. SIGN FOOTING SHALL NOT PENETRATE GEOTEXTILE FABRIC.


9 HDPE CORRUGATED, PERFORATED PIPE, SEE PLAN FOR SIZE & ELEVATION (10) 6" SAND LAYER

FILTER BED - 2-1/2" TO 3" ANGULAR ROCK
"RALIROAD BALLAST"- BOTTOM TO BE 6"
LOWER THAN PIPE INVERT
(12) EXISTING PAVEMENT (13) EXISTING WALL (14) EXISTING DRAINAGE OPENINGS IN WALL

NOT TO SCALE

(7) EXISTING SUB-BASE

FILTER BED

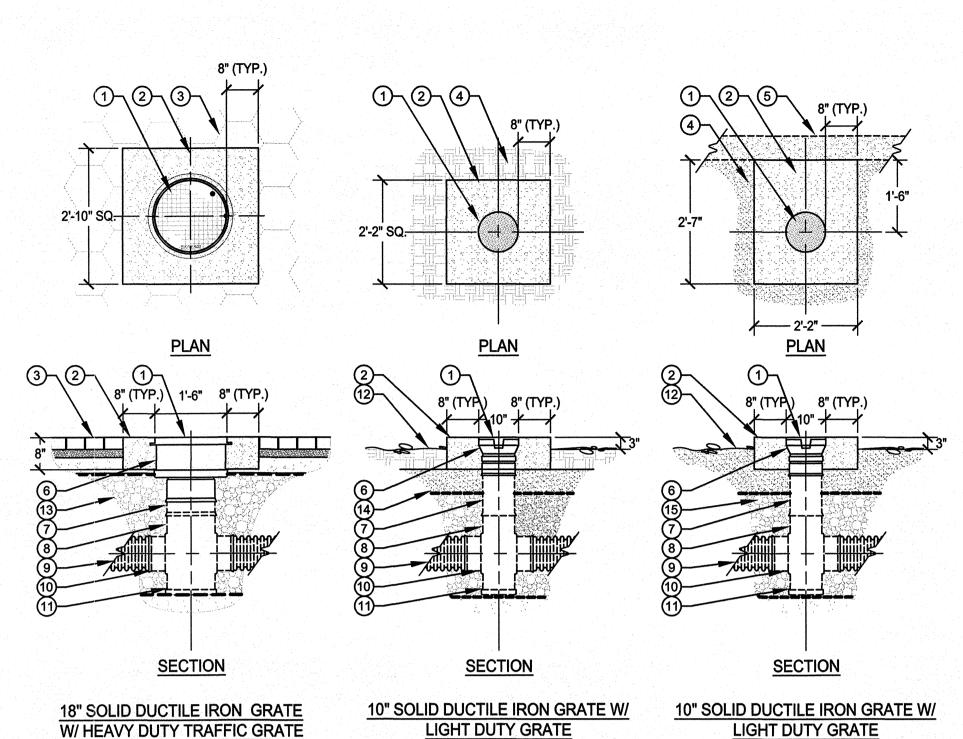

AT PERVIOUS PAVEMENT 1) DUCTILE IRON, SOLID GRATE 2) CONCRETE COLLAR (2) CONCRETE COLLAR
(3) PERVIOUS PAVEMENT (B)
(C-6)

(4) SOIL

5) CONCRETE CURB

(6) IRON GRATE FITTING

0) INVERT ELEVATION (11) CLEAN-OUT SUMP

(7) PIPE EXTENSION - LENGTH AS NECESSARY (13) PERVIOUS PAVEMENT FILTER BED (7) PIPE EXTENSION - LENGTH AS NECESSART (19) FLICTIOGO I ALLEMANTER BED (A) PLANTER AREA WITH BIO-SWALE FILTER BED (C-6) (12) FINISHED GRADE

AT PLANTER AREA WITH BIO-SWALE

DRAINAGE

NO SCALE

SOLID GRATE & COLLAR

AT FILTER BED

F DRAINAGE NOT TO SCALE

IRON RAIL AND GRATE

TRENCH DRAIN

_____ 6" CONCRETE


✓ 4" CLASS 2 BASE


→ 95% COMPACTED SUBGRADE

~ CONCRETE SEE NOTE 2

LOAD CLASS E ADJACENT TO ASPHALT

TYPE 1 NOTE: 1. NO PROTECTION BAR IS REQUIRED FOR TYPE 1 INLET.

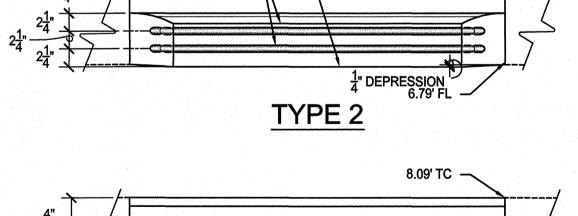

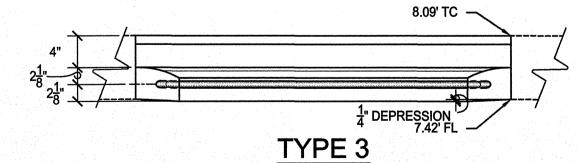

(1) ADJACENT CURB FACE ANGLE - SEE ANCHOR DETAIL A ON CALTRANS DETAIL D74C.

PROTECTION BAR (TYP.) - SEE NOTE 7 ON CALTRANS DETAIL D72. 4 CURB INLET DEPRESSION/RIM FLEVATION


NOTES:

1. SEE CALTRANS DETAIL OS D72 FOR ACTUAL DETIAL. THIS DETAIL IS TO SHOW PROTECTION BAR PLACEMENT ONLY.



L-DRAI52

PROTECTION BAR/CURB OPENINGS MODIFIED CALTRANS OS D72

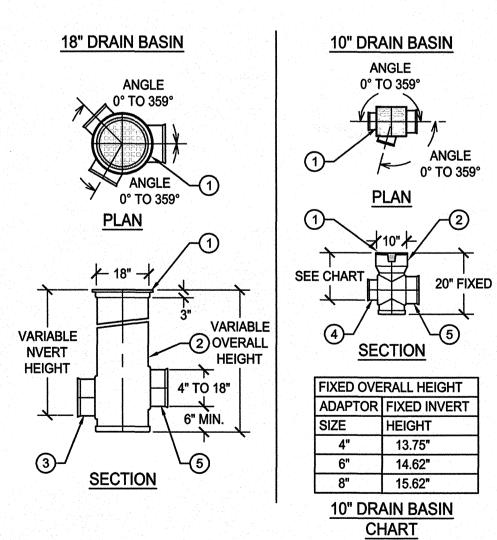

SEE NOTE 3 → ← 6 1/8" —

→ 6" MIN -

ON THE BOTTOM FOR VERTICAL CONNECTION WITH UNDERGROUND PIPING

OCKING SYSTEM SHALL BE FULLY REMOVABLE FROM CHANNE

RESISTANT TO DILUTE ACIDS AND ALKALIS.

TRENCH AT THE LOW END.

RECOMMENDATIONS.

SECTION

IT IS NECESSARY TO ENSURE THE MINIMUM DIMENSIONS SHOWN ARE SUITABLE FOR THE EXISTING

A MINIMUM CONCRETE STRENGTH OF 3000 PSI IS REQUIRED. THE CONCRETE SHALL BE VIBRATED TO

THE FINISHED LEVEL OF THE CONCRETE SURROUND MUST BE APPROX. 1/8" ABOVE THE TOP OF THE

THE SURFACE DRAINAGE SYSTEM SHALL BE POLYMER CONCRETE CHANNEL SYSTEM WITH DUCTILE

REFER TO MANUFACTURER'S LATEST INSTALLATION INSTRUCTIONS FOR COMPLETE DETAILS

CHANNELS WILL BE MANUFACTURED FROM POLYESTER RESIN POLYMER CONCRETE WITH AN NTEGRALLY CAST IN DUCTILE IRON RAIL AND SUPPLIED WITH DUCTILE IRON GRATES.

THE SYSTEM SHALL BE 4 INCHES (100MM) NOMINAL INSIDE WIDTH WITH A 6.3 IN. (160MM) OVERALL WIDTH AND A BUILT-IN SLOPE OF 0.6%. ALL CHANNELS SHALL BE INTERLOCKING WITH A MALE/FEMALE

THE CHANNEL SYSTEM SHALL BE INDEPENDENTLY CERTIFIED TO WITHSTAND LOADINGS TO LOAD CLASS F (DIN19580). GRATES SHALL BE SECURED USING A BOLTLESS LOCKING SYSTEM. GRATE AND

POLYMER CONCRETE SHALL HAVE MATERIAL PROPERTIES OF: COMPRESSIVE STRENGTH RANGE

BE RESISTANT TO PROLONGED SALT EXPOSURE, REPETITIVE FROST CYCLES AND CHEMICALLY

10. THE SYSTEM SHALL BE INSTALLED WITH AN INTEGRAL CATCH BASIN & BUCKET LOCATED WITHIN THE

11. THE SYSTEM SHALL BE INSTALLED IN ACCORDANCE WITH THE MANUFACTURER'S INSTRUCTIONS AND

JOINT. EACH CHANNEL SHALL HAVE A 4.5 IN. (114MM) SCHEDULE 40 AND 6 IN. (150MM) OVAL DRILL-OUT

----- 6" MIN ∤----

1) DUCTILE IRON GRATE (2) PVC BODY 3 INLET AND OUTLET ADAPTORS AVAILABLE 4" THRU 18" 4 INLET AND OUTLET ADAPTORS AVAILABLE 4" THRU 8" - SEE CHART VARIOUS TYPES OF OUTLETS WITH WATERTIGHT ADAPTORS:
SDR-35 SEWER
CORRUGATED POLYETHYLENE
SCHEDULE 40 DWV
RIBBED PVC

C-6

DRAINAGE

STANDPIPE/CLEANOUT NO SCALE



KEVIN BYRON BRANDT

WBS NO. B-00603

Stantec Consulting, Inc. 277 Rancheros Drive Suite 300 San Marcos, CA 92069

Tel. (760) 891-3200 Fax. (760) 891-3201 www.stantec.com

Exp. 6/30/10 CIVIL


PLANS FOR THE CONSTRUCTION OF **KELLOGG PARK GREEN LOT**

DRAINAGE DETAILS

RCE 54873 EXP. 6-30-10 DATE

CITY OF SAN DIEGO, CALIFORNIA ENGINEERING AND CAPITAL PROJECTS DEPARTMENT 121593 NO. SHEET 8 OF 13 SHEETS JEFF SORIANO FOR CITY ENGINEER DATE ASSOCIATE ENGINEER DATE FILMED DESCRIPTION DRAWN BY **WILLIAM MEREDITH ORIGINAL** STANTEC PROJECT ENGINEER CONTROL CERTIFICATION 252-1689 LAMBERT COORDINATES ONTRACTOR DATE STARTED 35278-8 -D

SHEET SIZE AND SCALE: "IF SHEET SIZE IS LESS THAN 24" X 36", IT IS A REDUCED PRINT SCALE ACCORDINGLY."

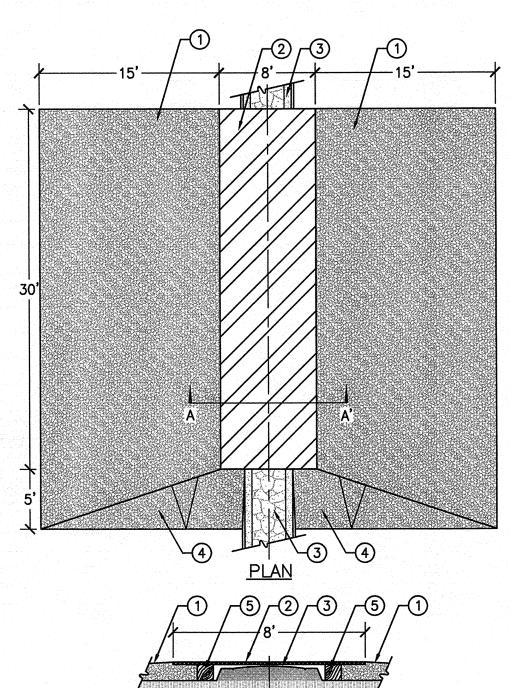

1 ASPHALT - COMPACTED COLD 2) STEEL TRENCH PLATES 3 EXISTING MEDIAN - PROTECT IN PLACE 4 ASPHALT - COMPACTED COLD MIX SIDE SLOPE

NOTES:

1. ASPHALT COLD PACK RAMP TO BE MAINTAINED DURING CONSTRUCTION TO THE SATISFACTION OF THE RESIDENT ENGINEER.


2. TIMBERS SHALL BE SIZED TO ACHIEVE A 2" MIN. GAB BETWEEN PLATE AND MEDIAN WITH A SINGLE TIMBER (NOT STACKED OR LAMINATED).


3. MAXIMUM SLOPE OF ASPHALT SHALL BE 5% MAX (NOT INCLUDING SIDE SLOPES)



OVER MEDIAN

NOT TO SCALE

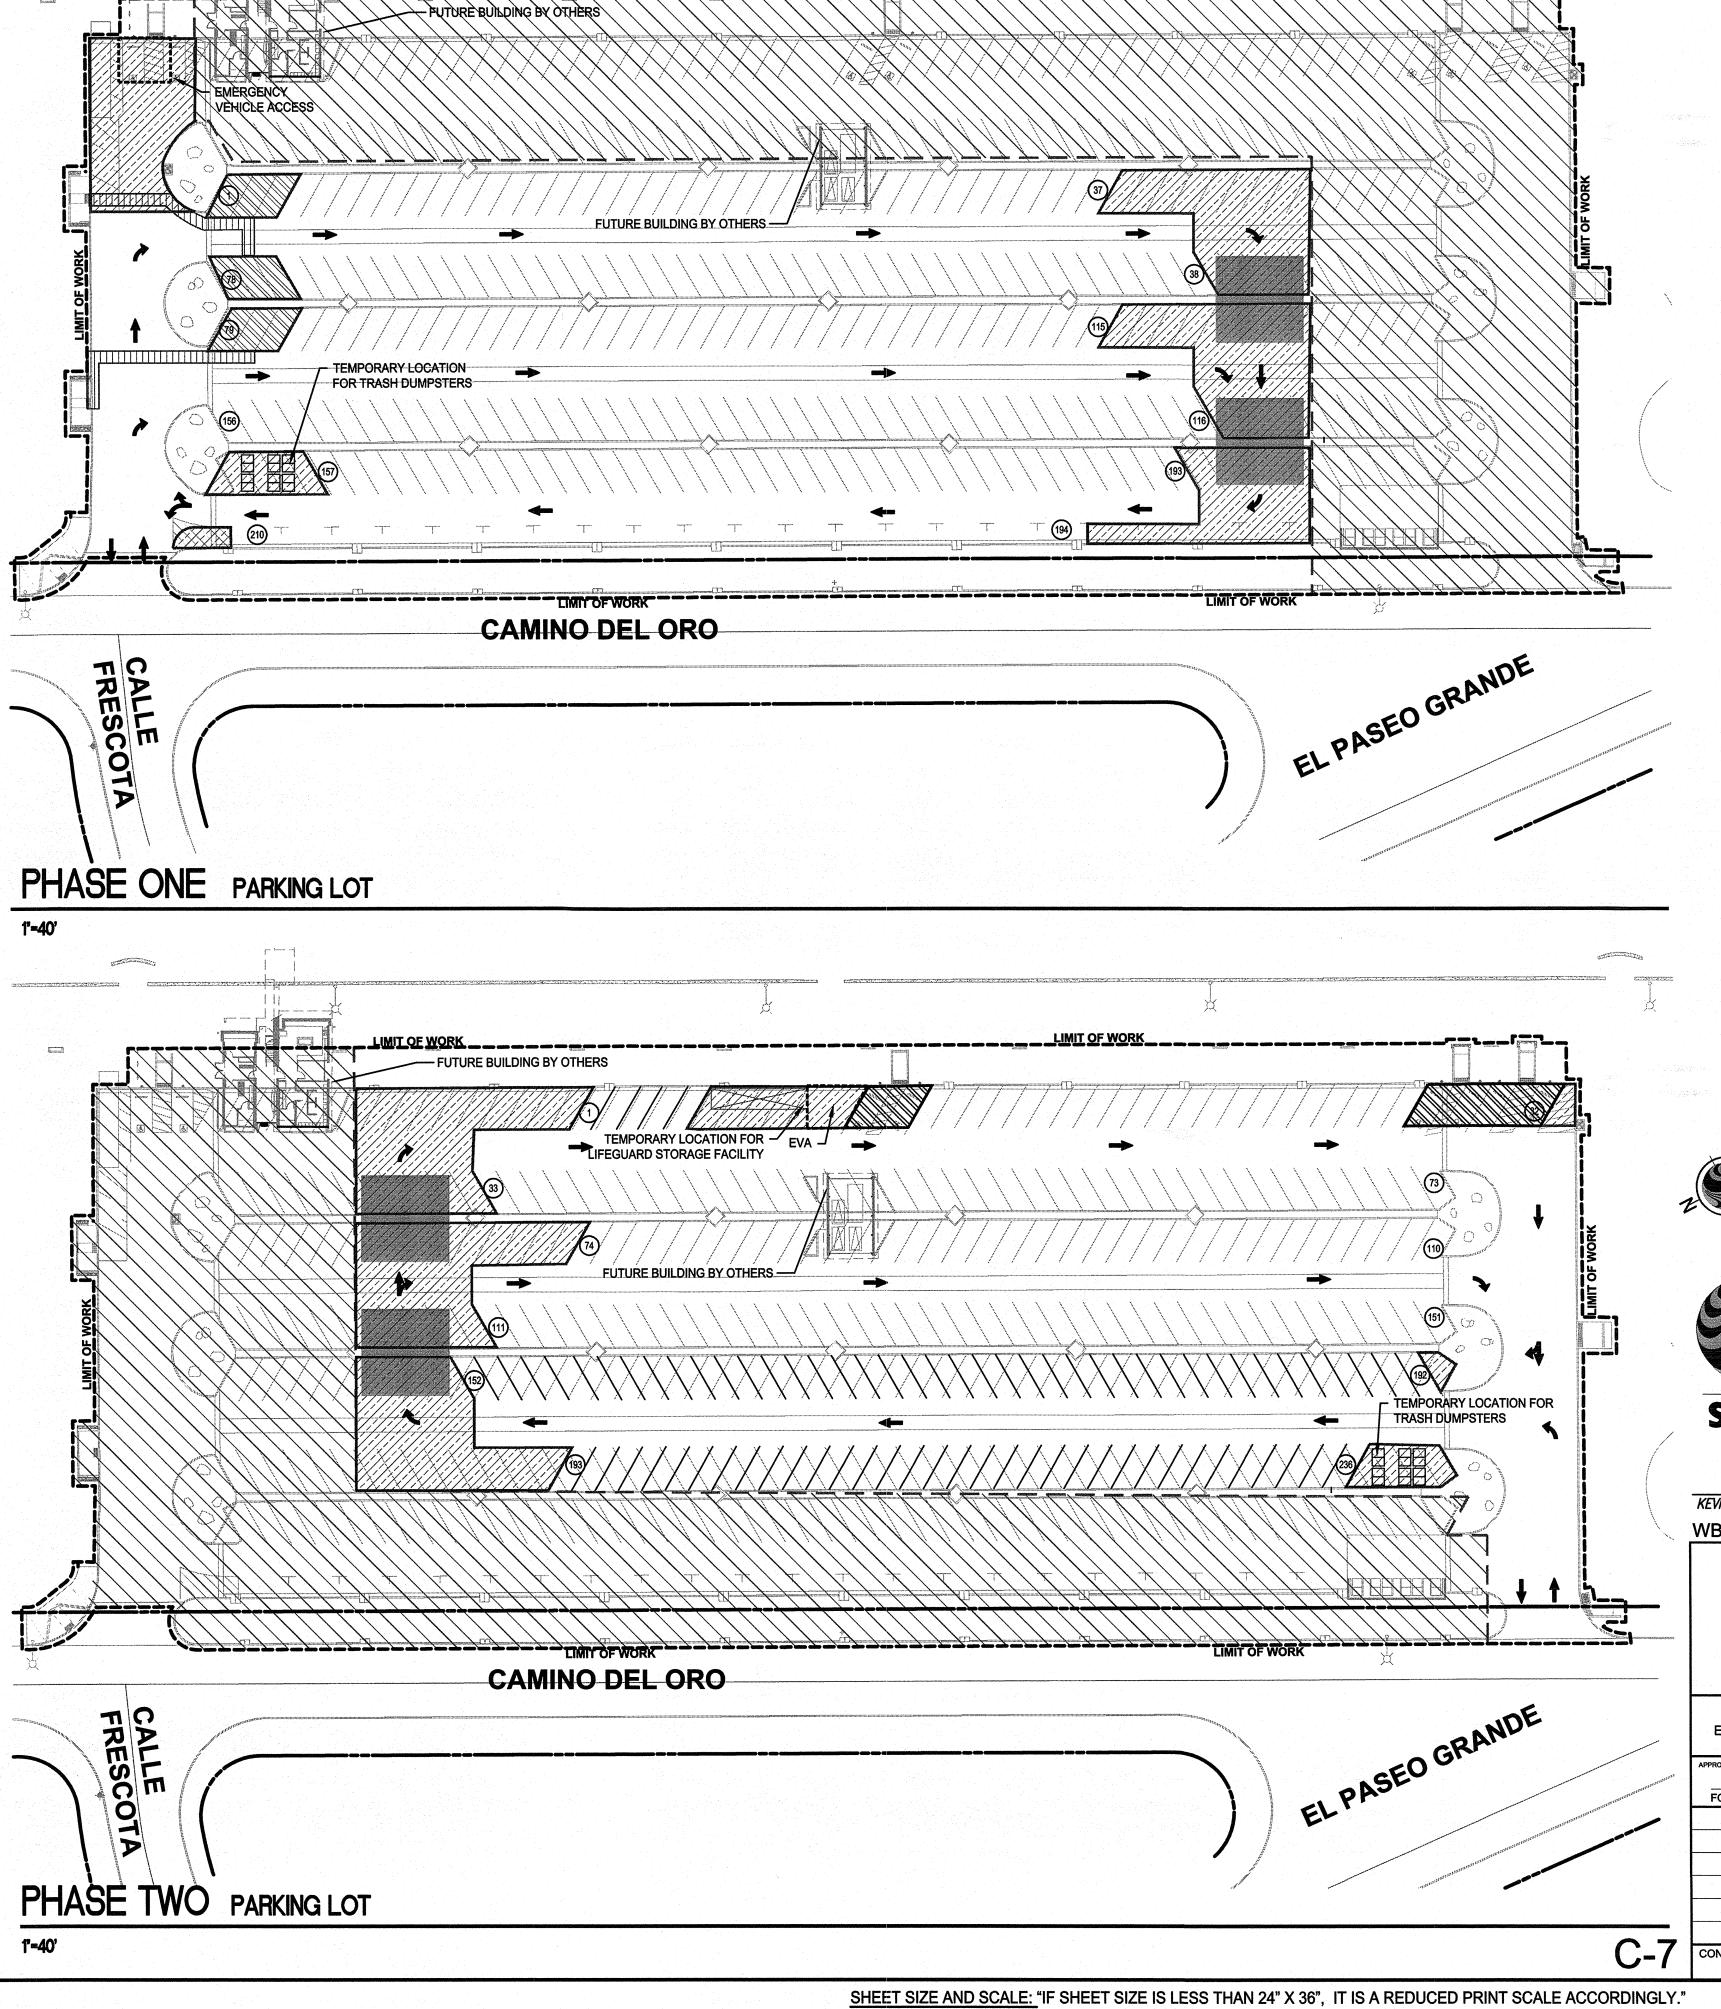

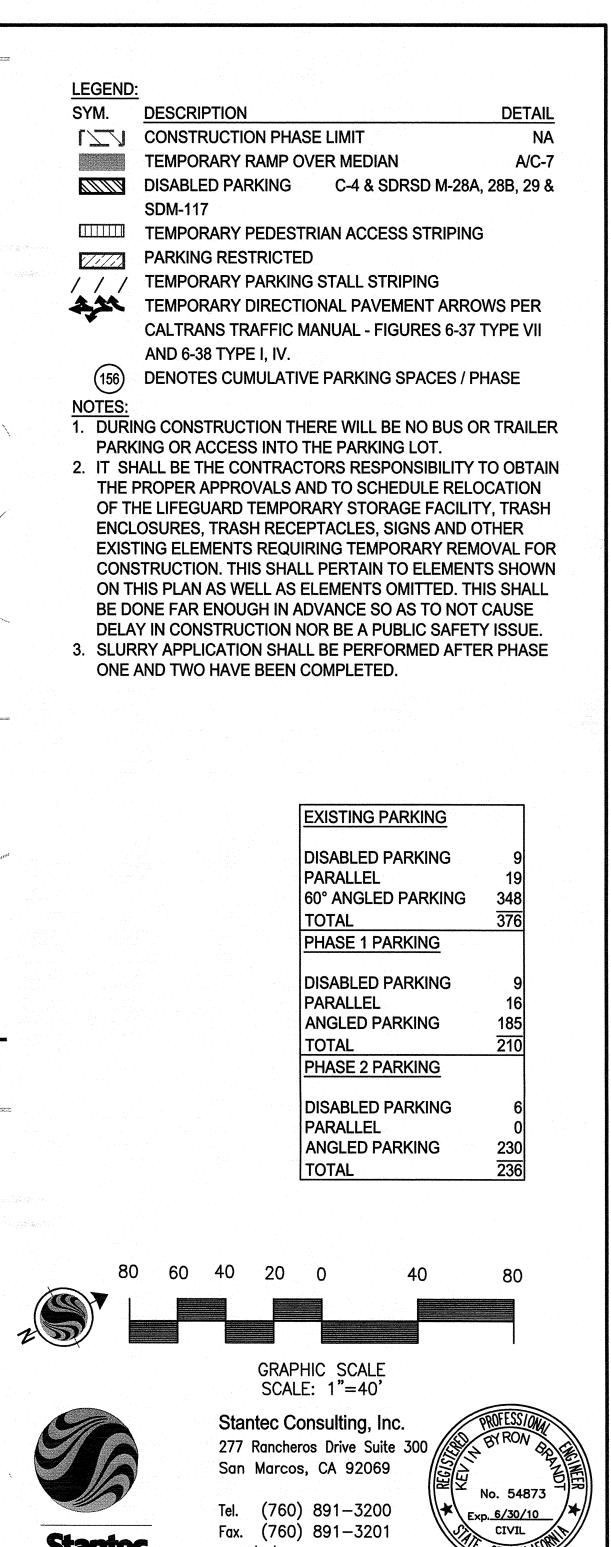





KEVIN BYRON BRANDT RCE 54873 EXP. 6-30-10 DATE WBS NO. B-00603


PLANS FOR THE CONSTRUCTION OF KELLOGG PARK GREEN LOT INTERIM ADA ACCESS / STRIPING PLAN


APPROVED:	T 9 OF 13 SHEETS	<u> </u>		SUBMITTED BY: JEFF SORIANO
FOR CITY ENGINEER		DATE		ASSOCIATE ENGINEE
DESCRIPTION	DRAWN BY	DATE	FILMED	WILLIAM MEREDI
ORIGINAL	STANTEC			PROJECT ENGINEER
			10 mm	CONTROL CERTIFICAT
				252-1689
				LAMBERT COORDINAT
CONTRACTOR	DATE STARTED)		35278-9

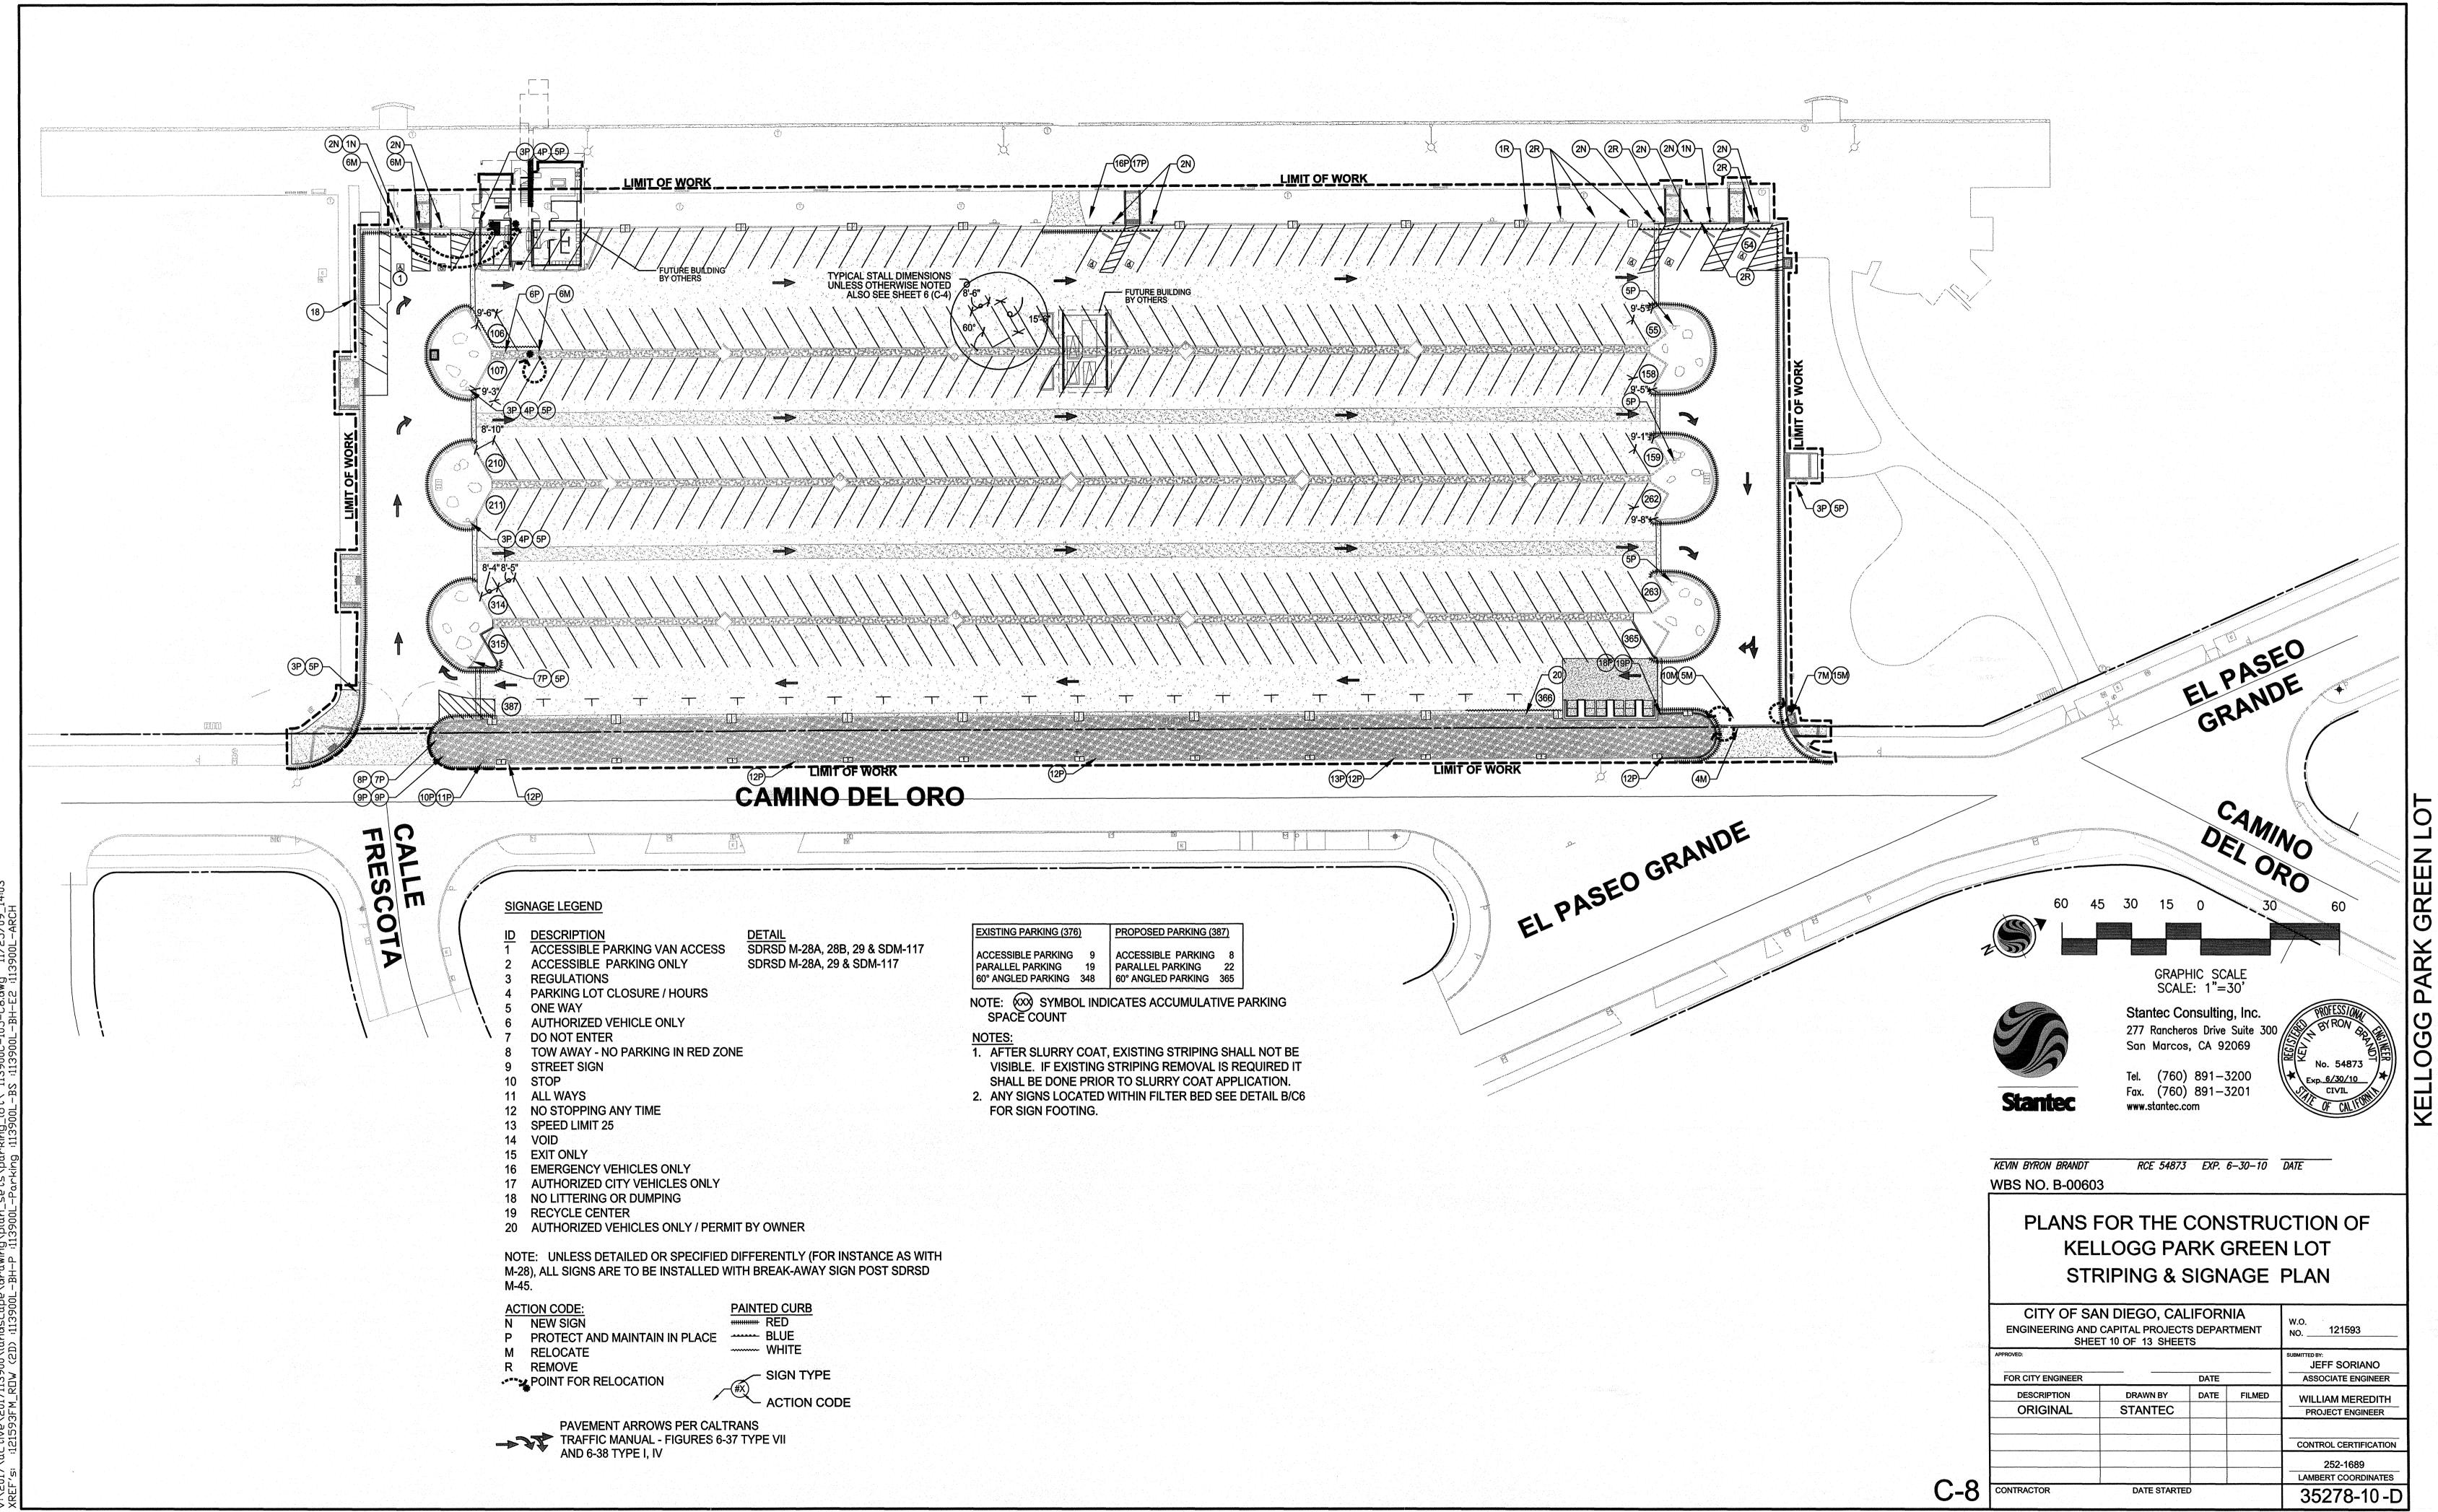

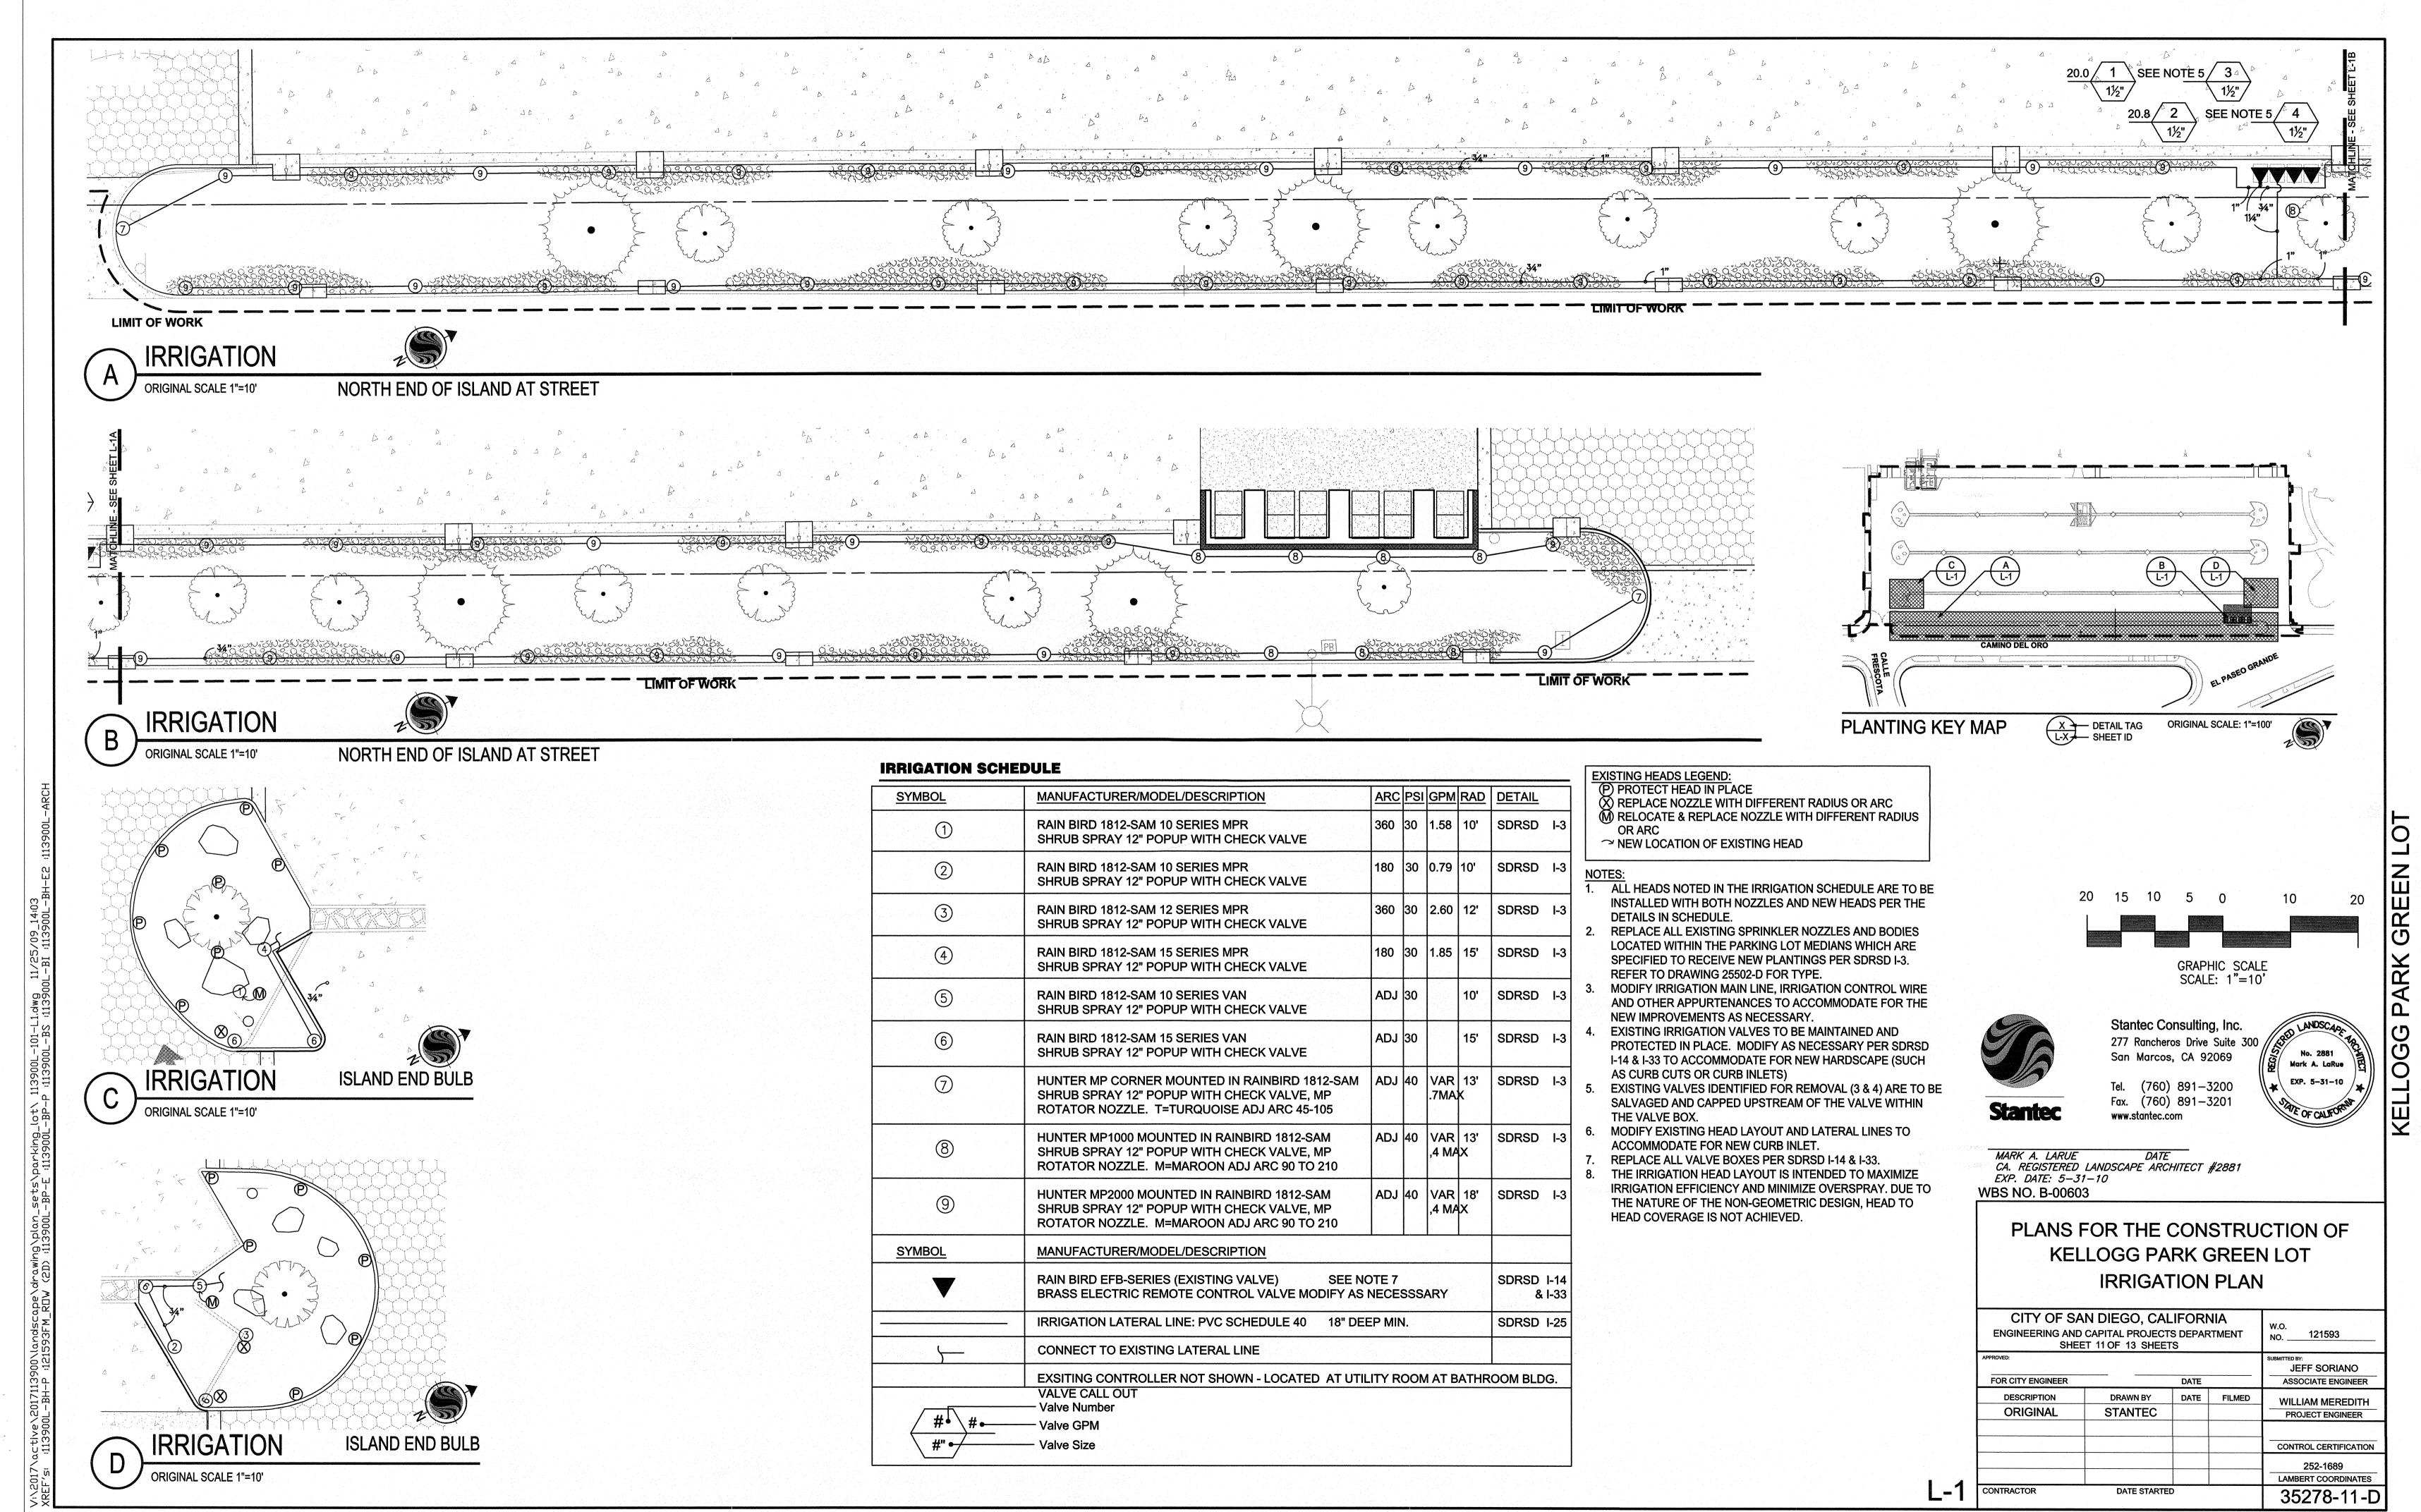



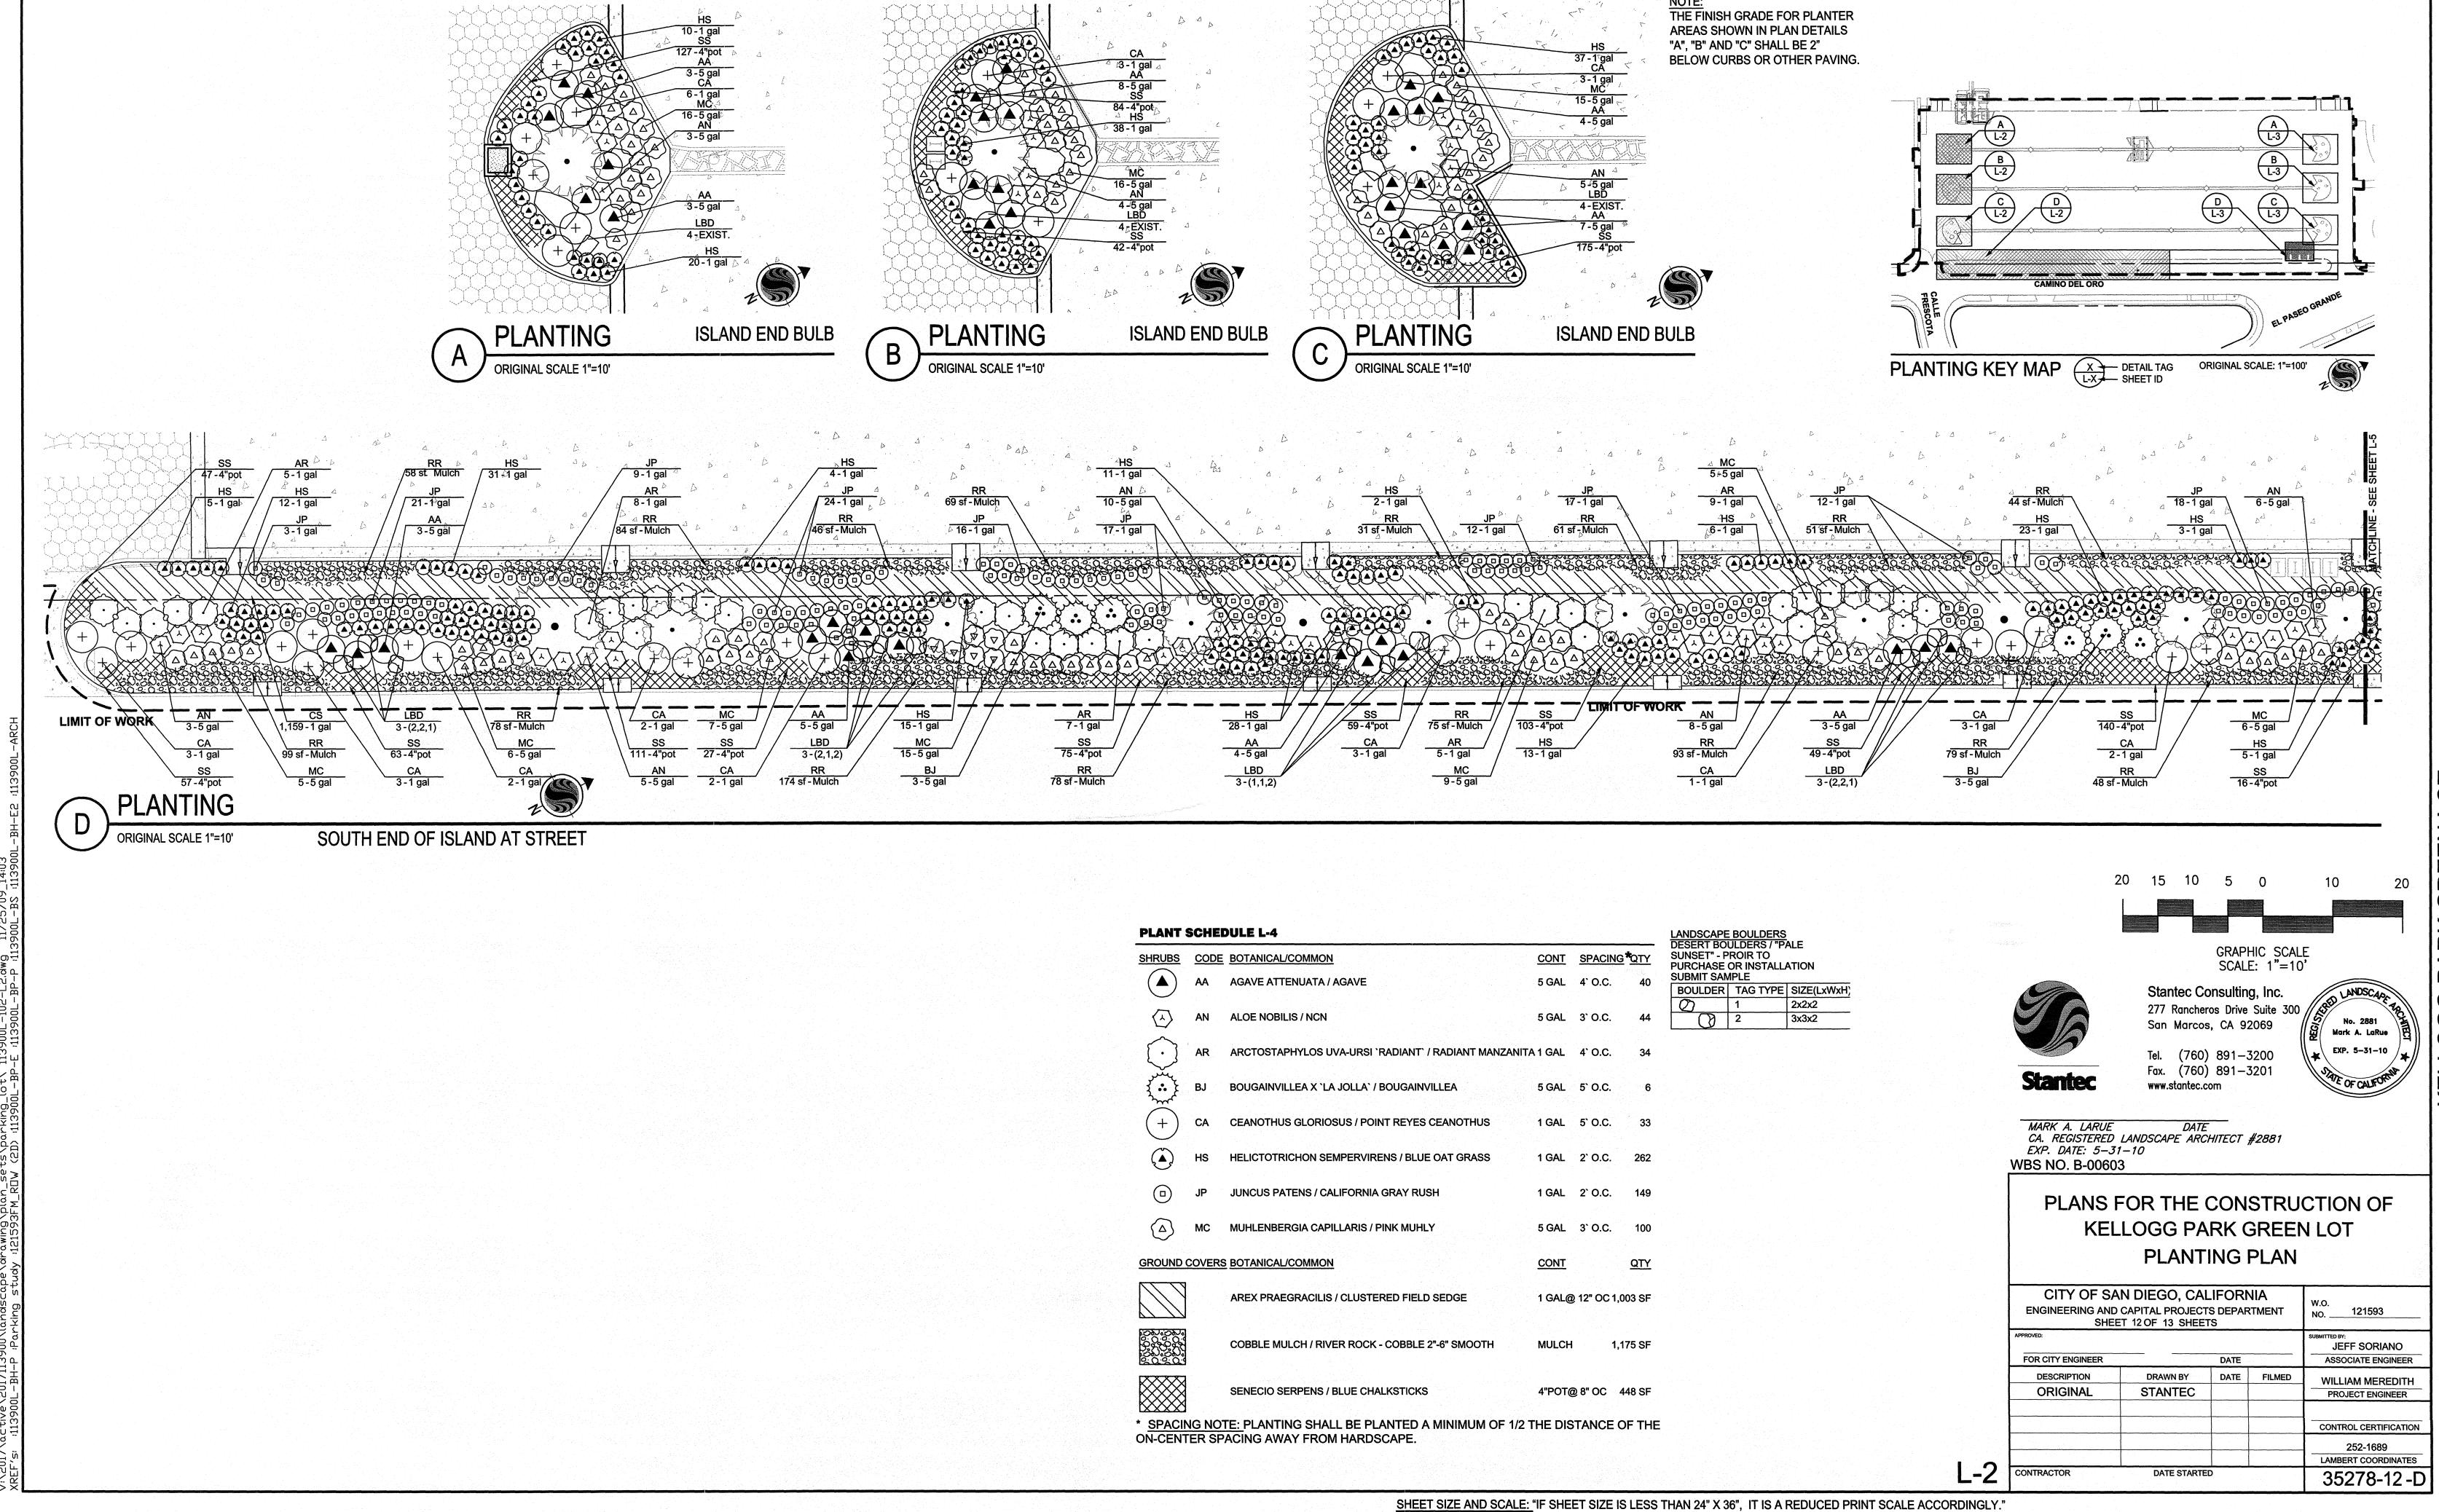


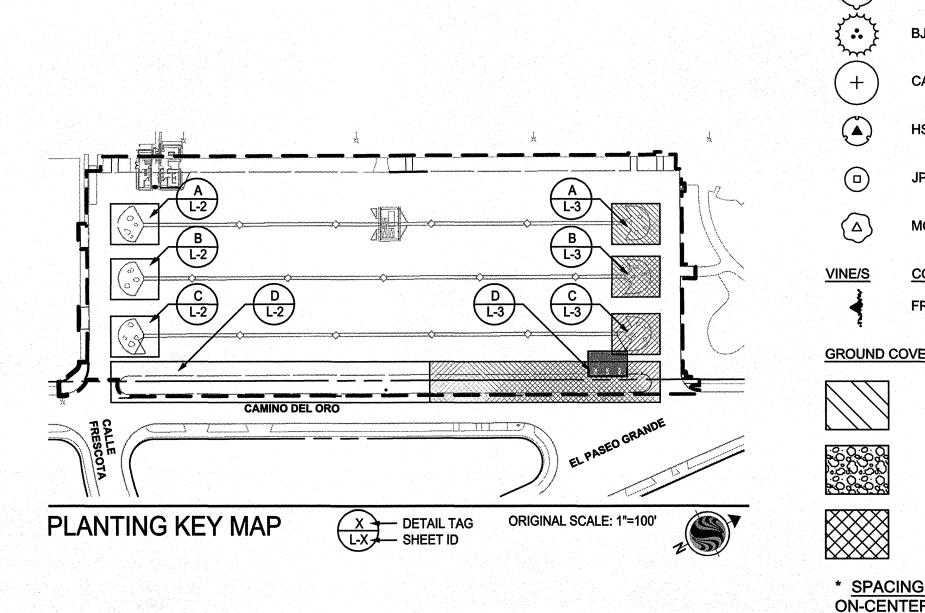


LANDSCAPE BOULDERS
DESERT BOULDERS / "PALE
SUNSET" - SUBMIT SAMPLE
PROIR TO PURCHASE OR SHRUBS CODE BOTANICAL/COMMON INSTALLATION 45 BOULDER TAG TYPE SIZE(LxWxH) AA AGAVE ATTENUATA / AGAVE 2x2x2 3x3x2 AN ALOE NOBILIS / NCN 5 GAL 3` O.C. 35 AR ARCTOSTAPHYLOS UVA-URSI 'RADIANT' / RADIANT MANZANITA 1 GAL 4' O.C. 27 BJ BOUGAINVILLEA X 'LA JOLLA' / BOUGAINVILLEA 5 GAL 5` O.C. 14 CEANOTHUS GLORIOSUS / POINT REYES CEANOTHUS 1 GAL 5` O.C. 28 HELICTOTRICHON SEMPERVIRENS / BLUE OAT GRASS 1 GAL 2` O.C. 202 JUNCUS PATENS / CALIFORNIA GRAY RUSH 1 GAL 2` O.C. 109 MC MUHLENBERGIA CAPILLARIS / PINK MUHLY 5 GAL 3` O.C. 70 CONT SPACING QTY CODE BOTANICAL/COMMON FR FICUS REPENS / CREEPING FIG 1 GAL 3 O.C. 11 GROUND COVERS BOTANICAL/COMMON CAREX PRAEGRACILIS / CLUSTERED FIELD SEDGE 1 GAL@ 12" OC 663 SF COBBLE MULCH / RIVER ROCK - COBBLE 2"-6" SMOOTH MULCH 771 SF SENECIO SERPENS / BLUE CHALKSTICKS 4"POT@ 8" OC 432 SF

* SPACING NOTE: PLANTING SHALL BE PLANTED A MINIMUM OF 1/2 THE DISTANCE OF THE ON-CENTER SPACING AWAY FROM HARDSCAPE.


PLANT SCHEDULE L-5

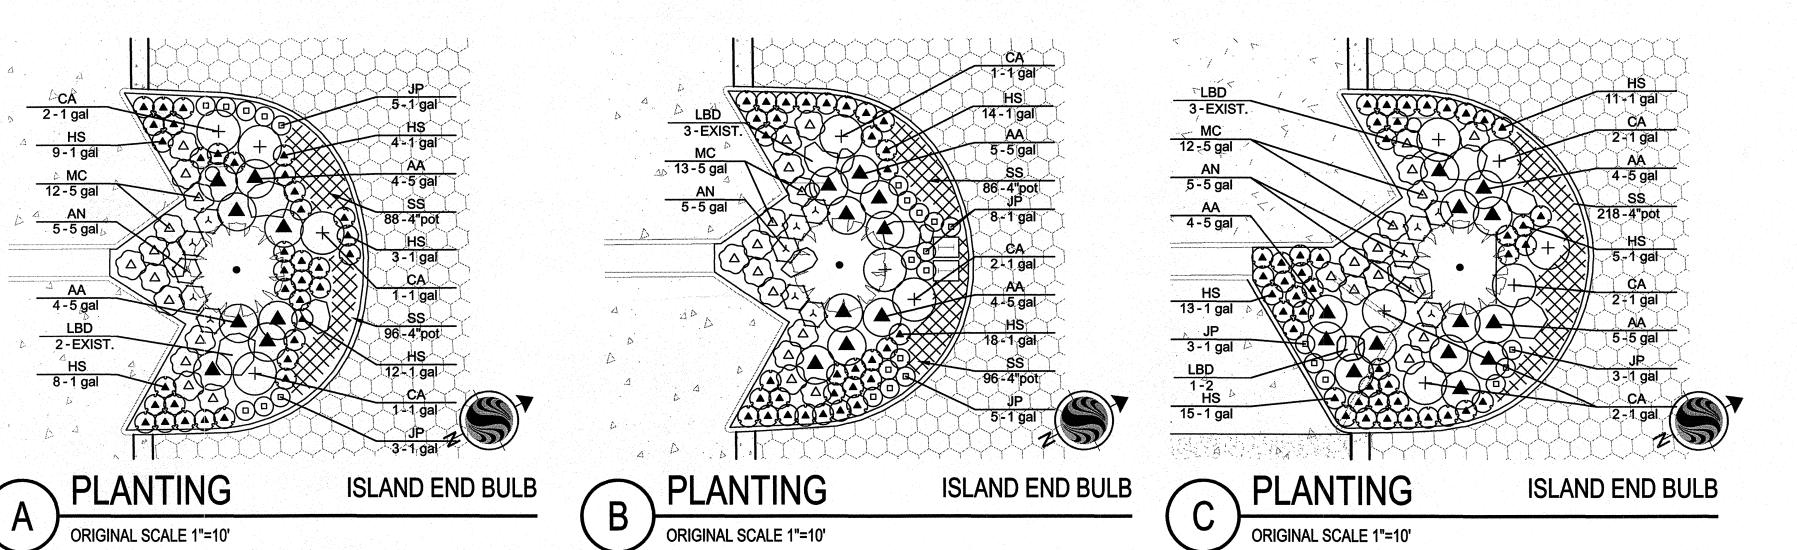

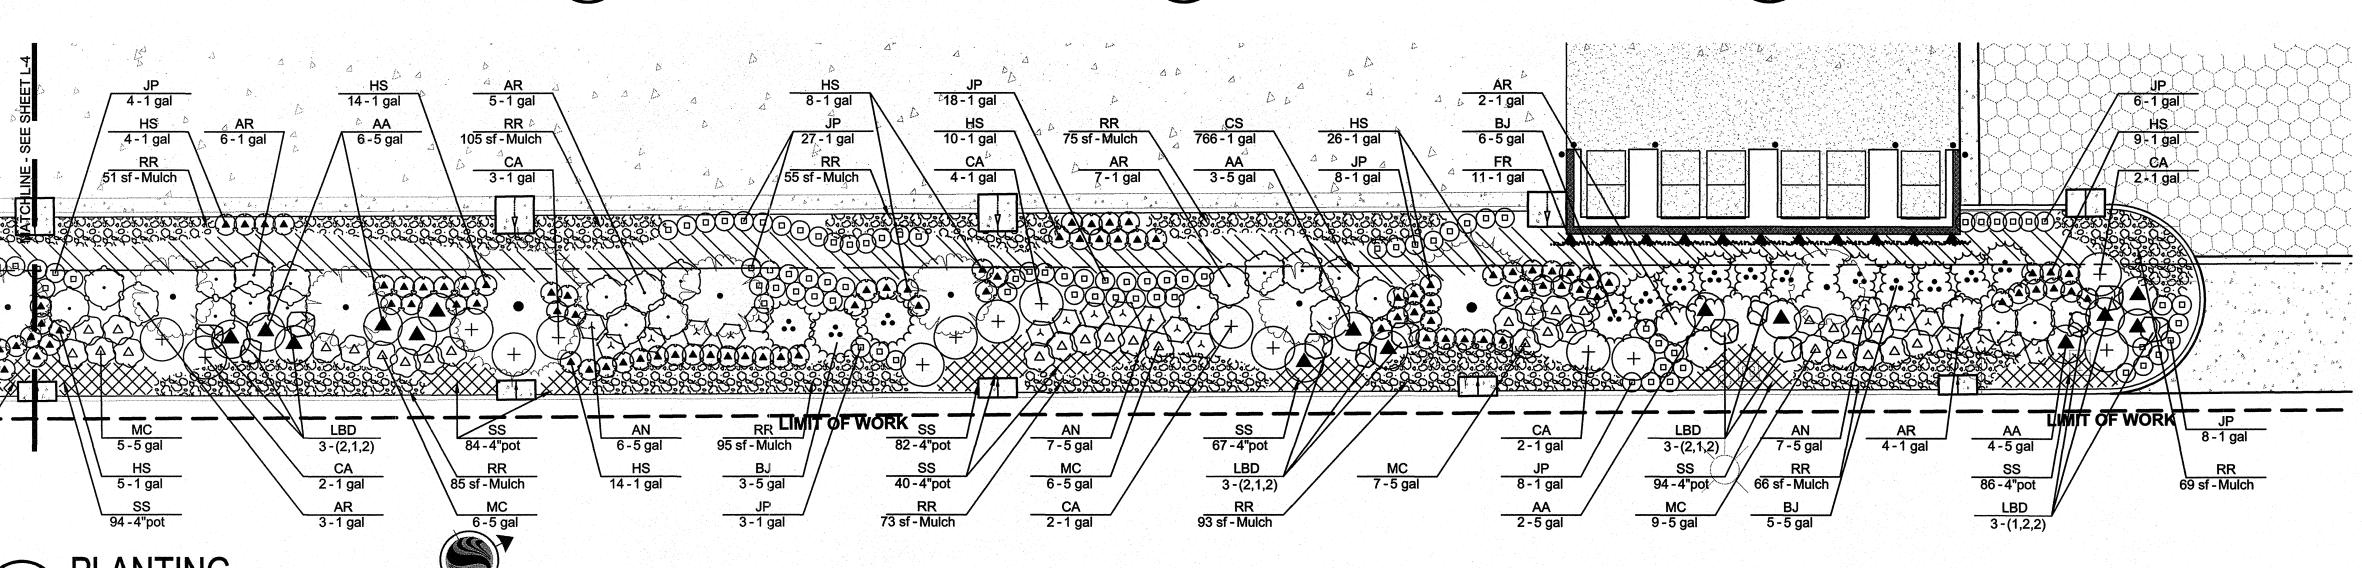

NORTH END OF ISLAND AT STREET

ORIGINAL SCALE 1"=10'

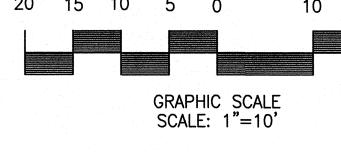



Stantec Consulting, Inc. 277 Rancheros Drive Suite 300 / San Marcos, CA 92069

Tel. (760) 891-3200 Fax. (760) 891-3201 www.stantec.com

MARK A. LARUE DATE
CA. REGISTERED LANDSCAPE ARCHITECT #2881
EXP. DATE: 5-31-10
WBS NO. B-00603

PLANS FOR THE CONSTRUCTION OF KELLOGG PARK GREEN LOT PLANTING PLAN

CITY OF SAI ENGINEERING AND SHEE	w.o. No. 121593				
APPROVED: FOR CITY ENGINEER		DATE		JEFF SORIANO ASSOCIATE ENGINEER	
DESCRIPTION ORIGINAL	DRAWN BY STANTEC	DATE	FILMED	WILLIAM MEREDITH PROJECT ENGINEER	
				CONTROL CERTIFICATION	
				252-1689 LAMBERT COORDINATES	
CONTRACTOR	DATE STARTED			35278-13-D	