




PROPOSED BASEMENT LEVEL ACCESSIBLITY PLAN

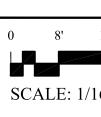

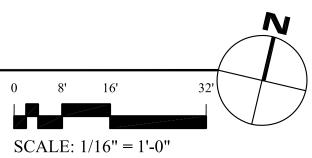








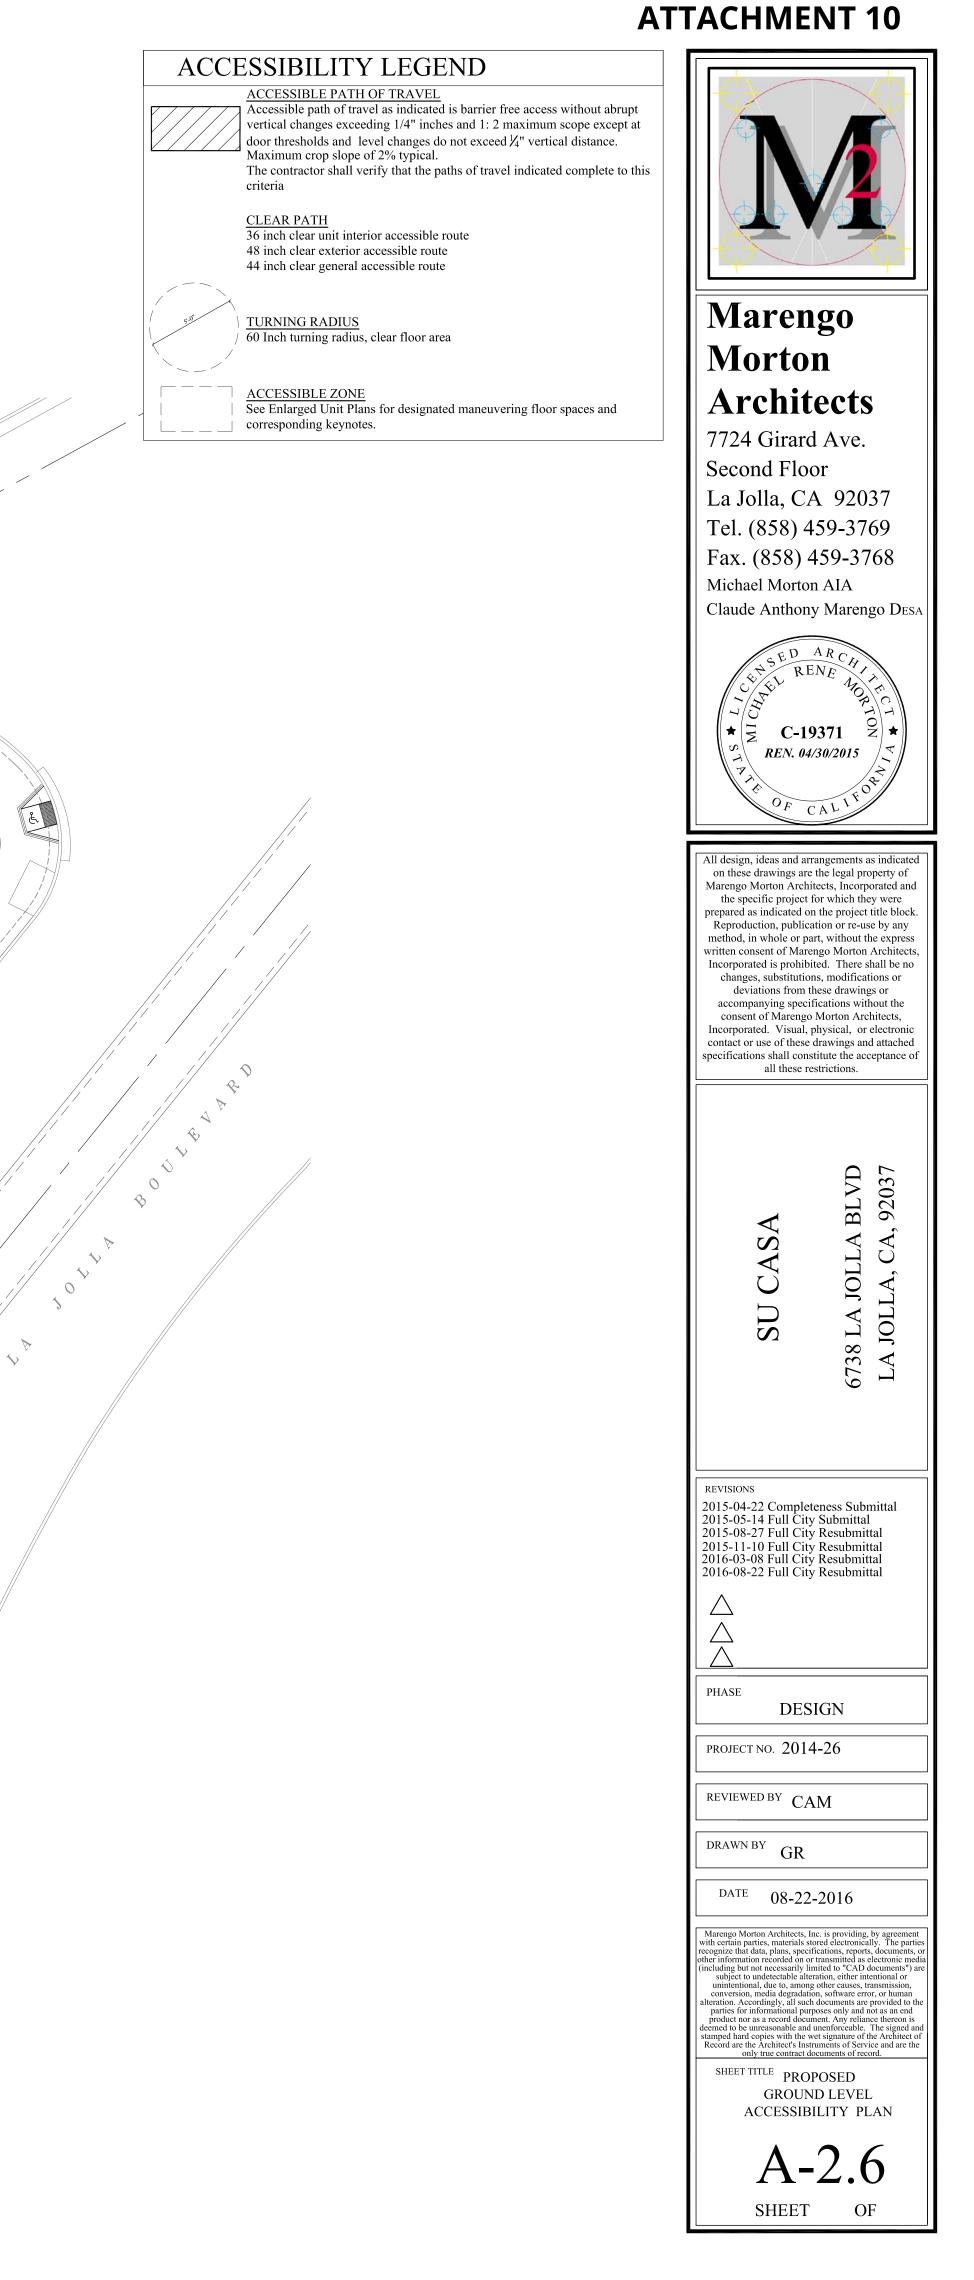




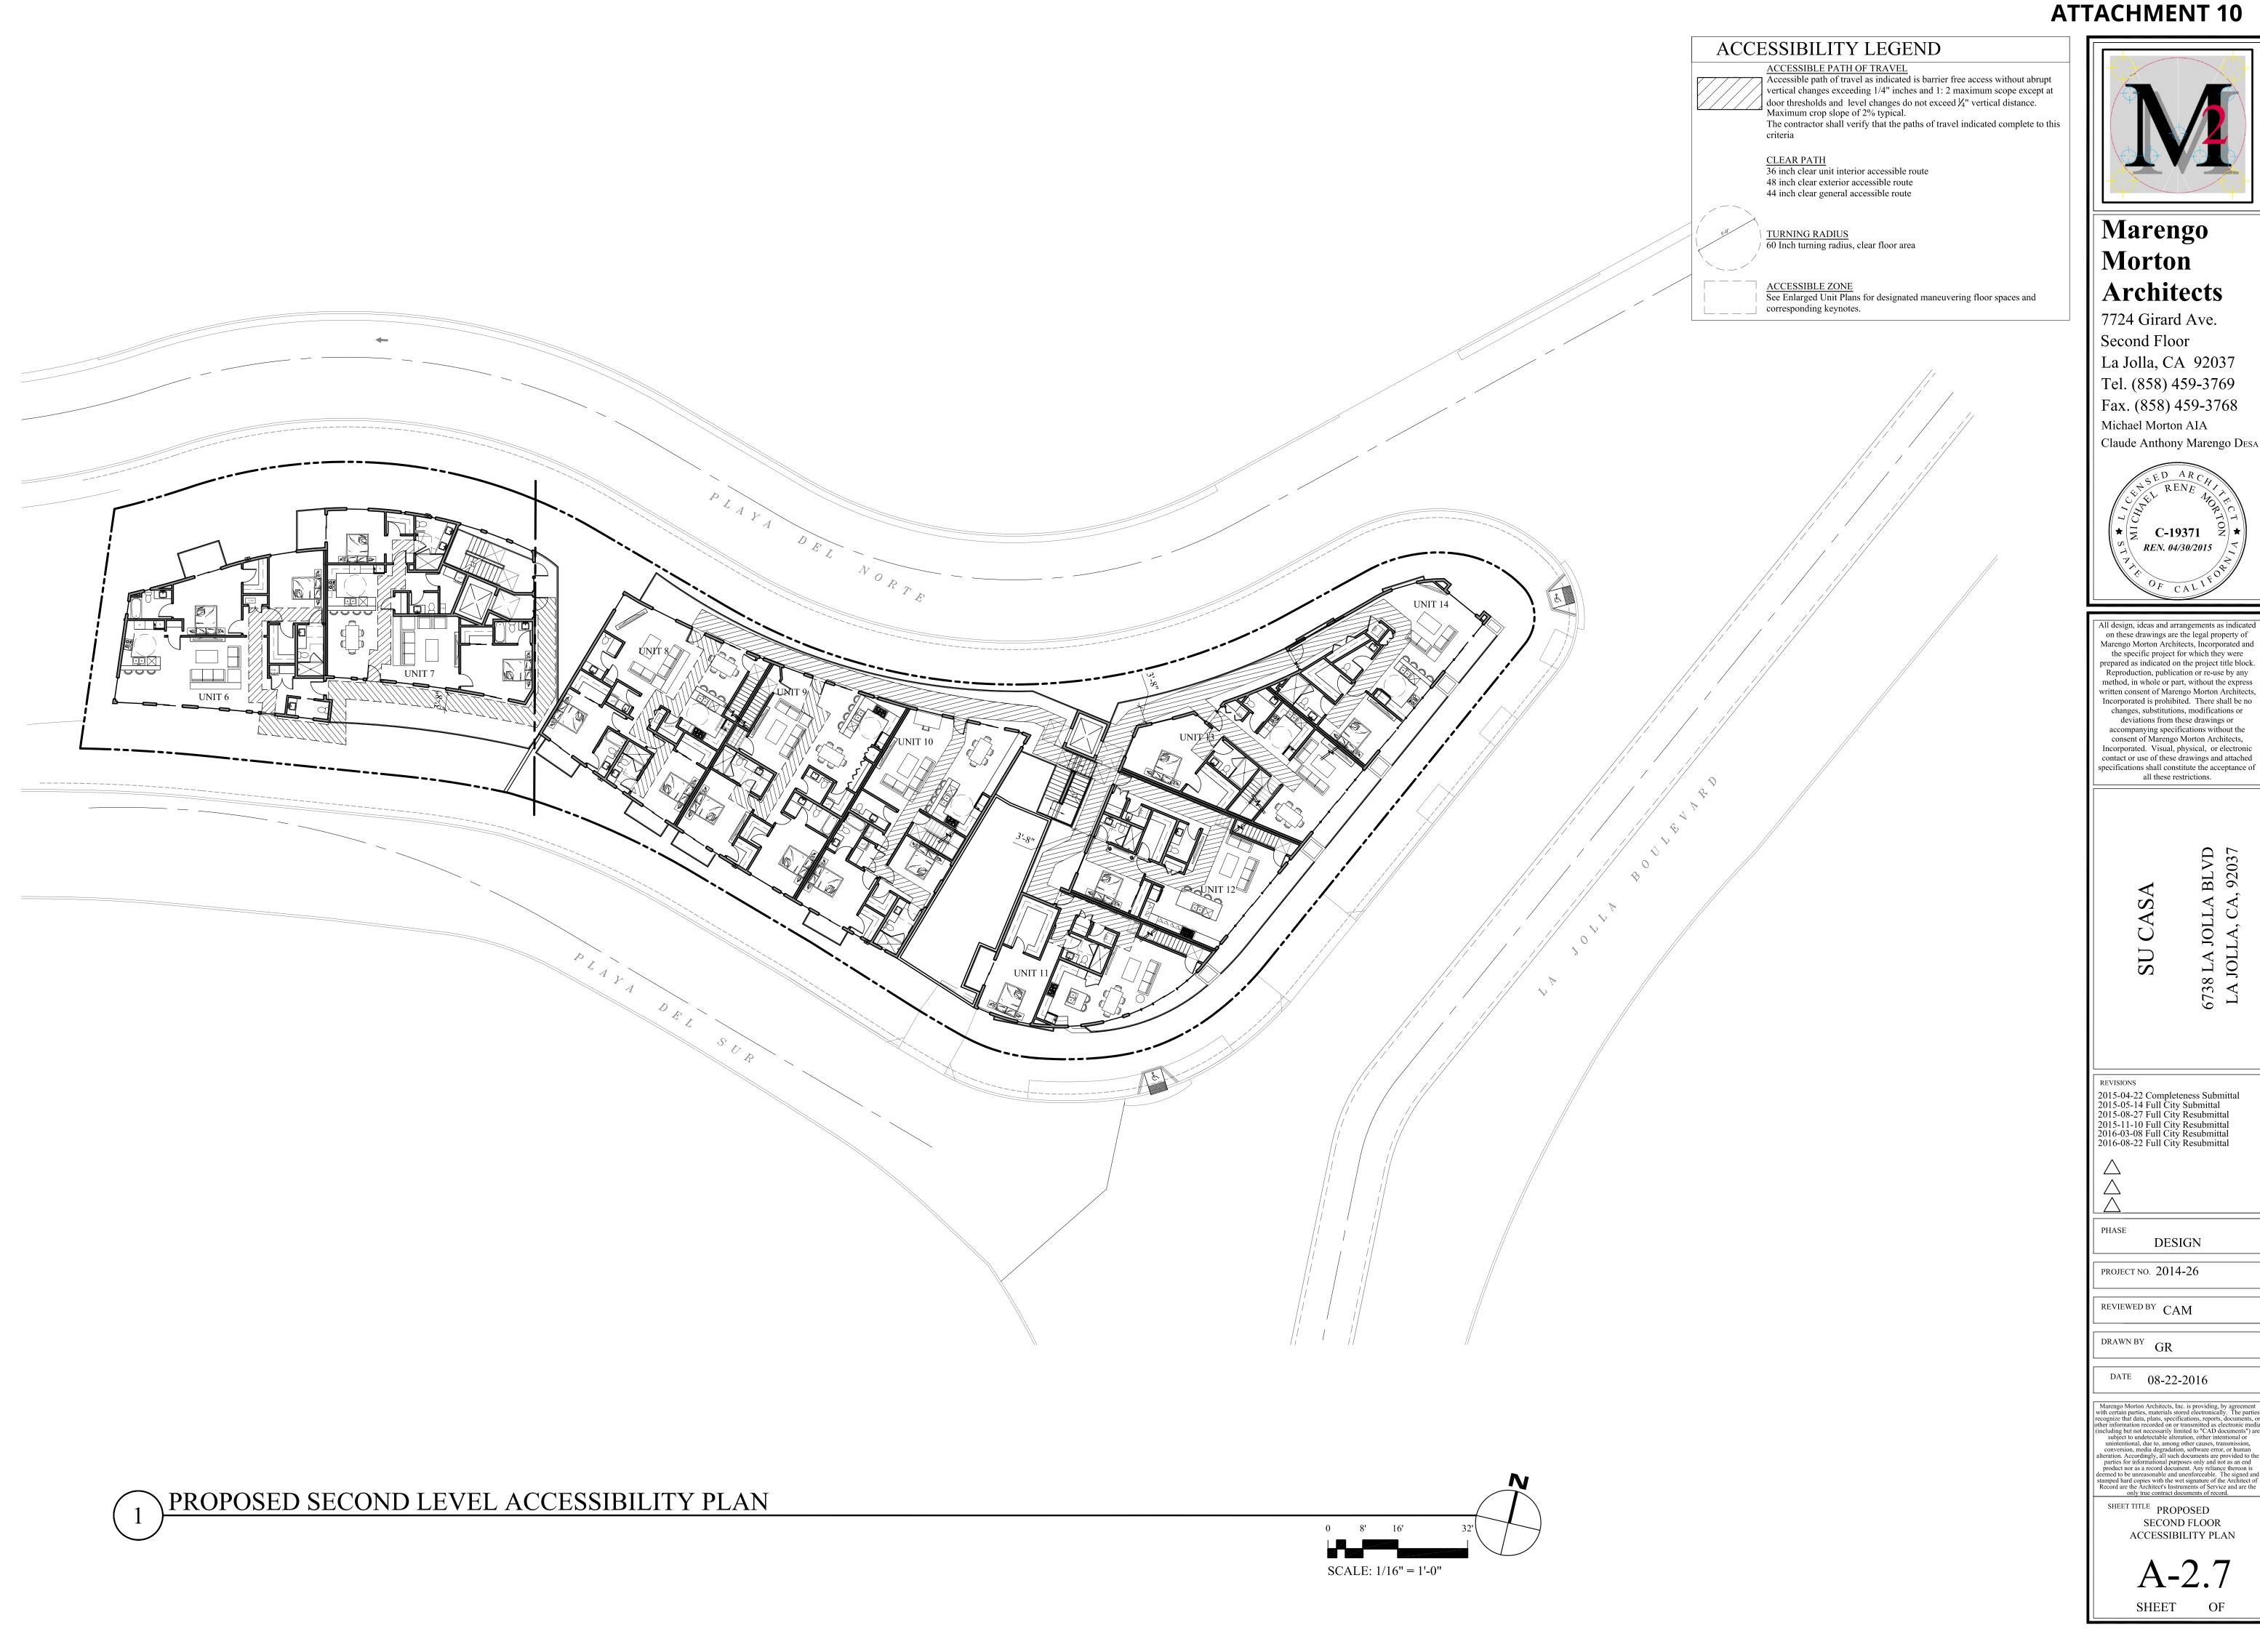

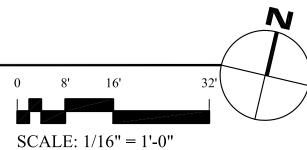

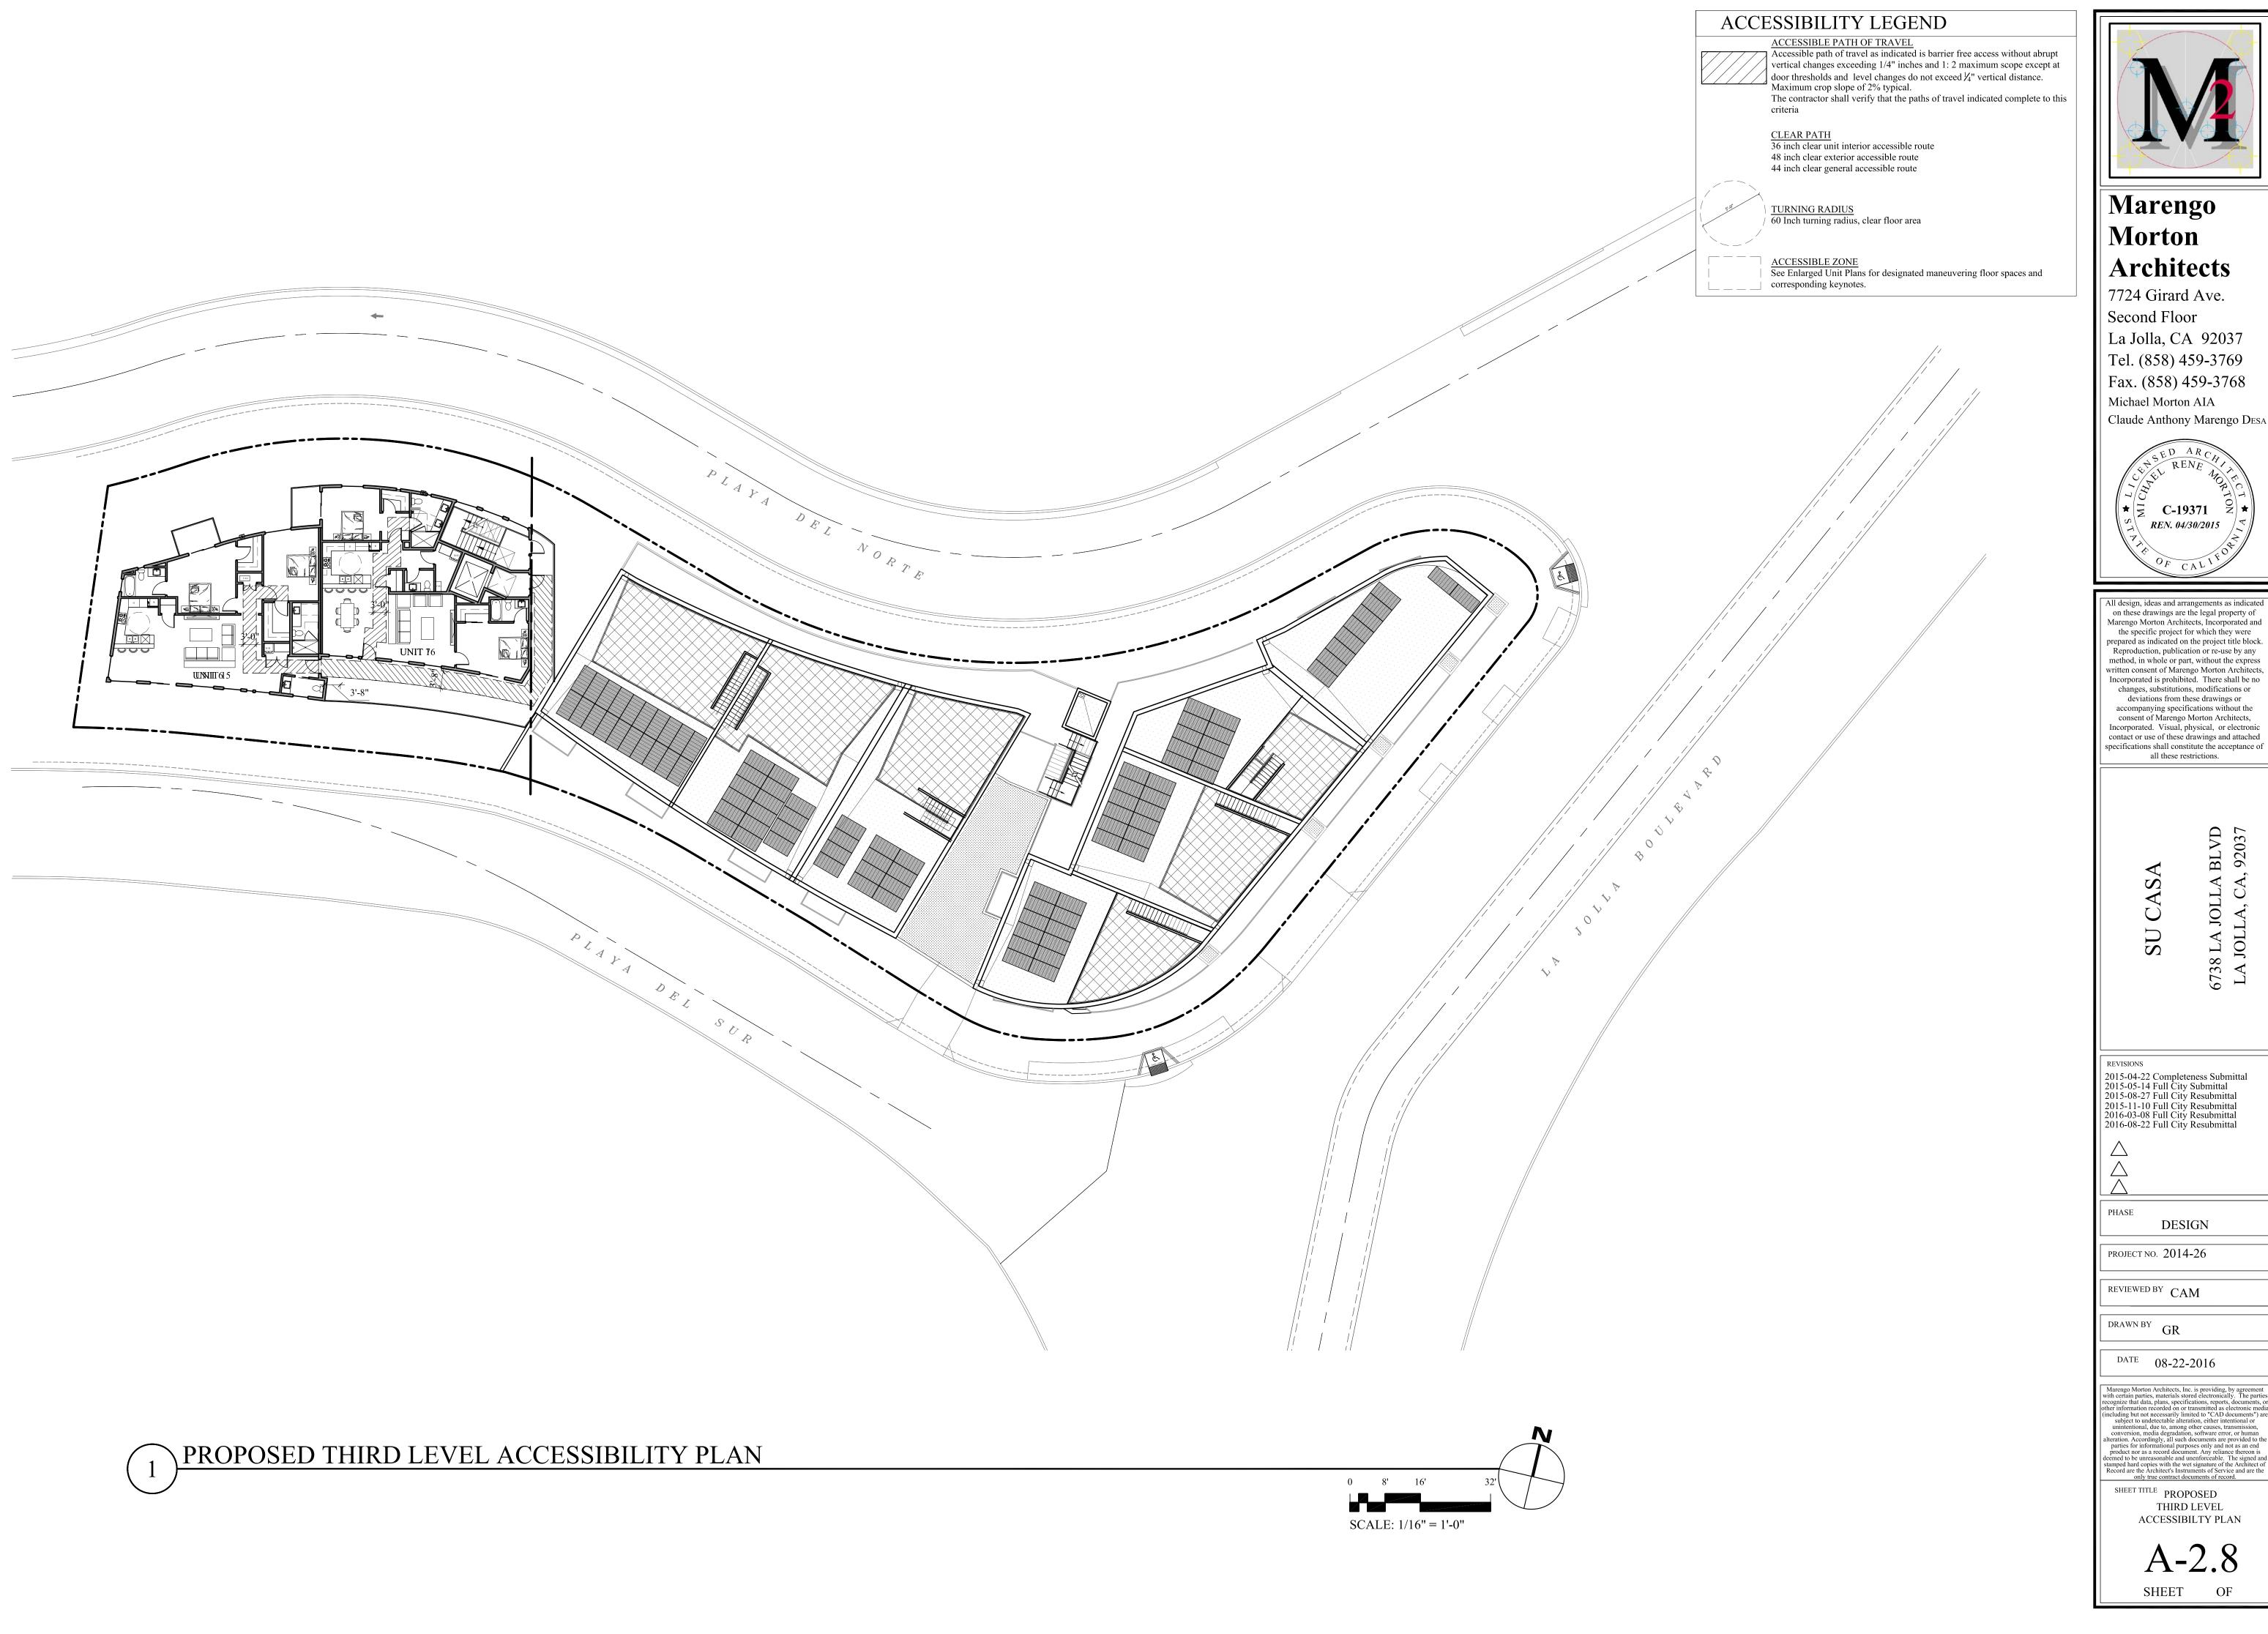

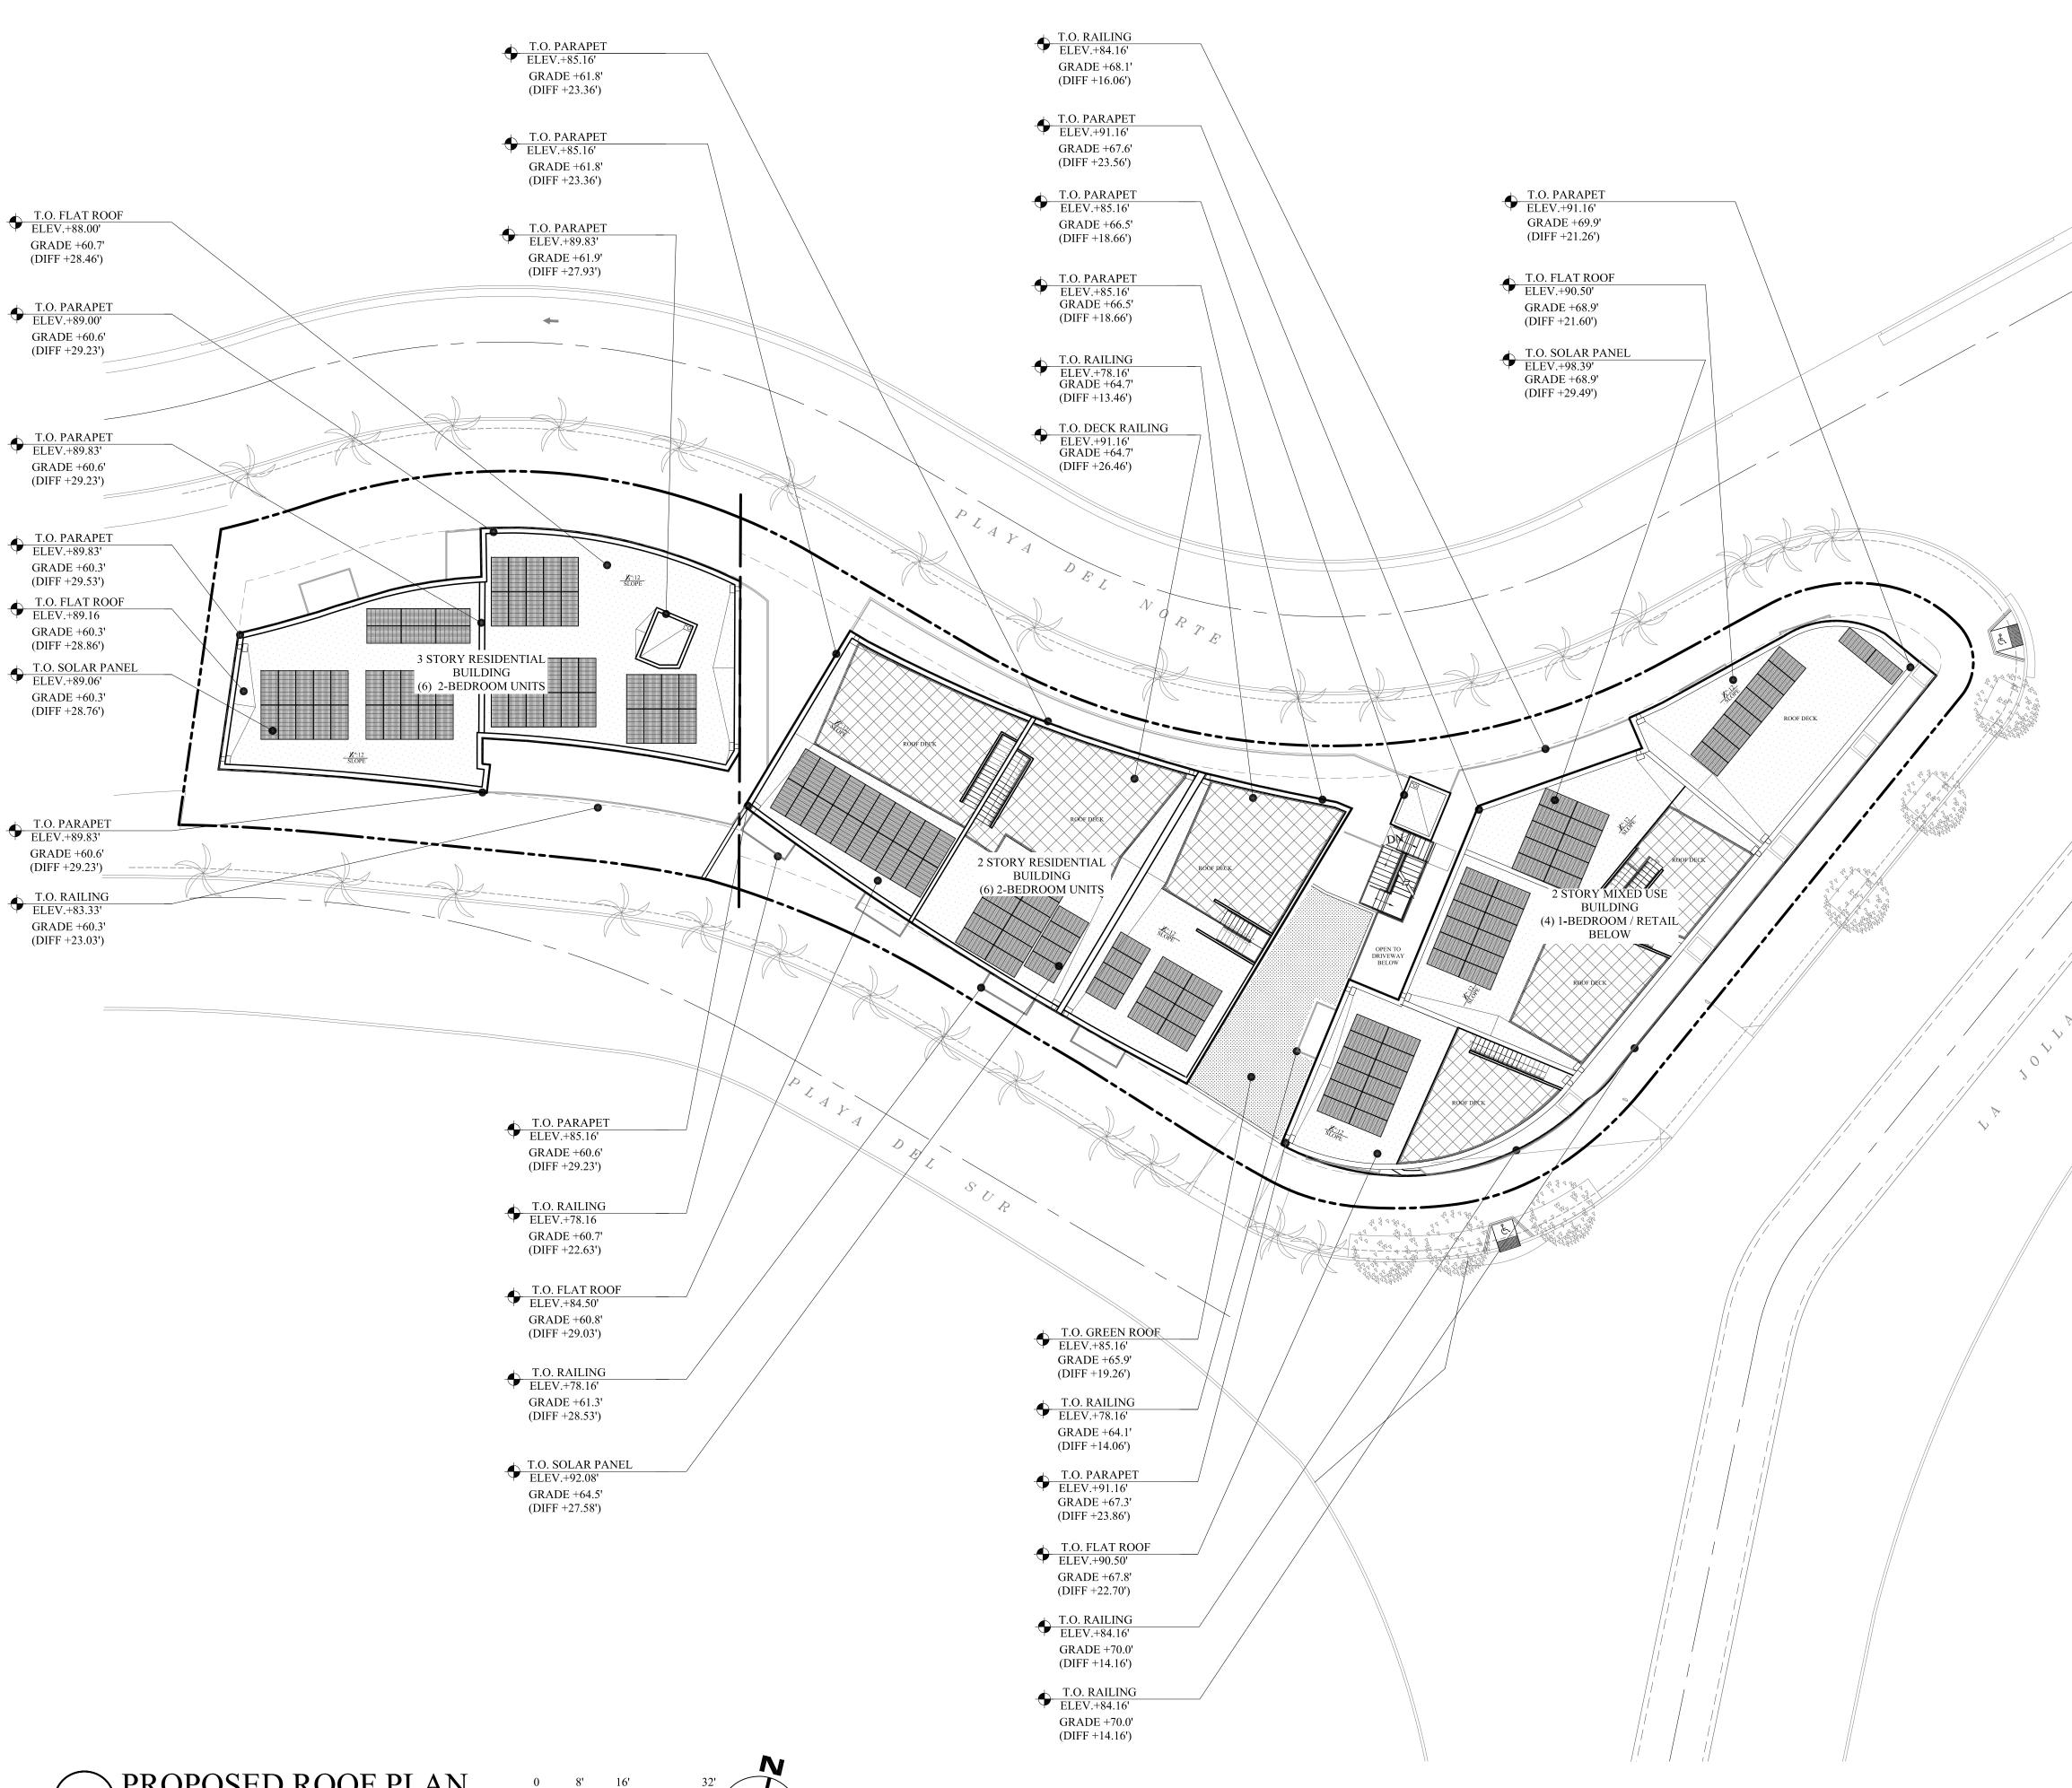



STORM DRAINAGE NOTES

- 1. THE PRIMARY STORM DRAINAGE SYSTEM SHALL CONNECT TO THE BUILDING STORM WATER THAT CONNECTS TO AN UNDERGROUND PUBLIC STORM SEWER
- 2. THE SECONDARY ROOF DRAINAGE SYSTEM SHALL DISCHARGE ABOVE GRADE, IN A LOCATION OBSERVABLE BY THE BUILDING OCCUPANTS OR MAINTENANCE PERSONNEL

HEIGHT NOTES

- 1. THE HIGHEST POINT OF THE ROOF, EQUIPMENT, OR ANY VENT, PIPE, ANTENNA OR OTHER PROJECTION, SHALL NOT EXCEED 30' ABOVE GRADE.
- 2. NO PORTION OF THE PROPOSED STRUCTURE WILL EXCEED THE EXISTING BUILDING HEIGHT. PROPOSED HEIGHT TO BE FIELD VERIFIED TO ENSURE COMPLIANCE

ROOF NOTES


- 1. Roofing Underlayment slope 3:12 or less: "Ice and Water Shield" by W.R. Grace, ESR-1677, or "Winter Guard HT" by Certain Teed Corp. ESR-1492 (or architect approved equal). Install per manufacturer's instructions. Install a #40 fiberglass reinforced felt sheet over roof membrane.
- Counter-slopes: ¼" per 12" (minimum) towards drains created using G-26 (latex -cement) flooring underlayment by <u>Crossfield Products Corp.</u>
 Roof Edge Drip, Metal Flashing, Panel Clips and Counter Flashing: All exterior
- 3. Roof Edge Drip, Metal Flashing, Panel Clips and Counter Flashing: All exterior flashing to be 16 oz copper unless otherwise noted. Solder or seal all seams. Hem all exposed edges.
- Built-Up Roofing System: By <u>GAF</u>, GAFGLAS 4-Ply Hot Mopped Modified Bitumen Mineral Surfaced Roofing System. Proved a ¼" per foot minimum roof slope. Install per manufactures instruction. Roofing system shall have a minimum 10 year labor and material warranty. Per specification Division 7.1, section G. For Flashing, "Springlok" flashing system, Type STX. By <u>Fry Reglet Corp</u>. Material 26 ga. Provide "Windlok" clips and prefabricated mitered corner sections. Install per manufacturer's specifications. <u>Roofing system shall be a UL class "A" rated</u>. ICC Report ESR-1274.
 Plumbing Vent: ABS plastic to be flashed with <u>Carlisle-Syntec</u> TPO Pre-Molded pipe
- Frumbing Vent: ABS plastic to be hashed with <u>Cartisle-Syntec</u> 1PO Pre-Molded pipe flashing.
 Parapet, Transitions and other Horizontal Stucco Surface Waterproofing: Membrane waterproofing shall be UEEV SEAL 140/60 by Protecto Wrop. Extend
- Membrane waterproofing shall be <u>JIFFY SEAL 140/60</u> by <u>Protecto Wrap</u>. Extend membrane a minimum of 6" below edge of parapet, each side. Provide a minimum end lap of 4" over adjoining membrane sheets. Where membrane abuts vertical surfaces, the membrane shall extend 6" up surface, and be overlapped by building wrap. ESR-1127.
- Roof Drain. Roof drain shall be TPO-RD2NH 2" TPO-clad no-hub bottom outlet drain by <u>Thunderbird Products</u> with A.B.S. dome strainer. Telephone (800) 658-2473. Provide 3" I.D. ABS drain lines with min.¼":1' slope. Connect to building storm water.
 Fireplace Vent: Fireplace vent shall be Type B Stainless Steel as required by fireplace
- 8. Fireplace vent: Fireplace vent shall be Type B Stainless Steel as required by hreplace manufacturer. Minimum size mesh in spark arrestor shall be ¼". Mesh shall be stainless steel or copper.
 9. Roof Vent: TPO Pre-molded roof venting see detail 6/A-10.4.1
- Roof Vent: IPO Pre-molded roof Venting see detail 6/A-10.4.1
 Clay Tile Roofing: Roofing shall be two-Piece Mission Tile, to be "Carmel Blend by US Tile, ESR-1017. Provide a 3'x3' Sample of Mock of Tale Patter N and Color For Owner and Architects Approval Prior to Ordering Material. Install with Random Exposure Pattern. Provide 20% Random Field Boosters. Install Per Manufacturers Instructions Over 40# Roofing Felt Underlayment at Roof With a Minimum of 3 to 12 Slope. All Roofing Materials Shall be Class "A".
- Roof gutters shall be provided with the means to prevent the accumulation of leaves and debris in the gutter. All roof gutters and downspouts shall be constructed of non-combustible materials.
- Drip edge flashing used at the free edges of roofing materials shall be non-combustible.
 Valley flashings shall be not less than 0.019' (#26 galvanized sheet gauge) corrosion-resistant metal installed over a min. 36"-wide underlayment consisting of one layer of No. 72 ASTM cap sheet running the full length of the valley.
- Turbine attic vents shall be equipped to allow one-way direction rotation only and shall not free spin in both directions.
 Enclosed rafter assemblies not required to be vented per CRC R806.5.
- Enclosed rafter assemblies not required to be vented per CRC R806.5.
 The entire roof shall be covered with a fire-retardant roof covering that is at least Class 'A' when the area of the addition to the existing building is more than twenty-five percent (25%) of the original floor area of the building [SDMC 149.0902(a)(2)].


ROOF PLAN LEGEND

SOLAR PANELS

ROOF DECK

A ROOF DRAIN W/ SCUPPER

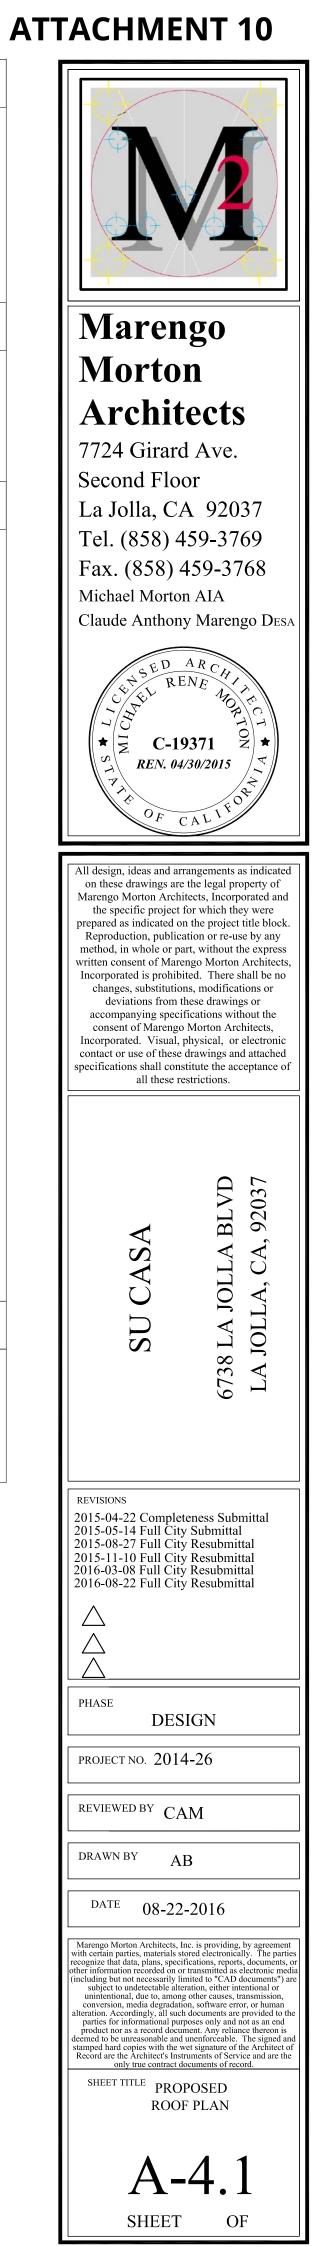

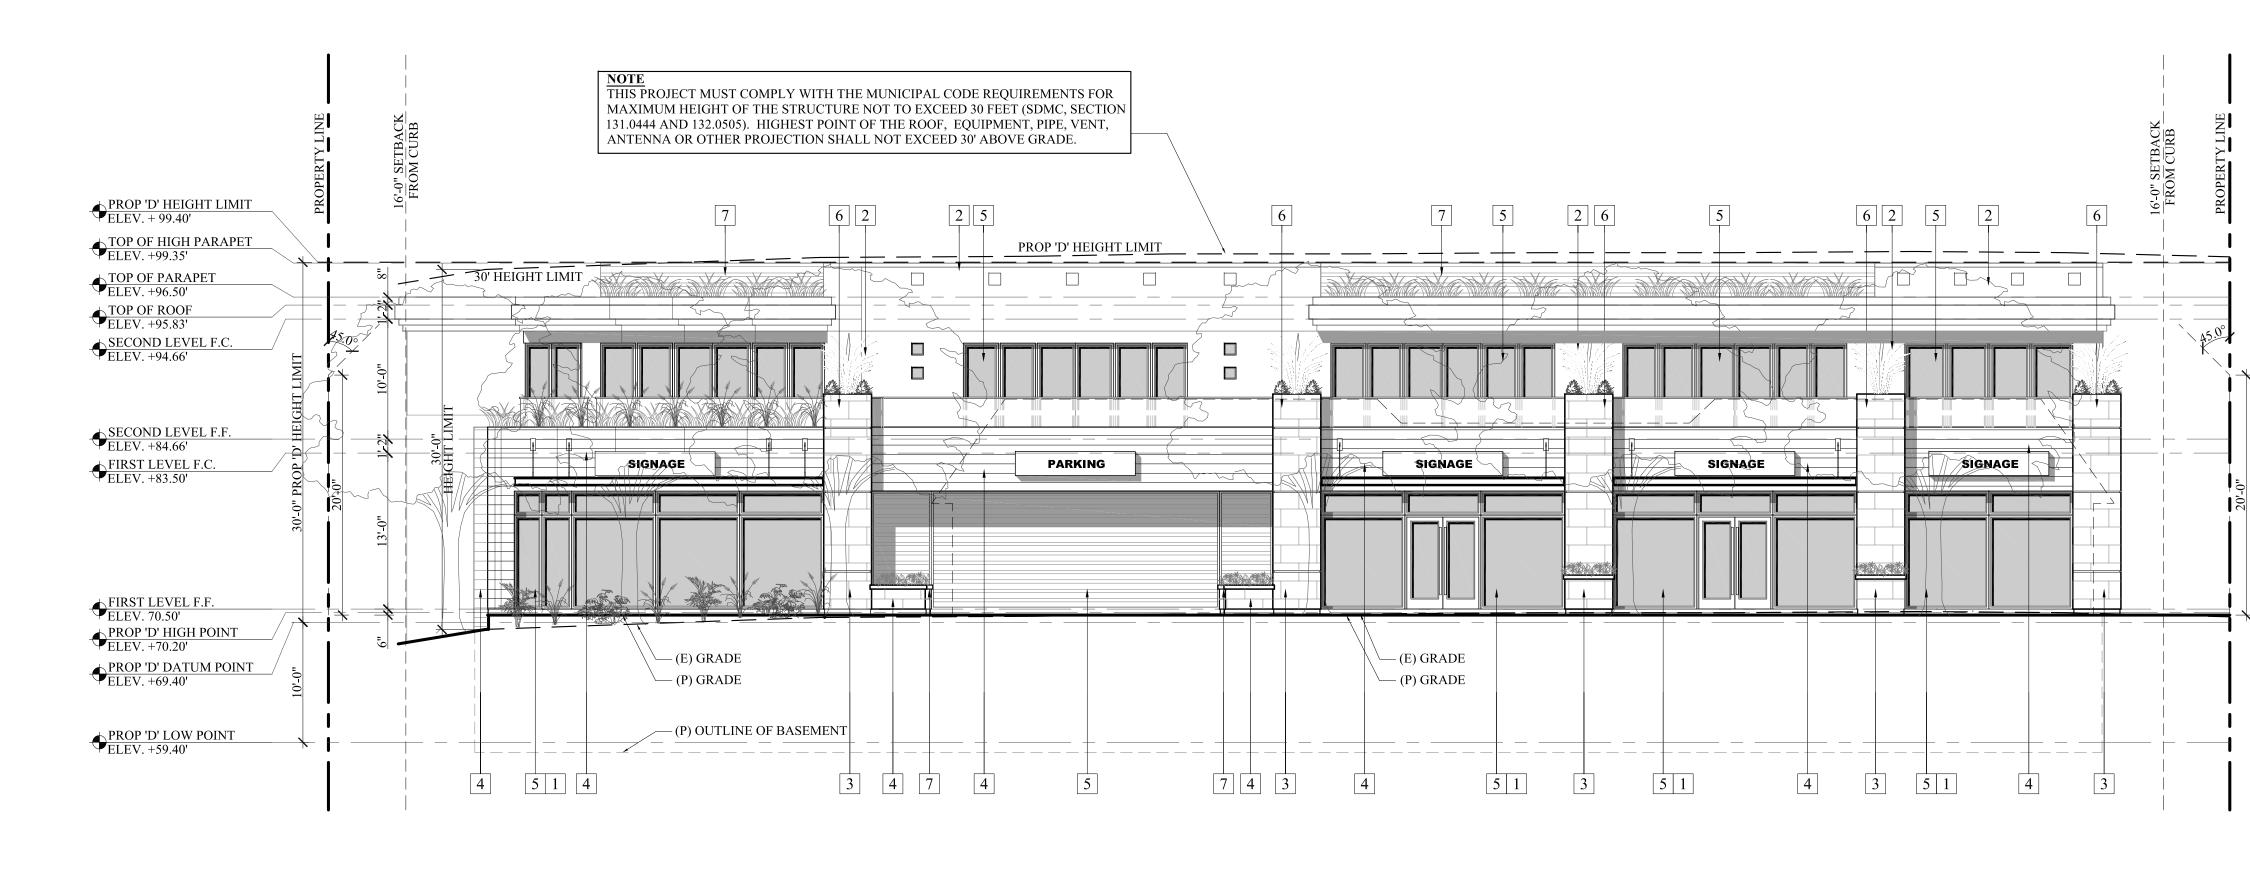

PROPOSED EAST ELEVATION

2

0	2'	4'	8'
SCA	ALE: 1	/8" = 1'-0	"


ELEVATION KEYNOTES

1 OPAQUE, REFLECTIVE, OR DARK TINTED GLAS SHALL NOT BE USED FOR ANY PORTIONS OF THE GROUND FLOOR DEVELOPED FOR RETAIL USE.

- 2 EXPO STUCCO; SANTA BARBARA FINISH. COLOR #479
- 3 EXTERIOR TILE; DALTILE: SANTINO COLLECTION, SN07 CHIARO
- 4 EXTERIOR TILE; ARIZONA TILE, ECLIPSE BEIGE, 6 x 24
- 5 WINDOW PER SCHEDULE, LOEWEN, COLOR: COPPER

6 ACCENT TILE; PRATT AND LARSON, 6 x 6 INTAGLIO J, W40 FOUNTAIN TILE

- 7 SUNSHADE+, GRATING PACIFIC INC., CLEAR ANODIZED METAL
- 8 EXPO STUCCO; SANTA BARBARA FINISH. COLOR #487 TUMBLEWEED, BASE 4
- 9 ACCENT TILE; PORCELANOSA, WOOD MODUL
- 10 WINDOW PER SCHEDULE, LOEWEN, COLOR: CHAMPAGNE
- 1 TUO SOGNO ACCENT TILE; SEE SAMPLE
- 12 EXPO STUCCO; SANTA BARBARA FINISH. COLOR #2037, BASE 4
- 13 EXPO STUCCO; SANTA BARBARA FINISH. COLOR #224 BENA VENTO, BASE 4
- 14 EXPO STUCCO; SANTA BARBARA FINISH. COLOR #227 NAVAJO WHITE
- 15 WINDOW PER SCHEDULE, LOEWEN, COLOR: CLEAR
- 16 EXTERIOR PLASTER: TEXSTON TERRA GREEN, CODE: VPC-3388I-090909
- 17 EXTERIOR SIDING: HARDIE PLANK, HEATHERED MOSS

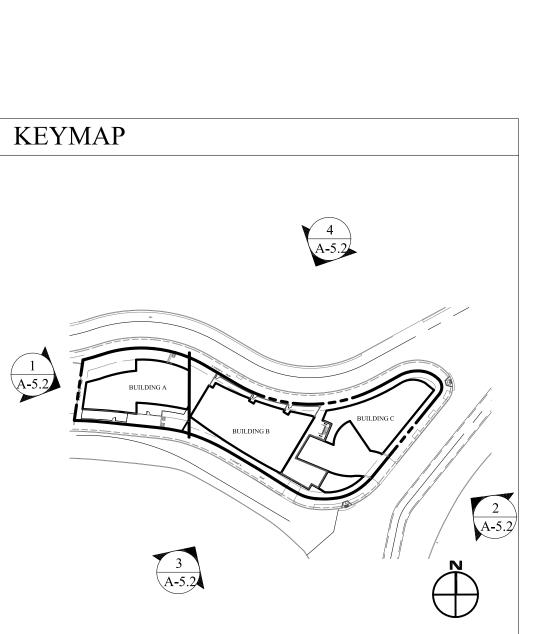

Marengo Morton Architects 7724 Girard Ave. Second Floor La Jolla, CA 92037 Tel. (858) 459-3769 Fax. (858) 459-3768 Michael Morton AIA Claude Anthony Marengo Desa RENE *3 C-19371 REN. 04/30/2015 All design, ideas and arrangements as indicate on these drawings are the legal property of Marengo Morton Architects, Incorporated and the specific project for which they were prepared as indicated on the project title block. Reproduction, publication or re-use by any method, in whole or part, without the express written consent of Marengo Morton Architects, Incorporated is prohibited. There shall be no changes, substitutions, modifications or deviations from these drawings or accompanying specifications without the consent of Marengo Morton Architects, Incorporated. Visual, physical, or electronic contact or use of these drawings and attached specifications shall constitute the acceptance of all these restrictions. /D 37 6738 LA JOLLA BLVI LA JOLLA, CA, 9203 SA À, Ú SU REVISIONS 2015-04-22 Completeness Submittal 2015-05-14 Full City Submittal 2015-08-27 Full City Resubmittal 2015-06-27 Full City Resubmittal 2015-11-10 Full City Resubmittal 2016-03-08 Full City Resubmittal 2016-08-22 Full City Resubmittal \square \triangle PHASE DESIGN PROJECT NO. 2014-26 REVIEWED BY CAM


ATTACHMENT 10

DATE 08-22-2016

DRAWN BY AB

- Marengo Morton Architects, Inc. is providing, by agreement with certain parties, materials stored electronically. The parties recognize that data, plans, specifications, reports, documents, or other information recorded on or transmitted as electronic media (including but not necessarily limited to "CAD documents") are subject to undetectable alteration, either intentional or unintentional, due to, among other causes, transmission, conversion, media degradation, software error, or human alteration. Accordingly, all such documents are provided to the parties for informational purposes only and not as an end product nor as a record document. Any reliance thereon is deemed to be unreasonable and unenforceable. The signed and stamped hard copies with the wet signature of the Architect of Record are the Architect's Instruments of Service and are the only true contract documents of record.
- SHEET TITLE PROPOSED ELEVATIONS



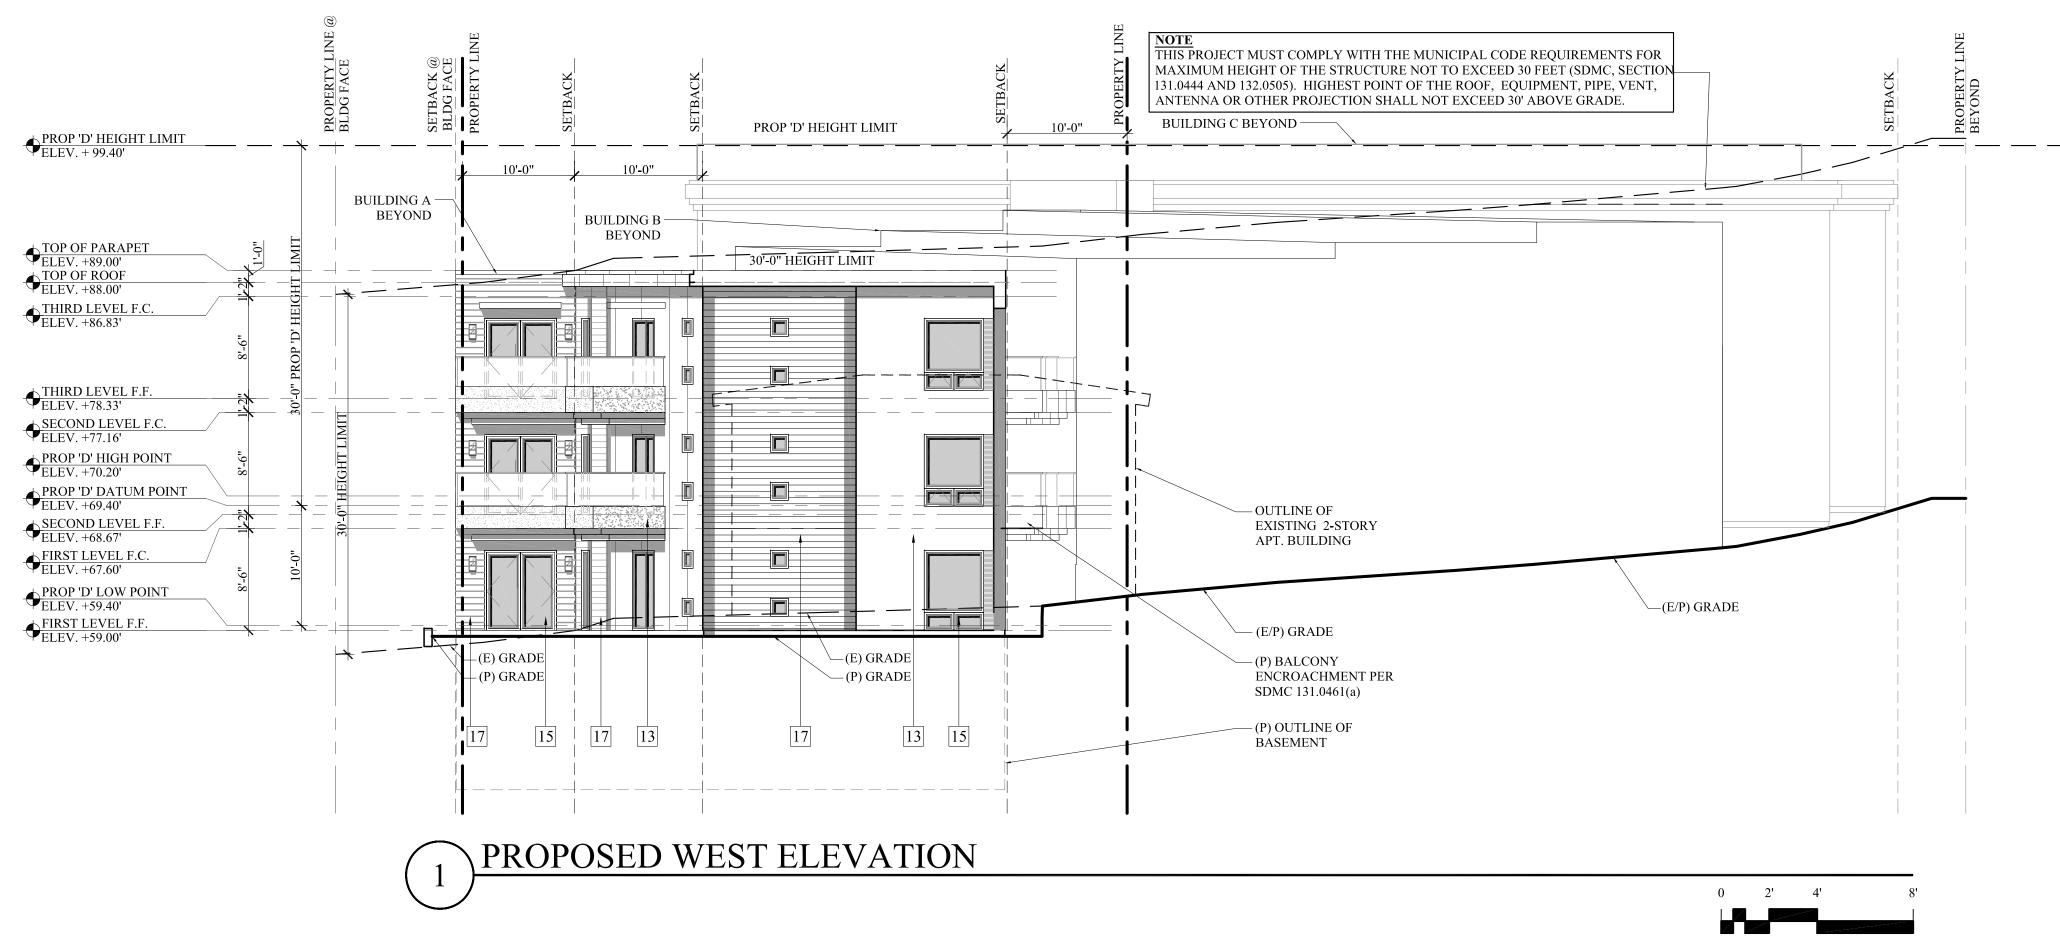

SCALE: 1/8" = 1'-0"

ELEVATION KEYNOTES

OPAQUE, REFLECTIVE, OR DARK TINTED GLAS SHALL NOT BE USED FOR ANY PORTIONS OF THE GROUND FLOOR DEVELOPED FOR RETAIL USE.


- 2 EXPO STUCCO; SANTA BARBARA FINISH. COLOR #479
- 3 EXTERIOR TILE; DALTILE: SANTINO COLLECTION, SN07 CHIARO
- 4 EXTERIOR TILE; ARIZONA TILE, ECLIPSE BEIGE, 6 x 24
- 5 WINDOW PER SCHEDULE, LOEWEN, COLOR: COPPER

6 ACCENT TILE; PRATT AND LARSON, 6 x 6 INTAGLIO J, W40 FOUNTAIN TILE

7 SUNSHADE+, GRATING PACIFIC INC., CLEAR ANODIZED METAL


8 EXPO STUCCO; SANTA BARBARA FINISH. COLOR #487 TUMBLEWEED, BASE 4

- 9 ACCENT TILE; PORCELANOSA, WOOD MODUL
- 10 WINDOW PER SCHEDULE, LOEWEN, COLOR: CHAMPAGNE
- 11 TUO SOGNO ACCENT TILE; SEE SAMPLE
- 12 EXPO STUCCO; SANTA BARBARA FINISH. COLOR #2037, BASE 4
- 13 EXPO STUCCO; SANTA BARBARA FINISH. COLOR #224 BENA VENTO, BASE 4
- 14
 EXPO STUCCO; SANTA BARBARA FINISH. COLOR #227 NAVAJO WHITE
- 15 WINDOW PER SCHEDULE, LOEWEN, COLOR: CLEAR
- 16 EXTERIOR PLASTER: TEXSTON TERRA GREEN, CODE: VPC-3388I-090909
- 17 EXTERIOR SIDING: HARDIE PLANK, HEATHERED MOSS

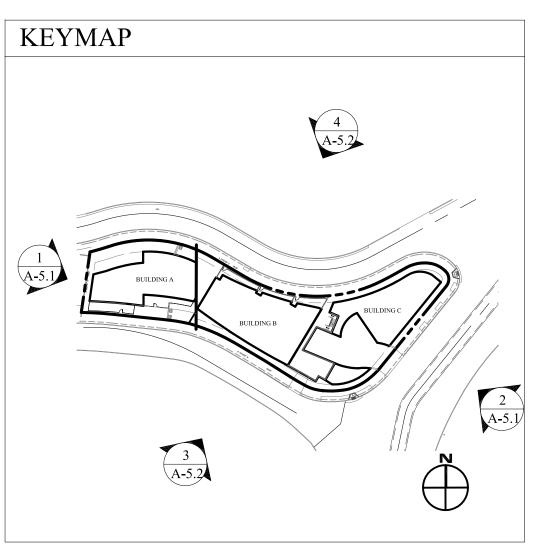


Marengo Morton Architects 7724 Girard Ave. Second Floor La Jolla, CA 92037 Tel. (858) 459-3769 Fax. (858) 459-3768 Michael Morton AIA Claude Anthony Marengo DESA RENE *3 C-19371 REN. 04/30/2015 All design, ideas and arrangements as indicate on these drawings are the legal property of Marengo Morton Architects, Incorporated and the specific project for which they were prepared as indicated on the project title block. Reproduction, publication or re-use by any method, in whole or part, without the express written consent of Marengo Morton Architects Incorporated is prohibited. There shall be no changes, substitutions, modifications or deviations from these drawings or accompanying specifications without the consent of Marengo Morton Architects, Incorporated. Visual, physical, or electronic contact or use of these drawings and attached specifications shall constitute the acceptance of all these restrictions. /D 37 6738 LA JOLLA BLVI LA JOLLA, CA, 9203 SA A, Ú SU REVISIONS 2015-04-22 Completeness Submittal 2015-05-14 Full City Submittal 2015-08-27 Full City Resubmittal 2015-01-27 Full City Resubmittal 2015-11-10 Full City Resubmittal 2016-03-08 Full City Resubmittal 2016-08-22 Full City Resubmittal \square PHASE DESIGN PROJECT NO. 2014-26 REVIEWED BY CAM DRAWN BY AB DATE 08-22-2016 Marengo Morton Architects, Inc. is providing, by agreement with certain parties, materials stored electronically. The parties recognize that data, plans, specifications, reports, documents, or other information recorded on or transmitted as electronic media (including but not necessarily limited to "CAD documents") are subject to undetectable alteration, either intentional or unintentional, due to, among other causes, transmission, conversion, media degradation, software error, or human alteration. Accordingly, all such documents are provided to the parties for informational purposes only and not as an end product nor as a record document. Any reliance thereon is deemed to be unreasonable and unenforceable. The signed and stamped hard copies with the wet signature of the Architect of Record are the Architect's Instruments of Service and are the only true contract documents of record.

ATTACHMENT 10

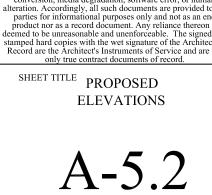

SHEET OF

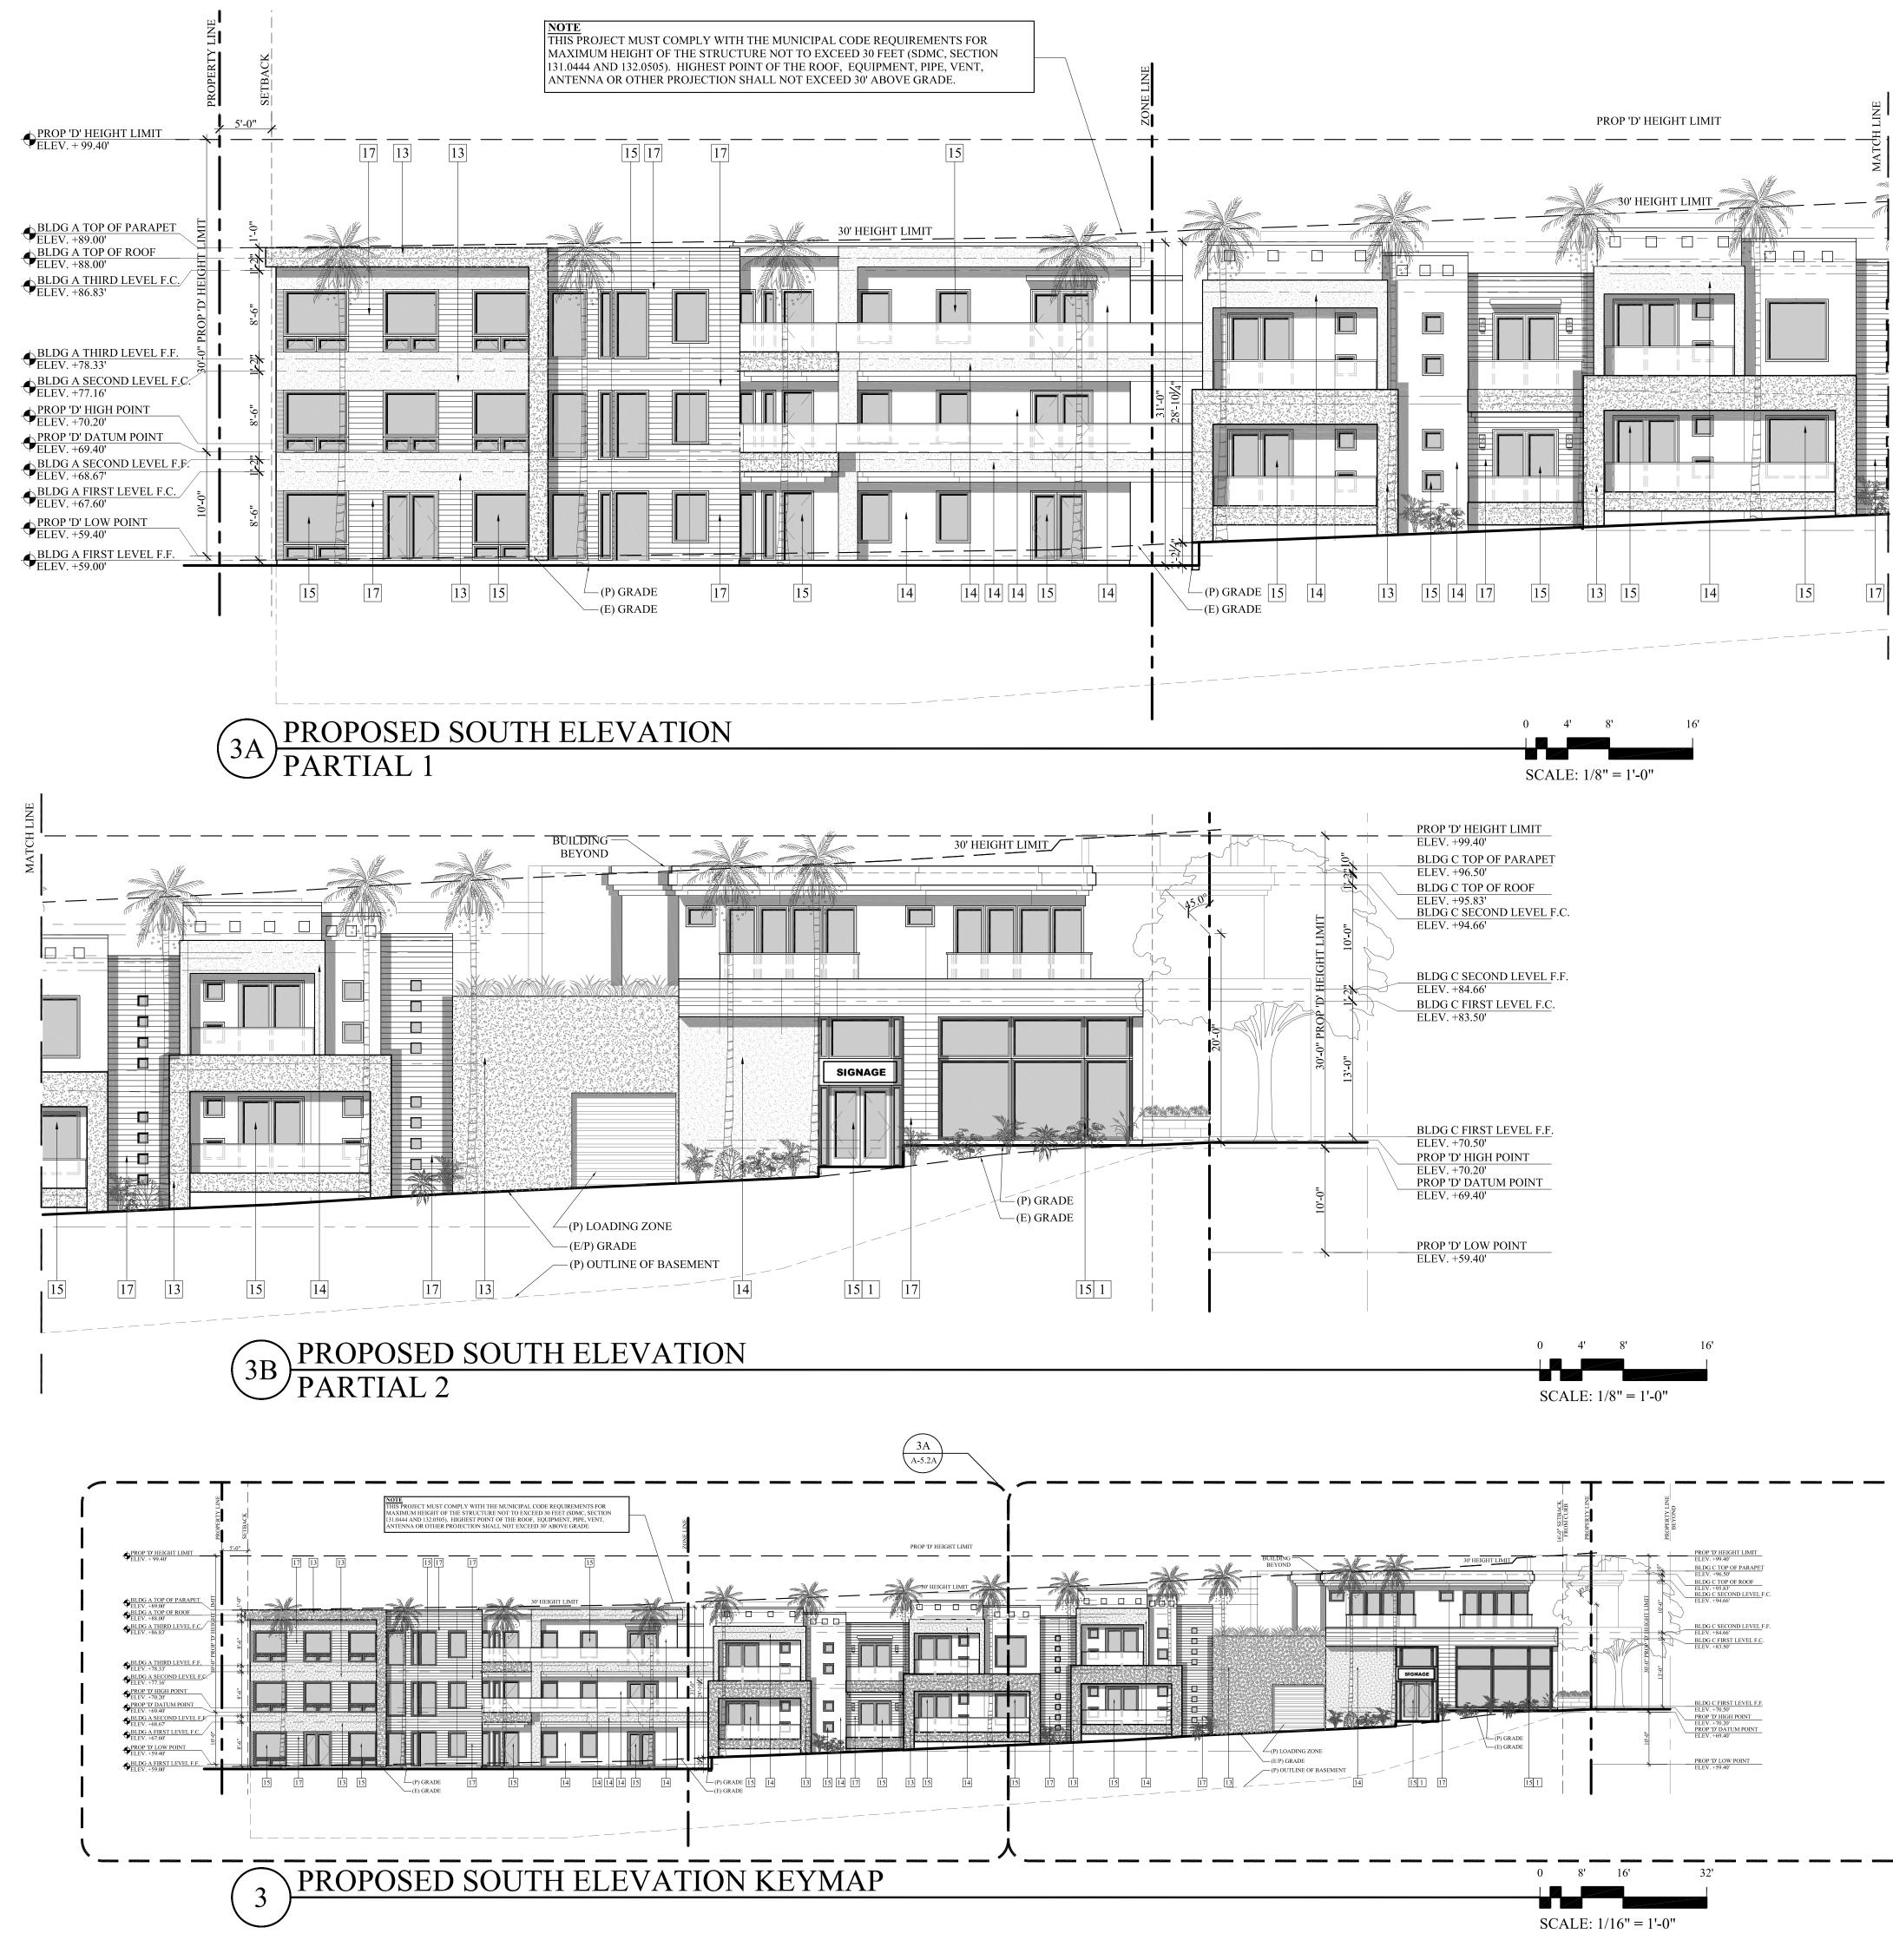

ELEVATION KEYNOTES

☐ OPAQUE, REFLECTIVE, OR DARK TINTED GLAS SHALL NOT BE USED FOR \perp ANY PORTIONS OF THE GROUND FLOOR DEVELOPED FOR RETAIL USE.


- 2 EXPO STUCCO; SANTA BARBARA FINISH. COLOR #479
- EXTERIOR TILE; DALTILE: SANTINO COLLECTION, SN07 CHIARO
- ⁴ EXTERIOR TILE; ARIZONA TILE, ECLIPSE BEIGE, 6 x 24
- 5 WINDOW PER SCHEDULE, LOEWEN, COLOR: COPPER

6 ACCENT TILE; PRATT AND LARSON, 6 x 6 INTAGLIO J, W40 FOUNTAIN TILE

7 SUNSHADE+, GRATING PACIFIC INC., CLEAR ANODIZED METAL

8 EXPO STUCCO; SANTA BARBARA FINISH. COLOR #487 TUMBLEWEED, BASE 4

- 9 ACCENT TILE; PORCELANOSA, WOOD MODUL
- 10 WINDOW PER SCHEDULE, LOEWEN, COLOR: CHAMPAGNE
- 11 TUO SOGNO ACCENT TILE; SEE SAMPLE
- 12 EXPO STUCCO; SANTA BARBARA FINISH. COLOR #2037, BASE 4
- 3 EXPO STUCCO; SANTA BARBARA FINISH. COLOR #224 BENA VENTO, BASE 4
- 14 EXPO STUCCO; SANTA BARBARA FINISH. COLOR #227 NAVAJO WHITE
- 15 WINDOW PER SCHEDULE, LOEWEN, COLOR: CLEAR
- 16 EXTERIOR PLASTER: TEXSTON TERRA GREEN, CODE: VPC-3388I-090909
- 17 EXTERIOR SIDING: HARDIE PLANK, HEATHERED MOSS

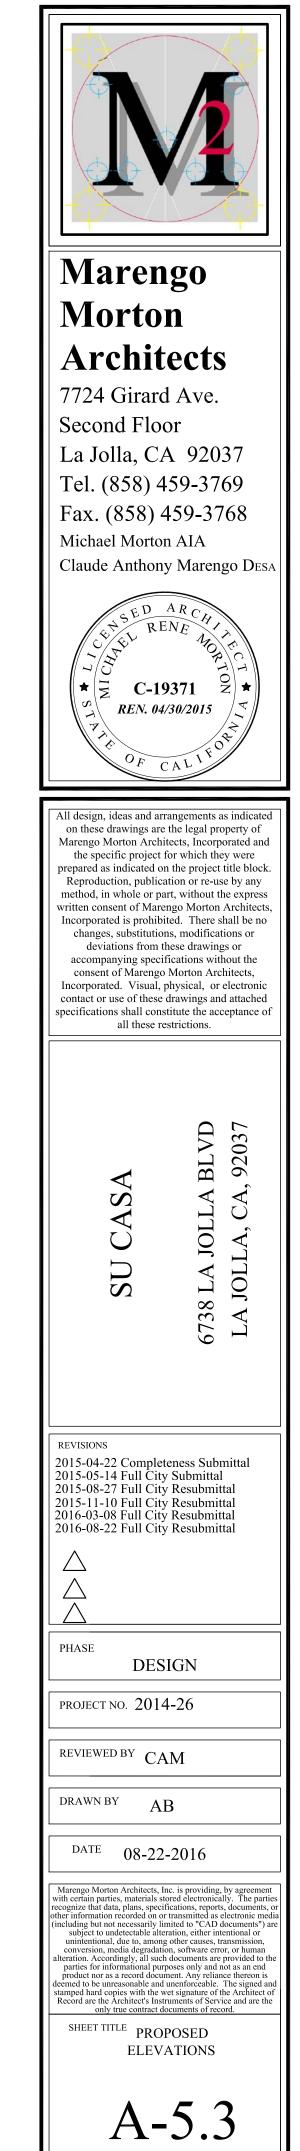



SHEET OF

ATTACHMENT 10

- \ 	KEYMAP
	4 A-5.3
	1 A-5.2 Building B Building B
・ _ノ	3 A-5.3 N

(A-5.2A)

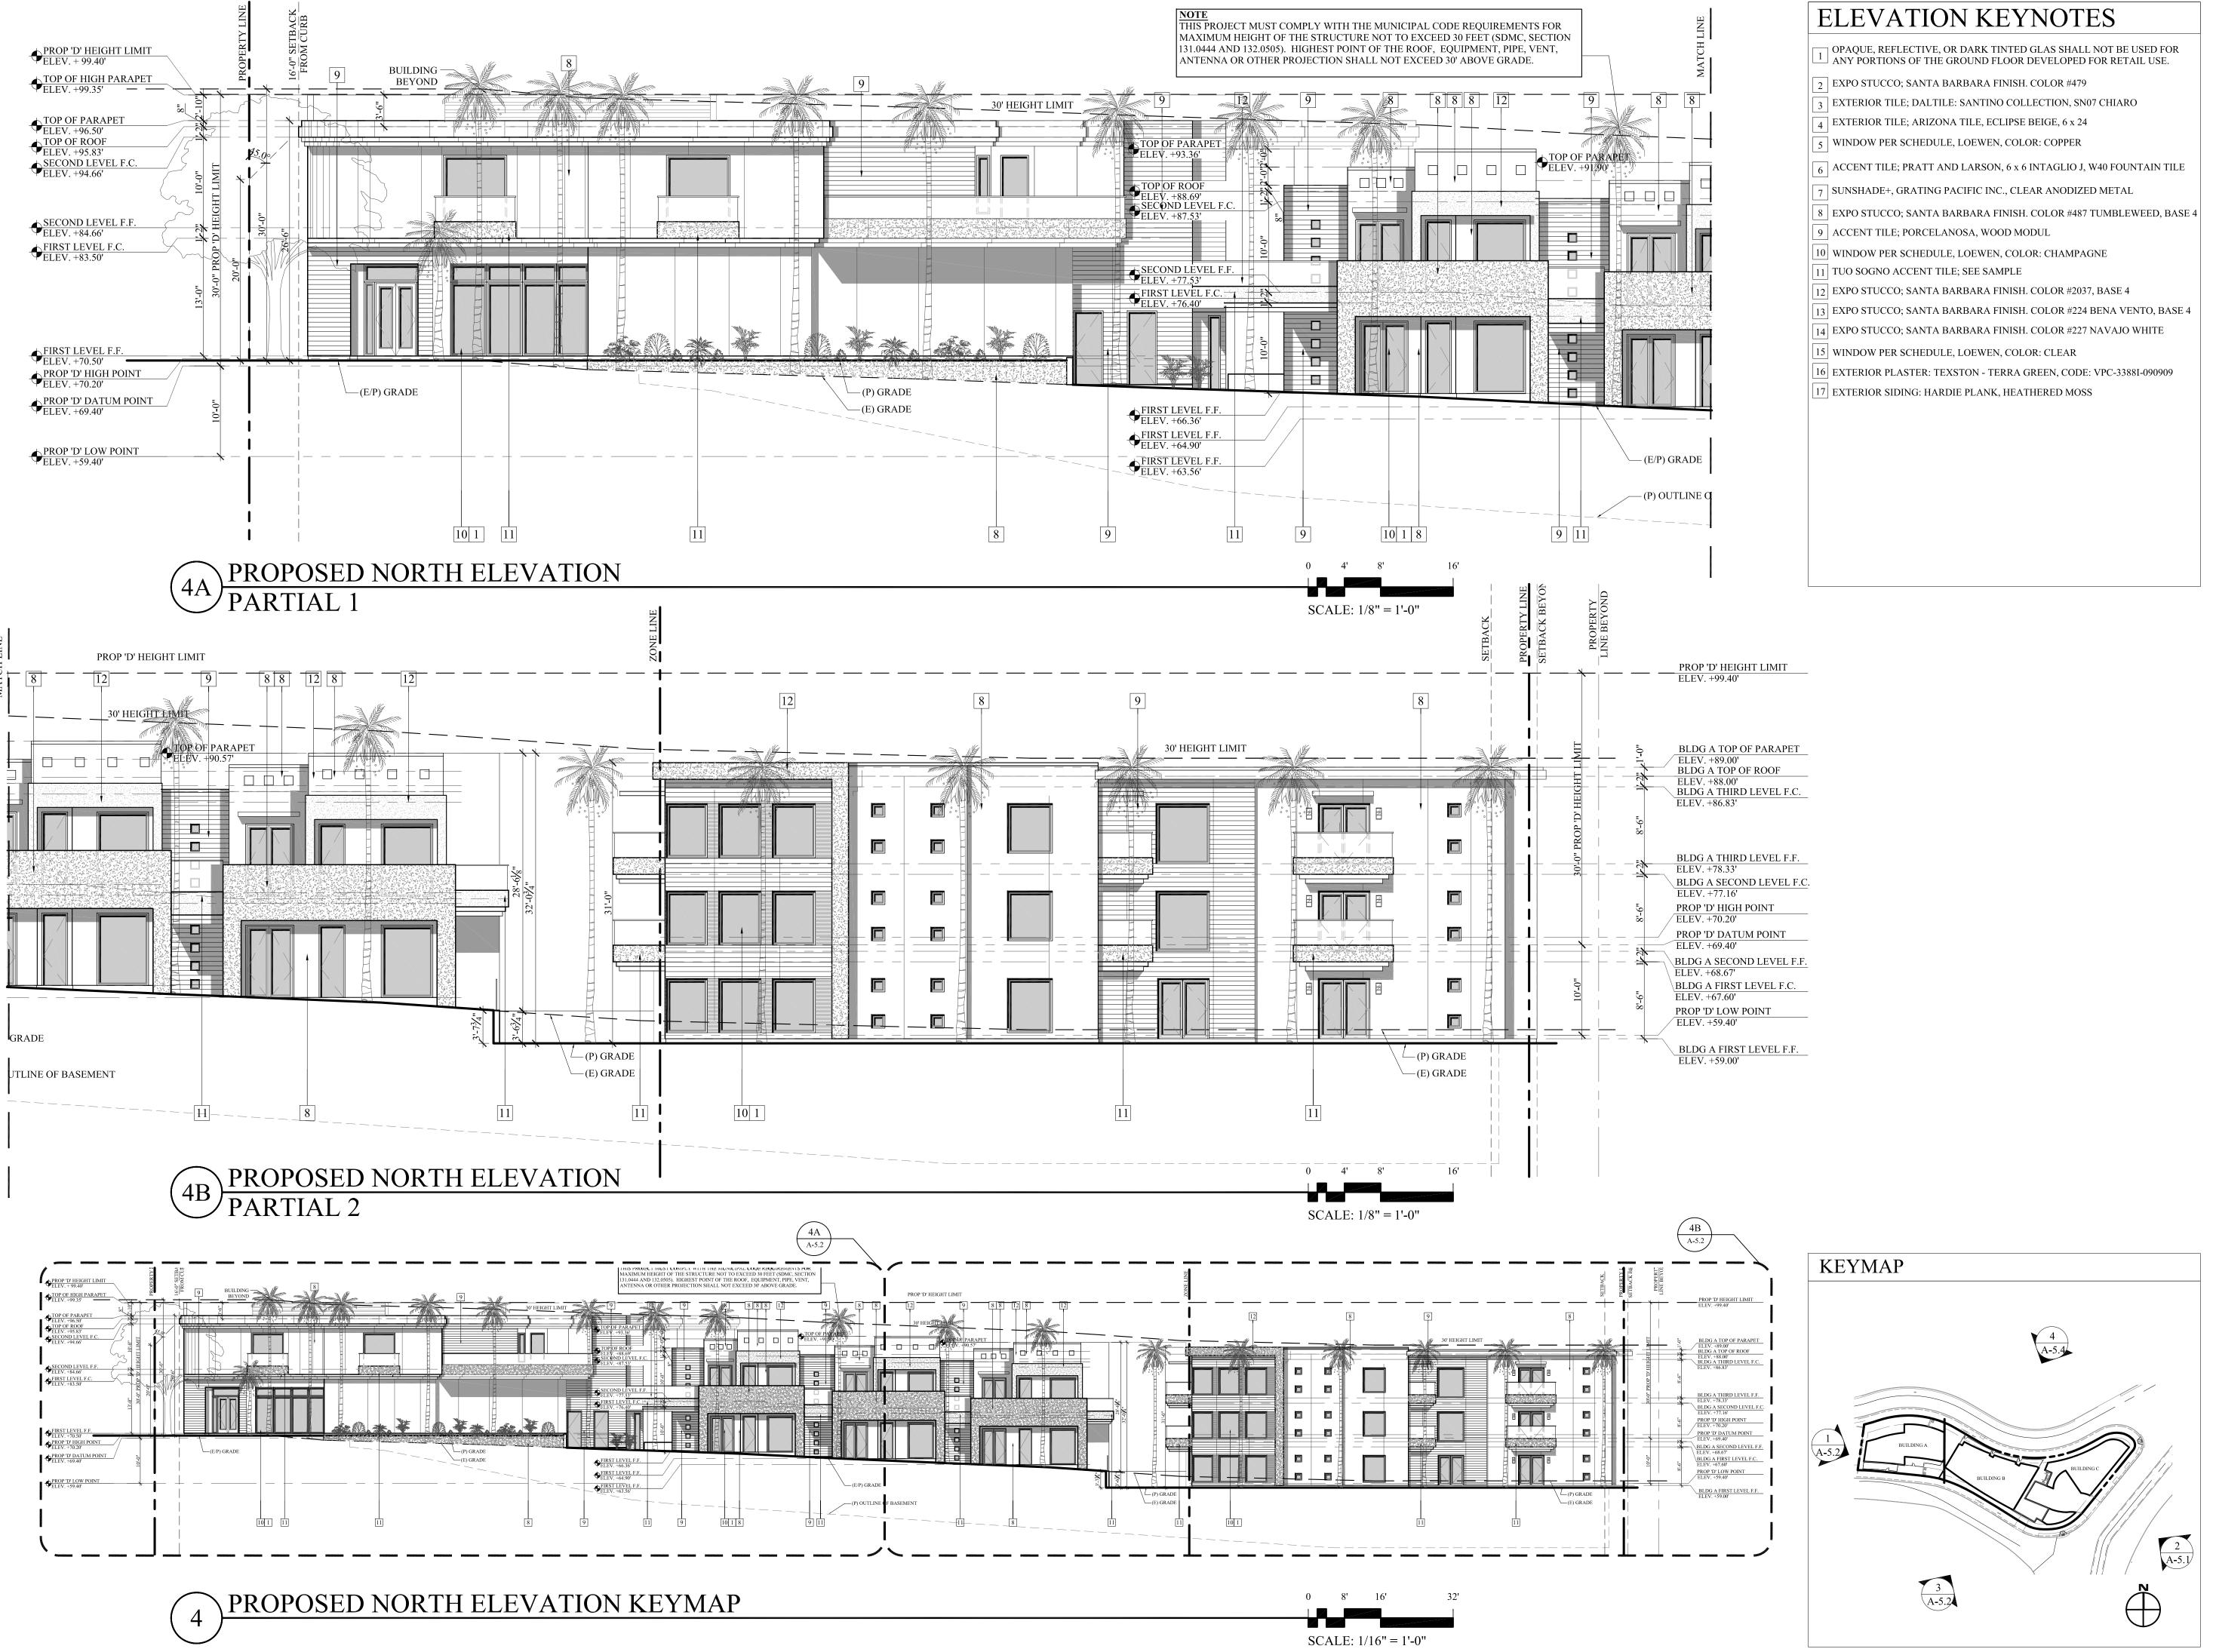

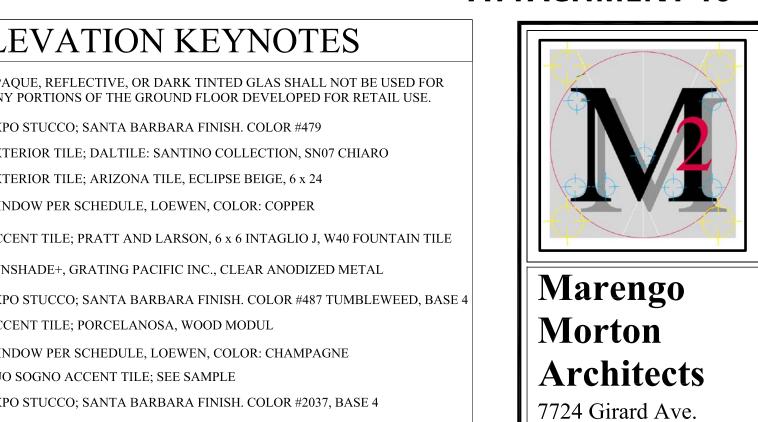

Tel. (858) 459-3769 Fax. (858) 459-3768 Michael Morton AIA Claude Anthony Marengo DESA RENA * 3 C-19371 REN. 04/30/2015 All design, ideas and arrangements as indica

Second Floor

La Jolla, CA 92037

on these drawings are the legal property of Marengo Morton Architects, Incorporated and the specific project for which they were prepared as indicated on the project title block. Reproduction, publication or re-use by any method, in whole or part, without the express written consent of Marengo Morton Architects Incorporated is prohibited. There shall be no changes, substitutions, modifications or deviations from these drawings or accompanying specifications without the consent of Marengo Morton Architects, Incorporated. Visual, physical, or electronic

contact or use of these drawings and attached specifications shall constitute the acceptance of all these restrictions.

> 7D 37 6738 LA JOLLA BLVI LA JOLLA, CA, 9203 SU

SA

 \checkmark

U

REVISIONS 2015-04-22 Completeness Submittal 2015-05-14 Full City Submittal 2015-08-27 Full City Resubmittal 2015-11-10 Full City Resubmittal 2016-03-08 Full City Resubmittal 2016-08-22 Full City Resubmittal

PHASE DESIGN

PROJECT NO. 2014-26

REVIEWED BY CAM

DRAWN BY GR

DATE 08-22-2016

Marengo Morton Architects, Inc. is providing, by agreem vith certain parties, materials stored electronically. The pa ecognize that data, plans, specifications, reports, documen ther information recorded on or transmitted as electronic r uding but not necessarily limited to "CAD documen subject to undetectable alteration, either intentional inintentional, due to, among other causes, transmiss


duct nor as a record document. Any reliance the amped hard copies with the wet signature of the Archit ecord are the Architect's Instruments of Service and ar only true contract documents of record. SHEET TITLE PROPOSED

onversion, media degradation, software error, or huma ation. Accordingly, all such documents are provided to


arties for informational purposes only and not as an en

ELEVATIONS




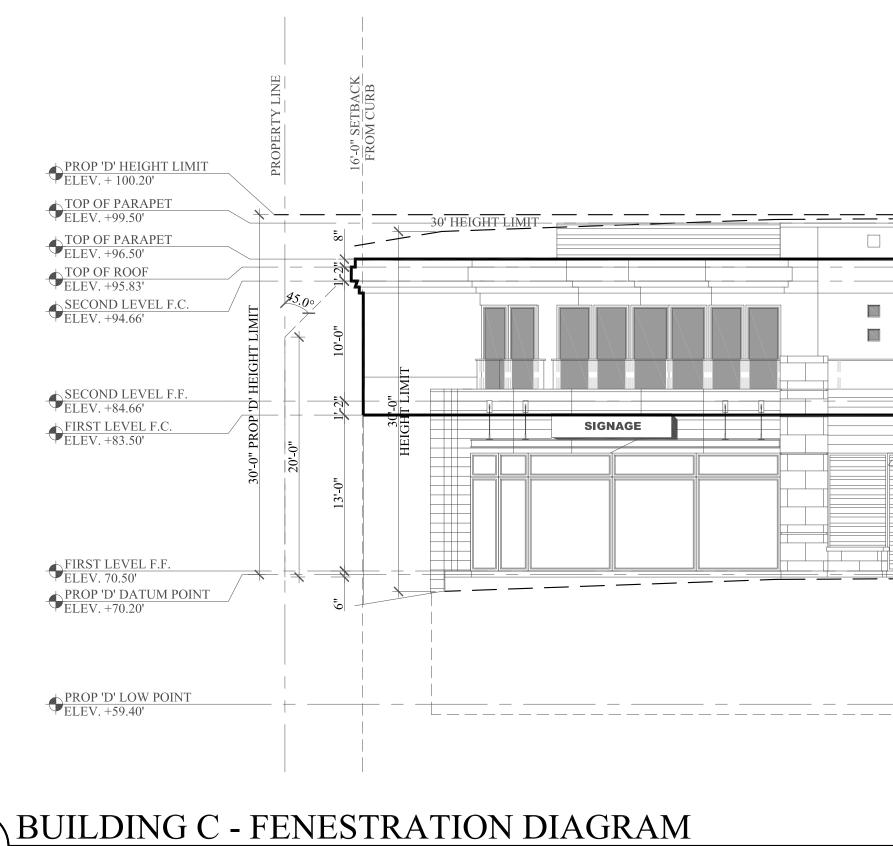


5

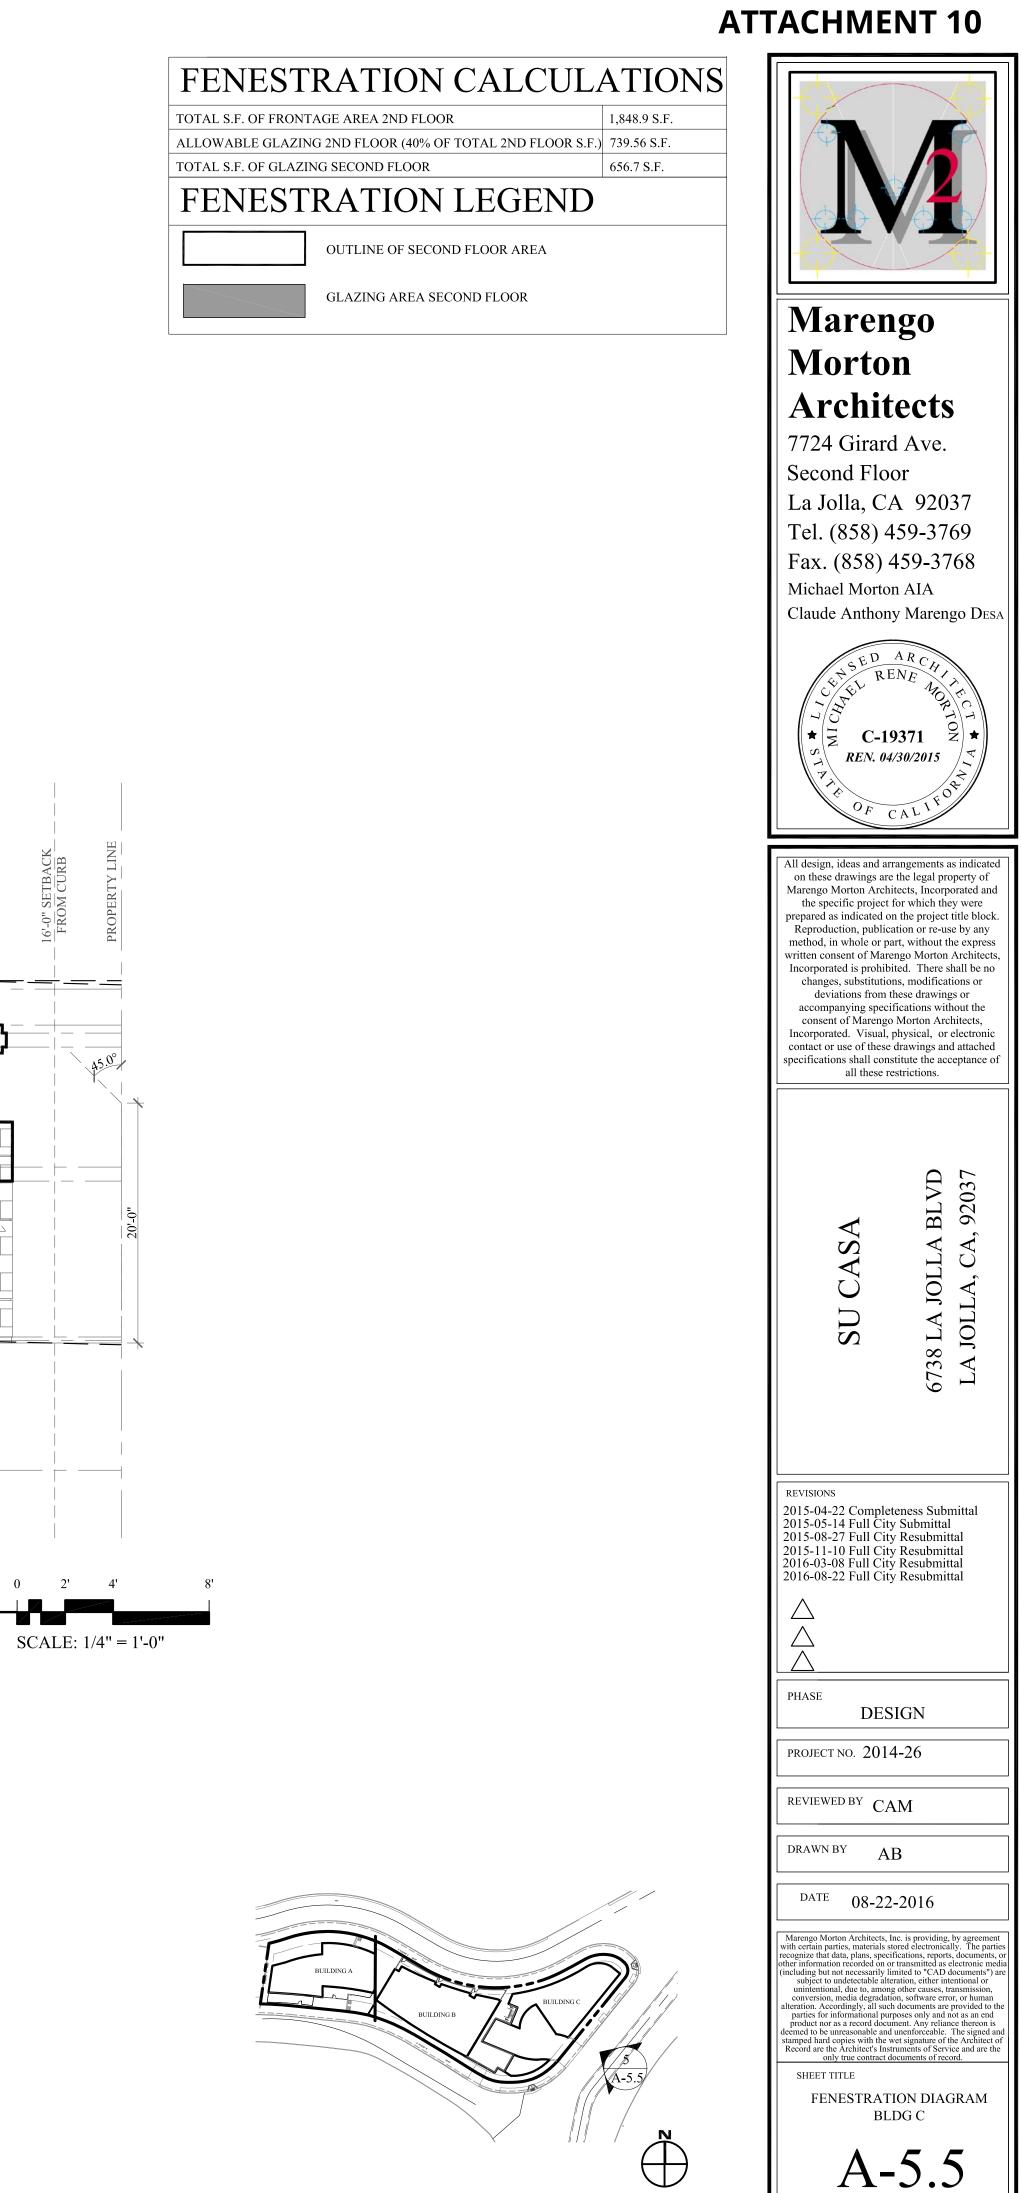



SHEET OF

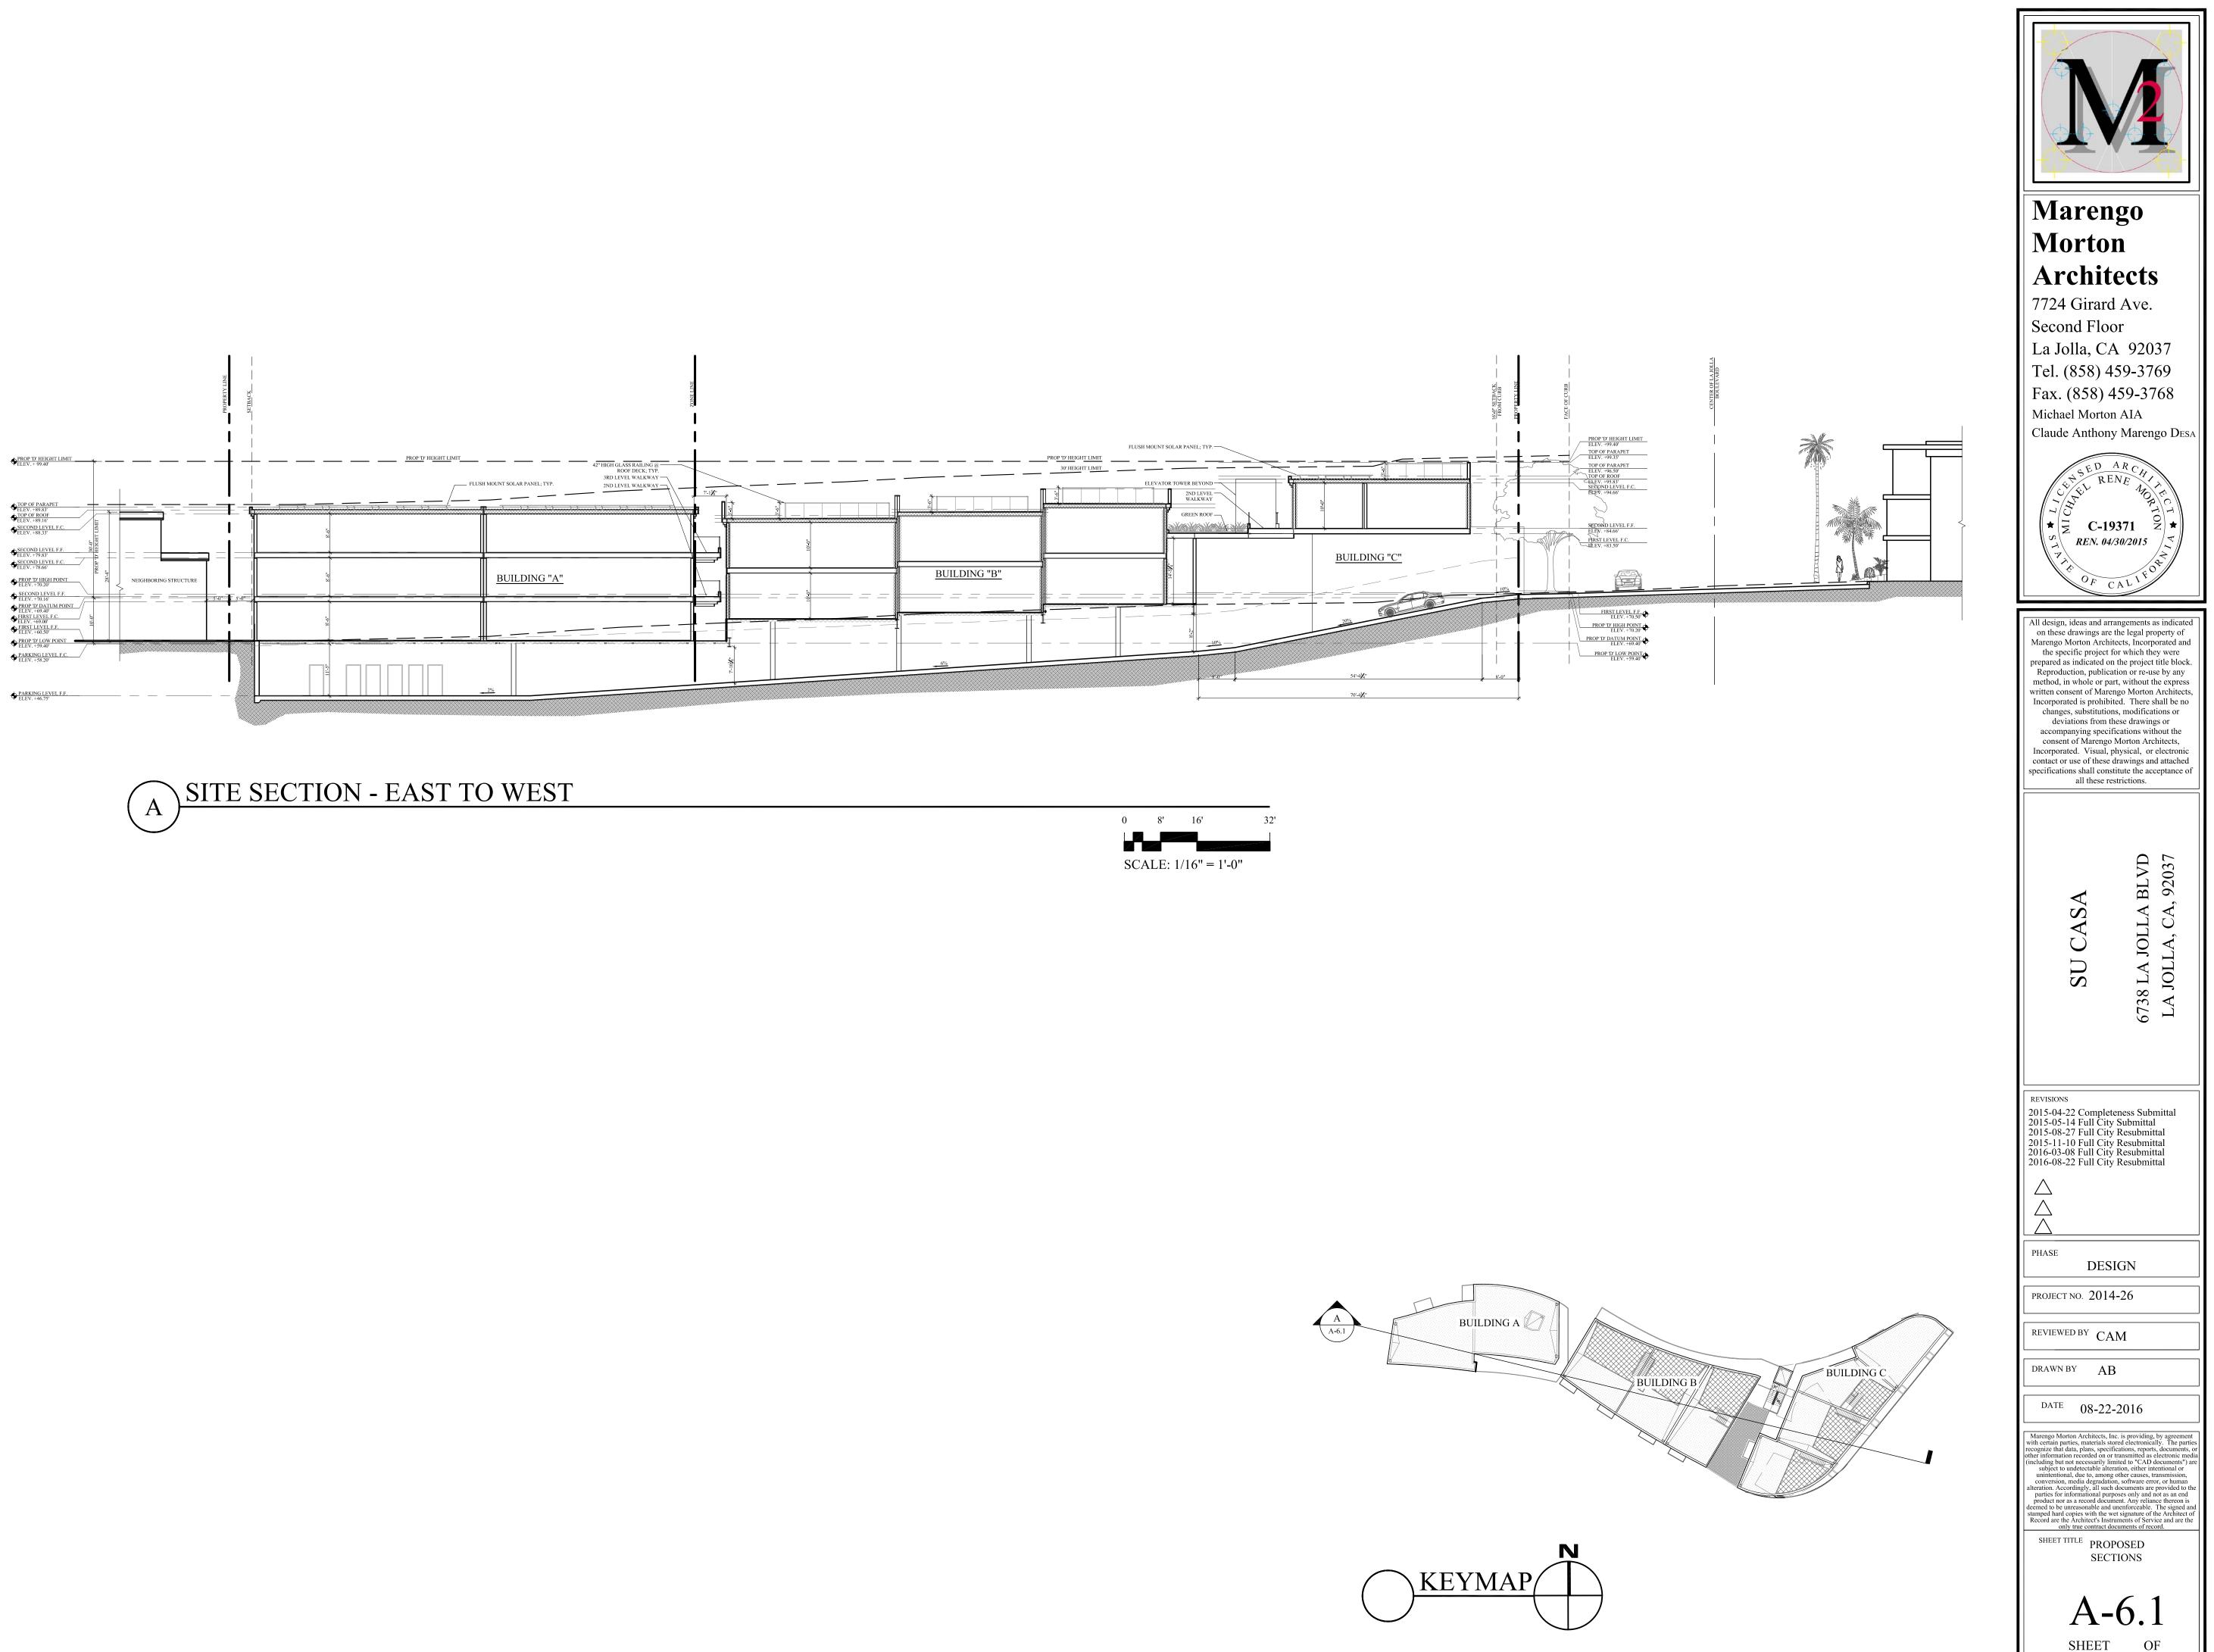





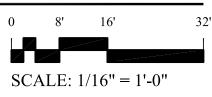

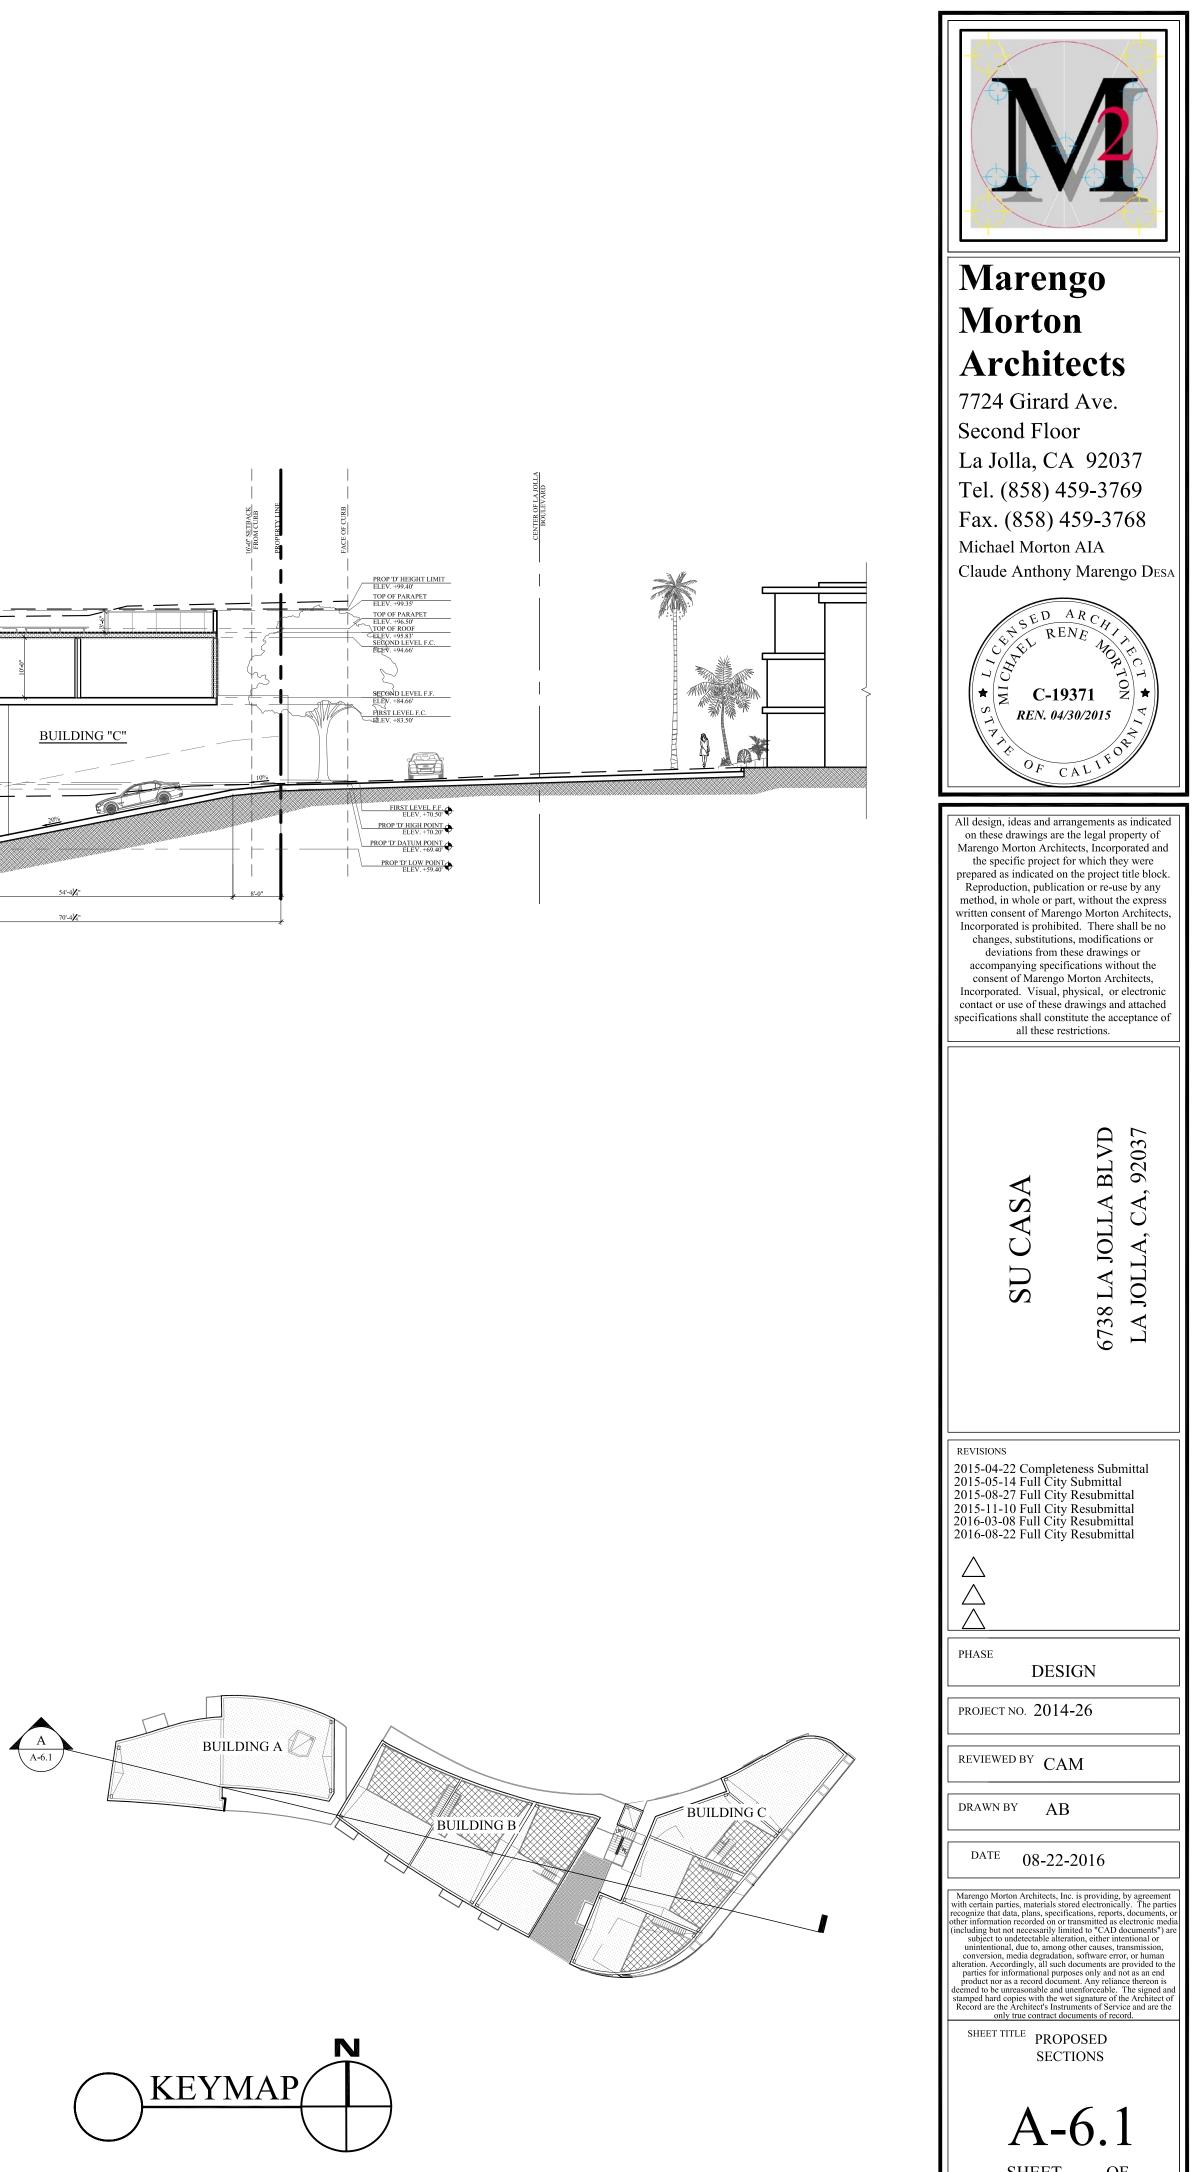


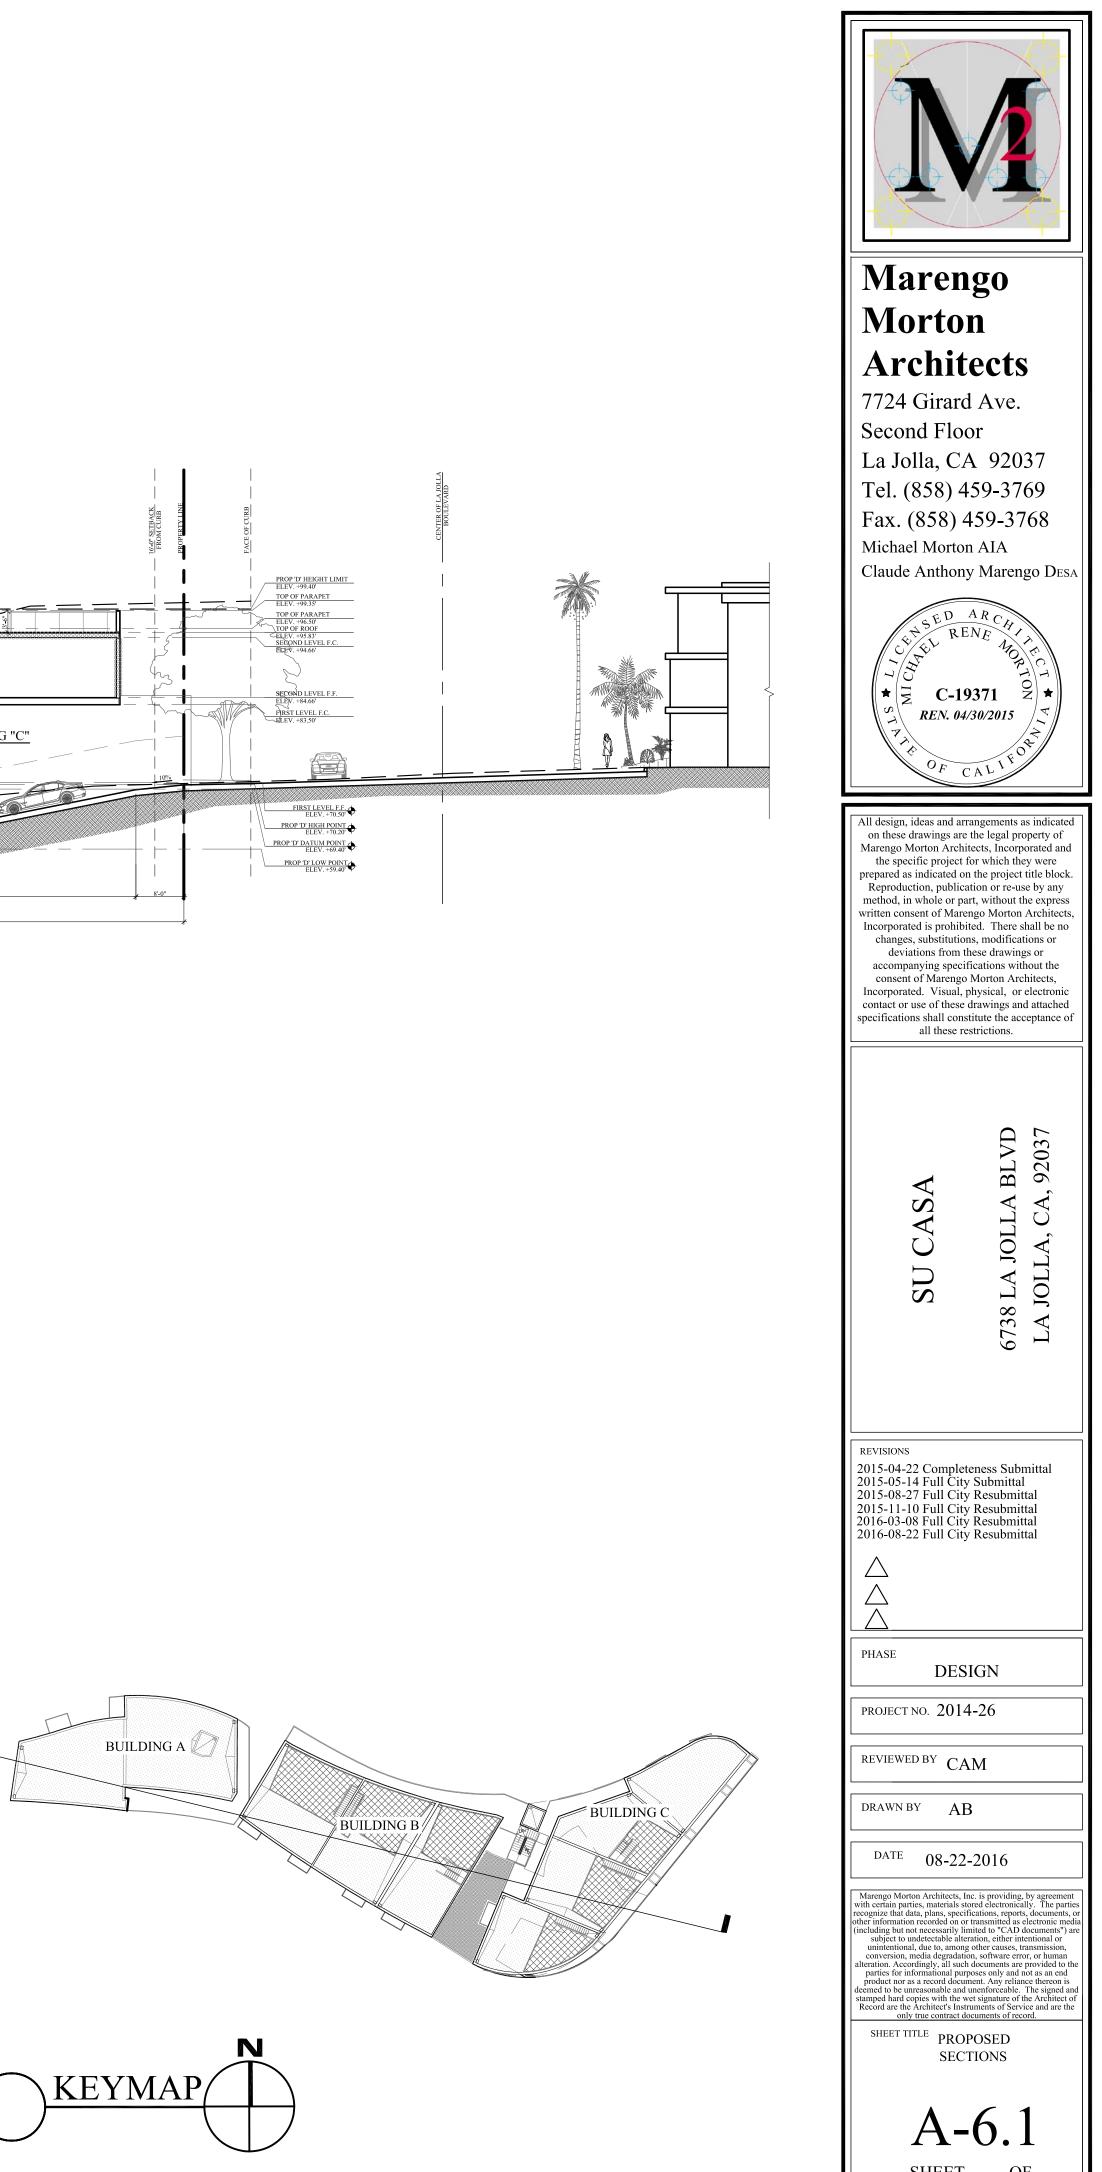


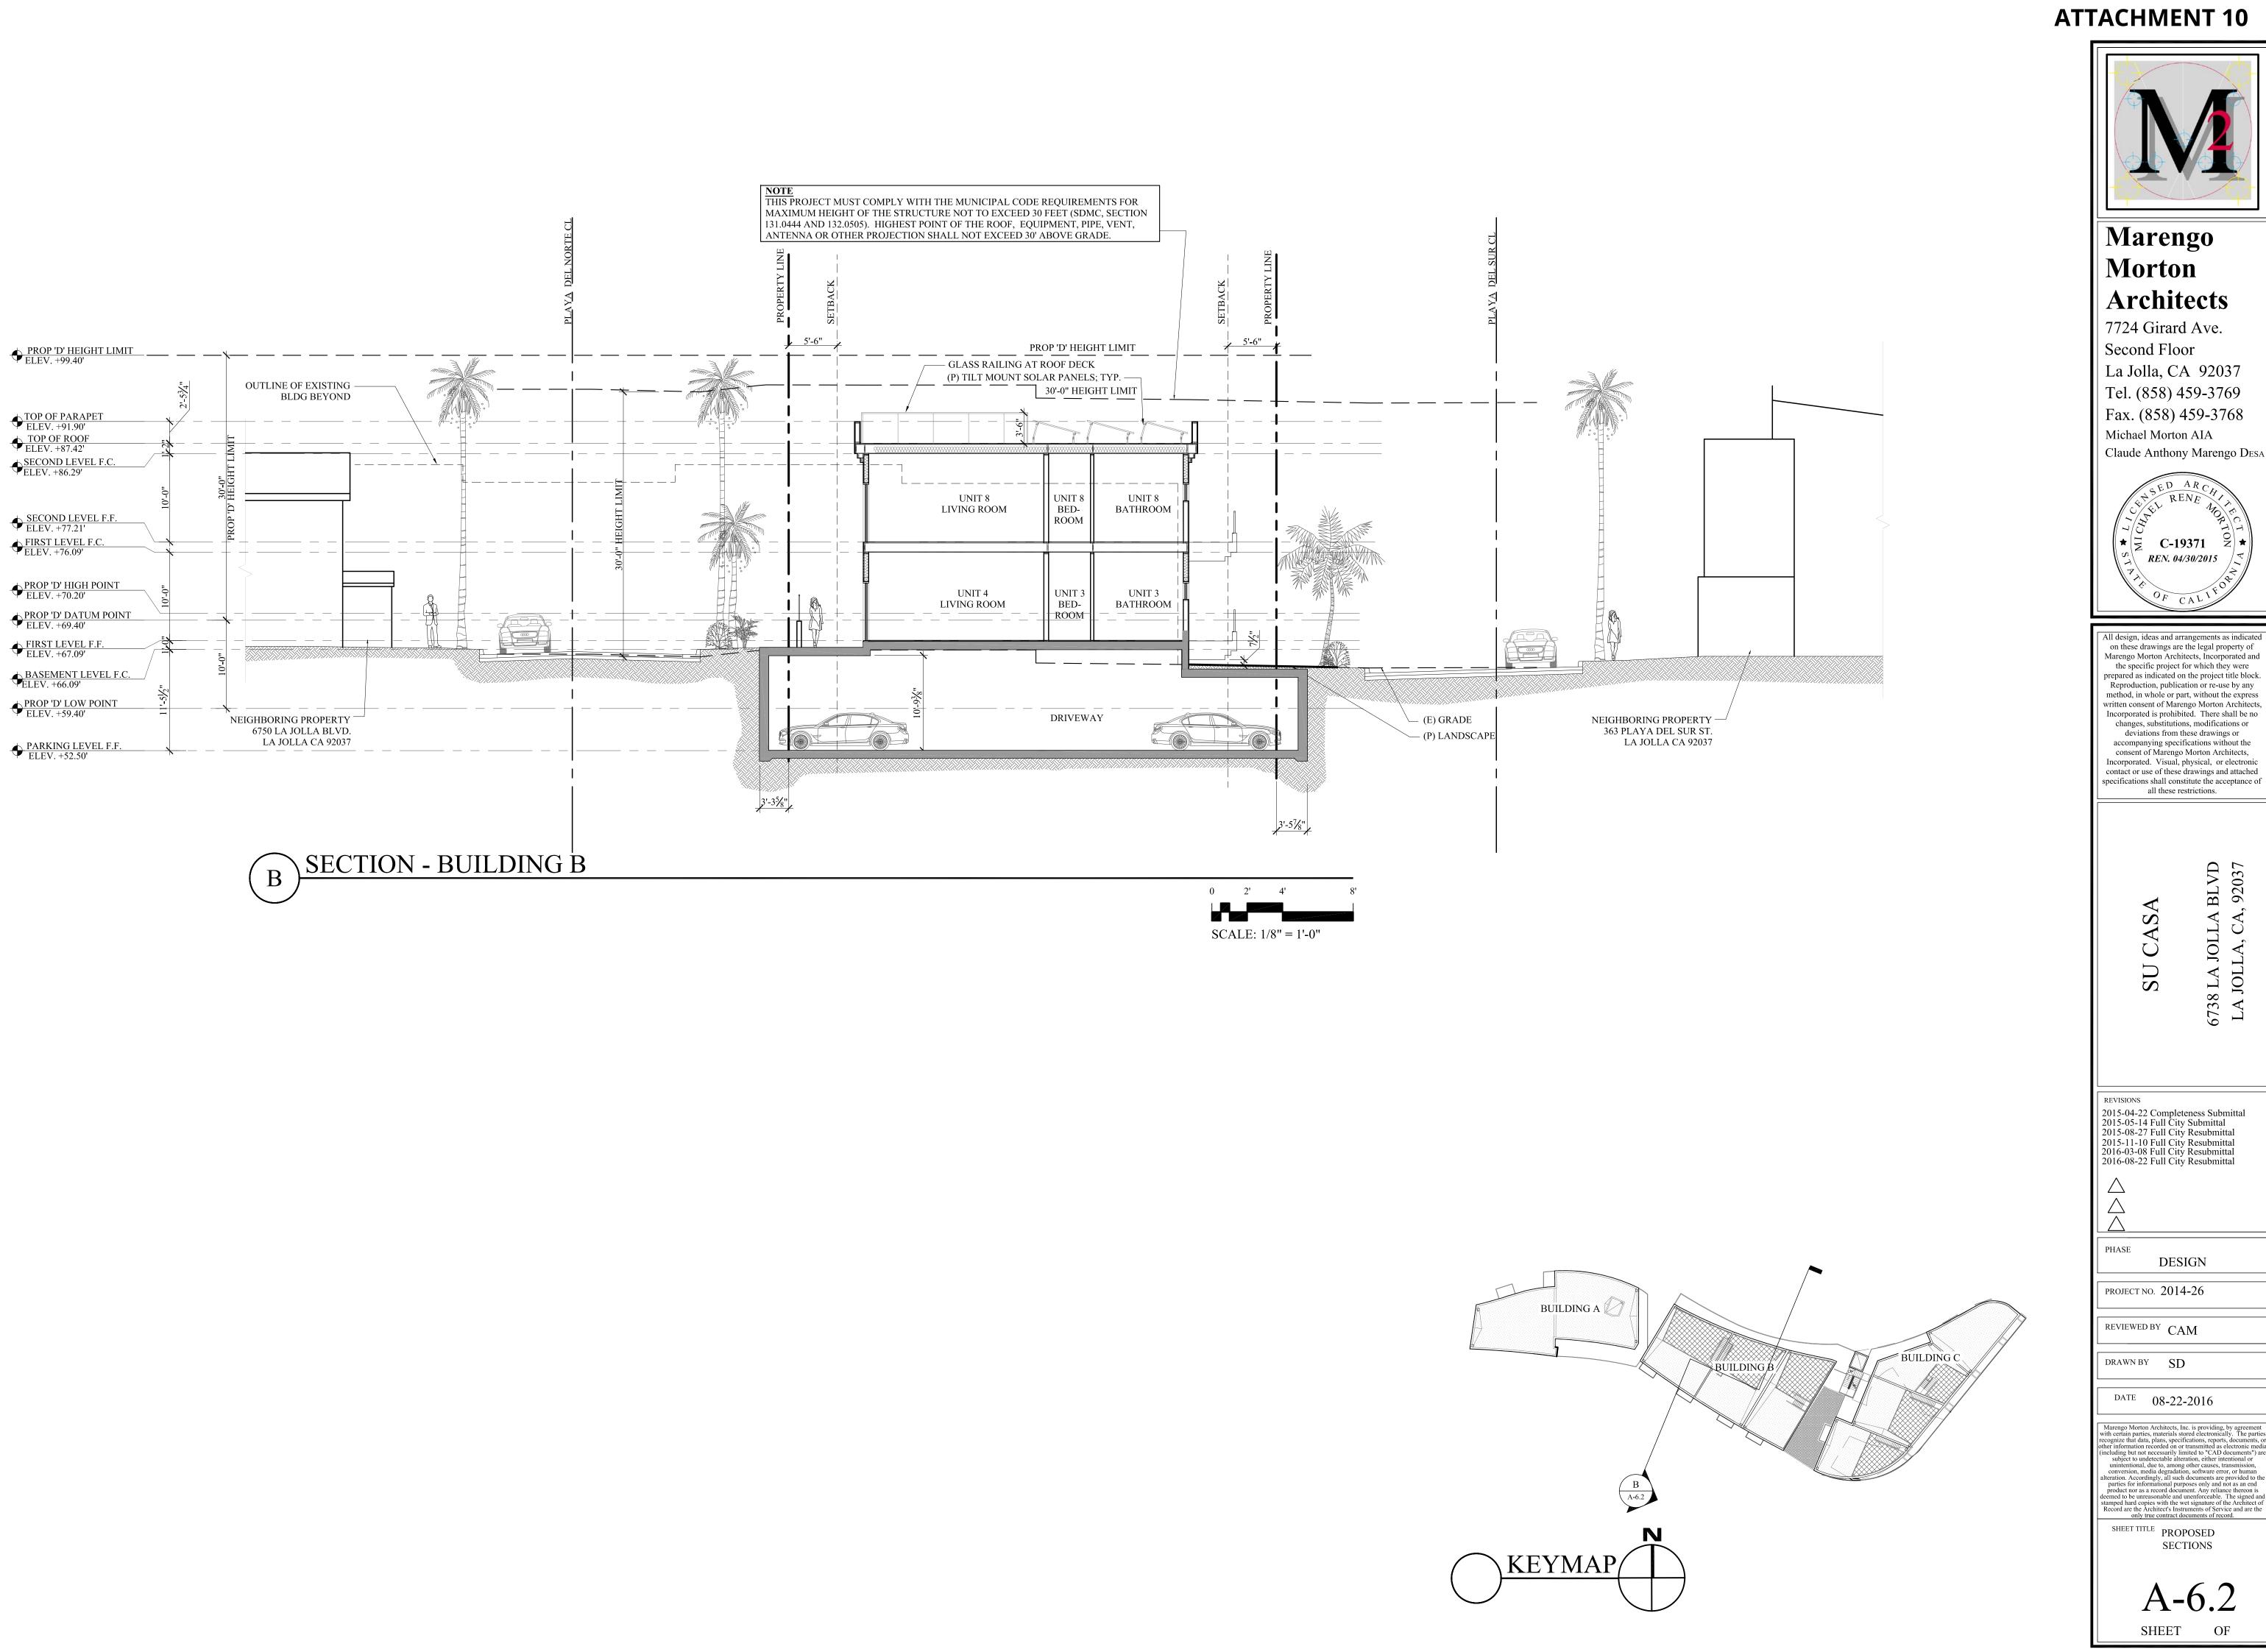


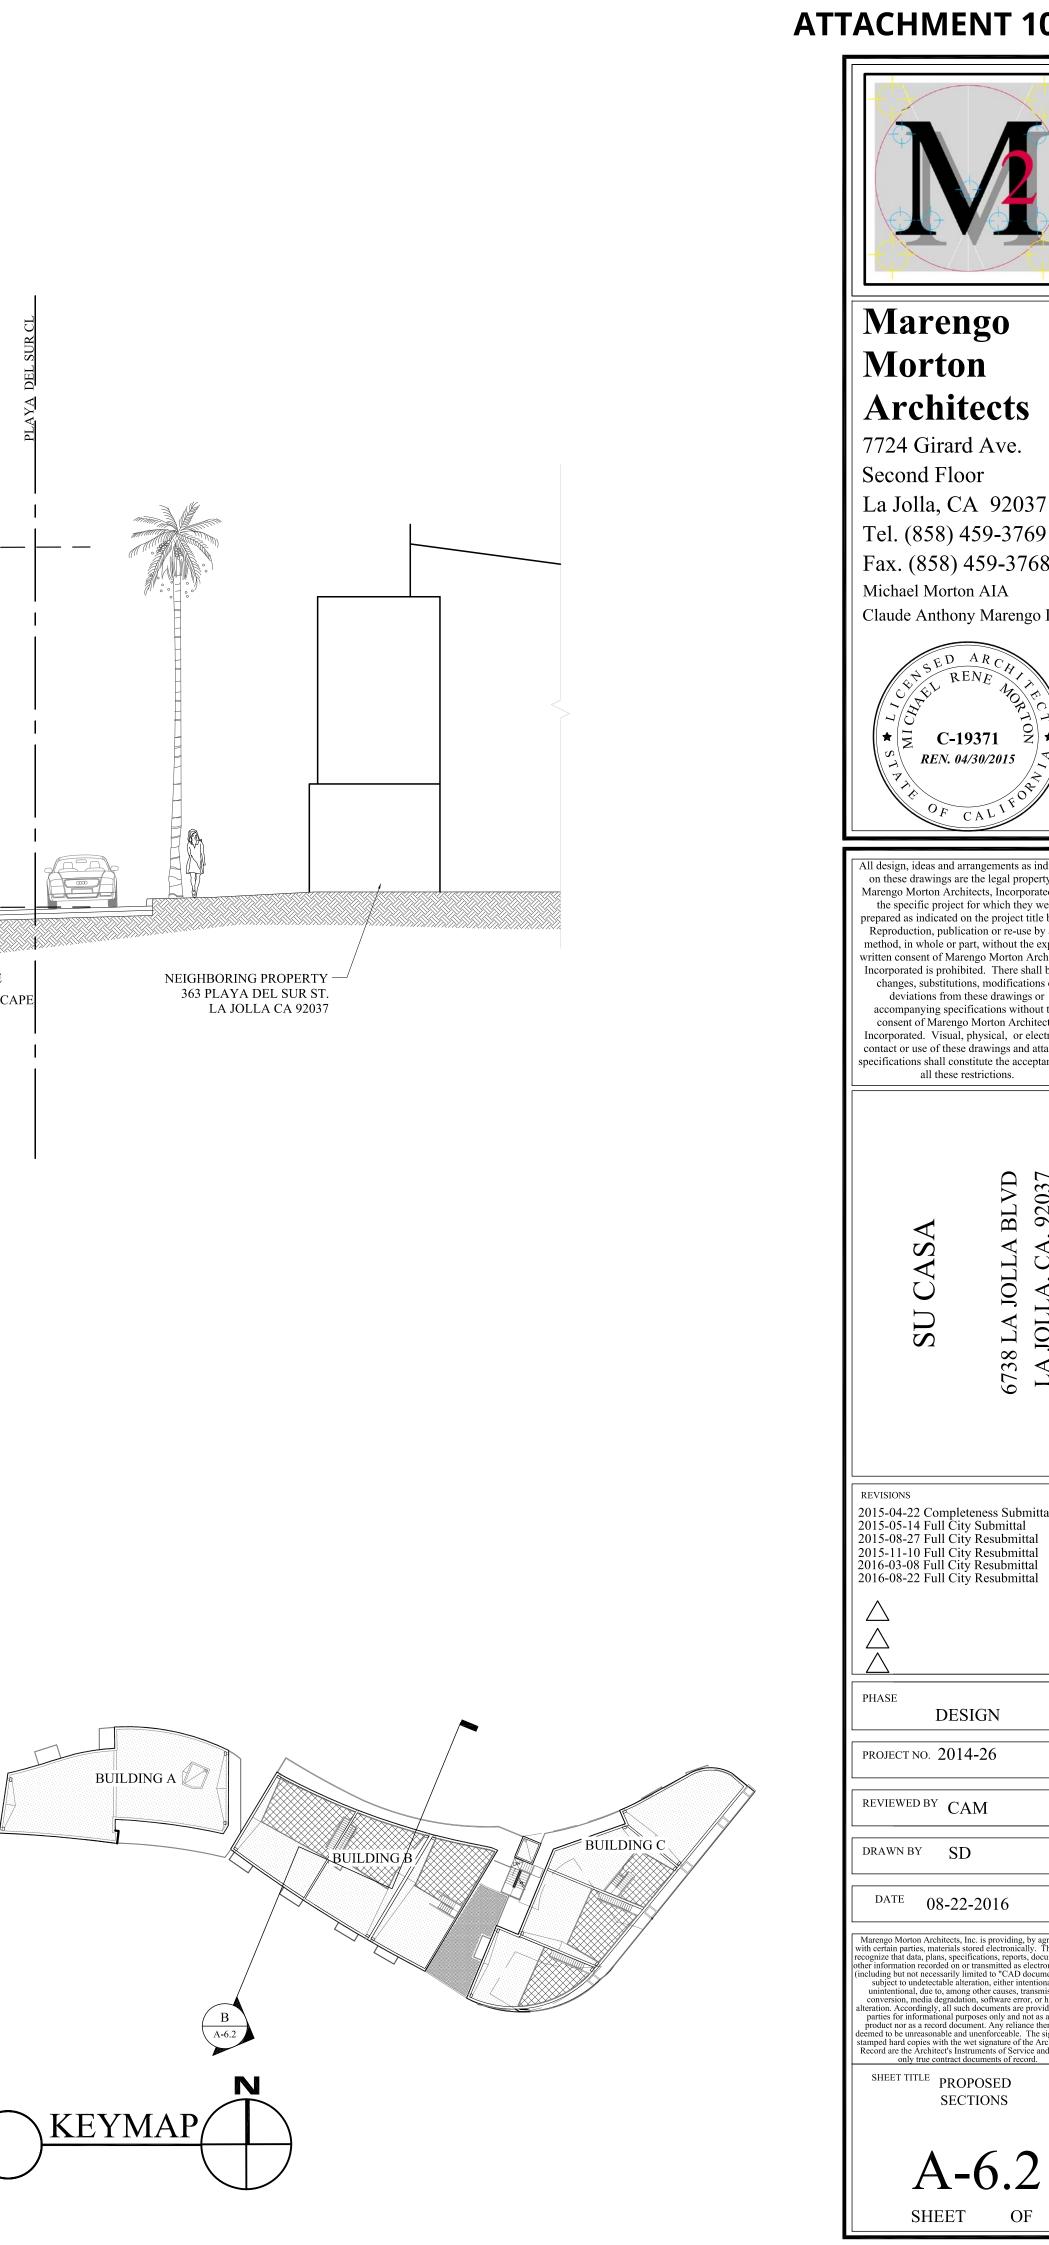





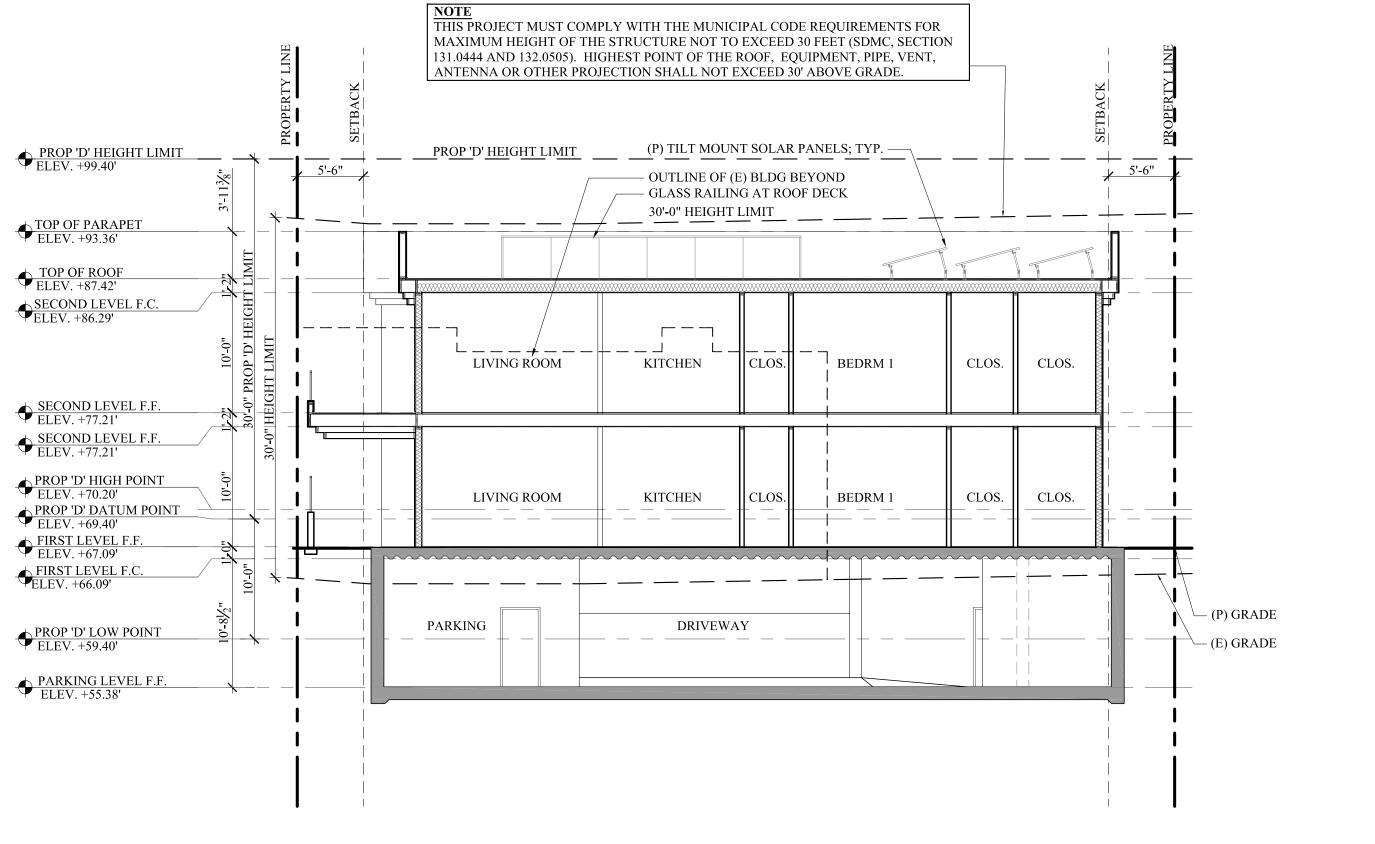


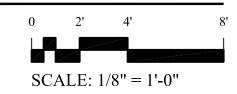

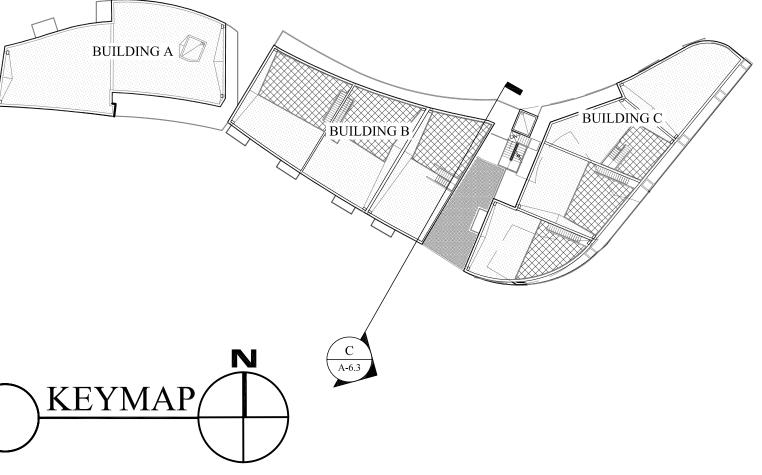


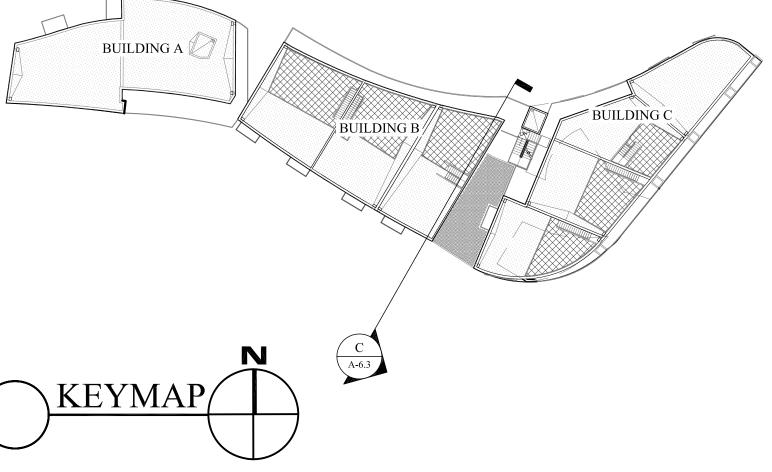


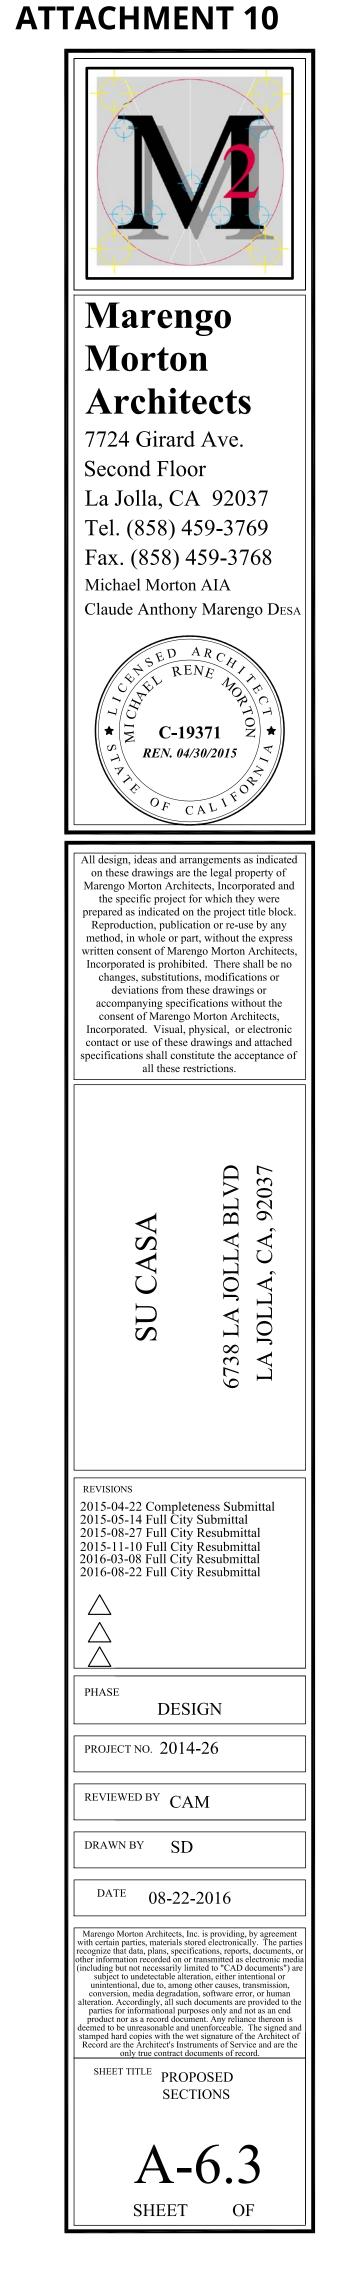

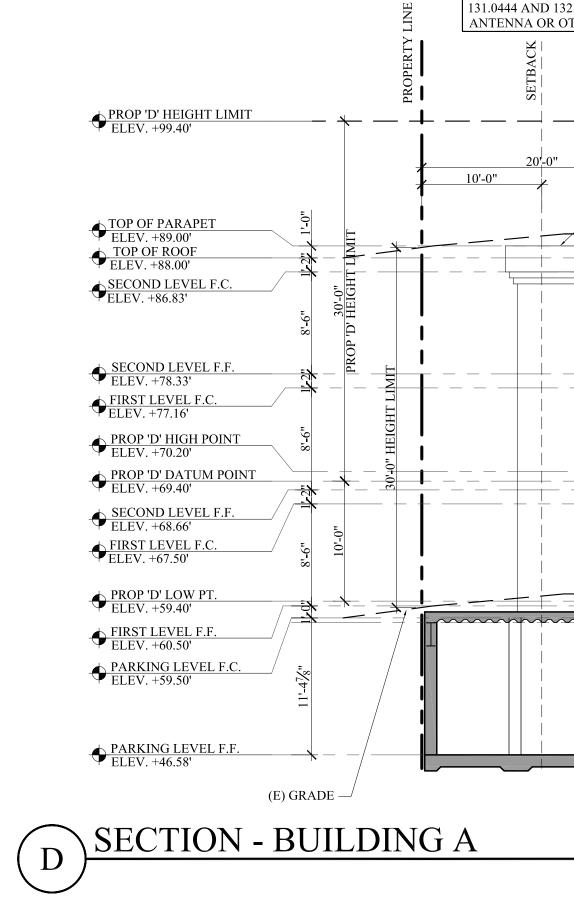


MAXIMUM HEIGHT OF THE STI 131.0444 AND 132.0505). HIGHES	WITH THE MUNICIPAL CODE REQUIREMENTS FOR RUCTURE NOT TO EXCEED 30 FEET (SDMC, SECTION ST POINT OF THE ROOF, EQUIPMENT, PIPE, VENT, ION SHALL NOT EXCEED 30' ABOVE GRADE.	
L SETBACK	PROP 'D' HEIGHT LIMIT	
	- STRUCTURE BEYOND FLUSH MOUNT SOLAT PANEL; TYP. 30'-0" HEIGHT LIMIT	
	CLOSET FAU HALL LIVING ROOM	OUTLINE OF EXISTING BLDG
	CLOSET FAU HALL LIVING ROOM	
	CLOSET FAU HALL LIVING ROOM	
PARKING		PARKING

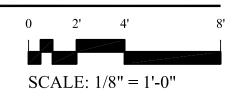


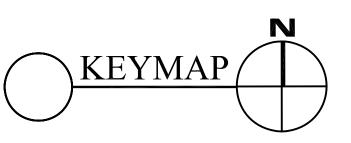



 $\left(\begin{array}{c} D\\ A-6.3 \end{array}\right)$

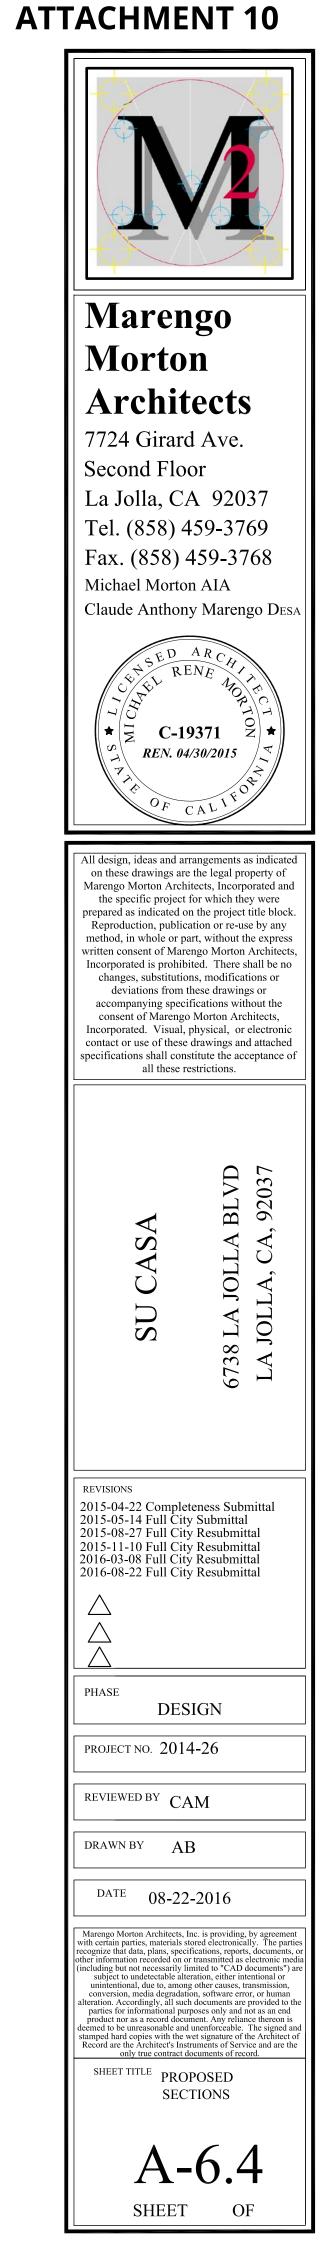



BUILDING A BUILDING C BUILDING B

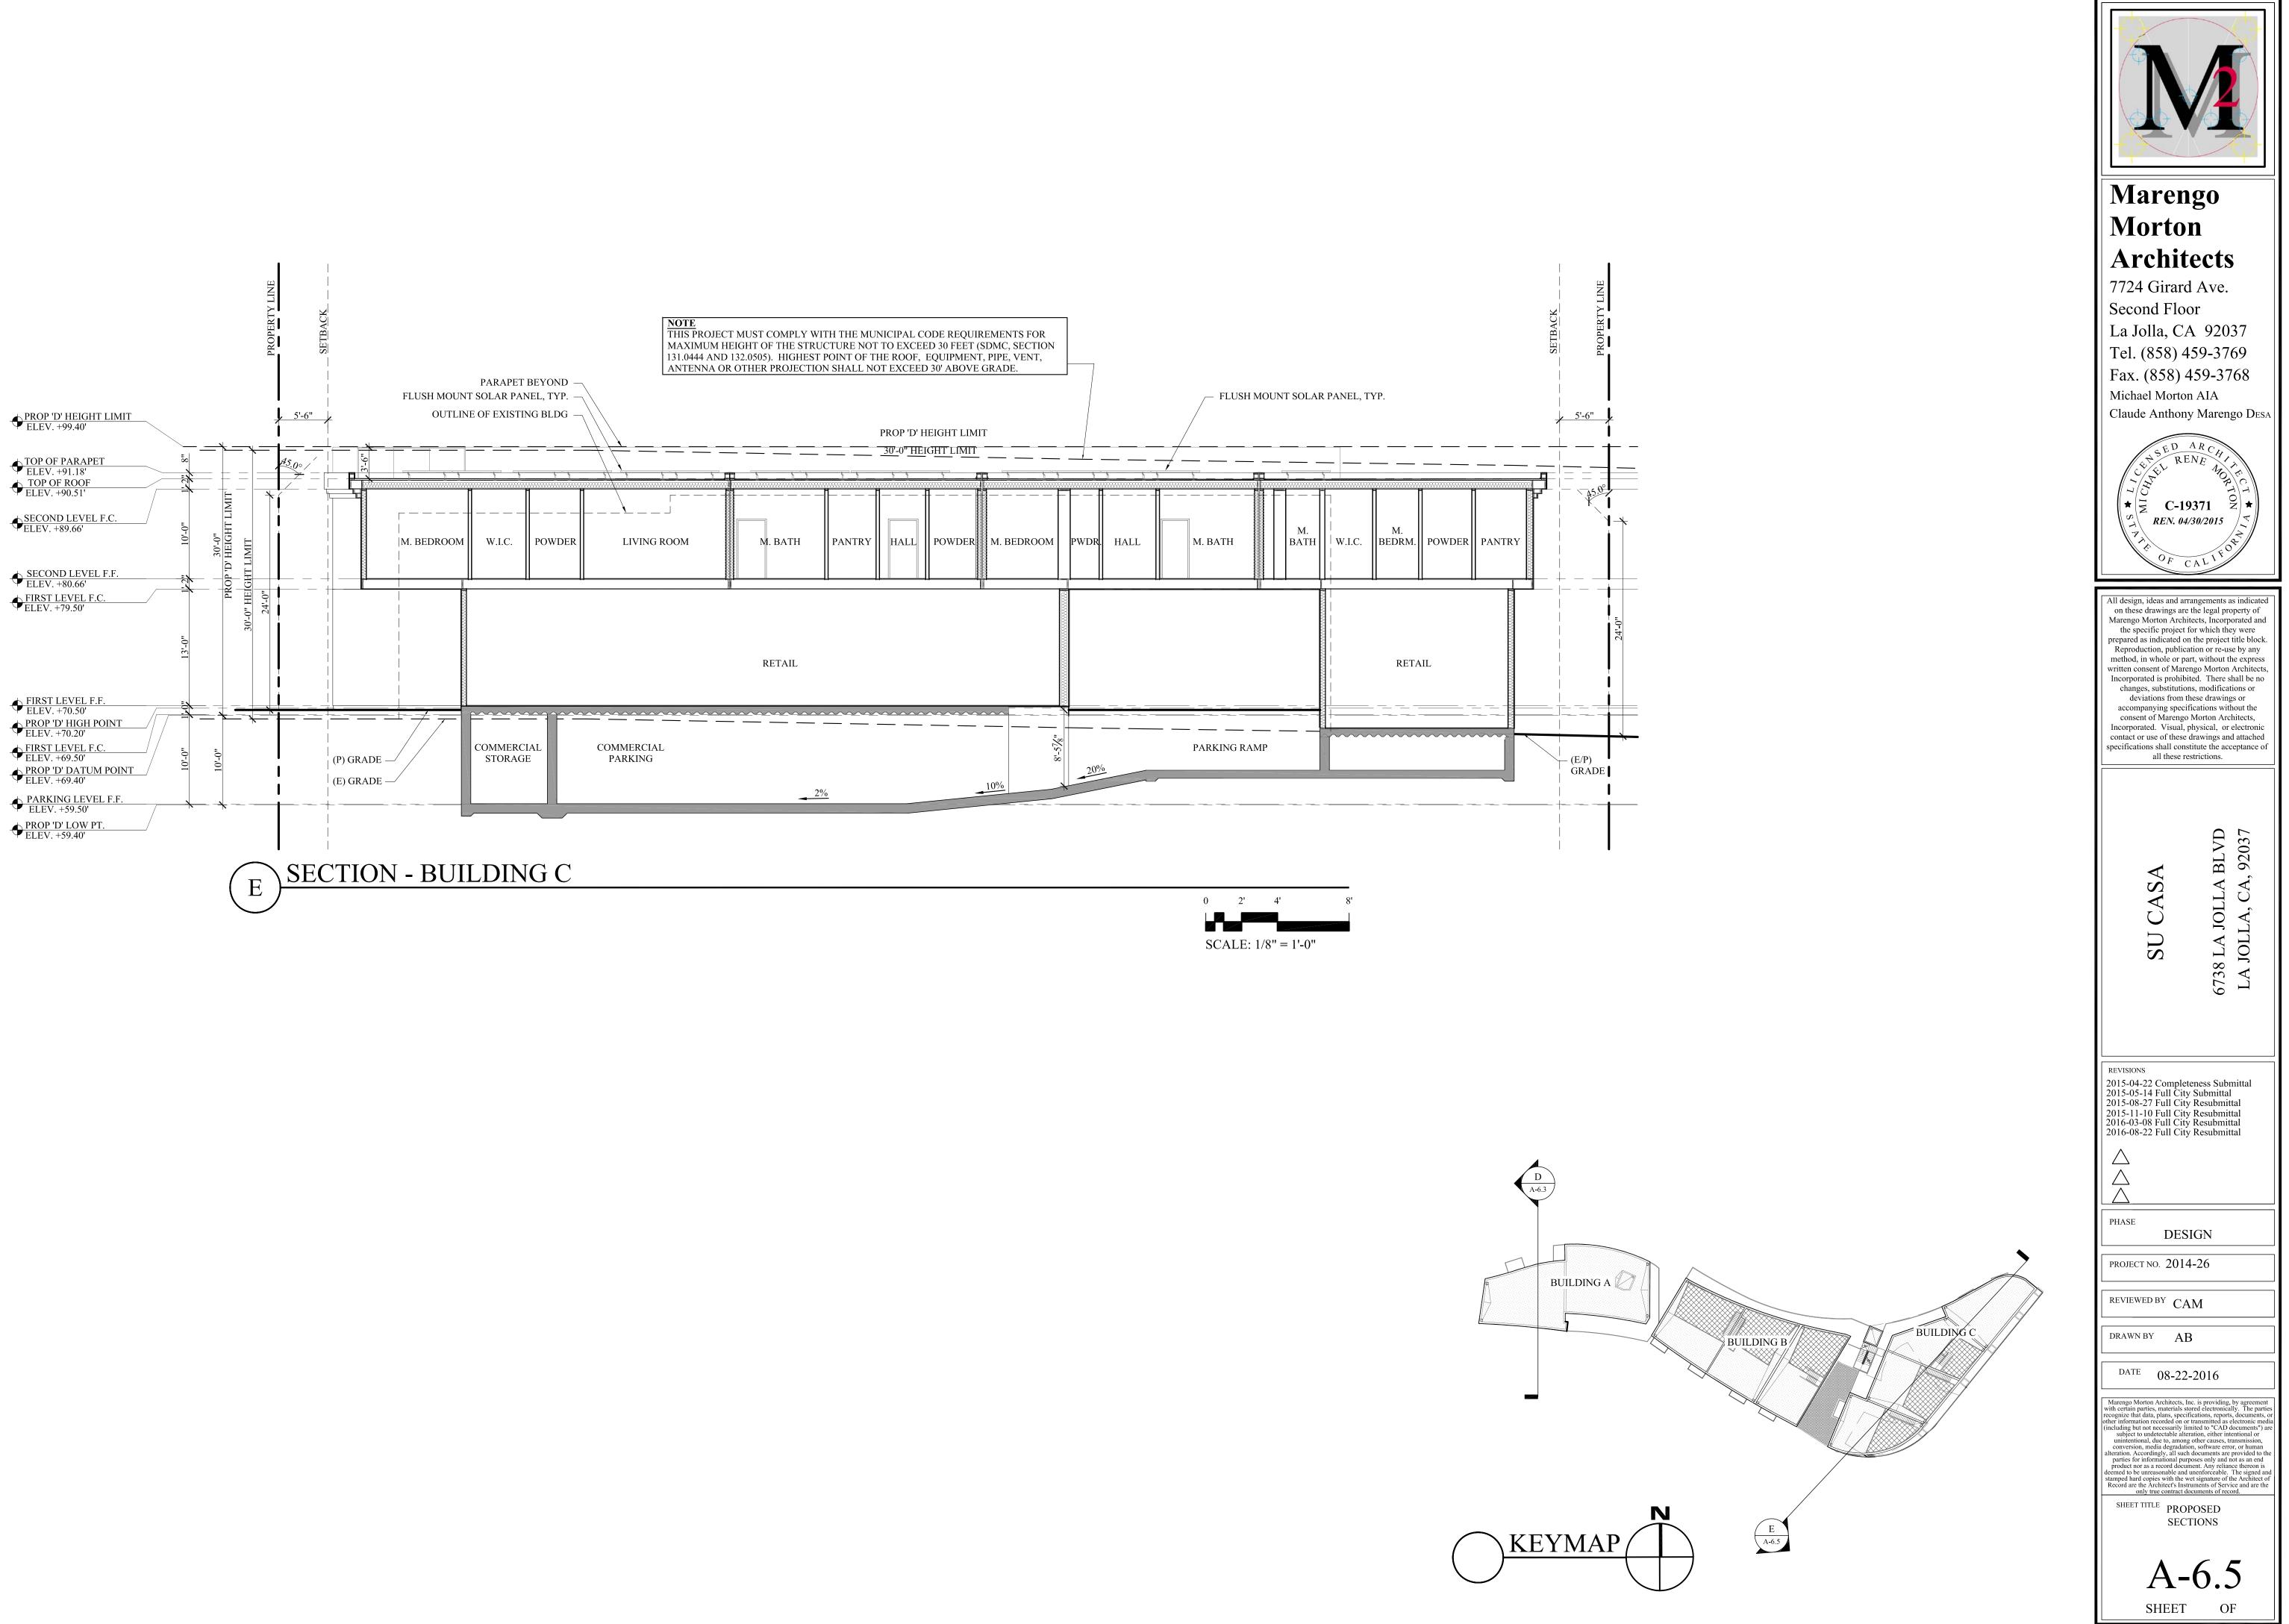

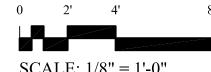

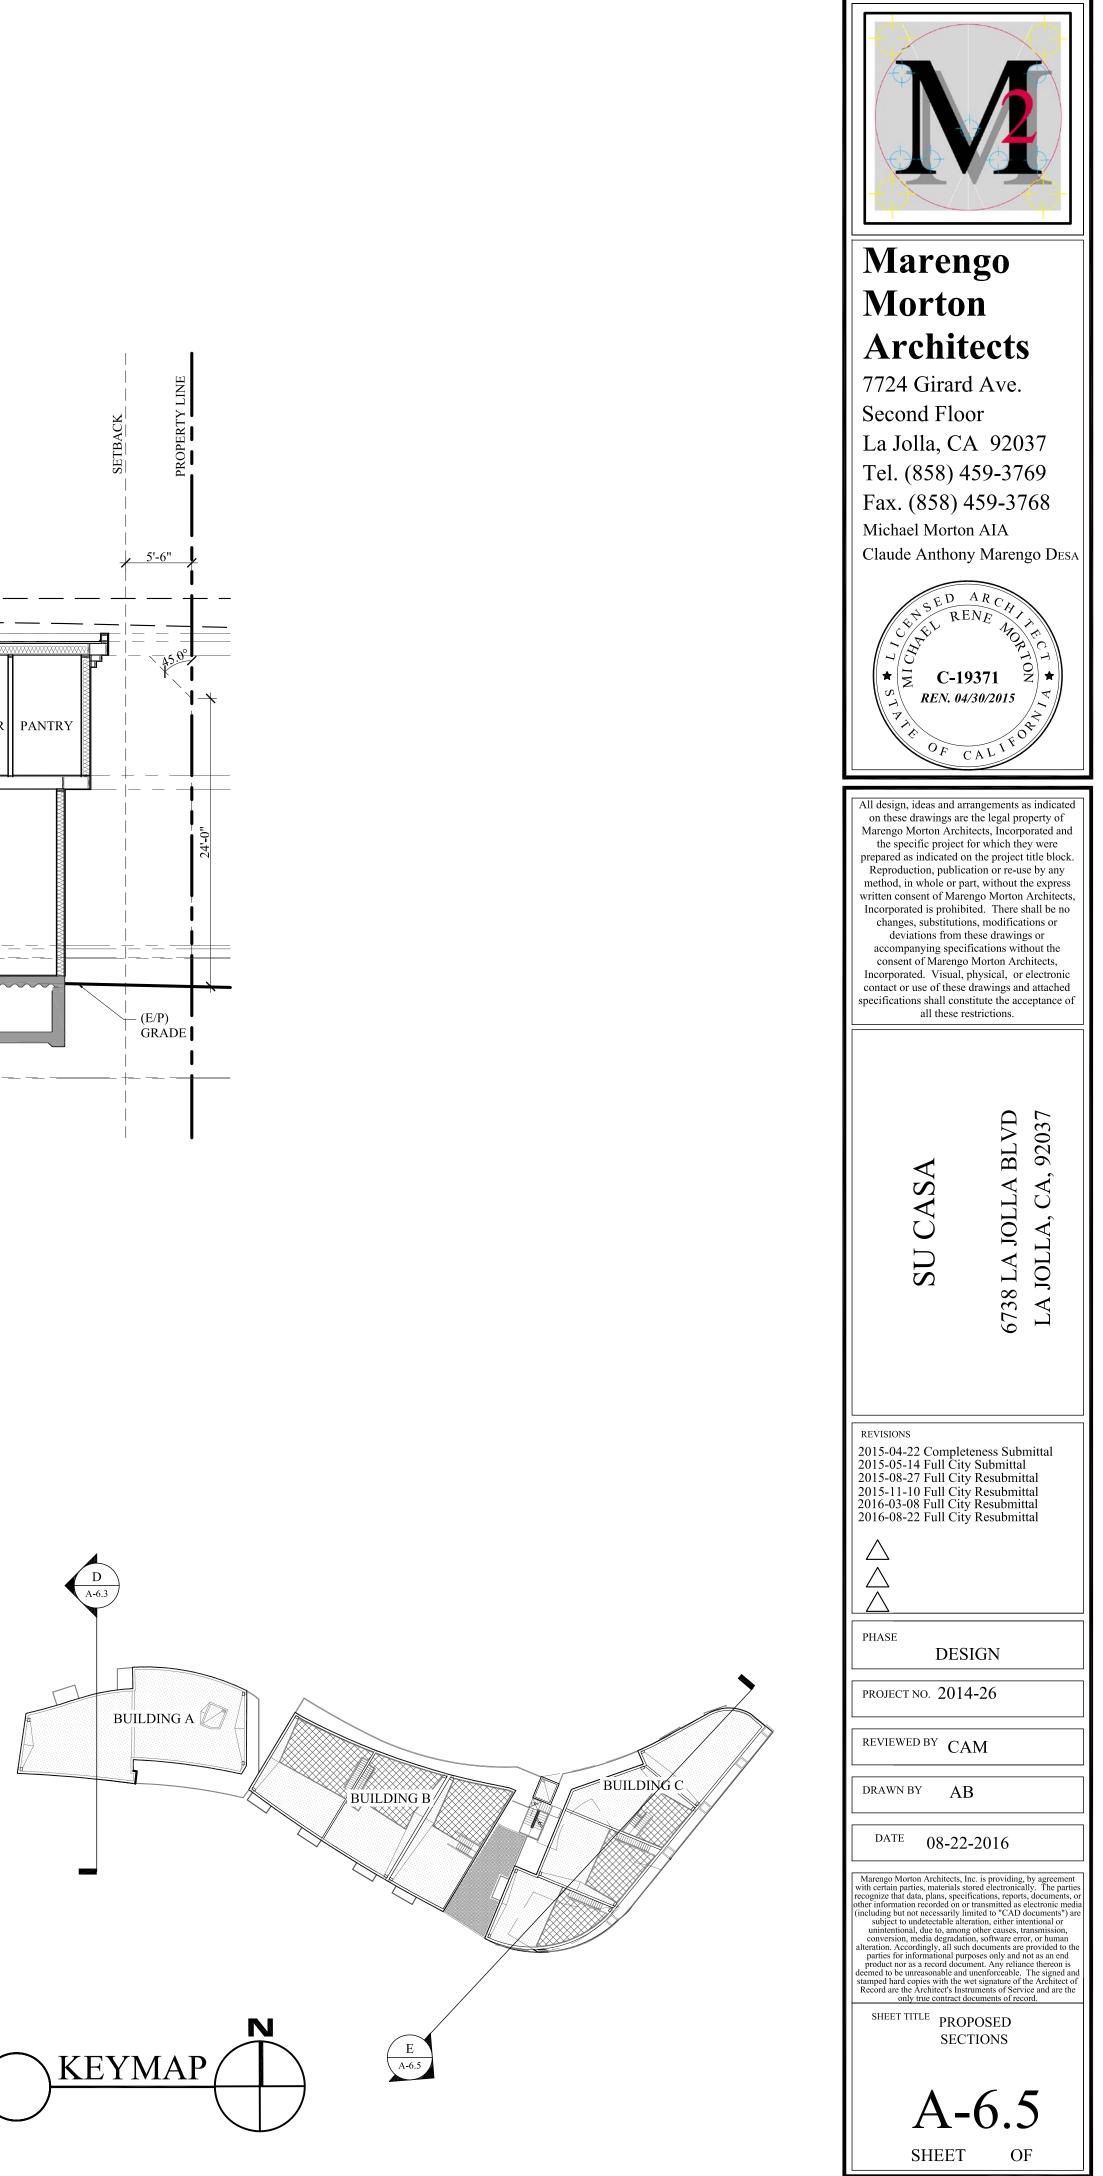

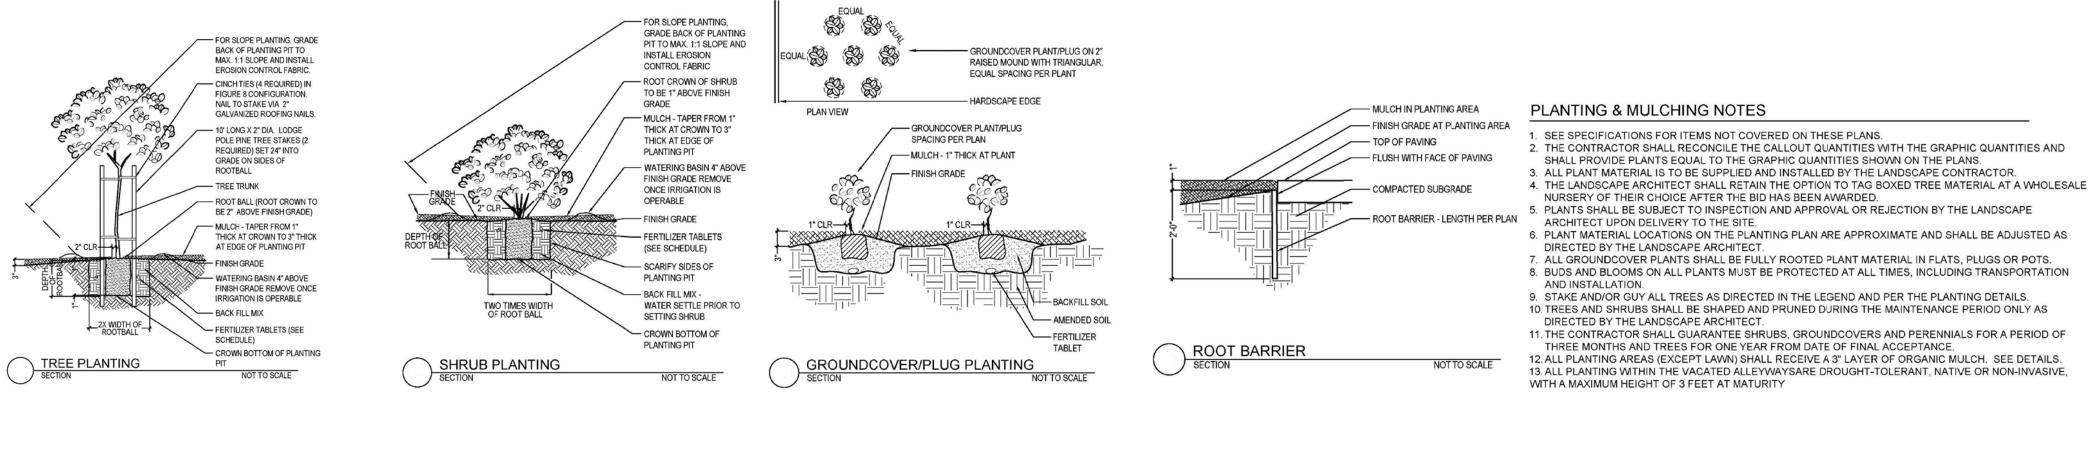

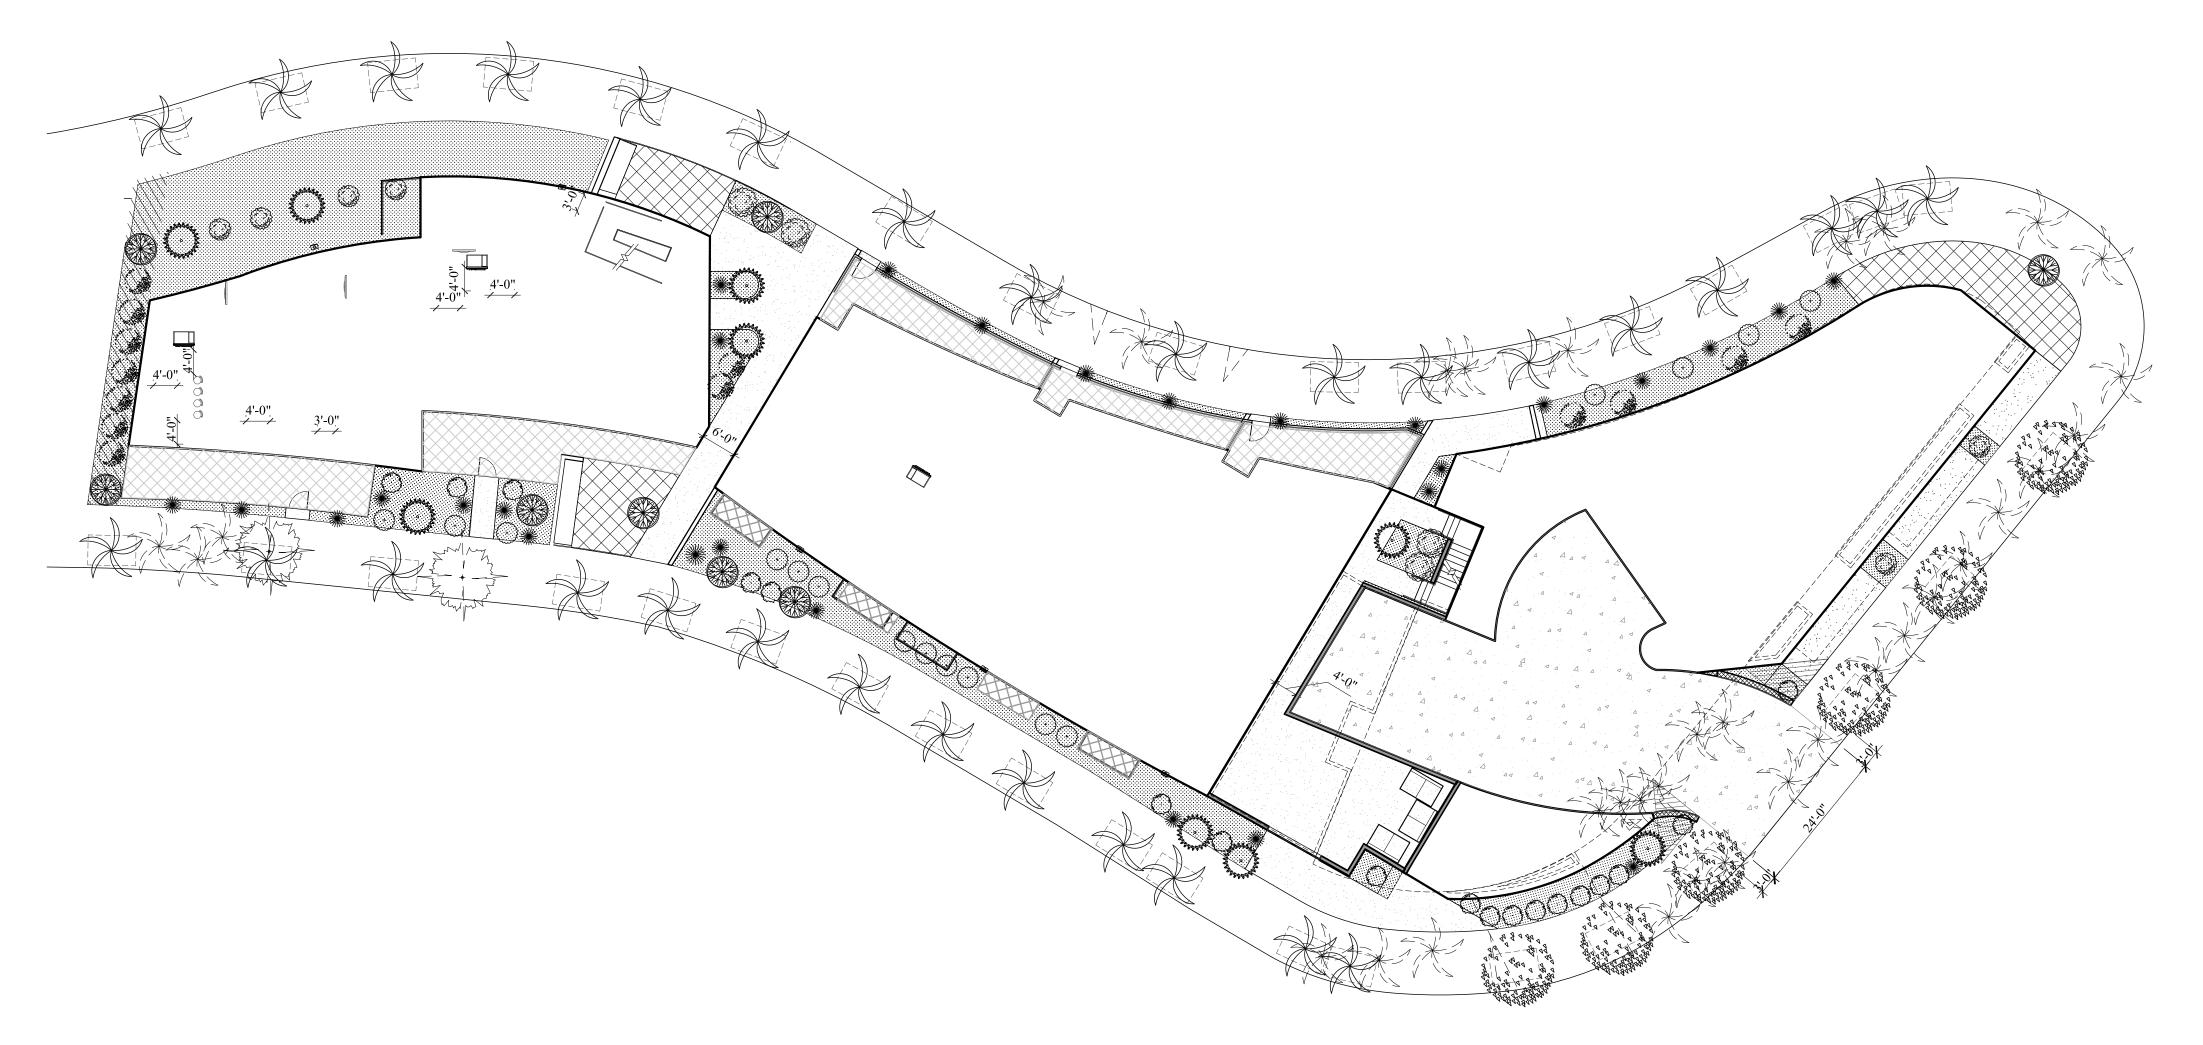



PLANTING NOTES

. DEDICATED LANDSCAPE IRRIGATION METERS SHALL BE REQUIRED IN ALL NEW DEVELOPMENT WITH A LANDSCAPE AREA GREATER THAN OR EQUAL TO 5,000 SQUARE FEET; EXCEPT THAT THIS REQUIREMENT SHALL NOT APPLY TO NEW SINGLE DWELLING UNIT DEVELOPMENT OR TO THE COMMERCIAL PRODUCTION OF AGRICULTURAL CROPS OR LIVESTOCK.

2. LANDSCAPE IRRIGATION SUBMETERS SHALL BE REQUIRED IN THE FOLLOWING DEVELOPMENTS:

(A) NEW SINGLE DWELLING UNIT DEVELOPMENT;

(B) IMPROVEMENTS TO EXISTING INDUSTRIAL, COMMERCIAL AND

MULTIPLE DWELLING UNIT DEVELOPMENT WHEN: (I) THE IMPROVEMENT REQUIRES A BUILDING PERMIT AS IDENTIFIED IN TABLE 142-04A; AND

(II) THE LANDSCAPE AREA IS 1,000 SQUARE FEET AND GREATER.

. NO TREES OR SHRUBS EXCEEDING THREE FEET IN HEIGHT AT MATURITY SHALL BE INSTALLED WITHIN TEN FEET OF ANY SEWER FACILITIES AND FIVE FEET OF ANY WATER FACILITIES.


4. THE OWNER/PERMITTEE SHALL PROCESS ENCROACHMENT MAINTENANCE AND REMOVAL AGREEMENTS, FOR ALL ACCEPTABLE ENCROACHMENTS

INTO THE WATER AND SEWER EASEMENT, INCLUDING BUT NOT LIMITED TO STRUCTURES, ENHANCED PAVING, OR LANDSCAPING. NO STRUCTURES OR LANDSCAPING SHALL BE INSTALLED IN OR OVER THE WATER AND SEWER EASEMENT THAT WOULD INHIBIT VEHICULAR ACCESS TO REPLACE A SECTION OF MAIN OR PROVIDE ACCESS TO ANY APPURTENANCE OR ISOLATED SECTION OF MAIN.

ABOVE GROUND UTILITY STRUCTURES - 10 FEET 5. THE OWNER/PERMITTEE SHALL BE RESPONSIBLE FOR ANY DAMAGE DRIVEWAY (ENTRIES) - 10 FEET CAUSED TO CITY OF SAN DIEGO WATER AND SEWER FACILITIES IN THE VICINITY OF THE PROJECT SITE, DUE TO THE CONSTRUCTION ACTIVITIES INTERSECTIONS (INTERSECTING CURB LINES OF TWO STREETS - 25 FEET ASSOCIATED WITH THIS PROJECT, IN ACCORDANCE WITH MUNICIPAL CODE 9. IF ANY REQUIRED LANDSCAPE INDICATED ON THE APPROVED SECTION 142.0607. IN THE EVENT THAT ANY SUCH FACILITY LOSES CONSTRUCTION DOCUMENT PLANS IS DAMAGED OR REMOVED DURING INTEGRITY THEN, THE OWNER/PERMITTEE SHALL REPAIR OR DEMOLITION OR CONSTRUCTION, IT SHALL BE REPAIRED AND/OR RECONSTRUCT ANY DAMAGED PUBLIC WATER AND SEWER FACILITY IN A REPLACED IN KIND AND EQUIVALENT SIZE PER APPROVED DOCUMENTS TO MANNER SATISFACTORY TO THE PUBLIC UTILITIES DIRECTOR AND THE THE SATIFACTION OF THE DEVELOPMENT SERVICES DEPARTMENT WITHIN 12. EXISTING TREES TO REMAIN ON SITE WITHIN THE AREA OF WORK WILL CITY ENGINEER. 30 DAYS OF DAMAGE.

6. ALL LANDSCAPE AND IRRIGATION SHALL CONFORM TO THE STANDARDS OF THE CITY-WIDE LANDSCAPE REGULATIONS AND THE CITY OF SAN DIEGO 10.MAINTENANCE: ALL REQUIRED LANDSCAPE AREAS SHALL BE LAND DEVELOPMENT MANUAL LANDSCAPE STANDARDS AND ALL OTHER MAINTAINED BY LANDSCAPE RELATED CITY AND REGIONAL STANDARDS.



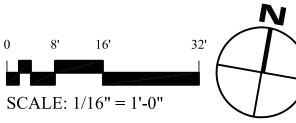

7.	A MINIMUM ROOT ZONE OF 40 SF IN AREA SHALL BE PROVIDED FOR ALL
	TREES. THE MINIMUM DIMENSION FOR THIS AREA SHALL BE 5 FEET, PER
	SDMC 142.0403(b)(5).

8. MINIMUM TREE SEPARATION DISTANCE: TRAFFIC SIGNALS/STOP SIGNS - 20 FEET UNDERGROUND UTILITY LINES - 5 FEET (10 FEET FOR SEWER)

RIGHT-OF-WAY SHALL BE MAINTAINED BY . THE LANDSCAPE AREAS SHALL BE MAINTAINED FREE OF DEBRIS AND LITTER, 3. A TREE WATERING SCHEDULE WILL BE MAINTAIN AND ALL PLANT MATERIAL SHALL BE MAINTANED IN A HEALTHY GROWING CONDITION. DISEASED OR DEAD MATERIAL SHALL BE SATISFACTORILY TREATRED OR REPLACED PER THE CONDITIONS OF THE OF EQUAL OR GREATER SIZE. PERMIT.

11.IRRIGATION: AN AUTOMATIC, ELECTRONICALLY CONTROLLED IRRIGATION SYSTEM SHALL BE PROVIDED AS REQUIRED BY LDC 142.0403(c) FOR PROPER IRRIGATION, DEVELOPMENT, AND MAINTENANCE OF THE VEGETATION IN A HEALTHY, DISEASE-RESISTANT CONDITION. THE DESIGN OF THE SYSTEM SHALL PROVIDE ADEQUATE SUPPORT FOR THE VEGETATION SELECTED.

BE PROTECTED IN PLACE. THE FOLLOWING MEASURES MUST BE PROVIDED: 1. A BRIGHT YELLOW OR ORANGE TEMPORARY FENCE WILL BE PLACED AROUND EXISTING TREE AT DRIP LINE. 2. STOCKPILING, TOPSOIL DISTURBANCE, VEHICLE USE AND MATERIAL

. LANDSCAPE AND IRRIFGATION AREAS IN THE PUBLIC STORAGE OF ANY KIND IS PROHIBITED WITHIN THE DRIP LINE. AND DOCUMENTED DURING CONSTRUCTION. 4. ALL DAMAGED TREES WILL BE REPLACED WITH O

LJPDO-4: LANDSCAPE OPT	ION B PER SD		LJPDO-4			
LOT AREA	RM 3-7 ZON 6,581.72SF	E AREA %	ZONE 15,459.24 SF	AREA %		
(P) BUILDING FOOTPRINT (P) LANDSCAPED AREA	3,359.34 SF 3,222.38 SF	51.04 % 48.96 %	8,345.5 SF 4,942.63 SF	53.98 % 31.91 %		
(P) DRIVEWAY AREA	3,222.38 SF 0 SF	48.96 % 0 %	4,942.63 SF 2,171.11 SF	31.91 % 14.11 %	¢.) V (
STREET TRE Per SD Municipal Code, one 24	I-inch box tree	for every 30 feet	t of street frontage	e or one		
10-foot brown trunk height palı PLAYA DEL SUR ST.	n for each 20 fe	et of street front	age.		Mar	ongo
Per Code Lot RM-3-7 102'/30= 3.4 trees Lot LJRD-4 153'/30= 5.1 trees LA JOLLA BLVD.		palms 5	ROPOSED QUAI PALMS PALMS	NTITY	Mor	
Per Code Lot LJRD-4 181'/30= 6.1 trees	3	67	TREES			hitects
PLAYA DEL NORTE ST. Per Code					Second	irard Ave. Floor
Lot RM-3-7 109'/30= 3.6trees Lot LJRD-4 230'/30= 7.6 tree.			PALMS 2 PALMS			a, CA 9203
LANDSCAPE CALCULATIONS (PER SDMC 142.0401-142			E CALCULATIONS (L SDMC 142.0401-142			58) 459-376
RESIDENTIAL DEVELOPMENT		RESIDENTIAL DEV STREET YARD 3985 SF x	ELOPMENT 50% 1992.5 S.F	REQUIRED	, i i i i i i i i i i i i i i i i i i i	58) 459-376 Aartan ALA
2860 SF x 0.05 142.98 PO	. Provided NTS required	3985 SF x	1547.9 S.F 0.05 199.25 PO	. PROVIDED		Morton AIA nthony Mareng
I/2 POINTS (P) 24-IN TREE 5 50 POI (P) 15-GAL TREE 10 100 POI		(P) 24-IN TREE (P) 15-GAL TREE	6 60 PO			ED AR
(P) 15-GAL IREE 10 100 PO (P) 15-GAL SHRUB 4 40 PO (P) 5-GAL SHRUB 6 60 PO	NTS	(P) 15-GAL SHRUB (P) 5-GAL SHRUB	3 7 70 PO 31 310 PO	INTS INTS		ED ARCHI RENE MO
250 PR		REMAINING YARD REMAINING YARD	DAREA 660.0 SF	UVIDED		ORTC
REMAINING YARD AREA 301.2 SF # OF RESIDENTIAL UNITS 6 EA. BUILDING = 60 PO	NTS	# OF RESIDENTIAL EA. BUI 2 BUILDINGS x	L UNITS 10 LDING = 60 POI	INTS INTS REQUIRED	* 2	C-19371 Ž EN. 04/30/2015
1 BUILDINGS x 60 60 PO (P) 24-IN TREE 2 20 PO	NTS REQUIRED	(P) 24-IN TREE (P) 15-GAL TREE	3 60 PO 2 20 PO	INTS INTS		08
	OVIDED	(P) 15-GAL SHRUB	120 PR			OF CALIF
LANDSCA	PE LI	EGEN.	D			s and arrangements as
OU	JTLINE OF PR	OPOSED STRU	JCTURE		Marengo Morto the specific	vings are the legal prop on Architects, Incorpor project for which they
VI	SIBILITY TRI	ANGLE			prepared as ind Reproduction	icated on the project tit a, publication or re-use ole or part, without the
PR	OPOSED PAT	IO AREA			written consent Incorporated is	of Marengo Morton A s prohibited. There sha
PR	OPOSED HAF	RDSCAPE AREA	Ą		deviation accompanyin	bstitutions, modificatio as from these drawings ng specifications witho
PR	OPOSED STR	EET FRONT LA	ANDSCAPE		consent of M Incorporated.	Marengo Morton Archi Visual, physical, or el of these drawings and a
PR	OPOSED REM	IAINING LAND	DSCAPE		specifications sl	of these drawings and a hall constitute the accept these restrictions.
PR	OPOSED DRI	VEWAY				
		VEWAY GUAR	DRAIL			
PR	OPOSED SITE	WALL				D
EX	ISTING TREE	TO REMOVE				LA BLV
EX	ISTING PALM	I TO REMOVE				
	TINT	FSDECIES				5738
A A A A A A A A A A A A A A A A A A A	JACA Jacan 25'-4 Medi	E SPECIES ARANDA - STR vanda mimosifoli 0' tall - 48" box um water needs itiy: 6				
V48335		EN PALM - STF			REVISIONS 2015-04-22 C 2015-05-14 F	Completeness Submi Full City Submittal
	25'-4 Medi Quan	astrum romanzofj 0' tall - 48" box um water needs itiy: 30			2015-08-27 F 2015-11-10 F 2016-03-08 F	full City Resubmitta full City Resubmitta full City Resubmitta full City Resubmitta
and a second sec	Aesci 20'-0 Low	IFORNIA BUCK ılus californica " max. tall - 24-iı water needs itiy: 9				
	Cerci 15'-0 Low	TERN RED BUI is occidentalis " max. tall - 24" i water needs itiy: 8			PHASE PROJECT NO.	DESIGN 2014-26
*	ELEC Cord 8'-0" Low	CTRIC PINK GR vline banksii - sp max. tall - 15-ga water needs	orilecpink		REVIEWED B	
	Quan <u>SHR</u>	<i>itiy: 28</i> <u>UBS</u>			DRAWN BY	GR
) INDI <i>Rhap</i> 5'-0"	A HAWTHORN hiolepis Indica max. tall - 5-gal tity: 16			Marengo Morton A	08-22-2016 rchitects, Inc. is providing, by naterials stored electronically
) BIG I Hydr 3'-0"	tity: 16 LEAF HYDRAN(angea Macrophu max. tall - 5-gal tity: 20	ılla 'Pia'		recognize that data, p other information recc (including but not nec subject to undete unintentional, du conversion, media alteration. According parties for inform product nor as a re	lans, specifications, reports, c orded on or transmitted as ele cessarily limited to "CAD doc ectable alteration, either inten e to, among other causes, tran degradation, software error, gly, all such documents are pro ational purposes only and not cord document. Any reliance
	BOU Boun 15'-4	tity: 20 NGAINVILLEA gainvillea 0' tall - 15-gal tity: 8	L		deemed to be unrease stamped hard copies Record are the Arch only true SHEET TITLE	nable and unenforceable. Th with the wet signature of the nitect's Instruments of Service contract documents of record PROPOSED
	SILV	ER SHEEN KOI sporum tenuifoliu " max. tall - 15-g	ит			.ndscape plan

