

LANDSCAPE CALCULATIONS

STREET YARD

TOTAL AREA = 25,644 SQ. FT. **PLANTING AREA REQUIRED = 25,668 x 25% = 6,411 SQ. FT.** PLANTING AREA PROVIDED = 14,937 SQ. FT. EXCEEDS REQUIREMENT BY 8,520 SQ. FT.

SHALL BE INSTALLED WITHIN THE PROPOSED WATER EASEMENT.

PLANT POINTS REQUIRED = 25,668 x .05 = 1,283 POINTS PLANT POINTS PROVIDED = 1,350 POINTS

> I EXISTING 8" CAL. TORREY PINE 250 POINTS I EXISTING 6" CAL. TORREY PINE 200 POINTS 40 POINTS (8) 5 GAL TREES * 5 PTS= 70 POINTS (7) 15 GAL TREES * 10 PTS= 340 POINTS (17) 24" BOX TREES * 20 PTS= (9) 36" BOX TREES * 50 PTS= 450 POINTS

1,350 POINTS EXCEEDS REQUIREMENT BY 57 POINTS

REMAINING YARD

TOTAL AREA = 696 SQ. FT. PLANTING AREA REQUIRED = 696 × 30% =208 SQ. FT. PLANTING AREA PROVIDED = 323 SQ. FT.

EXCEEDS REQUIREMENT BY 115 SQ. FT. PLANT POINTS REQUIRED = 626 x .05 = 35 POINTS

PLANT POINTS PROVIDED = 50 POINTS (I) 36" BOX TREES * 50 PTS = 50 POINTS

> 50 POINTS EXCEEDS REQUIREMENT BY 15 POINTS

VEHICULAR USE AREA IN THE STREET YARD

TOTAL AREA = 5.701 SQ. FT. PLANTING AREA REQUIRED = 5,701 x 5% =285 SQ. FT. PLANTING AREA PROVIDED = 1045 SQ. FT. EXCEEDS REQUIREMENT BY 760 SQ. FT.

PLANT POINTS REQUIRED = 5,701 X 0.05 = 285 POINTS PLANT POINTS PROVIDED = 344 POINTS (4) 36" BOX TREES * 50 PTS = 200 POINTS

(I) 24" BOX TREES * 20 PTS = 20 POINTS (62) 5 GAL. SHRUBS * 2 PTS = 124 POINTS

EXCEEDS REQUIREMENT BY 59 POINTS

STREET TREE & PUBLIC R.O.W. REQUIREMENTS

STREET NAME

STREET FRONTAGE LA JOLLA SCENIC DR NORTH = TREES REQUIRED = 382/30 = 12.73 STREET TREES TREES PROVIDED = (12) 24" BOX TREES

STREET FRONTAGE LA JOLLA SCENIC WAY = TREES REQUIRED = 214/30 = 7.13 STREET TREES TREES PROVIDED = (7) 24" BOX TREES

STREET FRONTAGE LA JOLLA VILLAGE DR = TREES REQUIRED = 310 / 30 = 12.33 STREET TREES TREES PROVIDED = (12) 24" BOX TREES

STREET FRONTAGE TORREY PINES ROAD = TREES REQUIRED = 50 / 30 = 1.67 STREET TREES TREES PROVIDED = (1) 24" BOX TREES

SPECIES OF TREE THAT IS UNIQUE TO LA JOLLA.

TREES SHALL BE WATERED DEEPLY, BUT INFREQUENTLY, TO PROMOTE DEEPER ROOTING, AND SHALL BE FERTILIZED AS REQUIRED BY SOUND HORTICULTURAL PRACTICES. PLANTS SHALL BE PRUNED IN ACCORDANCE WITH PROFESSIONAL TRIMMING STANDARDS TO MAINTAIN THEIR INTENDED SHAPES AND SIZES, AND TO INSURE THE HEALTH OF THE SPECIMEN

TREE GUYS AND STAKE TIES SHALL BE INSPECTED AND ADJUSTED PERIODICALLY, AND REMOVED WHEN NECESSARY, TO INSURE THAT THEY ARE ADEQUATELY SURROUNDING THE TREE WITHOUT GIRDLING TRUNKS OR BRANCHES.

PLANTS SHALL BE PRUNED TO AVOID BLOCKING WALLS, PASSAGEWAYS AND SIGHT DISTANCE VIEWS FOR VEHICULAR TRAFFIC.

DEAD PLANTS SHALL BE REPLACED, DAMAGED BRANCHES SHALL BE REMOVED, AND OVERGROWN AREAS SHALL BE THINNED BY THE SELECTIVE REMOVAL OF UNNECESSARY

SHRUBS AND VINES USED FOR SCREENING TRASH ENCLOSURES AND SERVICE AREAS SHALL

REQUIREMENT OR FOR SCREENING ADJACENT PROPERTIES SHALL BE KEPT PRUNED SO THEY

DO NOT INTERFERE WITH PEDESTRIAN TRAFFIC AND DO NOT ENCROACH EXCESSIVELY ONTO

BE PRUNED TO MAXIMIZE SCREENING WHILE ALLOWING ACCESS TO THE STORAGE/SERVICE SHRUBS, TREES, AND VINES USED TO MEET THE "REMAINING YARD RESIDENTIAL BUFFERING"

THE ADJACENT PROPERTY.

GENERAL NOTES

MAINTENANCE CRITERIA

AND THE SAFETY OF THE PUBLIC.

ALL LANDSCAPE AND IRRIGATION SHALL CONFORM TO THE STANDARDS OF THE CITY-WIDE LANDSCAPE REGULATIONS, THE CITY OF SAN DIEGO LAND DEVELOPMENT MANUAL LANDSCAPE STANDARDS AND THE LA JOLLA SHORES PLANNED DISTRICT REGULATIONS AND ALL OTHER LANDSCAPE RELATED CITY AND REGIONAL STANDARDS AS OF THE APPROVED DATE OF THESE

2. AN IRRIGATION SYSTEM SHALL BE PROVIDED AS REQUIRED FOR PROPER IRRIGATION DEVELOPMENT AND MAINTENANCE OF THE VEGETATION. THE DESIGN OF THE STATEM SHALL PROVIDE ADEQUATE SUPPORT FOR THE VEGETATION SELECTED.

3. MAINTENANCE: ALL REQUIRED LANDSCAPE AREAS SHALL BE MAINTAINED FREE OF DEBRIS AND LITTER AND ALL PLANT MATERIAL SHALL BE MAINTAINED IN A HEALTHY GROWING CONDITION. DISEASED OR DEAD PLANT MATERIAL SHALL BE SATISFACTORILY TREATED OR REPLACED PER THE CONDITIONS OF THE PERMIT WITHIN 30 DAYS.

MINIMUM TREE SEPARATION DISTANCE

A. IMPROVEMENT/MINIMUM DISTANCE TO STREET TREE, TRAFFIC SIGNALS (STOP SIGNS) - 20 UNDERGROUND UTILITY LINES - 5 FEET

ABOVE GROUND UTILITY STRUCTURES - 10 FEET DRIVEWAY (ENTRIES) - 10 FEET INTERSECTIONS (INTERSECTION CURB LINES OF TWO STREETS) - 25 FEET

B. LANDSCAPE AREAS FOR TREES: THE OPENINGS FOR TREES PLANTED IN PAVED AREAS SHALL BE A MINIMUM 40 SQUARE FEET IN AREA AND WATER PERMEABLE. UNCONSOLIDATED MULCH MATERIALS MUST BE COVERED BY TREE GRATES OR UNATTACHED PAVERS.

IRRIGATION NOTES

THIS PROJECT IS INTENDED TO AS A XERIPHYTIC LANDSCAPE HOWEVER, TO COMPLY WITH CITY REGULATIONS, ALL PLANTING AREAS SHALL BE IRRIGATED WITH A PERMANENT AUTOMATIC IRRIGATION SYSTEM, USING DRIP IRRIGATION OR LOW PRECIPITATION & PRECIPITATION MATCHED SPRINKLE HEADS. ALL SPRINKLER HEADS IN THE RIGHT-OF-WAY OR WITHIN TWO FEET OF THE SIDEMALK SHALL HAVE EXCESS FLOW VALVES IN THEM AND BE ON VALVES CONTROLLED FROM EACH ADJACENT LOT.


MAINTENANCE NOTES

LANDSCAPE MAINTENANCE SHALL BE PERFORMED ON ALL IMPROVED AREAS OF THE SITE, PER THE CRITERIA OF THE CITY OF SAN DIEGO LANDSCAPE STANDARDS, AS WELL AS THE REQUIREMENTS OF THE MAINTENANCE MANUAL AND SPECIFICATIONS OF DAVID REED, LANDSCAPE ARCHITECTS. THE APPLICANT, HILLEL OF UCSD - LA JOLLA, SHALL BE RESPONSIBLE FOR LONG TERM MAINTENANCE. CONTACT: LISA GOLDSTEIN, (858) 550-2210



LANDSCAPE **ARCHITECTS**

> 2171 INDIA STREET SUITE A SAN DIEGO, CALIFORNIA 92101 (619) 239-3300 www.drasla.com

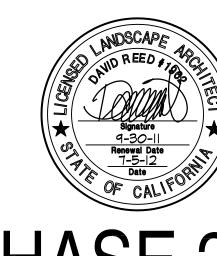

Hillel of San Diego

- Street Vacation
- Right of Way Dedication
- La Jolla Shores Site Development Permit for Sustainable Building Development with Deviations from Development Regulations
- Change of Occupancy Permit
 Sustainable Expedite Program

M.W. STEELE

GROUP, INC.

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SAN DIEGO | CA | 92113

TELEPHONE 619 230 0325

FACSIMILE 619 230 0335

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ARCHITECTURE | PLANNING

of San Diego

8976 Cliffridge Avenue

La Jolla, California 92037

La Jolla Village Drive

and La Jolla Scenic Drive

La Jolla, California 92037

Phase 1:

Phase 2:

San Diego, California

Intersection of La Jolla Scenic Way,

Street Vacation Right of Way Dedication La Jolla Shores Site Development Permit for Sustainable Building Development with **Deviations from Development Regulations** Change of Occupancy Permit Sustainable Expedite Program

June 8, 2010

NOT FOR CONSTRUCTION


LANDSCAPE CONCEPT


PLAN

See Drawing

Sheet No. 11 Of 19

FOR PLANT PALETTE, SEE SHEET L-3

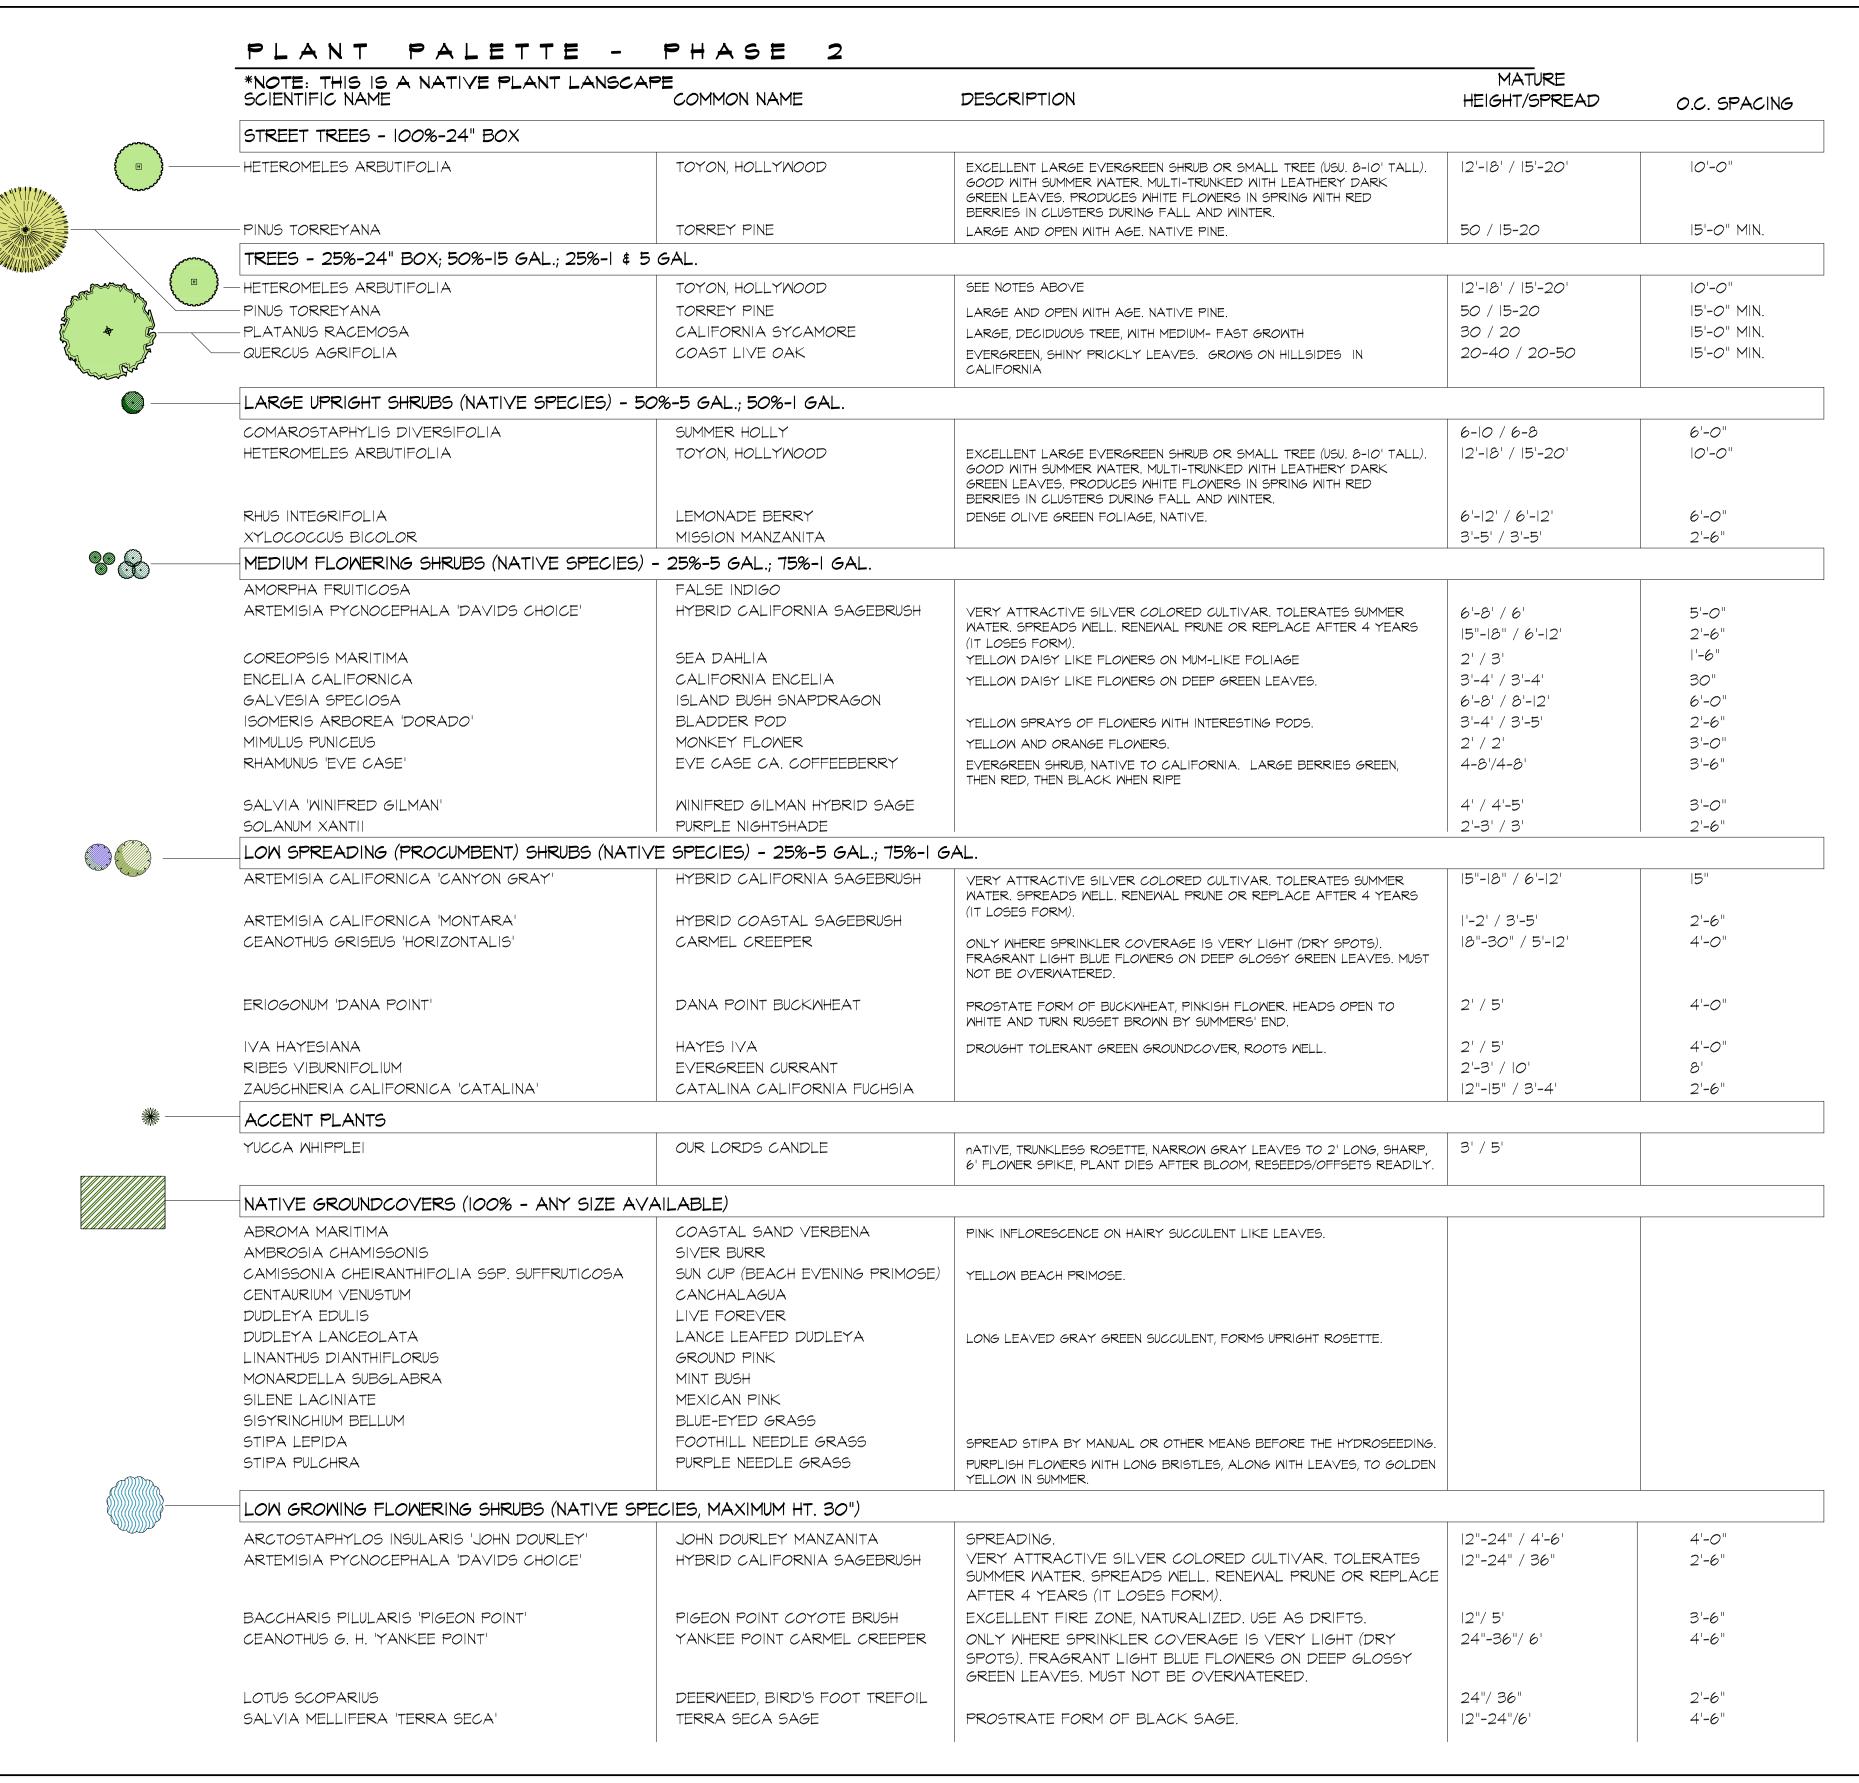

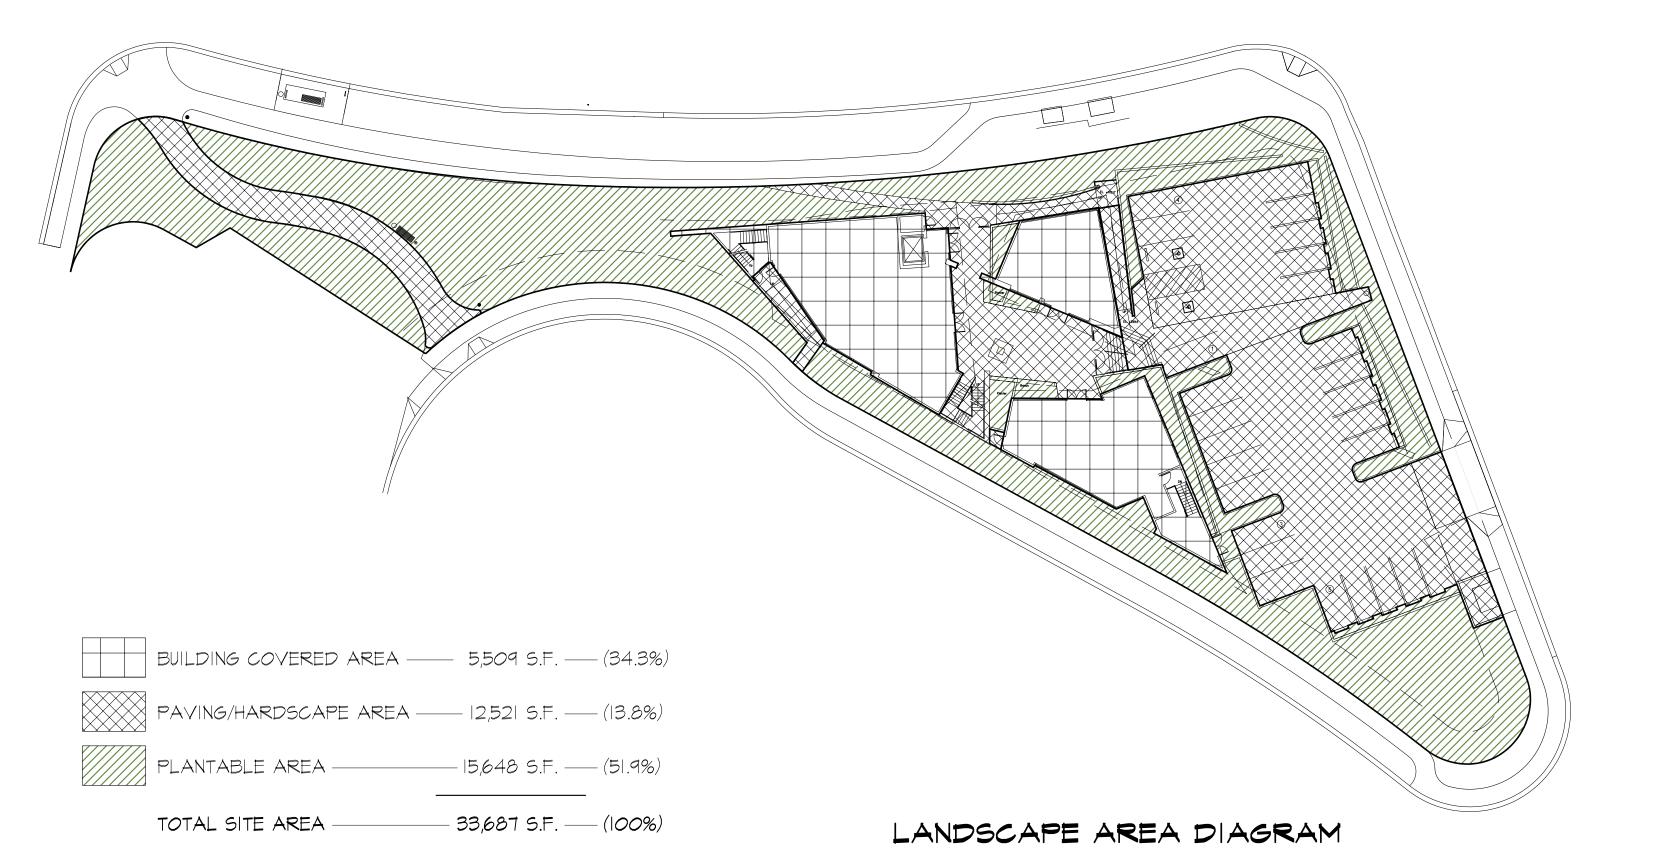

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Street Vacation Right of Way Dedication M.W. STEELE La Jolla Shores Site Development Permit for Sustainable Building Development with GROUP, INC. Deviations from Development Regulations 1805 NEWTON AVENUE | SUITE A Change of Occupancy Permit SAN DIEGO | CA | 92113 Sustainable Expedite Program TELEPHONE 619 230 0325 0915 FACSIMILE 619 230 0335 June 3, 2010

	*
Drawn:	AS/AP
Checked:	-
Revision 1:	06.03.10 MIR Submittal
Revision 2:	
Revision 3:	
Revision 4:	
Revision 5:	
Pevision 6.	

of San Diego San Diego, California

Phase 1: 8976 Cliffridge Avenue La Jolla, California 92037

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SCALE |"=30'-0'

Phase 2: Intersection of La Jolla Scenic Way, La Jolla Village Drive and La Jolla Scenic Drive La Jolla, California 92037

NOT FOR CONSTRUCTION LANDSCAPE CONCEPT PLAN

Sheet No. 12 Of 19

DAVID REED LANDSCAPE **ARCHITECTS** 2171 INDIA STREET SUITE A SAN DIEGO, CALIFORNIA 92101 (619) 239-3300 www.drasla.com



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Phase 1: Temp. Parking Notes

- 1) Existing stop sign to be removed. Existing concrete masonry wall.
- 3 Existing tree to remain.

- 6 Existing walkway. 7 Existing fence.


- 10 New concrete driveway.
- 13 Existing pedestrian curb ramp to remain.

- 16 Temporary bike and pedestrian path during construction of Phase 2.
- Visibility Area Trianles per SDMC Sec. 113.0273, diagram 113-02RR for street intersections and driveways. See General Note 3.

General Notes

1. The temporary parking plan for Phase 1, provides parking for the existing temporary office use of the single family residence at 8976 Cliffridge Ave., La Jolla, CA 92037, during the construction of Phase 2 on site 653. This provides 6 parking spaces through a combination of utilizing the existing garage and providing new spaces in the vacated cul—de—sac. It also involves the construction of a temporary sidewalk connecting La Jolla Village Dr. to La Jolla Scenic Drive North.

No objects higher than 36 inches may be proposed in the visibility areas. If any portion of the visibility areas lies within the public right of way, no vegetation in these areas will exceed 24 inches in height.

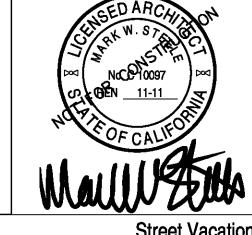

La Jolla Shores Site Development Permit for

Deviations from Development Regulations

Sustainable Building Development with

Right of Way Dedication

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Sustainable Expedite Program

June 8, 2010

06.08.10 Completeness Check 06.24.10 MIR Submittal

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ARCHITECTURE | PLANNING

Hillel Center for Jewish Life

San Diego, California

8976 Cliffridge Avenue La Jolla, California 92037

Intersection of La Jolla Scenic Way,


La Jolla Village Drive and La Jolla Scenic Drive La Jolla, California 92037

Phase 1:

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Temporary Parking Plan (During Phase 2 Construction)

Sheet No. 13 or 19

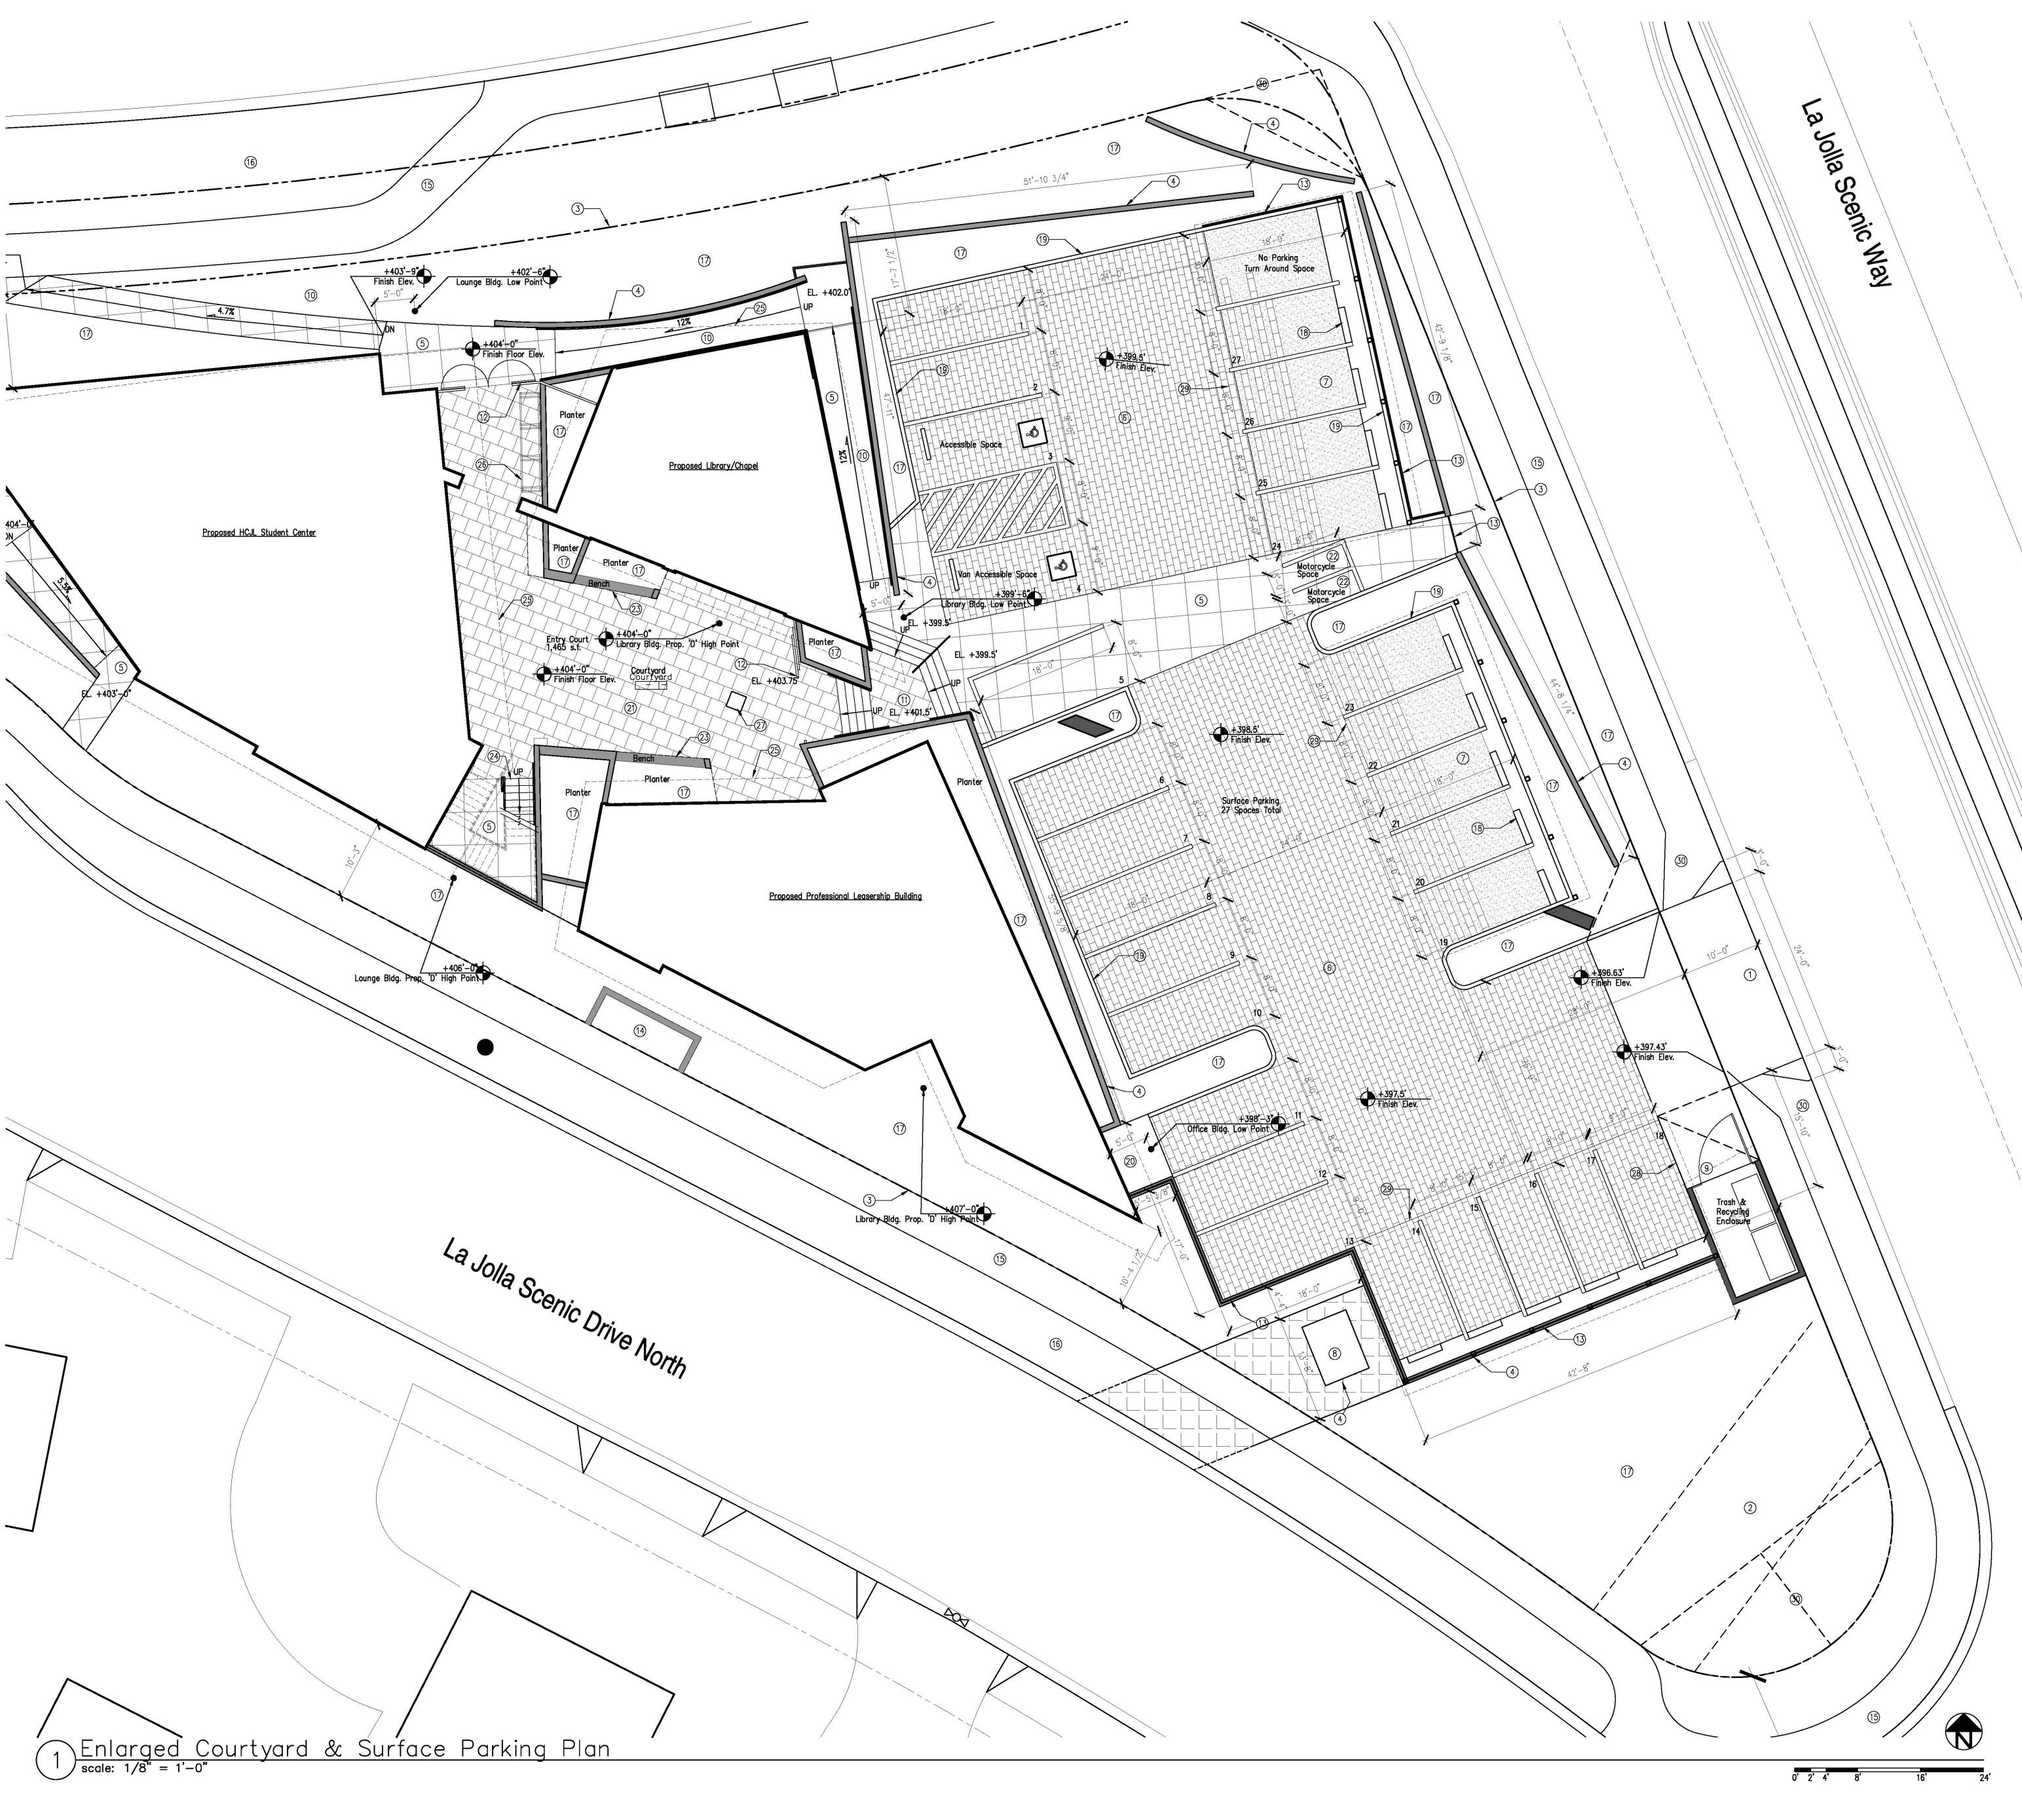

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- Street Vacation
- Right of Way Dedication
- La Jolla Shores Site Development Permit for Sustainable Building Development with Deviations from Development Regulations
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 Sustainable Expedite Program

Courtyard & Parking Plan Notes

- 1) New 24'-0" driveway and curb cut.
- Easement reservation for storm drain, refer to Civil drawings for more information.
- $\stackrel{ ext{4}}{ ext{4}}$ New site wall. Refer to Civil drawings for top and bottom of wall elevations.

- 7 Decorative gravel paving. Refer to Landscape drawings for more information.
- 8 Proposed transformer location.
- 9 Trash and recycling enclosure.
- 10 Accessible pedestrian ramp to courtyard entry.
- 11) Stairs up to courtyard entry.


(12) Courtyard security gate.

- (13) Decorative guardrail.
- (14) Proposed backflow preventer location.

- 17) New landscaped planting area.
- (18) Concrete wheel stop, typical.
- 19 Concrete curb.
- ② Storage room access.
- 22 Motorcycle parking space.
- 23 Bench integrated with raised planter.
- 24 Stair up to second floor above student lounge.
- 25 Line of roof above.
- 26 Bicycle rack.
- 27 Tree location. Refer to Landscape drawings for more information.
- 28 Line of trellis above.
- 29 Line of carport structure above.
- 30 Visibility Area Trianles per SDMC Sec. 113.0273, diagram 113-02RR for street intersections and driveways. See General Note 5.

General Notes

- 1. Refer to Architectural sheet A0.00 for parking requirements and calculations. 2. Refer to Architectural sheet A0.00 for bicycle parking requirements and
- 3. Refer to Architecural sheet A2.03 for the building plans and notes.
- Refer to the Landscape drawings for more information regarding planting materials.
- No objects higher than 36 inches may be proposed in the visibility areas. If any portion of the visibility areas lies within the public right of way, no vegetation in these areas will exceed 24 inches in height.

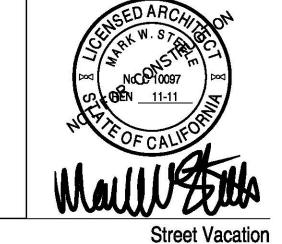

La Jolla Shores Site Development Permit for

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Phase 1:

8976 Cliffridge Avenue La Jolla, California 92037

Phase 2:


Intersection of La Jolla Scenic Way, La Jolla Village Drive and La Jolla Scenic Drive La Jolla, California 92037

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Phase 2: Enlarged Courtyard & Surface Parking Plan

Sheet No. 14 of 19

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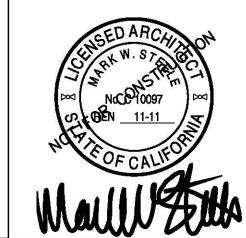
Building Plan Notes

2 Access hatch and ladder up to mechanical equipment on roof.

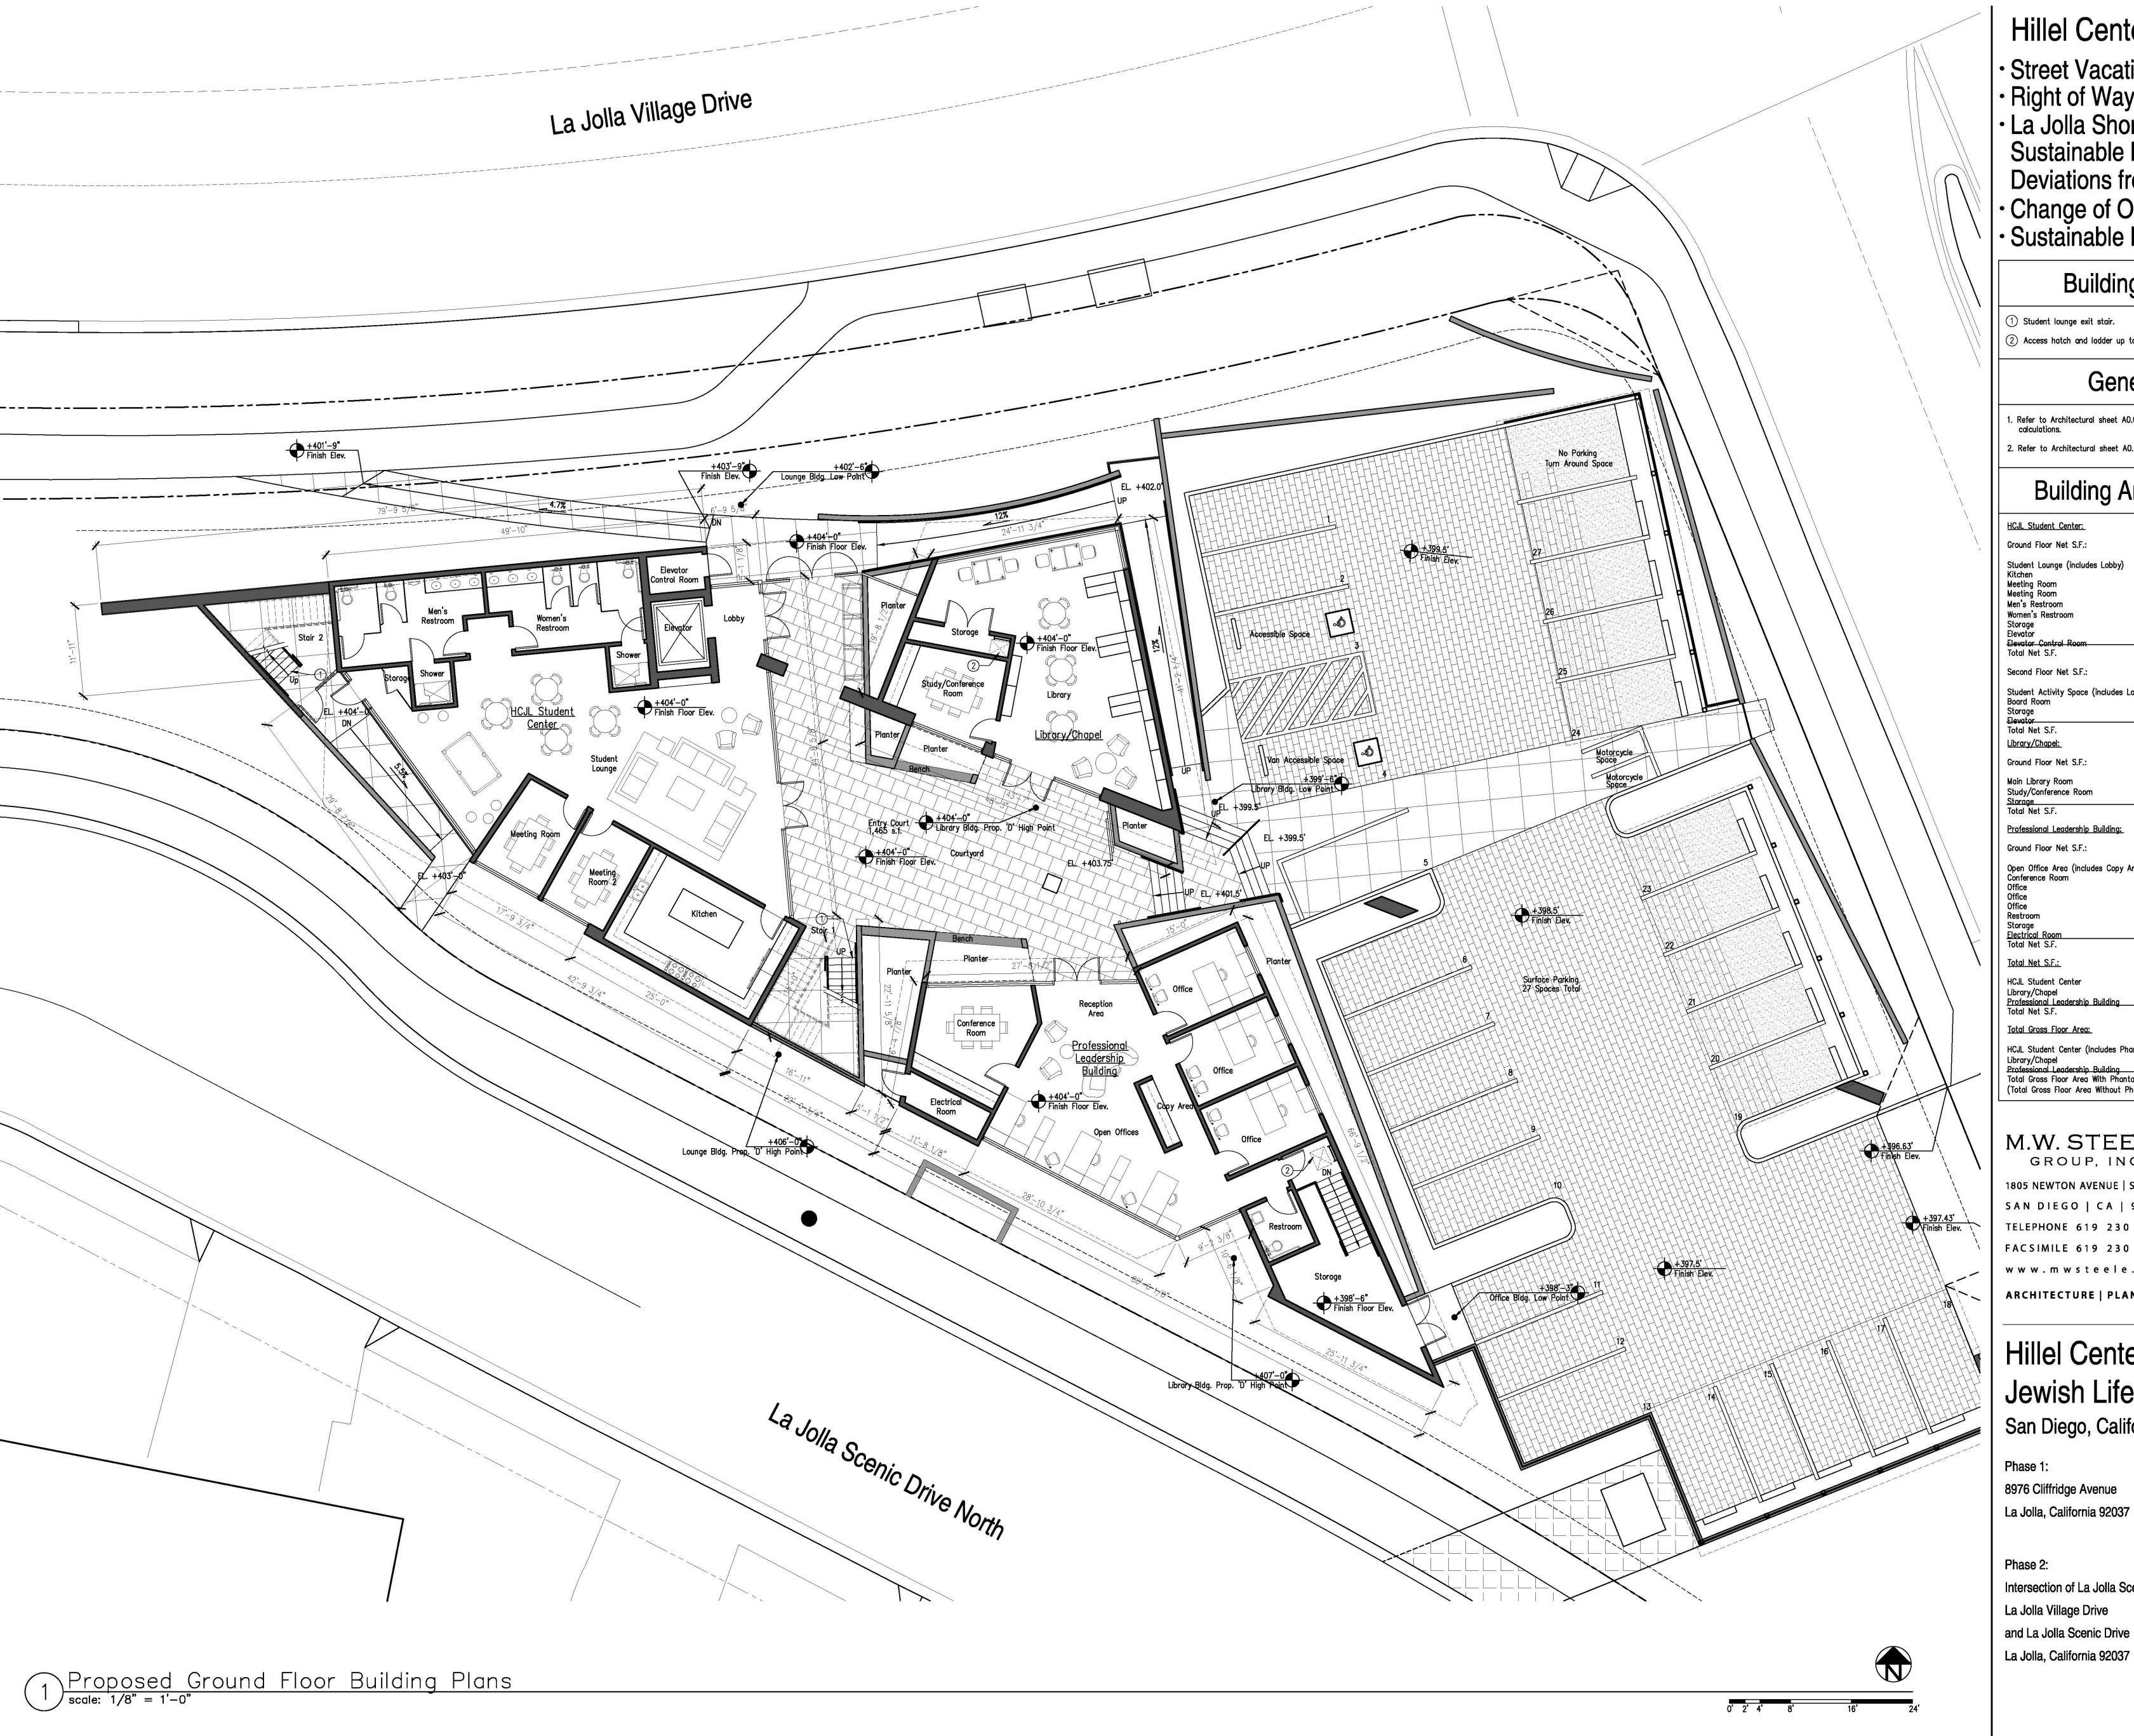General Notes

Building Area Tabulations

HCJL Student Center:	
Ground Floor Net S.F.:	
Student Lounge (includes Lobby)	1,213 S.F.
Kitchen	298 S.F.
Meeting Room	116 S.F.
Meeting Room	116 S.F. 193 S.F.
Men's Restroom	202 S.F.
Women's Restroom	13 S.F.
Storage	65 S.F.
Elevator Elevator Control Room	36 S.F.
Total Net S.F.	2,252 S.F.
Second Floor Net S.F.:	
Student Activity Space (includes Lobby)	674 S.F.
Board Room	233 S.F. 74 S.F.
Storage	74 S.F. 65 S.F.
Elevator	1,046 S.F.
Total Net S.F.	44 14 3111
<u>Library/Chapel:</u>	
Ground Floor Net S.F.:	
Main Library Room	676 S.F.
Study/Conference Room	148 S.F.
Storage	33 S.F. 857 S.F.
Total Net S.F.	007 0.1.
Professional Leadership Building:	
Ground Floor Net S.F.:	
Open Office Area (includes Copy Area)	667 S.F.
Conference Room	192 S.F.
Office	133 S.F.
Office	133 S.F. 133 S.F.
Office Pestroom	133 S.F. 49 S.F.
Restroom Storage	265 S.F.
Storage Electrical Room	45 S.F.
Total Net S.F.	1,617 S.F.
Total Net S.F.:	
HCJL Student Center	3,298 S.F.
Library/Chapel	857 S.F.
Professional Leadership Building	1,617 S.F. 5,772 S.F.
Total Net S.F.	J,//Z 3.F.
Total Gross Floor Area:	
HCJL Student Center (Includes Phantom Floor)	4,287 S.F.
Library/Chapel	984 S.F.
Professional Leadership Building	1,813 S.F.
Total Gross Floor Area With Phantom Floor	7,084 S.F.
(Total Gross Floor Area Without Phantom Floo	r 0,4/9 3.r.)



Right of Way Dedication

Change of Occupancy Permit

Sustainable Expedite Program

June 8, 2010

06.24.10 MIR Submittal 10.18.12 Revisions Cycle 50

La Jolla Shores Site Development Permit for

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San Diego, California

Phase 1:


8976 Cliffridge Avenue La Jolla, California 92037

Phase 2: Intersection of La Jolla Scenic Way, La Jolla Village Drive and La Jolla Scenic Drive

Phase 2: Proposed Ground Floor Building Plans

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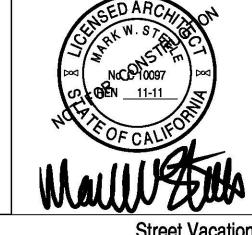
Building Plan Notes

2 Access hatch and ladder up to mechanical equipment on roof.

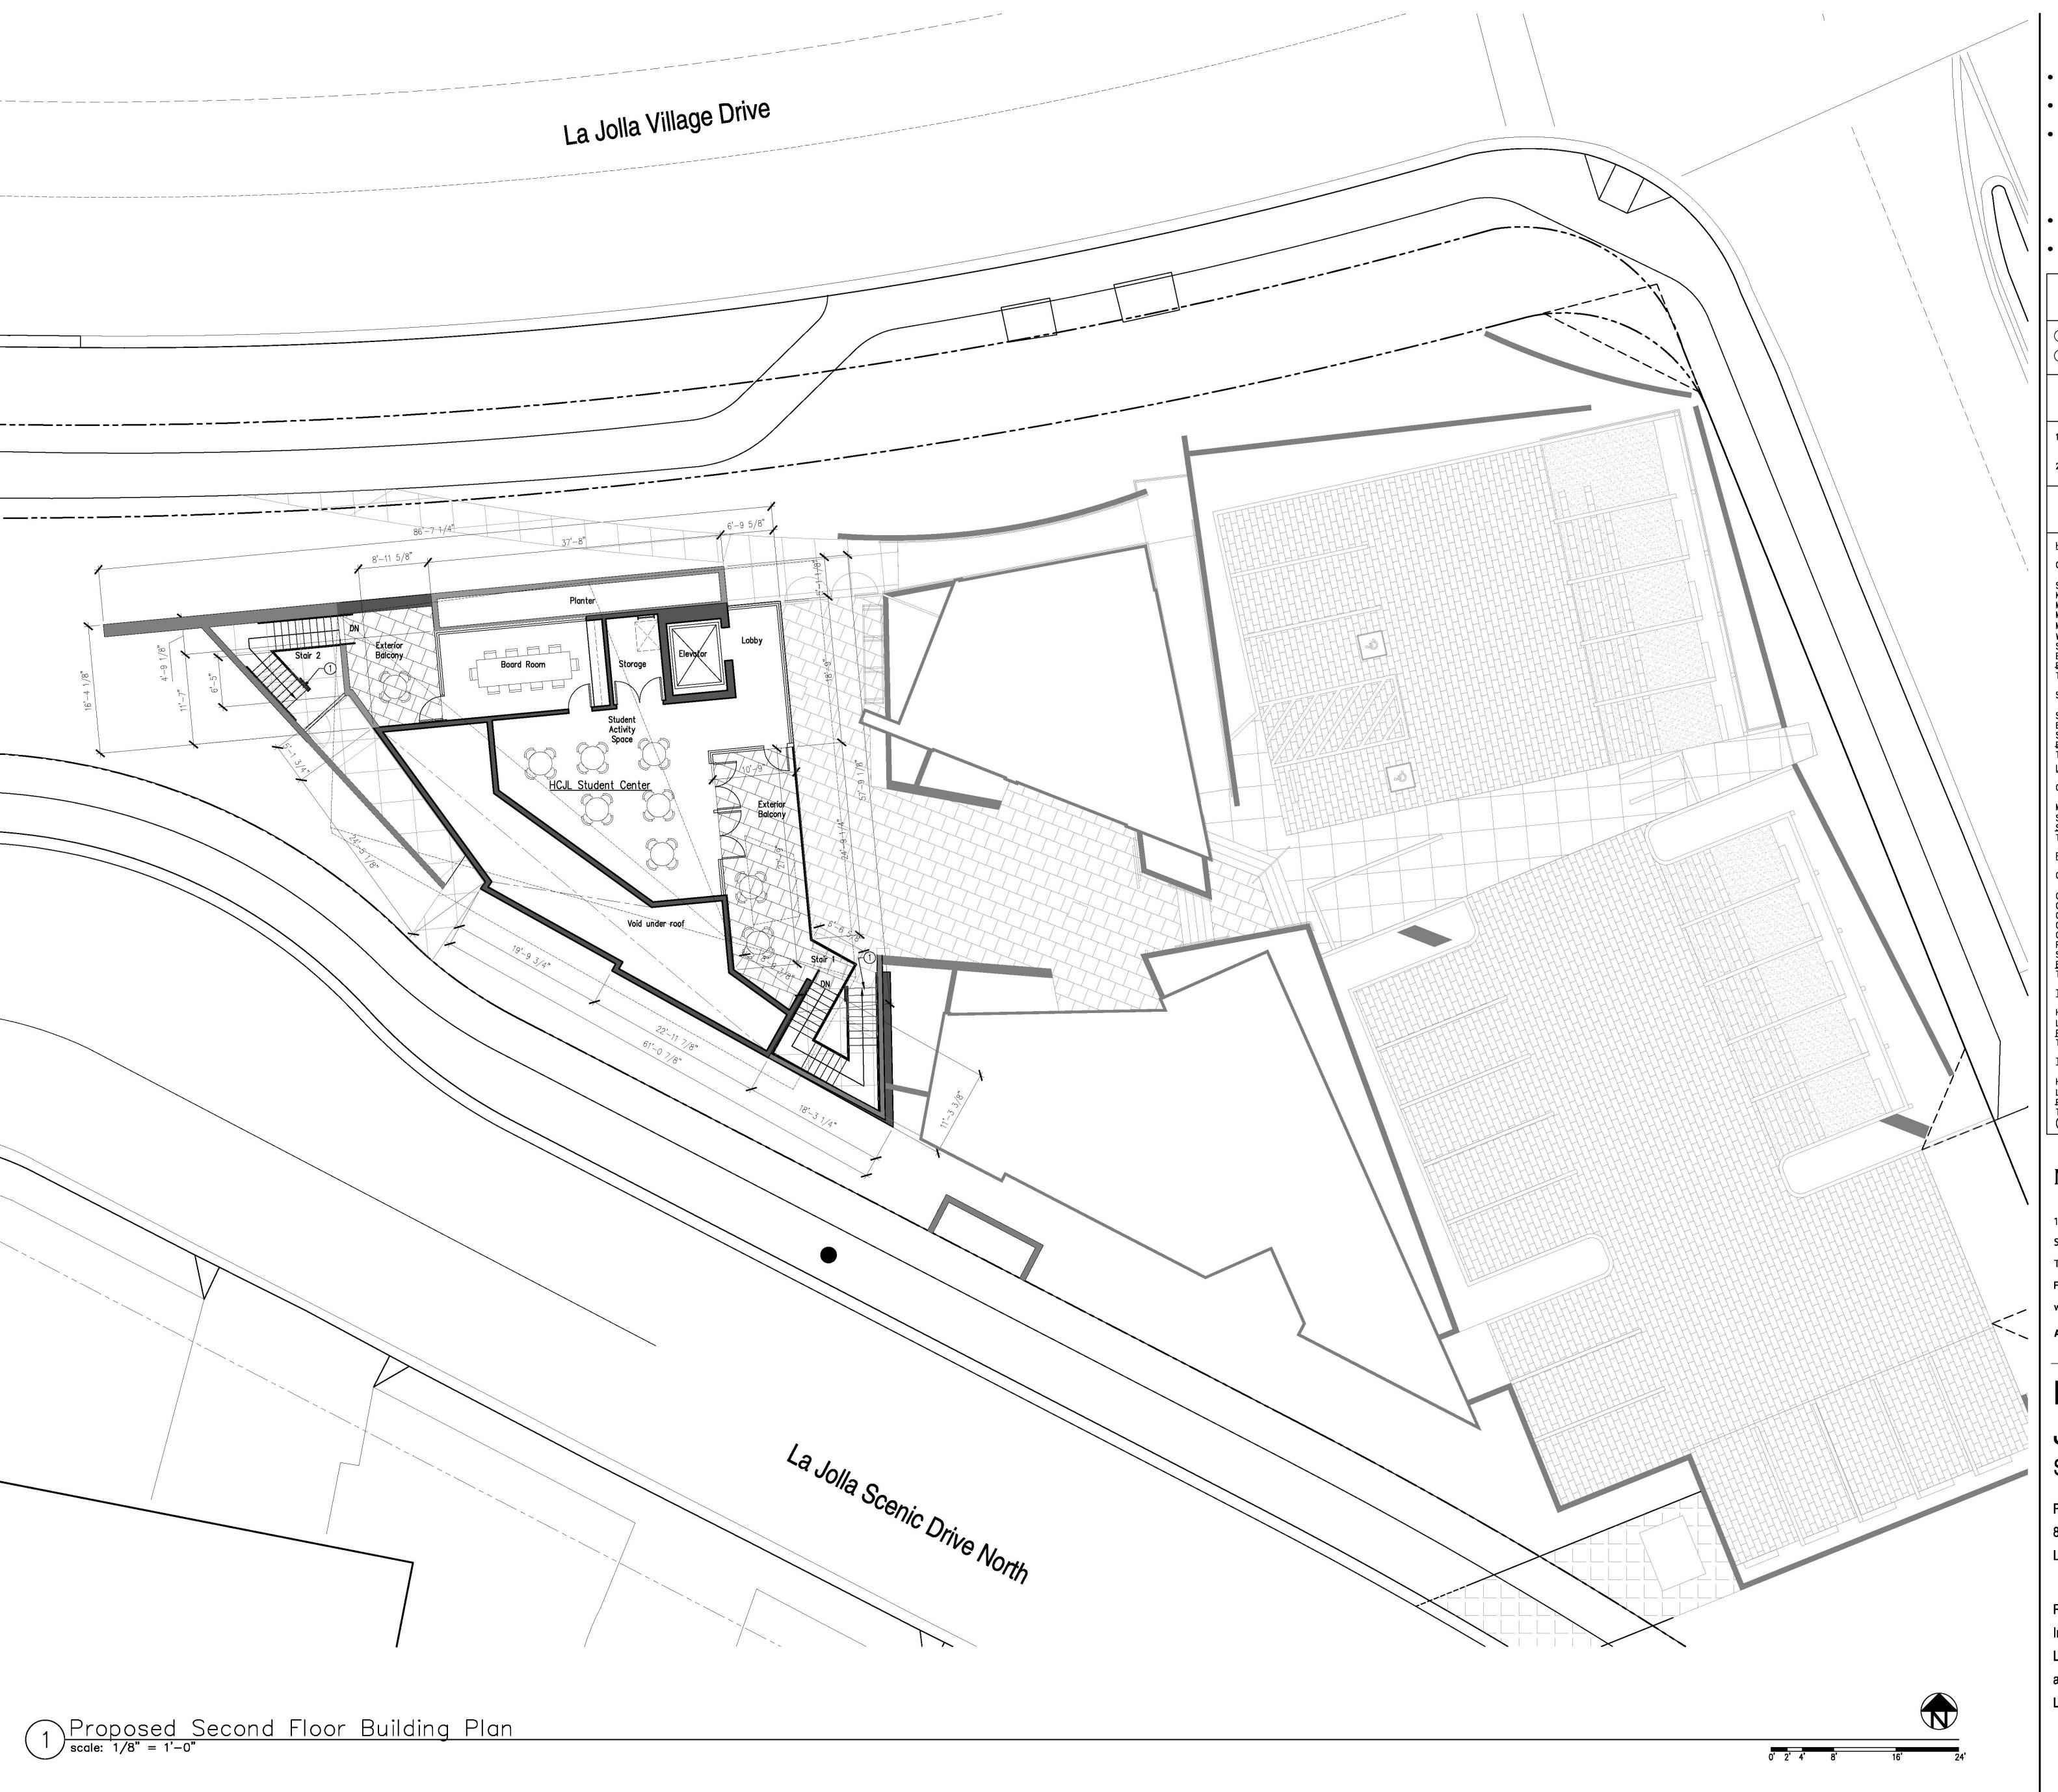General Notes

Building Area Tabulations

Ground Floor Net S.F.:	
Student Lounge (includes Lobby)	1,213 S.F.
Kitchen	298 S.F.
Meeting Room	116 S.F.
Meeting Room	116 S.F.
Men's Restroom	193 S.F.
Women's Restroom	202 S.F.
Storage	13 S.F.
Elevator	65 S.F.
Elevator Control Room	36 S.F.
Total Net S.F.	2,252 S.F.
Second Floor Net S.F.:	
Student Activity Space (includes Lobby)	674 S.F.
Board Room	233 S.F.
Storage	74 S.F.
Elevator	65 S.F. 1,046 S.F.
Total Net S.F.	IJUTU SIFI
<u>Library/Chapel:</u>	
Ground Floor Net S.F.:	
Main Library Room	676 S.F.
Study/Conference Room	148 S.F.
Storage	33 S.F.
Total Net S.F.	857 S.F.
Professional Leadership Building:	
Ground Floor Net S.F.:	
Open Office Area (includes Copy Area)	667 S.F.
Conference Room	192 S.F.
Office	133 S.F.
Office	133 S.F.
Office	133 S.F.
Restroom	49 S.F.
Storage	265 S.F.
Electrical Room	45 S.F.
Total Net S.F.	1,617 S.F.
Total Net S.F.:	
HCJL Student Center	3,298 S.F.
TOWNS TOWNS NAME OF THE PARTY O	857 S.F.
Library/Chapel	1,617 S.F.
Professional Leadership Building	C 330 0 C
Library/Chapel Professional Leadership Building Total Net S.F.	5,772 S.F.
Professional Leadership Building Total Net S.F.	5,772 S.F.
Professional Leadership Building	4,287 S.F.
Professional Leadership Building Total Net S.F. <u>Total Gross Floor Area:</u> HCJL Student Center (Includes Phantom Floor)	4,287 S.F. 984 S.F.
Professional Leadership Building Total Net S.F. Total Gross Floor Area: HCJL Student Center (Includes Phantom Floor) Library/Chapel Professional Leadership Building	984 S.F. 1,813 S.F.
Professional Leadership Building Total Net S.F. Total Gross Floor Area:	4,287 S.F. 984 S.F. 1,813 S.F. 7,084 S.F.



Right of Way Dedication
La Jolla Shores Site Development Permit for

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ARCHITECTURE | PLANNING

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San Diego, California

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8976 Cliffridge Avenue La Jolla, California 92037


Phase 2:

Intersection of La Jolla Scenic Way, La Jolla Village Drive and La Jolla Scenic Drive La Jolla, California 92037

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Phase 2: Proposed Second Floor Building Plan

Sheet No. 16 Of **19**

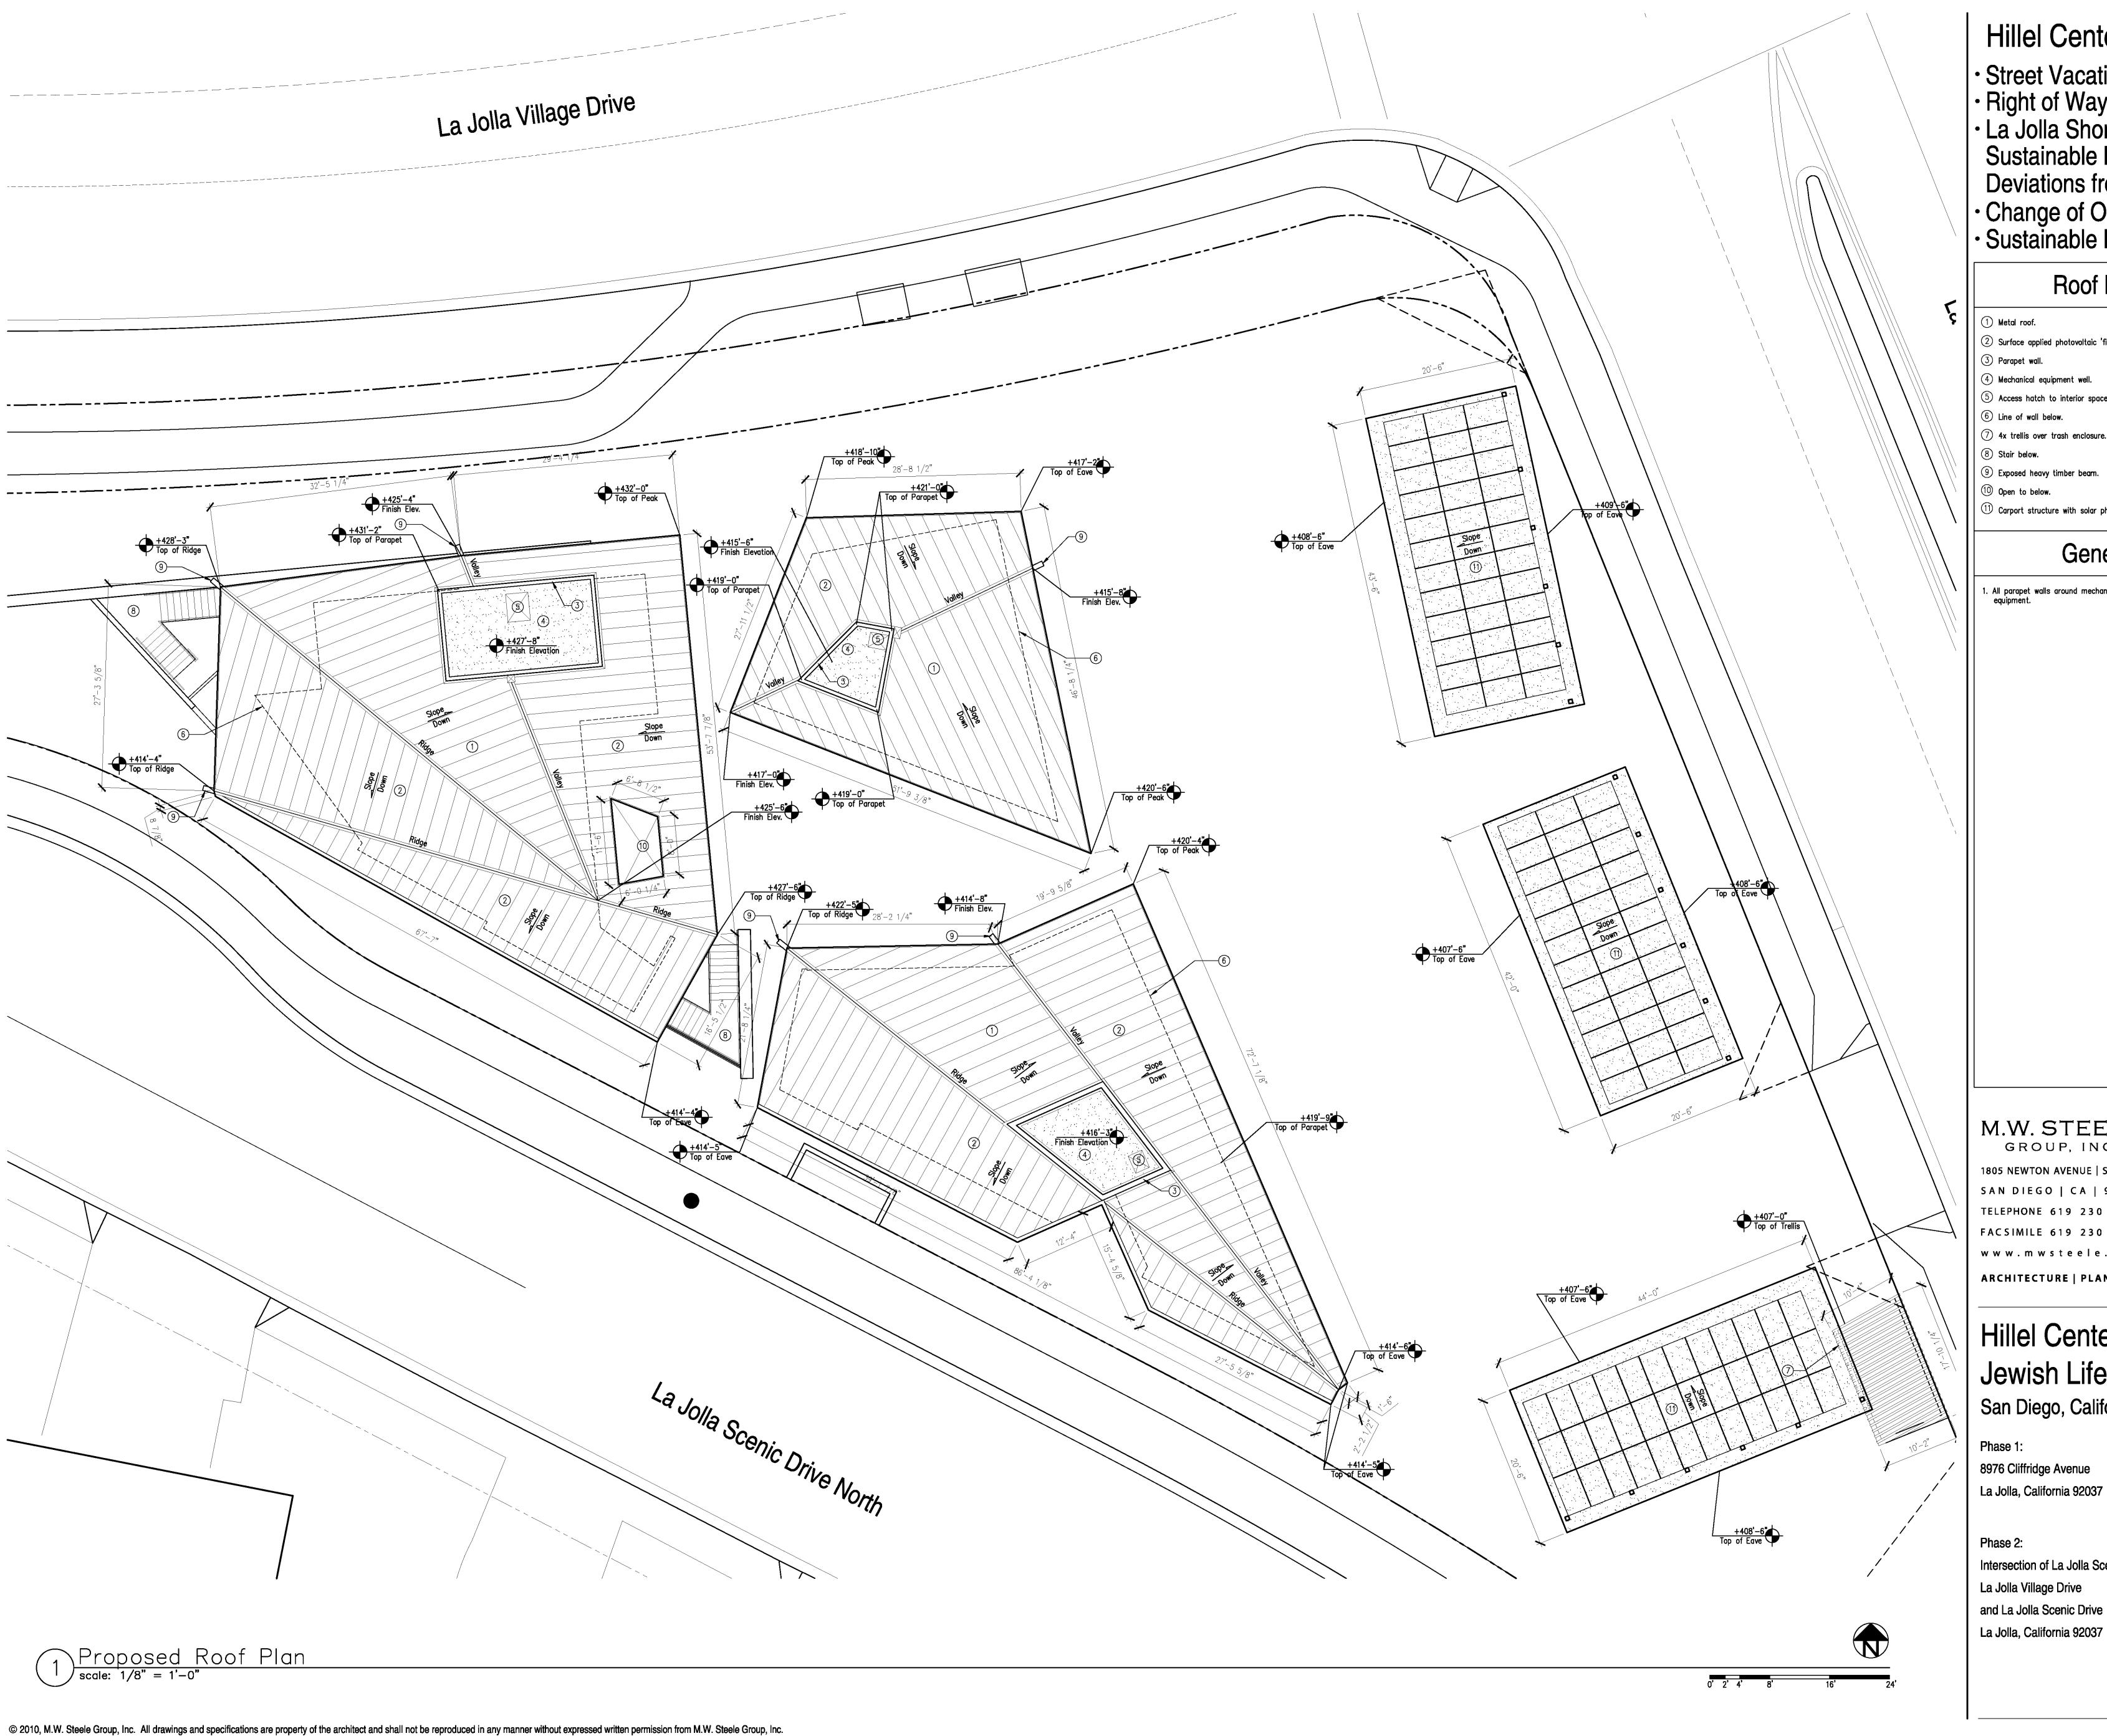

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 La Jolla Shores Site Development Permit for Sustainable Building Development with Deviations from Development Regulations
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Roof Plan Notes


- 2 Surface applied photovoltaic 'film'.

- 6 Line of wall below.

- $\stackrel{ ext{(1)}}{ ext{(1)}}$ Carport structure with solar photovoltaic panels on top

General Notes

All parapet walls around mechanical wells to provide screening for mechical equipment.

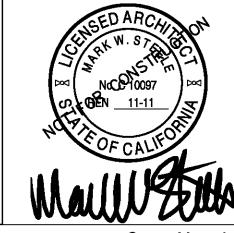

La Jolla Shores Site Development Permit for

Sustainable Building Development with Deviations from Development Regulations

Right of Way Dedication

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06.24.10 MIR Submittal 10.18.12 Revisions Cycle 50

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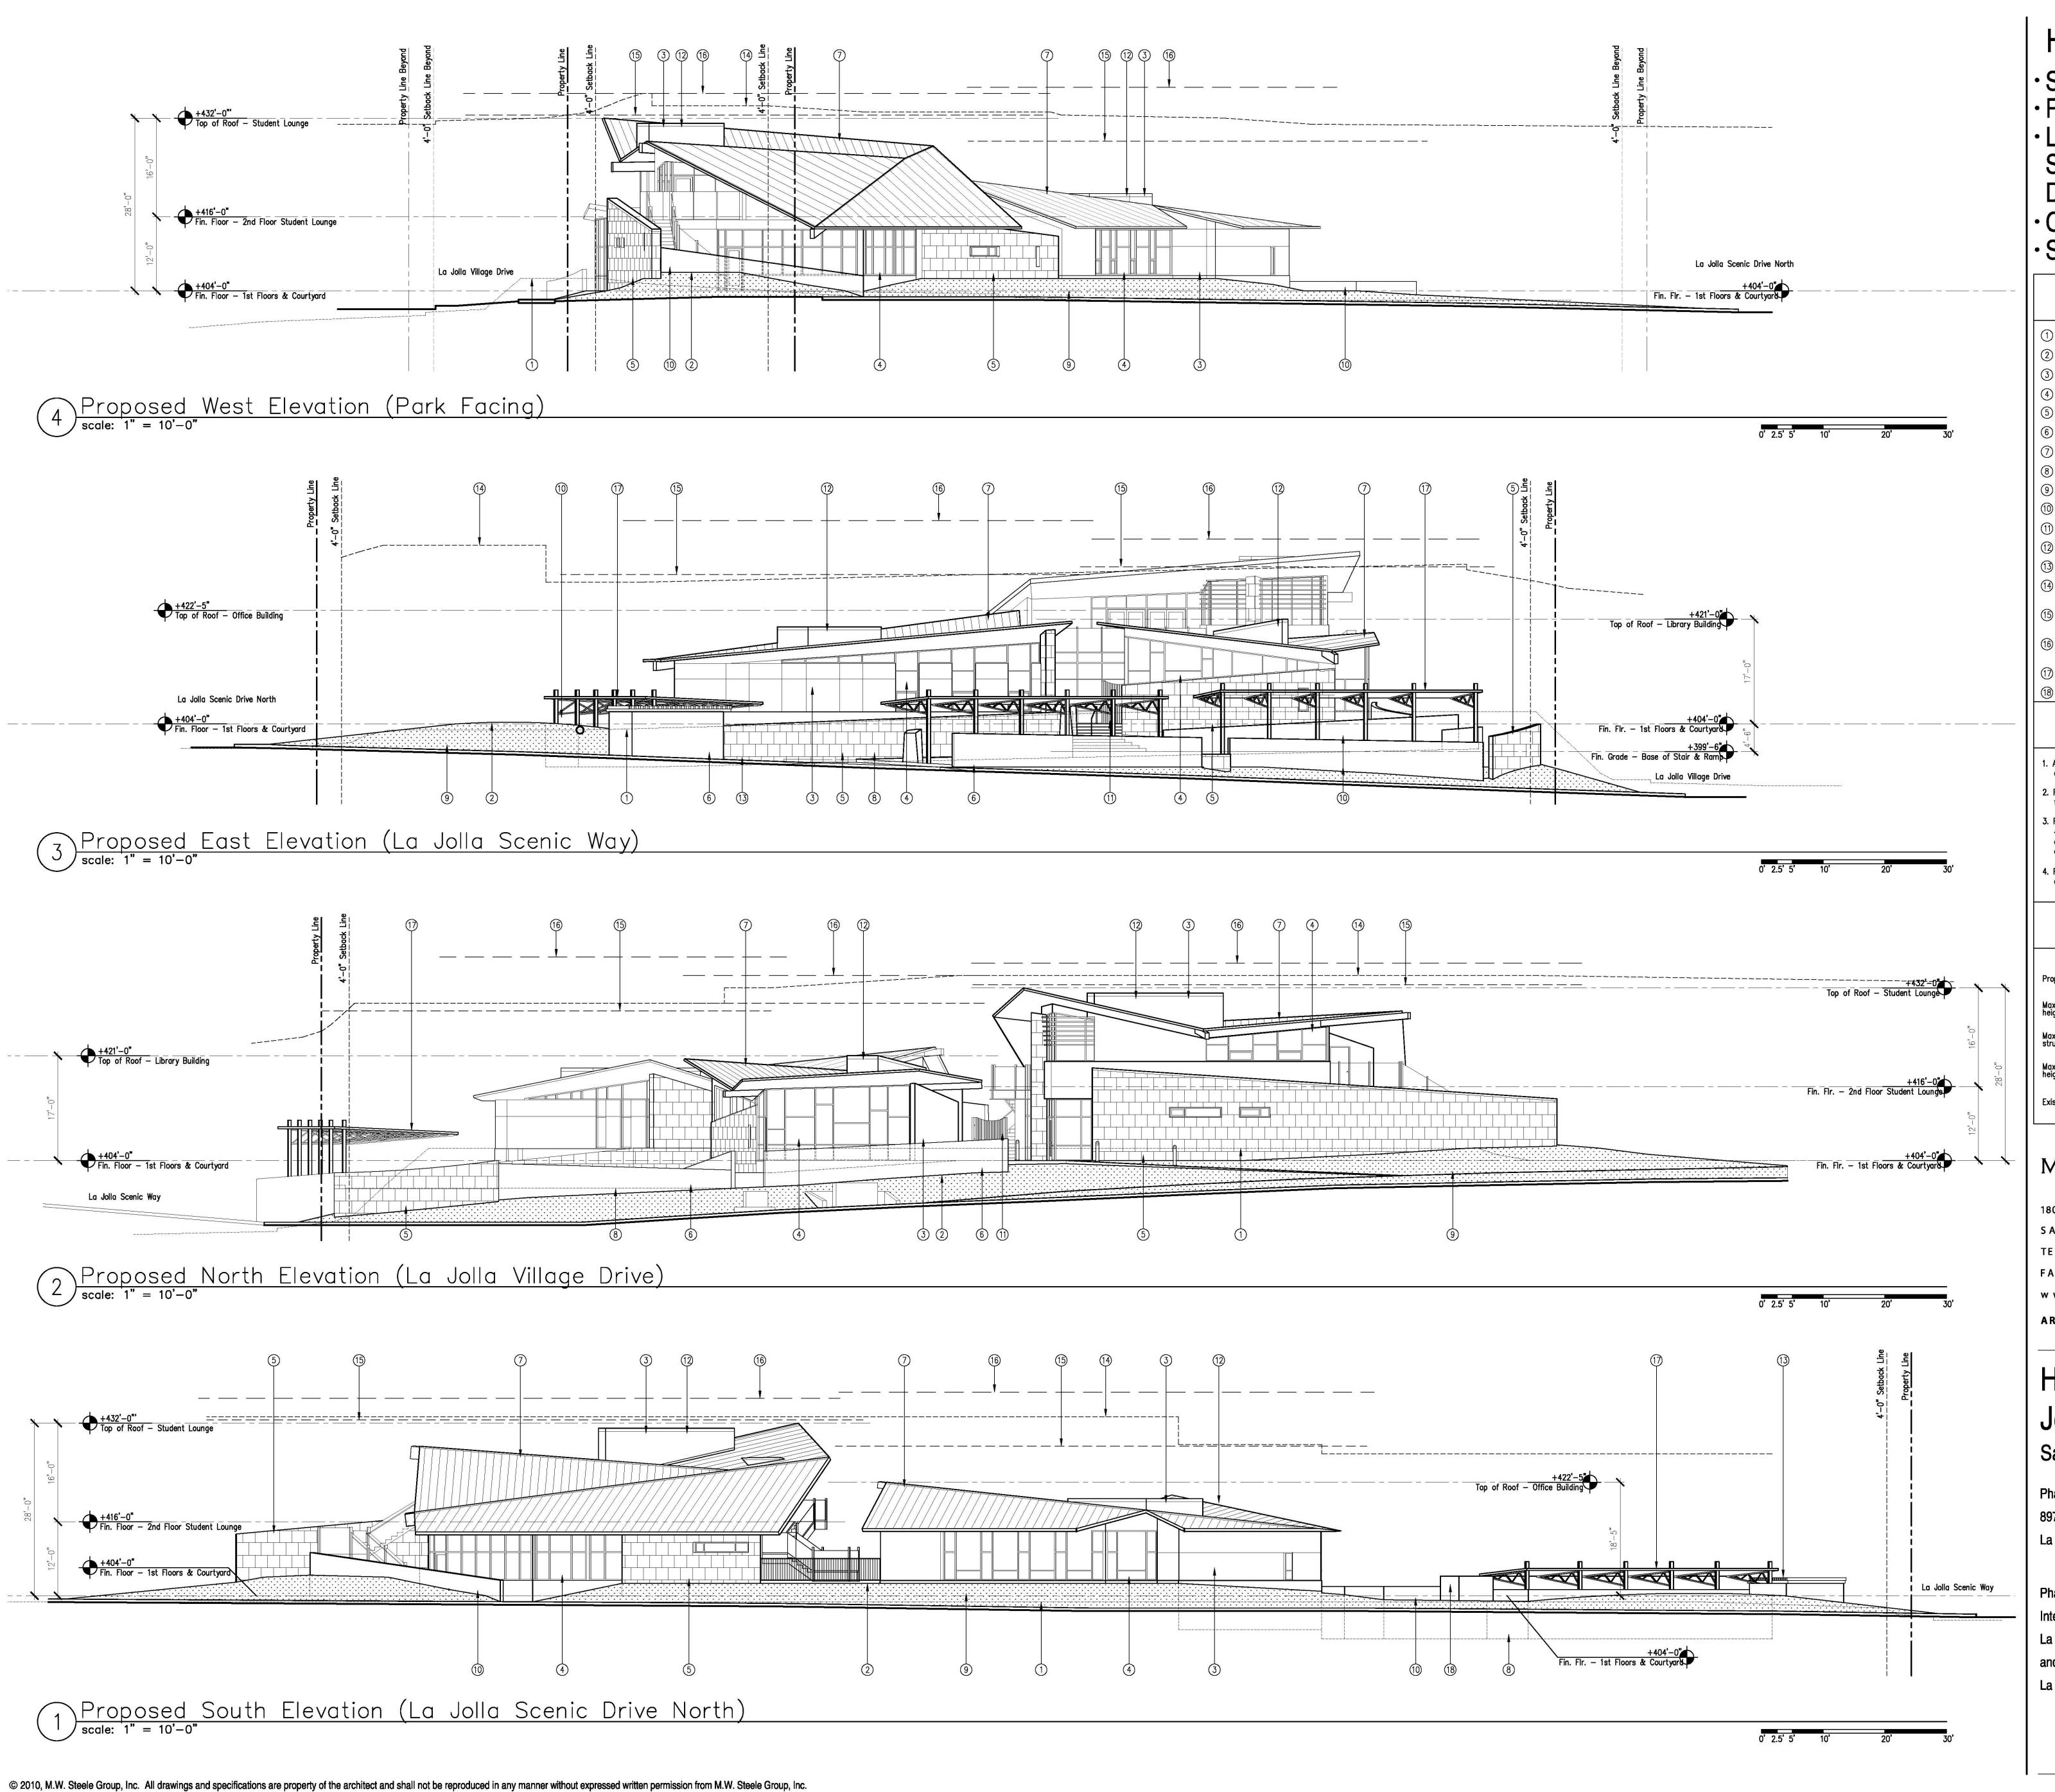
Phase 2:

Intersection of La Jolla Scenic Way, La Jolla Village Drive and La Jolla Scenic Drive La Jolla, California 92037

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Phase 2: Proposed Roof Plan


Sheet No. 17 or 19




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	Elevation Notes
1	Existing grade.
2	Proposed grade.
3	Stucco — earth tone colors.
4	Glazing.
(5)	Stone veneer facing.
6	Concrete block — earth tone colors.
7	Copper roofing.
8	Surface parking lot.
910	Landscaping — refer to Landscape Drawings for all paving and planting materials.
~	Concrete block retaining wall — earth tone colors.
(1)	Courtyard entry gate.
(12)	Parapet wall of mechanical well.
(13)	Trash enclosure.
(14) (15)	Maximum permitted structure height limit line: $30'-0"$ line from existing or finish grade, whichever is lower.
(16)	Maximum permitted overall structure height limit line: $30^\circ-0^\circ$ line from the low point within $5^\circ-0^\circ$ of building perimeter.
17)	Coastal height limit line: $30^\circ-0^{\circ\circ}$ line from the high point within $5^\prime-0^{\circ\circ}$ of building perimeter.
18	Carport with solar photovoltaic panels on top.
	Proposed transformer location.
	General Notes
2. F	all parapet walls around mechanical wells to provide screening for mechanical equipment. Refer to roof plan for roof spot elevations and surface applied photovoltaic film locations.



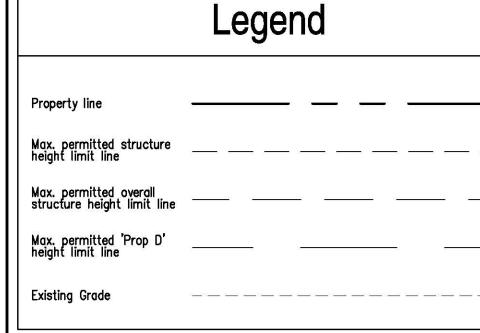

Right of Way Dedication

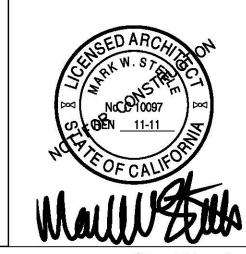Change of Occupancy Permit

Sustainable Expedite Program

June 8, 2010

La Jolla Shores Site Development Permit for

Deviations from Development Regulations

Sustainable Building Development with

M.W. STEELE GROUP, INC.

1805 NEWTON AVENUE | SUITE A SAN DIEGO | CA | 92113 TELEPHONE 619 230 0325 FACSIMILE 619 230 0335 www.mwsteele.com

ARCHITECTURE | PLANNING

Hillel Center for Jewish Life

San Diego, California

Phase 1:


8976 Cliffridge Avenue La Jolla, California 92037


Phase 2: Intersection of La Jolla Scenic Way, La Jolla Village Drive and La Jolla Scenic Drive La Jolla, California 92037

NOT FOR CONSTRUCTION

Phase 2: **Proposed Elevations**

Sheet No. 18 or 19

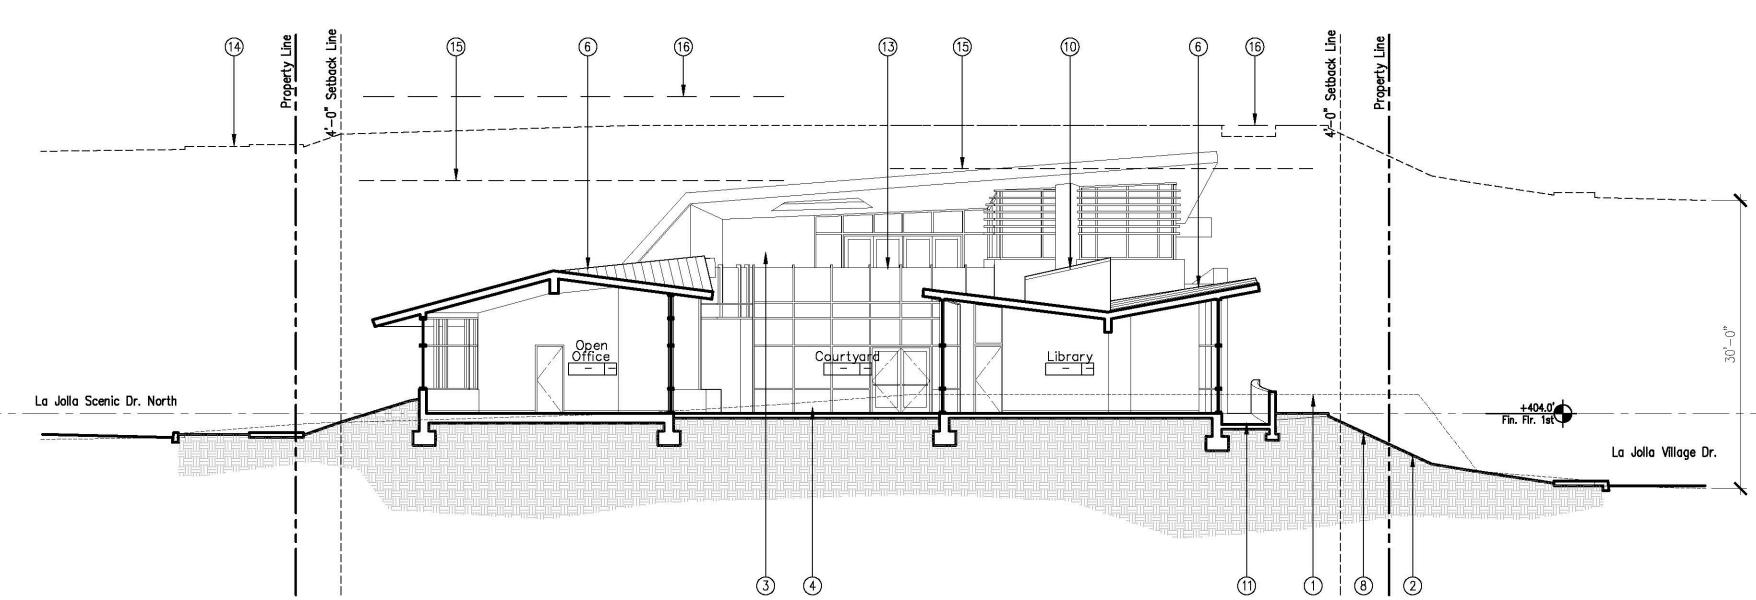

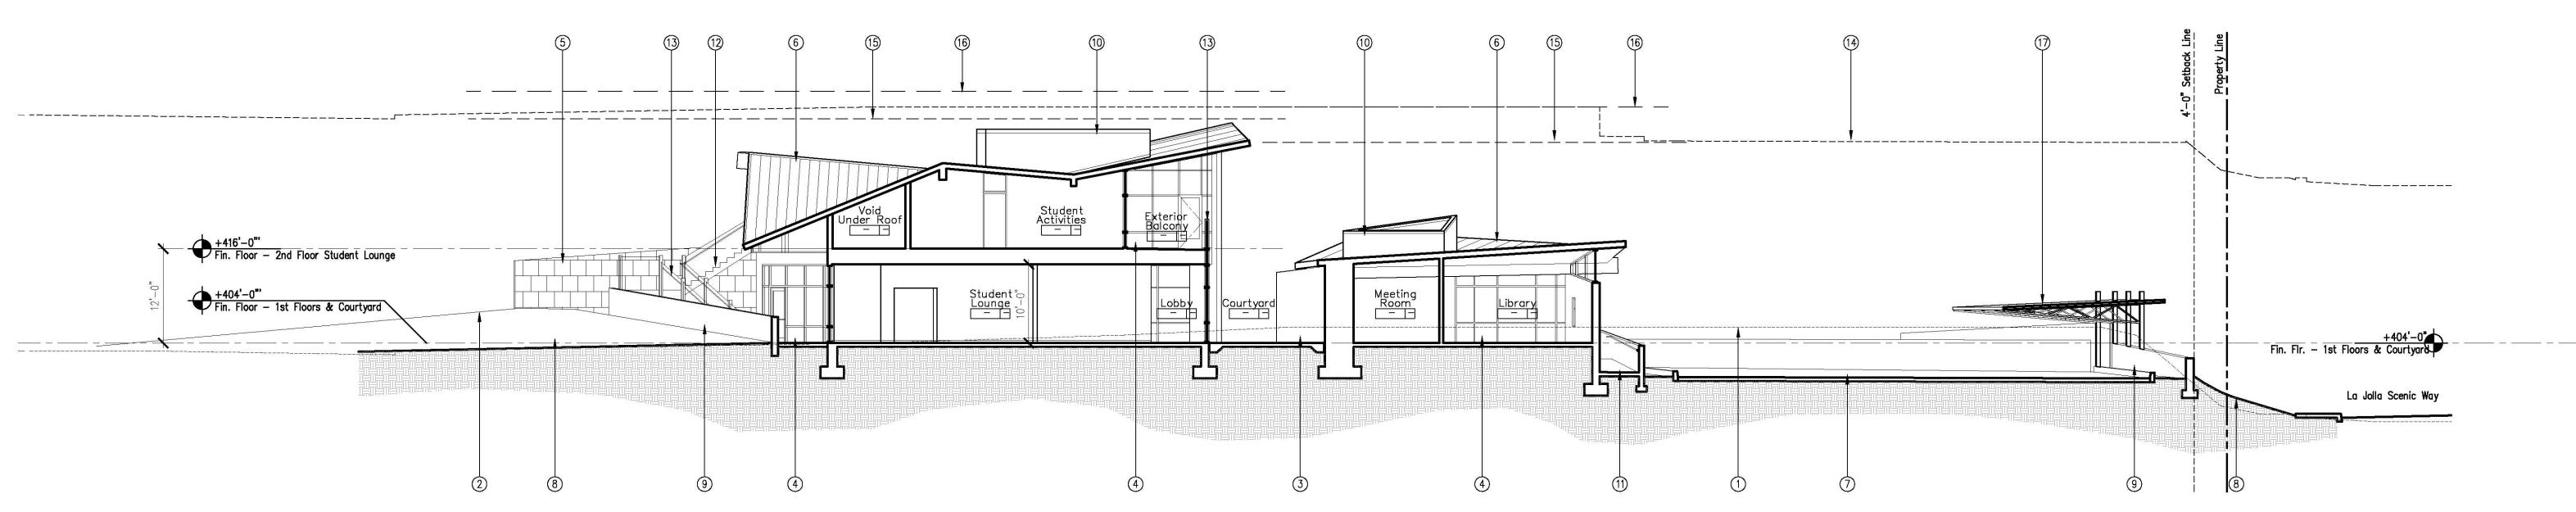

Site/Building Section
scale: 1" = 10'-0"

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Hillel Center for Jewish Life

- Street Vacation
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	Section Notes
1	Existing grade.
2	Proposed grade.
3	Stucco — earth tone colors.
4	Glazing.
(5)	Stone veneer facing.
6	Metal roofing.
7	Surface parking lot.
(8)(9)	Landscaping — refer to Landscape Drawings for all paving and planting materials.
ان (10)	Concrete block retaining wall — earth tone colors.
_	Parapet wall of mechanical well.
(1) (3)	Accessible pedestrian ramp.
(12) (13)	Stair.
(13) (14)	Railing system.
(1 5)	Maximum permitted structure height limit line: 30'-0" line from existing or finish grade, whichever is lower.
(16) (16)	Maximum permitted overall structure height limit line: $30'-0''$ line from the low point within $5'-0''$ of building perimeter.
<u>)</u> (17)	Coastal height limit line: $30'-0''$ line from the high point within $5'-0''$ of building perimeter.
	Carport with solar photovoltaic panels on top.
	General Notes
	All parapet walls around mechanical wells to provide screening for mechanical equipment.
	Refer to roof plan for roof spot elevations and surface applied photovoltaic film locations.
	Refer to Architectural site plan drawing for locations of property lines and 4'-0" setback lines. Property lines and setback lines are shown at approximate location of elevation cut. Property lines and setback lines beyond are shown for the outermost locations at the particular view shown.
	Refer to Architectural elevations for top of roof heights and overall building heights.
	Refer to Architectural courtyard plan for high and low points for the Prop 'D' and Overall structure height limit lines.
	Legend

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Phase 1:

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La Jolla, California 92037

Phase 2: Intersection of La Jolla Scenic Way, La Jolla Village Drive and La Jolla Scenic Drive

Phase 2: Site/Building Sections

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06.24.10 MIR Submittal

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