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TRAFFIC ENGINEER

Contact: Sam Kab Email: sam@urbansystems.net

OWNER'S ATTORNEY

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Contact: Bobbi Herdes
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ALEXANDRIA.

ALEXANDRIA REAL ESTATE EOUITIES

10996 Torreyana Road Suite 250 San Diego, CA 92121

CAMPUS POINT SITE DEVELOPMENT PERMIT

10290 &10300 CAMPUS POINT DRIVE SAN DIEGO, CA 92112

225 Broadway

San Diego CA 92101 Tel: 619.557.2500

Fax: 619.557.2520

Suite 1600

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Δ	Date	Issue/Revision	Ву	To
	11/30/2015	CYCLE 27	HR/BH	SS
	04/01/2016	CYCLE 32	JB/KD	SS
	06/24/2016	CYCLE 35	JB/KD	SS
	08/24/2016	CYCLE 38	KD	SS
	09/29/2016	CYCLE 41	KD	SS

PROJECT SIGNAGE SHALL COMPLY WITH THE SIGN REGULATIONS IN THE SAN DIEGO MUNICIPAL CODE CHAPTER 14, ARTICLE 2D, UNISION 2.0 EP EFEMITTED WITH A NEIGHBORHOOD USE PERMIT (NUP) FOR COMPREHENSIVE SIGN PLAN IN ACCORDANCE WITH CHAPTER 14, ARTICLE 01, DIVISION 1.10 FTHE SDMC.

THE NEW DEVELOPMENT IS COMMITTED TO THE NEW DEVELOPMENT IS COMMITTED TO ACHIEVING LEED SILVER STANDARD AND USES SUSTAINABLE PRACTICES FOLLOWING. THE OUTLINES OF THE GENERAL PLAN AND THE PORTION APPLICABLE TO RESIDENTIAL AND COMMERICAL PROPERTIES OF THE CURRENT COUNCIL POLICY 900-14. REFUSE/RECYCLE STORAGE:

REFUSE AND RECYCLE STORAGE AREAS ARE TO BE PROVIDED ON-SITE IN COMPLIANCE WITH TABLE 142-08C OF THE SAN DIEGO MUNICIPAL CODE.

UTILITY PLAN PROJECT DESCRIPTION PROJECT DEVELOPMENT SUMMARY **DEVELOPMENT INTENSITY ANALYSIS**

16.523 AC (719,741 GSF) 41.67 AC (1,815,145 GSF) 58.193 AC (2,534,886 GSF)

25.03 AC (1,090,307 GSF) 15.25 AC (664,290 GSF) 40.28 AC (1,754,597 GSF)

376,314 GSF

564,471 GSF

SHEET NAME

GRADING PLAN

GRADING PLAN

GRADING PLAN

GRADING PLAN

GRADING PLAN

GRADING PLAN

UTILITY PLAN UTILITY PLAN UTILITY PLAN

LITILITY PLAN

LITILITY PLAN

OVERALL UTILITY PLAN UTILITY PLAN

EXISTING CONDITIONS PLAN

OVERALL GRADING PLAN

THE 58.193-ACRE PROJECT SITE IS BOUND BY CAMPUS POINT DRIVE TO THE EAST, OPEN SPACE TO THE NORTH-LAST, NORTH, AND TO THE WEST, AND RESEARCH FACILITIES TO THE SOUTH. THE PROJECT SITE IS COLORED WITH IN THE UNIVERSITY COMMUNITY PLANNING AREA OF SAN DIEGO.

CP2 MSL 376.37 74.4* TITLA GROSS AREA-CROSS AREA-CROS

SHEET NAME

TITLE PAGE

PROPOSED SITE PLAN

SITE ACCESSIBILITY PLAN

SITE FIRE ACCESS PLAN

BUILDING CP1 FLOOR PLANS

BUILDING CP1 ELEVATIONS

BUILDING CP2 FLOOR PLANS

BUILDING CP2 ELEVATIONS BUILDING CP2 SECTIONS

BUILDING CP3 FLOOR PLANS

BUILDING CP3 ELEVATIONS

BUILDING CP4 FLOOR PLANS & ELEVATIONS

BUILDING CP3 SECTIONS

BUILDING CP4 SECTIONS

PARKING COUNT (SITE)

EXISTING SITE PLAN

SHEET NUMBER

ARCHITECTURAL A1.00

A1.01A

A1.01B

A1.01C

A1.01G

A2.01A

A2.01B

A2.02A

A2.02B A2.02C

A2.03A

A2.03C

A2 04A

THE CURRENT DEVELOPMENT INTENSITY OF THE COMBINED SITES IS 731,7250SF, CONSISTING OF ONE (1) 463,791GSF, 2.STORY, MULTI-TENANT BUILDING (*CP-1*), AND ONE (1) 267,934CSF, 4.STORY, MULTI-TENANT BUILDING (*CP-1*), AND ONE (1) 267,934CSF, 4.STORY, SIGLEATENANT CCP (*CP-1*), AND ONE (1) 267,934CSF, 4.STORY SUILDING (*CP-1*) SIGLEATENANT CCP (*CP-1*), AND ONE (1) 267,934CSF, 4.STORY SUILDING (*CP-1*) SIGLEATENANT (*CP-1*), AND ONE (1) 267,934CSF, 4.STORY SUILDING (*C

BOTH EXISTING BUILDINGS HAVE REGULARLY NON-OCCUPIED UTILITY/CENTRAL PLANT STRUCTURES ASSOCIATED WITH THEM: 9,044GSF (CP1-1) AND 7,310GSF (CP2-1) RESPECTIVELY. THE UTILITY STRUCTURES ARE ROOFED AND ARE NOT NORMALLY OCCUPIED EXCEPT POR OCCASIONAL MAINTENANCE PERSONNEL. THUS, THE SQUARE POR OCCASIONAL MAINTENANCE PERSONNEL. THUS, THE SQUARE DEVELOPMENT IN FEASITY CALCULATION.

APPLICANT PROPOSES INCREASING THE DEVELOPMENT INTENSITY OF THE COMBINED SITES BY ADDING ONE (I) 318.383 GSF. COMBINED 6 & 12 STORY, MML.TERNATI BULLDING (CPS) AT THE WEST END OF 14!E CAMPUS; ONE (I) 10.00 GSF. 2-STORY BUILDING HOUSING A MICRO-BREWERY WA ACCESSORY DIMING SPACE & SHARED TENANT AMENTY SPACES (CPSF.); AND ONE (I) 564.471GSF, 6-LEVEL (ABOVE GRADE) PARKING STRUCTURE, ACCOMMODATING 1-440 PASSENGER VEHICLES, SITUATED ALONG THE SOUTHERN EDGE OF THE SITE.

OTHER PROPOSED SITE IMPROVEMENTS INCLUDE A SOCCER RELD AND A RECONHIGURATION OF THE MAIN BOLLEVARD (PRIVATE ROAD). A RECONHIGURATION OF THE MAIN BOLLEVARD (PRIVATE ROAD). FROM THE PROJECT SITE A TPLUL BUILD-OUT THE TOTAL PROPOSED OCCUPIABLE BUILDING SOURRE FOOTAGE SHALL BE 1.080,108GSF. THE TOTAL WIMBER OF PASSENGER VEHICLE PARKING SPACES PROPOSED MEW + EXISTING) = 2,909; YIELDING A COMBINED PARKING RATIO OF 2.74 PER 1.000 GROSS SQUARE FEET.

SHEET NUMBER

A2.05A

A2.05B

A2.05C

A3.01A

A4 01

SHEET NAME

SITE SECTIONS

DESIGN GUIDELINES

PARKING STRUCTURE FLOOR PLANS

PARKING STRUCTURE FLEVATIONS

SOCCER FIELD LIGHTING AND DATA

PARKING STRUCTURE SECTIONS

GROSS AREA – 10290 CAMPUS POINT DRIVE GROSS AREA – 10300 CAMPUS POINT DRIVE TOTAL GROSS SITE AREA NET (DEVELOPED) – 10290 CAMPUS POINT DRIVE NET (DEVELOPED) – 10300 CAMPUS POINT DRIVE TOTAL NET (DEVELOPED) SITE AREA (69% OF GROSS) LANDSCAPED AREA - 10290 CAMPUS POINT DRIVE EXISTING:

BUILDING 1 (CP1)
BUILDING 2 (CP2)
TOTAL EXISTING BUILDING GSF
(COUNTED TOWARD DEVELOPMENT
INTENSITY CALCULATION) 267,934 GSF 731,725 GSF CENTRAL PLANT (CP1-1)
CENTRAL PLANT (CP2-1)
(NOT COUNTED TOWARD DEVELOPMENT
INTENSITY CALCULATION) PROPOSED: BUILDING 3 (CP3, ABOVE-GRADE) 10,000 GSF 328,383 GSF 1,060,108 GSF TOTAL EXISTING + PROPOSED GSF AT FULL ENTITLEMENT PARKING SUBTERRANEAN (3 LEVELS)
STRUCTURE: (BELOW-GRADE NOT COUNTED TOWARD DEVELOPMENT INTENSITY NOR FAR 188,157 GSF

CALCULATION)
AT & ABOVE-GRADE (6 LEVELS)

(NOT COUNTED TOWARD DEVELOPMENT INTENSITY NOR FAR CALCULATION; STRUCTURE COMPLIES WITH SDMC RULES & CALCULATIONS SEC. 113.0234 D.3(B) TOTAL PROPOSED PARKING STRUCTURE GSF

SHEET NUMBER

C1.0

C2.1

C2 2

C2.4

C2.5 C2.6

C2.7

C3.2

C3.3 C3.4

C3.5

MCAS MIRAMAR ALLICP BASE ON 50 PERSONS/AC 0.34 x 2,534,886 GSF =

UNIVERSITY COMMUNTIY PLAN 30,000 GSF/AC X 40.28 NET AC = 1.208.400GSF 861.861GSF MAXIMUM INTENSITY ALLOWED BY ALUC WITHIN APZ II 50 PERSON/AC THEREFORE: 50 PEOPLE/AC x 58.1973AC = 2,909 PEOPLE THE FAR OF THE ALUCP BASED UPON 50 PP/AC AND A LOAD FACTOR OF 300 SF. PER PERSON FOR R&D IS: 300 SF/PERSON x 2,909 PEOPLE / 2,534,886 GSF = 300 SF/PERSON x 2,909 PEOPLE = ALTERNATIVE CALCULATION (METHOD USED) SAN DIEGO MUNICIPAL CODE SECTION 132.1515 (d) ALLOWS WITH A NDP: ALTERNATIVE METHOD OF CALCULATION BASED UPON THE PROPOSED NUMBER OF PARKING SPACES ASSOCIATED WITH THE DEVELOPMENT OR AN ESTIMATE BASED ON A SURVEY OF SIMILAR USE:

SHEET NUMBER

LANDSCAPE

L1.1A

L1.1B

L1.1C L1.1D

L1.2A L1.2B

L1.2C L1.2D

L1.3

L1.4 L1.5

L1.6

SHEET NAME

HARDSCAPE PLAN

HARDSCAPE PLAN

HARDSCAPE PLAN PLANTING PLAN
PLANTING PLAN

PLANTING PI AN

WATER BUDGET LANDSCAPE CALCULATIONS CHARACTER IMAGERY

BRUSH MANAGEMENT PLAN

EXISTING VEGETATION IMAGERY

EXISTING VEGETATION IMAGERY

PLANTING LEGEND & NOTES IRRIGATION &

KEY MAP

PER ALUCP APPENDIX D: 400 SF / PERSON / 1.1 PERSON = 364 SF / PERSON

1.058.876GSF

PROJECT INFORMATION PARCELS NO. 1 & 2 OF PARCEL MAP NO. 10898 LEGAL DESCRIPTION

APN NUMBER ASSESSOR PARCEL NO. 343-230-13 & 343-230-

OCCUPANCIES OCCUPANCY CLASSIFICATIONS A,B,S-1, F-1 (VARIES BY BUILDING) ZONING DESIGNATION: 1P-1-1 ZONE OVERLAY ZONE: MCAS MIRAMAR ALUCP ZONING DESIGNATION: RS-1-14 ZONING DESIGNATION: RS-1-7 ZONING DESIGNATIONS

EXISTING USES SCIENTIFIC RESEARCH PROPOSED USES

EXISTING CP1 & CP1-1 BUILT IN 1979 EXISTING CP2 & CP2-1 BUILT IN 1997 YEAR CONSTRUCTED

GEOLOGICAL HAZARD CATEGORY 21,25 & 52

Project Name


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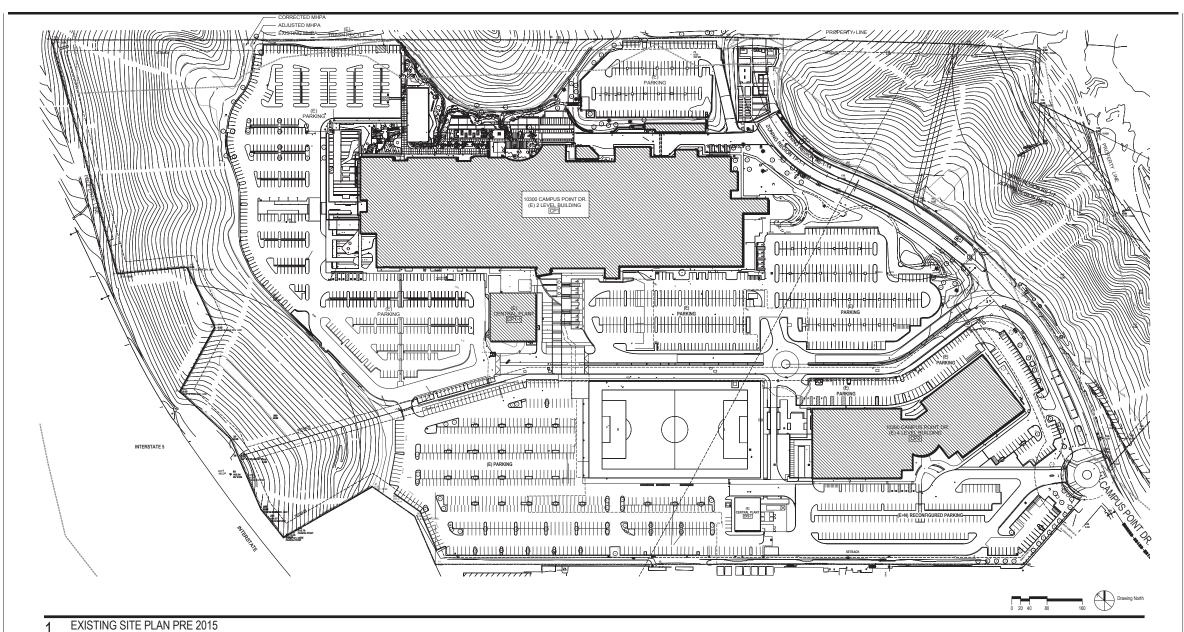
Seal/Signature

TITLE PAGE

A1.00

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SITE LEGEND_EXISTING

SCALE: 1/2" = 1

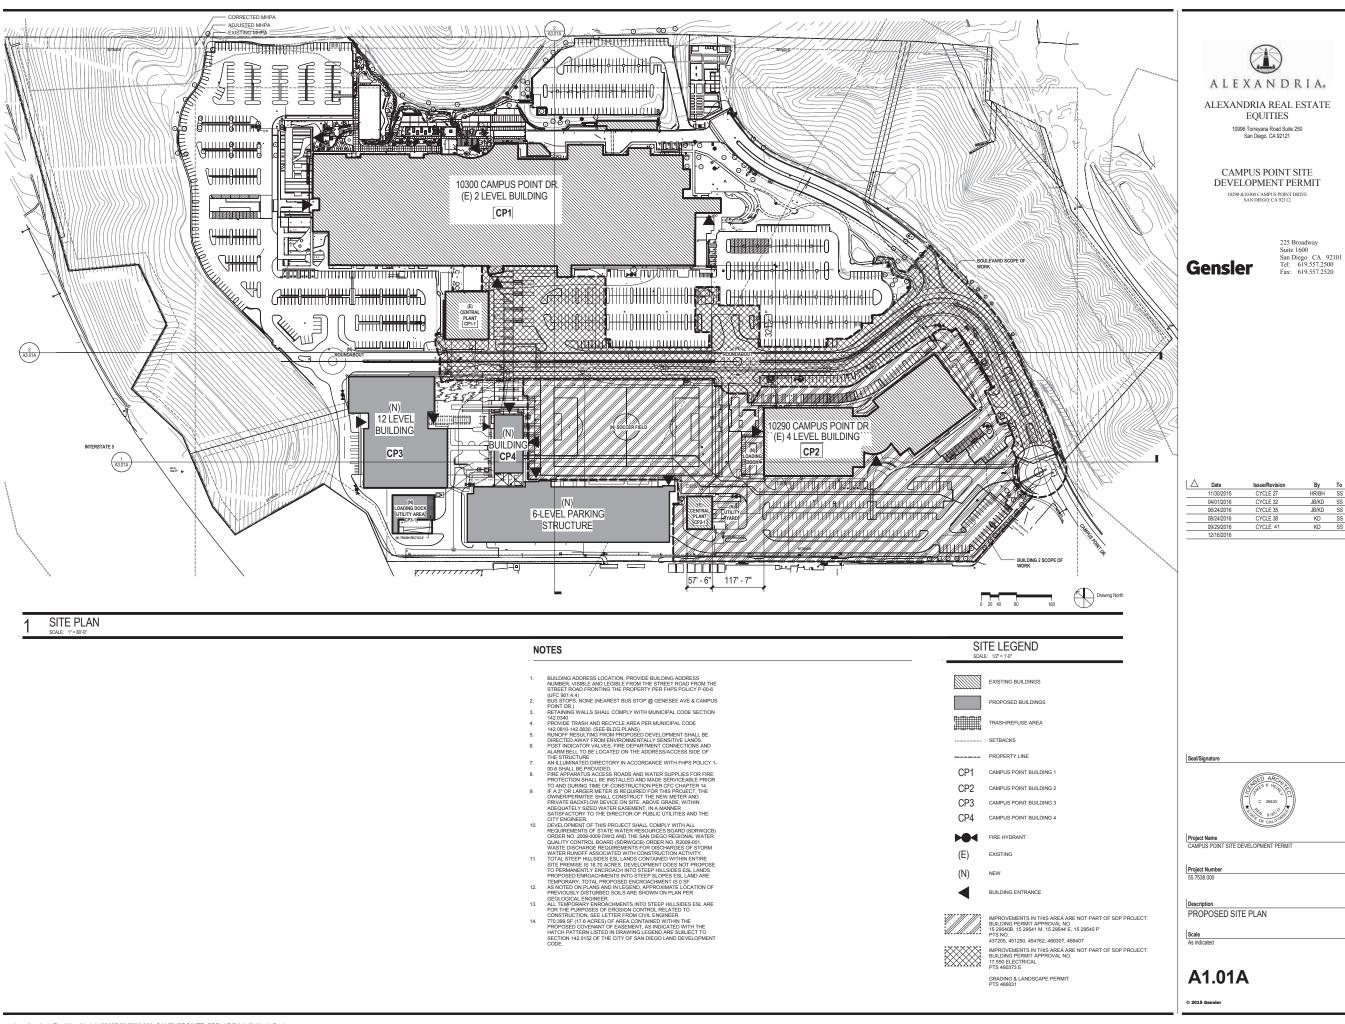EXISTING BUILDINGS

TRASH/REFUSE AREA

PROPERTY LINE

CP1 CAMPUS POINT BUILDING 1

CPZ CAMPUS POINT BUILDIN

FIRE H

(L)

◀



IMPROVEMENTS IN THIS AREA ARE NOT PART OF SDP PROJECT. SOCCER FIELD: APPROVED ACCESSORY USE PER PRIOR PERMIT



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0290 &10300 CAMPUS POINT DR

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Seal/Signature



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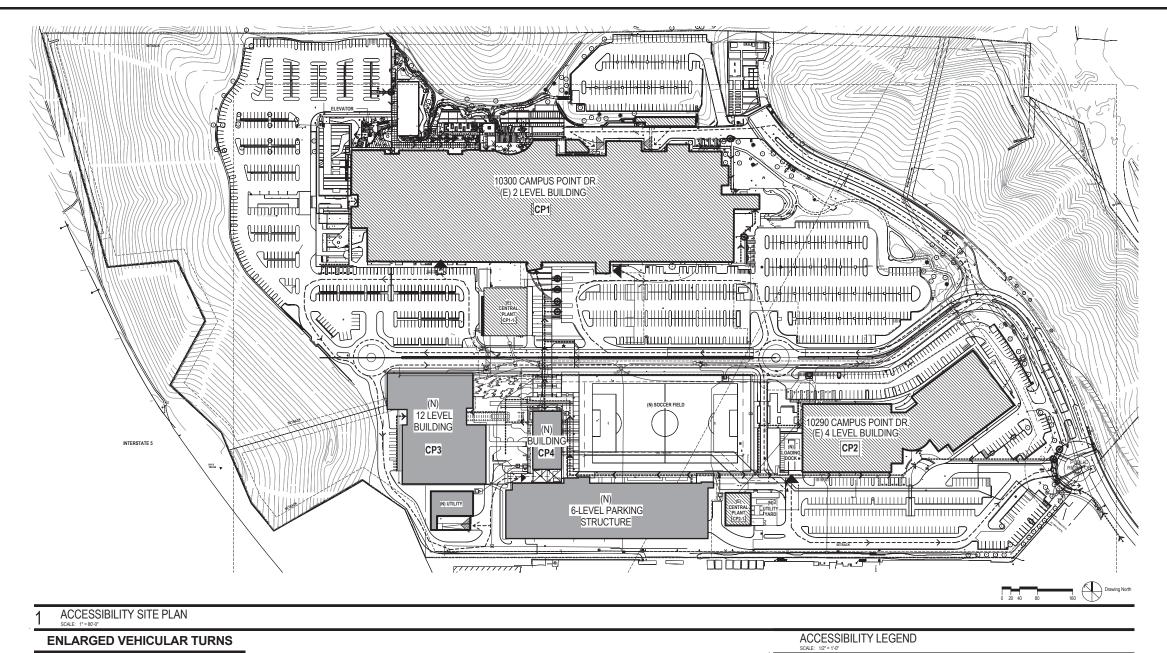
Project Number

Description
EXISTING SITE PLAN

Scale

A1.01B

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08/24/2016	CYCLE 38	KD	SS
09/29/2016	CYCLE 41	KD	SS
12/16/2016			



Project Name
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Seal/Signature

SITE ACCESSIBILITY PLAN

A1.01C


EXISTING BUILDINGS


PROPOSED BUILDINGS


----- PROPERTY LINE


ACCESSIBLE PARKING SPACE PER CBC 11259B


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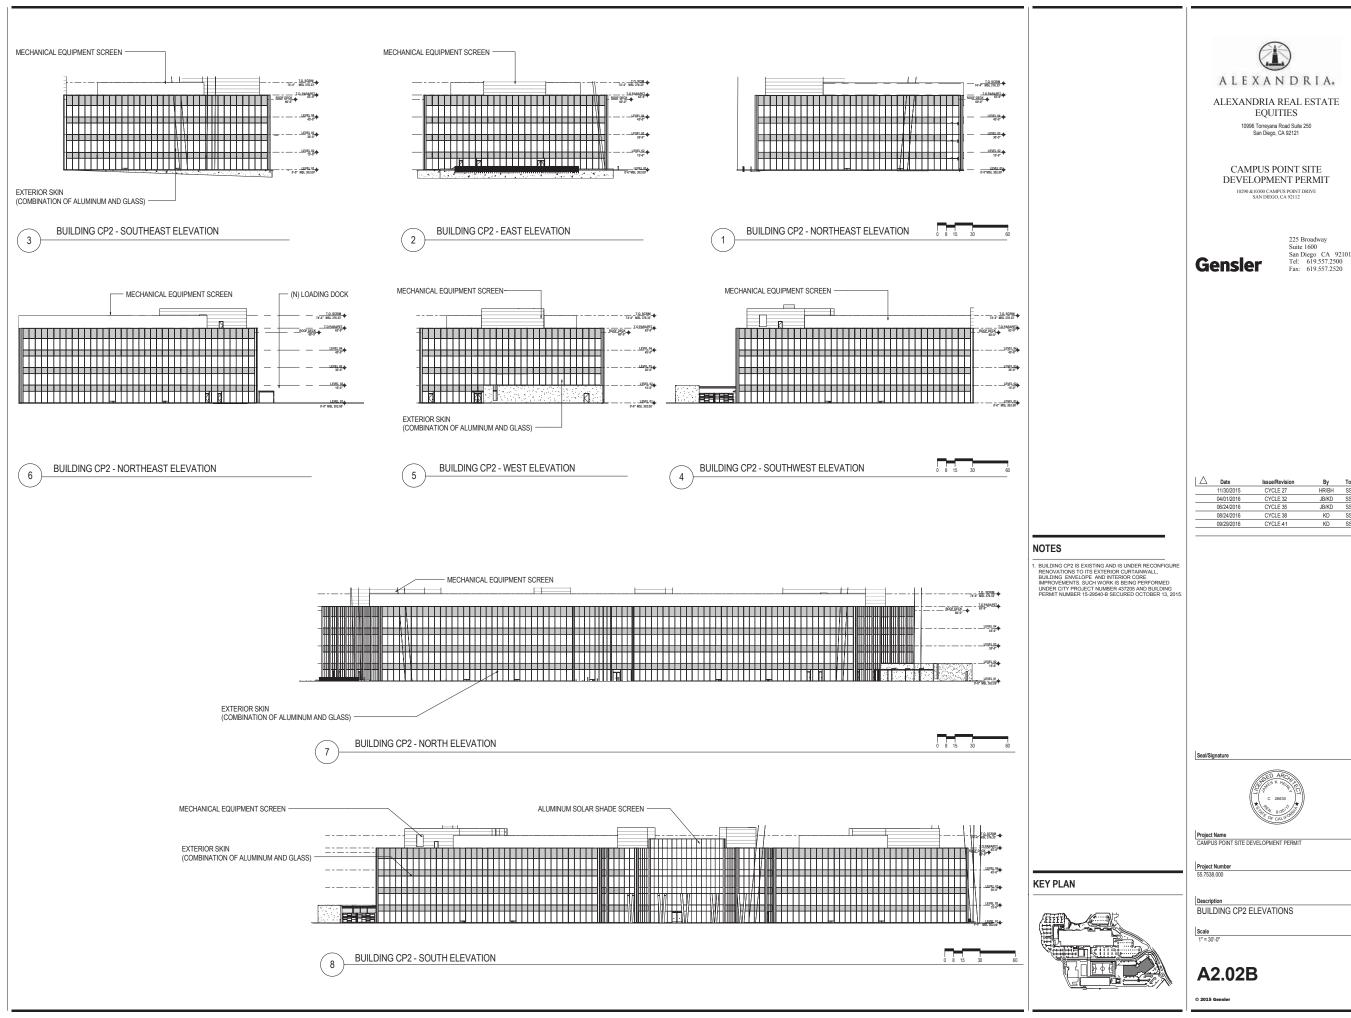


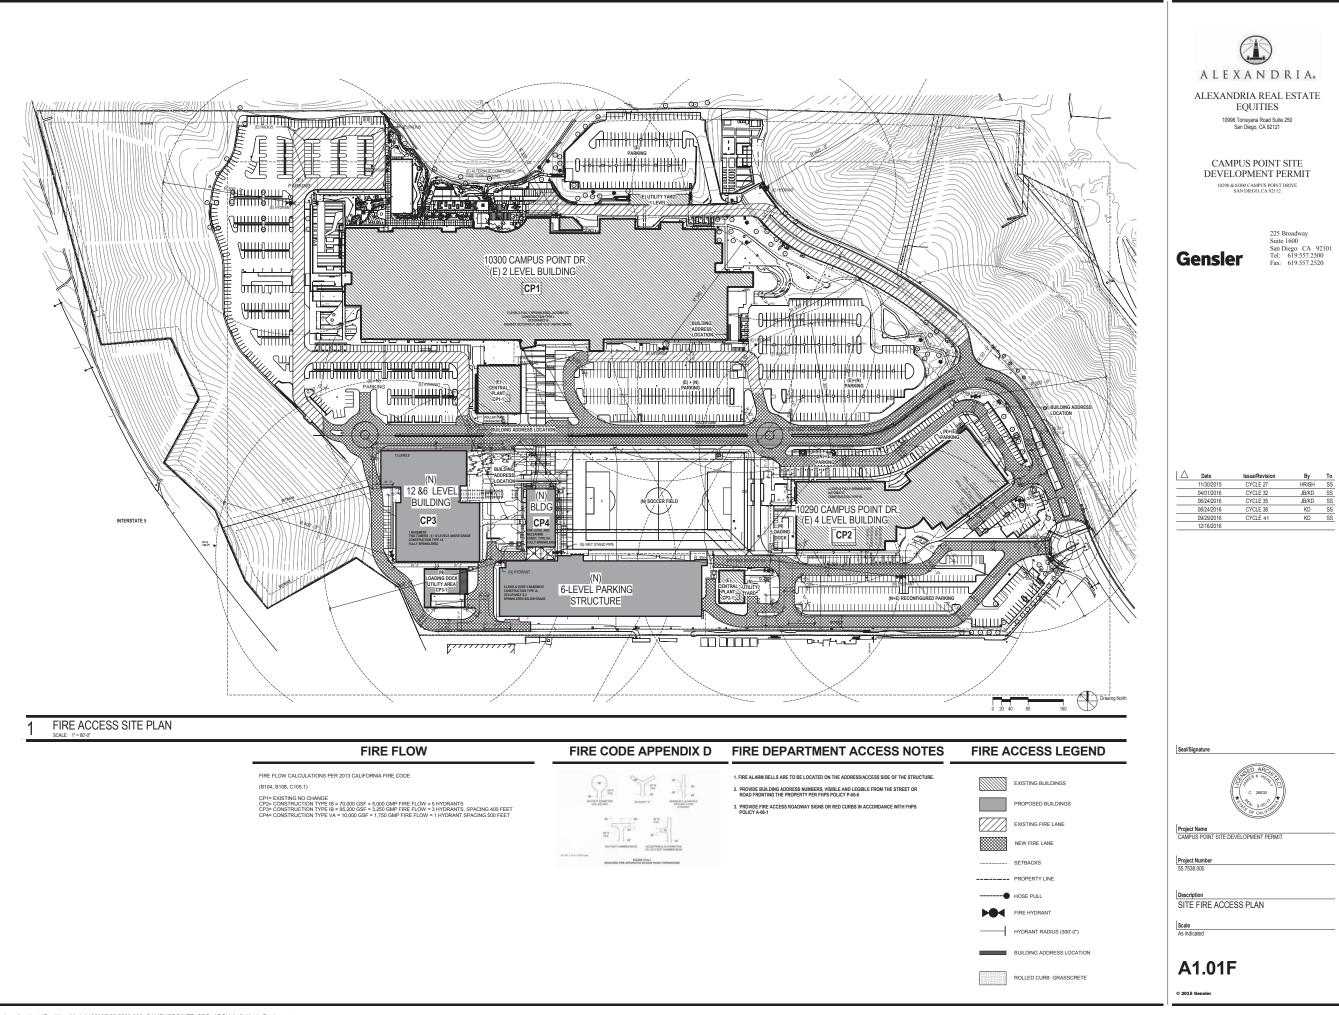


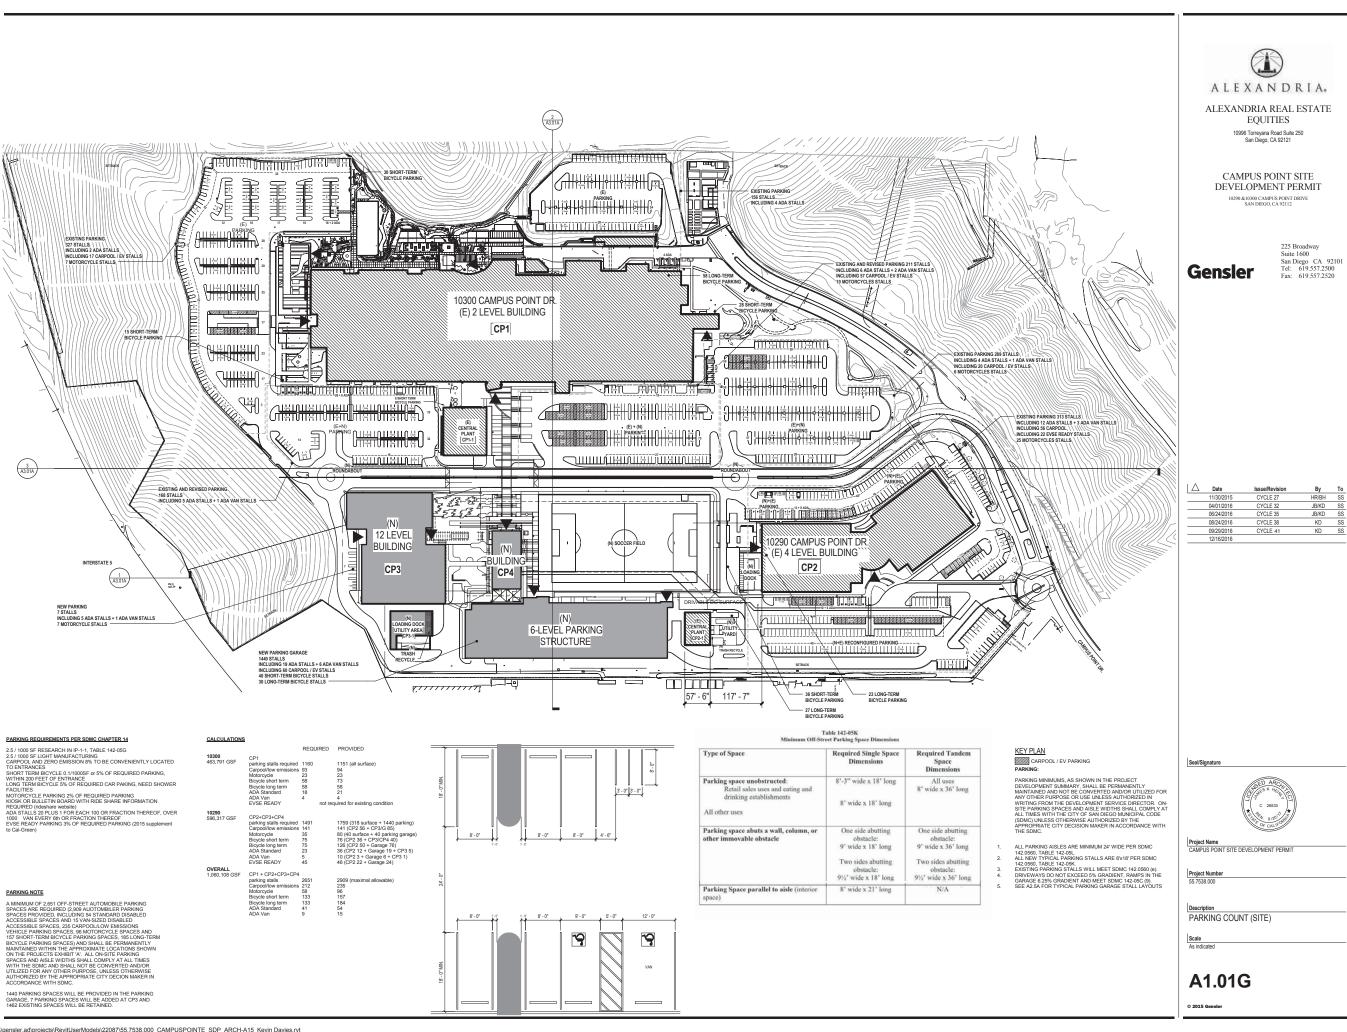


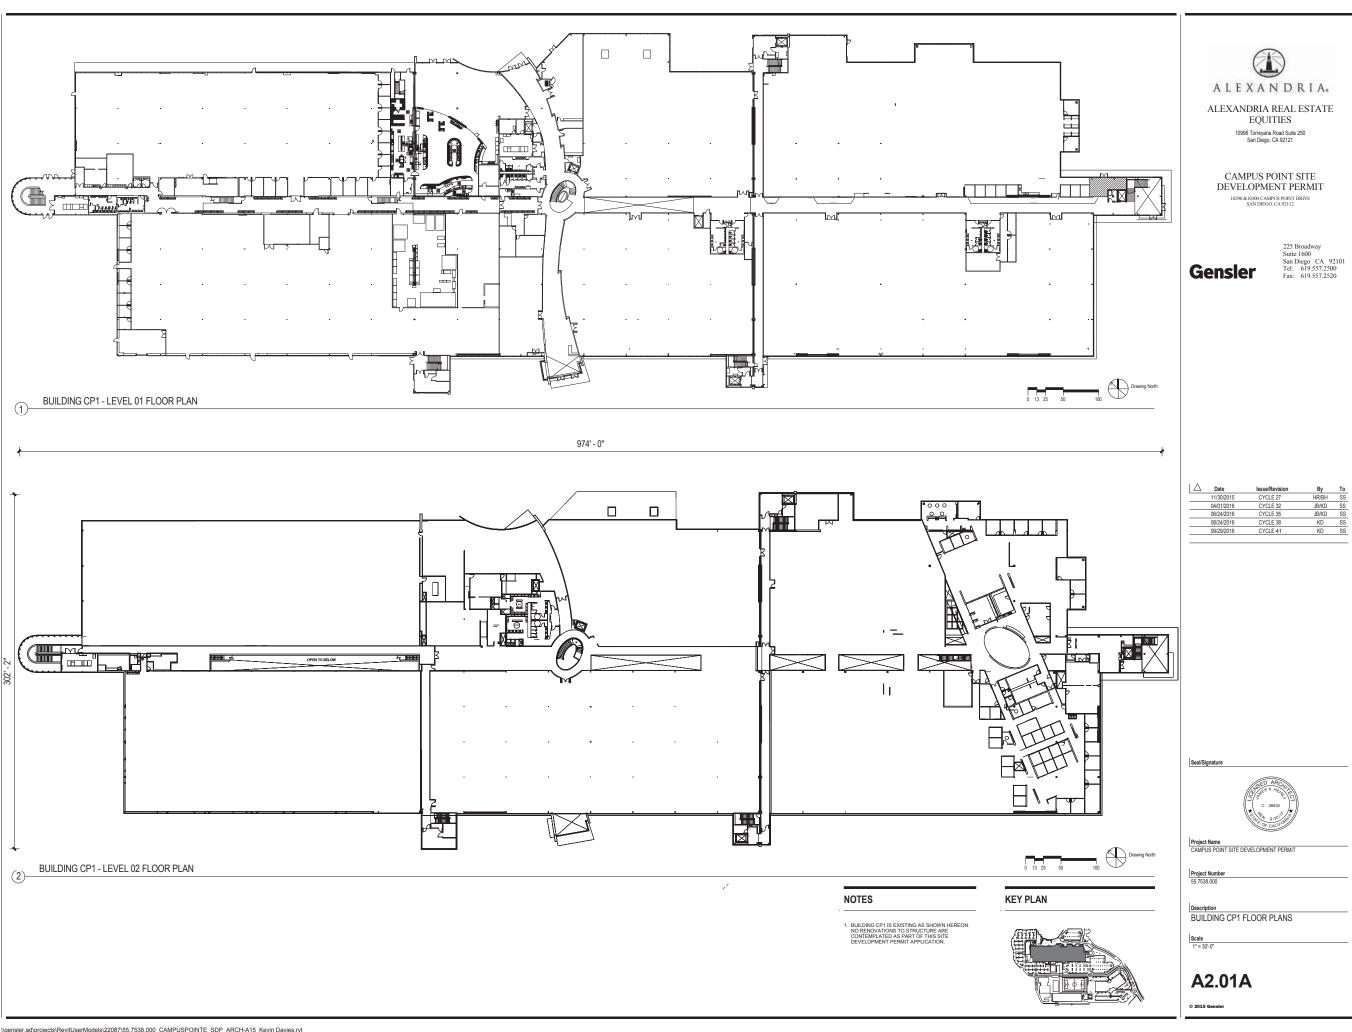


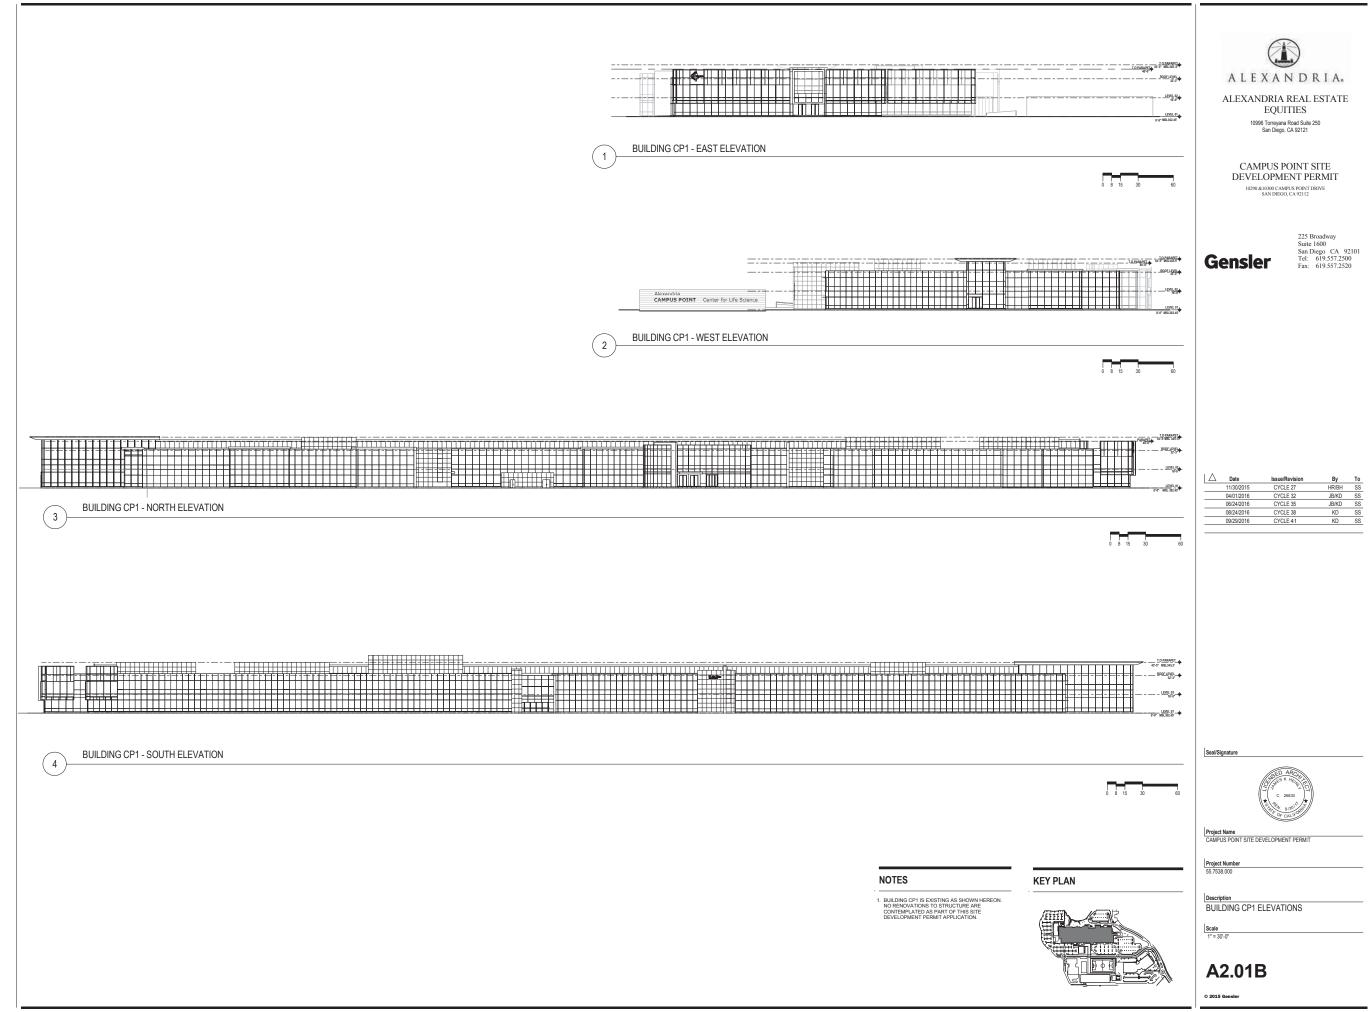


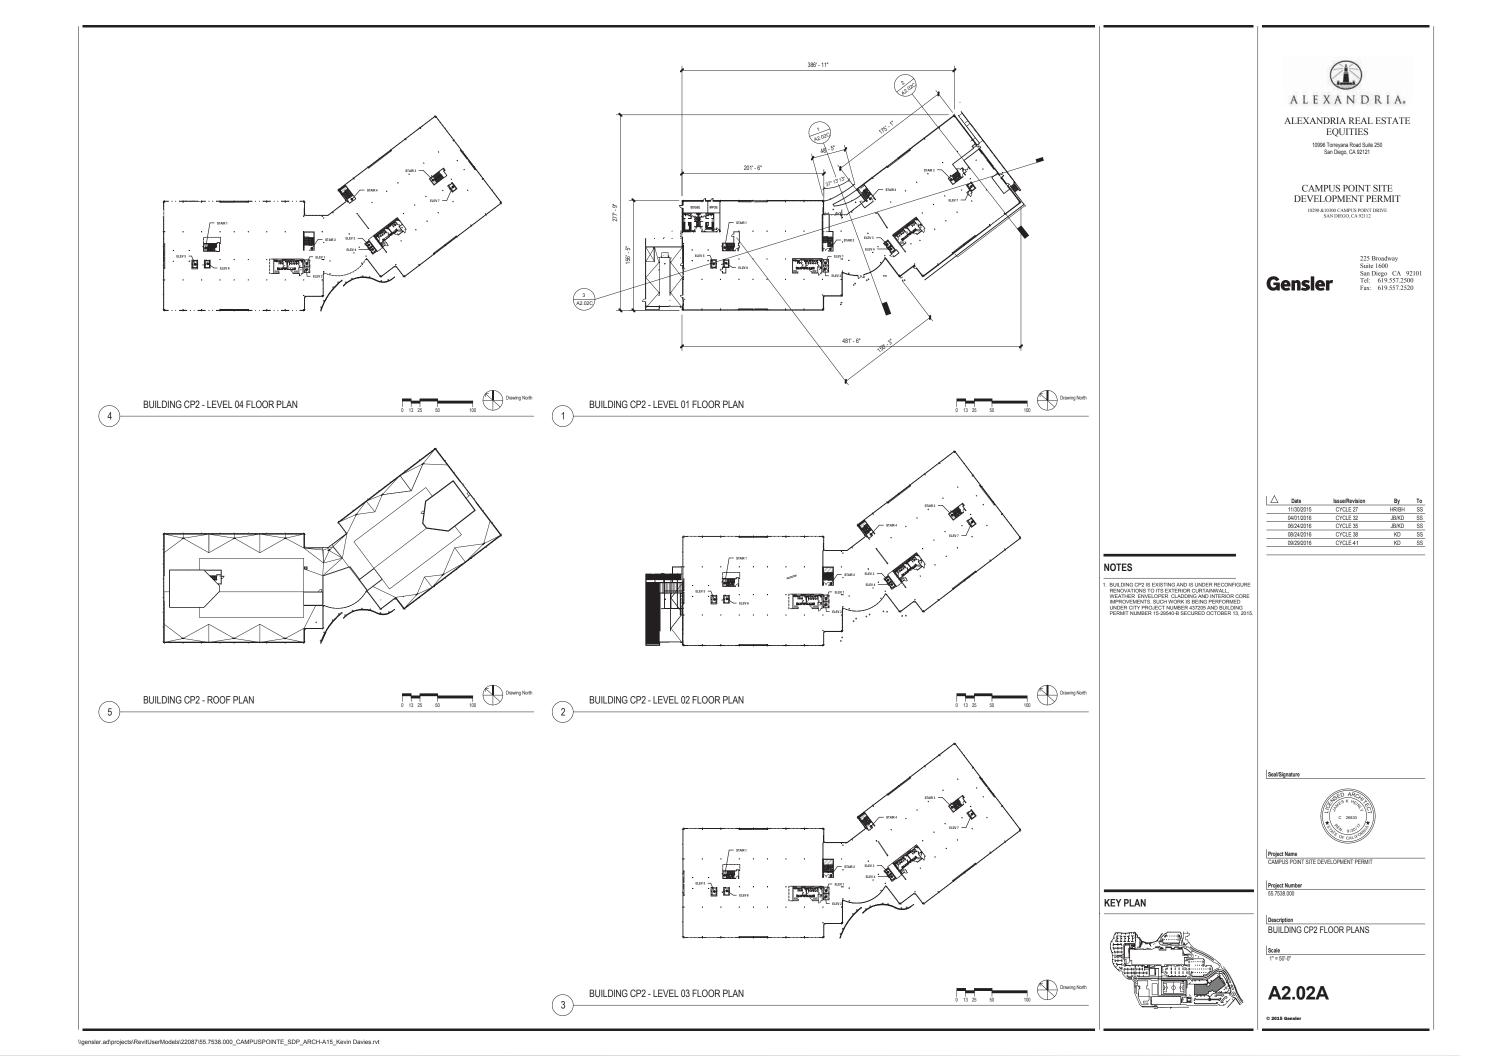

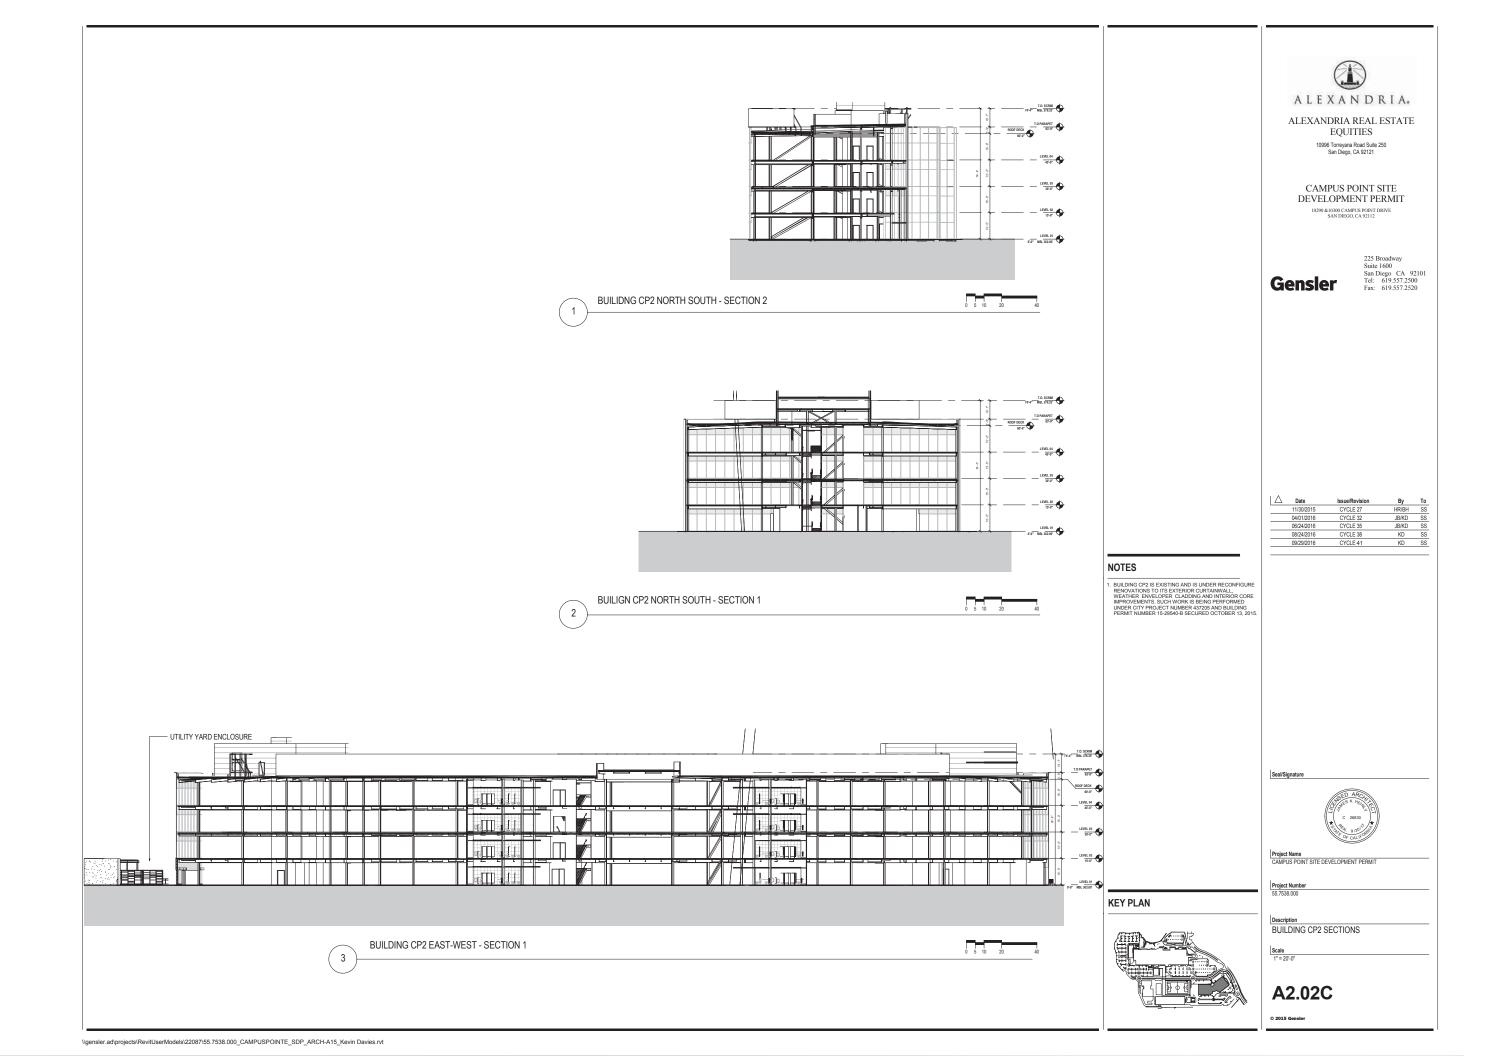

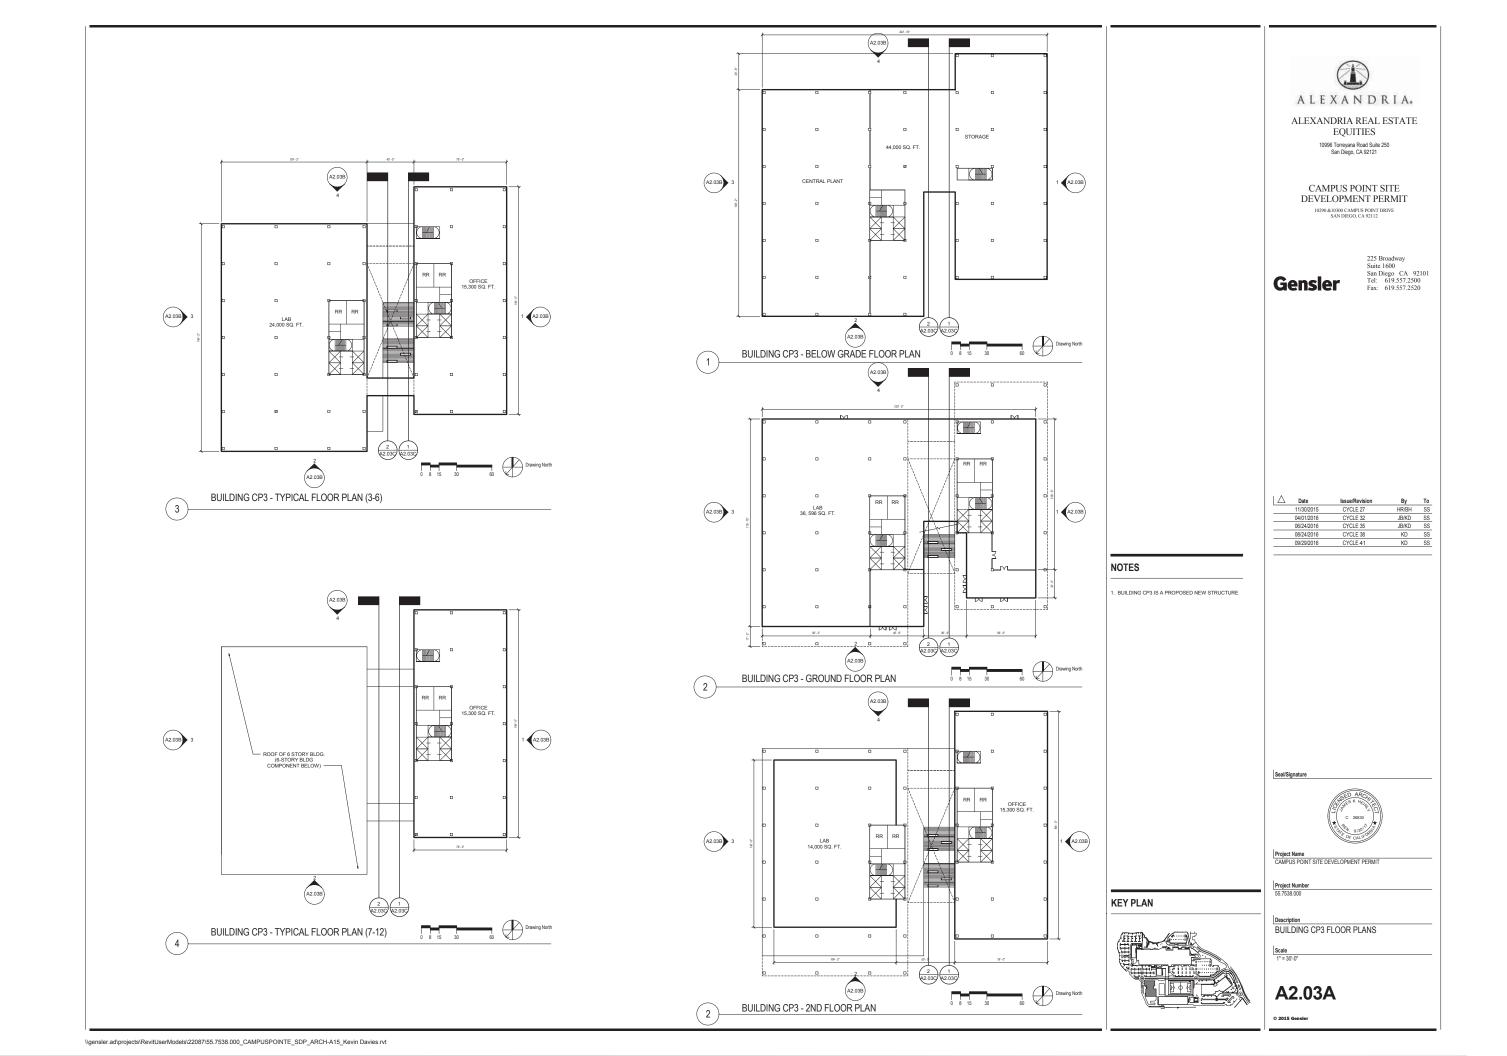

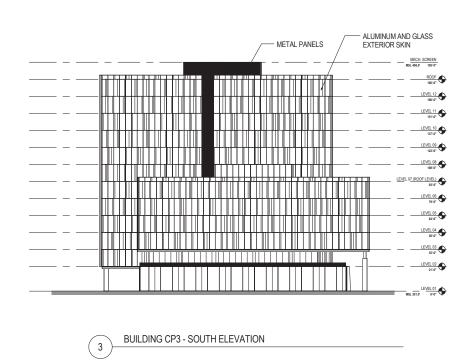

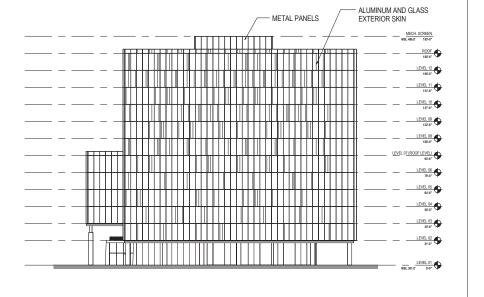

BUILDING CP3 - NORTH ELEVATION

BUILDING CP3 - EAST ELEVATION

 Date
 Issue/Revision
 By
 To

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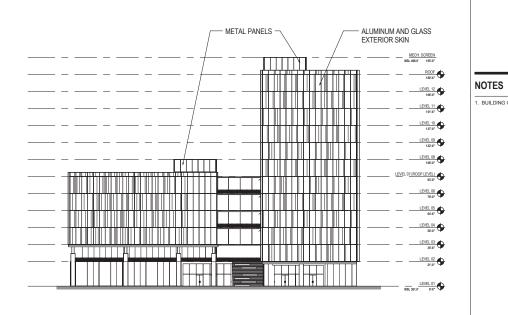
WE GET THEFT

LEVEL 17

LEVEL 10

LEVEL

BUILDING CP3 - WEST ELEVATION






Project Name
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7538.000


BUILDING CP3 ELEVATIONS


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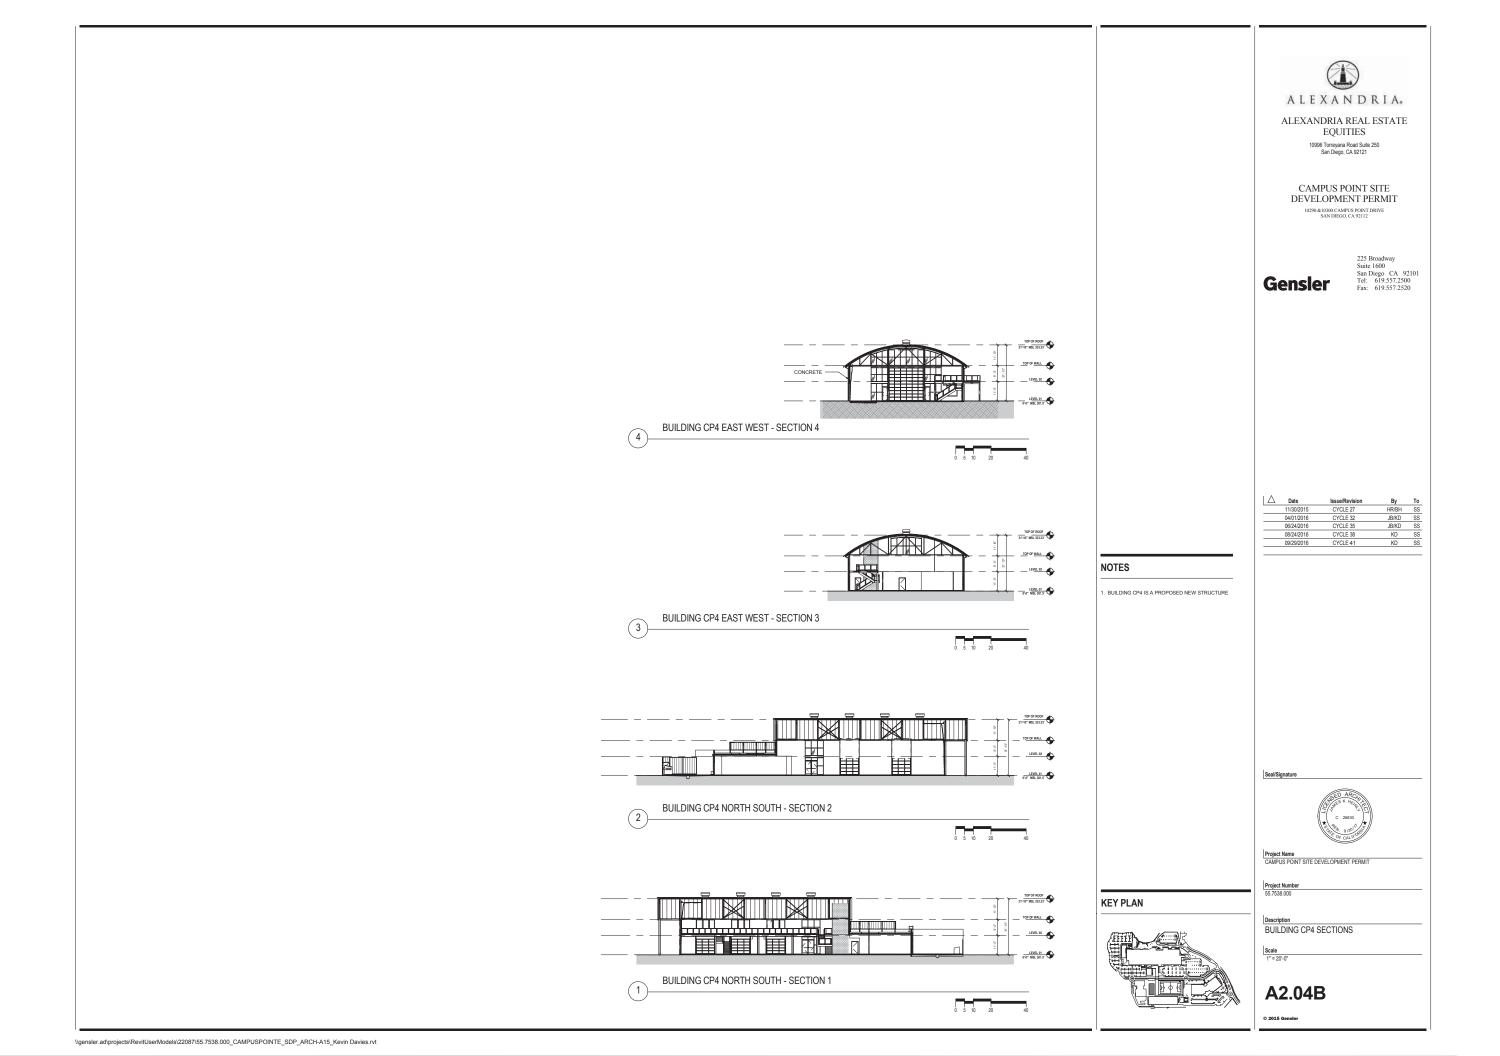
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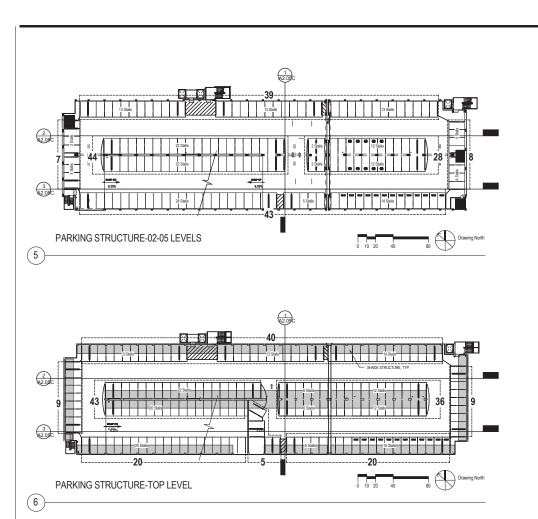



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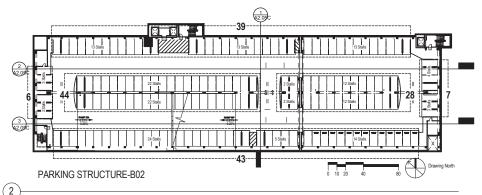





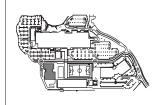


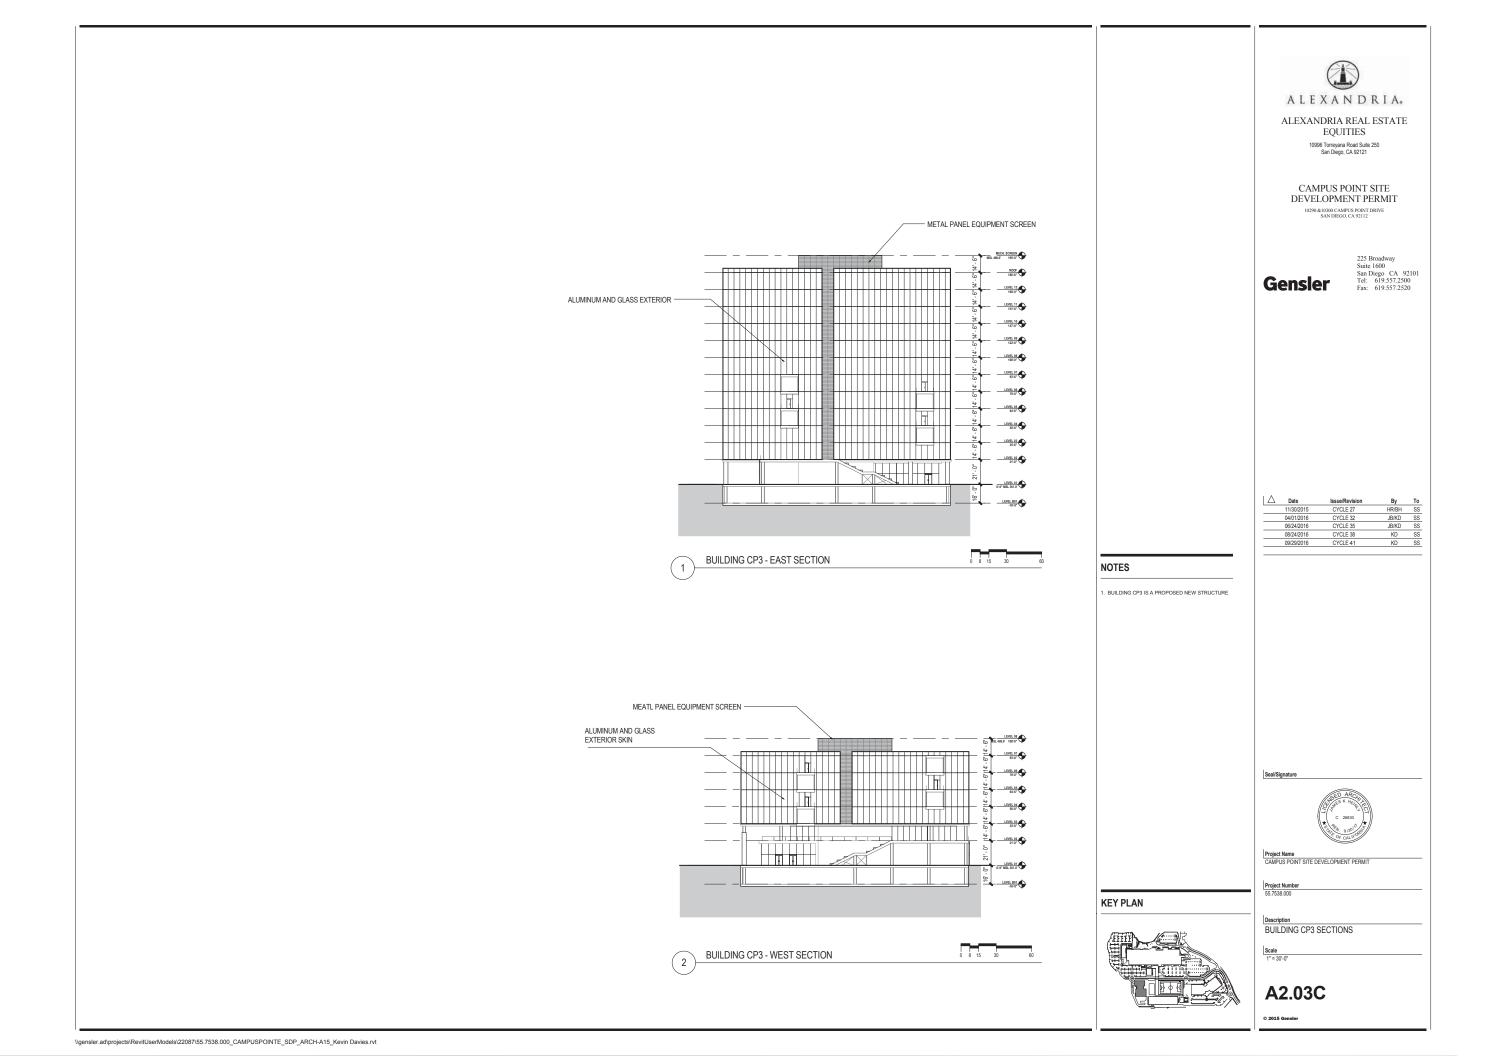


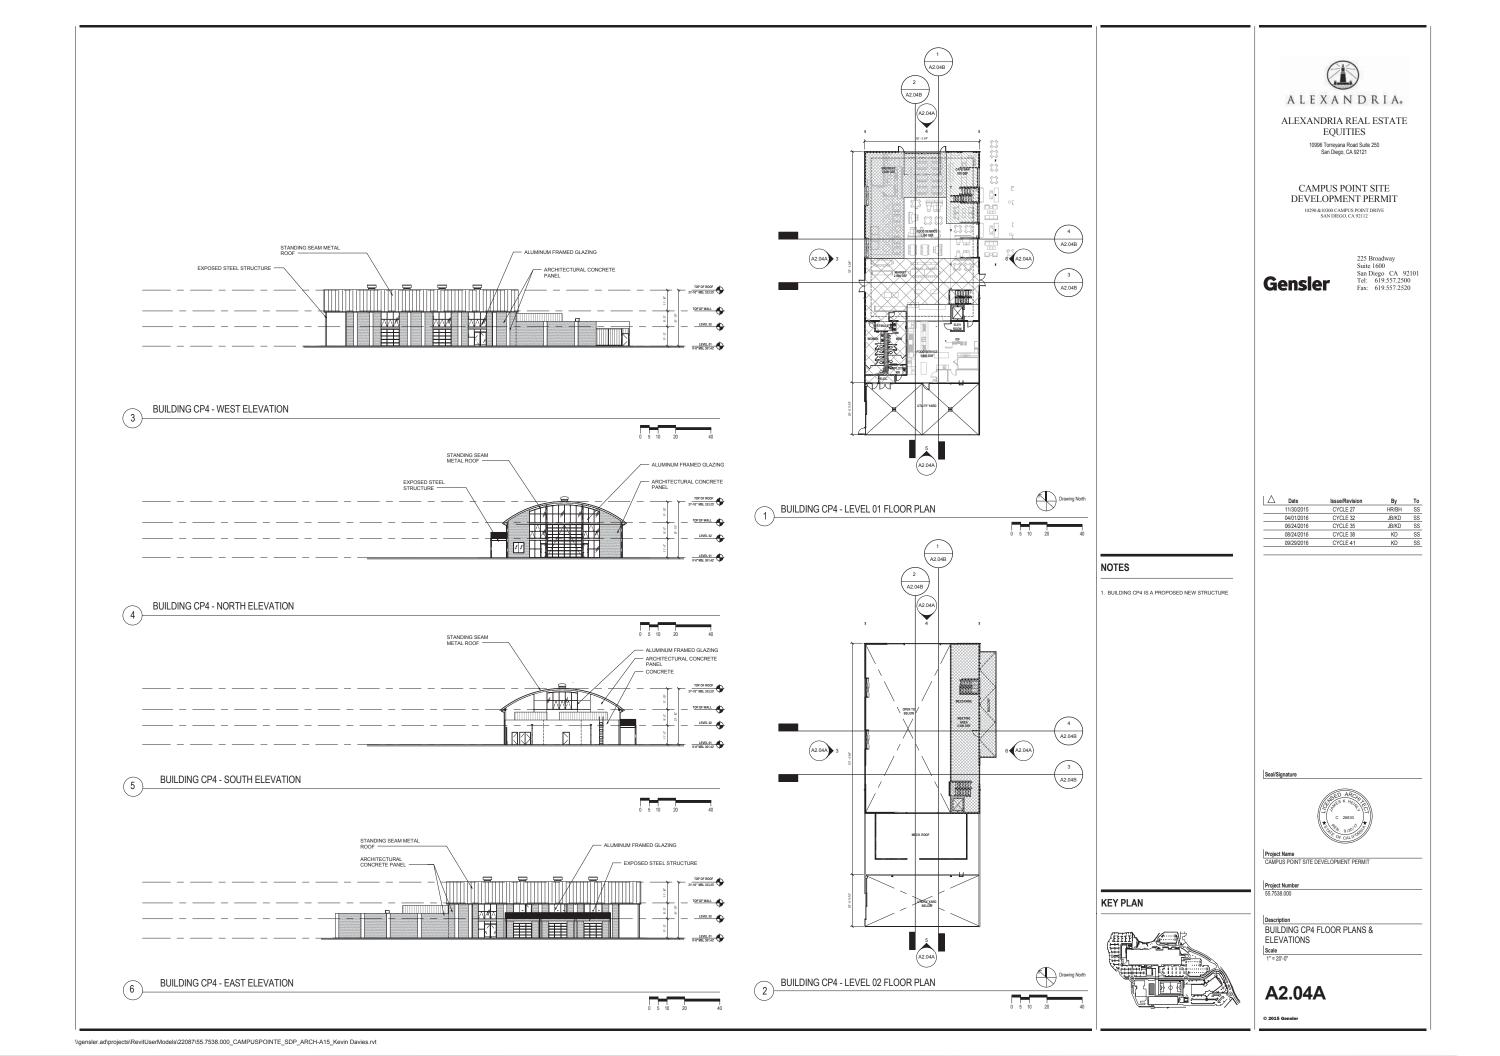


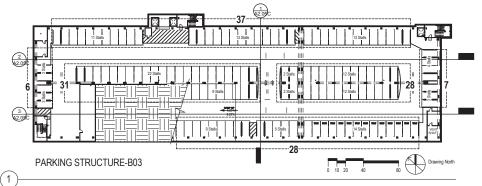

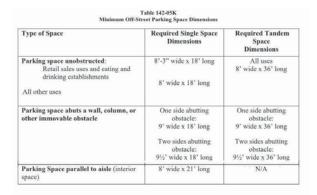


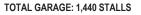

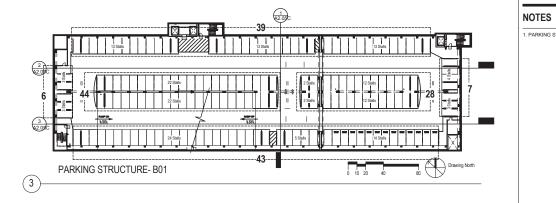


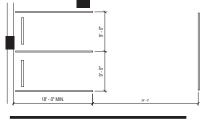

TYPICAL PARKING SCALE: 1/8" = 1'-0"

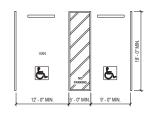

4 TYPICAL ACCESSIBLE VAN PARKING

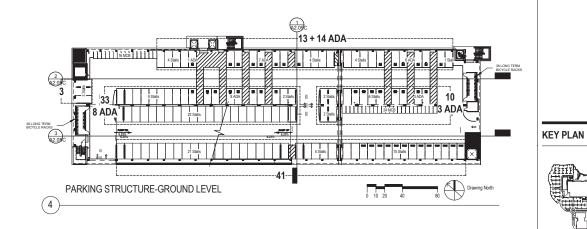



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I A Date

PARKING STRUCUTRE IS A PROPOSED NEW FACILITY

225 Broadway Suite 1600 San Diego CA 92101 Tel: 619.557.2500 Fax: 619.557.2520

1 4	Date	19206/LEA121011	Бу	10
	11/30/2015	CYCLE 27	HR/BH	SS
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	06/24/2016	CYCLE 35	JB/KD	SS
	08/24/2016	CYCLE 38	KD	SS
	09/29/2016	CYCLE 41	KD	SS

Seal/Signature



Project Name
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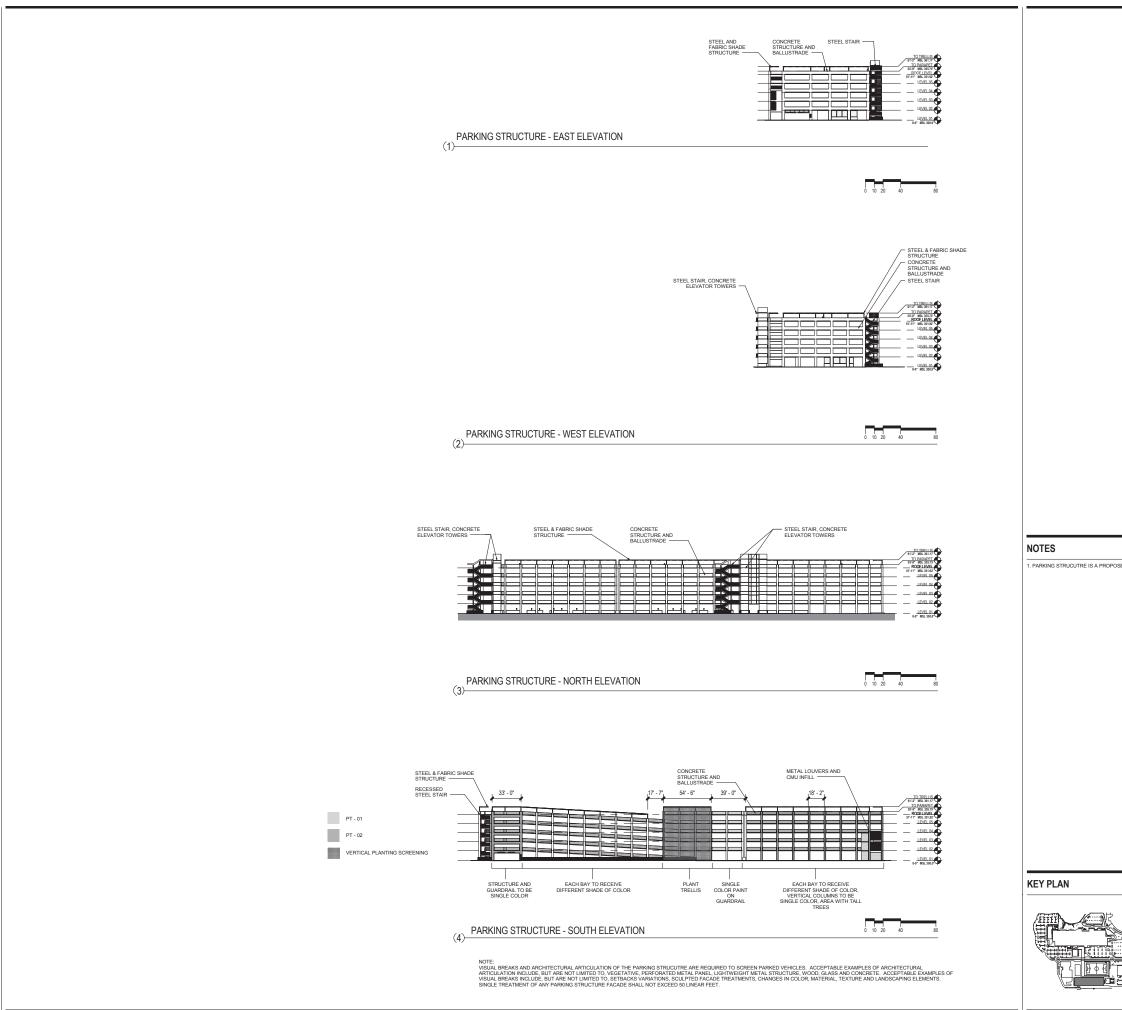
7538.000

PARKING STRUCTURE FLOOR PLANS

Scale

A2.05A

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	CYCLE 27 CYCLE 32 CYCLE 35 CYCLE 38	CYCLE 27 HR/BH CYCLE 32 JB/KD CYCLE 35 JB/KD CYCLE 38 KD

PARKING STRUCUTRE IS A PROPOSED NEW FACILITY


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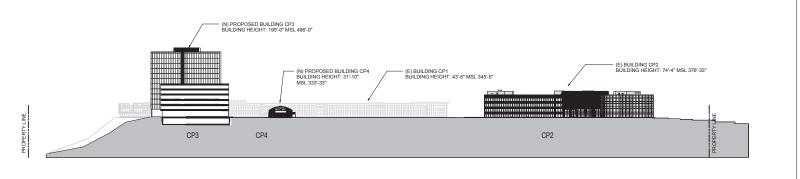


Project Name
CAMPUS POINT SITE DEVELOPMENT PERMIT

Description
PARKING STRUCTURE ELEVATIONS

A2.05B



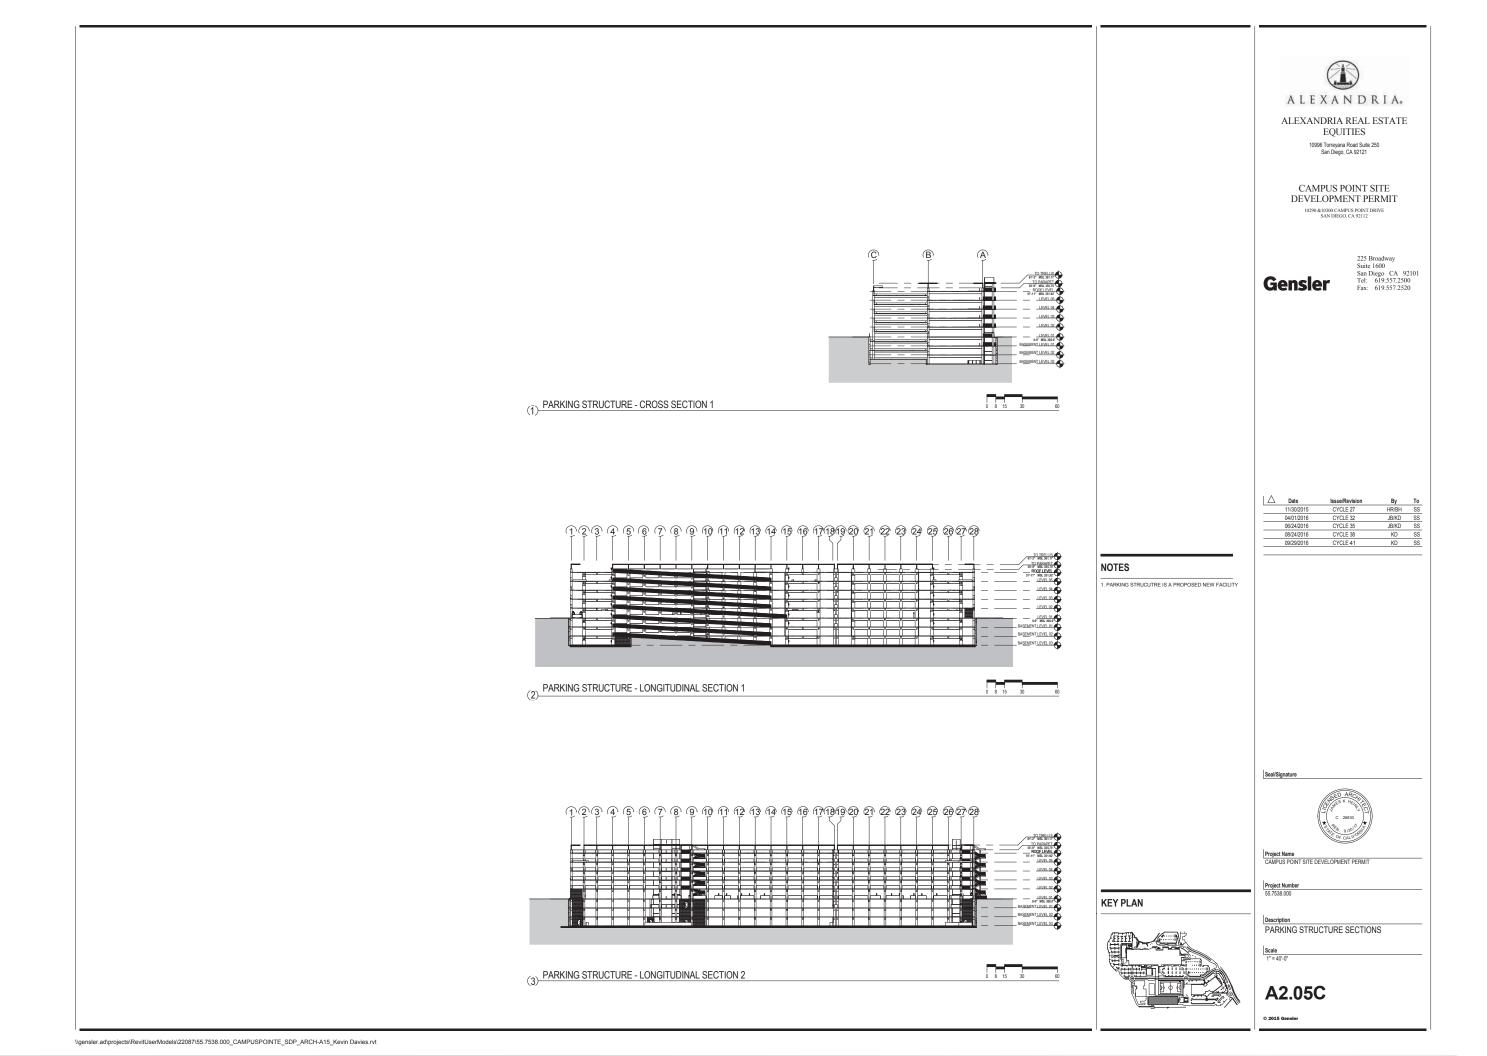

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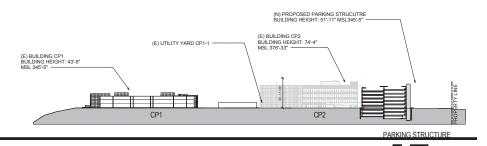
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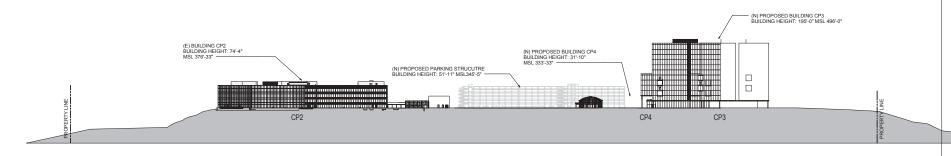
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2 SITE SECTIONS 2 (LOOKING EAST)


SITE SECTION 1 (LOOKING NORTH)

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08/24/2016	CYCLE 38	KD	SS
09/29/2016	CYCLE 41	KD	SS



3 SITE SECTIONS 3 (LOOKING SOUTH)

SCALE: 1" = 10

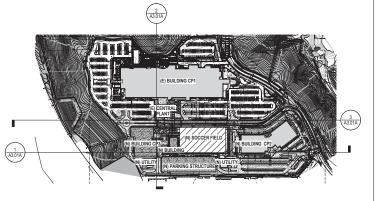

KP SITE SECTION KEY PLAN

Seal/Signature



Project Name
CAMPUS POINT SITE DEVELOPMENT PERMIT

55.7538.000

Description
SITE SECTIONS

leaste.

A3.01A

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Figure 1





Figure 3



Figure 4



Figure 5

Figure 6





Figure 9

Figure 10











Figure 14

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	06/24/2016	CYCLE 35	JB/KD	5
_	08/24/2016	CYCLE 38	KD	S
	09/29/2016	CYCLE 41	KD	S
	· ·			

Design Guidelines Introduction

Architectural style, building placement, and building/landscape design for Campus Point should be visually comparable and complimentary with the existing development on the site. Buildings should portray the look of a sustainable, high-tech, scientific research complex fitting with the advanced scientific research work developing inside the buildings and the surrounding Torrey Pines area. The overall intent is to establish a "prestigious corporate image" for Campus Point and be of the highest standard of "green architecture." Figures 1 through 14 demonstrate the basic architectural intent by using examples of the existing buildings. Campus Point illustrates world-class, contemporary architecture expected of a facility in this region.

Site Design

The following general guidelines have been incorporated into the site design. They are listed here to guide the refinement of the Campus Point site planning. All reference (Figure 1).

- Building(s) should be sited and designed to maximize solar access and view corridors. Plazas should be located with the thought of sun access and sun shading.
- Pedestrian walkways should be designed to clearly demarcate main building entrances.
- Site elements such as gathering places and points of visual interest are encouraged for the enjoyment of employees and distinction of important area such as plazas and spaces shall comply with the City of San Diego's Landscape Regulations and Standards.
- Parking should be in unobtrusive and convenient locations whenever possible. Surface parking landscaping must conform to the City's Landscape Regulations and Standards.

Building Placement, Massing & General Design

Buildings should generally be located along the boulevard and near parking structures or surface parking areas (Figure 1). Special consideration should be given to building massing and site planning that would maximize open space and views between buildings and surrounding views. Sensitive treatment of landscape, setbacks, building massing, building systems and fenestrations will promote the "prestigious corporate image" intended for Campus Point. Combinations of structural systems and building massing will allow for sufficient flexibility in designing the building to be able to achieve an individual identity within the design concept and architectural objectives established for the project as a whole. All building elevations shall be designed with equal care. Rear and side elevations shall be as refined as the principal elevation with regard to architectural style and detail. Each building may have unique features though be cohesive with the overall development. Building mass may be articulated with offsets, change of planes, and parapet height (Figures 5, 6, & 7). The base of buildings should relate to the pedestrian scale, color, architectural detailing and visual interest.

In order to clearly articulate building entrances and enhance the aesthetic quality of entrances, each building should have a unique and distinct entry using elements such as frames (Figure 5), metal awnings, projecting roof elements (Figure 13), and/or special glazing. All aspects of the entry design should give a sense of arrival and be welcoming at the pedestrian level.

Building Finishes

Building materials should be selected that relate and compliment the materials used in the existing complex, such as concrete, metal, and a variety of glass (Figures 2 thru 13). Use of contrasting materials may be appropriate accents (Figure 4). Special attention should be paid to the selection of sustainable and recycled materials that advance the LEED goals and resource conservation.

Brush Management

Where the full defensible space cannot be provided for buildings within the Brush Management Zone, alternative compliance measures shall be incorporated under authority of the fire chief to achieve a comparable level of protection. Building CP3 will be subject to all CBC 7A requirements. In addition, the structure will need to be further "hardened" by upgrading openings to dual-glazed, dual-tempered panes where dual-glazed, per the CBC 7A.

Glazing / Fenestration

Fenestration treatments should be simple and straight forward to convey a sleek and contemporary image Figures 2, 5, 8, 9, & 11). Building design shall minimize light and glare reflectivity to adjacent roads and buildings through necessary building articulation and selection of exterior building materials. Glazing with an outdoor visible light reflectivity greater than 55% should not be used. A maximum of 50% of the exterior of buildings may be comprised of material with light reflectivity greater than of 30% of Municipal Code. Glazing in colors and level of transparency that harmoize with the overall existing color palette should be utilized. Mullions may be expressed in a variety of ways where details might be highly expressed. minimized, and/or directional on a horizontal or vertical plane.

Parapet / Roof

Parapet articulation should fit the contemporary architectural style of the existing buildings (Figures 6 & 7). Facade glazing may extend above the roof line as an extension of the facade and be of the correct opacity to obsure all structural and mechanical elements. Lighting and signage may be used on the upper portion of the buildings(s) in ways not to overpower the overall building design and reflect the quality of materials. Roofs are appropriate for sustainable features such as water reclamation, photovoltaic panels, and solar reflectance to minimize the "heat island affect". The addition of roof mounted solar arrays should be treated as an integral design element that compliments the overall building design. All other roof top equipment shall be screened and integrated into the building design (Figure 12).

Screening

Exterior screens are vital to the articulation of facades, roofs and overall design, Screens shall be of superior quality and may be used in a variety of methods for visual interest (Figures 11 & 13). Metal screens may be used to protect the buildings from solar heat gain and aesthetically contribute to the overall design.

Outdoor Activities

The landscape site design endeavors to enhance the social, environmental and aesthetic qualities of the Campus. The master plan provides employees with ample outdoor amenities at a variety of scales. Each building has an associated outdoor gathering area suitable for small to medium size meetings and events. Additionally, intimate garden and tree-shaded spaces are provided adjacent to each building for breaks or outdoor

Parking Structure

The parking structure shall be designed to complement the surrounding buildings. Structures will be made of concrete and shall utilize architectural articulation to screen parked vehicles on all sides. Examples include, but are not limited to, vegetative, perforated metal panel, light-weight metal structure, wood, glass and concrete. Top levels of parking structures that are open to the sky shall meet surface landscape requirements for shade over parking. (Figure 14). Structures shall be designed to be efficient and cohesive with the overall design of Campus Point. Use of parking ramps in encouraged in lieu of speed ramps for a more efficient structure and small building footprint.

Loading and Utilities

Loading areas when located on-grade shall be designed to be unobtrusive or screened from view. Mechanical equipment shall be placed within structures or screened from view

The style of light fixture and its quality of light will have a dramatic influence on the appearance of the campus. Particular attention should be paid to the comparibility of light fixtures and lamp types both throughout the site as well as on the buildings. To ensure design unity within the project a consistent lighting theme is recommended.

See Landscape sheets for landscape design and Brush Managment.

Signage shall comply with City of San Diego Standards.





Project Name

CAMPUS POINT SITE DEVELOPMENT PERMIT

DESIGN GUIDELINES

A4.01

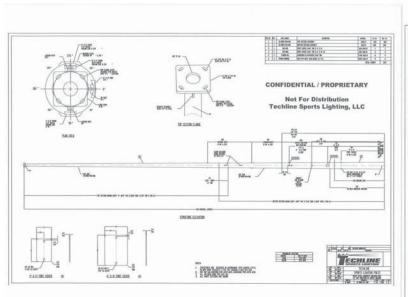

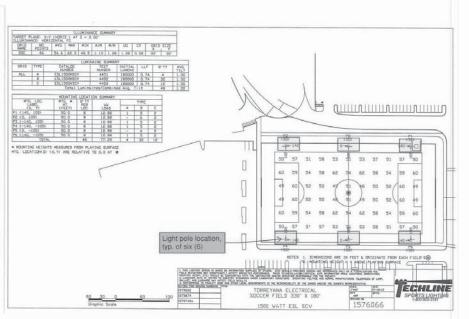

Steven Schrader

Steven Schrader Friday, October 23, 2015 3:27 PM

Importance:

Good Afternoon, Mr. Lias & Ms. Camper,

The location of the proposed soccer field is immediately west of the building located at 10290 Campus Point Drive; and immediately south of the building located at 10300 Campus Point Drive.

Please see attached overall master plan (in-process), indicating the two existing buildings/addresses well as a current Google Earth image showing the proposed soccer field location (yellow-highlighted

In addition to the site images noted above, I have attached copies of a field lighting photometric plan, illustrating the locations of six (6) 50-foot high poles. Each pole will be outfitted with eight (8) 1500-watt metal halide luminaires, directed downward onto the field plane, each including the optional cut-off visor shown in the attached Light Pole Cutsheet. Ballast Lamp Technical document.

On behalf of our Client, we are submitting this information and requesting a courtesy review by your office. We would like your office to confirm whether or not the proposed installation of six (6) 50-foot high poles & fixtures pose any problems related to McAS operations (i.e., fixtures height, sighting levels/glare at night, etc.). Any feedback you can offer at this time will be greatly appreciated.

Should you have any questions, or require additional information, please do not hesitate to call or write.

Steven T. Schrader, AIA +1 619.557.2509 Direct +1 619.557.2500 Main +1 619.905.4590 Mobile

Gensler 225 Broadway Suite 1600 San Diego, California 92101 USA



EOUITIES 10996 Torreyana Road Suite 250 San Diego, CA 92121


CAMPUS POINT SITE DEVELOPMENT PERMIT


10290 &10300 CAMPUS POINT DRIVE SAN DIEGO, CA 92112


Gensler

△ Date

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11/30/2015	CYCLE 27	HR/BH	SS
04/01/2016	CYCLE 32	JB/KD	SS
06/24/2016	CYCLE 35	JB/KD	SS
08/24/2016	CYCLE 38	KD	SS
09/29/2016	CYCLE 41	KD	SS

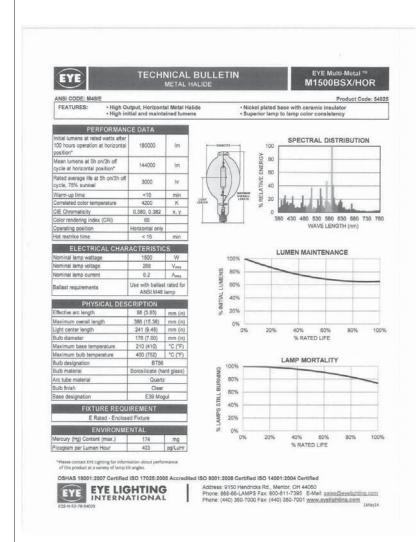Issue/Revision

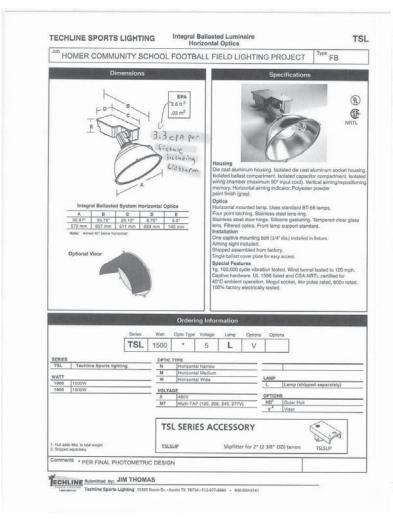
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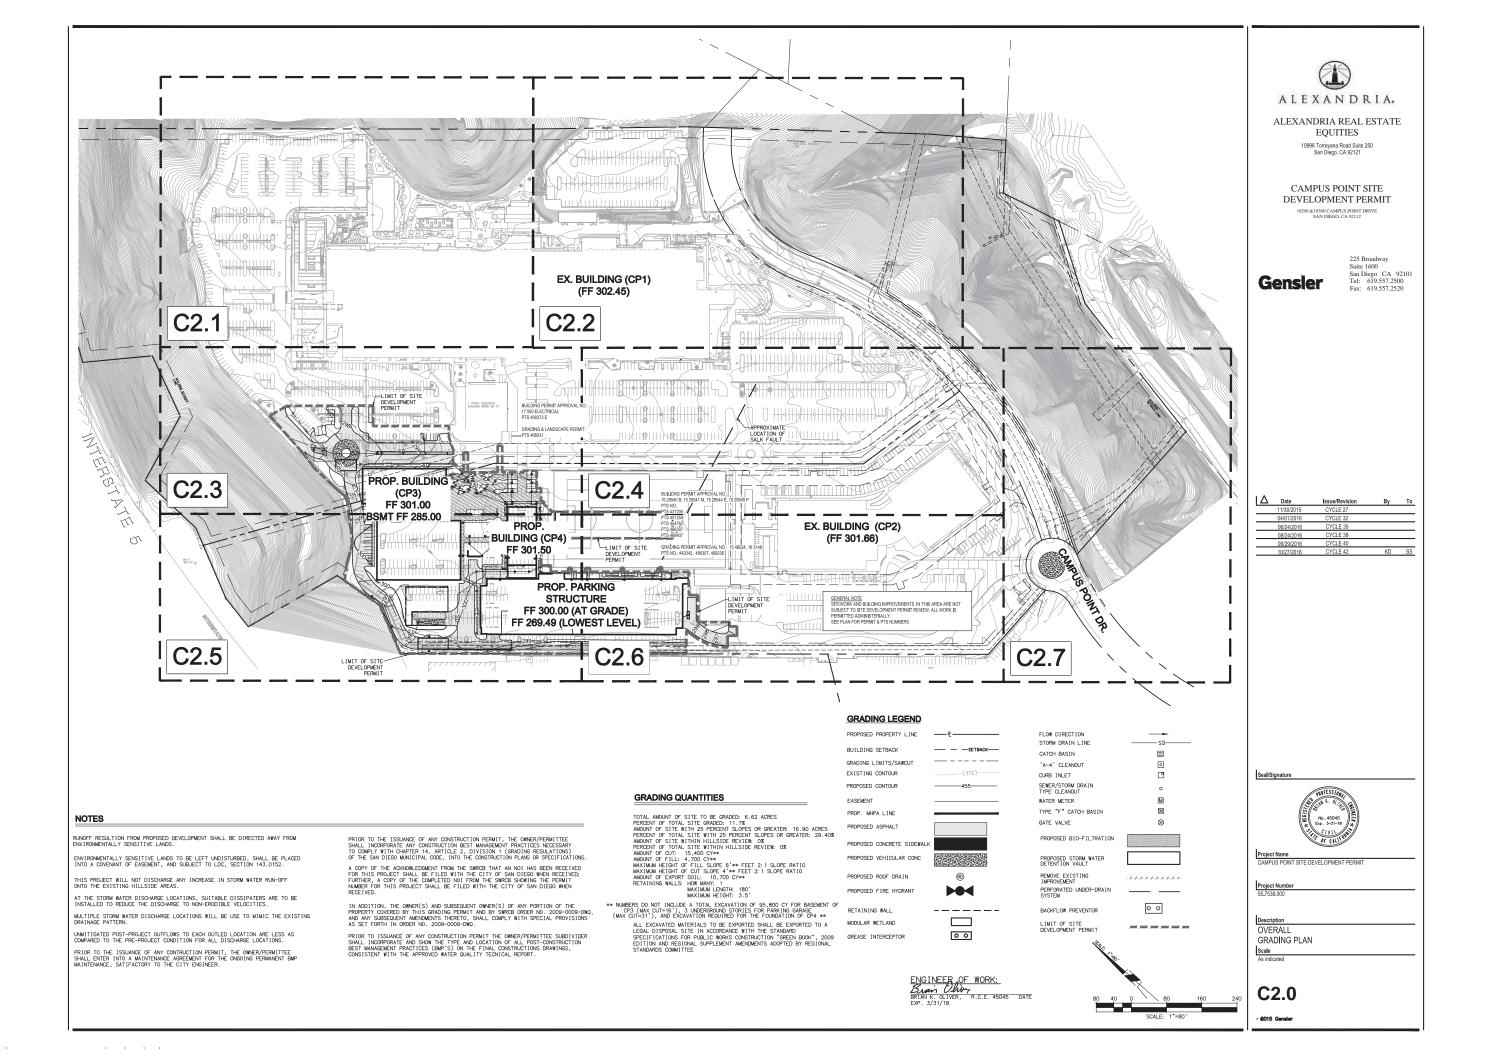


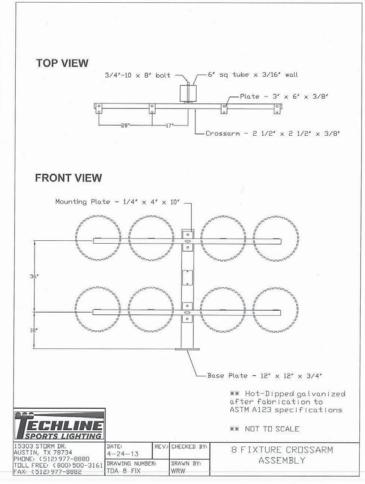
Project Name
CAMPUS POINT SITE DEVELOPMENT PERMIT

SOCCER FIELD LIGHTING AND DATA

A4.02




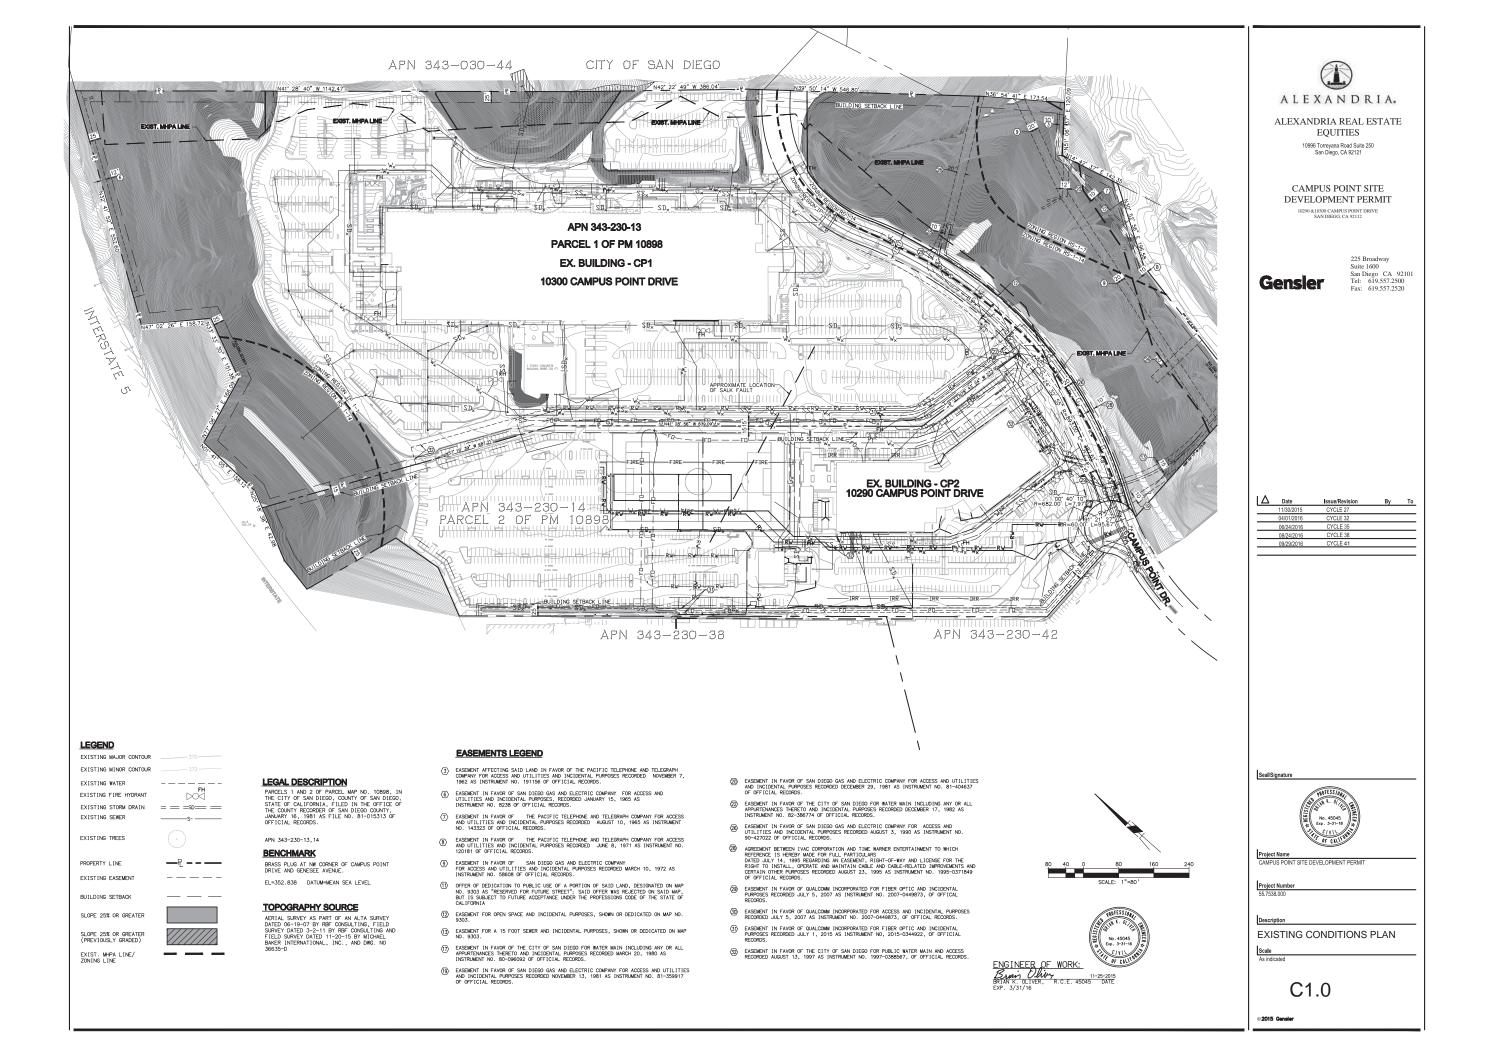


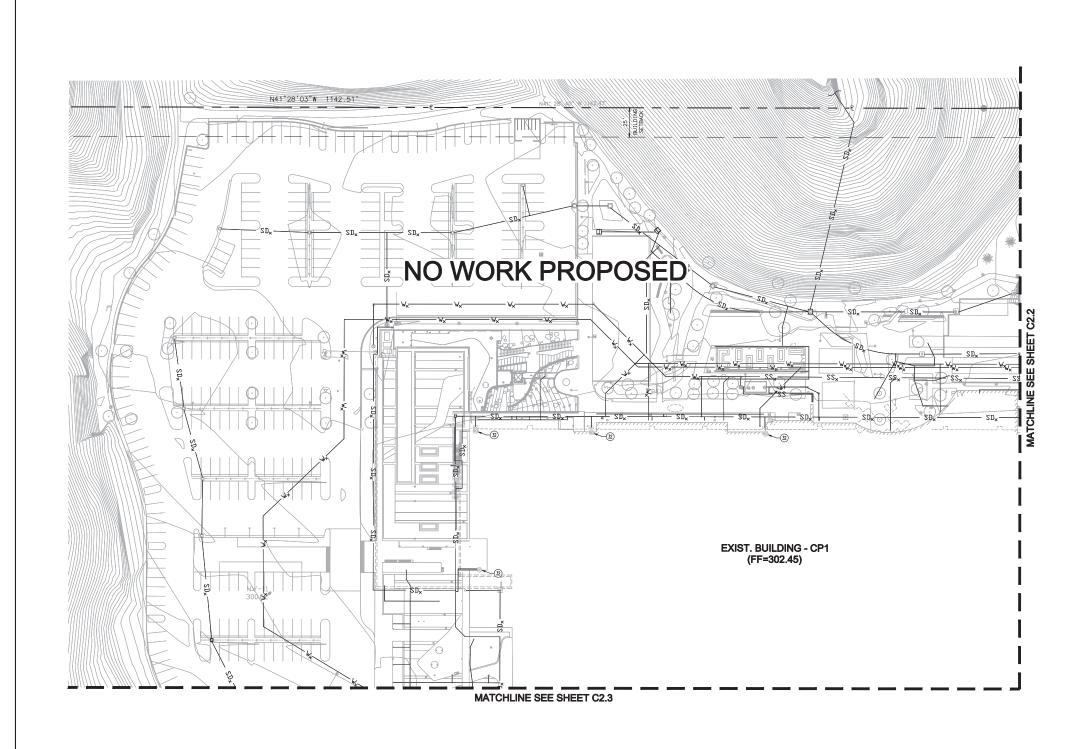


CONSTRUCTION NOTES

@ existing roof drain

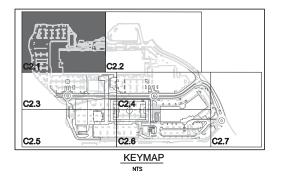

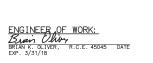

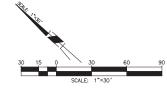

PRIOR TO ISSUANCE OF ANY CONSTRUCTION PERMIT, THE APPLICANT SHALL SUBMIT A TECHNICAL REPORT THAT WILL BE SUBJECT TO FINAL REVIEW AND APPROVAL BY THE CITY ENGINEER, BASED ON STORM MATER STANDARDS IN EFFECT AT THE TIME OF THE CONSTRUCTION PERMIT ISSUANCE.



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	11/30/2015	CYCLE 27		
	04/01/2016	CYCLE 32		
	06/24/2016	CYCLE 35		
	08/24/2016	CYCLE 38		
	09/29/2016	CYCLE 41		

Seal/Signature



Project Name

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Project Number


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GRADING PLAN

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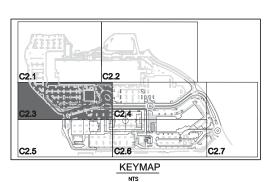
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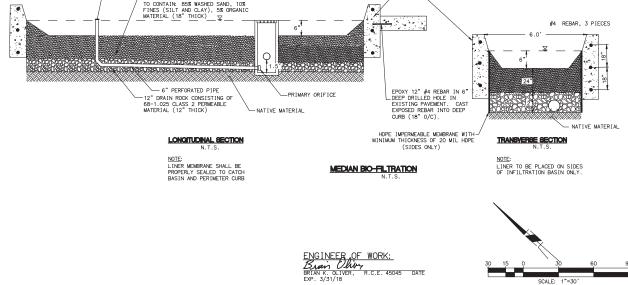
ALEXANDRIA. ALEXANDRIA REAL ESTATE MATCHLINE SEE SHEET C2.1 **EQUITIES** 10996 Torreyana Road Suite 250 San Diego, CA 92121 EXIST. BUILDING - CP1 (FF=302.45) CAMPUS POINT SITE DEVELOPMENT PERMIT 225 Broadway Suite 1600 San Diego CA 92101 Tel: 619.557.2500 Fax: 619.557.2520 Gensler 1 STORY CONCRETE BUILDING 8980 SQ FT 25 MATCHLINE TO TO EX FOR EXE STORM WATER CP3 PROP. BUILDING FF 301.00 BASEMENT FF 285.00 09/29/2016 FF 301.50 MATCHLINE SEE SHEET C2.5 #4 REBAR, 3 PIECES CONSTRUCTION NOTES 1 LIMIT OF GRADING/ LIMIT OF WORK/ SAWCUT LINE 2 CATCH BASIN 3 SEWER-TYPE STORM DRAIN CLEANOUT (SDCO) 5 VEHICULAR CONCRETE PAVEMENT Seal/Signature

NOTE:

1. PRIOR TO ISSUANCE OF ANY CONSTRUCTION PERMIT, THE APPLICANT SHALL SUBMIT A TECHNICAL REPORT THAT WILL BE SUBJECT TO FINAL REVIEW AND APPROVAL BY THE CITY ENGINEER, BASED ON STORM WATER STANDARDS IN EFFECT AT THE TIME OF THE CONSTRUCTION PERMIT ISSUANCE.

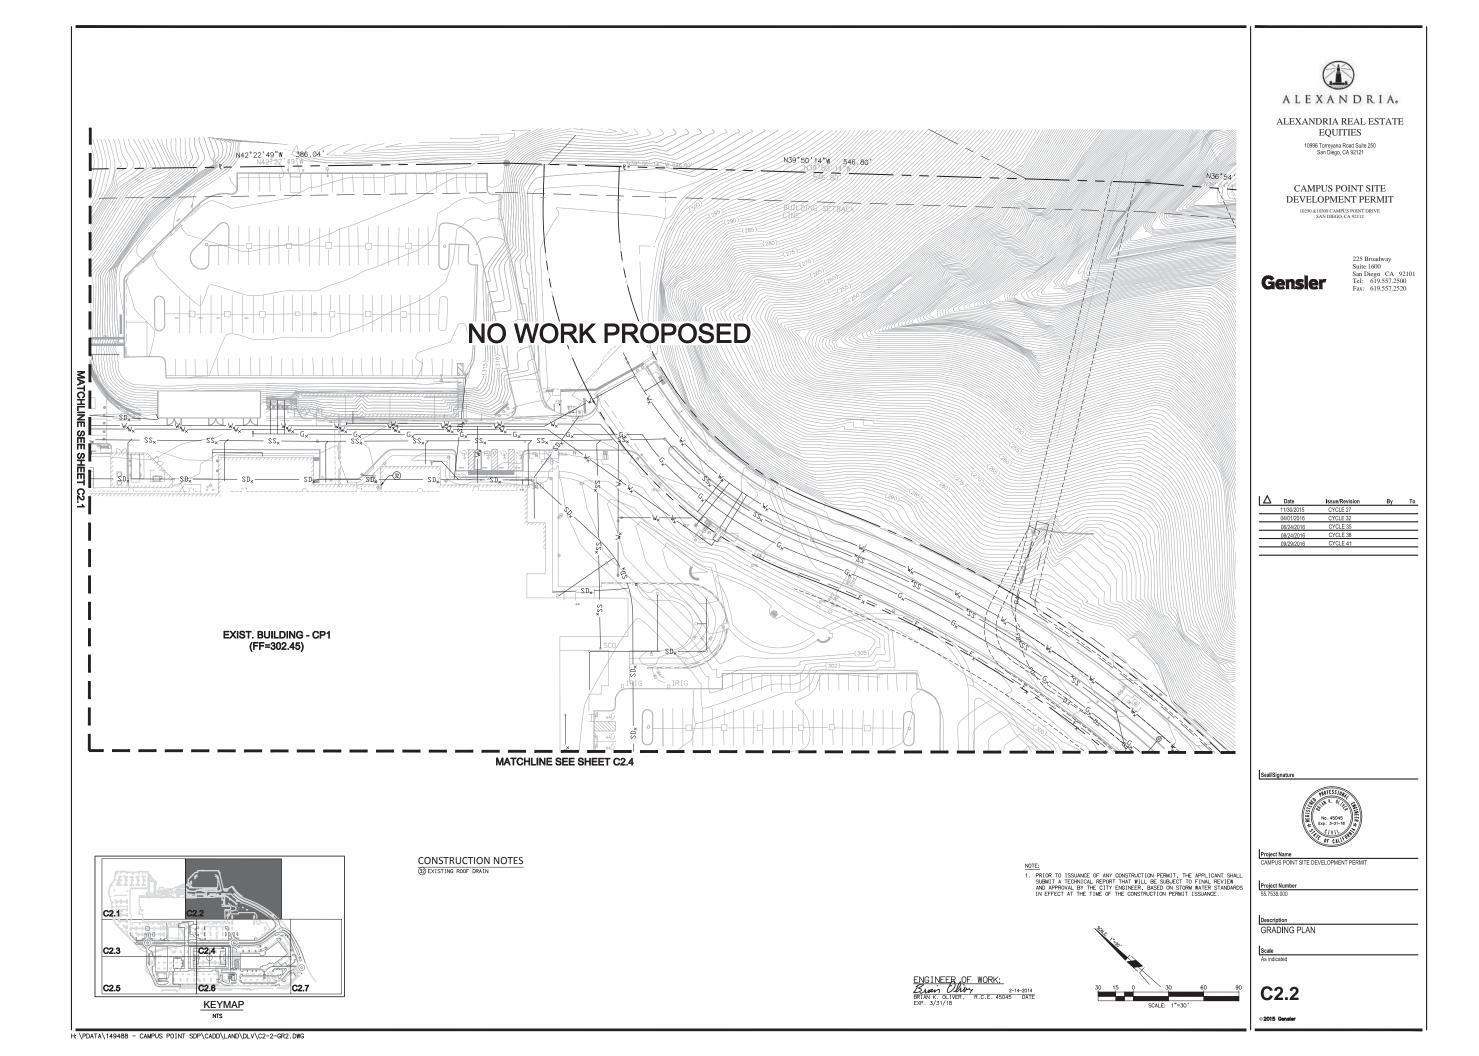



SEMER-TYPE STORM DRAIN CLEANOUT (SDCO)
 VEHICULAR CONCRETE PAVEMENT
 AC PAVEMENT
 CONCRET SIDEWALK
 CONNECT TO EX STORM DRAIN
 CONNECT TO EX STORM DRAIN
 CONSINLET
 MEDIAN BIO-FILTRATION PER DETAIL SHEET C2.3
 STORM WATER SURGE TANK
 ROOF DRAIN
 EXISTING ROOF DRAIN
 SINFILTRATION BASIN PER DETAILS ON SHEET C2.4





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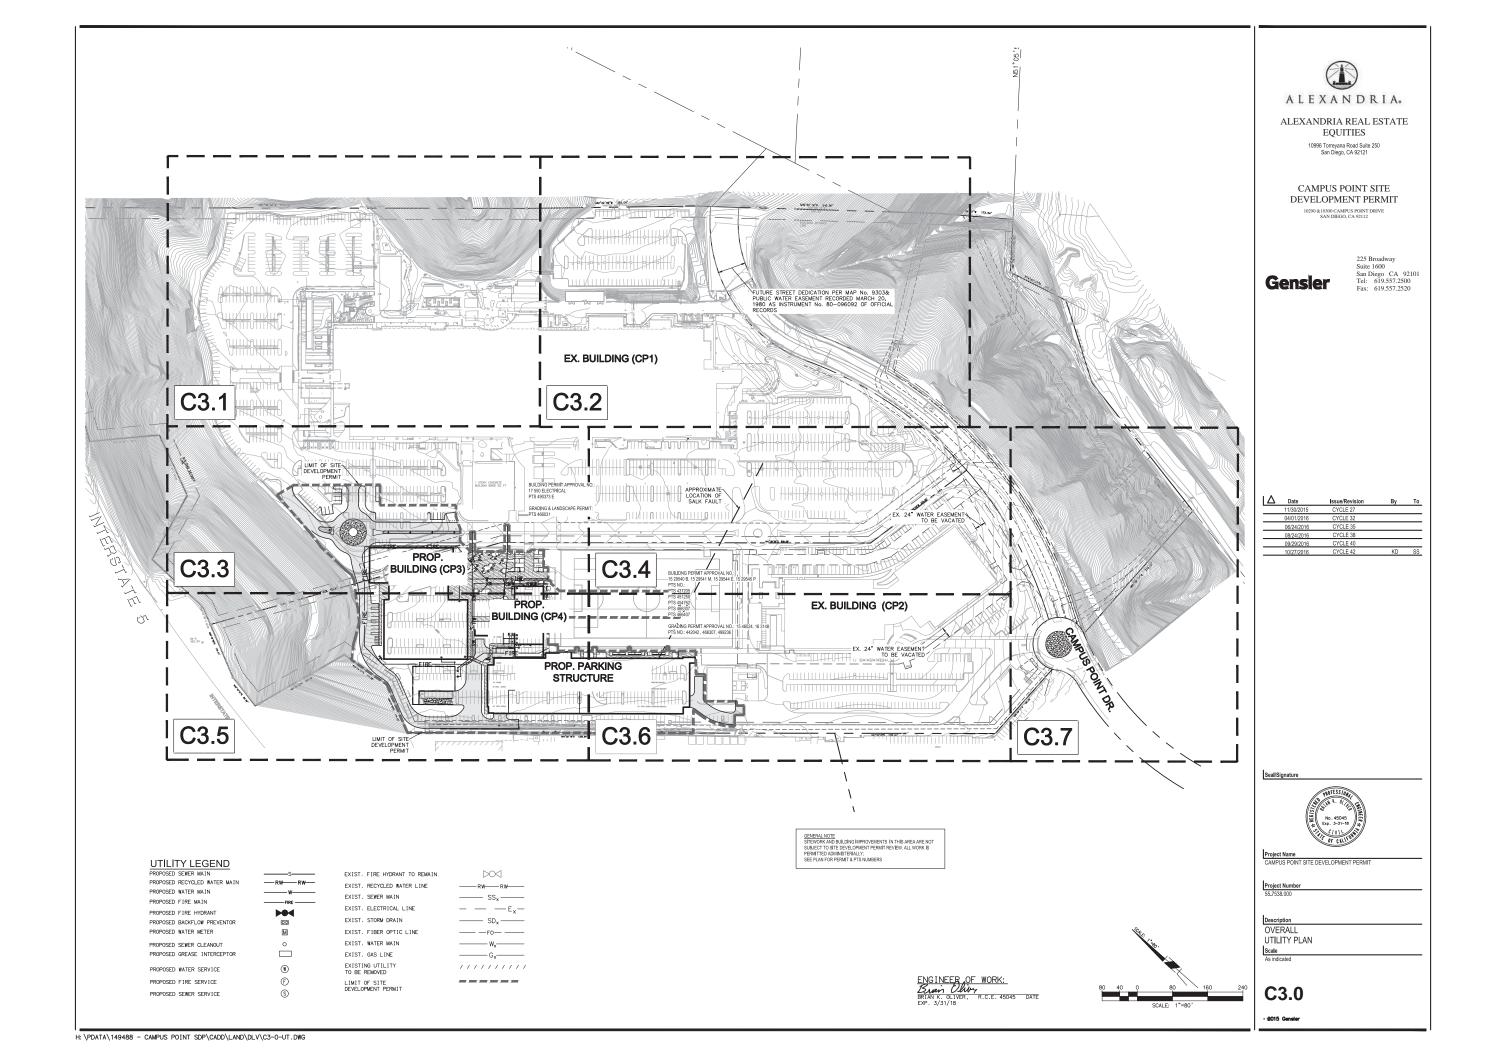
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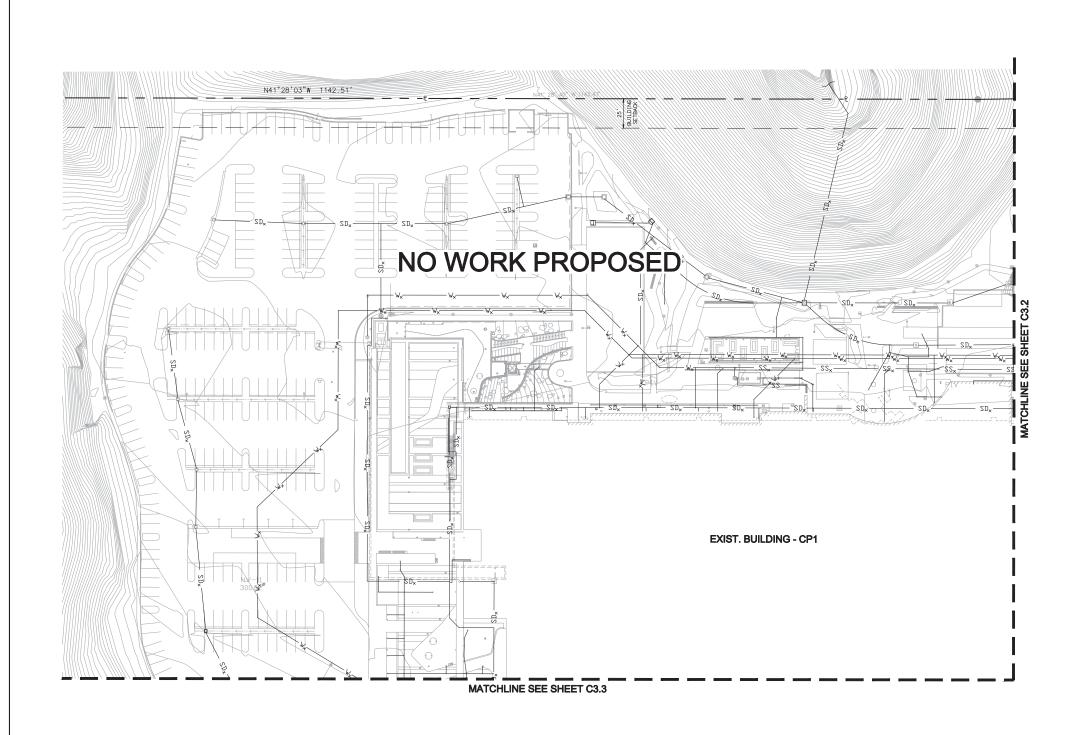





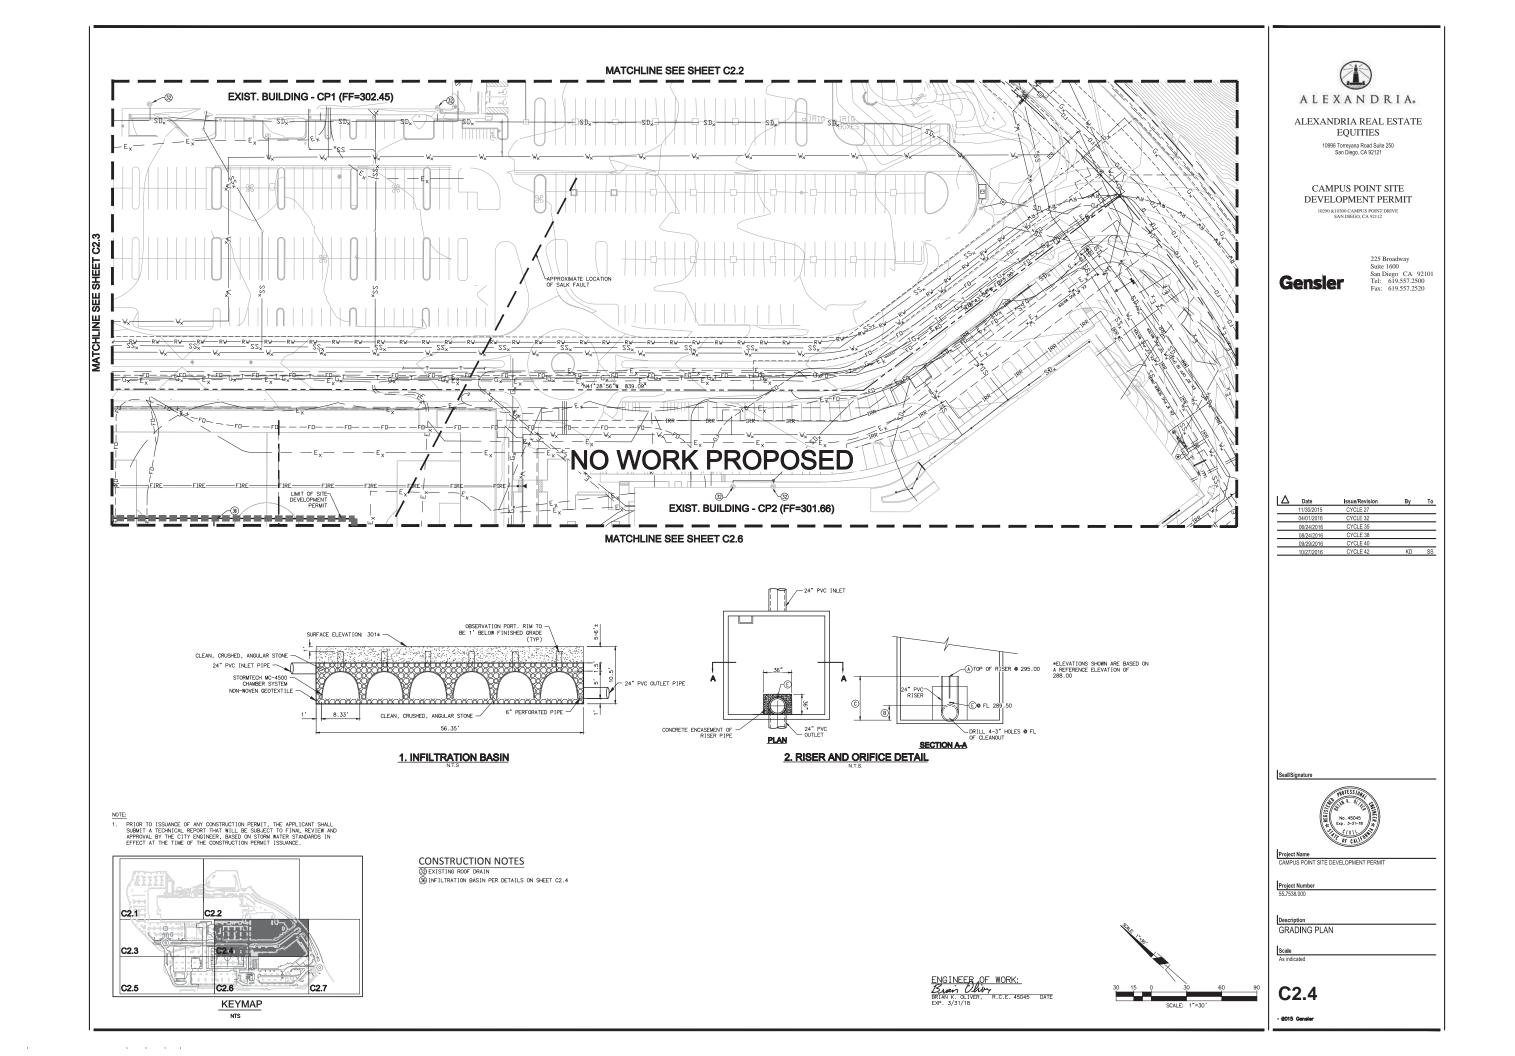


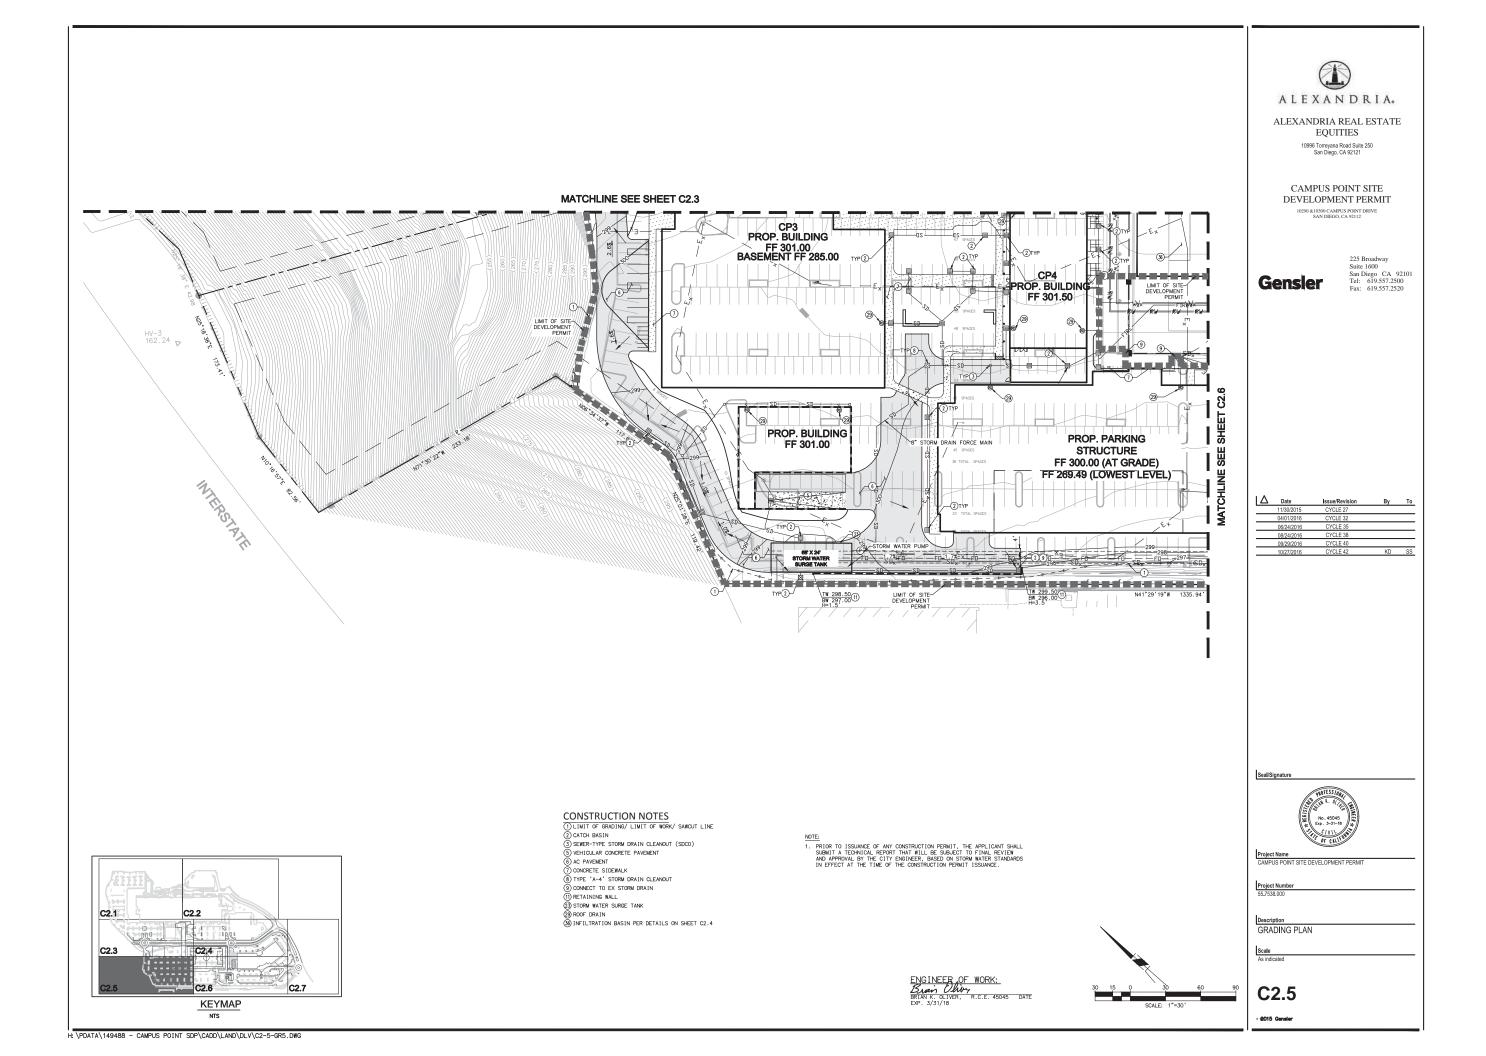


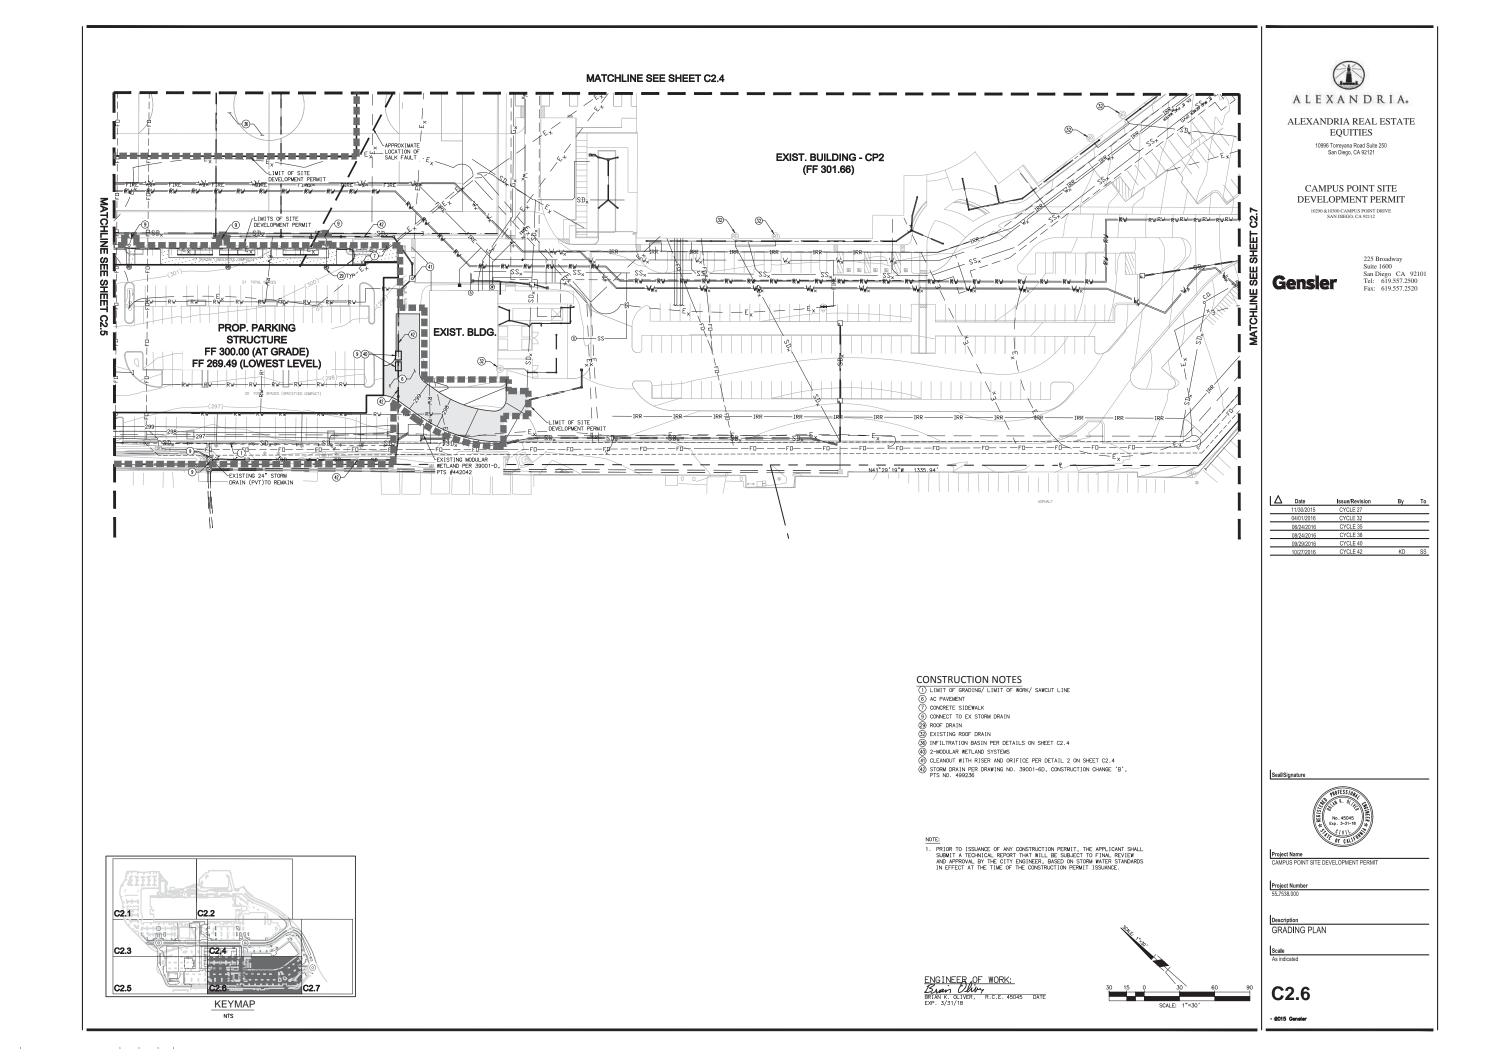

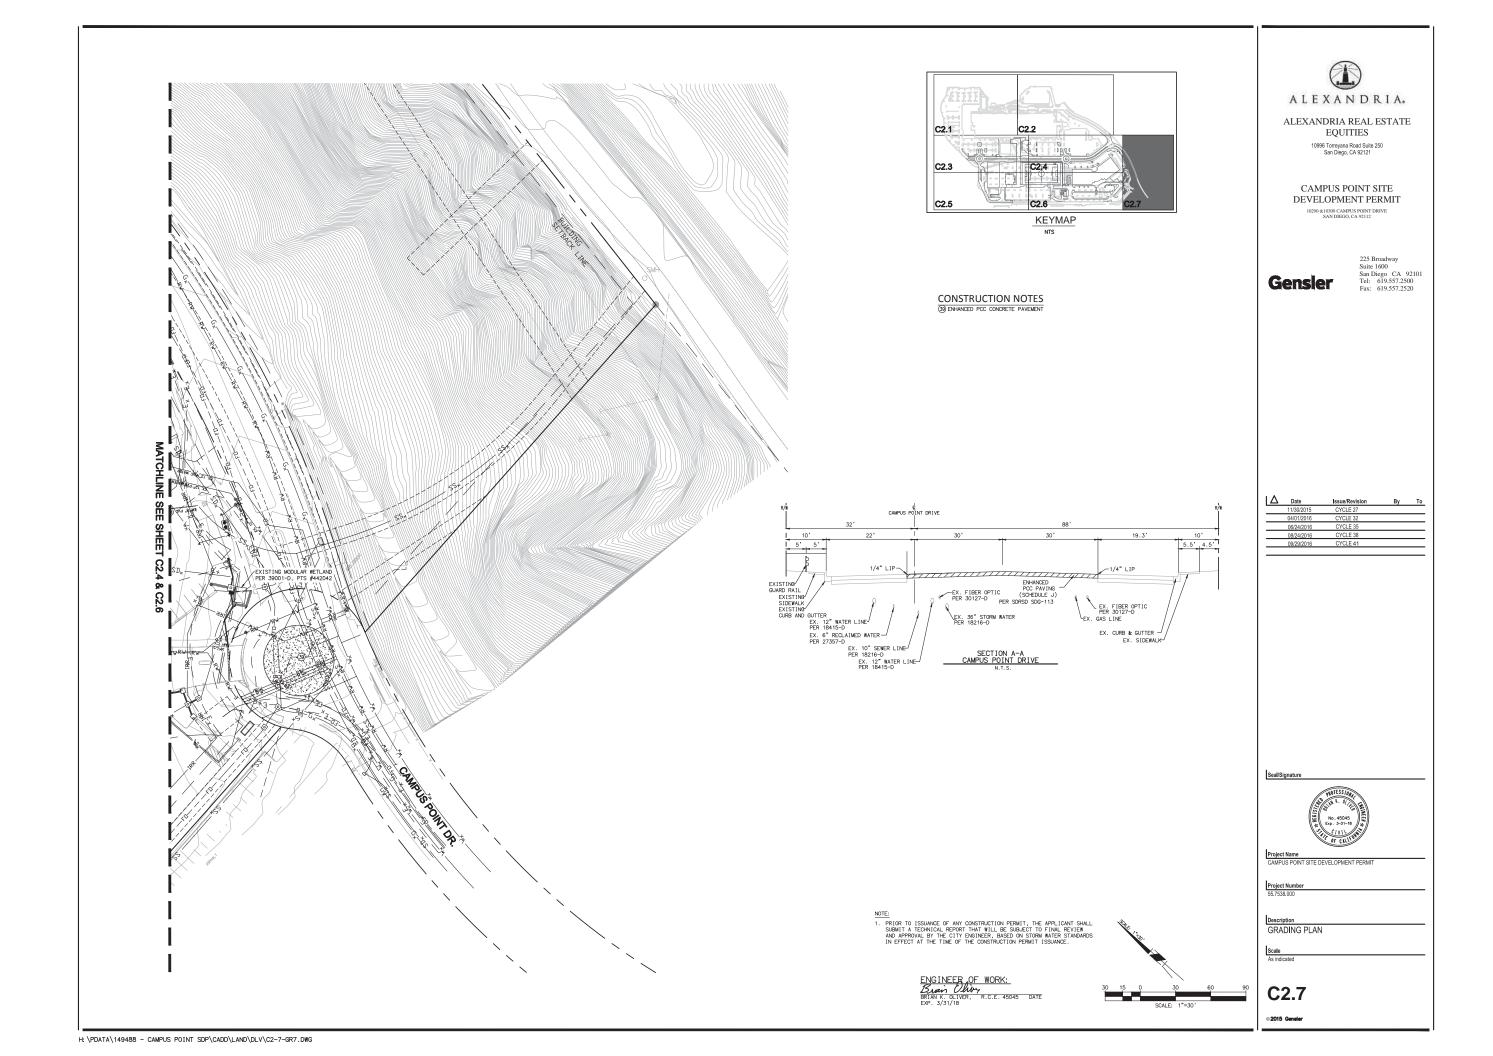

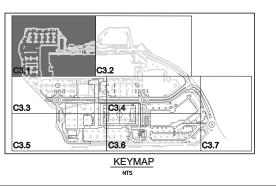

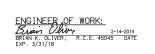

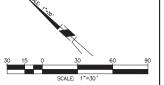



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	06/24/2016	CYCLE 35		
	08/24/2016	CYCLE 38		
	09/29/2016	CYCLE 41		

Seal/Signature



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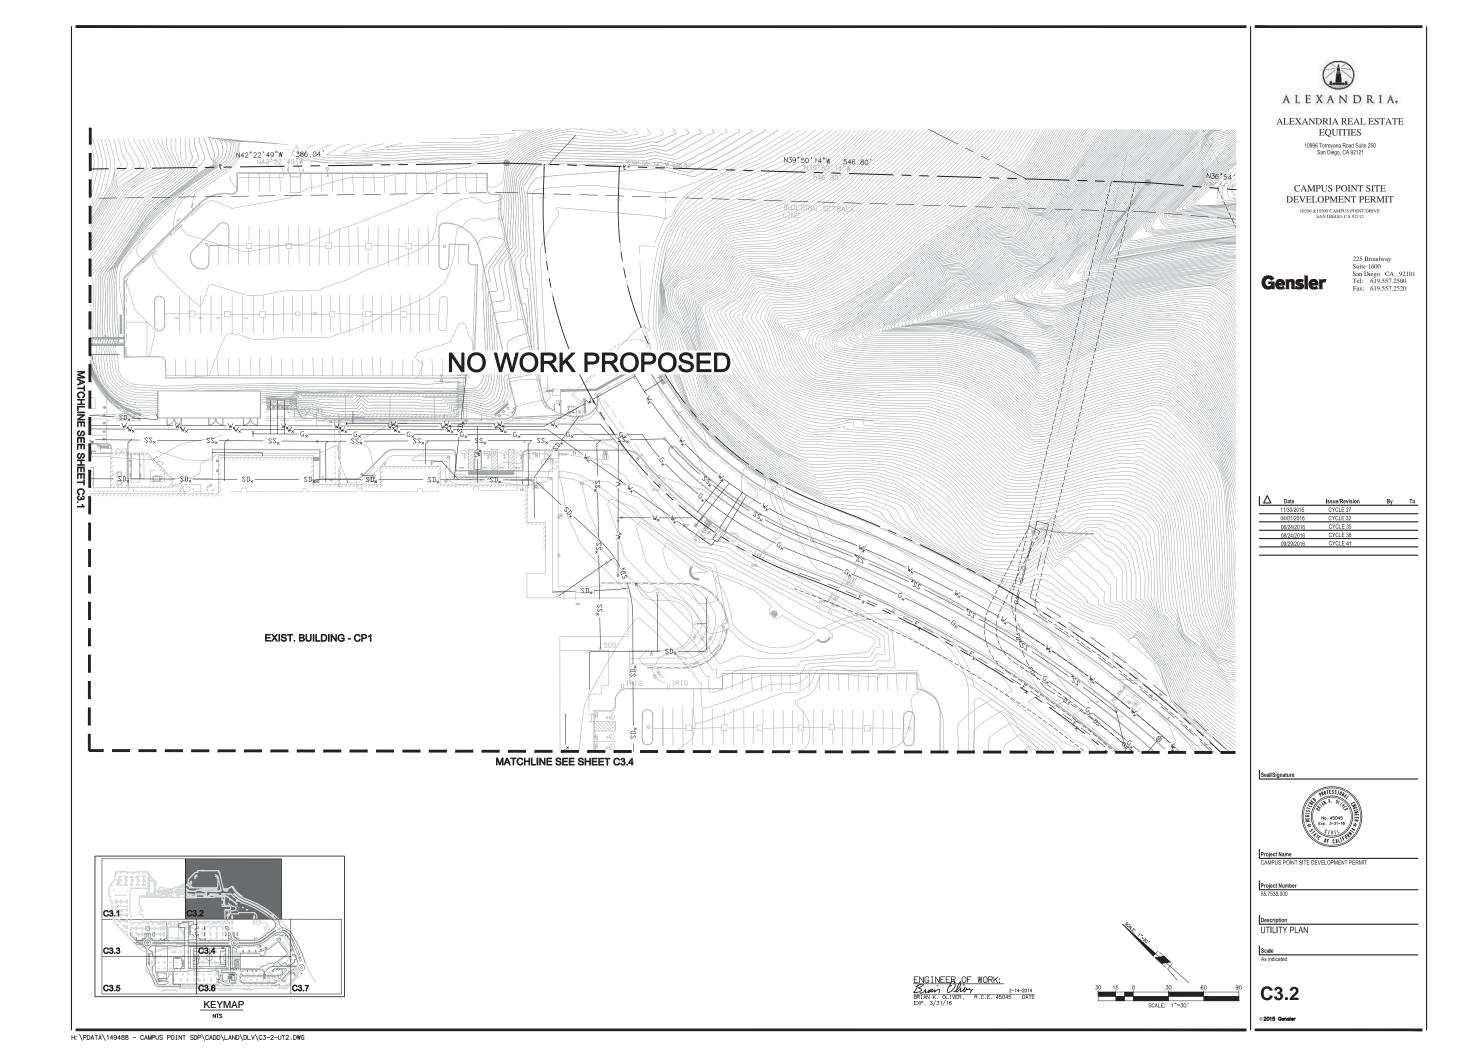
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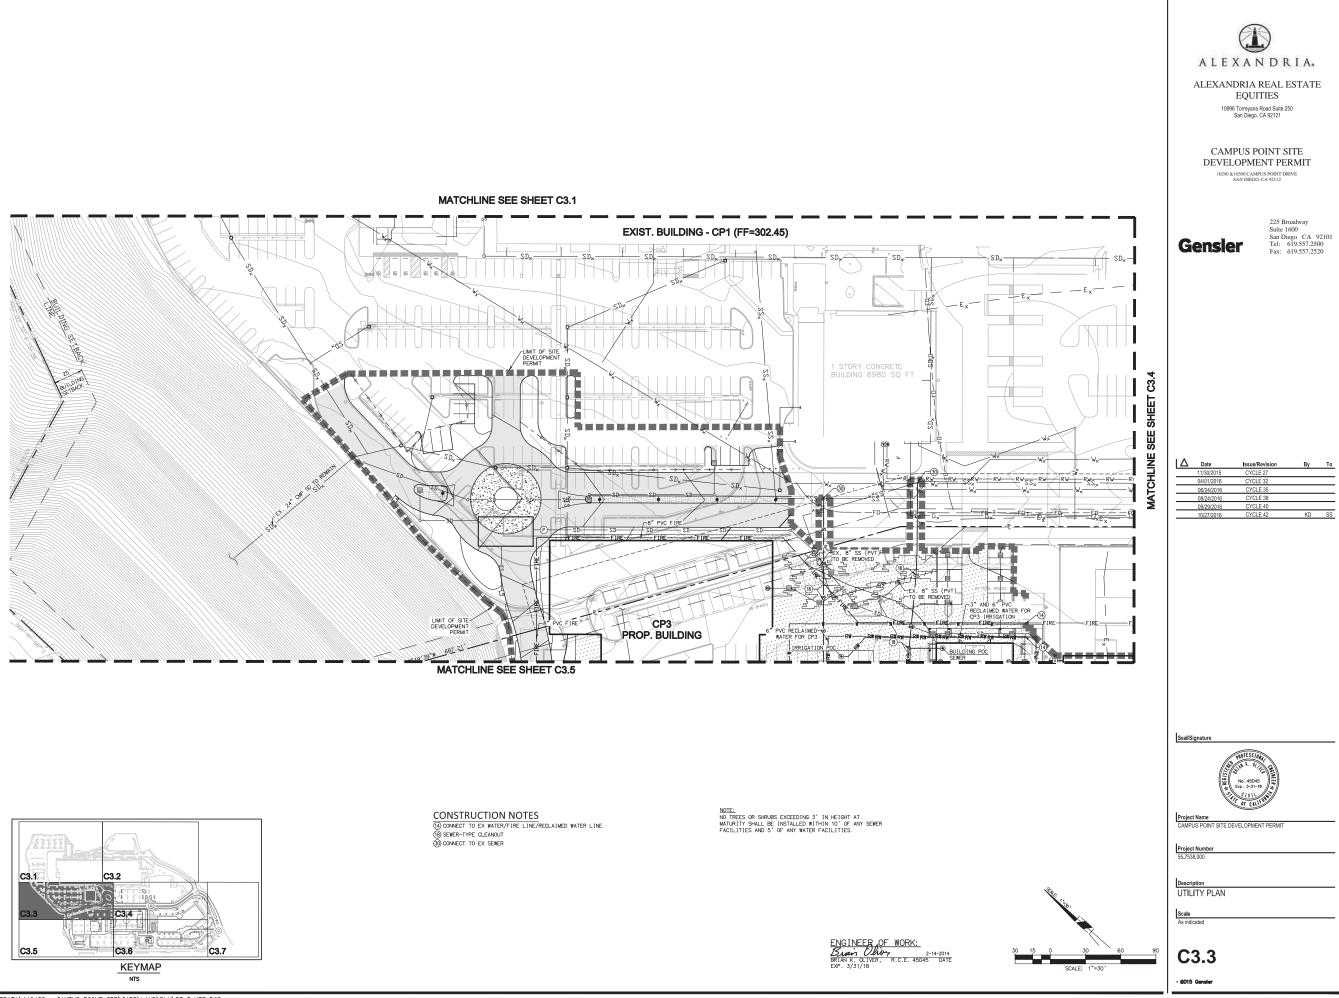
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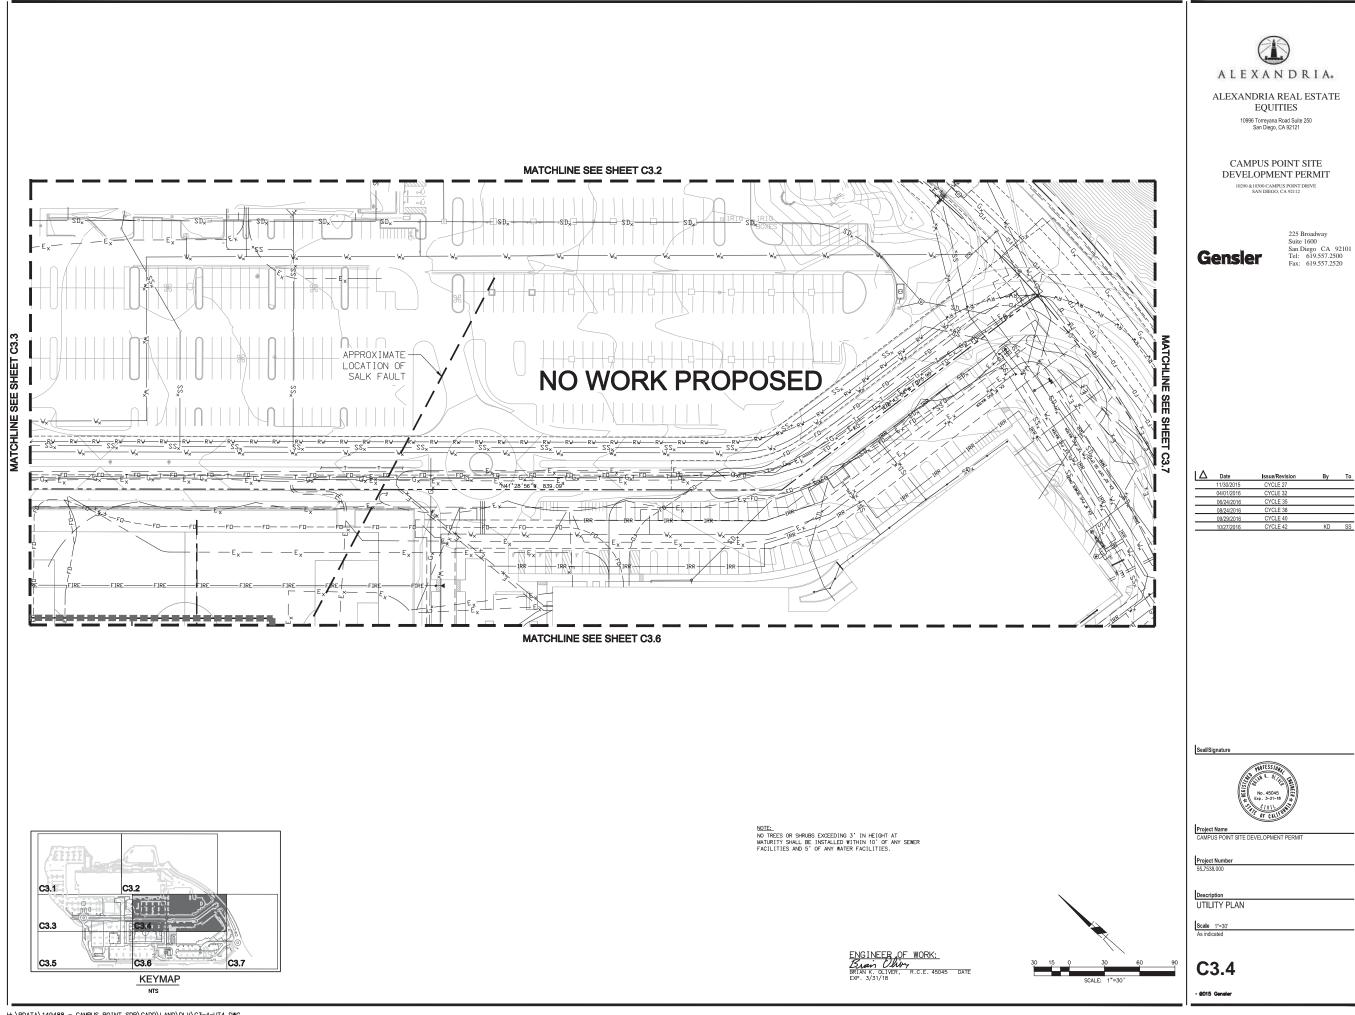
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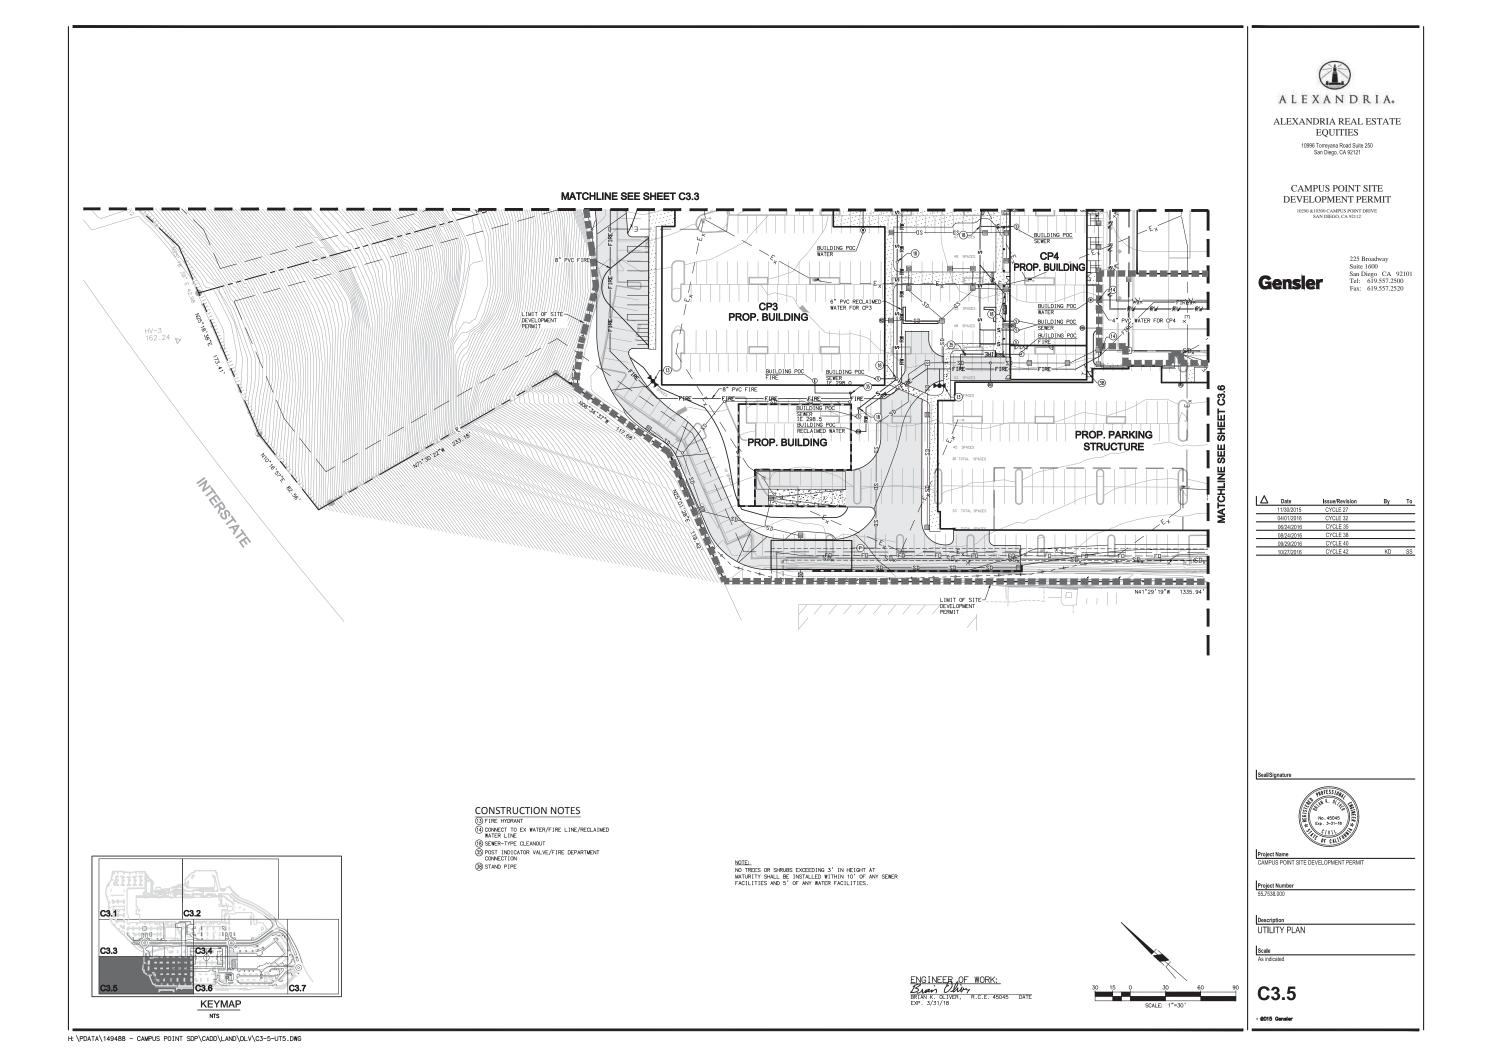
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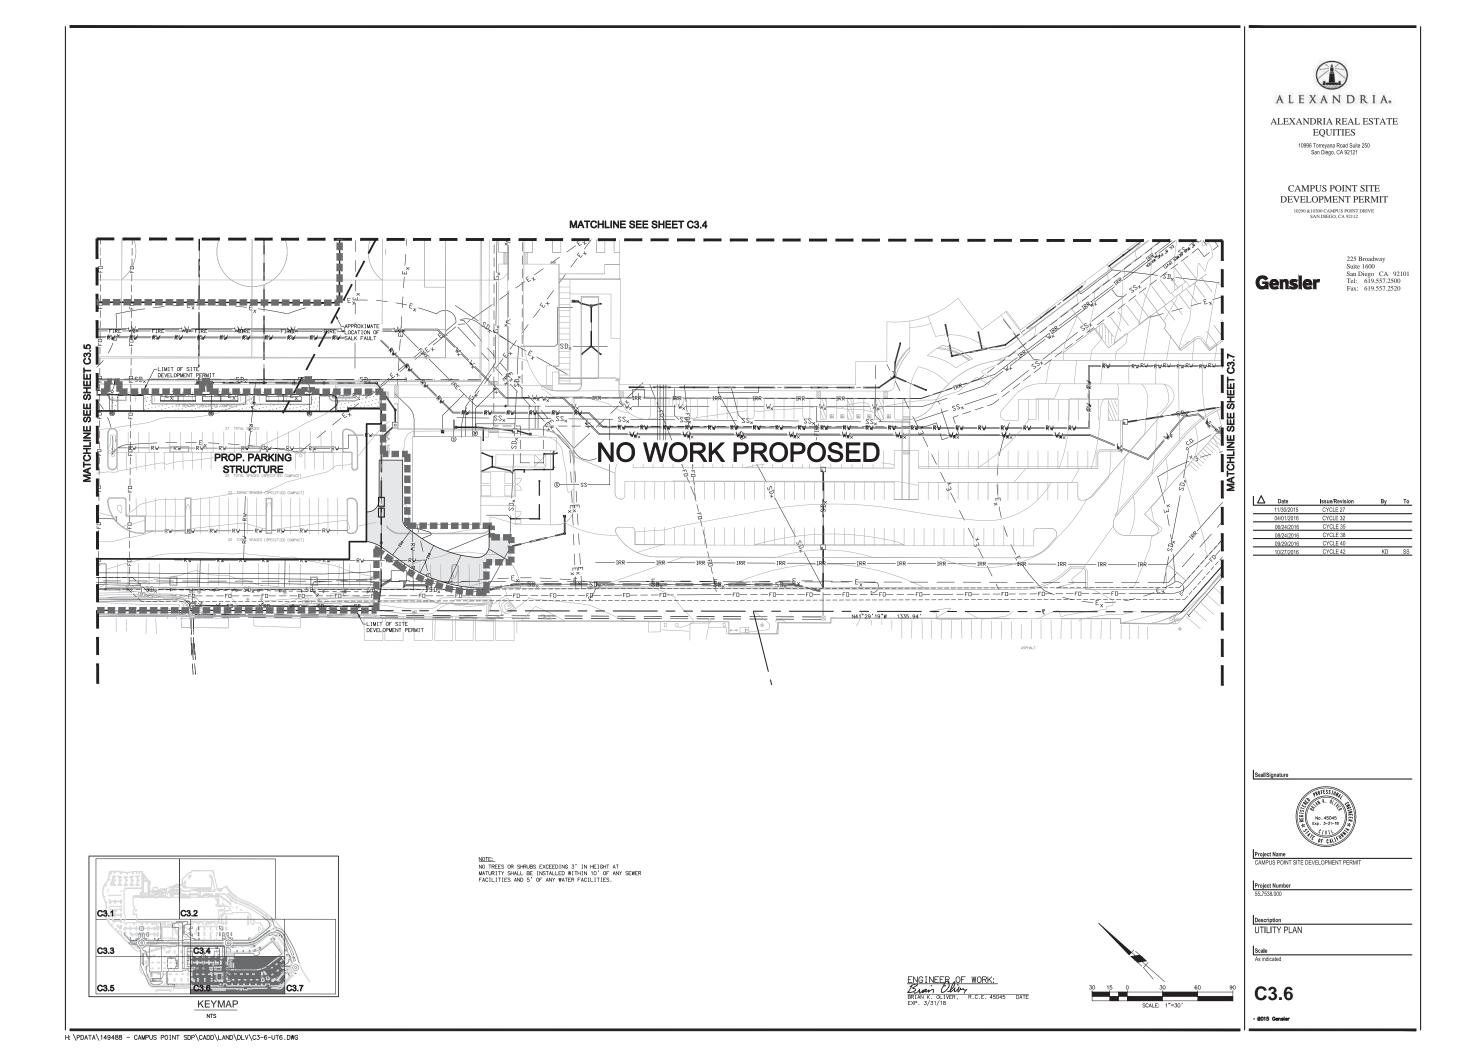
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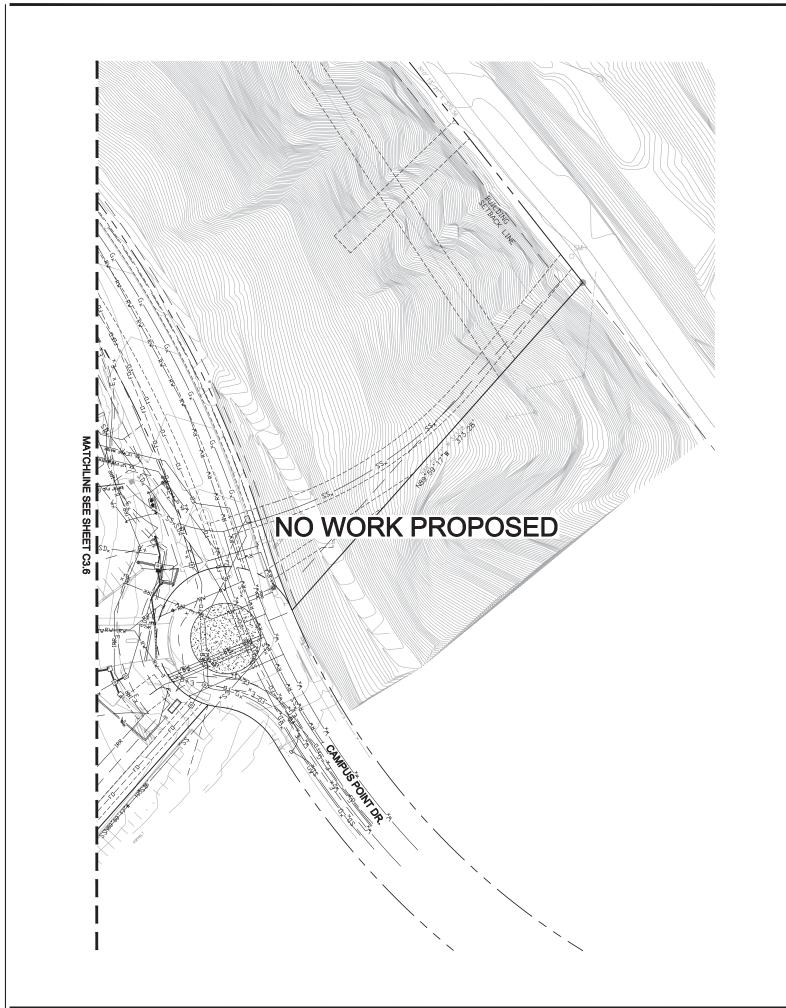













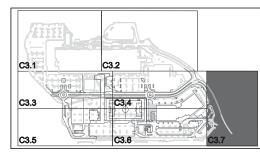

KEYMAP

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A L E X A N D R I A.

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	04/01/2016	CYCLE 32		
	06/24/2016	CYCLE 35		
	08/24/2016	CYCLE 38		
	09/29/2016	CYCLE 41		

NOTE: NO TREES OR SHRUBS EXCEEDING 3' IN HEIGHT AT MATURITY SHALL BE INSTALLED WITHIN 10' OF ANY SEWER FACILITIES AND 5' OF ANY WATER FACILITIES.

ENGINEER OF WORK:

BLIAN CULVER, R.C.E. 45045 DATE
EXP. 3/31/18



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Project Name

CAMPUS POINT SITE DEVELOPMENT PERMI

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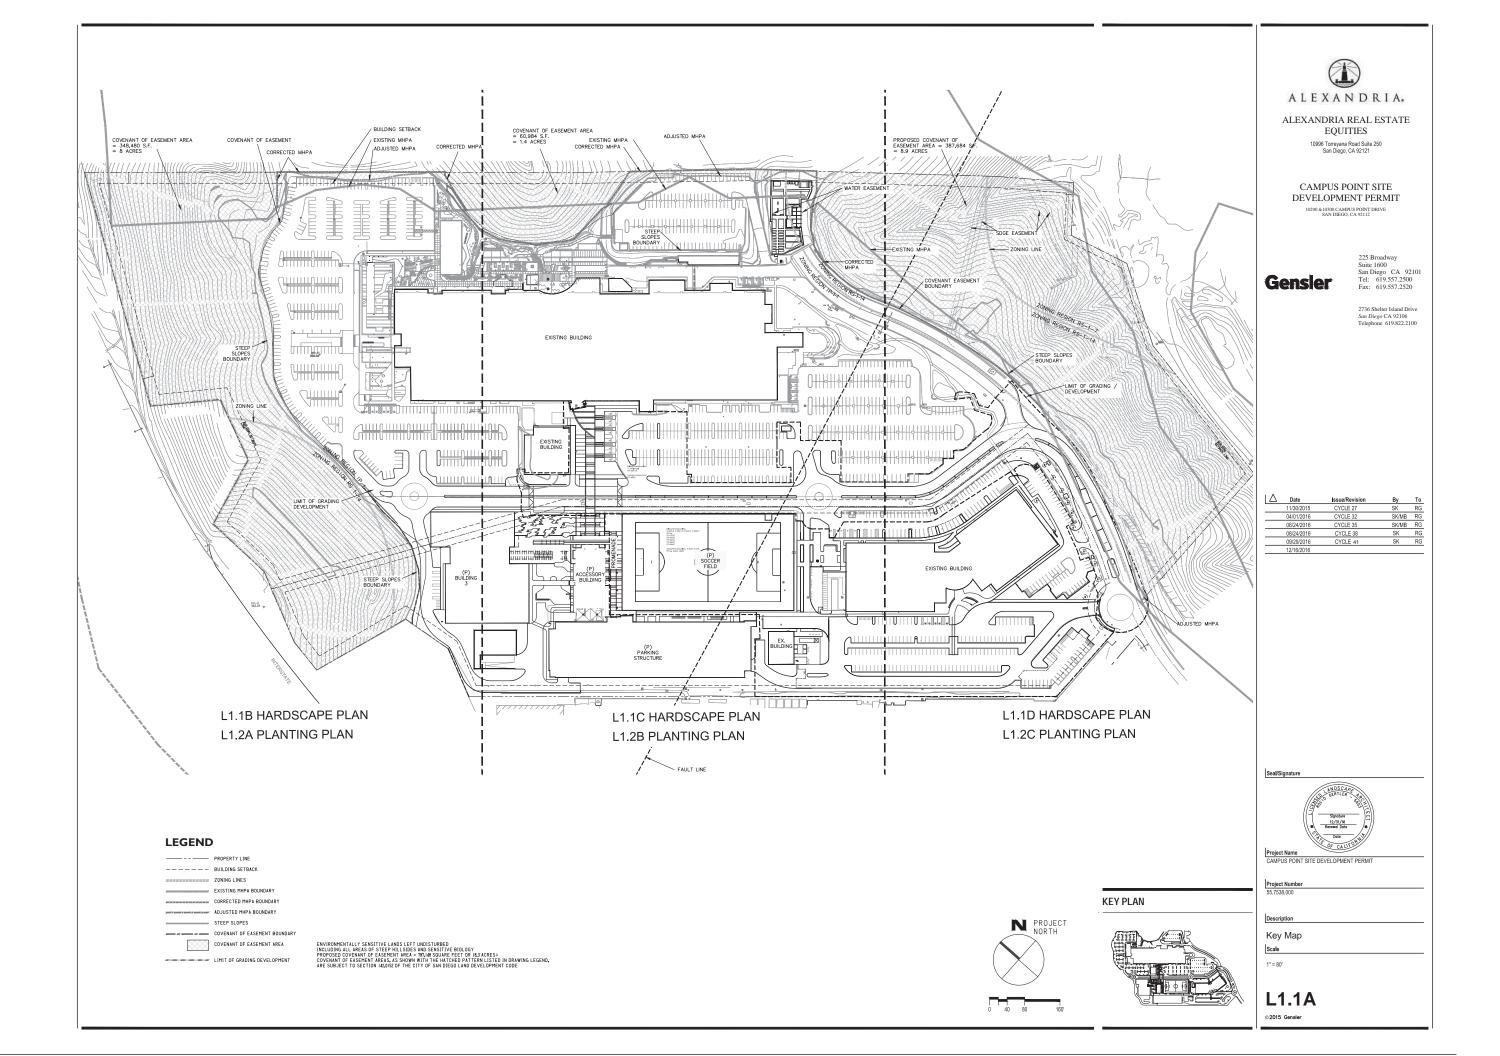
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UTILITY PLAN


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HARDSCAPE LEGEND

CORRECTED MHPA BOUNDARY ADJUSTED MHPA BOUNDARY

	HARDSCAPE	DESCRIPTION
	PAVING/CURB/HEADER/EDGING	
	ENHANCED PAVING, TYPE I	C.I.P. INTEGRAL COLOR CONCRETE W/ EXPOSED AGGREGATE OR TOPSEEDED AGGREGATE FINISH
:	ENHANCED PAVING, TYPE 2	C.I.P. INTEGRAL COLOR CONCRETE W/ SEEDED, QUARRY STONE OR EXPOSED AGGREGATE FINISH
	ENHANCED PAVING, TYPE 3	C.I.P. INTEGRAL COLOR CONCRETE W/ SEEDED, QUARRY STONE OR EXPOSED AGGREGATE FINISH
	PAVING, TYPE 4	C.I.P. STANDARD GRAY CONCRETE W/ BROOM OR QUARRYSTONE FINISH
	PRECAST CONCRETE PAVER	PRECAST CONCRETE PAVER, PEDESTRIAN 60MM, VEH 80MM
	STABILIZED DG PAVING	STABILIZED DECOMPOSED GRANITE PAVING
	ASPHALT PAVING	PER CIVIL
	EXISTING ASPHALT	PER CIVIL
	EXISTING P.I.P POROUS PAVING WITH TURF FOR FIRE TRUCK ACCESS	GRASSCRETE PAVING TO MEET FIRE DEPARTMENT STANDARDS
	P.I.P POROUS PAVING WITH DG FOR FIRE TRUCK ACCESS	GRASSCRETE PAVING TO MEET FIRE DEPARTMENT STANDARDS
	EXISTING PAVING TO REMAIN	
	PROPERTY LINE	
	BUILDING SETBACK	
100000000000	EXISTING MHPA BOUNDARY	



ALEXANDRIA.

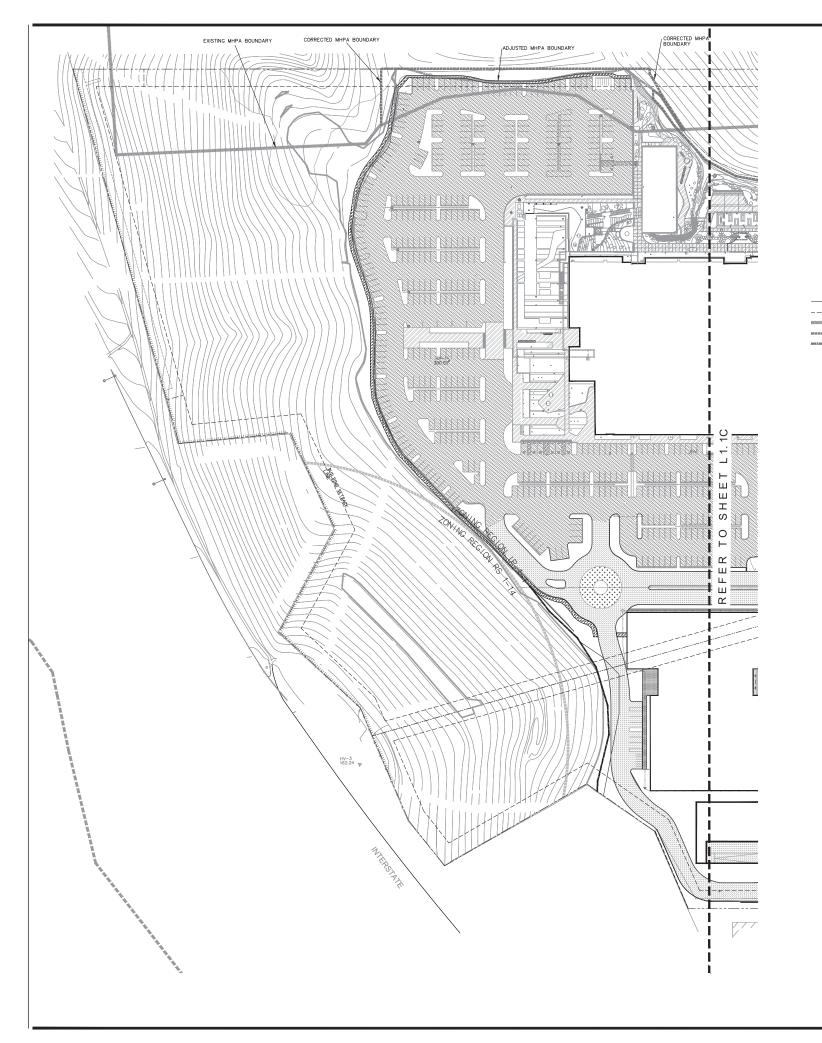ALEXANDRIA REAL ESTATE **EQUITIES**

10996 Torreyana Road Suite 250 San Diego, CA 92121

CAMPUS POINT SITE DEVELOPMENT PERMIT

10290 &10300 CAMPUS POINT DRIVE SAN DIEGO, CA 92112



225 Broadway Suite 1600 San Diego CA 92101 Tel: 619.557.2500 Fax: 619.557.2520

2736 Shelter Island Drive San Diego CA 92106 Telephone 619.822.2100

 Date	loone/I/CA/191011	Dy	10
11/30/2015	CYCLE 27	SK	RG
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06/24/2016	CYCLE 35	SK/MB	RG
08/24/2016	CYCLE 38	SK	RG
09/29/2016	CYCLE 41	SK	RG



Project Name

CAMPUS POINT SITE DEVELOPMENT PERMI

Description
Hardscape Plan


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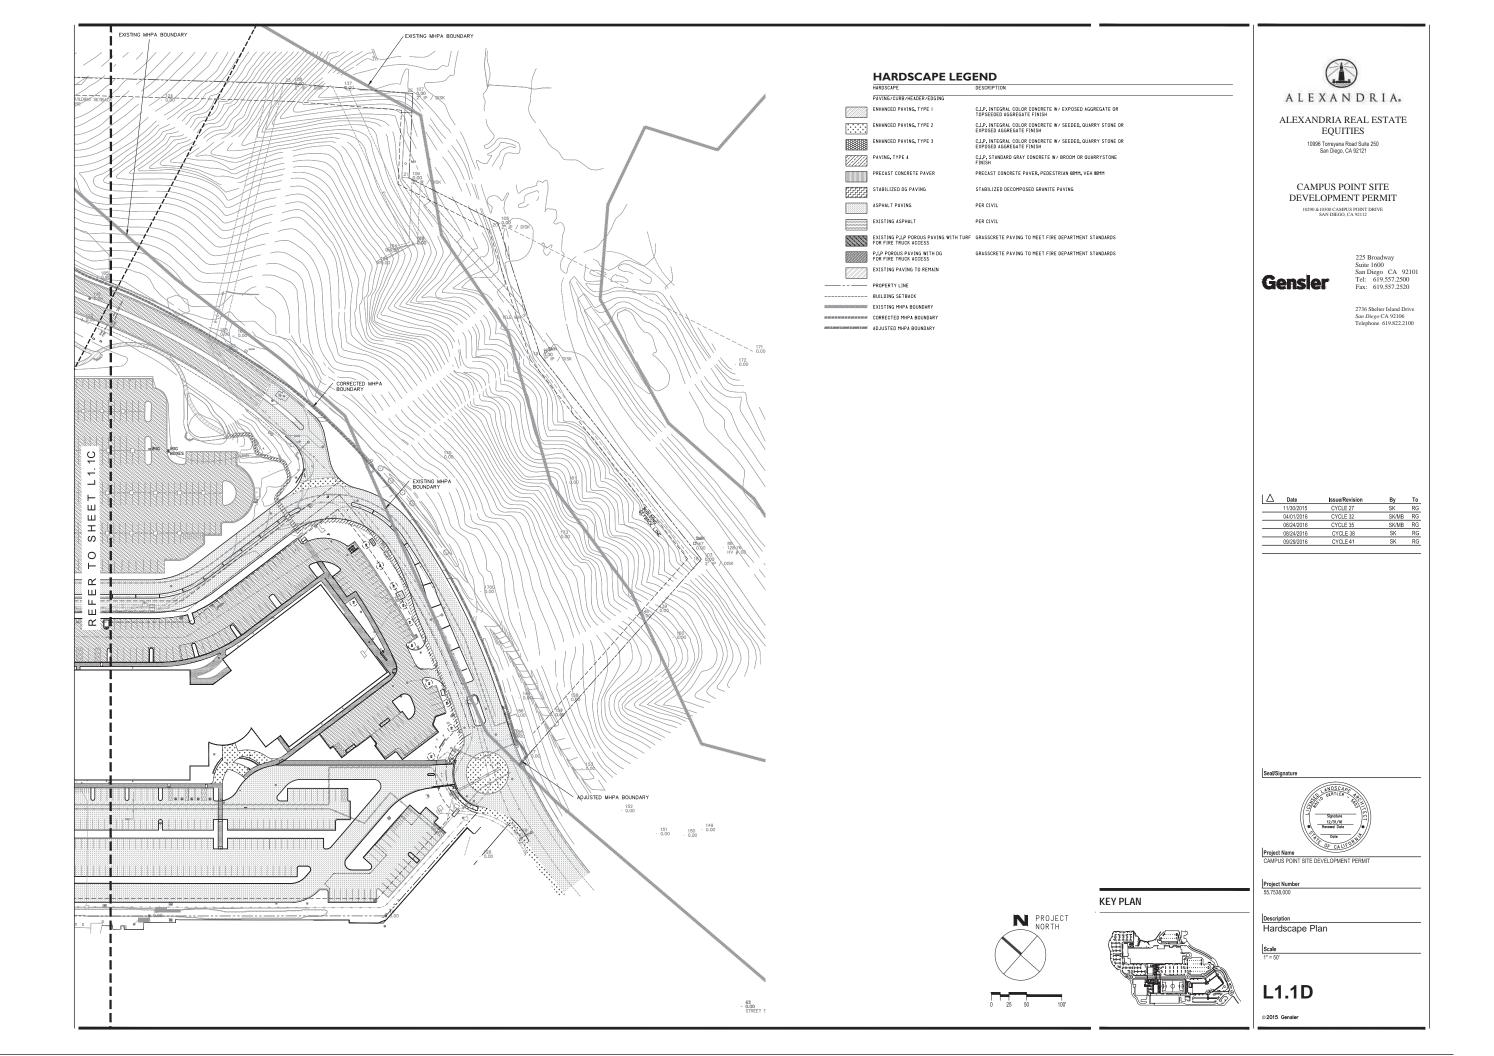
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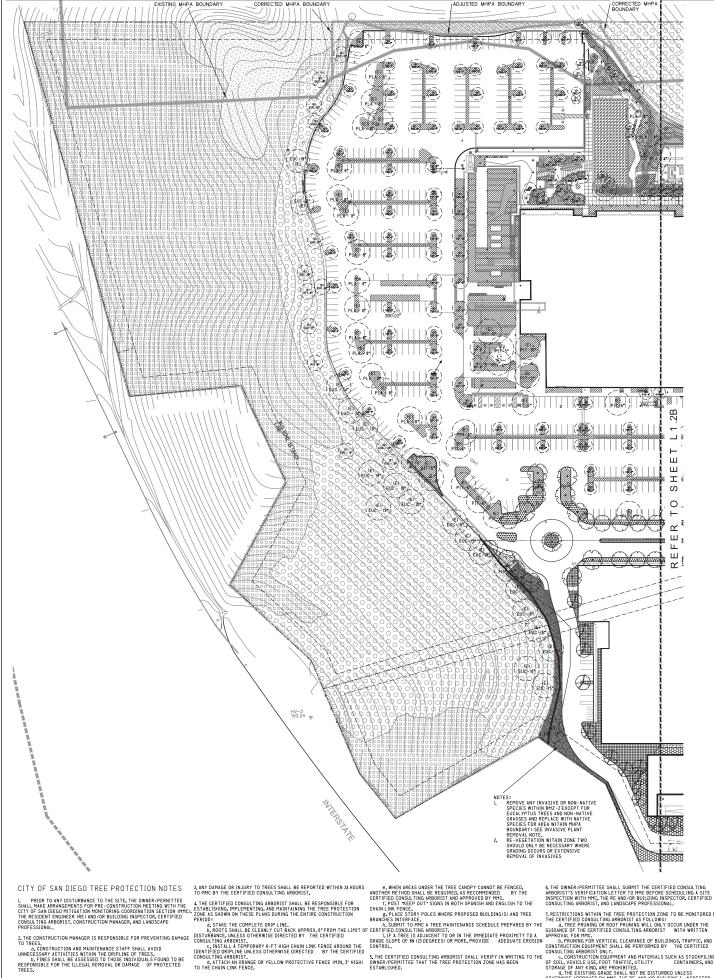




KEY PLAN





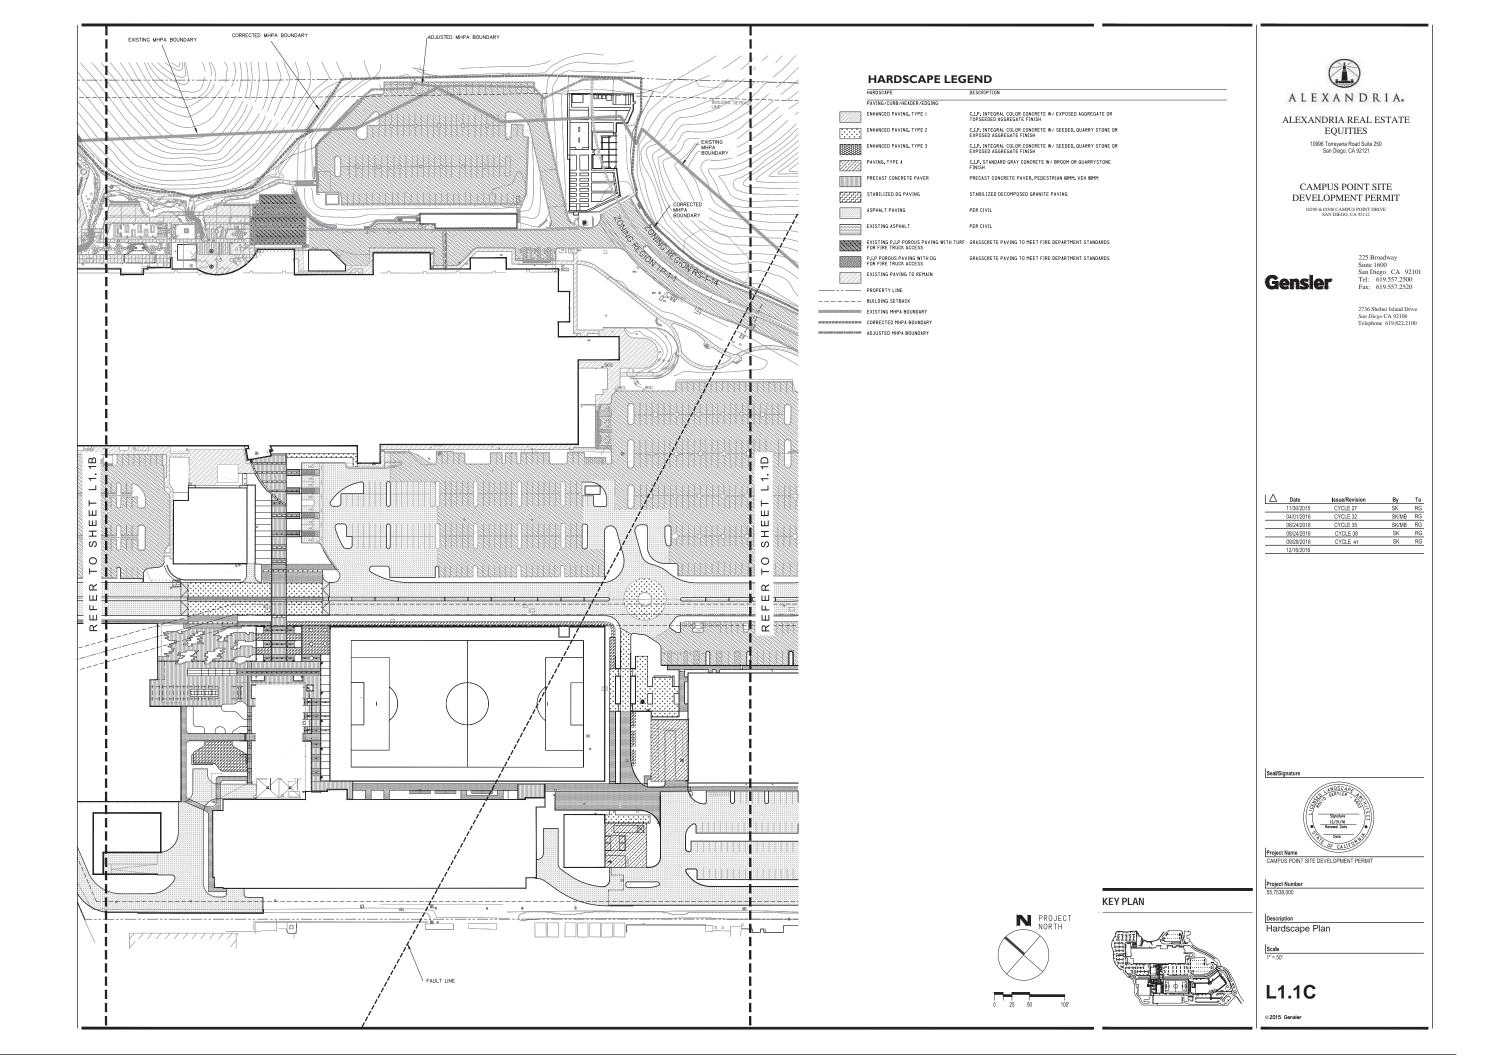

PLANTING LEGEND

(£) PROPOSED TREES

TIPU TREE

— TIPUANA TIPU SCREENING TREES SUCH AS: LOPHOSTEMON CONFERTUS

PARKING LOT TREES SUCH A: LOPHOSTEMON CONFERTUS PINUS TORREYANA KOELREUTERIA BIPINNATA

SITE ENTRY PLANTING SUCH AS COMMON NAME AEONIUM 'JOLLY GREEN' JOLLY GREEN AEONIUM AGAVE AMER. VAR. MEDIO-PICTA WHT,-STRIPED CENTURY PLAN ALOE X 'ALWAYS RED' ANIGOZANTHOS FLAVIDUS 'BUSH DAWN YELLOW KANGAROO PAW BULBINE FRUTESCENS SNAKE FLOWER LEUCOSPERMUM 'FLAME GIANT' GIANT ORANGE NODDING PINCUSIO MEXICAN FEATHER GRASS SENECIO MANDRALISCAE KLENIA

BOULEVARD PLANTING SUCH AS BESCHORNERIA Y. 'FLAMINGO GLOW' BULBINE FRUTESCENS 'YELLOW' YELLOW STALKED BULBING SMALL CAPE RUSH HESPERALDE PARVIFLORA RED YUCCA NASSELLA TENUISISMA MEXICAN FEATHER GRASS

SENECIO MANDRALISCAE KLENIA PROMENADE PLANTING SUCH AS: ALOE X "ALWAYS RED" ALWAYS RED HYBRID ALOE AGAVE 'BLUE GLOW' BESCHORNERIA Y, 'FLAMINGO GLOW' FLAMINGO GLOW MEXICAN LILY

NASSELLA TENUISISMA SENECIO MANDRALISCAE KLENIA


AEONIUM 'JOLLY GREEN' JOLLY GREEN AEONIUM AGAVE AMER. VAR. HEDIO-PICTA AGAVE 'BLUE GLOW' AGAVE BRACTEOSA "CALAMAR" CALAMAR SQUID AGAVE BULBINE FRUTESCENS 'YELLOW' YELLOW STALKED BULBING CHONDROPETAL UM TECTORUM CAPE RUSH RED-EDGED DRACAEN DRACAENA MARGINATA GRAPTOPETALUM PARAGUAYENSE GHOST PLANT

NASSELLA TENUISISMA MEXICAN FEATHER GRASS ALEXHAUS PLANTING SUCH AS: AGAVE AMER, VAR, MEDIO-PICTA WHT,-STRIPED CENTURY PLAN

BESCHORNERIA Y, 'FLAMINGO GLOW' FLAMINGO GLOW MEXICAN LILY DRACAENA MARGINATA GREVILLEA 'BONFIRE' HESPERALDE PARVIFLORA 'YELLOW' NASSELLA TENUISISMA MEXICAN FEATHER GRASS

e. ROOT SYSTEMS SHALL BE PROTECTED FROM FLOODING, EROSION CHEMICAL SPILLS, AND EXCESS VARIATIONS IN SOIL MOISTURE BY CONSTRUCTION ACTIVITY.

SENECIO MANDRALISCAE

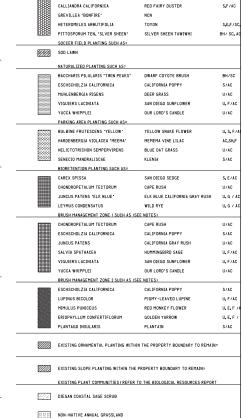

KNIF-LEAF WATTLE

ACACIA CULTIFORMIS

EUCALYPTUS WOODLAND

EXISTING MHPA BOUNDA SHIRE CORRECTED MHPA BOUNDARY

ADJUSTED MHPA BOUNDARY ABBREVIATIONS

INVASIVE SPECIES WILL BE REMOVED FROM THE PREMISES TO THE MAXIMUM EXTENT PRACTICABLE, THESE SPECIES INCLUDE (BUT ARE NOT LIMITED TO) WITH THE TOTAL WATER OF THE PRACTICABLE, THESE SPECIES INCLUDE (BUT ARE NOT LIMITED TO) WATER WESTERN COASTAL WATER, I FAILAM INTEST, FREE TO PROCESS, PERVIVAN SCAREET PIMPERNEL, ENGLISH PLANTAIN, AUSTRALIAN SALTBRUSH, PERVIVAN PEPPER, AND TOCALOTE COCCURING WITHIN THE MEM PAGE OF WITHIN THE PEPPER.

KEY PLAN

_ _ _ _ BUILDING SETBACK



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CAMPUS POINT SITE DEVELOPMENT PERMIT

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2736 Shelter Island Drive San Diego CA 92106 Telephone 619.822.2100

| △ Date 11/30/2015 04/01/2016 SK/MB RG 06/24/2016 CYCLE 38 08/24/2016 09/29/2016

Seal/Signature



Project Name

CAMPUS POINT SITE DEVELOPMENT PERM

Description Planting Plan

Scale 1" = 50'

L1.2A

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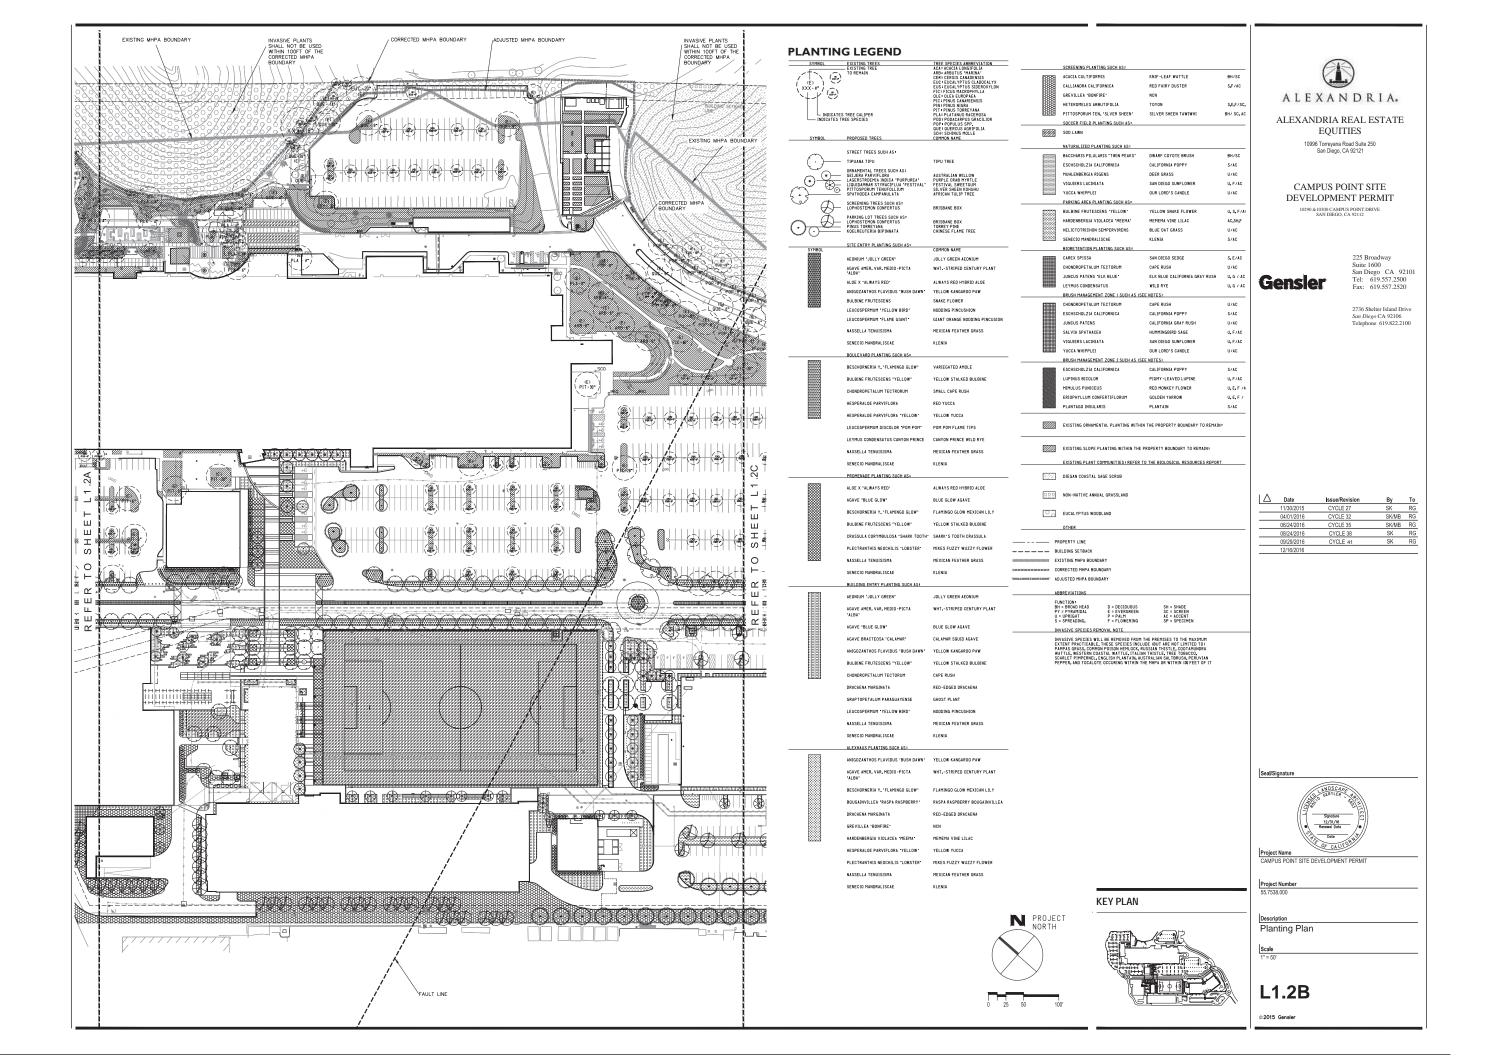
INSPECTION WITH MC, THE RE AND/OR BUILDING INSPECTOR, CERTIFIED
CONSTRUCTION ACTIVITY.


ONSTRUCTION ACTIVITY.


A, MAY MODIFICATION ADDITIONS TO THE APPROVED TREE
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MONITORING AND MAINTENANCE PERIOD, DESIGNED BY THE CERTIFIED
CONSTRUCTION COUPTENT SHALL BE PERFORMED BY THE CERTIFIED
CONSTRUCTION COUPTENT SHALL BE PERFORMED BY THE CERTIFIED
OF SOLI, VEHICLE USE, POOT TRAFFIC, UTILITY
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MAINTENANCE PERIOD.

MAINTENA

PROJECT NORTH



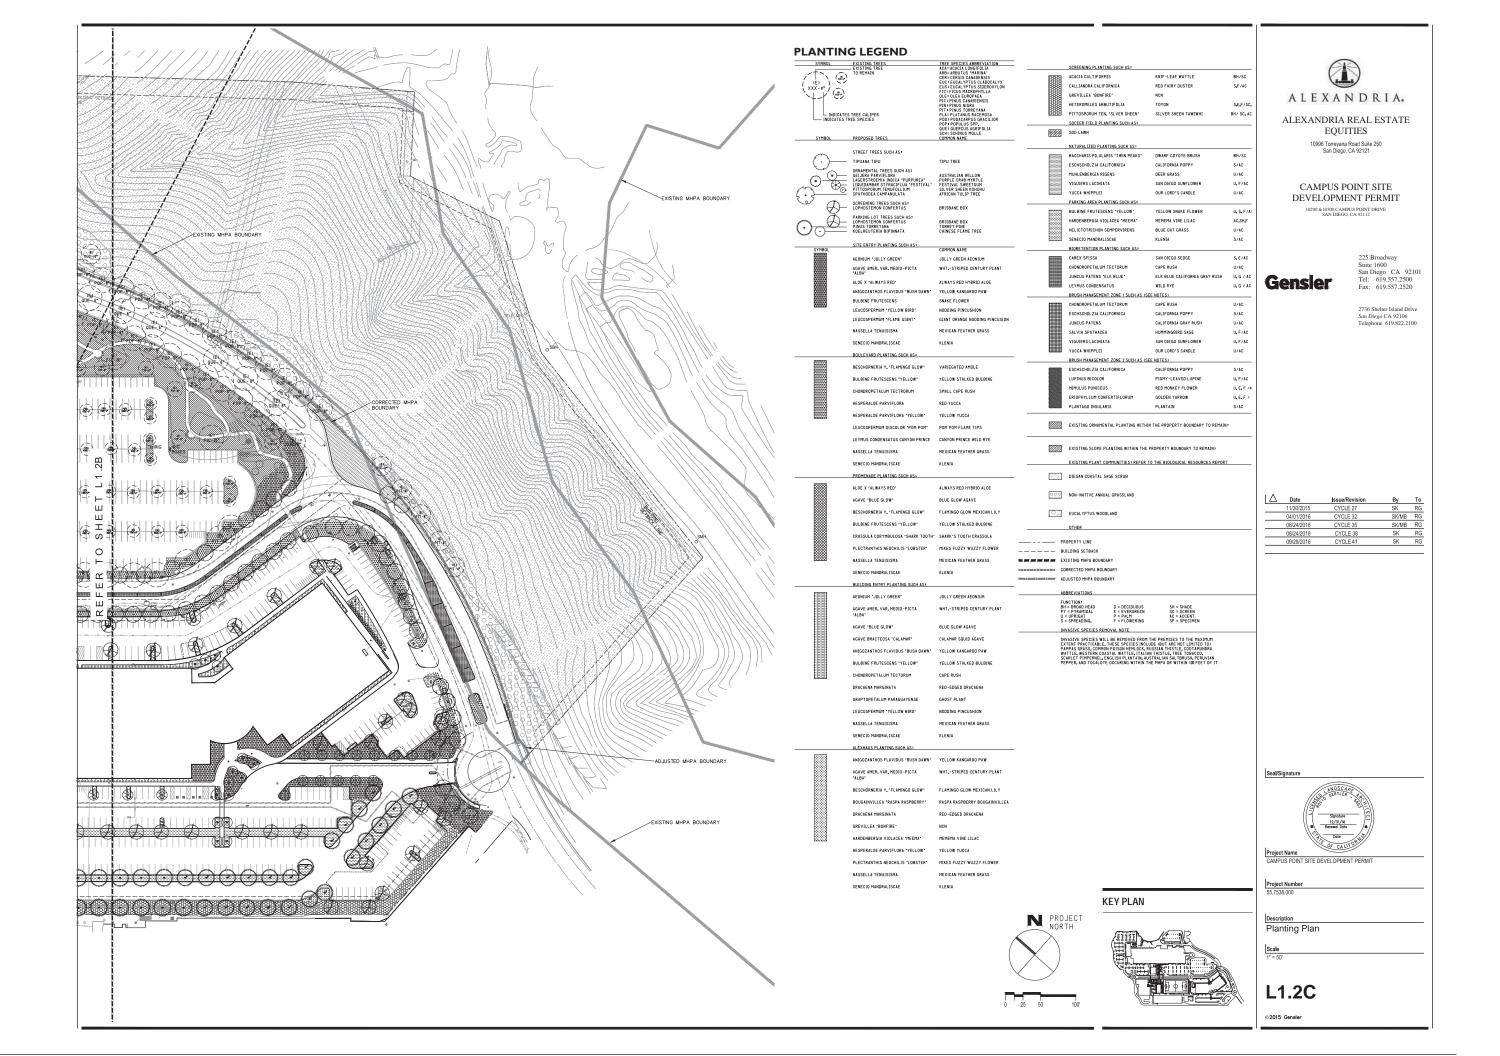

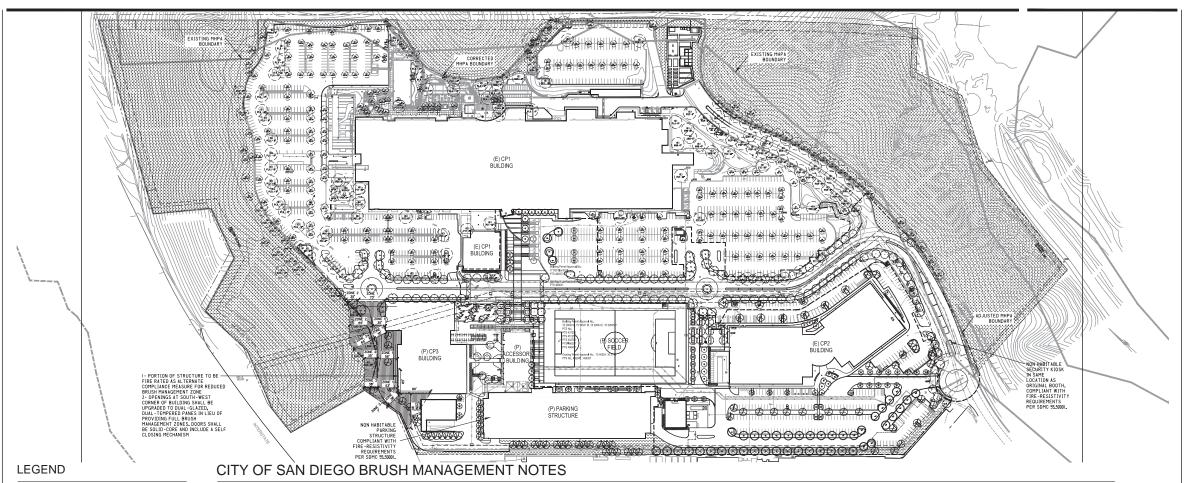

DESCRIPTION NATURALIZED AREAS OUTSIDE OF ZONE | 42 FIRE ZONE I

URBAN/DEVELOPED AREA

PROPERTY LINE

10' TREE PLANTING OFFSET FROM PLANTING AREA



EXISTING TREES TO REMAIN

I, EXISTING VEGETATION OUTSIDE OF PROPERTY LINE AND PUBLIC R,O,W, TO REMAIN

REFER TO THE BIOLOGICAL RESOURCES REPORT FOR EXISTING VEGETATION CLASSIFICATIONS

BRUSH MANAGEMENT BASIS OF DESIGN

THE BRUSH MANAGEMENT PROGRAM SHALL BE BASED ON A STANDARD ZONE ONE OF 35 FEET IN WIDTH WITH ZONE "WO OF 65 FEET IN WIDTH, EXTENDING OUT FROM THE STRUCTURE TOWARDS THE NATIVE ANALURAL IZED VECET AT ION, CONSISTENT WITH THE RESEARCH MANAGEMENT AND THE STRUCTURE OF THE STANDARD STANDA

BRUSH MANAGEMENT DESCRIPTION:
FIRE SAFETY IN THE LANDSCAPE IS ACHIEVED BY REDUCING THE READILY
FLAMMABLE FUEL JANDSCAPE IS ACHIEVED BY REDUCING THE READILY
FLAMMABLE FUEL JANDSCAPT OF STRUCTURES, THIS CAN BE ACCOMPLISHED
BY PRUNNING AND THINNING OF NATIVE AND NATURALIZED VEGETATION,
REVEGETATION WITH LOW FUEL VOLLUME PLANTINGS OR A COMBINATION OF
THE TWO, IMPLEMENTING BRUSH MANAGEMENT IN AN ENVIRONMENTALLY
APPROPRIATE MANNER REQUIRES A REDUCTION IN THE AMOUNT ALLY
COVERAGE FOR SOIL PROTECTION, SUCH A TRANSITION WILL MINIMIZE THE
VISUAL, BIOLOGICAL AND EROSION IMPACTS WHILE REDUCING THE RISK OF
WILLDAND FIRES.

BRUSH MANAGEMENT GENERAL REQUIREMENTS

I. The Owner/Permittee shall implement the following requirements in accordance with the Brush Management Program shown on Exhibit 'A' Brush Management Plar on file in the Office of the Development Services Department.

Prior to issuance of any Engineering Permits for grading, Landscape construction documents required for the engineering permit shall be submitted showing the brush management zones on the property in substantial conformance with Exhibit

3. Prior to issuance of any Building Permits, a complete set of Brush Management Plans shall be submitted for approval to the Development Services Department, The construction documents shall be in substantial conformance with Exhibit 'A' and shall compty with the Landscape Standards and Brush Management Regulations as set forth under Land Development Code Section 182012.

4. Zone One Requirements

a. The required Zone One width shall be provided between native or naturalized vegetation and any structure and shall be measured from the exterior of the structure to the vegetation

b, Zone One shall contain no habitable structures, structures that are directly attached to habitable structures, or other combustible construction that provides a means for transmitting fire to the habitable structures. Structures such as fences, walls, palapas, play structures, and non-habitable gazebos that are located within brush management Zone One shall be of noncombustible, one hour fire-rated or heavy timber construction.

c. Plants within Zone One shall be primarily low-growing and less than 4 feet in height with the exception of trees. Plants shall be low-fuel and fire-resistive.

d. Trees within Zone One shall be located away from structures to a minimum distance of 10 feet as measured from the structures to the drip line of the tree at maturity in accordance with the Landscape Standards of the Land Development Hanual.

e. Permanent irrigation is required for all planting areas within Zone One except as follows:

(I) When planting areas contain only species that do not grow taller than Winches in height or

(2) When planting areas contain only native or naturalized species that are not summer-dormant and have a maximum height at plant maturity of less than 2ℓ inches,

f, Zone One irrigation over spray and runoff shall not be allowed into adjacent areas of native or naturalized vegetation,

 ${\bf g},$ Zone One shall be maintained on a regular basis by pruning and thinning plants, controlling weeds, and maintaining irrigation systems.

h. Within Zone One, combustible accessory structures (including, but not limited to decks, trellises, gazebos, etc.) shall not be permitted white accessory structures of non-combustible, one-hour filter-ated, and/or heavy timber construction may be approved within the designated Zone One area subject to Fife Marshal's approval.

a. The required Zone Two width shall be provided $\,$ between Zone One and the undisturbed, native or naturalized vegetation, and shall be measured from the edge of Zone One that is farthest from the habitable structure, to the edge of undisturbed vegetation.

b. No structures shall be constructed in Zone Two.

c. Within Zone Two, 50 percent of the plants over 24 inches shall be cut and cleared to a height of 6 inches.

d, Within Zone Two, all plants remaining after 50 percent are reduced in height, shall be pruned to reduce fuel loading in accordance with the Landscape Standards in the Land Development Manual, Non-nativeplants shall be pruned before native plants are pruned.

e. The following standards shall be used where Zone Two Is in an area previously graded as part of legal development activity and is proposed to be planted with new plant material instead of clearing existing native or naturalized vegetation:

I) All new plant material for Zone Two shall be native, low-fuel, and fire-resistive. No non-native plant material may be planted in Zone Two either inside the MHPA or in the Coastal Overlay Zone, adjacent to areas containing sensitive biological resources.

12) New plants shall be low-growing with a maximum height at maturity of 24 inches, Single specimens of fire resistive native trees and tree form shrubs may exceed this limitation if they are located to reduce the chance of transmitting fire from native or naturalized vegetation to habitable structures and if the vertical distance between the lowest branches of the trees and the top of adjacent plants are three times the height of the adjacent plants to reduce the spread of fire through ladder fueling.

(3) All new Zone Two plantings shall irrigated temporarily until established to the satisfaction of the City Manager, Only Lowflow, low-gallonage spray heads may be used in Zone Two, Overspray and runoff from the Irrigation shall not drift or flow into adjacent areas of native or naturalized vegetation. Temporary Irrigation systems shall be removed upon approved establishment of the plantings, Permanent Irrigation is not allowed in Zone Two.

(D) Where Zone I wo is being revegetated as a requirement of Section 142,041(a), revegetation shall comply with the spacing standards in the Land Development Manual, Fifty percent of the planting area shall be planted with material that does not grow taller than 21 inches. The remaining planting area may be planted with taller material, but this material shall be maintained in accordance with the requirements for existing plant material in Zone Two.

e. Zone Two shall be maintained on a regular basis by pruning and thinning plants, removing invasive species, and controlling weeds.

f. Except as provided in Section 142,0412(i), where the required Zone One width shown in Table 142-044 cannot be provided on premises with existing structures, the required Zone Two width shall be increased by one foot

BRUSH MANAGEMENT MAINTENANCE REQUIREMENTS

Basic requirements - All Zones

I. The Brush Management Program shall be maintained at all times in accordance with the City of San Diego's Landscape Standards

2. For zone two, plants shall not be cut below 6 inches.

3. Debris and trimmings produced by thinning and pruning shall be removed from the site or if Left, shall be converted into mulch by a chipping machine and evenly dispersed, non-irrigated, to a maximum depth of 6 inches.

4. Trees and large tree form shrubs fe.g., Oaks, Sumac, Toyon) which are being relained shall be pruned to provide clearance of three times the height of the under story plant material or six feet whichever is higher (Figure 3-1 of the City of San Diego Landscape Standards). Dead and excessively wildgay growth shall also be removed

5. All plants or plant groupings except cacti, succulents, trees and tree-form shrubs shall be separated by a distance three times the height of the tallest adjacent plants (Figure 3-1 of the City of San Diego Landscape Standards).

I. Do not use, and remove if necessary, highly flammable plant materials. Trees should not be located any closer to a structure than a distance equal to the tree's mature spread.

3. Non-irrigated plant groupings over six inches in height may be retained provided they do not exceed IOD square feet in area and their combined coverage does not exceed IO percent of the total Zone I area.

Zone 2 Requirements - All Structures

I, Individual non-irrigated plant groupings over 24 inches in height may be retained provided they do not exceed 400 square feet in area and their combined coverage does not exceed 30 percent of the total Zone 2 area.

CLARIFICATION OF BRUSH MANAGEMENT REGULATIONS AND LANDSCAPE STANDARDS

Thinning - This first step requires identification of the native/naturalized species and a familiarity with their various characteristics such as rooting depth, tuel Loads, flammability, as well as habitat and aesthetic value, Thinning should be prioritized as follows: I) Invasive non-native species with the exception of eucalyptus trees in Eucalyptus Woodland areas, 2) non-native species, 31 flammable hative species, 4, in ative species, and 51 regionally sensitive species, all vegetation that is not to be removed during the inflict thinning should be noted or flaggach, the remaining plants which are the process of the species and should be cut six inches above the ground without pulling out the roots.

For Eucalyptus Woodland areas that fall within Zone Two Brush Management, all trees 3 inches or less in diameter at breast height (dbh) shall be removed with the exception of indigenous, native species. The removal of Live Includes "diseased" eucalyptus trees over 3 inches dbh, should only occur"

a) when needed to remove adjacent dead trees: b) to achieve tree/shrub verifical requirements: c) where deemed a specific Liability or fire safety hazard by the Fire Chief: or d) on private property when adhering to the horizontal spacing criteria shown in the Tree * Shrub Spacing Chart under Section VIR

Certain native plants, such as those found in coastal sage scrub, should be cut back to within 12 inches of the root crown. As sprouting and re-growth occur, these plants can be maintained as Low, succulent mounds, Examples include Artemisia californica (California Sagebrush), Salvia mellitra a (Black Sage), Adenostoma fasciculatum (Chamise) and Eriogonum fasciculatum (Buckwheat),

Thinning and Pruning, Trees [Landscape Standards 83,2-1,03, 1,05] -Triming and Pruning, Trees Liquiscape Standards Saz. Jos, Ibb J Trees are allowed within the defensible space, provided the horizontal and vertical distance between trees and shrubs masses complies with required spacing for the slope gradient shown in the following Tree and Shrub Spacing Chart:



a.Trees greater than 3 inches dbh located in Eucalyptus Woodland areas are exempt from the minimum horizontal tree spacing requirement. bindigenous, native trees in all areas are exempt from the minimum horizontal tree spacing requirement.

Vertical clearance between trees and shrubs can be created by vertical coeffance between trees and shrubs can be created by pruning up the tree canopy, reducing height of the shrubs, or a pruning up the tree canopy, reducing height of the shrubs, or a up to the control of the control of the control of the control of the horizontal and vertical clearance of 10 feet, Portions of tree canoples that extend within 10 feet of the outlet of a chimney shall be pruned to maintain a minimum horizontal and vertical clearance of 10 feet pruned to maintain a minimum horizontal and vertical clearance of 10 feet pruned to maintain a minimum horizontal and vertical clearance of 10 feet pruned to maintain a minimum horizontal and vertical clearance of 10 feet pruning the control of th

ALTERNATIVE COMPLIANCE FOR REDUCED BRUSH MANAGEMENT ZONES

____ DATE _____ DEPUTY FIRE MARSHALL SIGNATURE BLOCK



BRUSH MANAGEMENT PROGRAM, ADDITIONAL MAINTENANCE NOTES

BNOON TAXMACENER! PROUNT, AUDITIONAL MAINTENANCE NOTES

I. General Maintenance - Regular inspections and Landscape maintenance are necessary to minimize the potential damage or loss of property from brush fires and other natural hazards such as erosion and slope refutures, Because each property is unique, establishing a precise maintenance schedule is not reasible, for effective fire and provide the maintenance schedule is not reasible, for effective fire and provided in the constant of the property owners should expect to water shed management, however, property owners should expect to learn the constant of the city Manager that the thinning would be consistent with conditions of species coverage described in the City of San Diego's MSCCP Subarea Plan.


2. Brush Management Zone I - This is the most critical area for fire and watershed safety, All ornamental plantings should keep well watered and any firigation run-orf should drain towards the street, Rain gutters and drainage pipes should be cleaned regularly and all leaves removed from the roof before the fire season begins, All planting, particularly no-irrigated natives and large trees should be regularly pruned to eliminate dead fuels, to reduce excessive fuel and to provide adequate space between plants and structures.

3. Brush Management Zone 2 - Seasonal maintenance in this zone should include removal of dead woody plants, eradication of weedy species and periodic pruning and thinning of trees and shrubs. Removal of weeds should not be done with hand tools such as hoes, as this disturbs valuable soil. The use of weed trimmers or other tools which retain short stubble that protects the soil is recommended. Native shrubs should be pruned in the summer after the major plant growth occurs, Well pruned healthy shrubs should typically require several years to build up excessive live and dead fuel. On slopes all drainage devices must be kept clear. Re-inspect after each major storm since minor soil slips can block drains, various groundcovers should be periodically sheared and thatch removed. Diseased and dead wood should be pruned from trees, Fertilizing trees and shrubs is not typically recommended as this may stimulate excessive growth,

4. Long-term Maintenance Responsibility ~ ALL Landscaping / Brush management within the Brush Management Zone(s) as shown on these plans shall be the responsibility of the Owner. The Brush Management Zone areas shall be maintained in each the growing condition.

it shall be the responsibility of the Owner/Permittee to schedule a pre-construction meeting on site with the contractor and the Development Services Department to discuss and outline the implementation of the Brush Management Program.

KEY PLAN

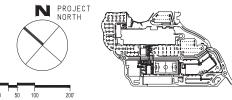



ALEXANDRIA. ALEXANDRIA REAL ESTATE **EQUITIES** 10996 Torreyana Road Suite 250 San Diego, CA 92121

CAMPUS POINT SITE DEVELOPMENT PERMIT 10290 &10300 CAMPUS POINT DRIVE SAN DIEGO, CA 92112

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Δ	Date	Issue/Revision	Ву	То
	11/30/2015	CYCLE 27	SK	RG
	04/01/2016	CYCLE 32	SK/MB	RG
	06/24/2016	CYCLE 35	SK/MB	RG
	08/24/2016	CYCLE 38	SK	RG
	09/29/2016	CYCLE 41	SK	RG
	Δ	11/30/2015 04/01/2016 06/24/2016 08/24/2016	11/30/2015 CYCLE 27 04/01/2016 CYCLE 32 06/24/2016 CYCLE 35 08/24/2016 CYCLE 38	11/30/2015 CYCLE 27 SK 04/01/2016 CYCLE 32 SK/MB 06/24/2016 CYCLE 35 SK/MB 08/24/2016 CYCLE 38 SK

Seal/Signature




Project Name

CAMPUS POINT SITE DEVELOPMENT PERMI

Brush Management Plan

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PLANT LEGEND

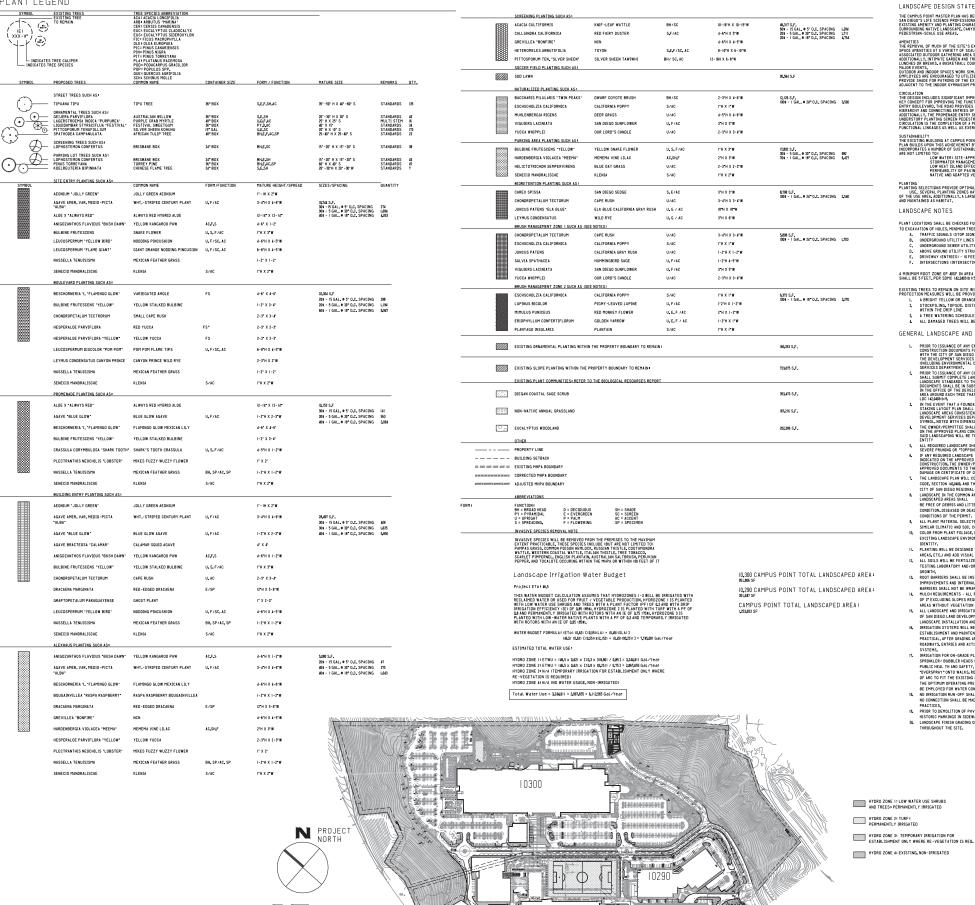

AMENITIES
THE REPOVAL OF HUCH OF THE SITE'S EXISTING ON-GRADE PARKING AREAS PROVIDES EMPLOYEES WITH OPEN SPACE MENTICS AT A VARIETY OF SCALES AND INTENSITIES OF USE, EACH PROPOSED BUILDING MAS AN ADDITIONALLY, WITHINFE CARRIER AND THE CHARGE SPACES ARE PROVIDED AUGUST TO BUILDINGS FOR CASUAL ULKNESS OR BEAKES, A BASEFIELD, COURT AND LAMP PROVIDES THE RECESSARY SEATING CAPACITY FOR MANDER STATES. MAJOR EVENTS.

OUTDOOR AND INDOOR SPACES WORK SIMULTANCOUSLY TO PROVIDE MENITIES FOR A GREATER VARIETY OF NEED
EMPLOYEES AND ENCOURAGED TO UTILIZE THE SITE'S OUTDOOR SPACES, A LARGE TRELIS WITH SEATING AREAS
PROVIDE SHADE FOR PATROMS OF THE EXISTING ON SITE CAPE, ADDITIONALLY, A USE AREA IS PROVIDED
ADJACENT TO THE INDOOR OTHMASION PROVIDINGS SPACE FOR OUTDOOR EXERGIS EXTINITIES.

CERCULATION

CERCU

ID TO:

LOW WATER: SITE-APPROPRIATE PLANT PALETTE

STORMWATER MANAGEMENT: PLANTED SWALES TREAT UNMOFF

LOW HEAT ISLAND EFFECT: PAVING WITH HIGH SRI VALUE, TREES AND STRUCTURES FOR SHADING

PERMEABILITY OF PAVING REDUCING THE AMOUNT OF EXISTING PAVED SURFACES

NATIVE AND ARAPTED VEGETATION CREATING HABITA VALUE

LANDSCAPE NOTES

PLANT LOCATIONS SHALL BE CHECKED FOR POSSIBLE INTERFERENCE WITH EXISTING UNDERGOUND PIPING, PRIOR TO EXCAVITION OF HOLES, NEIMBHOUT REE SEPARATION DISTANCES ARE AS FOLLOWS:

A. THAT EXPOSSIBLE SITURD SHALL SHAL

A MINIMUM ROOT ZONE OF AISE IN AREA SHALL BE PROVIDED FOR ALL TREES. THE MINIMUM DIMENSION FOR THIS AREA SHALL BE 5 FEET, FER SOME 142,003/001015).

EXISTING TREES TO REMAIN ON SITE WITHIN THE AREA OF WORK WILL BE PROTECTED IN PLACE, THE FOLLOWING PROTECTION MEASURES WILL BE PROVIDED:

- A BRIGHT YELLOW OR PROVIDED!

 A BRIGHT YELLOW OR PANNEE TEMPORARY FENCE WILL BE PLACED AROUND EXISTING TREES AT THE DRIP LINE.

 STOCKPLINE, TOPSOIL DISTURBANCE, VEHICLE USE, AND MATERIAL STORAGE OF ANY KIND IS PROHIBITED

 WITHIN THE DRIP LINE
- WITHIN THE DRIFT LINE

 A TREE WATERING SCHEDULE WILL BE MAINTAINED AND DOCUMENTED DURING CONSTRUCTION.

 A ALL DAMAGED TREES WILL BE REPLACED WITH ONE OF EQUAL OR GREATER SIZE.

GENERAL LANDSCAPE AND IRRIGATION SYSTEM NOTES

- PRIOR TO ISSUANCE OF ANY ENGINEERING PERMITS FOR GRADING, THE OWNER-PERMITTEE SHALL SUBMIT COMPLETE CONSTRUCTION DOCUMENTS FOR THE REVEGETATION AND INTRODUCED HIS OF ALL DISTORDED LAND IN DEDINANCE THE REVERSE OF ALL DISTORDED LAND IN DEDINANCE THE REVERSE OF ALL DISTORDED LAND IN DEDINANCE THE REVERSE OF ALL DISTORDED LAND DEPORTMENT OF THE PERMIT LINCALUBING ENVIRONMENT LO CONTITUNES AND EXHIBIT "A", ON FILE IN THE OFFICE OF THE DEVELOPMENT SERVICES DEPARTMENT.
- SERVICES SEPREMENT.

 PROBE TO ISSUANCE OF ANY CONSTRUCTION PERMITS FOR STRUCTURES INCLUDING SHELLY, THE OWNER-PREMITTEE SAIL SUBMIT COPINETY EXPENSIVE SHELL SHELL
- STIRBUL, NULEW WITH UTTERSTORMS AND LABELEU AS CAMBUSANING AREA.

 THE OWNER-PERNITTEE SHALL BE RESPONSIBLE FOR THE HAINTENANCE OF ALL LANDSCAPE IMPROVEMENTS SHOW ON THE APPROVED PLANS CONSISTENT WITH THE LANDSCAPE STANDARDS UNLESS CONG-TERM MAINTENANCE OF SAID LANDSCAPING WILL BE THE RESPONSIBILITY OF A LANDSCAPE MAINTENANCE DISTRICT OR THERE APPROVED ALL REQUIRED LANDSCAPE SHALL BE MAINTAINED IN A DISEASE, WEED AND LITER FREE CONDITION AT ALL TIMES.
 SEVERE PRUMING OR "TOPPING" OF TREES IS NOT PERMITTED UNLESS SPECIFICALLY NOTED IN THIS PERMIT.

- OUR SECTION REGION AND THE DEFECTION THANKS I CANSSISTED STANDARD AND THE JANUARY TO AND THE PERMIT OF AN OFFICE AND THE PERMIT OF THE PERMIT OF THE CONTROL STANDARD SHIPS, AND REQUESTED THE CONTROL SHIPS AND THE PERMIT OF THE PERMIT.
- L PLANT MATERIAL SELECTED FOR USE WILL BE OF A TYPE KNOWN TO BE SUCCESSFUL IN THE AREA OF
- ALL YEAR TRAINERS SECRETED AND ALL THE SERVICE OF T
- IDENTITY.

 PLANTING WILL BE DESIGNED TO OBSCURE UNDESIRABLE VIEWS IAUTOMOBILES, STORAGE, MAINTENANCE, UTILITY
 AREAS, ETC, AND ADD VISUAL INTEREST TO THE SITE.

 ALL SOLIS WILL BE FETHIZZED, AMBODO AND TILLED TO CONFORM TO RECOMMENDATIONS MUG BY A SOIL
 TESTING LABORATORY AND/OR LANDSCAPE ARCHITECT IN ORDER TO PROMOTE HEALTHY AND VIGOROUS PLANT
- +. Arriers shall be installed for all new trees which are placed within 5°-0° of public Ements and internal site hardscape areas, such as walks, curbs, or street pavement. Root

- SYSTEMS.

 RIGHATION FOR ON-GRADE PLANTING AREAS SHALL UTILIZE SUB-SURFACE OR SPRINKLER / BUBBLER SYSTEMS,
 SPRINKLER, PUBBLER HEADS SHALL RESPOND TO THE LANDSCAPE DESIGN, PLANT MITERIAL REQUIREMENTS AND
 PRUBLIC MELT. IT AND SAFETY, RECHIFICATION, LEE DAUDISETS FOR OPTIMINE PERFORMET OF DEVENTE
 "VOVERSPAR" ONTO WALKS, RODWAYS AND/OR BUILDINGS, THIS SHALL INCLUDE SELECTING THE BEST DEGREE
 OF ARE TO PIT IT WE SUSTIMINE SITE CONDITIONS AND TO THORTIZE HE FLOW CONTROL A CHEN VALVE TO BOT
 THE OPTIMIN OPERATING PRESSINE FOR ELICH SYSTEM, MOISTURE SENSING AND RAIN SHIT-OFF DEVICES SHALL
 BE FREPLYCHED FOR MATE CONSCIENTING.
- BE EMPLOYED FOR WATER CONSERVATION.

 NO IRRIGATION RUN-OFF SHALL DRAIN OFF SITE INTO THE PUBLIC RIGHTS-OF-WAY, STREETS, DRIVES OR ALLEYS,
 NO CONNECTION SHALL BE MADE TO ANY STORM WATER SEWER SYSTEMS WITHOUT PROPER BEST MANAGEMENT
 PARATICES.

KEY PLAN

- PRACTICES,
 II. PRIOR TO GENELITION OF PAVEMENT ON-SITE, IDENTIFY AND PRESERVE OR RELOCATE ANY DATE STAMPS OR
 HISTORIC MARKINGS IN SIGNEBALES-PAYUNG.
 2. LANDSCAPE FINISH ORDING ORJECTIVES WILL INCLUDE POSITIVE SURFACE DRAIMAGE OF PLANTED AREA
 THROUGHOUTH THE SITE.



EQUITIES 10996 Torreyana Road Suite 250 San Diego, CA 92121

CAMPUS POINT SITE DEVELOPMENT PERMIT

Gensler

225 Broadway Suite 1600 San Diego CA 92101 Tel: 619.557.2500

Date	Issue/Revision	Ву	То
11/30/2015	CYCLE 27	SK	RG
04/01/2016	CYCLE 32	SK/MB	RG
06/24/2016	CYCLE 35	SK/MB	RG
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12/16/2016			
	11/30/2015 04/01/2016 06/24/2016 08/24/2016 09/29/2016	11/30/2015 CYCLE 27 04/01/2016 CYCLE 32 06/24/2016 CYCLE 35 08/24/2016 CYCLE 38 09/29/2016 CYCLE 41	11/30/2015 CYCLE 27 SK 04/01/2016 CYCLE 32 SK/MB 06/24/2016 CYCLE 35 SK/MB 08/24/2016 CYCLE 38 SK 09/29/2016 CYCLE 41 SK

Seal/Signature




Project Name

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Planting Legend and Notes Irrigation and Water Budget Scale

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TREES





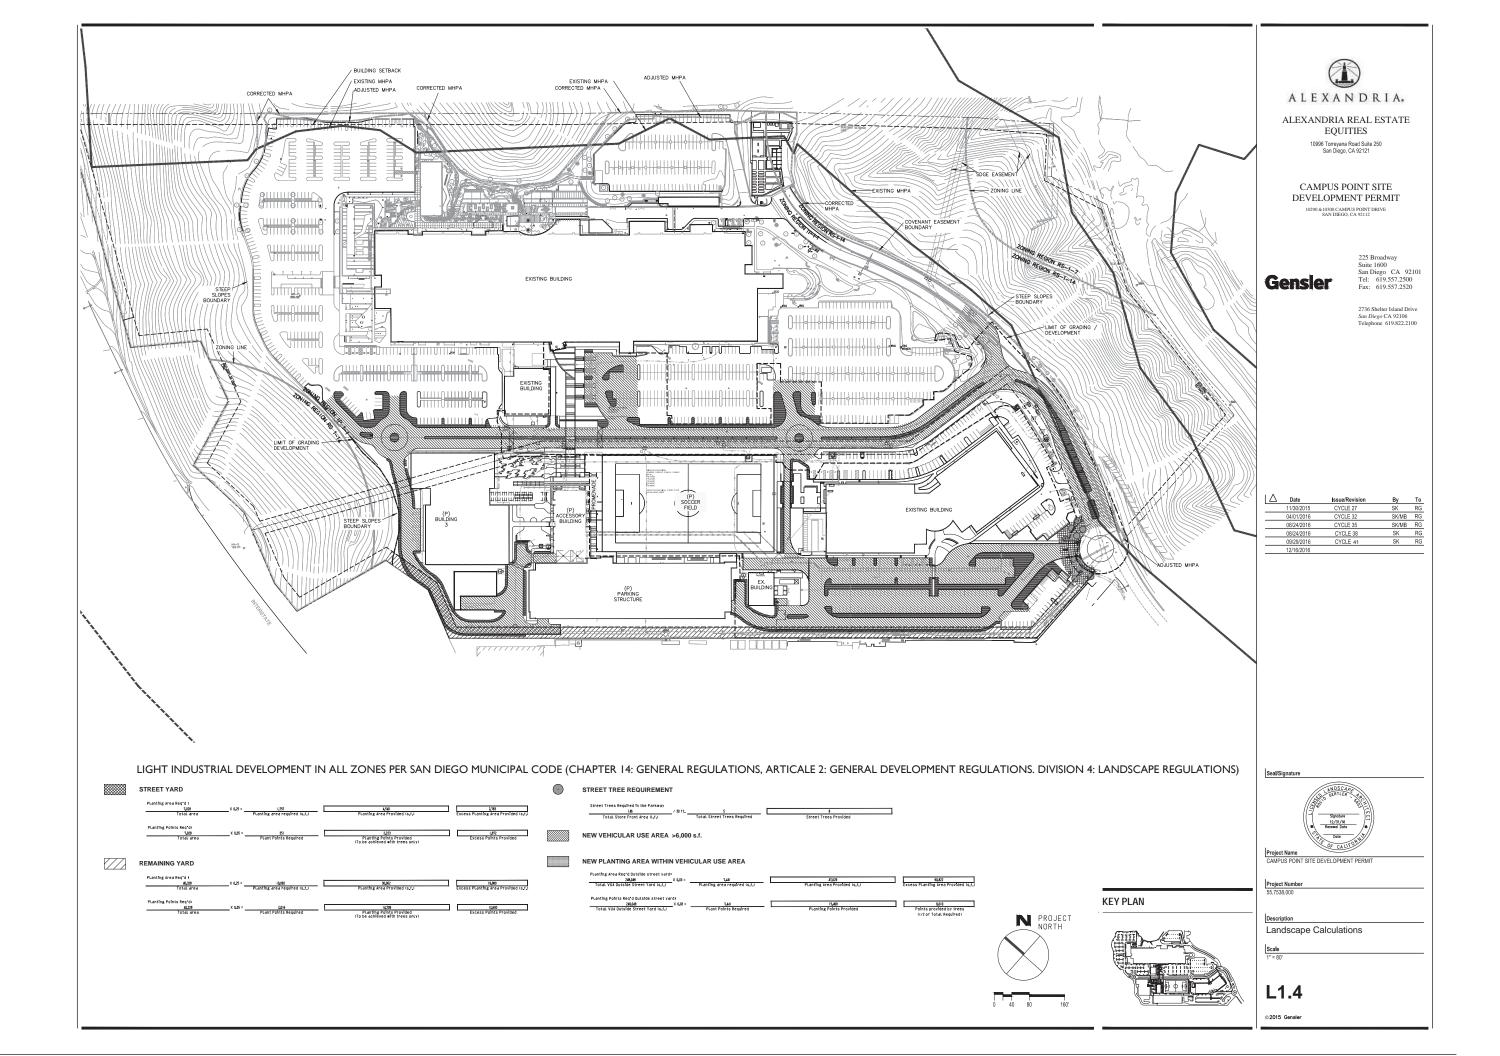



AMENITY AREA CHARACTER















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ALEXANDRIA.

ALEXANDRIA REAL ESTATE EQUITIES 10996 Torreyana Road Suite 250 San Diego, CA 92121

CAMPUS POINT SITE DEVELOPMENT PERMIT 10290 & 10300 CAMPUS POINT DRIVE SAN DIEGO, CA 92112

Gensler

2736 Shelter Island Drive San Diego CA 92106 Telephone 619.822.2100

By To SK RG SK/MB RG SK/MB RG SK RG SK RG













HARDSCAPE

		Date	Issue/Revision	Ву
	The same of the sa	11/30/2015	CYCLE 27	SK
	P/A	04/01/2016	CYCLE 32	SK
Tout	1	06/24/2016	CYCLE 35	SK
	1000	08/24/2016	CYCLE 38	Sł
	100	09/29/2016	CYCLE 41	Sł
20100	200			

LIQUIDAMBAR STYRACIFLUA 'FESTIVAL'








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Description
Character Imagery

L1.5

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Seal/Signature	105 C A A A A A A A A A A A A A A A A A A	
Project Name CAMPUS POINT Project Number	SITE DEVELOPMENT PERMIT	
55.7538.000		

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CAMPUS POINT SITE DEVELOPMENT PERMIT 10290 &10300 CAMPUS POINT DRIVE SAN DIEGO, CA 92112


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Description
Existing Vegetation Imagery
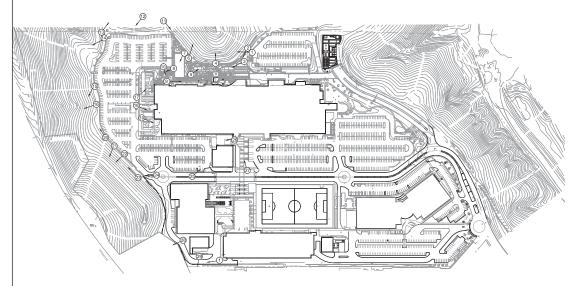
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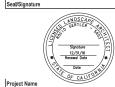








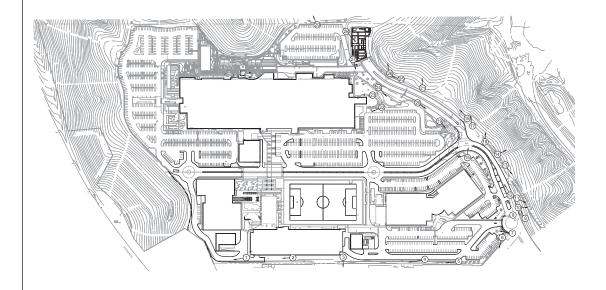



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Project Name

CAMPUS POINT SITE DEVELOPMENT PERMIT

Existing Vegetation Imagery