

### **Report to the Planning Commission**

DATE ISSUED: August 17, 2017 REPORT NO. PC-17-061

HEARING DATE: August 24, 2017

SUBJECT: T-MOBILE BLACK MOUNTAIN. Process Four Decision.

PROJECT NUMBER: <u>513210</u>

OWNER/APPLICANT: PACIFIC BELL MOBILE SERVICES/T-MOBILE WEST CORPORATION

### **SUMMARY**

<u>Issue</u>: Should the Planning Commission approve a modification to an existing Wireless Communication Facility (WCF) located at 14565 Black Mountain Road within the Rancho Penasquitos Community Plan?

<u>Staff Recommendations</u>: APPROVE Planned Development Permit (PDP) No. 1978960 and Neighborhood Use Permit (NUP) No. 1978961.

Community Planning Group Recommendation: On April 21, 2017, the Rancho Penasquitos Planning Board (RPPB) voted 10-0-0 to support the T-Mobile Black Mountain project (Attachment 13). As a condition of approval, the RPPB requested placing a shroud around the cables on the pole as well as painting the pole, shroud, and antenna one color. DSD staff and the applicant are amenable to the proposed condition and thus it has been added to the permit (Attachment 12).

<u>Environmental Review</u>: The project was determined to be exempt pursuant to California Environmental Quality Act (CEQA) Guidelines Section 15301 (Existing Facilities). This project is not pending an appeal of the environmental determination. The environmental exemption determination for this project was made on May 12, 2017, and the opportunity to appeal that determination ended on May 26, 2017 (Attachment 7).

<u>Fiscal Impact Statement</u>: None. All costs associated with the processing of this project are paid by the applicant.

<u>Code Enforcement Impact</u>: None with this action.

### **BACKGROUND**

The project site is located at 14565 Black Mountain Road (Attachment 3) in the Agricultural Residential AR-1-1 zone within the Rancho Penasquitos Community Plan. The existing WCF supports six panel antennas on a 37-foot tall wood pole. The site is surrounded by five additional communication towers on top of Black Mountain. The equipment associated with this WCF includes three ground mounted cabinets enclosed behind a chain link fence immediately adjacent to the WCF pole (Attachment 9).

Cingular Wireless PCS was granted the original Conditional Use Permit (CUP) No. 950-350-110 on May 6, 1997. At the time, the antennas were much smaller due to the inception of the technology. This site was subsequently acquired by T-Mobile West Corporation from Cingular Wireless PCS in 2001. T-Mobile's current application is to bring the site into compliance with the current Land Development Code (LDC) Regulations under Section 141.0420 as part of the project modification.

### **DISCUSSION**

<u>Project Description</u>: This T-Mobile WCF modification will continue to support six antennas mounted to the existing 37-foot tall wooden pole design. However, this new mounting design brings the antennas much closer to the pole which reduces the antenna offset while concealing all conduits inside a shroud on the pole (Attachment 8). Furthermore, the pole, antenna, shroud, and all associated mounting apparatus will be painted brown to match the surface of the wooden pole. The ground mounted cabinet equipment will have no exterior modifications. To account for the latest technology, T-Mobile is proposing to update the interior of an existing equipment cabinet to include six remote radio units. The entire lease area is approximately 180 square feet.

The project site is surrounded by five communication towers, with the tallest facility belonging to AT&T at 131 feet and the shortest pole belonging to the City of San Diego at 38 feet. In comparison, T-Mobile is the shortest pole at 37 feet. The nearest developed residential land use is over ¾ of a mile away to the west from the project location. This T-Mobile pole is the least visible structure from the nearest residential use as compared to other lattice towers existing on site. Normally, a WCF located in an AR-1-1 zone and set back from certain uses would typically require only a Neighborhood Use Permit, Process 2 decision, pursuant to LDC Section 141.0420(d)(3). However, a Planned Development Permit is also required for the proposed WCF deviations to operate above the AR-1-1 zone height limit of 30 feet, and to be located within the required rear and side yard setbacks. In order to continue using the wooden pole, T-Mobile is also proposing to deviate from LDC Sections 141.0420(g)(1) (smallest and least visually intrusive components) and 141.0420(g)(2) (integration through architecture, landscape and siting solutions). This deviation is required since the antennas are exposed and will not be integrated or camouflaged. As a result, the PDP and the NUP will be consolidated into a Process 4, Planning Commission decision.

### **Deviations:**

<b>Proposing</b> to maintain a 0-foot rear yard setback.	<b>Required</b> to obtain a 25-foot rear yard setback.		
<b>Proposing</b> to maintain a 2-foot side yard setback.	<b>Required</b> to obtain a 20-foot side yard setback.		
<b>Proposing</b> to maintain a 37-foot tall wooden pole supporting six antennas.	<b>Required</b> to obtain a 30-foot height limit.		
<b>Proposing</b> to maintain the existing exposed antenna appearance without integration and/or camouflaging techniques.	<b>Required</b> to comply with Sections 141.0420(g)(1) and 141.0410(G)(2).		
Modifications are proposed to reduce the antenna offset distance by bringing the antennas closer to the pole as reflected below:	141.0420(g)(1) - Wireless communication facilities shall utilize the smallest, least visually intrusive antennas, components and other necessary equipment.		
Existing dimension from FACE of wooden pole to widest part of antenna/mounting arm = 7'-8"  Proposed dimension from FACE of	141.0420(g)(2) - The applicant shall use all reasonable means to conceal or minimize the visual impacts of the wireless communication facilities through integration. Integration with		
<ul> <li>Proposed dimension from FACE of wooden pole to widest part of antenna/mounting arm 2'-10"</li> </ul>	existing structures or among other existing uses shall be accomplished through the use of architecture, landscape and siting solutions.		

<u>Community Plan Analysis</u>: The project location has been designated as the Black Mountain Transmission Towers (Attachment 3) with the intended use solely for communication purposes. In order to minimize the negative visual impacts from this site location, the Rancho Penasquitos Community Plan makes the following recommendations:

- <u>All transmission towers should be removed when technology becomes available that would render the structures obsolete.</u>
- All tower, dishes, and antennas should be painted with a non-reflective, low contrast color.
- <u>Landscape screening should be required around the site to shield all associated equipment buildings.</u>
- All future needed transmission facilities should utilize the existing towers as an alternative to building additional towers.
- The construction of additional towers is discouraged. If additional towers are necessary, they should not exceed the height or bulk of the existing facilities.
- Long range master plans (five to ten years) should be submitted.

Consistent with the community plan, T-Mobile will not be adding any additional towers to the location by maintaining the existing 37-foot tall wooden pole. The number of antennas will remain the same as the current amount of antennas. Additionally, the pole will remain at the current height

of 37 feet with the proposed modification to reduce the bulk by bringing the antennas closer and reducing the offset distance. Additionally, consistent with the RPPB's condition, a shroud will be installed to manage the conduits and the entire pole and all attachments will be painted to match. The 37-foot tall WCF is also the shortest facility and screened by other taller lattice towers and communication facilities. No new landscaping is being requested by staff to screen the base of the structure since the equipment cabinets are not visible unless you are standing on the premises.

General Plan: The General Plan, Section UD-A.15, states that WCFs should be concealed in existing structures when possible, or otherwise use camouflaging and screening techniques to hide or blend facilities into the surrounding area. The design of facilities is to be aesthetically pleasing and respectful of the neighborhood context. T-Mobile's WCF will be updated to include a reduced antenna offset, cable management plan that conceals all conduits within a shroud and the entire WCF pole will be painted to match the pole. Staff has concluded that the T-Mobile's WCF design is acceptable for this location due to the community designation and since it is the shortest tower and blends in with the much taller and bulkier lattice towers on site. Therefore, staff has determined that the proposed WCF modification has been designed to the extent possible to be integrated and respectful of the neighborhood context considering the site is designated for communication use in the Rancho Penasquitos Community Plan.

<u>Council Policy 600-43:</u> These guidelines establish a hierarchy from the most preferred locations (Preference 1) to the least preferred locations (Preference 4). The T-Mobile Black Mountain project is within a Preference 2 location according to Council Policy 600-43. Furthermore, no Preference 1 sites were identified in the site justification analysis (Attachment 12) and the current site is designated for communication facilities within the Rancho Penasquitos community plan.

Conclusion: The project has been determined by staff to be consistent with the purpose and intent of the applicable development regulations of the San Diego Municipal Code, which includes the development regulations for the AR-1-1 zone and the Wireless Communication Facilities Regulations Section 141.0420. Staff supports the Rancho Penasquitos Planning Board's recommendation to approve the T-Mobile WCF modification. The project complies with all applicable zoning requirements with exceptions to the requested height and setback deviations and the WCF design requirements, which require a PDP. The WCF has been determined to be consistent with the General Plan and the Rancho Penasquitos Community Plan. Staff recommends that the Planning Commission approve PDP No. 1978960 and NUP. No. 1978961.

### **ALTERNATIVES**

- 1. Approve PDP No. 1978960 and NUP. No. 1978961, with modifications.
- 2. Deny PDP No. 1978960 and NUP. No. 1978961, if the Planning Commission makes findings based on substantial evidence that the approval is not authorized by state or local zoning law and if the findings required to approve the project cannot be affirmed.

Respectfully submitted,

Elyse W. Lowe Deputy Director

**Development Services Department** 

Simon Tse

Development Project Manager
Development Services Department

### Attachments:

- 1. Aerial Photograph
- 2. Community Plan Land Use Map
- 3. Project Location Map
- 4. Project Data Sheet
- 5. Draft Permit Resolution with Findings
- 6. Draft Permit with Conditions
- 7. Environmental Exemption
- 8. Photosimulations
- 9. Photo Survey
- 10. Project Plans
- 11. Site Justification
- 12. Community Planning Group Recommendation
- 13. Ownership Disclosure Statement




# **Aerial Photo**



North

ATTACHMENT


**T-Mobile Black Mountain (Rancho Penasquitos Community)** 14565 Black Mountain Road

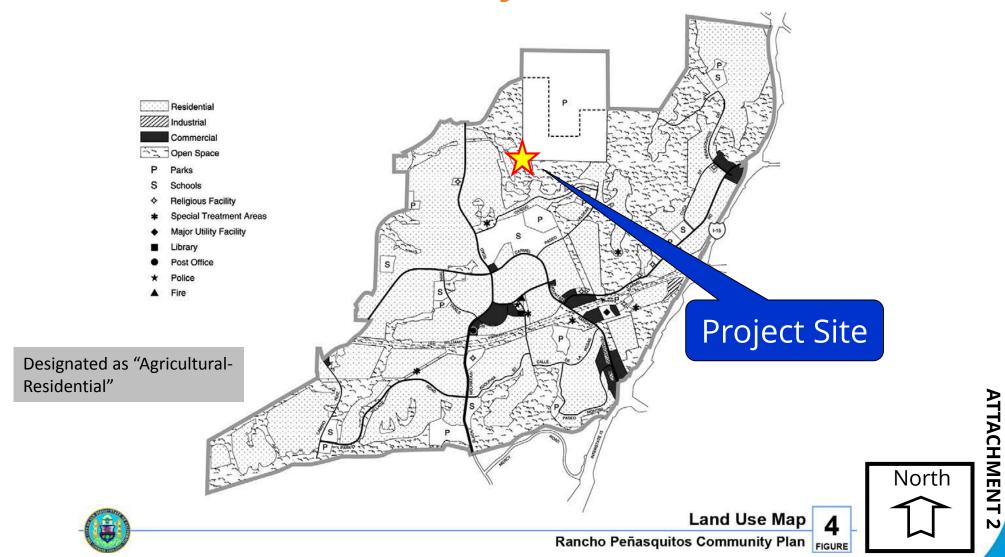

<u>T-Mobile Black Mountain (Rancho Penasquitos Community)</u> 14565 Black Mountain Road



# **Project Location Map**

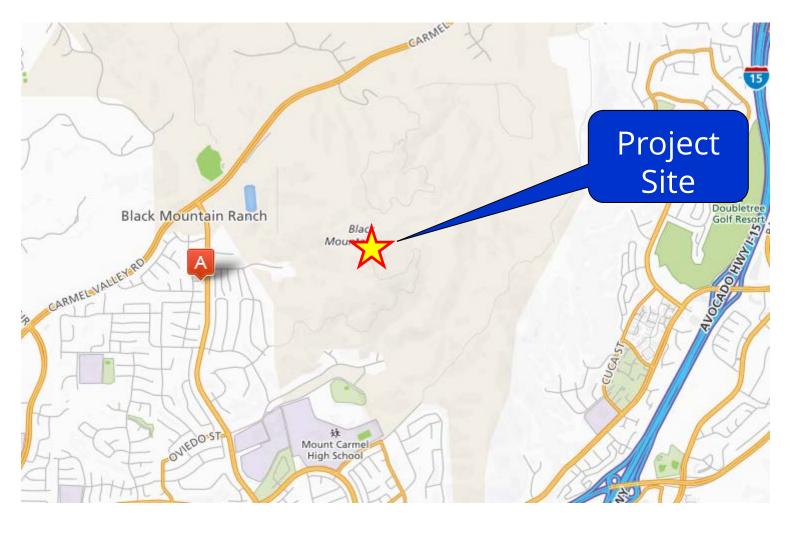

<u>T-Mobile Black Mountain (Rancho Penasquitos Community)</u> 14565 Black Mountain Road

PROJECT DATA SHEET				
PROJECT NAME:	T-Mobile Black Mountain			
PROJECT DESCRIPTION:	Planned Development Permit and Neighborhood Use Permit (Process 4) application for a Wireless Communication Facility located at 14565 Black Mountain Road in the AR-1-1 zone of the Rancho Penasquitos Planning area. The project supports six panel antennas on a wooden pole with ground-mounted equipment. Deviations are being proposed to keep the equipment within the required setbacks and to operate above the 30-foot height limit			
COMMUNITY PLAN AREA:	Rancho Penasquitos			
DISCRETIONARY ACTIONS:	Planned Development Permit ar	nd Neighborhood Use Permit		
COMMUNITY PLAN LAND USE DESIGNATION:	Agricultural-Residential	Agricultural-Residential		
	ZONING INFORMATI	ON:		
ZONE: HEIGHT LIMIT: FRONT SETBACK: SIDE SETBACK: STREETSIDE SETBACK: REAR SETBACK: PARKING:	25 feet 20 feet N/A 25 feet			
ADJACENT PROPERTIES:	LAND USE DESIGNATION & ZONE	EXISTING LAND USE		
NORTH:	Agricultural-Residential; AR-1-1	Open Space		
SOUTH:	Single Family; RS-1-14	Single Dwelling Residential		
EAST:	Agricultural-Residential; AR-1-1	Open Space		
WEST:	Single Family; RS-1-14	Single Dwelling Residential		
DEVIATION REQUESTED:	A 7-inch deviation to the 30-foot	height limit		
COMMUNITY PLANNING GROUP RECOMMENDATION:	On June 7, 2017, the Rancho Penasquitos Planning Board voted 10-0-0 to recommend approval with the condition that the project provides a shroud around the cables and paints the entire pole, shroud, and			

antennas one color

# PLANNING COMMISSION RESOLUTION NO. \_\_\_\_\_ PLANNED DEVELOPMENT PERMIT NO. 1978960 NEIGHBORHOOD USE PERMIT NO. 1978961

T-MOBILE BLACK MOUNTAIN PROJECT NO. 513210

WHEREAS, PACIFIC BELL MOBILE SERVICES, Owner, and T-MOBILE WEST CORPORATION, Permittee, filed an application with the City of San Diego for a permit to modify an existing Wireless Communication Facility (WCF) supporting six antennas on a 37-foot tall wooden pole with three ground mounted equipment cabinets (as described in and by reference to the approved Exhibits "A" and corresponding conditions of approval for the associated Planned Development Permit (PDP) No. 1978960 and Neighborhood Use Permit (NUP) No. 1978961); and

WHEREAS, the project site is located at 14565 Black Mountain Road in the Agricultural-Residential (AR)-1-1 zone of the Rancho Penasquitos Community Plan; and

WHEREAS, the project site is legally described as:

All that portion of Lot 5 of Section 5, Township 14 South, Range 2 West, San Bernardino Base and Meridian, in the City of San Diego, County of San Diego, State of California, according to the United States Government Survey, approved November 19, 1880, described as follows:

Beginning at the southwest corner of said Section 5, said corner being a 2-inch iron pipe with a brass cap as shown on Record of Survey No.6204, Records of said County, from which 2-inch iron pipe the west quarter corner of said Section 5 bears N 0°05'37" East, 2,266.41 feet; thence North 20°51 '20" East (Record North 20°21 '30" East), 1,288.30 feet to the southwest corner of that certain. Real property described in and designated as Parcel 1 of EXHIBIT "A" of the deed to AT&T COMMUNICATIONS OF CALIFORNIA, INC. • a California corporation, recorded in the office of the Recorder of said County on January 9, 1984, as Instrument No. 84-007660 of Official Records; thence along the south line of said Parcel 1, North 89°29 '10" East (Record North 88°09'57" East), 107.88 feet to the True Point of Beginning of this description; thence retracing said south line South 89°29'10" West, 95.16 feet; thence North 02° 50 '00" East, 103.60 feet; thence North 89°29 '10" East, 95.16 feet; thence South 02°50 '00" West, 103.60 feet to the True Point of Beginning;

WHEREAS, on August 24, 2017, the Planning Commission of the City of San Diego considered PDP No. 1978960 and NUP No. 1978961 pursuant to the Land Development Code of the City of San Diego; and

WHEREAS, on May 12, 2017, the City of San Diego, as Lead Agency, through the Development Services Department, made and issued an Environmental Determination that the project is exempt from the California Environmental Quality Act (CEQA) (Public Resources Code Section 21000 et seq.) under CEQA Guideline Section 15301 and there was no appeal of the Environmental Determination filed within the time period provided by San Diego Municipal Code Section 112.0520; NOW, THEREFORE.

BE IT RESOLVED, by the Planning Commission of the City of San Diego as follows:

That the Planning Commission adopts the following written Findings, dated August 24, 2017.

### **FINDINGS**:

### A. <u>Planned Development Permit - Section 126.0604</u>

## 1. The proposed development will not adversely affect the applicable land use plan.

The proposed development will not adversely affect the applicable land use plan. The Rancho Penasquitos Community Plan specifically identifies this area as the Black Mountain Transmission Tower site. This location has been designated for communication use within the community plan. Additionally, the community plan recommends that these facilities to be removed when technology becomes available that would render these structures obsolete. Presently, T-Mobile and other carriers at this location rely on these existing facilities to provide cellular and data coverage to users within this coverage area. The T-Mobile Wireless Communication Facility (WCF) is the shortest facility at 37 feet compared to the surrounding lattice towers at the project site. Consistent with the community plan, T-Mobile will not be increasing the height of the existing wooden pole. However, the current technology still requires T-Mobile to maintain their antennas at the current height to maintain their existing coverage area. As part of this project modification, T-Mobile is proposing to reduce the antenna offset and shroud all conduits associated with the wooden pole. As a result, the overall appearance of the wooden pole would appear even slimmer compared to the current configuration.

Additionally, Section UD-A.15 of the Urban Design Section of the City of San Diego's General Plan requires that the visual impact of all wireless facilities be minimized. Furthermore, the General Plan requires that all WCF must be concealed in existing structures when possible, or otherwise use camouflaging and screening techniques to hide or blend the facilities into the surrounding area. This project is consistent with the General Plan's requirement by further reducing the bulk of the original design. T-Mobile's WCF is also set back from the hillside and screened by other much taller communication facilities on site. No additional landscaping is necessary due to the existing use of the site based on the Rancho Penasquitos Community Plan and potential interference issues with other switch stations on the premises. As designed, T-Mobile's WCF is consistent with the Rancho Penasquitos Community Plan and the City's General Plan for Wireless

Facilities and the proposed development will not adversely affect the applicable land use plan.

2. The proposed development will not be detrimental to the public health, safety, and welfare.

The project is located at 14565 Black Mountain Road in the Rancho Penasquitos Community Plan area. The WCF consists of a 37-foot-tall wooden pole supporting six antennas and associated mounting components. As part of this modification, T-Mobile will be reducing the antenna offset to achieve a slimmer overall design. The existing antennas will also be replaced to support the latest technology. The three existing ground mounted equipment cabinets will continue to operate with minor interior modifications. The interior modifications consist of six new remote radio units.

The project was determined to be exempt from CEQA pursuant to Section 15301. The conditions of approval for the project will require compliance with several operational constraints and development controls intended to assure the continued public health, safety and welfare. All proposed improvement plans associated with the project will be reviewed prior to issuance of construction permits and inspected during construction to assure the project will meet or exceed all relevant and applicable building, electrical, mechanical, plumbing and fire codes.

The Telecommunications Act of 1996 preempts local governments from regulating the "placement, construction and modification of wireless communication facilities on the basis of the environmental effects of Radio Frequency (RF) emission to the extent that such facilities comply with the Federal Communication Commission's (FCC) standards for such emissions." An Electromagnetic Energy Exposure Report was prepared by T-Mobile, which concluded that the project is in compliance with FCC standards for RF emissions. Therefore, the project will not result in any significant health or safety risks to the surrounding area within matters of the City's jurisdiction and the proposed development will not be detrimental to the public health, safety, and welfare.

3. The proposed development will comply with the regulations of the Land Development Code including any proposed deviations pursuant to Section 126.0602(b)(1) that are appropriate for this location and will result in a more desirable project than would be achieved if designed in strict conformance with the development regulations of the applicable zone, and any allowable deviations that are otherwise authorized pursuant to the Land Development Code.

The project requires an NUP pursuant to Land Development Code (LDC) Section 141.0420(d)(3) which would typically be a Process 2, Development Services Department Decision. However, the project is requesting deviations to the development regulations applicable in the AR-1-1 zone. The deviations

consist of exceeding the 30-foot height limit as well as encroaching into the required rear and side yard setbacks. The project is also proposing to deviate from the Wireless Communication Facility (WCF) regulations LDC Section 141.0420(g)(1) and 141.0420(g)(2) which requires integration. As a result of these deviations, the project requires a Planned Development Permit, consolidated Process 4, Planning Commission decision, appealable to City Council.

Moving T-Mobile's WCF to comply with the required 25-foot rear and 20-foot side yard setbacks would require a redesign resulting in taller facility to achieve the same coverage objective. Such modification is discouraged by the Rancho Penasquitos Community Plan which opposes increasing the existing height or bulk of the existing facilities. Furthermore, the proposed T-Mobile modification improvements will result in a slimmer wooden pole design. T-Mobile's WCF is already the shortest structure on site at 37 feet compared to other taller communication lattice towers. Due to current coverage needs and to avoid any significant gap in coverage, T-Mobile is unable to reduce the height of the pole.

The current wooden monopole design deviates from the WCF Regulations LDC Sections 141.0420(g)(1) and 141.0420(g)(2). These deviations are only appropriate for this location due primarily to the Rancho Penasquitos Community Plan's land use designation as the Black Mountain Transmission Tower Site. Additionally, the proposed height deviation is appropriate due to the higher topographical elevation and remoteness of this site, with limited direct views of the T-Mobile tower compound and the fact that this tower is the shortest and set back amongst other larger sized lattice towers in an area designated for communication facilities.

### B. Neighborhood Use Permit - Section 126.0201

# 1. The proposed development will not adversely affect the applicable land use plan.

For the reasons described within Planned Development Permit Finding (A)(1)(a), listed above and incorporated by reference herein, the proposed development will not adversely affect the applicable land use plan.

# 2. The proposed development will not be detrimental to the public health, safety, and welfare.

For the reasons described within Planned Development Permit Finding (A)(2), listed above and incorporated by reference herein, the proposed development will not be detrimental to the public health, safety, and welfare.

3. The proposed development will comply with the regulations of the Land Development Code including any allowable deviations pursuant to the Land Development Code.

For the reasons described within Planned Development Permit Finding (A)(3), listed above and incorporated by reference herein, the proposed development will comply with the regulations of the Land Development Code including any allowable deviations pursuant to the Land Development Code, as allowed through a Planned Development Permit.

BE IT FURTHER RESOLVED that, based on the findings hereinbefore adopted by the Planning Commission, PDP No. 1978960 and NUP No. 1978961 is hereby GRANTED by the Planning Commission to the referenced Owner/Permittee, in the form, exhibits, terms and conditions as set forth in PDP No. 1978960 and NUP No. 1978961, a copy of which is attached hereto and made a part hereof.

Simon Tse
Development Project Manager
Development Services

Adopted on: August 24, 2017

3-3-16

RECORDING REQUESTED BY
CITY OF SAN DIEGO
DEVELOPMENT SERVICES
PERMIT INTAKE, MAIL STATION
501

WHEN RECORDED MAIL TO

PROJECT MANAGEMENT PERMIT CLERK MAIL STATION 501

**INTERNAL ORDER NUMBER: 24006999** 

SPACE ABOVE THIS LINE FOR RECORDER'S USE

PLANNED DEVELOPMENT PERMIT (PDP) NO. 1978960
NEIGHBORHOOD USE PERMIT (NUP) NO. 1978961
T-MOBILE BLACK MOUNTAIN PROJECT NO. 513210
PLANNING COMMISSION

This Planned Development Permit No. 1978960 and Neighborhood Use Permit No. 1978961 are granted by the Planning Commission of the City of San Diego to PACIFIC BELL MOBILE SERVICES, Owner, and T-MOBILE WEST CORPORATION, Permittee, pursuant to San Diego Municipal Code [SDMC] sections 126.0205, 126.0604, 131.0301, and 141.0420. The site is located at 14565 Black Mountain Road in the AR-1-1 zone of the Rancho Penasquitos Community Plan. The project site is legally described as:

All that portion of Lot 5 of Section 5, Township 14 South, Range 2 West, San Bernardino Base and Meridian, in the City of San Diego, County of San Diego, State of California, according to the United States Government Survey, approved November 19, 1880, described as follows:

Beginning at the southwest corner of said Section 5, said corner being a 2-inch iron pipe with a brass cap as shown on Record of Survey No.6204, Records of said County, from which 2-inch iron pipe the west quarter corner of said Section 5 bears N 0°05'37" East, 2,266.41 feet; thence North 20°51 '20" East (Record North 20°21 '30" East), 1,288.30 feet to the southwest corner of that certain. Real property is described in and designated as Parcel 1 of EXHIBIT "A" of the deed to AT&T COMMUNICATIONS OF CALIFORNIA, INC. • a California corporation, recorded in the office of the Recorder of said County on January 9, 1984, as Instrument No. 84-007660 of Official Records; thence along the south line of said Parcel 1, North 89°29 '10" East {Record North 88°09'57" East), 107.88 feet to the True Point of Beginning of this description; thence retracing said south line South 89°29'10" West, 95.16 feet; thence North 02° 50 '00" East, 103.60 feet; thence North 89°29 '10" East, 95.16 feet; thence South 02°50 '00" West, 103.60 feet to the True Point of Beginning.

Subject to the terms and conditions set forth in this Permit, permission is granted to Owner and Permittee to modify an existing Wireless Communication Facility (WCF) described and identified by size, dimension, quantity, type, and location on the approved exhibits [Exhibit "A"] dated August 24, 2017, on file in the Development Services Department.

### The project shall include:

- a. A WCF supporting six antennas on a 37-foot tall wooden pole. The mounting arms shall be reduced and all conduits to and from the antennas shall be concealed inside a shroud attached alongside the side of the pole. All antennas, mounting apparatus and shroud shall be painted and textured to match the surface of the wooden pole.
- b. Six antennas with the following dimensions:
  - Three antennas 59" by 11.9" by 6.3"
  - Three antennas 96.6" by 11.9" by 7.1"
- c. Three ground mounted equipment cabinets with internal modification that consists of six new remote radio units.
- d. Deviation to exceed the AR-1-1 zone height limit of 30 feet with a 37-foot tall wooden pole.
- e. Deviation to encroach into the required AR-1-1 front and side yard setbacks.
- f. Deviations to Land Development Code Sections 141.0420(g)(1) and 141.0420(g)(2) to allow a wooden monopole with exposed antennas.
- g. Public and private accessory improvements determined by the Development Services Department to be consistent with the land use and development standards for this site in accordance with the adopted community plan, the California Environmental Quality Act [CEQA] and the CEQA Guidelines, the City Engineer's requirements, zoning regulations, conditions of this Permit, and any other applicable regulations of the SDMC.

### **STANDARD REQUIREMENTS:**

- 1. This permit must be utilized within thirty-six (36) months after the date on which all rights of appeal have expired. If this permit is not utilized in accordance with Chapter 12, Article 6, Division 1 of the SDMC within the 36 month period, this permit shall be void unless an Extension of Time has been granted. Any such Extension of Time must meet all SDMC requirements and applicable guidelines in effect at the time the extension is considered by the appropriate decision maker. This permit must be utilized by September 7, 2020.
- 2. This PDP and NUP and corresponding use of this site shall expire on **September 7, 2027**. Upon expiration of this Permit, the entire WCF shall be removed from this site and the property shall be restored to its original condition preceding approval of this Permit.
- 3. No later than ninety (90) days prior to the expiration of this approval, the Owner/Permittee may submit a new application to the Development Services Department for consideration with review and a decision by the appropriate decision maker at that time. Failure to submit prior to the deadline will be cause for enforcement for noncompliance, which may include penalties and fines.

- 4. Under no circumstances does approval of this permit authorize the Owner/Permittee to utilize this site for WCF purposes beyond the permit expiration date. Use of this permit approval beyond the expiration date of this permit is prohibited.
- 5. No permit for the construction, occupancy, or operation of any facility or improvement described herein shall be granted, nor shall any activity authorized by this Permit be conducted on the premises until:
  - a. The Owner/Permittee signs and returns the Permit to the Development Services Department; and
  - b. The Permit is recorded in the Office of the San Diego County Recorder.
- 6. While this Permit is in effect, the subject property shall be used only for the purposes and under the terms and conditions set forth in this Permit unless otherwise authorized by the appropriate City decision maker.
- 7. This Permit is a covenant running with the subject property and all of the requirements and conditions of this Permit and related documents shall be binding upon the Owner/Permittee and any successor(s) in interest.
- 8. The continued use of this Permit shall be subject to the regulations of this and any other applicable governmental agency.
- 9. Issuance of this Permit by the City of San Diego does not authorize the Owner/Permittee for this Permit to violate any Federal, State or City laws, ordinances, regulations or policies including, but not limited to, the Endangered Species Act of 1973 [ESA] and any amendments thereto (16 U.S.C. § 1531 et seq.).
- 10. The Owner/Permittee shall secure all necessary building permits. The Owner/Permittee is informed that to secure these permits, substantial building modifications and site improvements may be required to comply with applicable building, fire, mechanical, and plumbing codes, and State and Federal disability access laws.
- 11. Construction plans shall be in substantial conformity to Exhibit "A." Changes, modifications, or alterations to the construction plans are prohibited unless appropriate application(s) or amendment(s) to this Permit have been granted.
- 12. All of the conditions contained in this Permit have been considered and were determined necessary to make the findings required for approval of this Permit. The Permit holder is required to comply with each and every condition in order to maintain the entitlements that are granted by this Permit.

If any condition of this Permit, on a legal challenge by the Owner/Permittee of this Permit, is found or held by a court of competent jurisdiction to be invalid, unenforceable, or unreasonable, this Permit shall be void. However, in such an event, the Owner/Permittee shall have the right, by paying

applicable processing fees, to bring a request for a new permit without the "invalid" conditions(s) back to the discretionary body which approved the Permit for a determination by that body as to whether all of the findings necessary for the issuance of the proposed permit can still be made in the absence of the "invalid" condition(s). Such hearing shall be a hearing de novo, and the discretionary body shall have the absolute right to approve, disapprove, or modify the proposed permit and the condition(s) contained therein.

The Owner/Permittee shall defend, indemnify, and hold harmless the City, its agents, officers, and employees from any and all claims, actions, proceedings, damages, judgments, or costs, including attorney's fees, against the City or its agents, officers, or employees, relating to the issuance of this permit including, but not limited to, any action to attack, set aside, void, challenge, or annul this development approval and any environmental document or decision. The City will promptly notify Owner/Permittee of any claim, action, or proceeding and, if the City should fail to cooperate fully in the defense, the Owner/Permittee shall not thereafter be responsible to defend, indemnify, and hold harmless the City or its agents, officers, and employees. The City may elect to conduct its own defense, participate in its own defense, or obtain independent legal counsel in defense of any claim related to this indemnification. In the event of such election, Owner/Permittee shall pay all of the costs related thereto, including without limitation reasonable attorney's fees and costs. In the event of a disagreement between the City and Owner/Permittee regarding litigation issues, the City shall have the authority to control the litigation and make litigation related decisions, including, but not limited to, settlement or other disposition of the matter. However, the Owner/Permittee shall not be required to pay or perform any settlement unless such settlement is approved by Owner/Permittee.

### **ENGINEERING REQUIREMENTS:**

14. Prior to the issuance of any construction permit the Owner/Permittee shall submit a Water Pollution Control Plan (WPCP). The WPCP shall be prepared in accordance with the guidelines in Part 2 Construction BMP Standards Chapter 4 of the City's Storm Water Standards

### **PLANNING/DESIGN REQUIREMENTS:**

- 15. Every aspect of this project is considered an element of concealment including (but not limited to) the dimensions, build and scale, color, materials and texture. Any future modifications to this permit/project must not defeat concealment.
- 16. Any future modifications to the antennas must be approved by Development Services. Antennas deviating up to the approved size (length, width, or height), must include screening designed to create the appearance of uniformity among the antennas to the satisfaction of the Development Services Department. The Permittee shall provide evidence demonstrating compliance with Federal standards for radio frequency emissions in accordance with the Telecommunications Act of 1996 and any subsequent amendments.
- 17. The WCF shall conform to the approved construction plans.
- 18. Photo simulations shall be printed on the construction plans.

- 19. The Owner/Permittee shall install and maintain appropriate warning signage on the WCF as required by State and Federal regulations. The Owner/Permittee shall be responsible for complying with all State and Federal regulations.
- 20. The accuracy and validity of the RF Compliance Report, submitted by the Permittee, shall be assured while the WCF is in operation.
- 21. All equipment, including transformers, emergency generators and air conditioners belonging to the Permittee shall be designed and operated consistent with the City noise ordinance. Ventilation openings shall be baffled and directed away from residential areas. Vibration resonance of operating equipment in the equipment enclosures shall be eliminated.
- 22. All facilities and related equipment shall be maintained in good working order and free from trash, debris, graffiti and designed to discourage vandalism. Any damaged equipment shall be repaired or replaced within thirty (30) calendar days of notification by the City of San Diego.
- 23. The Owner/Permittee shall notify the City within 30 days of the sale or transfer of this site to any other provider or if the site is no longer operational, in which case, the removal and the restoration of this site to its original condition is required.
- 24. No exposed pipes or mounting apparatus absent antennas shall be present at any time. Mounting pipes shall not be longer than the antennas.
- 25. A topographical survey conforming to the provisions of the SDMC may be required if it is determined, during construction, that there may be a conflict between the building(s) under construction and a condition of this Permit or a regulation of the underlying zone. The cost of any such survey shall be borne by the Owner/Permittee.

### **INFORMATION ONLY:**

- A Telecom Inspection is required prior to construction permit completion.
- The issuance of this development permit alone does not allow the immediate commencement or continued operation of the proposed use on site. Any operation allowed by this discretionary permit may only begin or recommence after all conditions listed on this permit are fully completed and all required ministerial permits have been issued and received final inspection.
- Any party on whom fees, dedications, reservations, or other exactions have been imposed as conditions of approval of this Permit, may protest the imposition within ninety days of the approval of this development permit by filing a written protest with the City Clerk pursuant to California Government Code-section 66020.
- This development may be subject to impact fees at the time of construction permit issuance.

APPROVED by the Planning Commission of the City of San Diego on August 24, 2017 and PC-####.

### **ATTACHMENT 6**

PDP No. 1978960 & NUP No. 1978961 August 24, 2017

AUTHENTICATED BY THE CITY OF SAN DIEGO	DEVELOPMENT SERVICES DEPARTMENT
Simon Tse Development Project Manager	
NOTE: Notary acknowledgment must be attached per Civil Code section 1189 et seq.	
	ecution hereof, agrees to each and every condition of and every obligation of Owner/Permittee hereunder.
	Pacific Bell Mobile Services Owner
	By NAME TITLE
	<b>T-Mobile West Corporation</b> Owner/Permittee
	By NAME TITLE

NOTE: Notary acknowledgments must be attached per Civil Code section 1189 et seq.

### **NOTICE OF EXEMPTION**

(Check one or both	o)	OI EXCIVIT FIOR	
TO: <u>X</u>		FROM:	City of San Diego Development Services Department 1222 First Avenue, MS 501 San Diego, CA 92101
Project Name	: T-Mobile Black Mountain	, ,	<b>Project No.:</b> 513210
Project Locat	ion-Specific: The project is located at 1	4565 Black Moun	tain Road, San Diego, CA 92129.
Project Locat	ion-City/County: San Diego/San Diego	0	
and Neighborn Penasquitos C mounted equi	hood Use Permit (NUP) application for community Plan area. The project supp	a Wireless Comm orts six panel anto to keep the equip	ennas on a wooden pole with ground- oment within the required setbacks and to
Name of Pub	lic Agency Approving Project: City of	San Diego	
Name of Pers	son or Agency Carrying Out Project:	Dail Richard SAC Wireless 5865 Avenida Er Carlsbad, CA 920 (858) 200-6541	
( ) Minist ( ) Declar ( ) Emerg	s: (CHECK ONE) erial (Sec. 21080(b)(1); 15268); red Emergency (Sec. 21080(b)(3); 15269 gency Project (Sec. 21080(b)(4); 15269 ( prical Exemption: CEQA Section 15301	(b)(c))	
proposed projoperation, rep private), involve proposed proj	ving negligible or no expansion of use b ject, a PDP and an NUP for an existing \ d for the proposed project. Additionall	CEQA Guidelines Sicensing, or minor beyond that existing WCF, is not an exp	Section 15301, which allows for the alteration of existing facilities (public or ng at the time of the determination. The pansion of use. No environmental impacts
Lead Agency	Contact Person: Anna L. McPherson, A	AICP -	<b>Геlephone:</b> (619) 446-5276
	licant: ertified document of exemption finding otice of exemption been filed by the pu	51	ving the project? ()Yes ()No

### Attachment 7

Much. Monein	/Senior Planner	May 12, 2017	
Signature/Title		Date	,

It is hereby certified that the City of San Diego has determined the above activity to be exempt from CEQA

Check One:

(X) Signed By Lead Agency( ) Signed by Applicant

Date Received for Filing with County Clerk or OPR:

# T--Mobile-

**DESIGN CRITERIA** 

### 1. CRITERIA:

THIS STRUCTURAL ANALYSIS WAS PERFORMED IN ACCORDANCE WITH THE REQUIREMENTS OF GENERAL ORDER 95 FOR A DESIGN WIND LOAD OF 8 PSF FOR A LIGHT LOADING DISTRICT:
- ASCE 7-10 MINIMUM DESIGN LOADS FOR BUILDINGS AND OTHER

### 2. DESIGN LOADS

- SHORT PERIOD SPECTRAL
- RESPONSE COEFFICIENT, SDS: - SOIL SITE CLASS:
- SEISMIC DESIGN CATEGORY:
- WIND EXPOSURE CATEGORY:
- BASIC WIND SPEED, Vult

SITE NUMBER: SD06287A

SD287 PACBELL-BLACK MOUNTAIN SITE NAME:

ADDRESS: 14565 BLACK MOUNTAIN ROAD

SITE

SAN DIEGO, CA 92129

LOCATION MAP

**LEGAL DESCRIPTION** 

**GENERAL NOTES** 

THE FACILITY IS UNMANNED AND NOT FOR HUMAN HABITATION. A TECHNICIAN WILL VISIT THE SITE AS REQUIRED FOR ROUTINE MAINTENANCE. THE PROJECT WILL NOT RESULT IN ANY SIGNIFICANT DISTURBANCE OR EFFECT ON DRAINAGE: NO SANITARY SEWER SERVICE

DO NOT SCALE DRAWINGS

COUNTY: SAN DIEGO PROJECT: VoLTE/L700

### PROJECT INFORMATION

SITE NAME: SD287 PACBELL-BLACK MOUNTAIN SITE NUMBER SD06287A 14565 BLACK MOUNTAIN ROAD SITE ADDRESS

SAN DIEGO, CA 92129 JURISDICTION: CITY OF SAN DIEGO COUNTY: SAN DIEGO LEASE AREA 178,2329 SQ. FT

LATITUDE: 32 98149667°N LONGITUDE: 117.11636000°W CONSTRUCTION TYPE 312-010-28-00

ZONING CLASSIFICATION: AR-1-1 PROPOSED USE: LINMANNED TELECOMMUNICATION FACILITY

PACIFIC BELL MOBILE SERVICES PROPERTY OWNER: 3848 7TH AVENUE ROOM 120

SAN DIEGO, CA 92103

T-MOBILE PROJECT MANAGER: JOSEPH ROSE (858) 334-6112

ioseph.rose41@T-Mobile.com

APPLICANT: SAC WIRELESS ON

BEHALF OF T-MOBILE DAIL RICHARD (858) 200-6541 dail.richard@sacw.com

ZONING: SAC WIRELESS

DAIL RICHARD

# NORTH

VICINITY MAP

### SCOPE OF WORK

- REMOVE (6) EXISTING ANTENNAS REMOVE EXISTING ANTENNA MOUNT
- INSTALL (3) NEW VOLTE PANEL ANTENNAS
- INSTALL (3) NEW L700 8' PANEL ANTENNAS
- INSTALL (2) NEW ANTENNA MOUNTS
- INSTALL (3) NEW RET CABLES
- INSTALL (1) NEW RBS 6201 CABINET W/ (6) RRUSB12 AND DUL

### PROJECT TEAM

SAC WIRELESS NESTOR POPOWYCH, A.I.A. 5015 SHOREHAM PLACE, STE 150 SAN DIEGO, CA 92122 CONTACT: DENNIS YOSHII PHONE: (619) 736-3766 X105 EMAIL: dennis yoshii@sacw.com

5015 SHOREHAM PLACE, STE 150 SAN DIEGO, CA 92122 PHONE: (858) 200-6541 EMAIL: dail.richard@sacw.com RE ENGINEER

T-MOBILE USA SAC WIRELESS TAHZAY RAMIREZ, P.E. 5015 SHOREHAM PLACE, STE 150 10509 VISTA SORRENTO PKWY SAN DIEGO, CA 92122 PHONE: (619) 736-3766 X114 SAN DIEGO, CA 92121 EMAIL: tahzav.ramirez@sacw.com PHONE: -

PLANNING CONSULTANT: SAC WIRELESS DAIL RICHARD

5015 SHOREHAM PLACE, STE 150 SAN DIEGO, CA 92122 PHONE: (858) 200-654° EMAIL: dail.richard@sacw.com

CONSTRUCTION MANAGER: T-MOBILE LISA KIRT BABCOCK 10509 VISTA SORRENTO PKWY SAN DIEGO, CA 92121 PHONE: (858) 334-6139 EMAIL: kirt.babcock@T-Mobile.co

EMAIL: mustafa.aimal@T-Mobile.com

### **DRIVING DIRECTIONS**

DIRECTIONS FROM: 10509 VISTA SORRENTO PKWY, SAN DIEGO CA 92121

USE THE RIGHT 2 LANES TO TURN RIGHT

HEAD SOUTHEAST ON VISTA SORRENTO

- TO MERGE ONTO I-805 N USE THE RIGHT 2 LANES TO TAKE THE
- CA-56 BYPASS E EXIT
- MERGE ONTO I-5 LOCAL BYPASS N
- KEEP RIGHT TO CONTINUE ON CA-56 F
- 6. TAKE THE BLACK MOUNTAIN RD EXIT
- 7. USE THE LEFT 2 LANES TO TURN LEFT
- ONTO BLACK MOUNTAIN RD

TO OBTAIN LOCATION OF PARTICIPANTS UNDERGROUND FACILITIES BEFORE YOU DIG IN CALIFORNIA (SOUTH), CALL DIG ALERT TOLL FREE: 1-800-227-2600 OR

CALIFORNIA STATUTE REQUIRES MIN OF 2 WORKING DAYS NOTICE BEFORE YOU EXCAVATE

www.digalert.org

Know what's below Call before you did

CONTRACTOR SHALL VERIFY ALL PLANS, EXISTING DIMENSIONS & FIELD CONDITIONS ON THE JOB SITE & SHALL IMMEDIATELY NOTIFY THE ARCHITECT OR ENGINEER OF RECORD IN WRITING OF ANY DISCREPANCIES BEFORE PROCEEDING WITH THE WORK OR BE RESPONSIBLE FOR SAME.

NORTH

### **SPECIAL NOTES**

ALL WORK SHALL BE INSTALLED IN CONFORMANCE WITH CURRENT T-MOBILE CONSTRUCTION INSTALLATION GUIDE

EXISTING CONDITIONS WILL BE VERIFIED IN FIELD. IF SIGNIFICANT DEVIATIONS OR DETERIORATION ARE ENCOUNTERED AT THE TIME OF CONSTRUCTION, A REPAIR PERMIT WILL BE OBTAINED & CONTRACTOR SHALL NOTIFY ARCHITECT OR ENGINEER OF RECORD IMMEDIATELY

SEE TOPOGRAPHIC SURVEY, SHEETS C-1 & C-2

REQUIRED AND NO COMMERCIAL SIGNAGE IS PROPOSED.

CONTRACTOR SHALL VERIFY ALL PLANS & EXISTING DIMENSIONS & CONDITIONS

ON THE JOB SITE & SHALL IMMEDIATEL NOTIFY THE ARCHITECT OR ENGINEER OF RECORD IN WRITING OF ANY DISCREPANCIES BEFORE PROCEEDING WITH THE WORK OR BE RESPONSIBLE FOR SAME.

THESE DRAWINGS ARE FULL SIZE & SCALEABLE ON 22"X34" SHEET SIZE & ARE NOT REDUCED IN SIZE. STATEMENT THAT COMPLIANCE WITH

THE ENERGY CODE IS NOT REQUIRED. -SCOPE OF WORK DOES NOT INVOLVE MODIFICATIONS TO EXTERIOR ENVELOPE OF BUILDING, HVAC

### SHEET DESCRIPTION T-1 TITLE SHEET T-2 GENERAL NOTES T-3 GENERAL NOTES REFERENCED DOCUMENTS, SIGNAGE, ABBREVIATIONS, & T-4 LEGEND LETTER OF AUTHORIZATION C-1 TOPOGRAPHIC SURVEY C-2 TOPOGRAPHIC SURVEY C-3 TOPOGRAPHIC SURVEY A-1 OVERALL SITE PLAN ENLARGED SITE PLAN \_A-2 EXISTING & PROPOSED ANTENNA PLANS, MOUNTING DETAIL, A-3 & ANTENNA SCHEDULES EXISTING & PROPOSED EQUIPMENT PLANS, CABINET ANCHORAGE A-4 & BATTERY CALCULATIONS A-5 EXISTING & PROPOSED NORTHWEST ELEVATIONS A-6 EXISTING & PROPOSED NORTHEAST ELEVATIONS A-7 **EXISTING & PROPOSED SOUTHEAST ELEVATIONS** A-8 **EXISTING & PROPOSED SOUTHWEST ELEVATIONS** A-9 **EQUIPMENT DETAILS & SPECIFICATIONS** A-9 1 **FOUIPMENT DETAILS & SPECIFICATIONS** A-10 FOLIPMENT CONFIGURATION SCHEMATIC GROUNDING PLANS NOTES & DETAILS

DRAWING INDEX

### **CODE COMPLIANCE**

- 2013CALIFORNIA ENERGY CODE
- 2013CALIFORNIA BUILDING CODE 2013 CALIFORNIA ELECTRICAL CODE
- 2013 CALIFORNIA FIRE CODE
- 2013 CALIFORNIA MECHANICAL CODE
- 2013 CALIFORNIA PLUMBING CODE

### **APPROVALS**


HE FOLLOWING PARTIES HEREBY APPROVE AND ACCEPT THESE DOCUMENTS & AUTHORIZE THE SUBCONTRACTOR TO PROCEED WITH THE CONSTRUCTION DESCRIBED HEREIN. ALL DOCUMENTS ARE SUBJECT TO REVIEW BY THE LOCAL

T-MOBILE PROJECT MANAGER: T-MOBILE CONSTRUCTION MANAGER: DATE: T-MOBILE RF ENGINEER DATE: SITE ACQUISITION: DATE: PROPERTY OWNER: DATE: DATE:





REVISIONS					
REV.	DATE	DESCRIPTION	INITIALS		
1	07/19/16	100% CD's	CA		
2	09/14/16	ER COMMENTS	JL		
3	10/11/16	LL COMMENTS	MD		
4	12/01/16	CITY COMMENTS	CA		
Ճ	03/27/17	CITY COMMENTS	AS		
<u></u>	05/02/17	CITY COMMENTS	JP		
NOT FOR CONSTRUCTION UNLESS LABELED AS CONSTRUCTION SET					

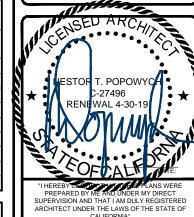

SD287 PACRELL-BLACK MOLINTAIN SD06287A 14565 BLACK MOUNTAIN ROAD SAN DIEGO, CA 92129

SHEET TITLE

TITLE SHEET

SHEET NUMBER

T-1

### GENERAL NOTES:

- 1. THIS FACILITY IS EXEMPT FROM HANDICAP REQUIREMENTS PER CBC SECTION 1105B.3.4 EXCEPTION #1. THIS FACILITY IS NON-OCCUPIABLE SPACE AND ENTERED ONLY BY SERVICE PERSONNEL.
- 2. ALL WORK SHALL CONFORM TO THE REQUIREMENTS OF THE LOCAL BUILDING CODE, THE LATEST EDITION AND ALL OTHER APPLICABLE CODES AND ORDINANCES.
- 3. CONTRACTOR SHALL CONSTRUCT SITE IN ACCORDANCE WITH THESE DRAWINGS AND CONSTRUCTION SPECIFICATIONS 80-T1196-1 REV H. THE SPECIFICATION IS THE RULING DOCUMENT AND ANY DISCREPANCIES BETWEEN THE SPECIFICATION AND THESE DRAWINGS SHOULD BE BROUGHT TO THE ATTENTION OF THE ARCHITECT OR ENGINEER OF RECORD PRIOR TO PROCEEDING WITH CONSTRUCTION.
- 4. CONTRACTOR SHALL VISIT THE JOB SITE AND SHALL FAMILIARIZE HIMSELF WITH ALL CONDITIONS AFFECTING THE PROPOSED WORK AND SHALL MAKE PREVISIONS AS TO THE COST THEREOF. CONTRACTOR SHALL BE RESPONSIBLE FOR FAMILIARIZING HIMSELF WITH ALL CONTRACT DOCUMENTS, FIELD CONDITIONS AND DIMENSIONS AND CONFORMING THAT THE WORK MAY BE ACCOMPLISH AS SHOWN PRIOR TO PROCEEDING WITH CONSTRUCTION. ANY DISCREPANCIES SHALL BE BROUGHT TO THE ATTENTION OF THE ARCHITECT OR ENGINEER OF RECORD PRIOR TO THE COMMENCEMENT OF WORK. NO COMPENSATION WILL BE AWARDED BASED ON CLAIM OF LACK OF KNOWLEDGE OF FIELD CONDITIONS.
- 5. PLANS ARE NOT TO BE SCALED. THESE PLANS ARE INTENDED TO BE A DIAGRAMMATIC OUTLINE ONLY UNLESS OTHERWISE NOTED. THE WORK SHALL INCLUDE FURNISHING MATERIALS, EQUIPMENT AND APPURTENANCES, AND LABOR NECESSARY TO EFFECT ALL INSTALLATIONS AS INDICATED ON THE DRAWINGS. OWNER PROVIDED MATERIALS WILL INCLUDE THE FOLLOWING, UNLESS NOTED OTHERWISE:
  - A. TRANSMITTER
  - B. RF FILTER
  - C. MFTS RACKS
  - D. AUXILIARY EQUIPMENT IN MFTS RACK
- E. PUMP ASSEMBLY
- F. HEAT EXCHANGE
- G. HOSE AND HOSE MANIFOLD (ANY COPPER OR STEEL SECTION PROVIDED BY CONTRACTOR)
- H. UHF ANTENNA AND MOUNTING BRACKET, GPS ANTENNA AND KU ANTENNAS
- I LIHE COAX AND HANGERS
- J. 480-208 & 208-400 ELECTRICAL TRANSFORMER (RE: E-2 FOR SPECIALIZED TRANSFORMER PROVIDED BY CONTRACTOR)
- K. AUTOMATIC TRANSFER SWITCH AND GENERATOR
- L. EQUIPMENT SHELTER (SHELTER FURNISH IN FACTORY W/HVAC EQUIPMENT AND ELECTRICAL DISTRIBUTION PANEL)
- M. INTEGRATED LOAD CÉNTER
- N. ANTENNAS, RADIOS & CABLES
- 5. DIMENSIONS SHOWN ARE TO FINISH SURFACES UNLESS OTHERWISE NOTED. SPACING BETWEEN EQUIPMENT IS REQUIRED CLEARANCE. THEREFORE, IT IS CRITICAL TO FIELD VERIFY DIMENSIONS, SHOULD THERE BE ANY QUESTIONS REGARDING THE CONTRACT DOCUMENTS, EXISTING CONDITIONS AND/OR DESIGN INTENT, THE CONTRACTOR SHALL BE RESPONSIBLE FOR OBTAINING THE WORK.
- DETAILS ARE INTENDED TO SHOW DESIGN INTENT. MODIFICATIONS MAY BE REQUIRED TO SUIT JOB DIMENSIONS OR CONDITIONS, AND SUCH MODIFICATIONS SHALL BE INCLUDED AS PART OF THE WORK.
- CONTRACTOR SHALL RECEIVE CLARIFICATION IN WRITING, AND SHALL RECEIVE IN WRITING AUTHORIZATION
  TO PROCEED BEFORE STARTING WORK ON ANY ITEMS NOT CLEARLY DEFINED OR IDENTIFIED BY THE
  CONTRACT DOCUMENT.
- CONTRACTOR SHALL SUPERVISE AND DIRECT THE WORK USING THE BEST CONSTRUCTION SKILLS AND ATTENTION. CONTRACTOR SHALL BE SOLELY RESPONSIBLE FOR CONSTRUCTION MEANS, METHODS, TECHNIQUES, SEQUENCES AND PROCEDURES AND FOR COORDINATING ALL PORTIONS OF THE WORK UNDER CONTRACT. UNLESS OTHERWISE NOTED.
- CONTRACTOR SHALL BE RESPONSIBLE FOR THE SAFETY OF THE WORK AREA, ADJACENT AREAS AND BUILDING
  OCCUPANTS THAT ARE LIKELY TO BE AFFECTED BY THE WORK UNDER THIS CONTRACT. WORK SHALL
  CONFORM TO ALL OSHA REQUIREMENTS.
- CONTRACTOR SHALL COORDINATE HIS WORK WITH THE SUPERINTENDENT OF THE BUILDING & GROUNDS & SCHEDULE HIS ACTIVITIES AND WORKING HOURS IN ACCORDANCE WITH THE REQUIREMENTS.
- CONTRACTOR SHALL BE RESPONSIBLE FOR COORDINATING HIS WORK WITH THE WORK OF OTHERS AS IT MAY RELATE TO RADIO EQUIPMENT, ANTENNAS AND ANY OTHER PORTIONS OF THE WORK.
- 12. INSTALL ALL EQUIPMENT AND MATERIAL IN ACCORDANCE WITH MANUFACTURER'S RECOMMENDATIONS UNLESS SPECIFICALLY OTHERWISE INDICATED OR WHERE LOCAL CODES OR REGULATIONS TAKE PRECEDENCE.
- MAKE NECESSARY PROVISIONS TO PROTECT EXISTING SURFACE, EQUIPMENT, IMPROVEMENTS, PIPING, ETC. AND IMMEDIATELY REPAIR ANY DAMAGE THAT OCCURS DURING CONSTRUCTION.
- 14. IN DRILLING HOLES INTO CONCRETE WHETHER FOR FASTENING OR ANCHORING PURPOSES, OR PENETRATIONS THROUGH THE FLOOR FOR CONDUIT RUNS, PIPE RUNS, ETC., IT MUST BE CLEARLY UNDERSTOOD THAT REINFORCING STEEL SHALL NOT BE DRILLED INTO, CUT OR DAMAGED UNDER ANY CIRCUMSTANCES (UNLESS NOTED OTHERWISE). LOCATIONS OF REINFORCING STEEL ARE NOT DEFINITELY KNOWN AND THEREFORE MUST BE SEARCHED FOR BY APPROPRIATE METHODS AND EQUIPMENT.
- REPAIR ALL EXISTING WALL SURFACE DAMAGED DURING CONSTRUCTION SUCH THAT THEY MATCH AND BLEND IN WITH ADJACENT SURFACE.
- 16. SEAL PENETRATION THROUGH FIRE RATED AREAS WITH U.L. LISTED AND FIRE CODE APPROVED MATERIALS.
   17. KEEP CONTRACT AREA CLEAN, HAZARD FREE, AND DISPOSE OF ALL DIRT, DEBRIS, AND RUBBISH. EQUIPMENT NOT SPECIFIED AS REMAINING ON THE PROPERTY OF THE OWNER SHALL BE REMOVED. LEAVE PREMISES IN CLEAN CONDITIONS AND FREE FROM PAINT SPOT. DUST. OR SMUDGES OF ANY NATURE. CONTRACTOR SHALL
- BE RESPONSIBLE FOR MAINTAINING ALL ITEMS UNTIL COMPLETION OF CONSTRUCTION.

  18. MINIMUM BEND RADIUS OF ANTENNA CABLE SHALL BE IN ACCORDANCE WITH CABLE MANUFACTURER'S RECOMMENDATIONS.
- 15. DAMAGE TO EXISTING STRUCTURES AND/OR UTILITIES RESULTING FROM CONTRACTORS NEGLIGENCE SHALL BE REPAIRED AND/OR REPLACED TO THE OWNERS SATISFACTION AT NO ADDITIONAL COST TO THE CONTRACT.
- 16. ALL CONSTRUCTION IS TO ADHERE TO T-MOBILE'S INTEGRATED CONSTRUCTION STANDARDS UNLESS CALIFORNIA CODE IS MORE STRINGENT.
- THE INTENT OF THE PLANS AND SPECIFICATIONS IS TO PERFORM THE CONSTRUCTION IN ACCORDANCE WITH THE CALIFORNIA BUILDING STANDARDS CODE, TITLE 19 AND 24, CALIFORNIA CODE REGULATIONS. SHOULD ANY CONDITIONS DEVELOP NOT COVERED BY THE APPROVED PLANS AND SPECIFICATIONS WHEREIN THE FINISH WORK WILL NOT COMPLY WITH TITLE 24, CALIFORNIA CODE OF REGULATIONS, A CHANGE ORDER DETAILING AND SPECIFYING THE REQUIRED WORK SHALL BE SUBMITTED TO AND APPROVED BY THE JURISDICTION BEFORE PROCEEDING WITH THE WORK.

### SITE WORK NOTES:

- 1. DO NOT SCALE BUILDING DIMENSIONS FROM DRAWINGS.
- SIZE, LOCATION, AND TYPE OF ANY UNDERGROUND UTILITIES OR IMPROVEMENTS SHALL BE ACCURATELY NOTED AND PLACED ON AS-BUILT DRAWINGS BY GENERAL CONTRACTOR AND ISSUED TO ARCHITECT OR ENGINEER OF RECORD AT COMPLETION OF PROJECT.

- 3. ALL EXISTING UTILITIES, FACILITIES, CONDITIONS AND THEIR DIMENSIONS SHOWN ON PLANS HAVE BEEN PLOTTED FROM AVAILABLE RECORDS. THE ARCHITECT OR ENGINEER OF RECORD AND OWNER ASSUME NO RESPONSIBILITY WHATSOEVER AS TO THE SUFFICIENCY OR ACCURACY OF THE INFORMATION SHOWN ON THE PLANS OR THE MANNER OF THEIR REMOVAL OR ADJUSTMENT. CONTRACTOR SHALL BE RESPONSIBLE FOR DETERMINING EXACT LOCATION OF ALL EXISTING UTILITIES AND FACILITIES PRIOR TO START OF CONSTRUCTION. CONTRACTOR SHALL ALSO OBTAIN FROM EACH UTILITY COMPANY DETAILED INFORMATION RELATIVE TO WORK SCHEDULES AND METHODS OF REMOVING OR ADJUSTING EXISTING UTILITIES.
- 4. CONTRACTOR SHALL VERIFY ALL EXISTING UTILITIES BOTH HORIZONTAL AND VERTICALLY PRIOR TO START OF CONSTRUCTION. ANY DISCREPANCIES OR DOUBTS AS TO THE INTERPRETATION OF PLANS SHALL BE IMMEDIATELY REPORTED TO THE ARCHITECT OR ENGINEER OF RECORD FOR RESOLUTION AND INSTRUCTION, AND NO FURTHER WORK SHALL BE PERFORMED UNTIL THE DISCREPANCY IS CHECKED AND CORRECTED BY THE ARCHITECT OR ENGINEER OF RECORD. FAILURE TO SECURE SUCH INSTRUCTION MEANS CONTRACTOR WILL HAVE WORKED AT HIS/HER OWN RISK AND EXPENSE. CONTRACTOR SHALL CALL LOCAL DIGGER HOT LINE FOR UTILITY LOCATIONS 48 HOURS PRIOR TO START OF CONSTRUCTION.
- CONTRACTOR SHALL CLEAN ENTIRE SITE AFTER CONSTRUCTION SUCH THAT NO PAPER, TRASH, WEEDS, BRUSH OR ANY OTHER DEPOSITS WILL REMAIN. ALL MATERIALS COLLECTED DURING CLEANING OPERATIONS SHALL BE DISPOSED OF OFF-SITE BY THE GENERAL CONTRACTOR.
- ALL SITE WORK SHALL BE CAREFULLY COORDINATED BY THE GENERAL CONTRACTOR WITH LOCAL UTILITY COMPANY, TELEPHONE COMPANY, AND ANY OTHER UTILITY COMPANIES HAVING JURISDICTION OVER THIS LOCATION

### FIRE DEPARTMENT NOTES:

- . ALL PENETRATIONS THROUGH FIRE RATED ASSEMBLIES SHALL BE CONSTRUCTED SO AS TO MAINTAIN AN EQUAL OR GREATER FIRE RATING.
- 2. DECORATIVE MATERIALS SHALL BE MAINTAINED IN A FLAME-RETARDANT CONDITION. [CFC 807.1.2]
- CONTRACTOR SHALL VERIFY IN FIELD THE EXISTENCE OR INSTALLATION OF A FIRE EXTINGUISHER WITH A
  MINIMUM RATING OF 2A-10BC, WITH A CHARGE STATUS ACCEPTABLE TO THE LOCAL FIRE AUTHORITY HAVING
  JURISDICTION

### **GROUNDING NOTES:**

- I. COMPRESSION CONNECTIONS (2), 2 AWG BARE TINNED SOLID COPPER CONDUCTORS TO GROUNDING BAR. ROUTE CONDUCTORS TO BURIED GROUNDING RING AND PROVIDE PARALLEL EXOTHERMIC WELD.
- EC SHALL USE PERMANENT MARKER TO DRAW THE LINES BETWEEN EACH SECTION AND LABEL EACH SECTION ("P", "A", "N", "I") WITH 1" HIGH LETTERS.
- ALL HARDWARE 18-8 STAINLESS STEEL, INCLUDING LOCK WASHERS, COAT ALL SURFACES WITH AN ANTI-OXIDANT COMPOUND BEFORE MATING. ALL HARDWARE SHALL BE STAINLESS STEEL 3/8 INCH DIAMETER OR LARGER.
- FOR GROUND BOND TO STEEL ONLY: INSERT A CADMIUM FLAT WASHER BETWEEN LUG AND STEEL, COAT ALL SURFACES WITH AN ANTI-OXIDANT COMPOUND BEFORE MATING.
- NUT & WASHER SHALL BE PLACED ON THE FRONT SIDE OF THE GROUNDING BAR AND BOLTED ON THE BACK SIDE.
- NUMBER OF GROUNDING BARS MAY VARY DEPENDING ON THE TYPE OF TOWER, ANTENNA LOCATION, AND CONNECTION ORIENTATION. PROVIDE AS REQUIRED.
- 7. WHEN THE SCOPE OF WORK REQUIRES THE ADDITION OF A GROUNDING BAR TO AN EXISTING TOWER, THE SUBCONTRACTOR SHALL OBTAIN APPROVAL FROM THE TOWER OWNER PRIOR TO MOUNTING THE GROUNDING BAR TO THE TOWER.
- 8. ALL ELECTRICAL AND GROUNDING AT THE CELL SITE SHALL COMPLY WITH THE NATIONAL ELECTRICAL CODE (NEC), NATIONAL FIRE PROTECTION ASSOCIATION (NFPA) 780 (LATEST EDITION), CALIFORNIA BUILDING STANDARDS AND MANUFACTURER.

### PROJECT SCOPE NOTES:

- THE PROJECT PROPOSES A NEIGHBORHOOD USE PERMIT (NUP) TO MODIFY AN EXISTING WCF TO REMOVE AND REPLACE 6 EXISTING ANTENNAS, INSTALL NEW ANTENNA MOUNTING, ASSOCIATED CABLES AND NEW EQUIPMENT CABINETS.
- THE PROJECT DOES NOT INCREASE THE BULK OF THE EXISTING FACILITY AS PER CEQA GUIDELINES SECTION
  15302.

### STRUCTURAL SPECIFICATIONS:

### A. GENERAL

- GENERAL DETAILS AND NOTES ON THESE SHEETS SHALL APPLY UNLESS SPECIFICALLY SHOWN OR NOTED
  OTHERWISE, CONSTRUCTION DETAILS NOT FULLY SHOWN OR NOTED SHALL BE SIMILAR TO DETAILS SHOWN
  FOR SIMILAR CONDITIONS.
- 4. SHORING: IT SHALL BE THE RESPONSIBILITY OF THE CONTRACTOR TO INSTALL ALL TEMPORARY BRACING AND SHORING TO INSURE THE SAFETY OF THE WORK UNTIL IT IS IN ITS COMPLETED FORM. THIS INCLUDES UNDERPINNING EXISTING FOOTINGS WHERE APPLICABLE.
- SAFETY: THESE STRUCTURAL DRAWINGS REPRESENT THE FINISHED STRUCTURE. UNLESS OTHERWISE, INDICATED, THEY DO NOT INDICATE THE METHOD OF CONSTRUCTION.

### B. STEEL

- ALL STRUCTURAL STEEL SECTIONS AND WELDED PLATE MEMBERS SHALL CONFORM TO ASTM A-36 AND BE FABRICATED IN ACCORDANCE WITH THE SPECIFICATIONS OF THE AISC.
- 2. ALL BOLTS SHALL CONFORM TO ASTM A-307 UNLESS OTHERWISE NOTED ON PLANS.
- 3. STEEL PIPE COLUMNS SHALL BE GRADE "B" CONFORMING TO ASTM A53.
- STEEL TUBING SHALL BE GRADE "B" CONFORMING TO ASTM A500.
- ALL WELDING SHOULD BE DONE IN CERTIFIED WELDER'S SHOP UNLESS NOTED OTHERWISE.
- 6. ALL STRUCTURAL STEEL SHALL HAVE MILL CERTIFICATION. MILL CERTIFICATION SHALL BE KEPT ON THE JOB SITE FOR EXAMINATION BY THE DESIGN ENGINEER AND THE CITY INSPECTOR.
- ALL HIGH STRENGTH BOLTS SHALL HAVE MILL CERTIFICATION. MILL CERTIFICATION SHALL BE KEPT ON THE JOB SITE FOR EXAMINATION BY THE INSPECTOR.
   C. CONCRETE
- STRENGTH: CONCRETE FOR THE PROJECT SHALL HAVE THE FOLLOWING ULTIMATE COMPRESSIVE STRENGTH AT AGE OF 33 DAYS:

	LOCATION	STRENGTH	WT.	SLUMP	ADMIXTURE	
	A.SLAB & FOOTING	2500 PSI	150 PCF	4"	NONE	
2.	REBAR GRADES: REINFOR	CING STEEL	SHALL BE CLEAN	PREFORME	D BARS CONFORMING TO	O ASTM A615 A

FOLLOWS:
#4 & SMALLER BARS......GRADE 40


- CEMENT: FOUNDATIONS & SLABS: TYPE V, LOW ALKALI, CONFORMING TO ASTM C-150. PIER/CAISSON FOOTINGS: TYPE V, LOW ALKALI, CONFORMING TO ASTM C-150.
- AGGREGATE: USED IN THE CONCRETE SHALL CONFORM TO ASTM C-33. USE ONLY AGGREGATES KNOWN NOT TO CAUSE EXCESSIVE SHRINKAGE. THE MAXIMUM SIZE AGGREGATE IN CONCRETE WORK SHALL BE THE FOLLOWING:
  - A. FOUNDATIONS & SLABS 9" OR LESS: 3/4" GRAVEL
  - B. PIER/CAISSON FOOTING: 1" GRAVEL
- WATER: SHALL BE CLEAN AND FREE FROM DELETERIOUS AMOUNT OF ACIDS, ALKALIS, ORGANIC MATERIALS
  AND SHALL BE SUITABLE FOR HUMAN CONSUMPTION.
- MIXING: PREPARATION OF CONCRETE SHALL CONFORM TO ASTM C-94. NO MORE THAN 90 MINUTES SHALL ELAPSE BETWEEN CONCRETE BATCHING AND CONCRETE PLACEMENT UNLESS APPROVED BY A TESTING AGENCY.
- 8. SPLICES OF REINFORCING STEEL SHALL BE LAPPED A MINIMUM OF 40 DIAMETERS AND SECURELY WIRED TOGETHER. SPLICES OF ADJACENT REINFORCING BARS SHALL BE STAGGERED WHEREVER POSSIBLE.
- I. ALL LUMBER SHALL BE NO. 2 GRADE DOUGLAS FIR, S4S. UNLESS NOTED OTHERWISE
- ROOF PLYWOOD SHALL MATCH EXISTING PLYWOOD SHEATHING WITH A PANEL SPAN RATING 32/16. EDGE NAIL WITH 8d AT 6" O.C. UNLESS NOTED OTHERWISE ON PLANS. NAIL WITH 8d AT 12" O.C. AT INTERMEDIATE SUPPORTS.
- 3. THE MAXIMUM MOISTURE CONTENT OF ALL LUMBER SHALL NOT EXCEED 19% AT THE TIME OF INSTALLATION.
- 4. MINIMUM NAILING SHALL COMPLY WITH TABLE 2304.9.1 OF CALIFORNIA BUILDING CODE. ALL NAILS SHALL BE COMMON WIRE NAILS.
- 5. ALL BOLTS SHALL HAVE STANDARD CUT WASHERS UNDER HEADS AND/OR NUTS WHERE IN CONTACT WITH WOOD.
   6. LAG BOLTS SHALL BE SCREWED INTO PLACE, NOT DRIVEN. LAG BOLTS SHALL BE INSTALLED IN PRE-DRILLED
- HOLES WITH A DIAMETER EQUAL TO 75% DIAMETER OF BOLTS.

  7. CONNECTORS: ALL SHEET METAL FRAMING CONNECTORS SHOWN IN THE PLANS SHALL BE SIMPSON
- STRONG-TIE CONNECTORS. SUBSTITUTIONS MAY BE MADE WHEN APPROVED BY THE STRUCTURAL ENGINEER.


  8. ALL LUMBER EXPOSED TO WEATHER OR IN CONTACT WITH MASONRY OR CONCRETE SHALL BE WOLMANIZED PRESSURE TREATED LUMBER OR A NATURALLY DECAY RESISTANT LUMBER SUCH AS REDWOOD OR CEDAR.





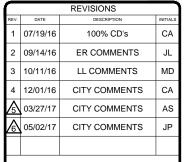

NOT FOR CONSTRUCTION UNLESS LABELED AS CONSTRUCTION SET

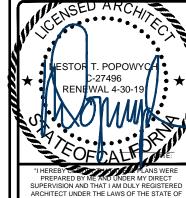

SD287 PACBELL-BLACK MOUNTAIN SD06287A 14565 BLACK MOUNTAIN ROAD SAN DIEGO, CA 92129

SHEET TITLE

**GENERAL NOTES** 

SHEET NUMBER

T-2

A. GENERAL

1. ALL PAINT PRODUCT LINES SHALL BE SHERWIN WILLIAMS UNLESS SPECIFICALLY NOTED OTHERWISE.

2. CONTRACTOR SHALL PREPARE ALL SURFACES AND APPLY ALL FINISHES PER LATEST EDITION OF

PAINTING NOTES & SPECIFICATIONS:

MANUFACTURER'S SPECIFICATIONS.
3. COMPLY WITH MANUFACTURER'S WRITTEN INSTRUCTIONS REGARDING SUFFICIENT DRYING TIME BETWEEN

COATS WITH PROVISIONS AS RECOMMENDED BY MANUFACTURER FOR EXISTING WEATHER CONDITIONS.

4. FINISH COLOR AND TEXTURE OF ALL PAINTED SURFACES SHALL MATCH EXISTING ADJACENT SURFACES UNLESS OTHERWISE NOTED.

5. ALL PAINT MATERIAL DATA SHEETS SHALL BE PROVIDED TO THE T-MOBILE CONSTRUCTION MANAGER

PREPARE PREVIOUSLY PAINTED SURFACE BY LIGHT SANDING WITH 400 GRIT SANDPAPER AND NON-HYDROCARBON WASH. PREPARE GALVANIZED SURFACES BY ACID ETCH OR SOLVENT CLEANING IN ACCORDANCE WITH SSPC-SP1.

 FURNISH DROP CLOTHES, SHIELDS, MASKING AND PROTECTIVE METHODS TO PREVENT SPRAY OR DROPPINGS FROM DAMAGING ADJACENT SURFACES AND FACILITIES.

 APPLY PAINT BY AIRLESS SPRAY, SANDING LIGHTLY BETWEEN EACH SUCCEEDING ENAMEL COAT ON FLAT SURFACES. APPLY MATERIAL TO ACHIEVE A COATING NO THINNER THAN THE DRY FILM THICKNESS INDICATED.

SURFACES, APPLY MATERIAL TO ACHIEVE A COATING NO THINNER THAN THE DRY FILM THICKNESS INDICATE
 APPLY BLOCK FILTER TO CONCRETE BLOCK CONSTRUCTION AT A RATE TO ENSURE COMPLETE COVERAGE
 WITH PORES COMPLETELY FILLED.

CONTRACTOR SHALL CORRECT RUNS, SAGS, MISSES AND OTHER DEFECTS INCLUDING INADEQUATE
COVERAGE AS DIRECTED BY THE T-MOBILE CONSTRUCTION MANAGER. REPAINT AS NECESSARY TO ACHIEVE
SURFACES WHICH ARE SMOOTH, EVENLY COATED WITH UNIFORM SHEEN AND FREE FROM BLEMISHES.
 B. COATING SYSTEM SPECIFICATIONS

 DTM ACRYLIC COATING (SERIES 866) BY SHERWIN WILLIAMS CO. 1MIL DFT PER COAT APPLIED IN TWO COATS OVER DTM BONDING PRIMER (B66A50).

 100% ACRYLIC, LATEX COATING EQUIVALENT TO A-100 (SERIES A-82) BY SHERWIN WILLIAMS CO. 1 DFT PER COAT APPLIED IN TWO COATS OVER SPECIFIED PRIMER.

PAINT & PRIMER

C. ANTENNAS

PRIMER - KEM AQUA E61-W525 TOPCOAT - COROTHANE II B65W200/B60V22

BTS CABINET

PRIMER - KEM AQUA E61-W525

TOPCOAT - COROTHANE II B65W200/B60V22

COAXIAL JUMPER CABLES

PRIMER - AS REQUIRED FOR ADHESION. APPLY ONE COAT OF KEM AQUA WATER REDUCIBLE PRIMER E61W25

REDUCED 25%

TOPCOAT - 2 COATS COROTHANE II POLYURETHANE B65W200/B60V2

RAW STE

PRIMER - KEM BOND HS B50WZ4, DMT ACRYLIC PRIMER

TOPCOAT - 2 COATS COROTHANE II POLYURETHANE B65W200/B60V2

GALVANIZED META

ACID ETCH WITH COMMERCIAL ETCH OR VINEGAR PRIMER COAT AND FINISH COAT (GALVITE HIGH SOLIDS OR DTM PRIMER/FINISH)

STAINLESS STEE

PRIMER - OTM WASH PRIMER, B71Y1

TOPCOATS - 2 COATS COROTHANE II POLYURETHANE B65W200/B60V2

PRE-PRIMED STEEL

TOUCH UP ANY RUST OR UN-PRIMED STEEL WITH KEM BOND HS, SS0WZ4

ALUMINUM & COPPER

PRIMER - DTM WASH PRIMER, B71Y1

TOPCOAT - 2 COATS COROTHANE II POLYURETHANE B65W200/B60V2

CONCRETE MASONRY

PRIMER - PRO MAR EXTERIOR BLOCK FILLER

TOPCOAT - 2 COATS A-100 LATEX HOUSE & TRIM, SHEEN TO MATCH

CONCRETE STUCCO (EXISTING)

2 COATS A-100 LATEX HOUSE & TRIM, SHEEN TO MATCH

STUCCO

PRIMER - PRO MAR MASONRY CONDITIONED B-46 W21000 TOPCOAT - SUPERPAINT A-80 SERIES A-89 SATIN A-84 GLOSS

WOO

PRIMER - A-100 EXTERIOR ALKYD W009D PRIMER Y-24W20 TOPCOAT - 2 COATS A-100 LATEX HOUSE & TRIM SHEEN TO MATCH ADJACENT SURFACES

FIELD CUTS/ DAMAGE (PRIOR TO PRIME & PAINT)

FIRST & SECOND COAT - CUPRINOL CLEAR WOOD PRESERVATIVE #158-0356 ALL PENETRATIONS INTO FINISHED CLU-LAMS SHALL BE CAULKED WITH "SIKAFLEX" SEALANT

STEEL TOUCH UP

STEEL THAT HAS BEEN WELDED, CUT OR SCRATCHED IN THE FIELD SHALL BE TOUCHED UP WITH COLD GALVANIZED PAINT.

### **BATTERY NOTES:**

A. QUANTITIES OF 500 GAL. OR LESS ARE EXEMPT PER TABLE 3-E OF THE 1997 U.B.C.

B. SINGLE VESSEL CAPACITIES OF 20 GAL. OR LESS, AND AGGREGATE QUANTITIES NOT IN EXCESS OF 100 GAL. ARE EXEMPT PER ARTICLE 64 OF THE 2013 C.F.C.

C. QUANTITIES LESS THAN 50 GAL. ARE EXEMPT FROM C.F.C. ARTICLE 80, AND SHALL NOT REQUIRE

D. ANY CHANGES OR ADDITIONS TO BACK-UP BATTERIES MUST COMPLY WITH 2013 C.F.C. ARTICLE 64, AND SHALL NOT CONTAIN ELECTROLYTE QUANTITIES IN EXCESS OF 50

### FIRE DEPARTMENT NOTES:

A. FIRE DEPARTMENT FINAL INSPECTION REQUIRED. SCHEDULE INSPECTION 2 DAYS IN ADVANCE.

B. A CFC PERMIT TO OPERATE BATTERY SYSTEMS WITH STATIONARY LEAD-ACID BATTERIES IS NOT REQUIRED FOR THE QUANTITIES ON SITE

C. A CFC PERMIT MAY BE REQUIRED FOR THE HAZARDOUS MATERIALS ON SITE.

D. A HAZARDOUS MATERIALS IDENTIFICATION SIGN IS REQUIRED FOR ALL ENTRANCES INTO BATTERY STORAGE AREAS. LETTERS MUST BE AT LEAST 1" IN HEIGHT AND IN A COLOR WHICH CONTRASTS TO THE BACKGROUND OF THE SIGN AND LIST THE FOLLOWING: "CLASS 1 WATER REACTIVE LIQUID TOXIC LIQUID CORROSIVE LIQUID OTHER HEALTH HAZARD LIQUID"

E. AN APPROVED METHOD TO NEUTRALIZE SPILLED ELECTROLYTE SHALL BE PROVIDED IN THE BATTERY ROOM.

F. BATTERIES SHALL BE PROVIDED WITH SAFETY VENTING CAPS.

G. LOCATIONS AND CLASSIFICATIONS OF EXTINGUISHERS SHALL BE IN ACCORDANCE WITH THE UNIFORM FIRE CODE STANDARD 10-1 AND PLACEMENT IS SUBJECT TO APPROVAL OF THE FIRE INSPECTOR.

H. STORAGE, DISPENSING OR USE OF ANY FLAMMABLE AND COMBUSTIBLE LIQUIDS, FLAMMABLE AND COMPRESSED GASES, AND OTHER HAZARDOUS MATERIALS SHALL COMPLY WITH UNIFORM FIRE CODE REGULATIONS

I. EXIST DOORS SHALL BE ABLE TO OPEN FROM THE INSIDE WITHOUT THE USE OF KEY OR ANY SPECIAL KNOWLEDGE OR EFFORT.

J.ADDRESS NUMBERS SHALL BE A MINIMUM 6 INCHES HIGH AND PLAINLY VISIBLE FROM ROADWAY BUILDING IS ADDRESSED ON.

K. REQUIRED SIGNAGE SHALL INCLUDE LETTERING HEIGHT OF AT LEAST ONE INCH, IN A COLOR THAT CONTRASTS TO THE SIGN BACKGROUND, AND SHALL BE PROMINENTLY DISPLAYED.


L.REQUIRED SIGNAGE SHALL INCLUDE, BUT MAY NOT BE LIMITED TO, APPLICABLE TYPES FROM EXAMPLES SHOWN HEREIN (SEE SIGNAGE).





REVISIONS			
REV.	DATE	DESCRIPTION	INITIALS
1	07/19/16	100% CD's	CA
2	09/14/16	ER COMMENTS	JL
3	10/11/16	LL COMMENTS	MD
4	12/01/16	CITY COMMENTS	CA
$\sqrt{5}$	03/27/17	CITY COMMENTS	AS
<b>∧</b>	05/02/17	CITY COMMENTS	JP

NOT FOR CONSTRUCTION UNLESS LABELED
AS CONSTRUCTION SET

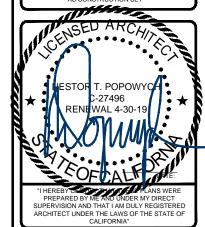

SD287 PACBELL-BLACK MOUNTAIN SD06287A 14565 BLACK MOUNTAIN ROAD SAN DIEGO, CA 92129

SHEET TITLE

GENERAL NOTES


SHEET NUMBER

T-3

GROUND

HEADER

HEIGHT

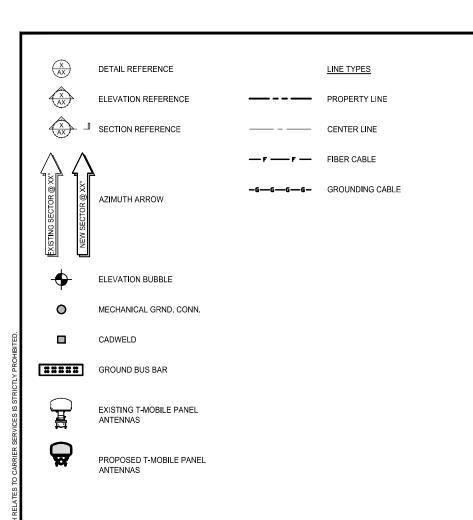

LEGEND

CONSTRUCTION DRAWINGS: SD06337A - PacBell-Black Mount\_CD100\_Rev0\_For Submittal\_08122015, BY: ZALZALI; 08/12/2015

SCALE

N.T.S.

- SCOPE OF WORK: RFDS\_SD06337A\_6\_(L700)\_Signed\_040816
- SITE WALK: 06/03/2016
- SITE SURVEY: NO CURRENT SURVEY AVAILABLE
  BATTERY INFORMATION: SD06337A\_Other\_SD06337A SITE SURVEY FORM\_BDR; 04/19/2012

### **NOTICE**



Radio frequency fields beyond this point may exceed the FCC general public exposure limit.

Obey all posted signs and site guidelines for working in radio frequency environments.

**CAUTION** 



## WARNING


CORROSIVE LIQUID TOXIC LIQUID CLASS 1 WATER REACTIVE LIQUID

SITE NUMBER:SD06287A

1-866-400-6040

PACBELL-BLACK MOUNTAIN



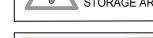

THIS FACILITY CONTAINS

IN CASE OF **EMERGENCY** CALL

SITE NAME: SD287



INFORMATION SIGN



Beyond this point: Radio frequency fields at this site may exceed FCC rules for human exposure.

For your safety, obey all posted signs and site guidelines for working in radio

frequency environments.



Beyond this point: Radio frequency fields at this site exceed the FCC rules for human exposure.

Failure to obey all posted signs and site guidelines for working in radio frequency environments could result in serious injury In accordance with Federal Communications Con radio frequency emissions 47 CFR 1.1307 (b)

**ALERTING SIGNS** 

### ABBREVIATION DEFINITION

ANCHOR BOLT

AIR CONDITIONING

ABOVE

ΑB

ABV.

FDN.

F.C. F.M.

F..S.

F.W.

F.S. FT. (') FTG.

GA. GI.

G.F.I.

GRC.

FOUNDATION

FACE OF STUD

FACE OF WALL

FOOT(FEET) FOOTING

GENERATOR

GAUGE GALVANIZE(D)

FACE OF CONCRETE

FACE OF MASONRY

FINISHED SURFACE

GROUND FAULT INTERRUPTER

GLOBAL POSITIONING SYSTEM

GROWTH RADIO CABINET

AC	AIR CONDITIONING	HGR.	HEIGHT
ACU	AIR CONDITIONING UNIT	ICGB.	ISOLATED COPPER GROUND BU
ACCA	ANTENNA CABLE COVER ASSY.	IGR	INTERIOR GROUND RING
ADD'L	ADDITIONAL	IN. (")	INCH(ES)
A.F.F.	ABOVE FINISHED FLOOR	INT.	INTERIOR
A.F.G.	ABOVE FINISHED GRADE	LB. (#)	POUND(S)
A.G.L.	ABOVE GRADE LEVEL	L.B.	LAG BOLTS
ALUM.	ALUMINUM	L.F.	LINEAR FEET (FOOT)
ALT.	ALTERNATE	L.	LONG(ITUDINAL)
ANT.	ANTENNA	MGB	MASTER GROUND BUS
APPRX.	APPROXIMATE(LY)	MAS.	MASONRY
APX	APEX	MAX.	MAXIMUM
ARCH.	ARCHITECT(URAL)	M.B.	MACHINE BOLT
ASSY.	ASSEMBLY	MECH.	MECHANICAL
AWG.	AMERICAN WIRE GAUGE	MFR.	MANUFACTURER
BCN	BEACON	MIN.	MINIMUM
BD.	BOLLARD	MISC.	MISCELLANEOUS
BDK	BRASS DISK	MTL.	METAL
BLDG.	BUILDING	MW	MICROWAVE
BLK.	BLOCK	(N)	NEW
BLKG.	BLOCKING	NÓ. (#)	NUMBER
BM	BEAM / BENCH MARK	N.T.S.	NOT TO SCALE
B.N.	BOUNDARY NAILING	0.C	ON CENTER
BTCW.	BARE TINNED COPPER WIRE	OH.	OVERHEAD
B.O.F.	BOTTOM OF FOOTING	OHP	OVERHEAD POWER LINE
BTM.	BOTTOM	OPNG.	OPENING
BRC.	BRACE	P/C	PRECAST CONCRETE
BTS	BASE TRANSCEIVER STATION	PLY.	PLYWOOD
B.W.F.	BARBED WIRE FENCE	PPC	POWER PROTECTION CABINET
B/U	BACK-UP CABINET	P.S.F.	POUNDS PER SQUARE FOOT
CAB.	CABINET	P.S.I.	POUNDS PER SQUARE INCH
CANT.	CANTILEVER(ED)	P.T.	PRESSURE TREATED
C.I.P.	CAST IN PLACE	PWR.	POWER (CABINET)
C.L.F.	CHAIN LINK FENCE	QTY.	QUANTITY
CLG.	CEILING	R.	RADIUS
CLR.	CLEAR	RAD. CTR.	RADIATION CENTER
COL.	COLUMN	RBS	RADIO BASE STATION
CONC.	CONCRETE	REF.	REFERENCE
CONN.	CONNECTION(OR)	REINF	REINFORCEMENT(ING)
		REQD.	
CONST.	CONSTRUCTION		REQUIRED
CONT.	CONTINUOUS	RF	RADIO FREQUENCY
CPD	CONCRETE PAD	RGS	RIGID GALVANIZED STEEL
C.T.	CABLE TRAY	RRU	REMOTE RADIO UNIT
d	PENNY (NAILS)	RRH	REMOTE RADIO HEAD
DBL.	DOUBLE	SCH.	SCHEDULE
DEF.	DEFINITION	SHT.	SHEET
DEPT.	DEPARTMENT	SIM.	SIMILAR
DF	DOUGLAS FIR	SPEC	
			SPECIFICATION(S)
DIA. (Ø)	DIAMETER	SP	STEEL PLATE
DIAG.	DIAGONAL	SQ.	SQUARE
DIM.	DIMENSION	S.S.	STAINLESS STEEL
DR.	DOOR	STD.	STANDARD
DWG.	DRAWING(S)	STL.	STEEL
DWL.	DOWEL(S)	STRUC.	STRUCTURAL
EA.	EACH	T.B.D.	TO BE DETERMINED
EBX	ELECTRICAL BOX	T.B.R.	TO BE RESOLVED
EG		TEMP	TEMPORARY
	EQUIPMENT GROUND		
EGR	EQUIPMENT GROUND RING	THK.	THICK(NESS)
EL.	ELEVATION	TMA	TOWER MOUNTED AMPLIFIER
ELEC.	ELECTRICAL	T.N.	TOE NAIL
ELEV.	ELEVATOR	T.O.A.	TOP OF ANTENNA
EM	ELECTRICAL METER	T.O.C.	TOP OF CURB
E.M.T.	ELECTRICAL METALLIC TUBING	T.O.F	TOP OF FOUNDATION
E.O.P.	EDGE OF PAVEMENT	T.O.P.	TOP OF PLATE (PARAPET)
EQ. (=)	EQUAL	T.O.S.	TOP OF STEEL
EVLT	ELECTRICAL VAULT	T.O.W.	TOP OF WALL
ENG.	EXPANSION	TWR.	TOWER
EXST.	EXISTING	TYP.	TYPICAL
EXT.	EXTERIOR	U.G.	UNDER GROUND
FAB.	FABRICATION(OR)	U.L.	UTILITY POLE
F.N.	FINISH FLOOR	U.N.O.	UNLESS NOTED OTHERWISE
F.O.	FINISH GRADE	V.I.N.	VERIFY IN FIELD
FIN.	FINISH(ED)	W.	WIDE(WIDTH)
	. ,		
FLR.	FLOOR	WD.	WOOD

W.P.

WEIGHT

WEATHERPROOF

GRND.

HDR.

HGR.





5015 SHOREHAM PLACE, SUITE 150 SAN DIEGO, CA 92122

REVISIONS CA 07/19/16 100% CD's 09/14/16 ER COMMENTS 3 10/11/16 LL COMMENTS CITY COMMENTS 4 12/01/16

NOT FOR CONSTRUCTION UNLESS LABELED AS CONSTRUCTION SET

CITY COMMENTS

CITY COMMENTS

03/27/17

6 05/02/17



SD287 PACBELL-BLACK MOUNTAIN SD06287A 14565 BLACK MOUNTAIN ROAD SAN DIEGO, CA 92129

SHEET TITLE

REFERENCED DOCUMENTS, SIGNAGE, ABBREVIATIONS, & LEGEND

SHEET NUMBER

T-4

SCALE SCALE REFERENCED DOCUMENTS 3 SIGNAGE **ABBREVIATIONS** 2



T-Mobile West LLC A subsidiary of T-Mobile USA Inc. 10509 Vista Sorrento Parkway, #206 San Diego, CA 92121

January 14, 2016

City of San Diego Development Services Department 1222 First Avenue, MS 301 San Diego, CA 92101

·· T··Mobile·

Re: Letter of Authorization for Obtaining Land Use Entitlements

To Whom it May Concern,

T-Mobile hereby authorizes SAC Wireless, its employees, agents, and contractors to file and complete any applications necessary to obtain required land use entitlements on T-Mobile's behalf for all T-Mobile projects.

If you have any questions or concerns, please contact me at (858) 334-6112.

Regards,

Joseph Rose

Joey Rose, Esq.

Site Development Manager T-Mobile USA

😂 at&t

### LETTER OF AUTHORIZATION

THE CITY OF SAN DIEGO 1222 First Avenue, MS 301 San Diego, CA 92101

Re: APPLICATION FOR ZONING/USE/BUILDING PERMIT

Pacific Bell Telephone Company, dba AT&T California ("AT&T"), as owner of the below-described property, does hereby appoint **T-Mobile** ("TMO"), as agent for the purpose of consummating any application necessary to ensure TMO's ability to use and/or construct improvements to the property licensed to it, for the purpose of modifying its existing wireless communications site. AT&T and TMO both understand that the application may be denied, modified, or approved with conditions, and that such conditions or modifications must be complied with prior to issuance of building permits

TMO understands and acknowledges that any construction of improvements is subject to the full execution of a license agreement with AT&T, and that any action on the part of TMO to proceed with any applications with governmental agencies is at TMO's sole risk and liability. TMO shall protect, defend, indemnify and hold AT&T and its parent, affiliates and its and their directors, officers, employees, successors and assigns free and harmless from and against any and all injury, damage, loss, liability, lien, penalty, claim or expense ("Liabilities") including without limitation, attorneys' fees, expert witness fees and legal costs suffered by reason of any claim, cause of action, suit or judgment, Liabilities as a result of injury to or death of any person, of damage to or loss or destruction of any property, violation of any laws affecting or concerning any properties owned by AT&T, claims for personal injury, emotional distress, infringement of any patent, trademark, copyright, trade secret or other legally protected proprietary right, which arises out of, is occasioned by or in any way attributable to the acts or omissions of TMO, its agents or contractors in connection with this Letter of Authorization, except to the extent caused by the active negligence or willful misconduct of AT&T, its agents or contractors.

Property Location: 0 5.4 MI WNW/O BLK MTN

Signature of Property Owner: PACIFIC BELL TELEPHONE COMPANY

San Diego, CA 92029

Assessor's Parcel Number(s): 312-010-39-00


Title: Area Manager, Network Engineering & Sales Support

September 13, 2016

5015 SHOREHAM PLACE, SUITE 150 SAN DIEGO, CA 92122

REVISIONS CA 1 07/19/16 100% CD's 2 09/14/16 ER COMMENTS 3 10/11/16 LL COMMENTS CITY COMMENTS 4 12/01/16 5 03/27/17 CITY COMMENTS 6 05/02/17 CITY COMMENTS

NOT FOR CONSTRUCTION UNLESS LABELED AS CONSTRUCTION SET

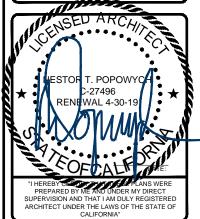

SD287 PACBELL-BLACK MOUNTAIN SD06287A 14565 BLACK MOUNTAIN ROAD SAN DIEGO, CA 92129


SHEET TITLE


LETTER OF AUTHORIZATION


SHEET NUMBER

T-5

SCALE 2 NOT USED SCALE LETTER OF AUTHORIZATION

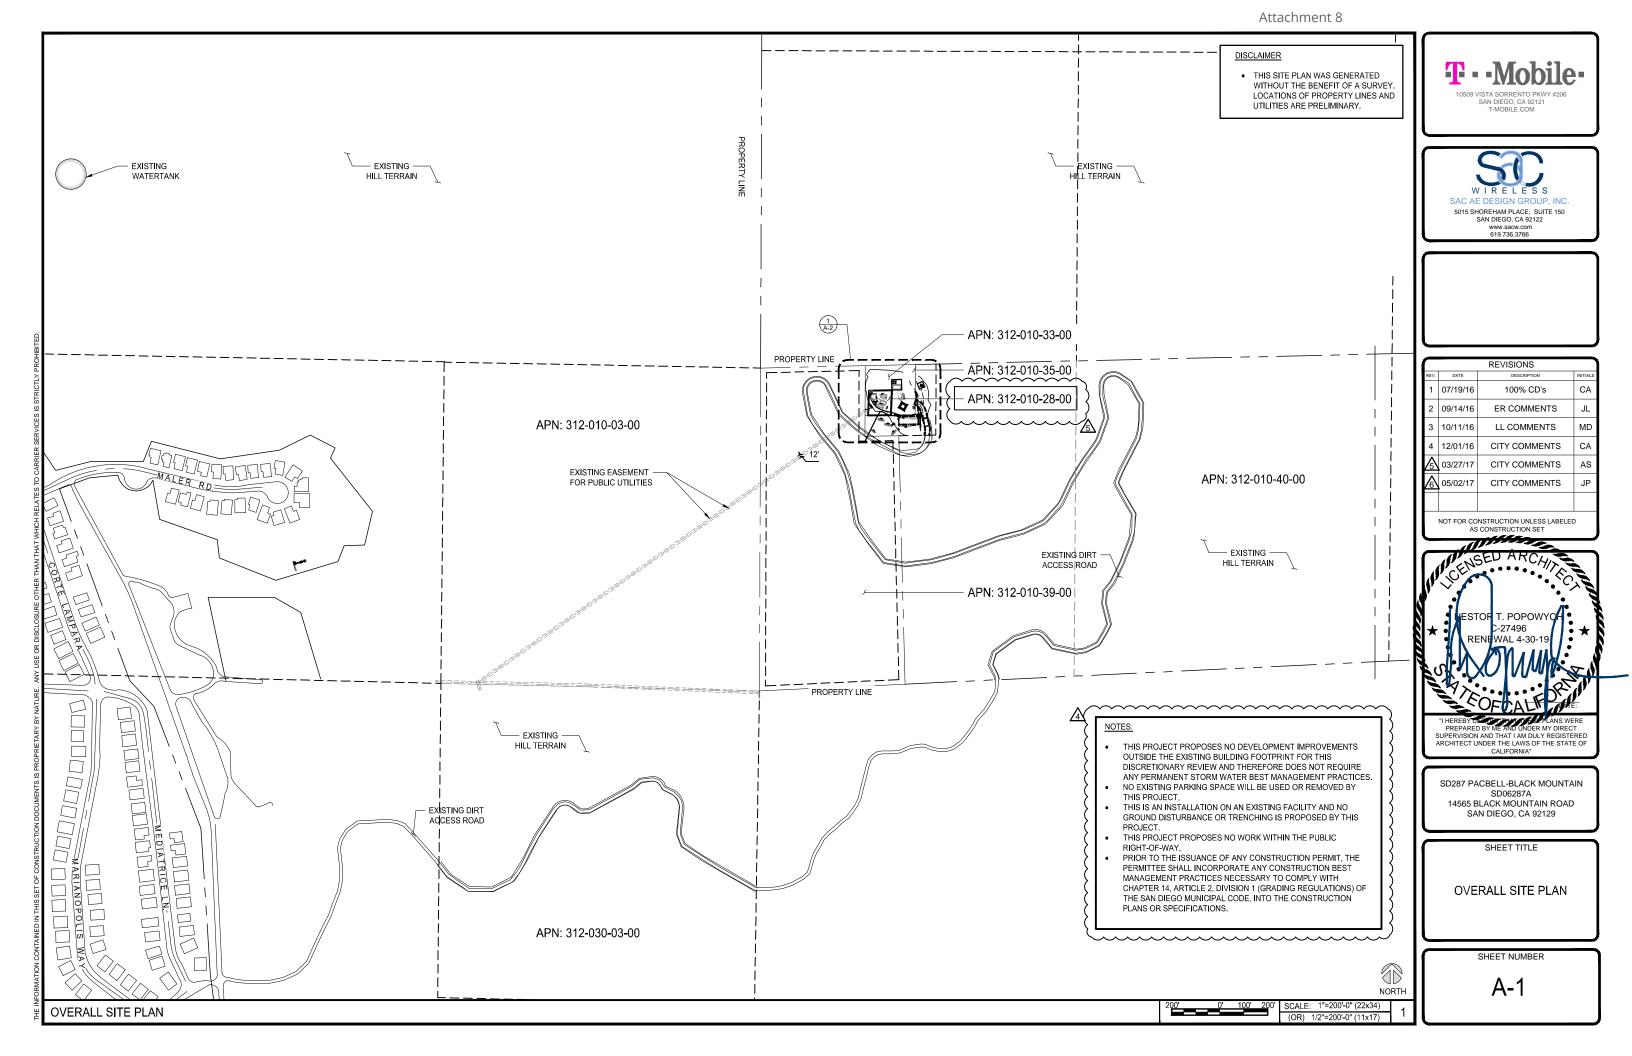

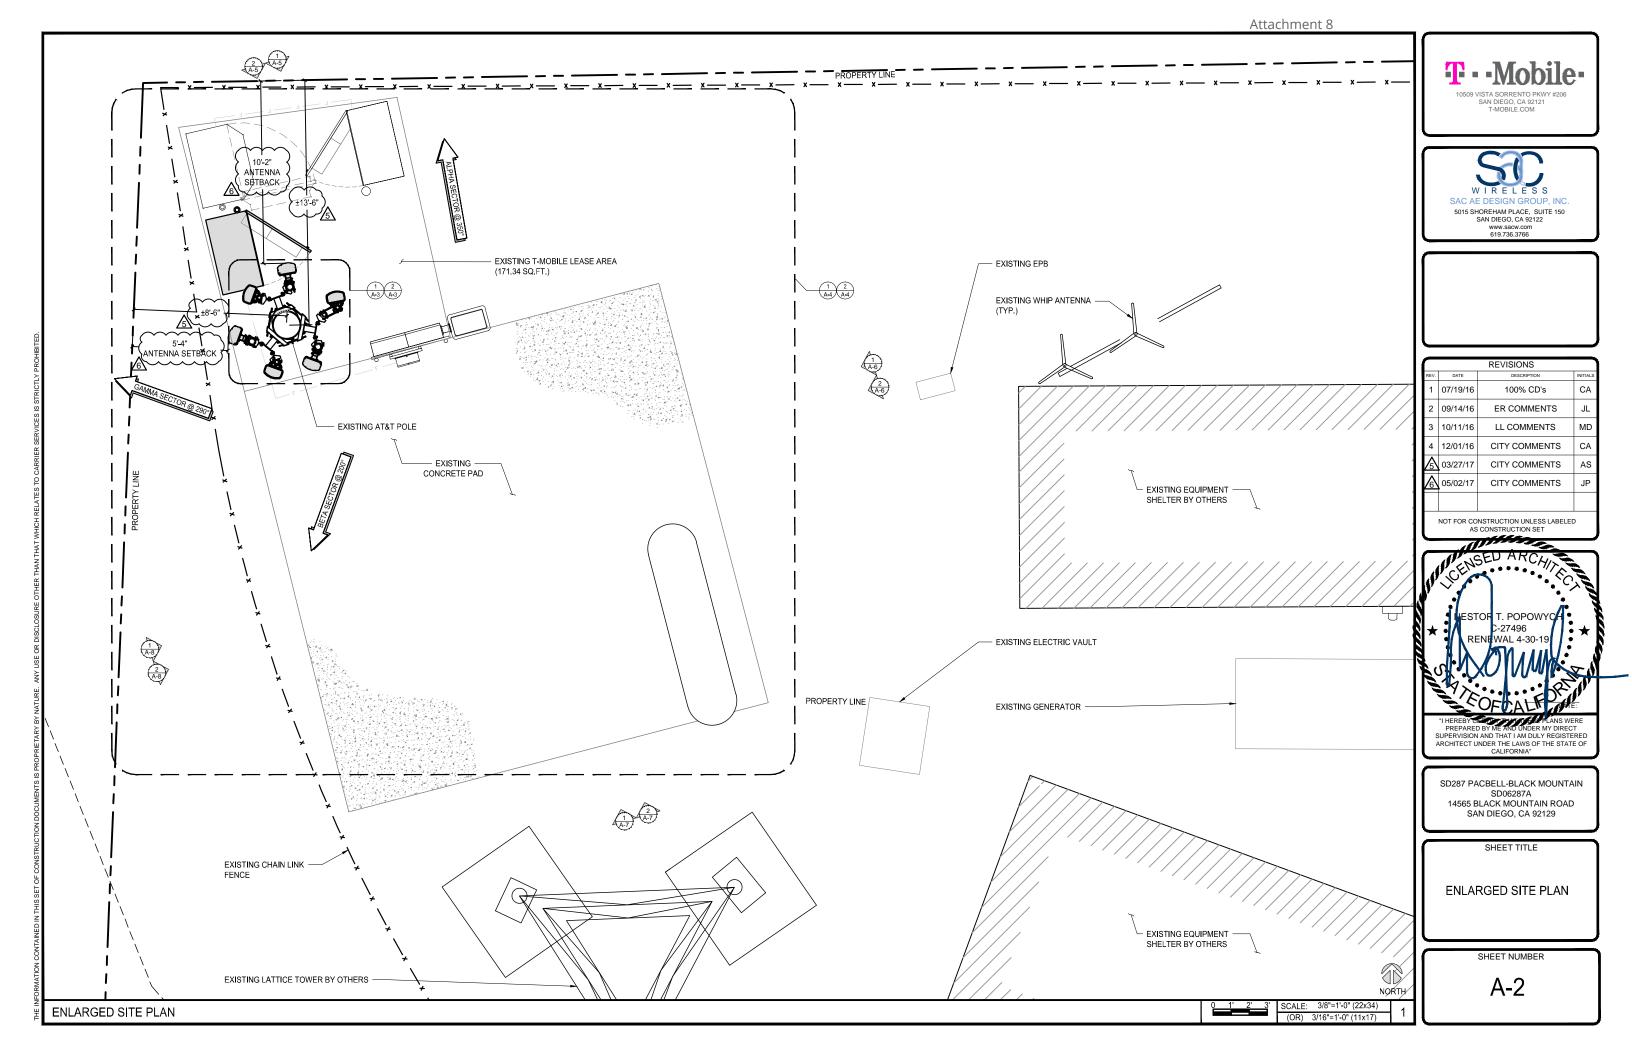


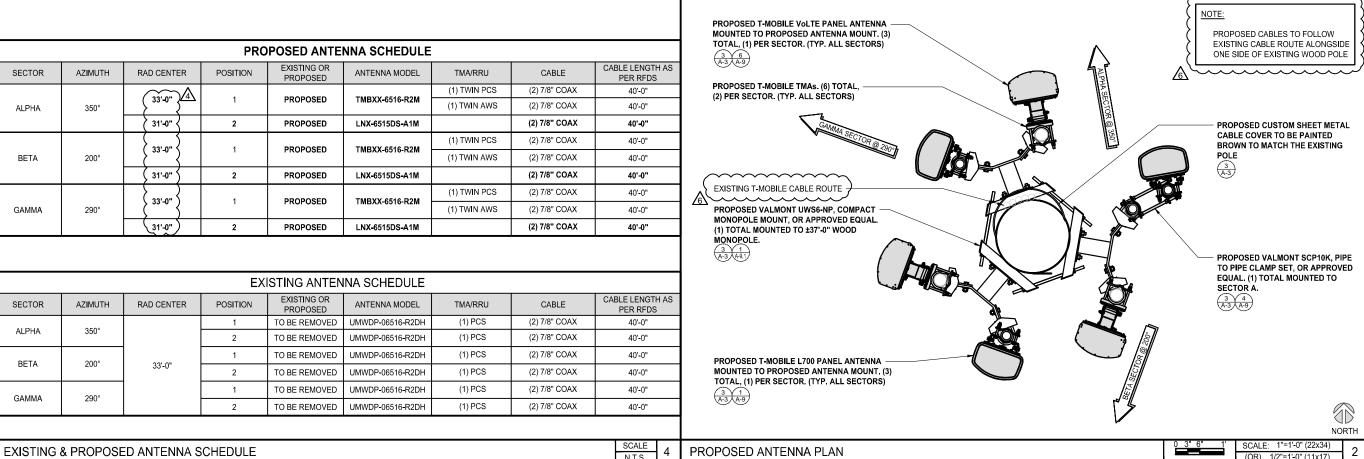

SAN DIEGO, CA 92122

1	REVISIONS					
П	REV.	DATE	DESCRIPTION	INITIALS		
	1	07/19/16	100% CD's	CA		
	2	09/14/16	ER COMMENTS	JL		
	3	10/11/16	LL COMMENTS	MD		
	4	12/01/16	CITY COMMENTS	CA		
	ß	03/27/17	CITY COMMENTS	AS		
	<u>^</u> 6	05/02/17	CITY COMMENTS	JP		
Ш						

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SHEET TITLE

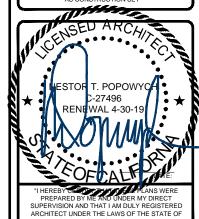
**EXISTING & PROPOSED** ANTENNA PLANS, MOUNTING DETAIL, & ANTENNA SCHEDULES


SHEET NUMBER


A-3


NORTH


SCALE: 3/4"=1'-0" (22x34) (OR) 3/8"=1'-0" (11x17)

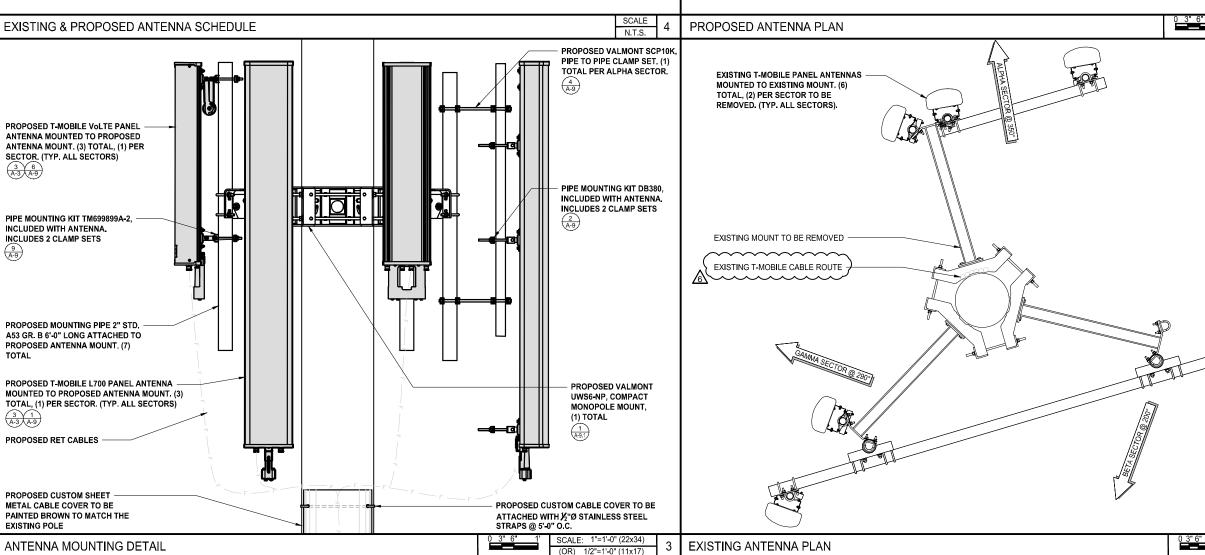


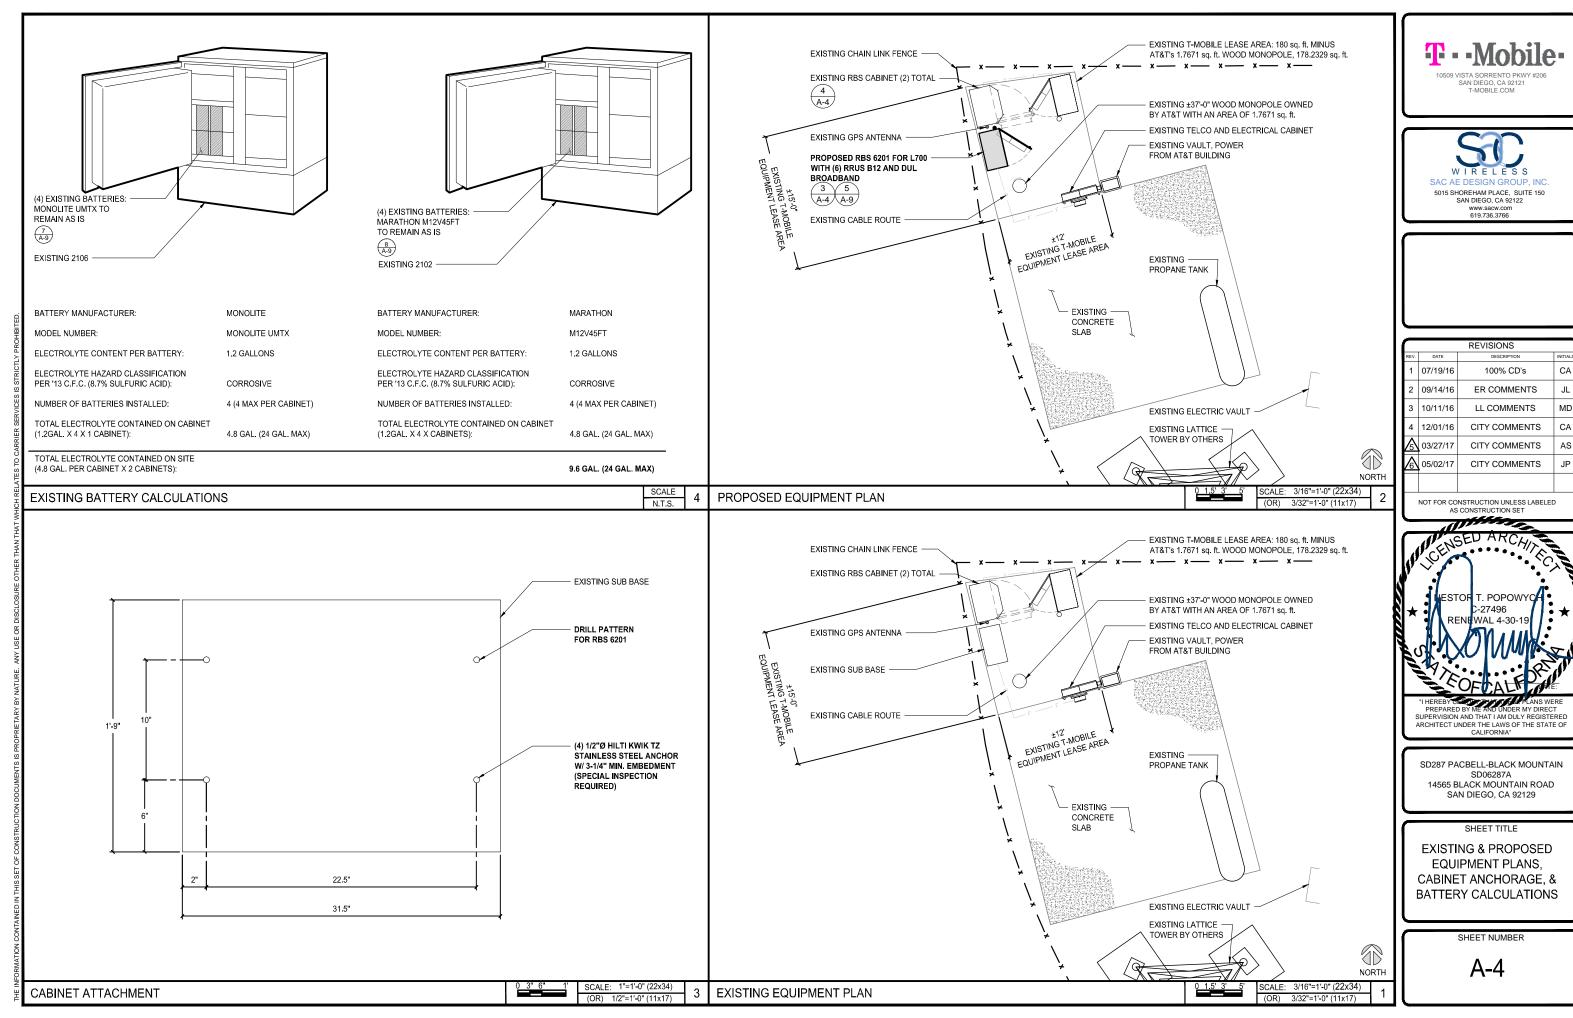


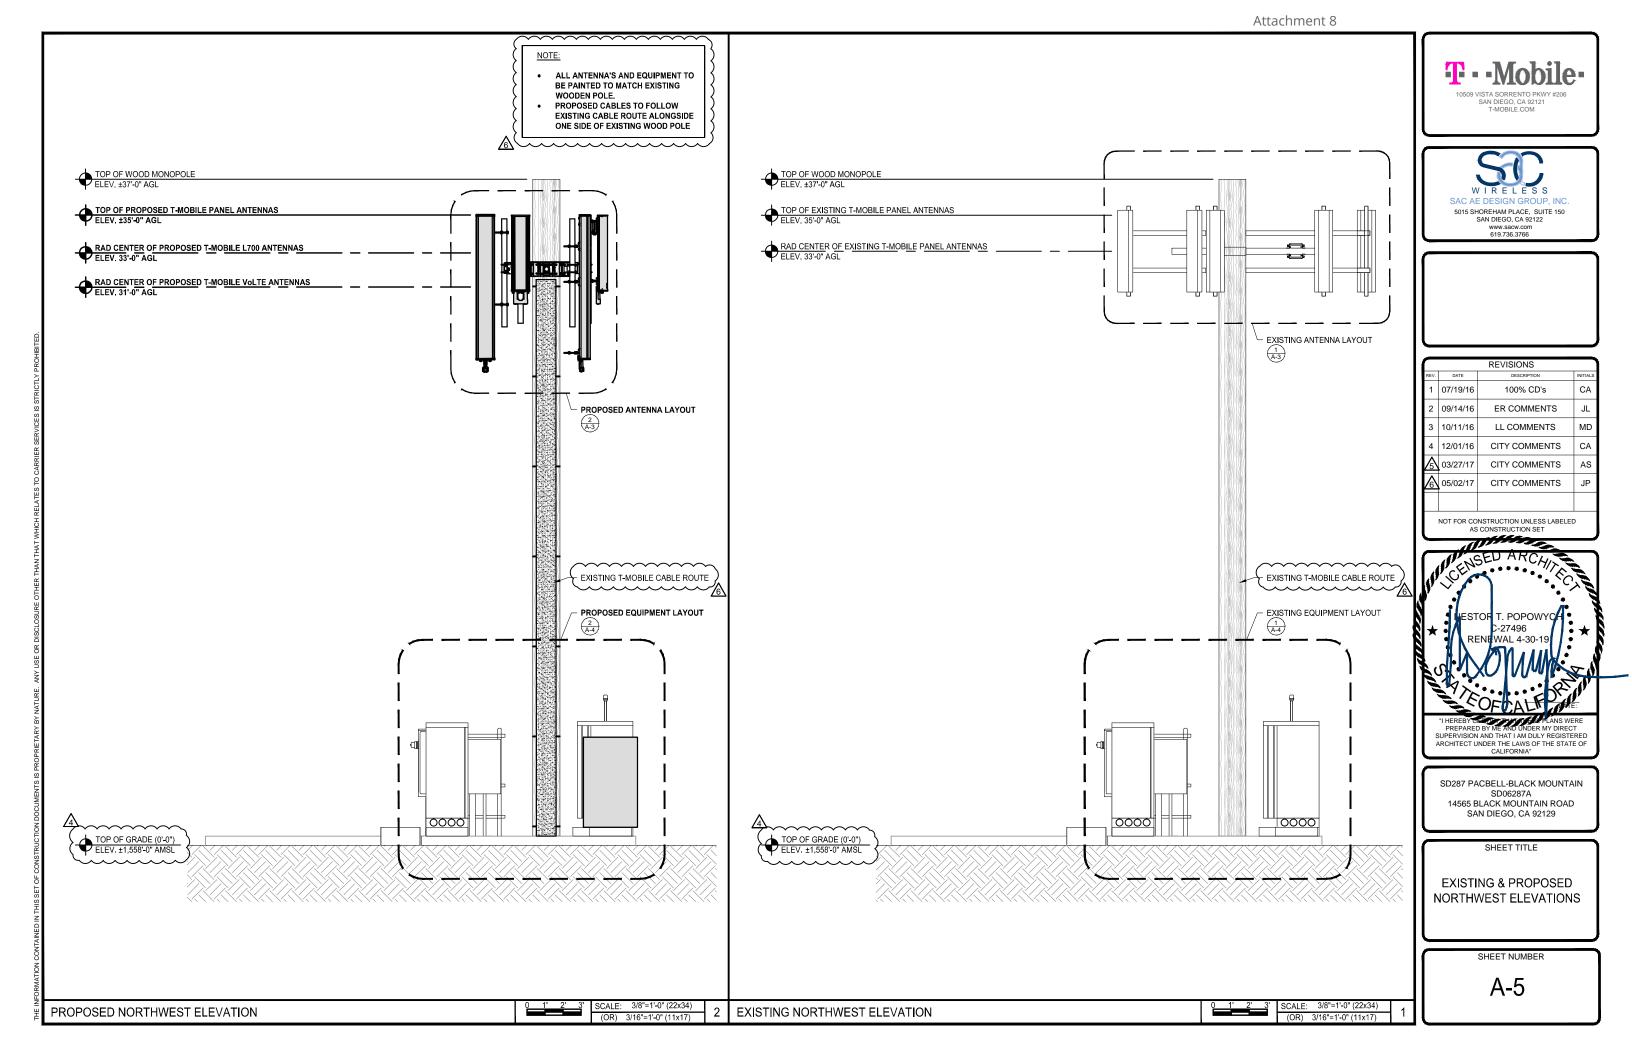


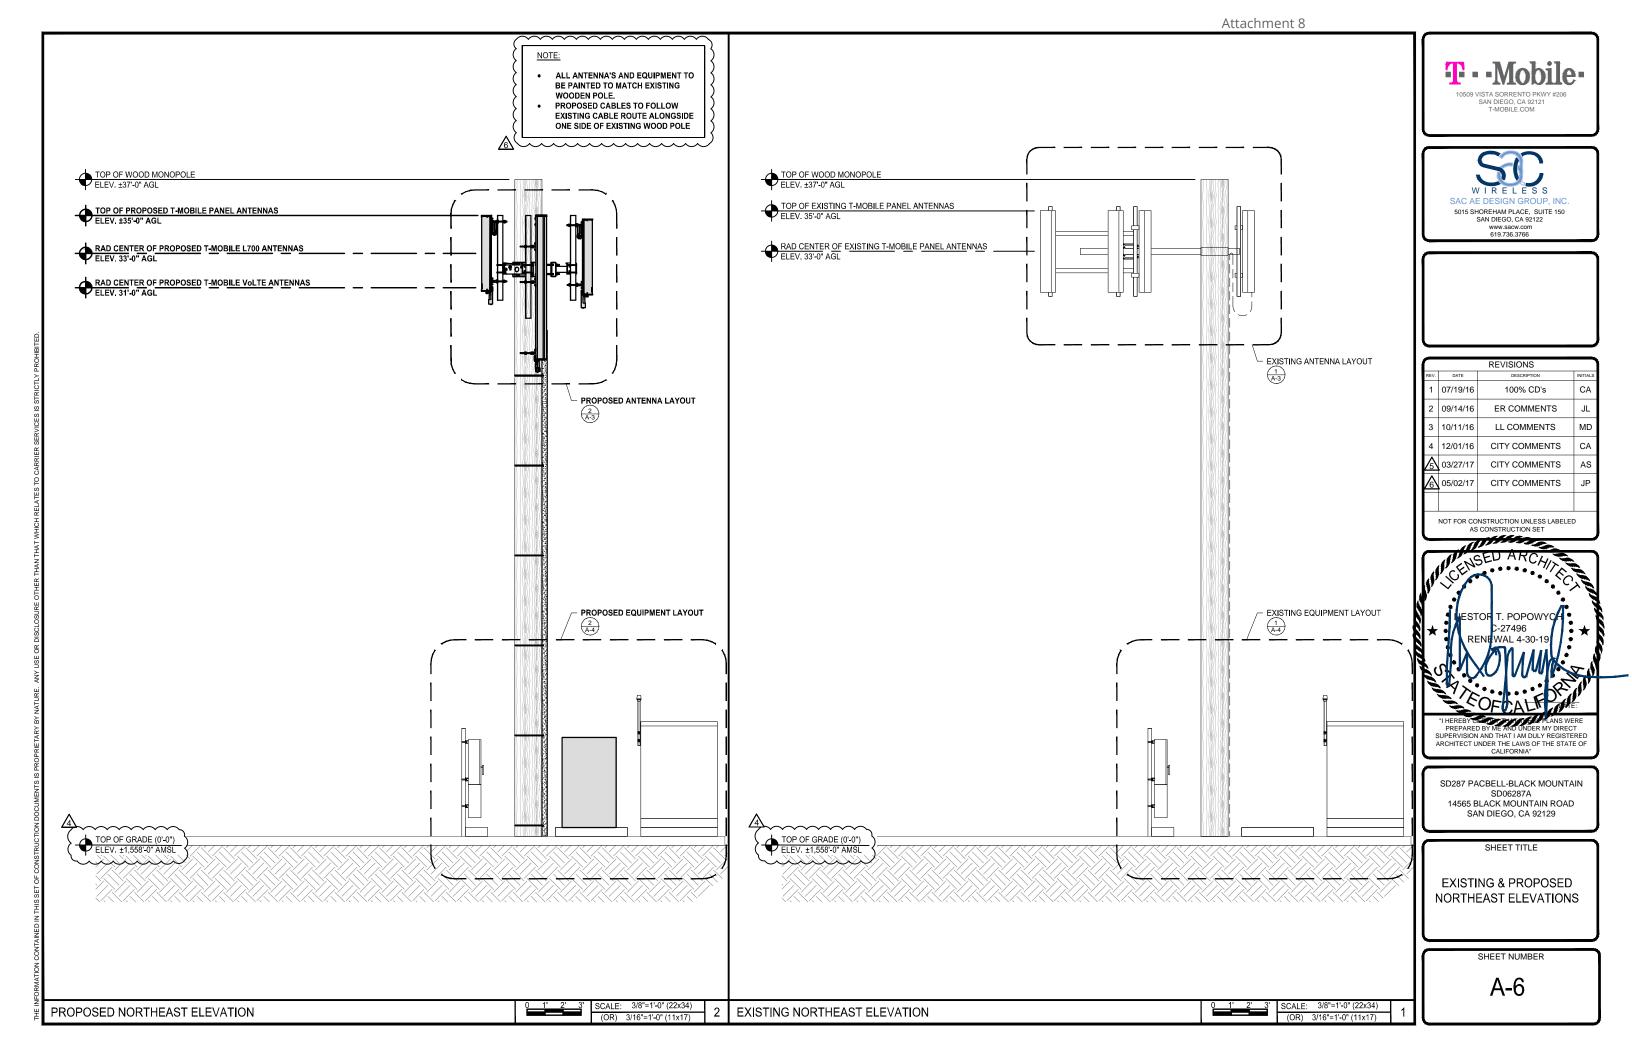


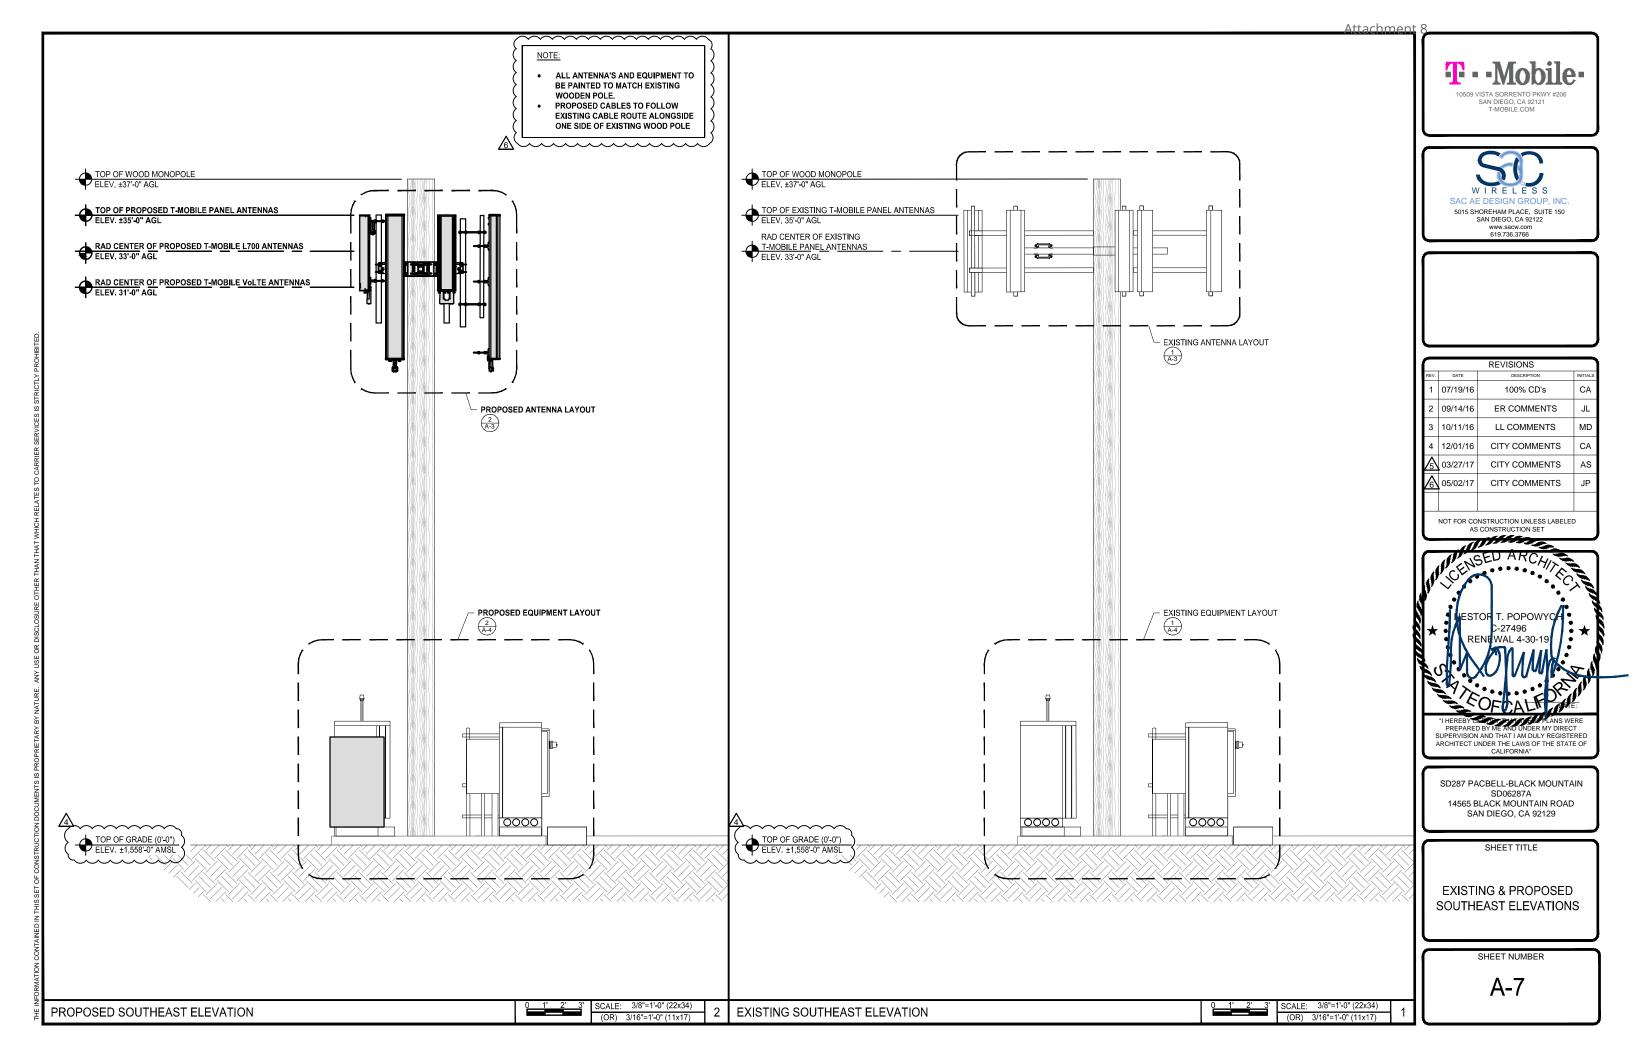


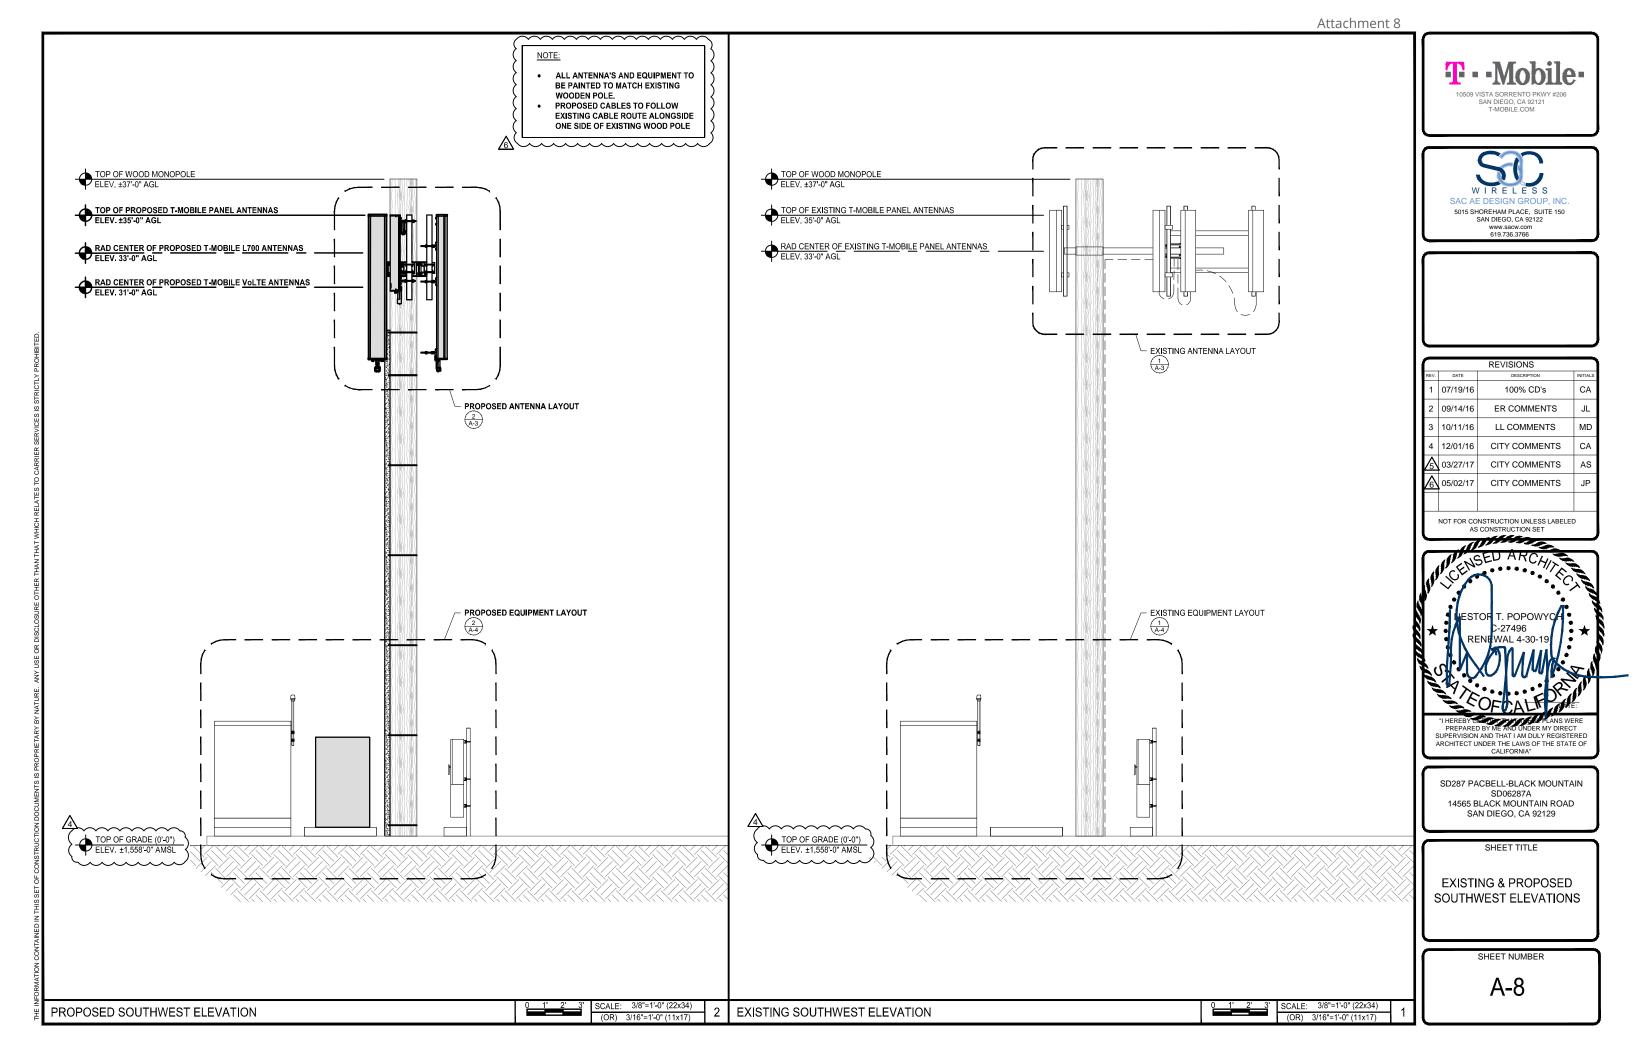

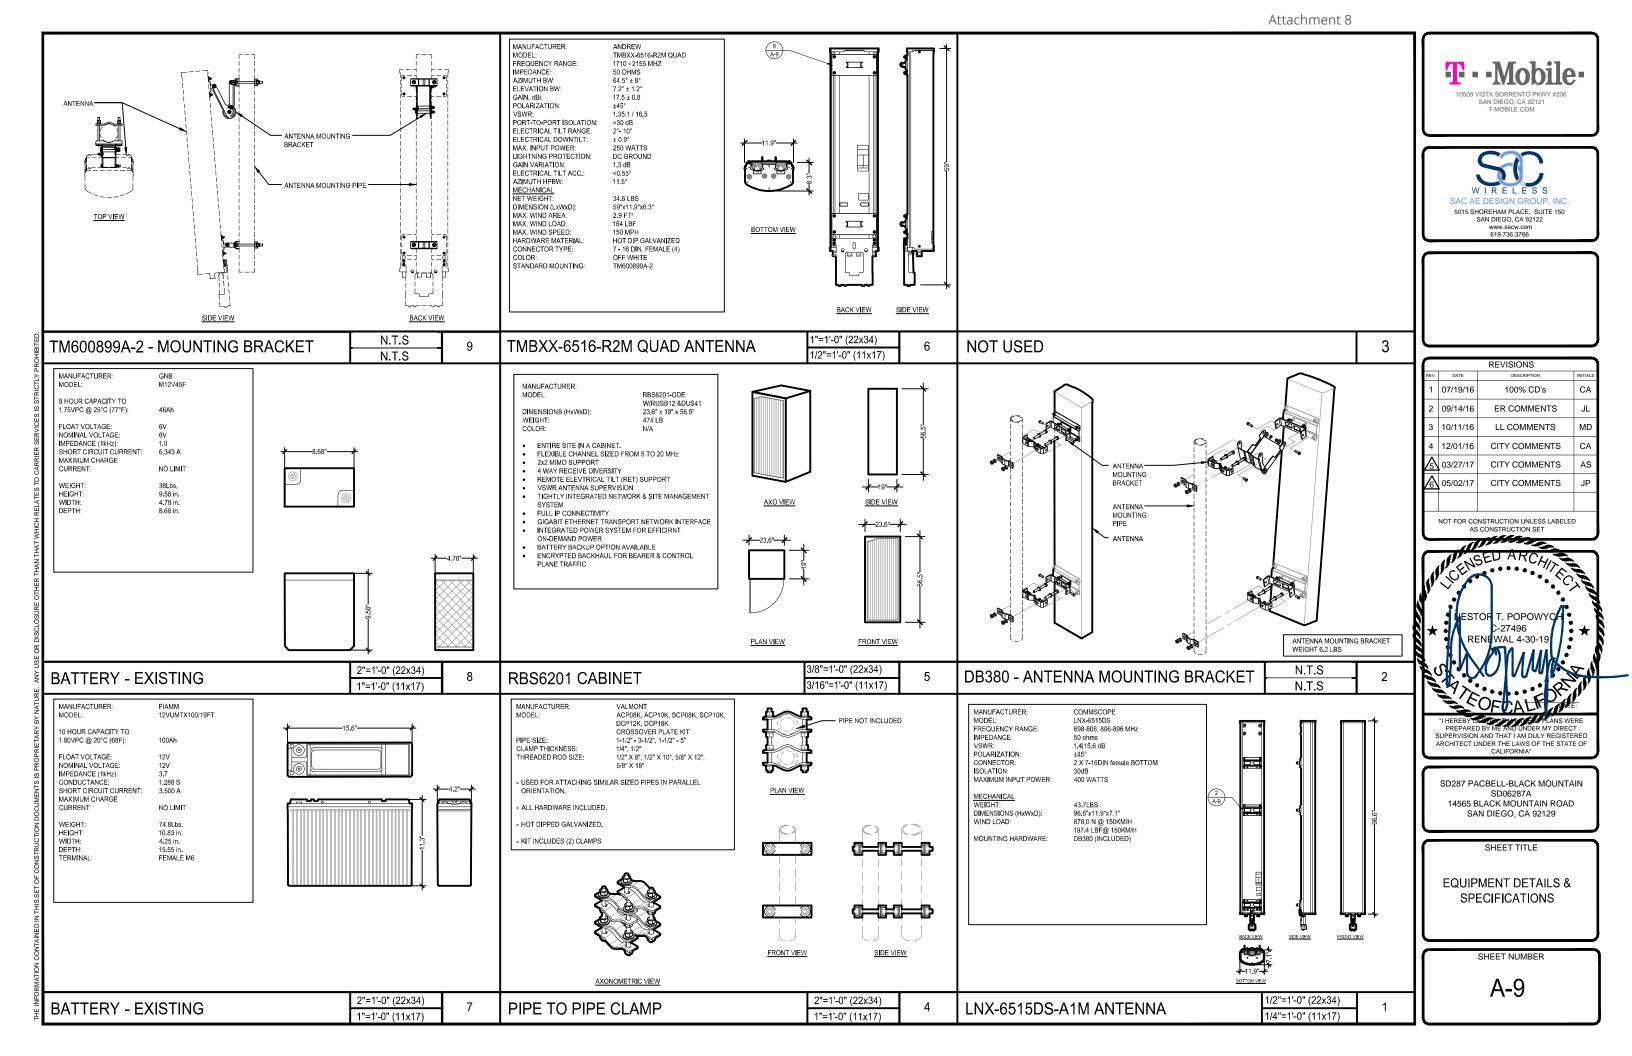

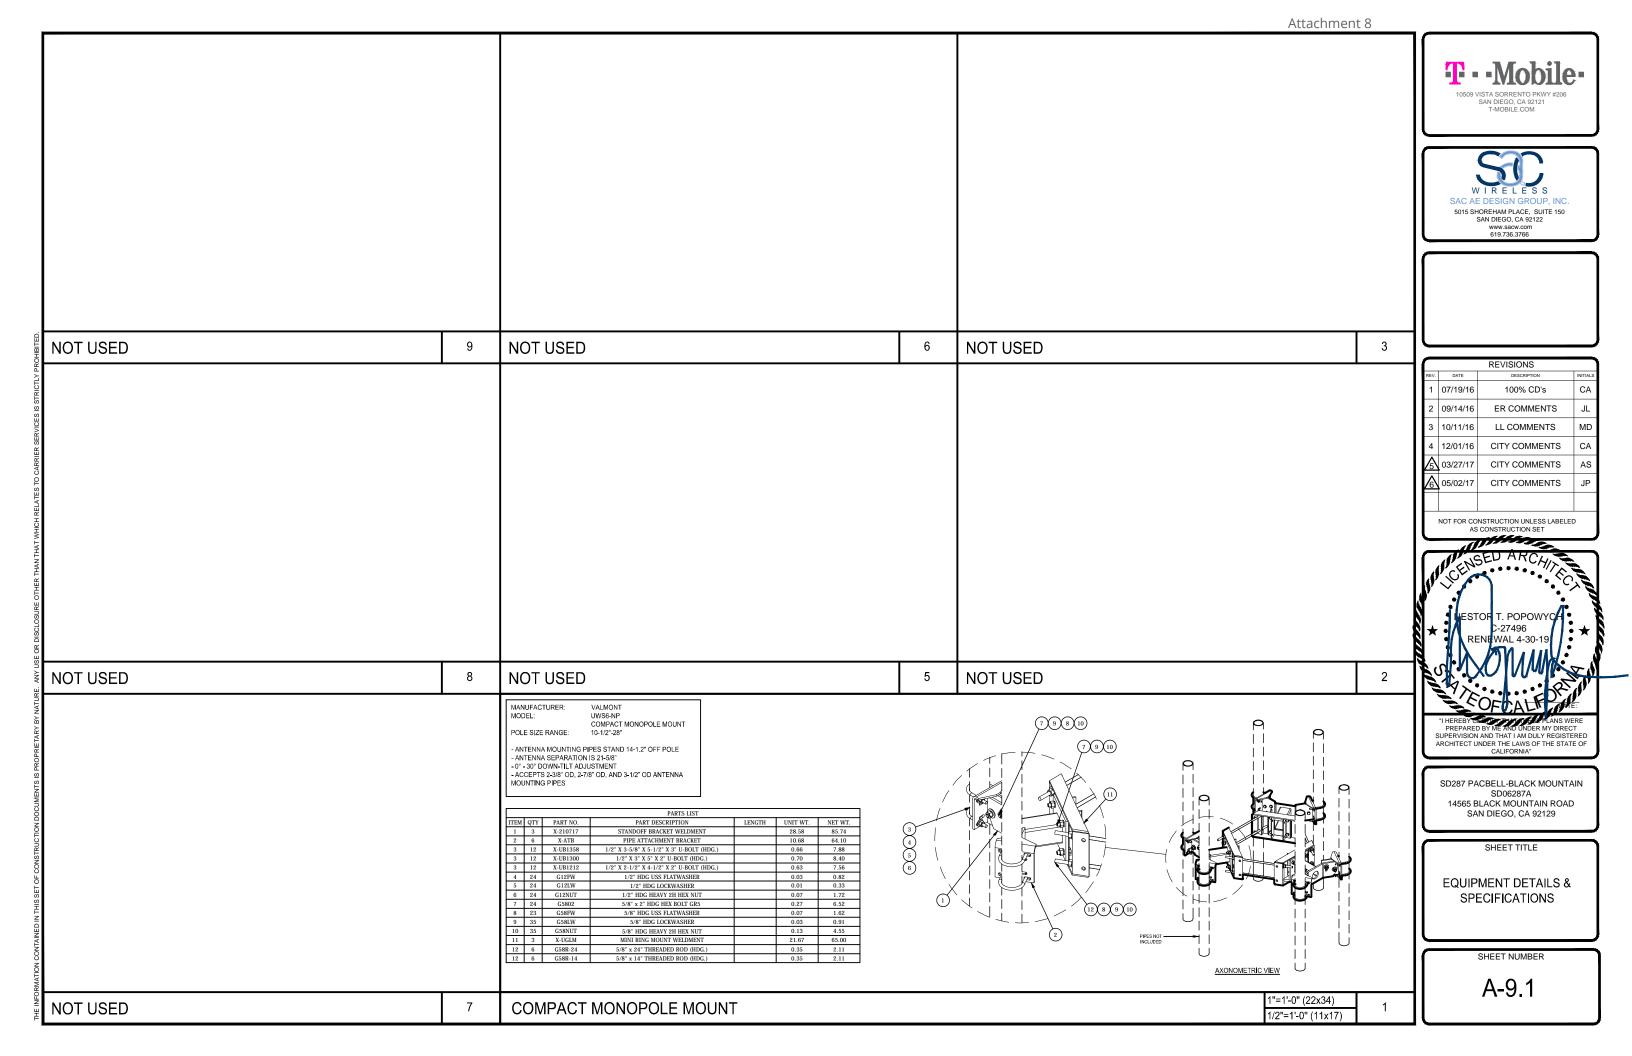

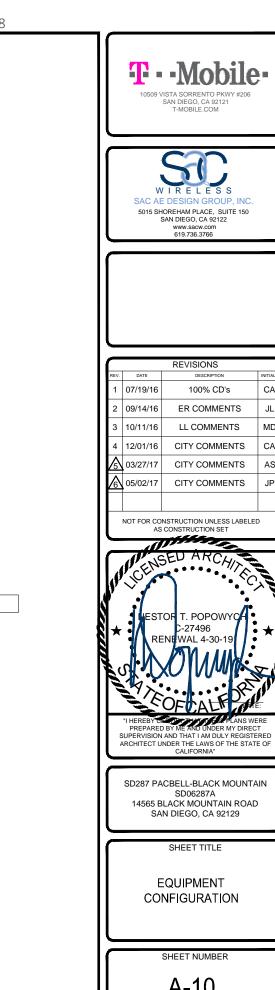

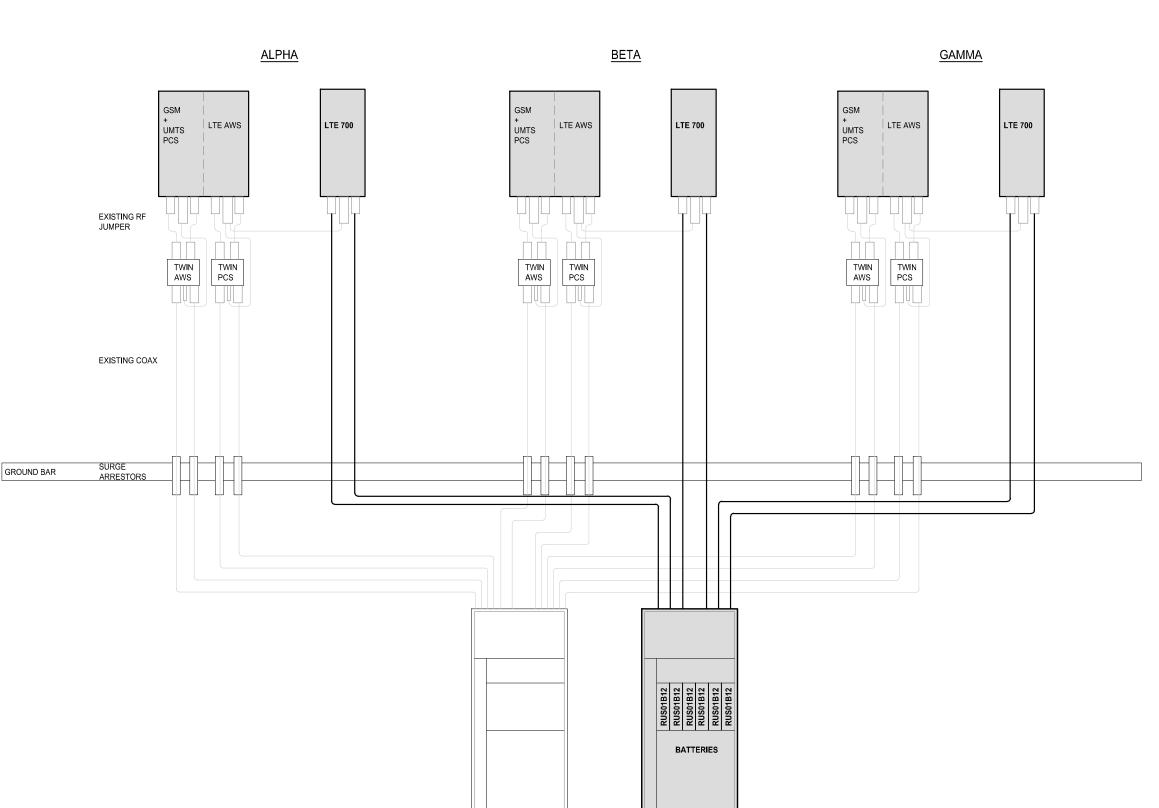


**EQUIPMENT CONFIGURATION** 


CA ER COMMENTS LL COMMENTS CITY COMMENTS CITY COMMENTS CITY COMMENTS

A-10

SCALE N.T.S.

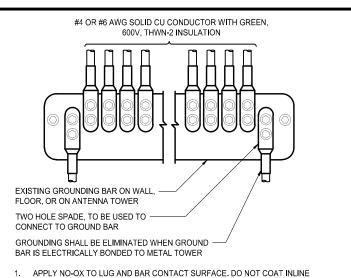

2. IF STOLEN GROUND BARS ARE ENCOUNTERED, CONTACT T-MOBILE CM FOR SCALE WIRE INSTALLATION TO ANTENNAS

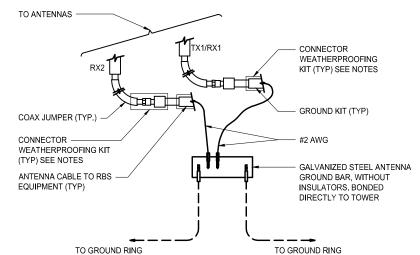

ROUND CABLE CO	NNECTION		SCALE N.T.S. 6
TYPE TA	TYPE VN	TYPE NC	TYPE SS
TYPE VB	TYPE PT	TYPE GT	TYPE GY
TYPE W	TYPE VS	TYPE GR	TYPE GL

**EXOTHERMIC WELD CONNECTIONS** 

- (1) ANTENNA GROUND BUS BAR NEAR ANTENNA MOUNTS WITH COAX GROUND KIT. SEE DETAIL 5/G-1.
- (2) EQUIPMENT GROUND BUS BAR NEAR EQUIPMENT WITH COAX GROUND KIT. SEE DETAIL 6/G-1.
- (3) #6 AWG GROUND FROM ANTENNA GROUND BUS BAR TO TIE INTO EXISTING GROUNDING SYSTEM (TYP OF (2) PLACES). SEE DETAIL 6/G-1.
- (4) #6 AWG GROUND FROM ANTENNAS TO ANTENNA GROUND BUS BAR. SEE DETAIL 5/G-1,
- (5) #6 AWG GROUND FROM RADIOS TO ANTENNA GROUND BUS BAR. SEE DETAIL 5/G-1.
- (6) #6 AWG GROUND MMBTS GROWTH CABINET TO EQUIPMENT GROUND BUSS BAR. SEE DETAIL 6/G-1.
- 7 #6 AWG GROUND FROM NEW GROUND BUS BAR TO TIE INTO EXISTING GROUNDING SYSTEM (TYP OF (2) PLACES). SEE DETAIL 4/G-1.

SCALE

#### **GROUNDING LEGEND**

**GROUNDING KEY** 

SYMBO	L DESCRIPTION	SYMBOL	DESCRIPTION
8	COPPER GROUND ROD	X	TEST WELL
<b>⊘</b> <i>N</i>	MECHANICAL CONNECTION	=====	GROUND BAF
	CADWELD CONNECTION	c	GROUNDING WIRE
\  <sub>  1</sub>	FIELD VERIFY & TIE INTO EXISTING GROUNDING SYSTEM		

ALL DETAILS ARE SHOWN IN GENERAL TERMS. ACTUAL INSTALLATION AND


CONSTRUCTION MAY VARY DUE TO SITE SPECIFIC CONDITIONS.


GROUND ALL ANTENNA BASES, FRAMES, CABLE RUNS, AND OTHER METALLIC COMPONENTS USING GROUND WIRES AND CONNECT TO SURFACE MOUNTED BUS BARS, FOLLOW ANTENNA AND BTS MANUFACTURES PRACTICES FOR GROUNDING REQUIREMENTS. GROUND COAX SHIELDS AT BOTH ENDS AND EXIT FROM TOWER OR POLE USING MFR'S PRACTICES.

- ALL GROUND WIRE SHALL BE GREEN INSULATED WIRE ABOVE GROUND.
- CONTRACTOR TO VERIFY AND TEST GROUND TO SOURCE. GROUNDING AND OTHER OPERATIONAL TESTING WILL BE WITNESSED BY A T-MOBILE REPRESENTATIVE.
- REFER TO DIVISION 16 GENERAL ELECTRIC; GENERAL ELECTRICAL PROVISION AND COMPLY WITH ALL REQUIREMENTS OF GROUNDING STANDARDS.
- CONTRACTOR TO ABIDE BY ALL T-MOBILE SAFETY STANDARDS DURING SITE CONSTRUCTION
- 7. CONTRACTOR SHALL REFER TO T-MOBILE STANDARDS FOR GROUNDING CONNECTIONS & INSTALLATION METHODS.
- 8. ELECTRICAL CONTRACTOR TO PROVIDE DETAILED DESIGN OF GROUNDING SYSTEM, AND RECEIVE APPROVAL OF DESIGN BY AUTHORIZED T-MOBILE REPRESENTATIVE, PRIOR TO INSTALLATION OF GROUNDING SYSTEM. PHOTO DOCUMENT ALL CADWELDS AND GROUND RING.
- NOTIFY CONSTRUCTION MANAGER IF THERE ARE ANY DIFFICULTIES INSTALLING GROUNDING SYSTEM DUE TO SITE SOIL CONDITIONS.
- 10. GROUNDING ROD NOTES (WHERE APPLICABLE)

**GENERAL GROUNDING NOTES** 

- 11. ELECTRICAL CONTRACTOR SHALL ORDER GROUND RESISTANCE TESTING ONCE THE GROUND SYSTEM HAS BEEN INSTALLED: A QUALIFIED INDIVIDUAL LITH IZING THE FALL OF POTENTIAL METHOD, SHOULD PERFORM THE TEST. THE REPORT WILL SHOW THE LOCATION OF THE TEST AND CONTAIN NO LESS THAN 9 TEST POINTS ALONG THE TESTING LINE, GRAPHED OUT TO SHOW THE PLATEAU.
- 12. POINT GROUND TEST OR 3 POINT 62% TESTS WILL NOT BE ACCEPTED AS ALTERNATIVES TO THE AFORE MENTIONED GROUND TESTS. TEST SHALL BE PERFORMED WHILE THE COUNTERPOISE IS ISOLATED. TEST SHALL BE PERFORMED WHILE THE COUNTERPOISE IS ISOLATED FROM THE A/C SYSTEM GRIDS AND EXISTING COMMUNICATIONS FACILITY.

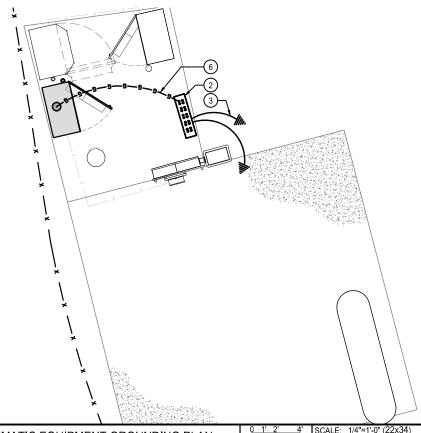


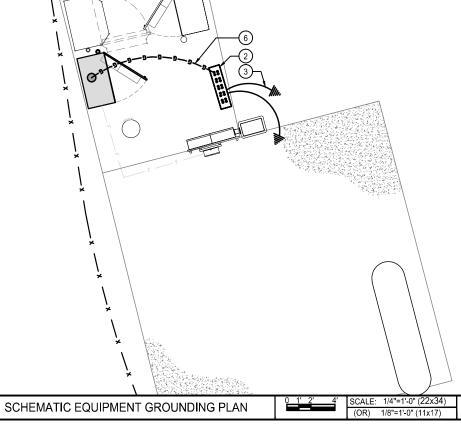





REVISIONS					
REV.	DATE	DESCRIPTION	INITIALS		
1	07/19/16	100% CD's	CA		
2	09/14/16	ER COMMENTS	JL		
3	10/11/16	LL COMMENTS	MD		
4	12/01/16	CITY COMMENTS	CA		
<u> </u>	03/27/17	CITY COMMENTS	AS		
$\sim$	05/02/17	CITY COMMENTS	JP		
NOT FOR CONSTRUCTION UNITESS I ARELED					

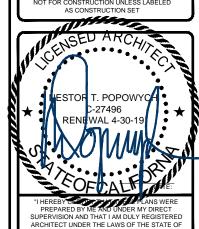


SD287 PACBELL-BLACK MOUNTAIN SD06287A 14565 BLACK MOUNTAIN ROAD SAN DIEGO, CA 92129

SHEET TITLE

SCHEMATIC GROUNDING PLANS, NOTES & DETAILS

SHEET NUMBER

G-1

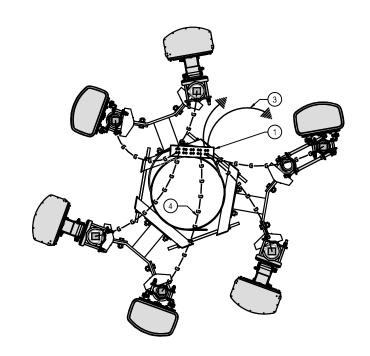

SCHEMATIC ANTENNA GROUNDING PLAN

SCALE: 1"=1'-0" (22x34)

(OR) 1/2"=1'-0" (11x17)


#### **VICINITY MAP**

# T--Mobile-®

#### VoLTE/L700 PROJECT SD06287A

SD287 PACBELL-BLACK MOUNTAIN 14565 BLACK MOUNTAIN ROAD SAN DIEGO, CA 92129 W I R E L E S S
5015 SHOREHAM PLACE, SUITE 150
SAN DIEGO, CA 92122
OFFICE: (619) 736-3766

#### PHOTOSIMULATION VIEWPOINTS

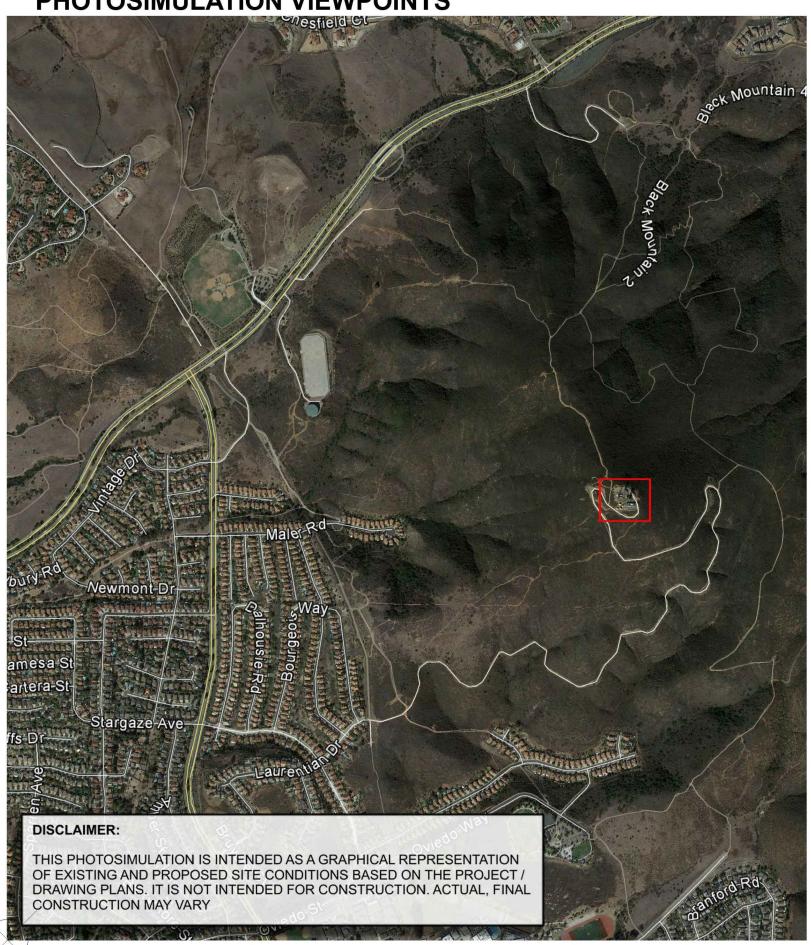



## **PHOTOSIMULATION VIEW 1**


T--Mobile-®


**VoLTE/L700 PROJECT** SD06287A **SD287 PACBELL-BLACK MOUNTAIN** 

14565 BLACK MOUNTAIN ROAD

SAN DIEGO, CA 92122

Attachment 9

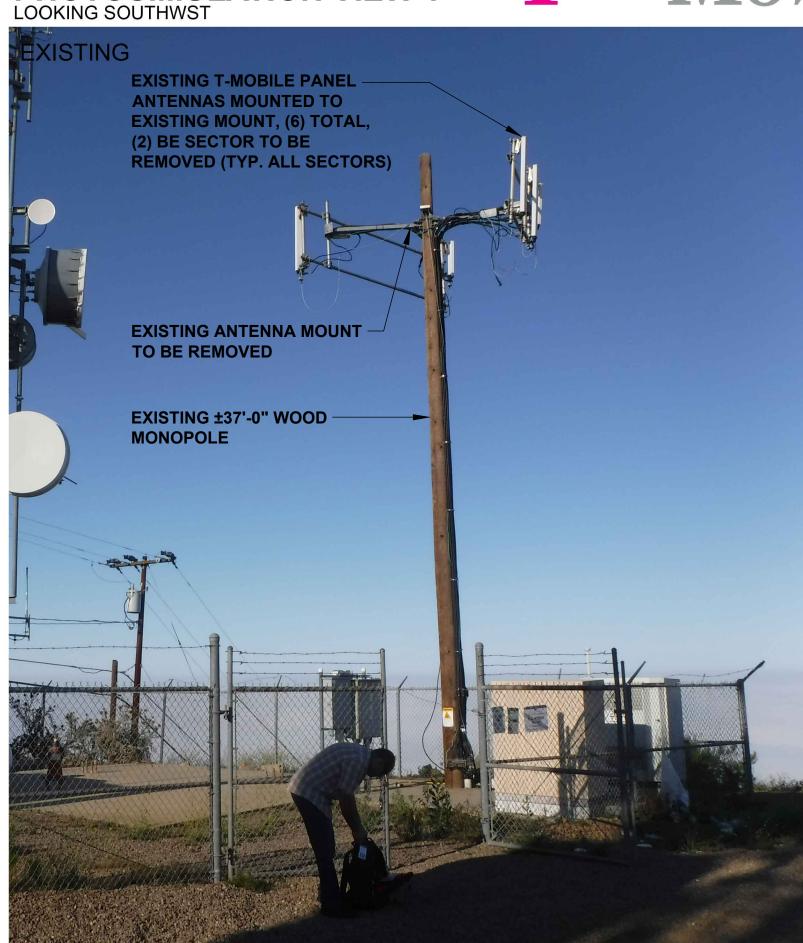

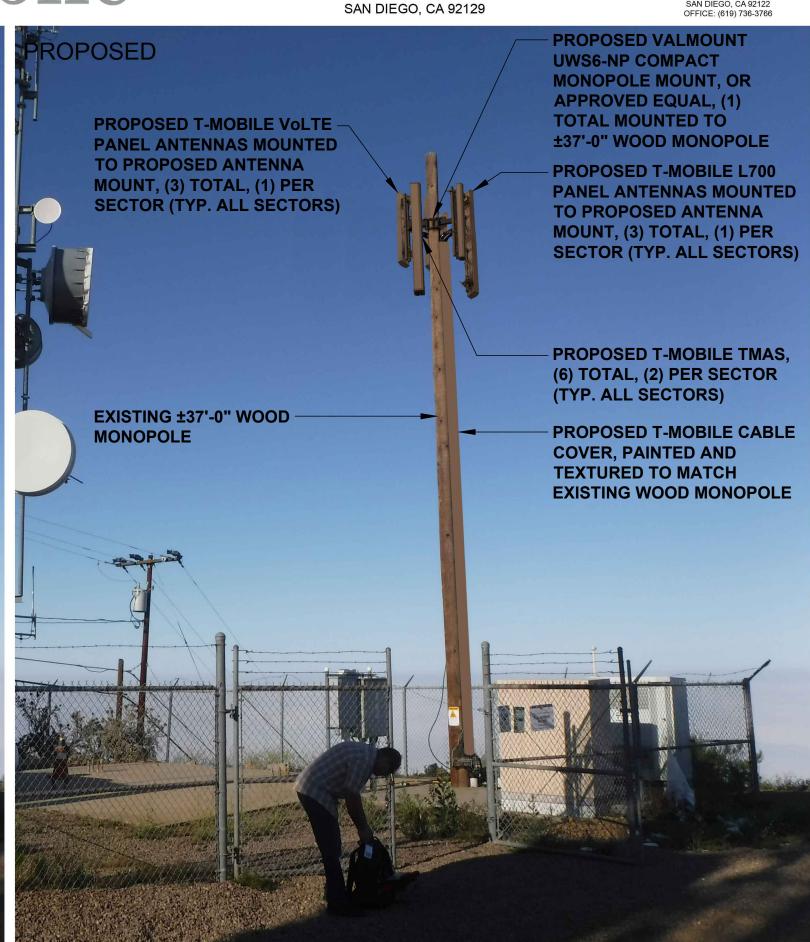



City of San Diego Development Services 1222 First Ave., MS-302 San Diego, CA 92101

# Community Planning Committee Distribution Form Part 2

THE CITY OF SAN DIEGO

Project Name:			Project Number:		Distribution Date:
T-Mobile Black Mountain			513210		4/21/2017
Project Scope/Location:					
Planned Development Permit and Neighborhood Use Permit (Process 4) application for a Wireless Communication Facility located at 14565 Black Mountain Road in the AR-1-1 zone of the Rancho Penasquitos Planning area. The project supports six panel antennas on a wooden pole with ground-mounted equipment. Deviations are being proposed to keep the equipment within the required setbacks and to operate above the 30-foot height limit.					
Applicant Name:			Applicant Phone Number:		
Dail Richard			858.200.6541		
Project Manager: Phone N		ne Number:	r: Fax Number:		E-mail Address:
Simon Tse	(619)	) 687-5984	84 (619) 321-3200		stse@sandiego.gov
Committee Recommendations (To be completed for Initial Review):					
Vote to Approve		Members Ye	es	Members No	Members Abstain
Vote to Approve With Conditions Listed Below		Members Ye	es	Members No	Members Abstain
Vote to Approve With Non-Binding Recommendations Listed Below		Members Ye	es	Members No	Members Abstain
Vote to Deny		Members Ye	es	Members No	Members Abstain
No Action (Please specify, e.g., Need further information, Split vote, Lack of quorum, etc.)					
CONDITIONS: PROVIDE A SHROUD AROUND THE CABLES AND PAINT THE ENTIRE POLE, SHROUD, & ANTENNESS ONE COLOR					
NAME: CORRY SIBUCKAHER TITLE: CHAIR RPPB					
SIGNATURE: GREY ABJUCKENE DATE: 6/7/2017					
Attach Additional Hages If Necessary.  Please return to: Project Management Division City of San Diego Development Services Department 1222 First Avenue, MS 302 San Diego, CA 92101					
Printed on recycled paper. Visit our web site at <a href="https://www.sandiego.gov/development-services">www.sandiego.gov/development-services</a> . Upon request, this information is available in alternative formats for persons with disabilities.					



City of San Diego

Development Services
1222 First Ave., MS-302
San Diego, CA 92101
(619) 446-5000

#### Ownership Disclosure Statement

			Project No. For City Use Only
TMO SD06287A Black Mountain			
Project Address:			
14565 Black Mountain Road, San l	Diego, CA 92129		
art I - To be completed when prope	rty is held by Individua	al(s)	
elow the owner(s) and tenant(s) (if application have an interest in the property, record dividuals who own the property). A signation the Assistant Executive Director of the evelopment Agreement (DDA) has been lanager of any changes in ownership during the Project Manager at least thirty days proformation could result in a delay in the heat additional pages attached Yes	ego on the subject property able) of the above reference of or otherwise, and state ture is required of at least a San Diego Redevelopmer approved / executed by the game the time the application for to any public hearing of	with the intent to record an enced property. The list must include the type of property interest (e.gone of the property owners. At a Agency shall be required for a sec city Council. Note: The applies being processed or considered in the subject property. Failure	ncumbrance against the property. Please list de the names and addresses of all persons in, tenants who will benefit from the permit, all tach additional pages if needed. A signature all project parcels for which a Disposition and licant is responsible for notifying the Project ed. Changes in ownership are to be given to be to provide accurate and current ownership.
Name of Individual (type or print):		Name of Individual (ty	
T-Mobile		Pacific Bell Mobile S	
Owner X Tenant/Lessee Re	edevelopment Agency	▼ Owner	nt/Lessee Redevelopment Agency
Street Address: 10509 Vista Sorrento Parkway, Suite	206	Street Address: 3848 7th Avenue Roo	m 120
City/State/Zip:		City/State/Zip:	
San Diego, CA 92121 Phone No:	Fax No:	San Diego, CA 92103 Phone No:	Fax No:
858 334 6112	T UX IVO.		
Signature :	Date: 9-19-16	Signature :	Date:
Name of Individual (type or print):		Name of Individual (ty	pe or print):
Owner Tenant/Lessee Red	levelopment Agency	Owner Tenant	/Lessee Redevelopment Agency
		Street Address:	
Street Address:		City/State/Zip:	
City/State/Zip:		Phone No:	Fax No:
city/State/Zip:	Fax No:	- 10.10	
	Fax No: Date:	Signature :	Date:

Project Title: TMO SD06287A Black Mountain	Project No. (For City Use Only)
Part II - To be completed when property is held	by a corporation or partnership
Legal Status (please check):	
Corporation Limited Liability -or- General Partnership	eral) What State? Corporate Identification No
as identified above, will be filed with the City of Sathe property. Please list below the names, titles a otherwise, and state the type of property interest (in a partnership who own the property). A signature property. Attach additional pages if needed. Note: ownership during the time the application is being Manager at least thirty days prior to any public hear	the owner(s) acknowledge that an application for a permit, map or other matter, an Diego on the subject property with the intent to record an encumbrance against and addresses of all persons who have an interest in the property, recorded or e.g., tenants who will benefit from the permit, all corporate officers, and all partners are is required of at least one of the corporate officers or partners who own the ten applicant is responsible for notifying the Project Manager of any changes in processed or considered. Changes in ownership are to be given to the Project aring on the subject property. Failure to provide accurate and current ownership process. Additional pages attached Yes No
Corporate/Partnership Name (type or print):	Corporate/Partnership Name (type or print):
Owner Tenant/Lessee	Owner Tenant/Lessee
Street Address:	Street Address:
City/State/Zip:	City/State/Zip:
Phone No: Fax No:	Phone No: Fax No:
Name of Corporate Officer/Partner (type or print):	Name of Corporate Officer/Partner (type or print):
Title (type or print):	Title (type or print):
Signature : Date:	Signature : Date:
Corporate/Partnership Name (type or print):	Corporate/Partnership Name (type or print):
Owner Tenant/Lessee	Owner Tenant/Lessee
Street Address:	Street Address:
City/State/Zip:	City/State/Zip:
Phone No: Fax No:	Phone No: Fax No:
Name of Corporate Officer/Partner (type or print):	Name of Corporate Officer/Partner (type or print):
Title (type or print):	Title (type or print):
Signature : Date:	Signature : Date:
Corporate/Partnership Name (type or print):	Corporate/Partnership Name (type or print):
Owner Tenant/Lessee	Owner Tenant/Lessee
Street Address:	Street Address:
City/State/Zip:	City/State/Zip:
Phone No: Fax No:	Phone No: Fax No:
Name of Corporate Officer/Partner (type or print):	Name of Corporate Officer/Partner (type or print):
Title (type or print):	Title (type or print):
Signature : Date:	Signature : Date:


# SAC Wireless Photo Survey

T-Mobile VolTE / L700 Project SD06287A Black Mountain 14565 Black Mountain Road

## Index

Page	Subject
3	Aerial View of Site
4	View of Site from North
5	View of Site from East
6	View of Site from South
7	View from Site to North
8	View from Site to East
9	View from Site to South
10	View from Site to West
11	Equipment Cabinets

## Aerial View of Site

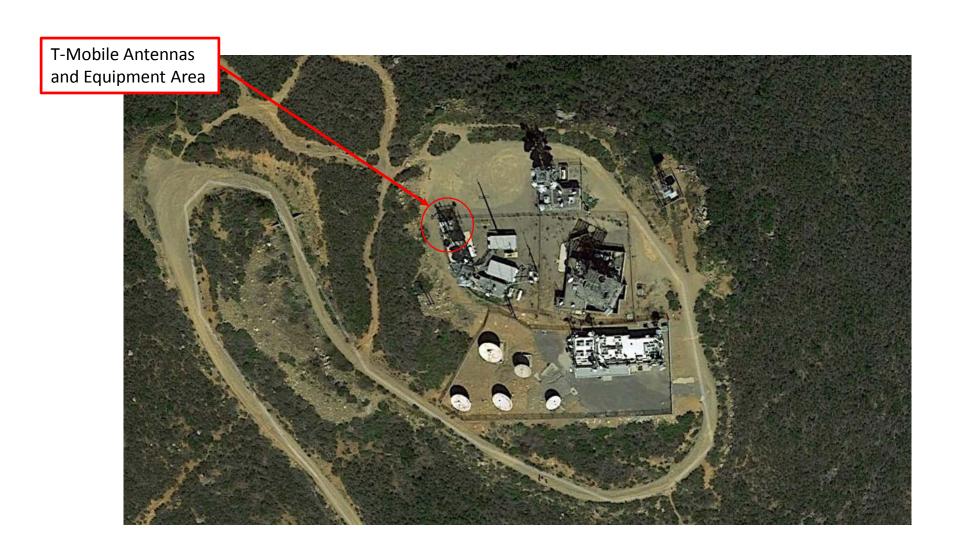

### View of Site from North



### View of Site from East



### View of Site from South



#### View from Site to North

(note: equipment/enclosures shown in photo are not T-Mobile's)

Attachment 12

#### Attachment 12

### View from Site to East



#### View from Site to South

(note: equipment/enclosures shown in photo are not T-Mobile's)

Attachment 12




#### Attachment 12

#### View from Site to West




# Equipment Area



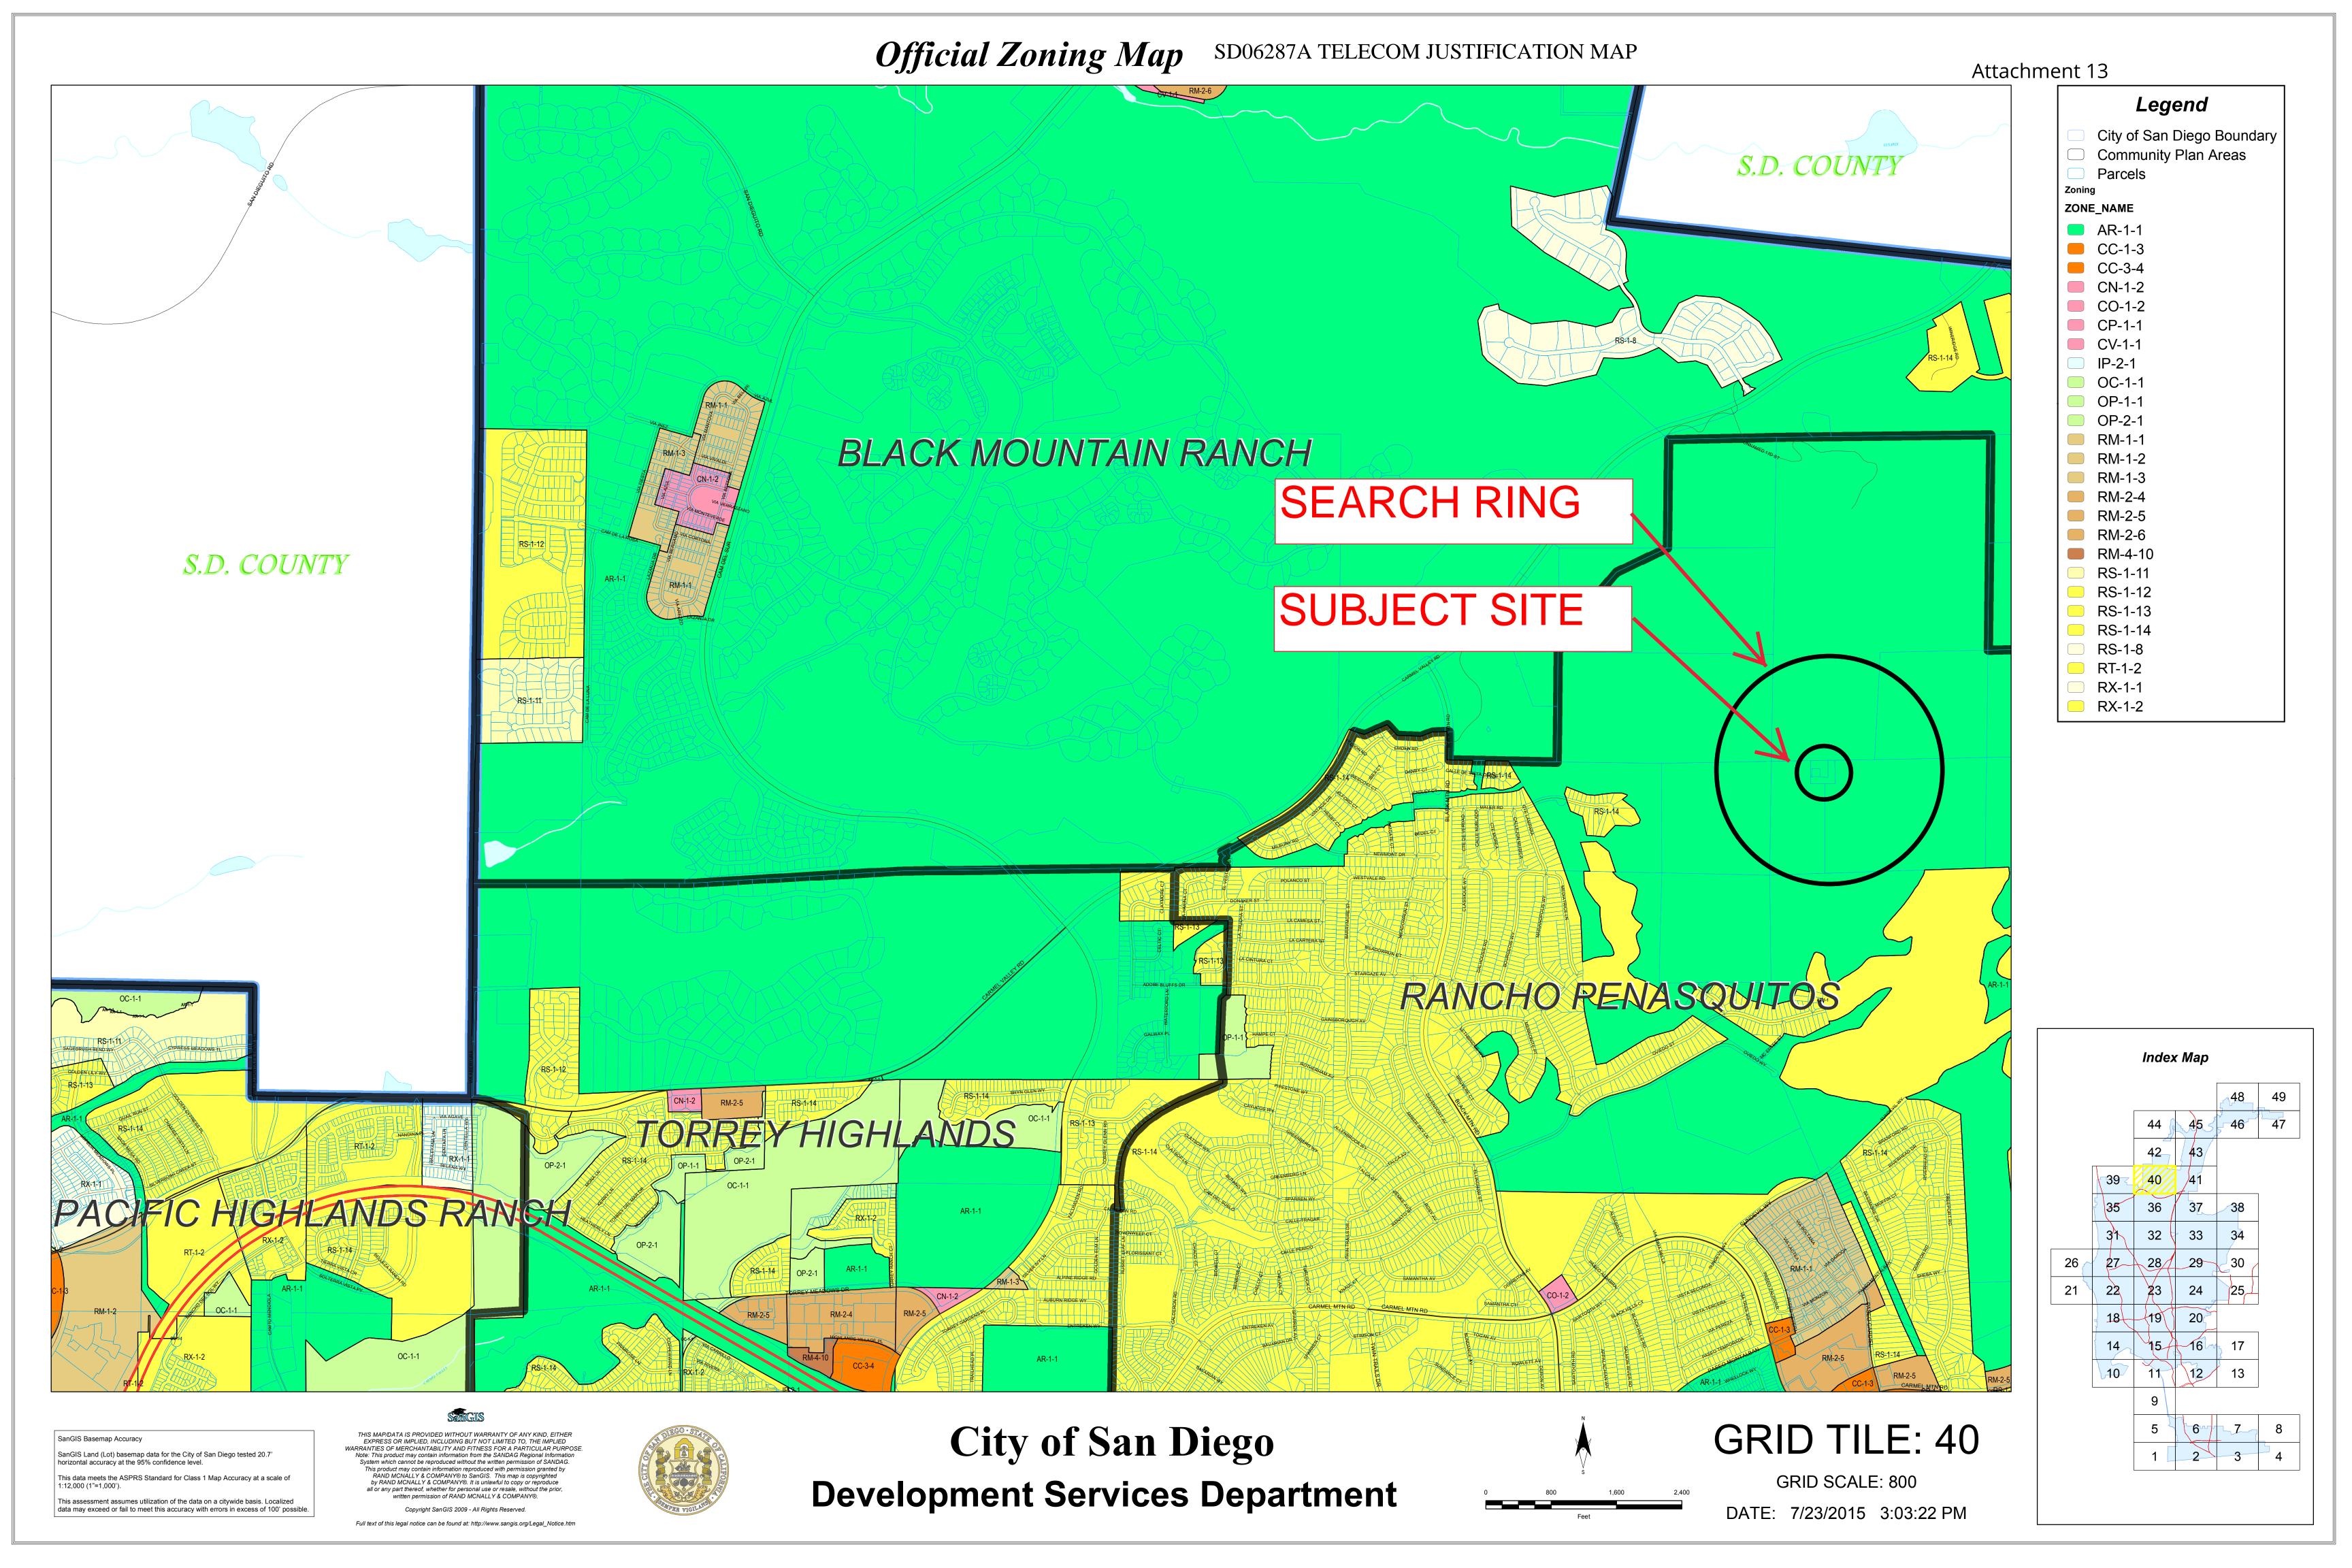



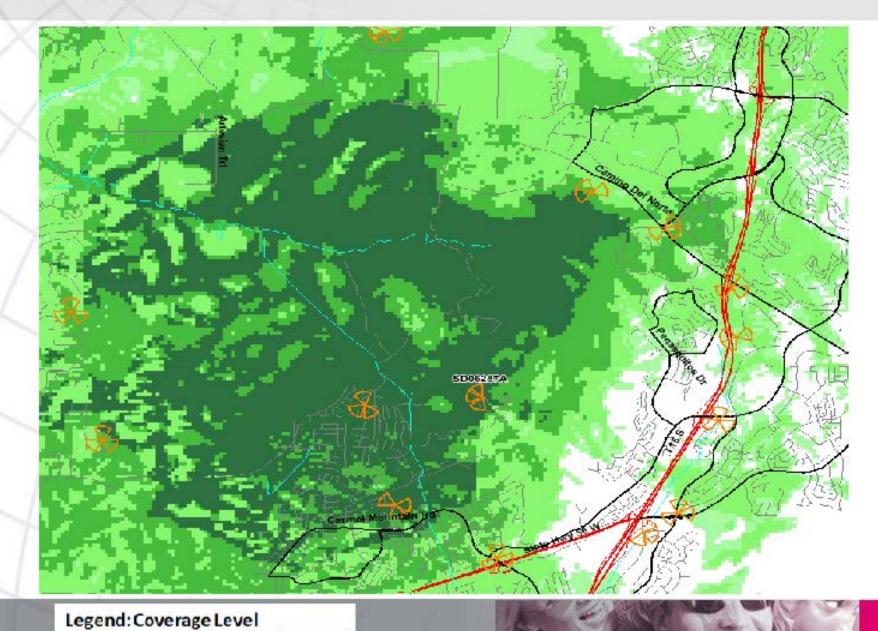


PORROR

FAIRR

**G00D** 

·· T· · Mobile·

## Existing On-Air sites coverage without SD06287A Attachment 13

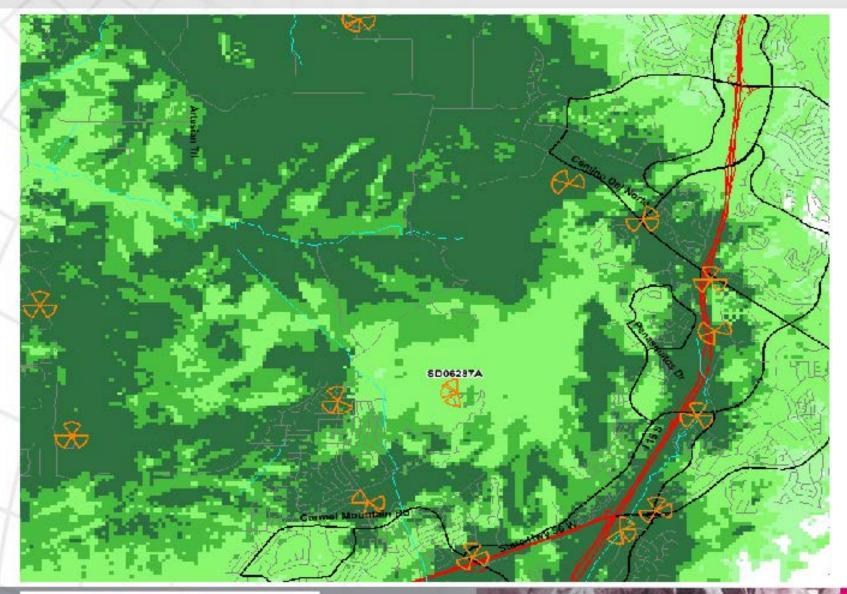

■ GOOD ■ FAIR ■ POOR

·· T·· Mobile·

Legend: Coverage Level

FAIR

GOOD

POOR

#### Site with existing On-Air neighbor sites coverage Attachment 13

