

THE CITY OF SAN DIEGO

Report to the Planning Commission

DATE ISSUED: September 26, 2019

REPORT NO. PC-19-085

HEARING DATE: October 3, 2019

SUBJECT: 35th AND J. Process Four Decision

PROJECT NUMBER: <u>549188</u>

OWNER/APPLICANT: 35th and J Partners, LLC/Craig Howard

SUMMARY

<u>Issue</u>: Should the Planning Commission approve an application for a small lot subdivision containing 21 lots and the construction of 20 single-family dwelling units on a 0.89-acre site located 440 at 1/3 35th Street in the Southeastern San Diego Community Plan?

Staff Recommendations:

- 2. **Approve** Tentative Map No. 1937933; and
- 3. **Approve** Site Development Permit No. 1937932.

<u>Community Planning Group Recommendation</u>: On June 10, 2019 the Southeastern San Diego Community Planning Group voted 7-5-0 to recommend approval of the project with recommendations (Attachment 13).

<u>Environmental Review</u>: This project was determined to be categorically exempt from the California Environmental Quality Act (CEQA) pursuant to Section 15332 (In-fill development project). This project is not pending an appeal of the environmental determination. The environmental exemption determination for this project was made on August 26, 2019 and the opportunity to appeal that determination ended September 10, 2019.

<u>Fiscal Impact Statement</u>: None associated with this action. All costs associated with the processing of this project are paid by the applicant.

Code Enforcement Impact: None.

<u>Housing Impact Statement</u>: The project proposes a small lot subdivision of three vacant parcels into 21 lots and the construction of 20 three-story single-family dwelling units. The Southeastern San Diego Community Plan designates the 0.89-acre site for Residential Low-

Medium use at 10-14 dwelling units/acre, which would allow 4 to 13 residential dwelling units on the site. The project includes a density bonus for seven residential units in accordance with <u>San Diego Municipal Code (SDMC) Section 143.0720</u> of up to 50 percent with five development incentives. The project proposes 15 percent of the pre-density bonus units to be affordable housing units (two units) for very-low income households with rents at 30 percent of 50 percent of the Area Median Income for a period of 55 years. The project would implement the existing land use designations and would create 20 single-family residential dwelling units where none currently exist.

BACKGROUND

The project site is located at 440 1/3 35th Street in the RM-1-1 Zone of the Southeastern San Diego Community Plan. Additionally, the project is located within the Airport Influence Area (San Diego International Airport (SDIA), Review Area 2), the Federal Aviation Administration (FAA) Part 77 Noticing Area (SDIA), and the Transit Area Overlay Zone. (Attachments 1-4).

The vacant site consists of three irregular parcels bordered to the north and west by slopes extending downward to Interstate Highway 15. To the east, across 35th Street and adjacent to the site, is a mix of single and multi-family residential units and to the south adjacent to the south side of the site are single and multi-family residential units. The site slopes to the west at elevations ranging from approximately 106 feet above Mean Sea Level (MSL) within the west central portion of the site to approximately 120 feet above MSL within the northeastern portion of the site (Attachment 1). The site is not within, or adjacent to, the Multi-Habitat Planning Area (MHPA) and does not contain other types of environmentally sensitive lands as defined in <u>SDMC Section 113.0103</u>

DISCUSSION

Project Description:

The project proposes a small lot subdivision containing 21 lots in accordance with <u>SDMC Section</u> <u>143.0365</u>, 20 lots will be for single-family residential dwelling units and a lot for parking, pedestrian circulation and landscaping. Eighteen of the residential lots will include companion units inclusive of the single-family dwelling units and two residential lots will include affordable housing units and not include companion units. The purpose and intent of the Small Lot Subdivision regulations is to encourage development of single dwelling units on small lots in order to provide a space-efficient and economical alternative to traditional single dwelling unit development. It is also the intent of these regulations to provide pedestrian friendly developments that are consistent with the neighborhood character.

Eighteen of single-family residential dwelling units will be three-stories containing two bedrooms with two bathrooms, living and dining rooms ranging in size from 1,495 to 1,525 square feet (Figure 1). Each of the 18 units will include a 480-square-foot companion unit located on the first floor. The affordable housing units will be three-stories containing three bedrooms with three bathrooms, living and dining rooms up to 1,525 square feet, which does not include the companion unit. Additionally, each residential dwelling unit will average 156 square feet of private exterior open

space located on the first and third floor of each unit (Attachment 16). Surface parking for up to 24 spaces will be located in the southeast quadrant of the site.



Figure 1: Birdseye view of site

The neighborhood around the proposed development currently contains mostly low-scale one and two-story single-family homes with one and two-story apartment buildings (Attachment 2). A majority of the structures around this development site were constructed in the 1950's, featuring stucco textures and painted wood siding. The proposed project represents a contemporary evolution of this aesthetic and scale. The 20 dwelling units are designed as narrow 16-foot wide



Figure 2: West facing units site design

three-story townhomes to match the low-scale and openness of the surrounding single-family neighborhood. Each unit has white and gray stucco on the lower two floors. Where the unit steps back at the third floor, it is wrapped in a wood siding of light gray and light blue (Figure 2).

The proposed project was reviewed for compliance with the RM-1-1 zone development requirements, which include but are not limited to height, setbacks, density, landscape, parking, and floor area ratio. Development of the project requires a Site Development Permit (SDP) and Tentative Map (TM) for the development of a small lot subdivision in accordance with <u>SDMC Section 143.0365</u> and <u>125.0410</u> and a request to waive the overhead utility undergrounding requirements. The project incorporates 15 percent of the pre-density bonus units as affordable units for a total of two affordable housing units on site. Because the project qualifies as an affordable housing development, the land use approvals have been processed through the Affordable/In-Fill Housing and Sustainable Buildings Expedite Program.

Community Plan Analysis:

The Southeastern San Diego Community Plan [Plan] designates the 0.89-acre site for Residential Low-Medium which allows both single-family and multi-family housing within a density range of 10-14 dwelling units per acre. Many of the neighborhoods in Southeastern San Diego are in the Residential – Low Medium category with a mix of single-family and small-scale multi-family development. The Plan recommends enhancing the community 's identity with strategic new higher density residential development in proximity to transit, improving the community's streets for the safe and efficient movement of pedestrians, bicyclists, transit, and vehicles and by sustainable practices in new development (mobility, water and energy conservation) in order to reduce greenhouse gas emissions. The Plan identifies opportunities for residential infill development within vacant lots in proximity to transit and by construction of companion units on lower density residential sites. Infill development is anticipated to offer more housing choices, including mixed-use units, multi-family housing, and townhome projects which can be appropriately scaled to the lot sizes.

The base density for the subject property is 13 units (10-14 dwelling units per acre). Applying the Density Bonus allowance in accordance with <u>SDMC Section 143.0720</u>, increases the unit count to 20. The project provides a higher density for this site through the design of separate townhome units with companion units. The units are appropriately scaled to the surrounding residential neighborhood and would provide added housing choices within the neighborhood.

The Housing Element of the General Plan serves as a policy guide to address the comprehensive housing needs of the City of San Diego. Specific to affordable housing, Goal No. 4 of the Housing Element is to "provide affordable housing opportunities consistent with a land use pattern which promotes infill development and socioeconomic equity; and facility compliance with all applicable federal, state, and local laws and regulations". Policy direction specific to density bonus is to, 1) Encourage and promote the use of available Housing Density Bonus Programs. Future consideration should be given to expanding density bonus incentives and provisions, and 2) Enforce all Federal, State, and Local ordinances or regulations pertaining to land use incentives which promote affordable housing opportunities for low- and moderate-income homebuyers, such as inclusionary housing and density bonus. The proposed project incorporates the General Plan Housing Element

by processing a project proposing affordable housing and applying the density bonus regulation of SDMC Section 143.0720

The project would improve the safety and efficiency of 35th Street by dedicating 13 feet of frontage width (over 300 feet of total frontage length) to help improve the community's street and provide safe passage for pedestrian, bicyclist and vehicles. The current narrow 35th Street fronting the project will be widened to 30 feet from 24 feet (curb to curb) with a landscape parkway and sidewalk to allow for a two-way vehicular road and parking on both sides of the street.

The project would provide several sustainable design features for reducing energy and water use within the residences. Each of the proposed twenty dwelling units have rain collection barrels, collecting water runoff that would normally be running into the surrounding soils or down to street gutters.

Each unit also has roof mounted photo voltaic systems and green roof modules (Live Roofs), reducing each unit's energy requirements.

The proposed project is designed to maintain the character of the neighborhood by creating a single-family style townhome development. Each dwelling unit in the proposed development is contained within its own separate building structure. A tentative map is required to provide individual lots and promote the townhome design while maintaining a single-family design as reflected throughout the neighborhood. The low-density character is maintained while bringing more dwelling units into the neighborhood. The proposed project is also located near public transit, connecting the development to the greater region.

Project-Related Issues:

<u>Incentives</u>- The proposed development includes 15 percent affordable housing and qualifies as an Affordable Housing development project pursuant to <u>SDMC Section 143.0915</u>. Because the project is providing 15 percent of the pre-density bonus units (2) as affordable, the project qualifies for a 50 percent density increase for a maximum of 20 dwelling units on the project site (13 (pre-density units) x 0.50 (density bonus allowed) = 6.5 rounds up to 7 additional units allowed). The project as proposed elects to develop a 20-unit multifamily complex. The City is required to process incentives requested by the applicant, consistent with State Density Bonus Law and as set forth in <u>SDMC Section 143.0720</u>. In accordance with SDMC Table 143-07A, the project would be allowed five (5) incentives. The applicant is entitled to the concessions or incentives, in the form of deviations to the development regulations, unless the City makes a written finding of denial based on substantial evidence pursuant to <u>SDMC Section 143.0740(c)(1)</u> and Government Code Section 65915(d)(1). The applicant is requesting five (5) affordable housing incentives, in the form of deviations, as follows:

DEVIATIONS SUMMARY Table 1				
Deviation Description	Deviation from SDMC	Allowed/Required	Proposed	
1. Building Height	SDMC Section 143.0365	36 feet maximum	42 feet	
	and Table 143-03C	height		
2. Angled Building	SDMC Section	Yes	Not included	
	<u>131.0444</u>			

DEVIATIONS SUMMARY Table 1				
Deviation Description	Deviation from SDMC	Allowed/Required	Proposed	
3. Rear Yard	SDMC Section 131.0431	15 feet	5 feet	
Setback	and Table 131-04G			
4. Front Yard	SDMC Section 131.0431	15/20 feet	6.5 feet minimum	
Setback	and Table 131-04G			
5. Floor Area Ratio	SDMC Section 131.0431	0.75	0.78	
	and Table 131-04G			

1. An incentive to deviate from <u>SDMC Section143.0365 and Table 143-03C</u> – building height, increase in building height to 42 feet where the maximum height allowed is 36 feet.

The proposal to deviate from the building height requirement is due to the topography which drops off dramatically towards the western portion of the site. The drop off requires a tall stem wall to be constructed for the western units which pushes the height of the structures above the height limit. The height elevation is measured at proposed or finished grade, whichever is lower. At finished grade, the units are 34 feet tall. However, when measured from existing grade the highest point reaches 42 feet. To offset the height of the units, the third level of each unit steps back on the east and west sides, reducing the overall bulk and scale of each unit.

2. An incentive to deviate from <u>SDMC Section 131.0444</u> – angled building envelope plane, to remove the angled building envelope plane requirement entirely.

The angled building envelope plane incentive will allow the single-family residential dwelling units to provide additional floor area to the third story. To help offset this condition, each of the twenty dwelling units step back on the third story to reduce the overall bulk and scale of each unit.

3. An incentive to deviate from <u>SDMC Section 131.0431 and Table 131-04G</u> – rear yard setback, to reduce the minimum rear yard setback to a maximum five feet where 15 feet is required.

The proposed five-foot rear yard setback allows for the better utilization of the panhandle portion at the southwest corner of the site and along the western narrow section of the site. The incentive fits two dwelling units into the southwest corner and allows the remaining homes along the western property line to increase livable floor area. The original design allowed the homes on the western property line to meet the setback requirements. However, due to the 13-foot dedication requirement to expand 35th Street 13 feet, the homes were pushed slightly to west causing an encroachment into the rear yard setback (Figure 3).

4. An incentive to deviate from <u>SDMC Section 131.0431and Table 131-04G</u> – front yard setback, to reduce the minimum front yard setback to 6 feet, 6-inches where 15/20 feet is required (Figure 3).

The requested reduction of the front yard setback is primarily caused from the 13-foot dedication along 35th Street pushing back the front property line. The reduced setback allows the residential

units to fit within the irregular shaped site. To help offset this, a short block wall runs in and out from the front property line, creating pockets of landscaping, extending the landscape area.

5. An incentive to deviate from <u>SDMC Section 131.0431 and Table 131-04G</u> – floor area ratio (FAR), to increase the FAR to 0.78 where the maximum FAR allowed is 0.75 percent

The 0.03 increase in FAR will allow each unit to maximize its living area.

The incentives are consistent with the intent of the State's Density Bonus Law. It has been determined that there is no substantial evidence pursuant to <u>SDMC Section 143.0740(d)(1)</u> or government Code Section 65915(d)(1) to deny the applicant's request for the incentives. Other than the requested incentives, the project meets all applicable regulations and policy documents, and is consistent with the recommended land use, design guidelines, and development standards in effect for this site per the SDMC and Southeastern San Diego Community Plan. The project is consistent with the community plan, has been designed to address the physical environment, and would not adversely impact the public's health or safety.



Figure 3: Front and Rear Setbacks

<u>Undergrounding Utility Waiver</u>- The neighborhood currently contains power poles and overhead utility lines within the public right-of-way along the alley located along 35th Street. The City's Undergrounding Master Plan designates the site within MTHP-05 and is unallocated for

undergrounding. The proposed subdivision utilities shall be undergrounded and the project includes a waiver from the requirement to underground the existing overhead utilities within the boundary of the subdivision or within the abutting public rights-of-way. In accordance with <u>SDMC</u> <u>Section144.0240(b)(5)</u>, the waiver of the requirements to underground privately owned utility systems and service facilities qualifies under the guidelines of <u>SDMC Section 144.0242(c)(2)</u> as follows: Inordinate cost to the development taking into consideration - the cost of conversion would increase the cost per unit for proposed residential development by more than one percent.

Community Planning Group Recommendation:

On June 19, 2019, the Southeastern San Diego Planning Group voted 7-5-0 to recommend approval of the Project with the following recommendations: 1) provide better parking, 2) provide better lighting, 3) provide security cameras, 4) devise a plan to help residents get their trash to the trash bins, 5) provide mature landscaping for screening for existing nearby homes, and 6) provide some type of recreation area in this overly dense project (Attachment 14).

Staff reviewed the recommended conditions and offer the following responses:

- 1) Parking: The parking requirements for a project providing a minimum of 11 percent of affordable units to very low income households in accordance with <u>SDMC Section 143.0744</u> Table 143-07D is 0.05 spaces per bedroom. The project requires 21 spaces but is proposing 24 spaces within the surface parking lot. Additionally, the project is proposing to dedicate 13 feet of the property frontage along 35th Street. By dedicating 13 feet of the property's frontage, the road can be widened to the City's Street Design Manual requirements for a two-way 30-foot wide street and allow for cars to safely park on both sides of the street (currently 24 feet). The units are expected to be marketed to people seeking opportunities for alternative transportation due to its proximity to Downtown, making biking attractive as well as the fact that the project is within a half-mile from a trolley station.
- 2) Lighting: Sufficient parking lighting including a new streetlight along 35th Street located midway along the property frontage is being proposed for the project.
- 3) Security Cameras: Security cameras are not a requirement for the proposed single-family housing development. However, the applicant has informed staff that the project will incorporate security and defensible building methods as recommended by the San Diego Police Department (Attachment 12).
- 4) Trash receptacle location: The location of trash receptacles is not a requirement for the proposed single-family housing development. However, the applicant has informed staff the driveway entry off 35th Street is centered with J Street so that a fire truck can drive into the project site and back up safely onto J Street. The same reasoning applies for a large garbage truck. There is not enough space within the parking lot, without removing parking spaces, to provide a turnaround clearance or a turning radius for big service trucks to enter and exit safely. The trash enclosure is located opposite the driveway entry so that the it can be serviced easily by garbage trucks. A garbage truck can pull into the lot in a straight line,

service the trash, and then back up straight on to J Street and use 35th Street as a hammerhead, if needed.

- 5) Provide Mature Landscaping: The project has been reviewed in accordance with the City's Landscape Ordinance (Chapter 14, Article 2, Division 4) and meets all criteria of the ordinance. The applicant has indicated that landscaping will be used to screen new dwelling units from the adjacent single-family home on the adjacent property to the south. This includes planting 18-foot tall cypress trees. The trees will be installed as mature or close to mature in age in order to provide screening when construction of the new dwelling units is completed.
- 6) Recreation Amenity: The recreation amenity is not a requirement of the Small Lot Subdivision Ordinance but as a condition of the permit a Mutual Maintenance and Access Agreement for all facilities used in common shall be entered into the satisfaction of the City Manager and shall be recorded against the applicable property or properties (Attachment 9). The agreement at a minimum shall include an easement for shared driveways, utilities, drainage and runoff, encroachments, maintenance, repair, and reconstruction. Additionally, the agreement shall provide maintenance for shared driveways, sewer lines, cable and electrical lines, exterior lighting, and fencing. The project will provide several landscaped areas maintained in accordance by the future CC&R, one of the areas is adjacent to the trash enclosure and is approximately 700 square feet, that could be used as a pet area. Another landscaped area at the end of the drive aisle, approximately 400 square feet and separated from dwelling units by the pedestrian paver path, could be used as an outdoor BBQ area/outdoor seating area. All the dwelling units have a private usable area averaging from 156 square feet.

Conclusion:

Staff has reviewed the proposed project and all issues identified through the review process have been resolved in conformance with adopted City Council policies and regulations of the SDMC. With the approval of the incentives, the project meets all applicable regulations and policy documents, and staff supports the determination that the project is consistent with the recommended land use plan and development standards in effect for this site per the SDMC, the Southeastern San Diego Community Plan and the General Plan. Thus, Staff recommends that the Planning Commission approve the project as proposed.

ALTERNATIVES

- 1. Approve Tentative Map No. 1937933 and Site Development Permit No. 1937932 with modifications.
- 2. Deny Tentative Map No. 1937933 and Site Development Permit No. 1937932, if the findings required to approve the project cannot be affirmed.

Respectfully submitted,

PVFitzG erald

Deputy Director Development Services Department

FITZGERALD/WJZ


Attachments:

- 1. Location Map
- 2. Aerial Photograph
- 3. Existing Land Use Designation
- 4. Existing Zoning
- 5. Site Photographs (Existing)
- 6. Project Renderings
- 7. Data Sheet
- 8. Draft SDP Resolution with Findings
- 9. Draft SDP Permit with Conditions
- 10. Draft TM Resolution with Findings
- 11. Draft TM Conditions
- 12. Crime Prevention through Environmental Design Summary
- 13. Project Chronology
- 14. Community Planning Group Recommendation
- 15. Ownership Disclosure Statement
- 16. Project Plans

William Zounes


Development Project Manager Development Services Department

North

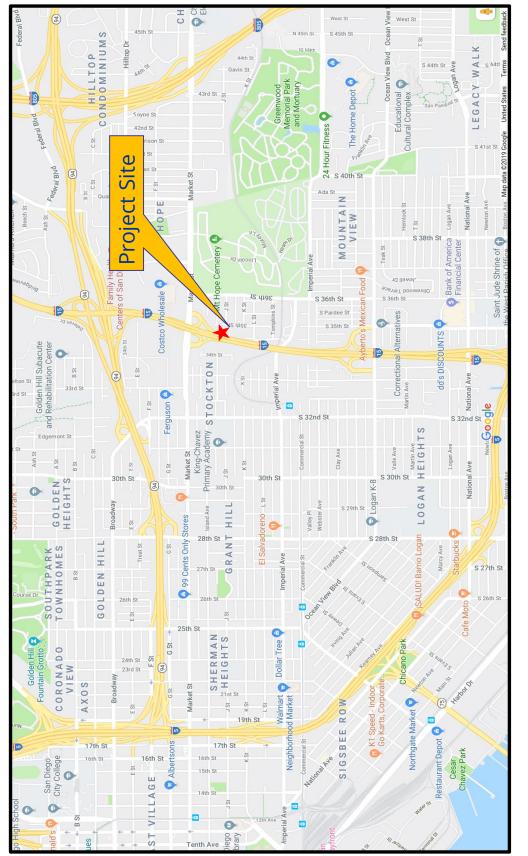






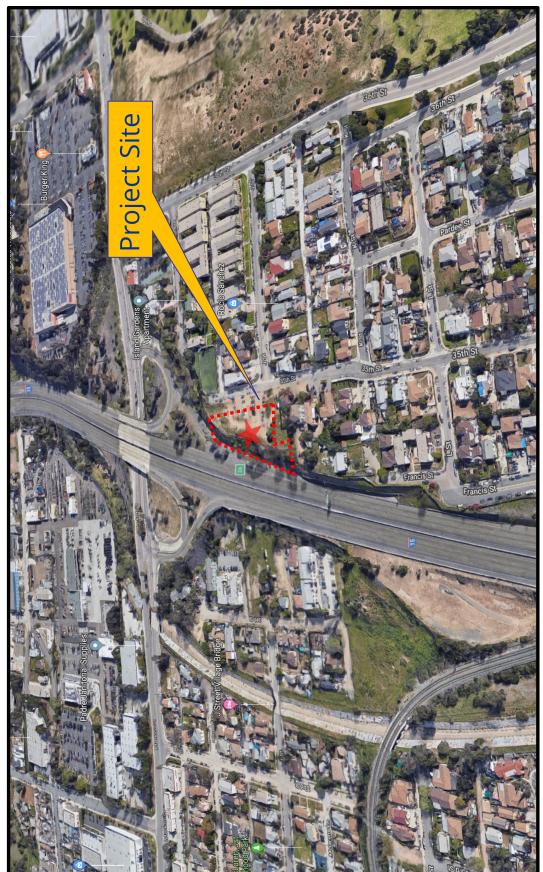

North

Aerial Photograph 35th and J Project No. 549188 440 1/3 35th Street



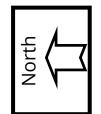







440 1/3 35th Street

Southeastern San Diego Community

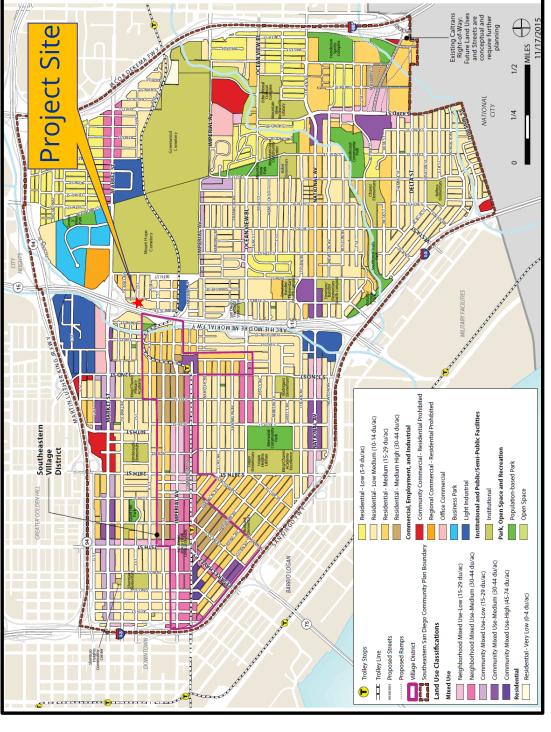


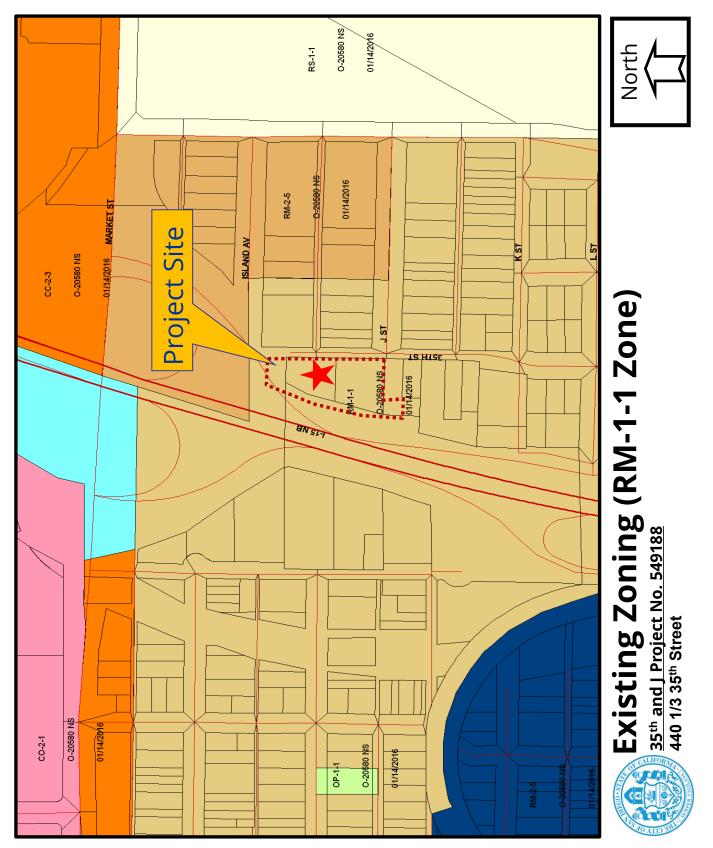





Site Photo – Existing Site Conditions viewed from 35th | Street Looking southwest 35th and J Project No. 549188 440 1/3 35th Street

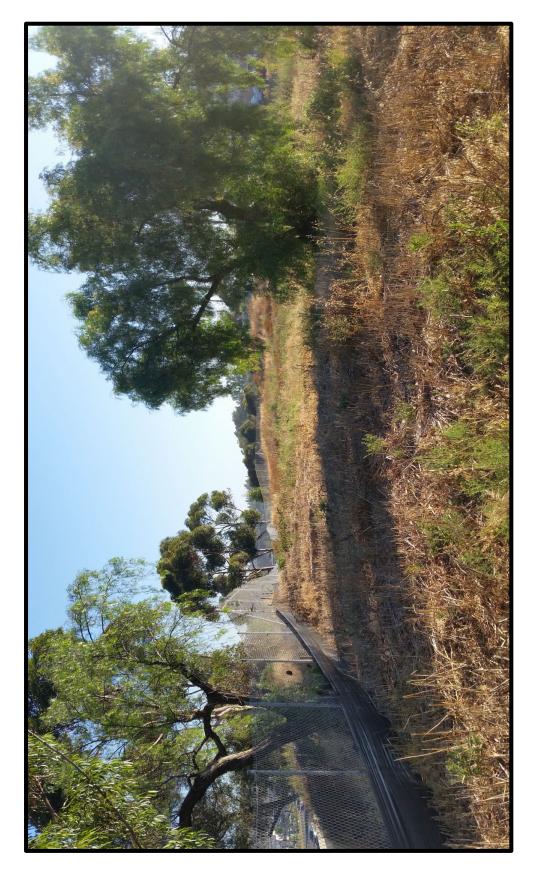



<u>35th and J Project No. 549188</u> 440 1/3 35th Street

Site Photo – Taken from south of site Looking northeast







35th and J Project No. 549188 440 1/3 35th Street



East

Site Photo – Taken from west side of site looking east Towards J Street 35th and J Project No. 549188 440 1/3 35th Street







Project Rendering – View of private exterior and interior







Project Rendering – View of Single-Family Dwelling Units from Parking Lot ^{35th} and J Project No. 549188 440 1/3 35th Street

PROJECT DATA SHEET					
PROJECT NAME:	35 th and J				
PROJECT DESCRIPTION:	The project proposes a small lot subdivision containing 21 lots in accordance with SDMC Section 143.0365, 20 lots will be for single-family residential dwelling units and a lot for parking, pedestrian circulation and landscaping. Eighteen of the residential lots will include companion units inclusive of the single-family dwelling units and two residential lots will be reserved for affordable housing.				
COMMUNITY PLAN AREA:	Southeastern San Diego				
DISCRETIONARY ACTIONS:	Tentative Map and Site Development Permit				
COMMUNITY PLAN LAND USE DESIGNATION:	Residential Low-Medium				
ZONING INFORMATION:					
ZONE: RM-1-1 HEIGHT LIMIT: 36 feet LOT SIZE: 0.89-acres FLOOR AREA RATIO: 0.75 FRONT SETBACK: 15/20 feet SIDE SETBACK: 5/8 feet STREETSIDE SETBACK: 10 feet REAR SETBACK: 15 feet PARKING: 24 spaces NORTH: SOUTH:	proposed LAND USE DESIGNATION & ZONE Low-Medium Residential; RM-1-1 Low-Medium Residential; RM-1-1 Low-Medium Residential; RM-1-1	EXISTING LAND USE Interstate-94 on-ramp, multi- family residential dwelling units Single and multi-family residential dwelling units			
EAST:	Low-Medium Residential; RM-1-1	Single and multi-family residential dwelling units			
WEST:	Low-Medium Residential; RM-1-1	Interstate-15			
DEVIATIONS OR VARIANCES REQUESTED (INCENTIVES):	Building Height, Angled Building, Read Yard Setback, Front Yard Setback, Floor Area Ratio				
COMMUNITY PLANNING GROUP RECOMMENDATION:	On June 19, 2019, the Southeastern San Diego Planning Group voted 7-5-0 to recommend approval of the Project with the following recommendations: 1) provide better parking, 2) provide better lighting, 3) provide security cameras, 4) Provide better access to trash cans, 5) provide mature landscaping for screening for existing nearby homes, and 6) provide some type of recreation area in this overly dense project.				

PLANNING COMMISSION RESOLUTION NO. _____ SITE DEVELOPMENT PERMIT NO. 1937932 35TH AND J PROJECT NO. 549188

WHEREAS, 35th and J Partners, LLC, a Nevada Limited Lability Company, Owner/Permittee, filed an application with the City of San Diego for a Small Lot Subdivision for the construction of 20 single-family dwelling units on individual lots including two affordable units where 18 of the homes will include companion units (as described in and by reference to the approved Exhibits "A" and corresponding conditions of approval for the associated Permit No. 1937932), on portions of a 0.89acre site;

WHEREAS, the project site is located at 440 1/3 35th Street in the RM-1-1 zone of the Southeastern San Diego Community Plan;

WHEREAS, the project site is legally described as that portion of the northeast quarter of Pueblo Lot 1152 of the Pueblo lands of San Diego, in the City of San Diego, County of San Diego, State of California, according to Map by James Pascoe in 1870, filed in the Office of the County Recorder of San Diego County, November 14, 1921 and known as Miscellaneous Map No. 36 and all that portion of the northeast quarter of Pueblo Lot 1152, in the City of San Diego, county of San Diego, State of California, according to map made by James Pascoe in 1870, filed in the Office of the County Recorder of San Diego County, November 14, 1921, known as Miscellaneous Map No. 36 and the portion of the northeast quarter of Pueblo Lot 1152 of the Pueblo lands of San Diego, in the City of San Diego, County of San Diego, State of California, according to map thereof by James Pascoe in 1870, filed in the Office of the County Recorder of San Diego County, November 14, 1921, known as Miscellaneous Map No. 36; WHEREAS, on August 26, 2019 the City of San Diego, as Lead Agency, through the

Development Services Department, made and issued an Environmental Determination that the

project is exempt from the California Environmental Quality Act (CEQA) (Public Resources Code

Section 21000 et seq.) under CEQA Guideline Section 15332 (In-fill development project); and there

was no appeal of the Environmental Determination filed within the time period provided by San

Diego Municipal Code Section 112.0520;

WHEREAS, on October 3, 2019, the Planning Commission of the City of San Diego considered

Site Development Permit No.1937932 pursuant to the Land Development Code of the City of San

Diego;

BE IT RESOLVED by the Planning Commission of the City of San Diego, that it adopts the

following findings with respect to Site Development Permit No. 1937932:

A. <u>SITE DEVELOPMENT PERMIT [San Diego Municipal Code Section 126.0505]</u>

1. <u>Findings for all Site Development Permits:</u>

a. The proposed development will not adversely affect the applicable land use plan.

The project proposes a small lot subdivision containing 21 lots in accordance with San Diego Municipal Code (SDMC) Section 143.0365, 20 lots will be for single-family residential dwelling units and one lot for parking, pedestrian circulation and landscaping. The project site is located at 440 1/3 35th Street in the RM-1-1 Zone of the Southeastern San Diego Community Plan. The vacant site consists of three irregularly shaped parcels fronting 35th Street to the east and Interstate 15 off-ramp to the west. The Southeastern San Diego Community Plan designates the 0.89-acre site for Residential Low-Medium which allows both single-family and multi-family housing within a density range of 10-14 dwelling units per acre. Eighteen of the residential lots will contain a companion unit and the remaining two residential lots will be for affordable housing.

Most neighborhoods in Southeastern San Diego are in the Residential–Low Medium category with a mix of single-family and small-scale multi-family development. The Southeastern San Diego Community Plan [Plan] recommends enhancing the community 's identity with strategic new higher density residential development in proximity to transit, improving the community's streets for the safe and efficient

movement of pedestrians, bicyclists, transit, and vehicles and by sustainable practices in new development (mobility, water and energy conservation) in order to reduce greenhouse gas emissions. The Plan identifies opportunities for residential infill development within vacant lots in proximity to transit and by the construction of companion units on lower density residential sites. Infill development is anticipated to offer more housing choices, including mixed-use units, multi-family housing, and townhome projects which can be appropriately scaled to the vacant lot sizes.

The base density for the subject property is 13 units (10-14 dwelling units per acre). Applying the Density Bonus allowance in accordance with San Diego Municipal Code (SDMC) Section 143.0720, increases the density to 20 units. The project provides a higher density for this site through the design of separate townhome units with companion units. The units are appropriately scaled to the surrounding residential neighborhood and would provide added housing choices within the neighborhood.

The Housing Element of the General Plan serves as a policy guide to address the comprehensive housing needs of the City of San Diego. Specific to affordable housing opportunities consistent with a land use pattern which promotes infill development and socioeconomic equity; and facility compliance with all applicable federal, state, and local laws and regulations". Policy direction specific to density bonus is to, 1) Encourage and promote the use of available Housing Density Bonus Programs. Future consideration should be given to expanding density bonus incentives and provisions, and 2) Enforce all Federal, State, and Local ordinances or regulations pertaining to land use incentives which promote affordable housing opportunities for low- and moderate-income homebuyers, such as inclusionary housing and density bonus. The proposed project incorporates the General Plan Housing Element by processing a project proposing affordable housing and applying the density bonus regulation of SDMC Section 143.0720

The project would improve the safety and efficiency of 35th Street by dedicating 13 feet of frontage width (over 300 feet of total frontage length) to help improve the community's street and provide safe passage for pedestrian, bicyclist and vehicles. The current narrow 35th Street fronting the project will be widened from 24 feet to 30 feet (curb to curb) with a landscape parkway and sidewalk to allow for a two-way vehicular road and parking on both sides of the street.

The project would provide several sustainable design features for reducing energy and water use within the residences. Each of the proposed twenty dwelling units have rain collection barrels, collecting water runoff that would normally be running into the surrounding soils or down to street gutters. Each unit also has roof mounted photo voltaic systems and green roof modules (Live Roofs), reducing each unit's energy requirements.

The proposed project is designed to maintain the character of the neighborhood by creating a single-family style townhome development. A tentative map is required to

provide individual lots and promote a townhome design that maintains the singlefamily theme that's reflected throughout the neighborhood. The low-density character is maintained while bringing more dwelling units into the neighborhood. The proposed project is also located near public transit connecting the development to the greater region. Therefore, the proposed development will not adversely affect the applicable land use plan.

b. The proposed development will not be detrimental to the public health, safety, and welfare.

The project proposes a small lot subdivision containing 21 lots in accordance with SDMC Section 143.0365, 20 lots will be for single-family residential dwelling units and one lot for parking, pedestrian circulation and landscaping. Two of the residential lots will be for affordable housing. The project site is located at 440 1/3 35th Street in the RM-1-1 Zone of the Southeastern San Diego Community Plan.

In addition to the on-site construction of the small lot subdivision, the project includes the widening of 35th Street with the construction of curb, gutter, sidewalk, and curb ramp to current City Standards and maintaining the existing sidewalk scoring pattern, adjacent to the site on 35th Street creating a safe passage for pedestrians, bicycles, and motorized vehicles.

The City of San Diego conducted an environmental review of this site in accordance with the California Environmental Quality Act (CEQA) guidelines. The project was determined to be categorically exempt from CEQA pursuant to Article 19, Section 15332 which allows for construction of infill development within an urbanized area that can be adequately serviced by all required utilities and public services.

The permit for the project includes various conditions and referenced exhibits of approval relevant to achieving project compliance with the applicable regulations of the SDMC in effect for this project. Such conditions within the permit have been determined as necessary to avoid adverse impacts upon the health, safety and general welfare of persons residing or working in the surrounding area. The project shall comply with the development conditions in effect for the subject property as described in Site Development Permit No. 1937932, and other regulations and guidelines pertaining to the subject property per the SDMC. Prior to issuance of any building permit for the proposed development, the plans shall be reviewed for compliance with all Building, Electrical, Mechanical, Plumbing and Fire Code requirements, and the Owner/Permittee shall be required to obtain grading and public improvement permits. Therefore, the proposed development will not be detrimental to the public health, safety, and welfare.

c. The proposed development will comply with the regulations of the Land Development Code including any allowable deviations pursuant to the Land Development Code.

The project proposes a small lot subdivision containing 21 lots in accordance with SDMC Section 143.0365, 20 lots will be for single-family residential dwelling units and

one lot for parking, pedestrian circulation and landscaping. Two of the residential lots will be for affordable housing. The project site is located at 440 1/3 35th Street in the RM-1-1 Zone of the Southeastern San Diego Community Plan.

The proposed development includes 15 percent affordable housing and qualifies as an Affordable Housing development project pursuant to SDMC Section 143.0915. Because the project is providing 15 percent of the pre-density bonus units (2) as affordable, the project qualifies for a 50 percent density increase for a maximum of 20 dwelling units on the project site (13 (pre-density units) x 0.50 (density bonus allowed) = 6.5 rounds up to 7 additional units allowed). The project as proposed elects to develop a 20-unit small lot subdivision. The City is required to process incentives requested by the applicant, consistent with State Density Bonus Law and as set forth in SDMC Section 143.0720. In accordance with SDMC Table 143-07A, the project would be allowed five (5) incentives. The applicant is entitled to the concessions or incentives, in the form of deviations to the development regulations, unless the City makes a written finding of denial based on substantial evidence pursuant to SDMC Section 143.0740(c)(1) and Government Code Section 65915(d)(1). The applicant is requesting five (5) affordable housing incentives, in the form of deviations, as follows:

 An incentive to deviate from SDMC Section143.0365 and Table 143-03C – building height, increase in building height to 42 feet where the maximum height allowed is 36 feet.

The proposal to deviate from the building height requirement is due to the topography which drops off dramatically towards the western portion of the site. The drop off requires a tall stem wall to be constructed for the western units which pushes the height of the structures above the height limit. The height elevation is measured at proposed or finished grade, whichever is lower. At finished grade, the units are 34 feet tall. However, when measured from existing grade the highest point reaches 42 feet. To offset the height of the units, the third level of each unit steps back on the east and west sides, reducing the overall bulk and scale of each unit.

2. An incentive to deviate from SDMC Section 131.0444 – angled building envelope plane, to remove the angled building envelope plane requirement entirely.

The angled building envelope plane incentive will allow the single-family residential dwelling units to provide additional floor area to the third story. To help offset this condition, each of the twenty dwelling units step back on the third story to reduce the overall bulk and scale of each unit.

3. An incentive to deviate from SDMC Section 131.0431and Table 131-04G – rear yard setback, to reduce the minimum rear yard setback to a maximum five feet where 15 feet is required.

The proposed five-foot rear yard setback allows for the better utilization of the panhandle portion at the southwest corner of the site and along the western narrow

section of the site. The incentive fits two dwelling units into the southwest corner and allows the remaining homes along the western property line to increase livable floor area. The original design allowed the homes on the western property line to meet the setback requirements. However, due to the 13-foot dedication requirement to expand 35th Street 13 feet, the homes were pushed slightly to west causing an encroachment into the rear yard setback.

4. An incentive to deviate from SDMC Section 131.0431and Table 131-04G – front yard setback, to reduce the minimum front yard setback to 6 feet, 6-inches where 15/20 feet is required.

The requested reduction of the front yard setback is primarily caused from the 13foot dedication along 35th Street pushing back the front property line. The reduced setback allows the residential units to fit within the irregular shaped site. To help offset this, a short block wall runs in and out from the front property line, creating pockets of landscaping, extending the landscape area.

5. An incentive to deviate from SDMC Section 131.0431 and Table 131-04G – floor area ratio (FAR), to increase the FAR to 0.78 where the maximum FAR allowed is 0.75 percent

The 0.03 increase in FAR will allow each unit to maximize its living area.

The incentives are consistent with the intent of the State's Density Bonus Law. It has been determined that there is no substantial evidence pursuant to SDMC Section 143.0740(d)(1) or government Code Section 65915(d)(1) to deny the applicant's request for the incentives. Other than the requested incentives, the project meets all applicable regulations and policy documents, and is consistent with the recommended land use, design guidelines, and development standards in effect for this site per the SDMC and Southeastern San Diego Community Plan. The project is consistent with the community plan, has been designed to address the physical environment, and would not adversely impact the public's health or safety. Therefore, the proposed development will comply with the regulations of the Land Development Code including any allowable deviations pursuant to the Land Development Code.

The above findings are supported by the minutes, maps and exhibits, all of which are

incorporated herein by this reference.

BE IT FURTHER RESOLVED that, based on the findings hereinbefore adopted by the Planning

Commission Site Development Permit No. 1939732 is hereby GRANTED by the Planning Commission

to the referenced Owner/Permittee, in the form, exhibits, terms and conditions as set forth in Permit

No. 1937932, a copy of which is attached hereto and made a part hereof.

William Zounes Development Project Manager Development Services

Adopted on: October 3, 2019

IO#: 24007282

RECORDING REQUESTED BY CITY OF SAN DIEGO DEVELOPMENT SERVICES PERMIT INTAKE, MAIL STATION 501

WHEN RECORDED MAIL TO PROJECT MANAGEMENT PERMIT CLERK MAIL STATION 501

INTERNAL ORDER NUMBER: 24007282

SPACE ABOVE THIS LINE FOR RECORDER'S USE

SITE DEVELOPMENT PERMIT NO. 1937932 35TH AND J PROJECT NO. 549188 PLANNING COMMISSION

This Site Development Permit No. 1937932 is granted by the Planning Commission of the City of San Diego to 35th and J Partners, LLC, a Nevada Limited Lability Company, Owner and Permittee, pursuant to San Diego Municipal Code [SDMC] Section 143.0365. The 0.89-acre site is located 440 1/3 35th Street in the RM-1-1 zone of the Southeastern San Diego Community Plan area. The project site is legally described as: that portion of the northeast quarter of Pueblo Lot 1152 of the Pueblo lands of San Diego, in the City of San Diego, County of San Diego, State of California, according to Map by James Pascoe in 1870, filed in the Office of the County Recorder of San Diego County, November 14, 1921 and known as Miscellaneous Map No. 36 and all that portion of the northeast quarter of Pueblo Lot 1152, in the City of San Diego, county of San Diego, State of California, according to map made by James Pascoe in 1870, filed in the Office of the County Recorder of San Diego County, November 14, 1921, known as Miscellaneous Map No. 36 and the portion of the northeast quarter of Pueblo Lot 1152 of the Pueblo lands of San Diego, State of California, according to map made by James Pascoe in 1870, filed in the Office of the County Recorder of San Diego County, November 14, 1921, known as Miscellaneous Map No. 36 and the portion of the northeast quarter of Pueblo Lot 1152 of the Pueblo lands of San Diego, in the City of San Diego, County of San Diego, State of California, according to map thereof by James Pascoe in 1870, filed in the Office of the County Recorder of San Diego, County of San Diego, State of California, according to map thereof by James Pascoe in 1870, filed in the Office of the County Recorder of San Diego County, November 14, 1921, known as Miscellaneous Map No. 36;

Subject to the terms and conditions set forth in this Permit, permission is granted to Owner/Permittee for a Small Lot Subdivision for the construction of 20 single-family dwelling units on individual lots including two affordable units where 18 of the homes will include companion units and a 21st lot reserved for parking and landscaping described and identified by size, dimension, quantity, type, and location on the approved exhibits [Exhibit "A"] dated October 3, 2019 on file in the Development Services Department.

The project shall include:

a. Construction of 18 market rate single-family dwelling units with companion units ranging in size from 1,485 square feet to 1,525 square feet and two very low income affordable single-family dwellings at 1,525 square feet without companion units for a total of 20 single-family dwelling units and a lot reserved for parking and landscaping. All units to include private exterior areas, green roof modules, and a photo voltaic system;

- b. Development Incentives for Affordable Housing Density Bonus as follows:
 - 1. An increase in building height per SDMC Section 143.0365 and Table 143-03C to 42 feet where the maximum height allowed is 36 feet;
 - 2. Removal of the angled building requirement per SDMC Section 131.0444;
 - 3. Reduction in the minimum rear yard setback per SDMC Section 131.0431 and Table 131-04G to 5 feet where 15 feet is required;
 - 4. Reduction in the minimum front yard setback per SDMC Section 131.0431 and Table 131-04G to six feet, six inches where 15/20 feet is required;
 - 5. An increase in the maximum Floor Area Ratio per SDMC Section 131.0431 and Table 131-04G to 0.78 where the maximum FAR allowed is 0.75;
- c. Landscaping (planting, irrigation and landscape related improvements);
- d. Off-street parking;
- e. Retaining walls and fences;
- f. A roof-mounted photovoltaic system consisting of solar panels sufficient to generate at least 50 percent of the project's projected energy consumption; and
- g. Public and private accessory improvements determined by the Development Services Department to be consistent with the land use and development standards for this site in accordance with the adopted community plan, the California Environmental Quality Act [CEQA] and the CEQA Guidelines, the City Engineer's requirements, zoning regulations, conditions of this Permit, and any other applicable regulations of the SDMC.

STANDARD REQUIREMENTS:

1. This permit must be utilized within thirty-six (36) months after the date on which all rights of appeal have expired. If this permit is not utilized in accordance with Chapter 12, Article 6, Division 1 of the SDMC within the 36-month period, this permit shall be void unless an Extension of Time has been granted. Any such Extension of Time must meet all SDMC requirements and applicable guidelines in effect at the time the extension is considered by the appropriate decision maker. This permit must be utilized by October 17, 2022.

2. No permit for the construction, occupancy, or operation of any facility or improvement described herein shall be granted, nor shall any activity authorized by this Permit be conducted on the premises until:

- a. The Owner/Permittee signs and returns the Permit to the Development Services Department; and
- b. The Permit is recorded in the Office of the San Diego County Recorder.

3. While this Permit is in effect, the subject property shall be used only for the purposes and under the terms and conditions set forth in this Permit unless otherwise authorized by the appropriate City decision maker.

4. This Permit is a covenant running with the subject property and all of the requirements and conditions of this Permit and related documents shall be binding upon the Owner/Permittee and any successor(s) in interest.

5. The continued use of this Permit shall be subject to the regulations of this and any other applicable governmental agency.

6. Issuance of this Permit by the City of San Diego does not authorize the Owner/Permittee for this Permit to violate any Federal, State or City laws, ordinances, regulations or policies including, but not limited to, the Endangered Species Act of 1973 [ESA] and any amendments thereto (16 U.S.C. § 1531 et seq.).

7. The Owner/Permittee shall secure all necessary building permits. The Owner/Permittee is informed that to secure these permits, substantial building modifications and site improvements may be required to comply with applicable building, fire, mechanical, and plumbing codes, and State and Federal disability access laws.

8. Construction plans shall be in substantial conformity to Exhibit "A." Changes, modifications, or alterations to the construction plans are prohibited unless appropriate application(s) or amendment(s) to this Permit have been granted.

9. All of the conditions contained in this Permit have been considered and were determined necessary to make the findings required for approval of this Permit. The Permit holder is required to comply with each and every condition in order to maintain the entitlements that are granted by this Permit.

10. If any condition of this Permit, on a legal challenge by the Owner/Permittee of this Permit, is found or held by a court of competent jurisdiction to be invalid, unenforceable, or unreasonable, this Permit shall be void. However, in such an event, the Owner/Permittee shall have the right, by paying applicable processing fees, to bring a request for a new permit without the "invalid" conditions(s) back to the discretionary body which approved the Permit for a determination by that body as to whether all of the findings necessary for the issuance of the proposed permit can still be made in the absence of the "invalid" condition(s). Such hearing shall be a hearing de novo, and the discretionary body shall have the absolute right to approve, disapprove, or modify the proposed permit and the condition(s) contained therein.

11. The Owner/Permittee shall defend, indemnify, and hold harmless the City, its agents, officers, and employees from any and all claims, actions, proceedings, damages, judgments, or costs, including attorney's fees, against the City or its agents, officers, or employees, relating to the issuance of this permit including, but not limited to, any action to attack, set aside, void, challenge, or annul this development approval and any environmental document or decision. The City will promptly notify Owner/Permittee of any claim, action, or proceeding and, if the City should fail to cooperate fully in the defense, the Owner/Permittee shall not thereafter be responsible to defend, indemnify, and hold harmless the City or its agents, officers, and employees. The City may elect to conduct its own defense, participate in its own defense, or obtain independent legal counsel in defense of any claim related to this indemnification. In the event of such election, Owner/Permittee shall pay all of the costs related thereto, including without limitation reasonable attorney's fees and costs. In the event of a disagreement between the City and Owner/Permittee regarding litigation issues, the City shall have the authority to control the litigation and make litigation related decisions, including, but not limited to, settlement or other disposition of the matter. However, the Owner/Permittee shall not be required to pay or perform any settlement unless such settlement is approved by Owner/Permittee.

CLIMATE ACTION PLAN REQUIREMENTS:

12. Owner/Permittee shall comply with the Climate Action Plan (CAP) Consistency Checklist stamped as Exhibit "A." Prior to issuance of any construction permit, all CAP strategies shall be noted within the first three (3) sheets of the construction plans under the heading "Climate Action Plan Requirements" and shall be enforced and implemented to the satisfaction of the Development Services Department.

ENVIRONMENTAL REQUIREMENTS:

13. Prior to issuance of any residential building permit, the Owner/Permittee shall submit an acoustical analysis report that identifies sound transmission reduction measures demonstrating that building structures will attenuate exterior noise to a 45 dBA CNEL in habitable residential space per the preliminary recommendations of the project-specific Noise Study by LDN Consulting, Inc July 2, 2018.

14. Prior to issuance of any residential building permit, the Owner/Permittee shall submit an acoustical analysis report that identifies sound transmission reduction measures that will attenuate exterior noise to a (noise level stated in report) in private outdoor use areas per the preliminary recommendations of the project-specific Noise Study by LDN Consulting, Inc July 2, 2018.

AFFORDABLE HOUSING REQUIREMENTS:

15. Prior to issuance of any building permit associated with this Project, the Owner/Permittee shall demonstrate compliance with the provisions of the Affordable Housing Density Bonus Regulations of Chapter 14, Article 3, Division 7 of the San Diego Municipal Code. The Owner/Permittee shall enter into a written Agreement with the San Diego Housing Commission which shall be drafted and approved by the San Diego Housing Commission, executed by the Owner/Permitee, and secured by a deed of trust which incorporates applicable affordability conditions consistent with the San Diego

Municipal Code. The Agreement will specify that in exchange for the City's approval of the Project, which contains a 50 percent density bonus (seven units in addition to what is permitted by the underlying zoning regulations), alone or in conjunction with any incentives or concessions granted as part of Project approval. The Owner/Permittee shall provide two density bonus units with rents to very low incomes households of no more than 30 percent of 50 percent of AMI for no fewer than 55 years.

16. The Agreement referenced in the preceding paragraph will satisfy the requirements of San Diego Municipal Code section 143.1303(g) and therefore, exempt the Project from the Inclusionary Affordable Housing Regulations in Chapter 14, Article 2, Division 13 of the San Diego Municipal Code.

ENGINEERING REQUIREMENTS:

17. The Site Development Permit shall comply with all Conditions of the Final Map for the Tentative Map No.1937933.

18. The project proposes to export no material from the project site. Any excavated material that is exported, shall be exported to a legal disposal site in accordance with the Standard Specifications for Public Works Construction (the "Green Book"), 2015 edition and Regional Supplement Amendments adopted by Regional Standards Committee.

19. The drainage system proposed for this development, as shown on the site plan, is private and subject to approval in a manner satisfactory to the City Engineer.

20. Prior to the issuance of any building permits, the Owner/Permittee shall obtain a bonded grading permit for the grading proposed for this project. All grading shall conform to the requirements of the City of San Diego Municipal Code in a manner satisfactory to the City Engineer.

21. Prior to the issuance of any building permits, the Owner/Permittee shall obtain an Encroachment Maintenance Removal Agreement, from the City Engineer, for the sidewalk underdrain/curb outlet in the 35th Street Right-of-Way.

22. Prior to the issuance of any building permits, the Owner/Permittee shall obtain an Encroachment Maintenance Removal Agreement, from the City Engineer, for any landscaping or private improvements in the 35th Street Right-of-Way.

23. Prior to the issuance of any building permits, the Owner/Permittee shall assure, by permit and bond, the construction of a current City Standard 20-foot wide driveway, adjacent to the site on 35th Street, in a manner satisfactory to the City Engineer.

24. Prior to the issuance of any building permits, the Owner/Permittee shall assure, by permit and bond, the closure of all non-utilized driveways with current City Standard curb, gutter and sidewalk, adjacent to the site on 35th Street, in a manner satisfactory to the City Engineer.

25. Prior to the issuance of any building permits, the Owner/Permittee shall assure, by permit and bond, to construct a sidewalk with current City Standard sidewalk, maintaining the existing sidewalk

scoring pattern and preserving the contractor's stamp, adjacent to the site on 35th Street, in a manner satisfactory to the City Engineer.

26. Prior to the issuance of any building permits, the Owner/Permittee shall assure, by permit and bond, to construct a curb with City Standard curb and gutter, adjacent to the site on 35th Street, in a manner satisfactory to the City Engineer.

27. Prior to the issuance of any building permits, the Owner/Permittee shall assure, by permit and bond, to construct curb ramps, as shown in Exhibit "A" with current City Standard curb ramp Standard Drawing SDG-130 and SDG-132 with truncated domes, in a manner satisfactory to the City Engineer.

28. Whenever street rights-of-way are required to be dedicated, it is the responsibility of the Owner/Permittee to provide the right-of-way free and clear of all encumbrances and prior easements. The Applicant must secure "subordination agreements" for minor distribution facilities and/or "joint-use agreements" for major transmission facilities.

29. Prior to the issuance of any construction permit, the Owner/Permittee shall enter into a Maintenance Agreement for the ongoing permanent Best Management Practices maintenance, in a manner satisfactory to the City Engineer.

30. Prior to the issuance of any construction permit, the Owner/Permittee shall incorporate any construction Best Management Practices necessary to comply with Chapter 14, Article 2, Division 1 (Grading Regulations) of the San Diego Municipal Code, into the construction plans or specifications.

31. Prior to the issuance of any construction permit, the Owner/Permittee shall submit a Technical Report that will be subject to final review and approval by the City Engineer, based on the Storm Water Standards in effect at the time of the construction permit issuance.

32. Prior to the issuance of any construction permit, the Owner/Permittee shall submit a Water Pollution Control Plan (WPCP). The WPCP shall be prepared in accordance with the guidelines in Part 2 Construction BMP Standards Chapter 4 of the City's Storm Water Standards.

LANDSCAPE REQUIREMENTS:

33. Prior to issuance of any engineering permits for grading, the Owner/Permittee shall submit complete construction documents for the revegetation and hydroseeding of all disturbed land in accordance with the City of San Diego Landscape Standards, Stormwater Design Manual, and to the satisfaction of the Development Services Department. All plans shall be in substantial conformance to this permit (including Environmental conditions) and Exhibit "A", on file in the Office of the Development Services Department.

34. Prior to issuance of any engineering permits for right-of-way improvements, the Owner/Permitee shall submit complete landscape construction documents for right-of-way improvements to the Development Services Department for approval. Improvement plans shall show, label, and dimension a 40-square-foot area around each tree which is unencumbered by

utilities. Driveways, utilities, drains, water and sewer laterals shall be designed so as not to prohibit the placement of street trees.

35. Prior to issuance of any construction permits for structures, the Owner/Permittee shall submit complete landscape and irrigation construction documents consistent with the Landscape Standards to the Development Services Department for approval. The construction documents shall be in substantial conformance with Exhibit "A", Landscape Development Plan, on file in the Office of the Development Services Department.

36. The Owner/Permittee shall be responsible for the maintenance of all landscape improvements shown on the approved plans, including in the right-of-way, unless long-term maintenance of said landscaping shall be the responsibility of a Landscape Maintenance District or other approved entity. All required landscape shall be maintained in a disease, weed and litter free condition at all times consistent with the City of San Diego Landscape Regulations and Standards.

37. If any required landscape (including existing or new plantings, hardscape, landscape features, etc.) indicated on the approved construction document plans is damaged or removed during demolition or construction, the Owner/Permittee shall repair and/or replace in kind and equivalent size per the approved documents to the satisfaction of the Development Services Department within 30 days of damage or Certificate of Occupancy.

PLANNING/DESIGN REQUIREMENTS:

38. Prior to issuance of a certificate of occupancy, a Mutual Maintenance and Access Agreement for all facilities used in common will be entered into to the satisfaction of the City Engineer and shall be recorded against the applicable properties in the office of the San Diego County Recorder

39. The Mutual Maintenance and Access Agreement shall, at a minimum, include and provide for the following:

- a) Prior to issuance of a certificate of occupancy for the first building permit, a Mutual Maintenance and Access Agreement for all facilities used in common will be entered into by the Owner/Permittee to the satisfaction of the City Engineer and shall be recorded against the applicable properties in the office of the San Diego County Recorder.
- a) Easements for 1) Shared driveway, 2) Parking aisles, 3) Parking facilities, 4) Utilities, 5) Drainage and runoff, 6) Common paved and landscaped areas, 7) Encroachments, 8) Maintenance, repair, and reconstruction;
- b) Maintenance for: 1) Shared driveway, 2) Drive aisles, 3) Parking facilities, 4) Utilities, 5) Cable and electrical lines, 6) Exterior lighting, 7) Fences, walls and common paved and landscaped areas as shown on Exhibit "A", satisfactory to the City Engineer.
- c) Easements for common utilities shall not traverse through private lots

40. All private outdoor lighting shall be shaded and adjusted to fall on the same premises where such lights are located and in accordance with the applicable regulations in the SDMC.

TRANSPORTATION REQUIREMENTS

41. All automobile, motorcycle and bicycle parking spaces must be constructed in accordance with the requirements of the San Diego Municipal Code (SDMC). All on-site parking stalls and aisle widths shall be in compliance with requirements of the City's Land Development Code and shall not be converted and/or utilized for any other purpose, unless otherwise authorized in writing by the appropriate City decision maker in accordance with the SDMC.

42. Prior to the issuance of any building permits, the Owner/Permittee shall dedicate, and assure by permit and bond, the improvement of additional right of way to provide a 30-foot wide curb-to-curb roadway and a 10-foot wide curb-to-property line parkway along 35th Street frontage, as shown in approved Exhibit "A", in a manner satisfactory to City Engineer

PUBLIC UTILITIES DEPARTMENT REQUIREMENTS:

43. No trees or shrubs exceeding three feet in height at maturity shall be installed within 10 feet of any sewer facilities and five feet of any water facilities.

44. The Owner/Permittee shall design and construct all proposed public water and sewer facilities in accordance with established criteria in the current edition of the City of San Diego Water and Sewer Facility Design Guidelines and City regulations, standards and practices.

45. Prior to any Certificate of Occupancy being issued, the Owner/Permittee is required to ensure that any and all separately titled units which share water or sewer service connections to the City's public utility systems are encumbered by Covenants, Conditions, and Restrictions (CC&Rs) written so as to ensure (to the satisfaction of the Public Utilities Director) that the operation and maintenance of all such shared water and/or sewer facilities will be provided for in perpetuity.

INFORMATION ONLY:

- The issuance of this discretionary permit alone does not allow the immediate commencement or continued operation of the proposed use on site. Any operation allowed by this discretionary permit may only begin or recommence after all conditions listed on this permit are fully completed and all required ministerial permits have been issued and received final inspection.
- Any party on whom fees, dedications, reservations, or other exactions have been imposed as conditions of approval of this Permit, may protest the imposition within ninety days of the approval of this development permit by filing a written protest with the City Clerk pursuant to California Government Code-section 66020.

• This development may be subject to impact fees at the time of construction permit issuance.

APPROVED by the Planning Commission of the City of San Diego on October 3, 2019.

Site Development Permit No. 1937932: Date of Approval: October 3, 2019

AUTHENTICATED BY THE CITY OF SAN DIEGO DEVELOPMENT SERVICES DEPARTMENT

William Zounes Development Project Manager

NOTE: Notary acknowledgment must be attached per Civil Code section 1189 et seq.

The undersigned Owner/Permittee, by execution hereof, agrees to each and every condition of this Permit and promises to perform each and every obligation of Owner/Permittee hereunder.

35th and J Partners, LLC Owner/Permittee

By .

Jason Elder: Title: Managing Member

NOTE: Notary acknowledgments must be attached per Civil Code section 1189 et seq.

PLANNING COMMISSION RESOLUTION NUMBER R-_____

TENTATIVE MAP NO. 1937933, 35TH AND J - PROJECT NO. 549188

WHEREAS, 35th and J Partners, LLC., a Nevada Limited Lability Company, Subdivider, and, William A. Snipes, Engineer, submitted an application to the City of San Diego for a Tentative Map (Tentative Map No. 1937933) to create 20 lots for single-family residential dwelling units and a lot for parking, pedestrian circulation and landscaping, and to waive the requirement to underground existing offsite overhead utilities. The project site is located at 440 1/3 35th Street. The property is legally described as that portion of the northeast quarter of Pueblo Lot 1152 of the Pueblo lands of San Diego, in the City of San Diego, County of San Diego, State of California, according to Map by James Pascoe in 1870, filed in the Office of the County Recorder of San Diego County, November 14, 1921 and known as Miscellaneous Map No. 36 and all that portion of the northeast quarter of Pueblo Lot 1152, in the City of San Diego, county of San Diego, State of California, according to map made by James Pascoe in 1870, filed in the Office of the County Recorder of San Diego County, November 14, 1921, known as Miscellaneous Map No. 36 and the portion of the northeast guarter of Pueblo Lot 1152 of the Pueblo lands of San Diego, in the City of San Diego, County of San Diego, State of California, according to map thereof by James Pascoe in 1870, filed in the Office of the County Recorder of San Diego County, November 14, 1921, known as Miscellaneous Map No. 36; and

WHEREAS, the Map proposes the Subdivision of a 0.89-acre site into twenty-one (21) lots for 20 residential dwelling units and one lot for parking, pedestrian circulation and landscaping; and

WHEREAS, on August 26, 2019, the City of San Diego, as Lead Agency, through the Development Services Department, made and issued an Environmental Determination that the

project is exempt from the California Environmental Quality Act [CEQA] (Public Resources Code section 21000 et. seq.) under CEQA Guideline Section 15332; and there was no appeal of the Environmental Determination filed within the time period provided by San Diego Municipal Code Section 112.0520;

WHEREAS, the project complies with the requirements of a preliminary soils and/or geological reconnaissance report pursuant to Subdivision Map Act sections 66490 and 66491(b)-(f) and San Diego Municipal Code section 144.0220; and

WHEREAS, on October 3, 2019, the Planning Commission of the City of San Diego considered

Tentative Map No. 1937933, including the waiver of the requirement to underground existing offsite

overhead utilities, and pursuant to San Diego Municipal Code sections 125.0440,144.0240 and

Subdivision Map Act section 66428, received for its consideration written and oral presentations,

evidence having been submitted, and testimony having been heard from all interested parties at the

public hearing, and the Planning Commission having fully considered the matter and being fully

advised concerning the same; NOW THEREFORE,

BE IT RESOLVED by the Planning Commission of the City of San Diego, that it adopts the following findings with respect to Tentative Map No. 1937933:

1. The proposed subdivision and its design or improvement are consistent with the policies, goals, and objectives of the applicable land use plan.

The project proposes a small lot subdivision containing 21 lots in accordance with San Diego Municipal Code (SDMC) Section 143.0365. 20 lots will be for single-family residential dwelling units and one lot for parking, pedestrian circulation and landscaping. The project site is located at 440 1/3 35th Street in the RM-1-1 Zone of the Southeastern San Diego Community Plan. The vacant site consists of three irregularly shaped parcels fronting 35th Street to the east and Interstate 15 off-ramp to the west. The Southeastern San Diego Community Plan designates the 0.89-acre site for Residential Low-Medium which allows both single-family and multi-family housing within a density range of 10-14 dwelling units per acre. Eighteen of the residential lots will contain a companion unit and the remaining two residential lots will be for affordable housing.

Most neighborhoods in Southeastern San Diego are in the Residential–Low Medium category with a mix of single-family and small-scale multi-family development. The Southeastern San Diego Community Plan [Plan] recommends enhancing the community 's identity with strategic new higher density residential development in proximity to transit, improving the community's streets for the safe and efficient movement of pedestrians, bicyclists, transit, and vehicles and by sustainable practices in new development (mobility, water and energy conservation) in order to reduce greenhouse gas emissions. The Plan identifies opportunities for residential infill development within vacant lots in proximity to transit and by the construction of companion units on lower density residential sites. Infill development is anticipated to offer more housing choices, including mixeduse units, multi-family housing, and townhome projects which can be appropriately scaled to the vacant lot sizes.

The base density for the subject property is 13 units (10-14 dwelling units per acre). Applying the Density Bonus allowance in accordance with San Diego Municipal Code Section 143.0720, increases the density to 20 units. The project provides a higher density for this site through the design of separate townhome units with companion units. The units are appropriately scaled to the surrounding residential neighborhood and would provide added housing choices within the neighborhood.

The Housing Element of the General Plan serves as a policy guide to address the comprehensive housing needs of the City of San Diego. Specific to affordable housing, Goal No. 4 of the Housing Element is to "provide affordable housing opportunities consistent with a land use pattern which promotes infill development and socioeconomic equity; and facility compliance with all applicable federal, state, and local laws and regulations". Policy direction specific to density bonus is to, 1) Encourage and promote the use of available Housing Density Bonus Programs. Future consideration should be given to expanding density bonus incentives and provisions, and 2) Enforce all Federal, State, and Local ordinances or regulations pertaining to land use incentives which promote affordable housing opportunities for low- and moderate-income homebuyers, such as inclusionary housing and density bonus. The proposed project incorporates the General Plan Housing Element by processing a project proposing affordable housing and applying the density bonus regulation of SDMC Section 143.0720

The project would improve the safety and efficiency of 35th Street by dedicating 13 feet of frontage width (over 300 feet of total frontage length) to help improve the community's street and provide safe passage for pedestrian, bicyclist and vehicles. The current narrow 35th Street fronting the project will be widened from 24 feet to 30 feet (curb to curb) with a landscape parkway and sidewalk to allow for a two-way vehicular road and parking on both sides of the street.

The project would provide several sustainable design features for reducing energy and water use within the residences. Each of the proposed twenty dwelling units have rain collection barrels, collecting water runoff that would normally be running into the surrounding soils or down to street gutters. Each unit also has roof mounted photo voltaic systems and green roof modules (Live Roofs), reducing each unit's energy requirements.

The proposed project is designed to maintain the character of the neighborhood by creating a single-family style townhome development. A tentative map is required to provide individual lots and promote a townhome design that maintains the single-family theme that's reflected throughout the neighborhood. The low-density character is maintained while bringing more dwelling units into the neighborhood. The proposed project is also located near public transit connecting the development to the greater region. Therefore, the proposed subdivision and its design or improvement are consistent with the policies, goals, and objectives of the applicable land use plan.

2. The proposed subdivision complies with the applicable zoning and development regulations of the Land Development Code, including any allowable deviations pursuant to the land development code.

The project proposes a small lot subdivision containing 21 lots in accordance with SDMC Section 143.0365. 20 lots will be for single-family residential dwelling units and one lot for parking, pedestrian circulation and landscaping. Two of the residential lots will be for affordable housing. The project site is located at 440 1/3 35th Street in the RM-1-1 Zone of the Southeastern San Diego Community Plan.

The neighborhood currently contains power poles and overhead utility lines within the public right-of-way along the alley located along 35th Street. The City's Undergrounding Master Plan designates the site within MTHP-05 and is unallocated for undergrounding. The proposed subdivision utilities shall be undergrounded and the project includes a waiver from the requirement to underground the existing overhead utilities within the boundary of the subdivision or within the abutting public rights-of-way. In accordance with <u>SDMC Section144.0240(b)(5)</u>, the waiver of the requirements to underground privately owned utility systems and service facilities qualifies under the guidelines of <u>SDMC Section 144.0242(c)(2)</u> as follows: Inordinate cost to the development taking into consideration – the cost of conversion would increase the cost per unit for proposed residential development by more than one percent.

The proposed development includes 15 percent affordable housing and qualifies as an Affordable Housing development project pursuant to SDMC Section 143.0915. Because the project is providing 15 percent of the pre-density bonus units (2) as affordable, the project qualifies for a 50 percent density increase for a maximum of 20 dwelling units on the project site (13 (pre-density units) x 0.50 (density bonus allowed) = 6.5 rounds up to 7 additional units allowed). The project as proposed elects to develop a 20-unit small lot subdivision. The City is required to process incentives requested by the applicant, consistent with State Density Bonus Law and as set forth in SDMC Section 143.0720. In accordance with SDMC Table 143-07A, the project would be allowed five (5) incentives. The applicant is entitled to the concessions or incentives, in the form of deviations to the development regulations, unless the City makes a written finding of denial based on substantial evidence pursuant to SDMC Section 143.0740(c)(1) and Government Code Section 65915(d)(1). The applicant is requesting five (5) affordable housing incentives, in the form of deviations, as follows:

1. An incentive to deviate from SDMC Section143.0365 and Table 143-03C – building height, increase in building height to 42 feet where the maximum height allowed is 36 feet.

The proposal to deviate from the building height requirement is due to the topography which drops off dramatically towards the western portion of the site. The drop off requires a tall stem wall to be constructed for the western units which pushes the height of the structures above the height limit. The height elevation is measured at proposed or finished grade, whichever is lower. At finished grade, the units are 34 feet tall. However, when measured from existing grade the

highest point reaches 42 feet. To offset the height of the units, the third level of each unit steps back on the east and west sides, reducing the overall bulk and scale of each unit.

2. An incentive to deviate from SDMC Section 131.0444 – angled building envelope plane, to remove the angled building envelope plane requirement entirely.

The angled building envelope plane incentive will allow the single-family residential dwelling units to provide additional floor area to the third story. To help offset this condition, each of the twenty dwelling units step back on the third story to reduce the overall bulk and scale of each unit.

3. An incentive to deviate from SDMC Section 131.0431and Table 131-04G – rear yard setback, to reduce the minimum rear yard setback to a maximum five feet where 15 feet is required.

The proposed five-foot rear yard setback allows for the better utilization of the panhandle portion at the southwest corner of the site and along the western narrow section of the site. The incentive fits two dwelling units into the southwest corner and allows the remaining homes along the western property line to increase livable floor area. The original design allowed the homes on the western property line to meet the setback requirements. However, due to the 13-foot dedication requirement to expand 35th Street 13 feet, the homes were pushed slightly to west causing an encroachment into the rear yard setback.

4. An incentive to deviate from SDMC Section 131.0431and Table 131-04G – front yard setback, to reduce the minimum front yard setback to 6 feet, 6-inches where 15/20 feet is required.

The requested reduction of the front yard setback is primarily caused from the 13-foot dedication along 35th Street pushing back the front property line. The reduced setback allows the residential units to fit within the irregular shaped site. To help offset this, a short block wall runs in and out from the front property line, creating pockets of landscaping, extending the landscape area.

5. An incentive to deviate from SDMC Section 131.0431 and Table 131-04G – floor area ratio (FAR), to increase the FAR to 0.78 where the maximum FAR allowed is 0.75 percent

The 0.03 increase in FAR will allow each unit to maximize its living area.

The incentives are consistent with the intent of the State's Density Bonus Law. It has been determined that there is no substantial evidence pursuant to SDMC Section 143.0740(d)(1) or government Code Section 65915(d)(1) to deny the applicant's request for the incentives. Other than the requested incentives, the project meets all applicable regulations and policy documents, and is consistent with the recommended land use, design guidelines, and development standards in effect for this site per the SDMC and Southeastern San Diego Community Plan. The project is consistent with the community plan, has been designed to address the physical environment, and would not adversely impact the public's health or safety. Therefore, the proposed development will comply with the regulations of the Land Development Code including any allowable deviations pursuant to the Land Development Code.

3. The site is physically suitable for the type and density of development.

The site is mostly flat with the exception of a steep fall off along the western edge of the property towards Interstate 15. To ensure that each of the twenty units is Americans with Disability Act (ADA) accessible, the proposed grading includes minor cut and fill to even out the center of the site so that each unit is accessible both from the sidewalk as well as from the parking lot and to support the stem wall for the structures on the west side of the site. There are no existing structures or existing environmental conditions that would adversely affect constructing the proposed project on the subject site as the site does not contain environmentally sensitive lands. The existing 38,815 square-foot site can accommodate up to 20 dwelling units in accordance with the RM-1-1 zone and Density Bonus allowance. The Southeastern San Diego Community Plan designates the site as Residential Low-Medium. The creation of 20 residential parcels is consistent with the community plan's land use designation and zoning density range. Therefore, the site is physically suitable for the type and density of development.

4. The design of the subdivision or the proposed improvements are not likely to cause substantial environmental damage or substantially and avoidably injure fish or wildlife or their habitat.

The City of San Diego conducted a California Environmental Quality Act (CEQA) Initial Study and determined that the proposed project will not have a significant environmental effect and the preparation of an Environmental Impact Report will not be required. The project was determined to be categorically exempt from CEQA pursuant to Article 19, Section 15332 which allows for construction of infill development within an urbanized area that can be adequately serviced by all required utilities and public services. The project is located within an urbanized and built-out environment where there are no watercourses, environmentally sensitive lands or Multiple Species Conservation Program/Multiple Habitat Planning Area harboring fish or wildlife on or adjacent to the site. Therefore, the subdivision or the proposed improvements will not cause substantial environmental damage or substantially injure fish or wildlife or their habitat.

5. The design of the subdivision or the type of improvement will not be detrimental to the public health, safety, and welfare.

The project proposes a small lot subdivision containing 21 lots in accordance with SDMC Section 143.0365. 20 lots will be for single-family residential dwelling units and one lot for parking, pedestrian circulation and landscaping. Two of the residential lots will be reserved for affordable housing. The project site is located west of 35th Street north of J Street and south of Island Avenue in the RM-1-1 Zone of the Southeastern San Diego Community Plan.

In addition to the on-site construction of the small lot subdivision, the project includes the widening of 35th Street with the construction of curb, gutter, sidewalk, and curb ramp to current City Standards and maintaining the existing sidewalk scoring pattern, adjacent to the site on 35th Street creating a safe passage for pedestrians, bicycles, and motorized vehicles.

The City of San Diego conducted an environmental review of this site in accordance with the California Environmental Quality Act (CEQA) guidelines. The project was determined to be categorically exempt from CEQA pursuant to Article 19, Section 15332 which allows for construction

of infill development within an urbanized area that can be adequately serviced by all required utilities and public services.

The permit for the project includes various conditions and referenced exhibits of approval relevant to achieving project compliance with the applicable regulations of the SDMC in effect for this project. Such conditions within the permit have been determined as necessary to avoid adverse impacts upon the health, safety and general welfare of persons residing or working in the surrounding area. The project shall comply with the development conditions in effect for the subject property as described in Tentative Map No. 1937933, and other regulations and guidelines pertaining to the subject property per the SDMC. Prior to issuance of any building permit for the proposed development, the plans shall be reviewed for compliance with all Building, Electrical, Mechanical, Plumbing and Fire Code requirements, and the Owner/Permittee shall be required to obtain grading and public improvement permits. Therefore, the design of the subdivision or the type of improvement will not be detrimental to the public health, safety, and welfare.

6. The design of the subdivision or the type of improvements will not conflict with easements acquired by the public at large for access through or use of property within the proposed subdivision.

The proposed subdivision will not conflict with existing public easements as there are none on the site. The site has frontage on 35th Street which is a dedicated public right-of-way. Additionally, general utilities run along the public rights-of-way and not through the existing project site. The subdivision proposes public improvements to includes the widening of 35th Street with the construction of curb, gutter, sidewalk, and curb ramp to current City Standards and maintaining the existing sidewalk scoring pattern, adjacent to the site on 35th Street. Therefore, the design of the subdivision and proposed improvements would not conflict with easements acquired by the public at large for access through or use of property within the proposed subdivision.

7. The design of the proposed subdivision provides, to the extent feasible, for future passive or natural heating and cooling opportunities.

The project proposes a small lot subdivision containing 21 lots in accordance with SDMC Section 143.0365. 20 lots will be for single-family residential dwelling units and one lot for parking, pedestrian circulation and landscaping. The design of the subdivision has taken into account the best use of the land to minimize grading. The project design has been adopted for the future construction of the single-family homes; however, they do not impede or inhibit any future passive or natural heating and cooling opportunities. With the independent design of the proposed subdivision each structure will have the opportunity through building materials, site orientation, architectural treatments, placement and selection of plant materials to provide to the extent feasible. The project features several sustainable factors that benefit the residents living at the proposed development as well as the surrounding neighborhood. Each of the proposed 20 dwelling units will contain a roof mounted photo voltaic system sufficient to generate at least 50 percent of the project's projected energy consumption and green roof modules (Live Roofs), reducing each unit's energy requirements. The green roofs will reduce the thermal load on the roof and each unit is designed with operable windows on the eastern and western elevations, allowing cross ventilation. Therefore, the design of the proposed subdivision provides, to the extent feasible, for future passive or natural heating and cooling opportunities.

8. The decision maker has considered the effects of the proposed subdivision on the housing needs of the region and that those needs are balanced against the needs for public services and the available fiscal and environmental resources.

The project proposes a small lot subdivision containing 21 lots in accordance with SDMC Section 143.0365. 20 lots will be for single-family residential dwelling units and one lot for parking, pedestrian circulation and landscaping. Two of the residential lots will be for affordable housing. The proposed subdivision is within a built urbanized community with adequate infrastructure. The decision maker has determined that the available fiscal and environmental resources are balanced by adequate public transit in the immediate area, the proximity of shopping and essential services and recreation in the nearby developed urban area. The project is within 0.40 miles from public transit and 0.25 -0.50 miles from retail services and Dennis V. Allen park. Therefore, the housing needs of the region are balanced against the needs for public services and the available fiscal and environmental resources.

The above findings are supported by the minutes, maps, and exhibits, all of which are herein

incorporated by reference.

BE IT FURTHER RESOLVED, that based on the Findings hereinbefore adopted by the Planning

Commission, Tentative Map No. 1937933, including the waiver of the requirement to underground

existing offsite overhead utilities, is hereby granted to 35th and J Partners, LLC subject to the

attached conditions which are made a part of this resolution by this reference.

By

William Zounes Development Project Manager Development Services Department

ATTACHMENT: Tentative Map Conditions

Internal Order No. 24007282

PLANNING COMMISSION CONDITIONS FOR TENTATIVE MAP NO. 1937933, 35TH AND J- PROJECT NO. 549188 ADOPTED BY RESOLUTION NO. R-_____ ON ______

GENERAL

- 1. This Tentative Map will expire October 17, 2022.
- 2. Compliance with all of the following conditions shall be completed and/or assured, to the satisfaction of the City Engineer, prior to the recordation of the Parcel map, unless otherwise noted.
- 3. Prior to the recordation of the Final Map, taxes must be paid on this property pursuant to Subdivision Map Act section 66492. To satisfy this condition, a tax certificate stating that there are no unpaid lien conditions against the subdivision must be recorded in the Office of the San Diego County Recorder.
- 4. The Tentative Map shall conform to the provisions of Site Development Permit No. 1937932.
- 5. The Subdivider shall defend, indemnify, and hold the City (including its agents, officers, and employees [together, "Indemnified Parties"]) harmless from any claim, action, or proceeding, against the City and/or any Indemnified Parties to attack, set aside, void, or annul City's approval of this project, which action is brought within the time period provided for in Government Code section 66499.37. City shall promptly notify Subdivider of any claim, action, or proceeding and shall cooperate fully in the defense. If City fails to promptly notify Subdivider of any claim, action, or proceeding, or if City fails to cooperate fully in the defense, Subdivider shall not thereafter be responsible to defend, indemnify, or hold City and/or any Indemnified Parties harmless. City may participate in the defense of any claim, action, or proceeding if City both bears its own attorney's fees and costs, City defends the action in good faith, and Subdivider is not required to pay or perform any settlement unless such settlement is approved by the Subdivider.

ENGINEERING

- Per the City of San Diego Street Design Manual-Street Light Standards, and Council Policy 200-18, the Subdivider will be required to install a new street light adjacent to the site on 35th Street.
- 7. The Subdivider shall underground any new service run to any new or proposed structures within the subdivision.
- 8. The Subdivider shall ensure that all existing onsite utilities serving the subdivision shall be undergrounded with the appropriate permits. The Subdivider shall provide written confirmation from applicable utilities that the conversion has taken place, or provide other means to assure the undergrounding, satisfactory to the City Engineer.

9. Conformance with the "General Conditions for Tentative Subdivision Maps," filed in the Office of the City Clerk under Document No. 767688 on May 7, 1980, is required. Only those exceptions to the General Conditions which are shown on the Tentative Map and covered in these special conditions will be authorized. All public improvements and incidental facilities shall be designed in accordance with criteria established in the Street Design Manual, filed with the City Clerk as Document No. RR-297376.

MAPPING

- 10. "Basis of Bearings" means the source of uniform orientation of all measured bearings shown on the map. Unless otherwise approved, this source shall be the California Coordinate System, Zone 6, North American Datum of 1983 [NAD 83].
- 11. "California Coordinate System" means the coordinate system as defined in Section 8801 through 8819 of the California Public Resources Code. The specified zone for San Diego County is "Zone 6," and the official datum is the "North American Datum of 1983."
- 12. The Tentative Map shall:
 - a. Use the California Coordinate System for its "Basis of Bearing" and express all measured and calculated bearing values in terms of said system. The angle of grid divergence from a true median (theta or mapping angle) and the north point of said map shall appear on each sheet thereof. Establishment of said Basis of Bearings may be by use of existing Horizontal Control stations or astronomic observations.
 - b. Show two measured ties from the boundary of the map to existing Horizontal Control stations having California Coordinate values of First Order accuracy. These tie lines to the existing control shall be shown in relation to the California Coordinate System (i.e., grid bearings and grid distances). All other distances shown on the map are to be shown as ground distances. A combined factor for conversion of grid-to-ground distances shall be shown on the map.
- **13.** The Final Map shall be based on field survey and all lot corners must be marked with durable survey monuments pursuant to Section 144.0311(d) of the City of San Diego Land Development Codes and Subdivision Map Act Section 66495. All survey monuments shall be set prior to the recordation of the Final Map, unless the setting of monuments is deemed impractical due to the proposed improvements and/or grading associated with the project, in which case, delayed monumentation may be applied on the Final Map.

INFORMATION:

• The approval of this Tentative Map by the Planning Commission of the City of San Diego does not authorize the Subdivider to violate any Federal, State, or City laws, ordinances, regulations, or policies including but not limited to, the Federal Endangered Species Act of 1973 and any amendments thereto (16 USC § 1531 et seq.).

- If the Subdivider makes any request for new water and sewer facilities (including services, fire hydrants, and laterals), the Subdivider shall design and construct such facilities in accordance with established criteria in the most current editions of the City of San Diego water and sewer design guides and City regulations, standards and practices pertaining thereto. Off-site improvements may be required to provide adequate and acceptable levels of service and will be determined at final engineering.
- Subsequent applications related to this Tentative Map will be subject to fees and charges based on the rate and calculation method in effect at the time of payment.
- Any party on whom fees, dedications, reservations, or other exactions have been imposed as conditions of approval of the Tentative Map, may protest the imposition within ninety days of the approval of this Tentative Map by filing a written protest with the San Diego City Clerk pursuant to Government Code sections 66020 and/or 66021.
- Where in the course of development of private property, public facilities are damaged or removed, the Subdivider shall at no cost to the City, obtain the required permits for work in the public right-of-way, and repair or replace the public facility to the satisfaction of the City Engineer (San Diego Municipal Code § 142.0607.

Internal Order No. 24007282

SUMMARY SDPD CPTED REVIEW OF 35TH & J STREET TOWN HOMES

Date:	July 11, 2017
Project Manager:	William Zounes
DSPN:	549188
Discipline:	Crime Prevention through Environmental Design (CPTED)
Reviewer:	Ted Parker, SDPD Crime Prevention
Copy to:	John Gonzalez, SDPD Southeastern Division Community Relations Officer (CRO)

This memo summarizes the specific crime prevention design measures suggested in the SDPD CPTED review of this project on the same date.

Vehicle Parking

Most crimes in open parking involving people and property can be prevented by relatively simple measures. Owners should lock their vehicles, keep valuables out of sight, and be aware of others in the area. Signs should be posted in the lot to remind people to do this. The lot should also have good vandal-proof lighting that is not blocked by any trees. And if cameras are installed, they should be mounted as high as practical to be out of reach of anyone who doesn't want to be seen.

In addition to these crime-prevention design measures, all spaces in should be numbered so the exact location of crimes or other incidents can be reported. This will help in improving security, e.g., by installing additional lighting and cameras. However, address numbers should not be used because an empty space might indicate an empty home.

Vehicle Gates

Consider installing simple swinging-arm entry and exit gates at the driveway entrance to the parking lot to prevent unauthorized vehicles from driving into the community. This will also help prevent vehicle theft. The gates could be operated by individual keypad codes. Then it will be possible to: (1)also give codes to businesses and agencies that need to enter the community, e.g., USPS, trash pickup, Fed Ex, landscape company, and SDPD, (2) keep a record of code use, (3) deactivate a code when the person, business, or agency it was given to is no longer allowed to enter the community, (4) trace the use of a code to the person, business, or agency it was issued to, and (5) restrict the use of a code by day of the week, hours of the day, period of time, etc. Others without codes, e.g., visitors, would park on the street.

Because patrol cars don't carry means to enter gated communities, SDPD access is needed for officers conducting an investigation or responding to a call for service when the caller can't let them in, e.g., in responding to a burglar alarm. The SDPD code would be stored in its computer system and transmitted in dispatch messages to officers who need to enter the community. Assuming the homes will be sold, the HOA should call the CRO in the SDPD Southeastern Division at **(619) 527-3500** to have the code entered in the SDPD Premises Information (PIN) file. Once officers enter the community they will need to go straight to the location of the problem. To make this possible a map showing the locations and addresses of all the homes and a YOU ARE HERE reference point should be posted at the gate where the officers will be sure to see it.

Motorcycle and Bicycle Parking

Open parking spaces for motorcycles should have permanently anchored fixtures that the bikes can be secured to. And bicycles should be kept in the homes. Bicycles parked in the pen parking are often stolen because any bike lock can be defeated.

Fencing

The existing chain-link fencing should be straightened where it is bent and a horizontal bar attached to the top of the fencing where it is missing. Also, its bottom should be secured with tension wire or galvanized pipe, or embedded in concrete to prevent someone from lifting it and crawling under it. And to make climbing more difficult you can install outward-angled "barb-arm" supports on top of the fence posts and attach strands of smooth wire to them. A sharp-pointed metal topping can't be used because it is permitted in the City only for agricultural uses in agricultural zones San Diego Municipal Code Sec. 142.0360.

Residential Communities

There should be some special features at the street entry to identify the community, e.g., signs, landscaping, planters, posts, pavement and sidewalk treatment, etc. These help promote pride in it.

Natural surveillance creates a risk of detection for intruders and a perception of safety for the residents. This is not possible from within the homes. The sidewalks and common trash enclosure help get people out of their homes, as would a cluster mailbox.

All spaces in the community should be controlled by individual residents or when open to all residents, be located in an area of high visibility within the community. There are often problems in spaces that are uncontrolled and hidden from view, e.g., littering, loitering, noise, drug use, etc. One such space is the strip between the homes on the west side of the community and the fence along the I-15 right-of-way. If the residents aren't going to use this space, consider adding some additional fencing and gates to keep them out of it.

Cameras

Homeowners with burglar alarms should also consider installing cameras that their alarm company can access over a secure, password-protected Internet link. Then if the imagery shows a crime in progress, **911** would be called and the dispatcher given the details. This will lead to a higher call priority and a faster response than would occur for an unverified alarm call. Also, the dispatcher can relay real-time information to officers en route to the home. This will enable them to make better, more-informed tactical decisions in dealing with the burglars. Officers might even arrive in time to arrest them.

To deal with crimes in the parking lot and common areas of the community, the HOA could consider installing programmable Internet Protocol (IP) digital cameras with video-analytics software, so-called "smart" cameras to record and alert a security company when specific conditions occur. There the imagery would be viewed to see what's happening so appropriate actions can be taken. Here are some examples of camera programming to alert a security company of possible vehicle break-ins.

- Someone walks or loiters between several parked vehicles apparently looking for one to break into
- A vehicle drives up and down the aisle without parking, perhaps looking for a particular vehicle to steal
- A vehicle stops in the aisle and someone gets out and goes to a parked vehicle

Because cameras are susceptible to damage by criminals attempting to hide their actions, measures should be taken to make them less vulnerable. Here are some possibilities.

- Mount cameras on high sturdy poles.
- Use damage-resistant cameras.
- Use armored conduits for electrical cables.
- Install cameras where they are within the field of view of at least one other camera.

• Use cameras with video analytics that can detect blocking, defocusing, and other tampering.

Signs regarding cameras should be posted to help deter crimes. If the cameras are not monitored all the time, the signs should use phrases RECORDED VIDEO SURVEILLANCE IN USE or ALL ACTIVITIES ARE RECORDED TO AID IN THE PROSECUTION OF CRIMES COMMITTED ON THE PREMISES. Don't use words like SECURITY, PROTECTION, or MONITORING because they can give people a false expectation of an immediate security response when an incident occurs or that they and their property are somehow being protected by the cameras.

Premises Identification

Good premises identification is needed to enable the police, fire, and other service providers to find an address quickly in an emergency. The following requirements are contained in various San Diego Fire-Rescue Department policies.

Address numbers must be on a contrasting background and located where they are plainly visible and legible from either direction of approach from the street fronting the property. They must be at least 6 inches high on individual homes and duplexes. And they should also be lighted directly or indirectly so they can be seen at night. However, where homes are set back from the from the street fronting the property and their address numbers can't be seen from it, as in this community, their address numbers must also be posted on a monument sign at the street driveway serving the homes. And on multi-unit housing communities, an illuminated directory and map must be located on the right side of the street driveway. It must show the name of the community, all driveways, home locations with addresses, and a YOU ARE HERE reference point. Directional signs should be located within the community. And individual home numbers should be located where they are easy to see and read.

Landscaping

Canopies of mature trees should be maintained at least 8 feet above the ground. Bushes should be trimmed to less than 3 feet except where privacy or environmental noise mitigation is a primary concern, or where higher plants would not block any views, lighting, camera coverage, or provide hiding places. For example, higher bushes or trees with lower canopies could be located next to a blank wall on the side of a building. And trees should not be planted near light poles and fixtures where they would block light or near cameras where they would block coverage.

Commercial water backflow preventers are being stolen for their brass and copper fittings. The following can be done to prevent these thefts:

- Paint the device. Paint is a deterrent because painted metal is a little less valuable. If copper is painted black, it can look like worthless plastic tubing. Painting also informs the scrap dealer to question the seller for proof of ownership. And it can also be used to identify the owner. This would deter the thief from going to a scrap dealer who complies with the California Business and Professions Code sections that attempt to limit the ability of thieves to convert stolen metals into immediate cash. Unfortunately, there are some rogue dealers who buy scrap metal and don't follow the law.
- Camouflage the device. Fake rocks work well. Just make sure there is a one-foot clearance around the device.
- Hide the device. Paint it green and place it in a bush or hedge. This is a low-cost measure.
- Use a device with plastic parts. They won't be stolen because they are worthless.
- Enclose the device in a protective cage. Secure the cage to its base with a padlock that is hard to cut or else the thieves will steal the cage too.
- Install a locking-cable system with shielded-shackle locks and a concrete foundation.

Also etch or paint some identifying words or numbers on pieces of metal that might be stolen. Or use metal

products with serial numbers and other identifying symbols etched on them. This will also enable you to identify your metal if it is recovered.

Dealing with Graffiti Vandalism

Graffiti-resistant paint or an anti-graffiti coating should be used on the sides of the building and any other surfaces that could be vandalized. The San Diego Park and Recreation Dept. specifies the use of anti-graffiti materials manufactured by Monopole Inc. on its facilities. Four coats are applied. The first is Aquaseal ME12 (Item 5200). The second is Permashield Base (Item 6100). The third and fourth are Permashield Premium (Item 5600 for matte finish or Item 5650 for gloss finish). Additional protection can be obtained by planting vines, bushes, etc. along walls and the sides of the buildings. They would cover areas that might otherwise be vandalized.

Dumpster Enclosures

Dumpsters in the enclosures should have bars over their lids that can be padlocked to prevent them from being opened except by the trash removal company. The lids would have an opening through which material can be put in but not taken out. This is to prevent scavenging. The dumpsters and the enclosure should also have signs saying that unauthorized collection of refuse or recyclable material is prohibited per SDMC Sec. 66.0402.

Residence Security

Residences should have the following security features:

- Deadbolt locks on all doors to the outside
- Double-pane glass windows
- Peepholes with a wide-angle (180 deg) viewer in solid front doors
- Deadbolt and secondary locking devices on sliding-glass patio, porch, and deck doors, and means to prevent them from being lifted up in their tracks to defeat their locks
- Secondary locking devices on sliding-glass windows and means to prevent them from being lifted up in their tracks to defeat their locks
- Non-removable pins on door hinges that are accessible from the outside when the door is closed
- Fully tempered glass in doors
- Steel door frames or steel reinforcing devices on the lock side of the frames that extend well above and below the strike plate to prevent door from being kicked in

DEVELOPMENT SERVICES DEPARTMENT PROJECT CHRONOLOGY 35th & J -Project No. 549188

Date	Action	Description	City Review Time (Working Days*)	Applicant Response (Working Days*)
6/29/2017	Mandatory Initial Review (MIR) Submittal	MIR routed	-	-
7/14/2017	Draft Review Comments	Sent to Applicant	10 days	-
7/24/2017	MIR Meeting	Meeting date confirmed by applicant	6 days	-
8/2/2017	MIR Assessment Letter	Letter distributed to applicant	7 days	-
8/2/2017	Total MIR Time	From Submittal to MIR Letter	23 days	
11/15/2017	First Submittal	Project Deemed Complete (Date from MIR Letter)	-	73 days
12/20/2017	First Assessment Letter		24 days	-
4/23/2018	Second Submittal		-	77 days
5/24/2018	Second Assessment Letter		23 days	-
8/30/18	Third Submittal		-	62 days
9/26/19	Third Assessment Letter		27	
5/16/19	Fourth Submittal			232
6/11/19	Fourth Assessment Letter		26	
7/22/19	Fifth Submittal			41
8/9/19	Fifth Assessment Letter		18	
10/3/19	Public Hearing		55	
TOTAL STAFF	тіме		196 Calendar Days	
TOTAL APPLI	CANT TIME			485 Calendar Days

TOTAL PROJECT RUNNING TIME		681 days
	From Deemed Complete to Hearing	

* Does not include City Holidays or City Furlough

Page 4	City of San Diego · lı	nfori	mation Bulle	etin 620		August 2018
SD	City of San Diego Development Services 1222 First Ave., MS-302 San Diego, CA 92101	C	Con Comm			Planning stribution orm Part 2
Project Name:	1		Project Nun	nber:	Dis	tribution Date:
Project Scope/Loca	ation:		1			
Applicant Name:			Applicant Pl	hone Numbe	er:	
Project Manager:			Phone Num	iber:	Em	ail Address:
Committee Recom	mendations (to be complet	ted fo	Dr Initial Revi	ew):	<u> </u>	
Vote to Approv	/e	Mei	mbers Yes	Members	No	Members Abstain
Vote to Approv With Conditions Li		Mei	mbers Yes	Members	No	Members Abstain
Vote to Approv With Non-Binding	/e Recommendations Listed Below	Members Yes		Members	No	Members Abstain
Vote to Deny		Members Yes		Members	No	Members Abstain
No Action (Please specify, e.g	g., Need further information, Split	vote,	Lack of quorum	, etc.)		Continued
CONDITIONS:						1
NAME:			TITLE:			
signature: M	tie Veach		DATE:			
Attach Additional Po	ages if Necessary.		City of San I Developme	nagement Di Diego nt Services I wenue, MS 3	Сера	

Printed on recycled paper. Visit our web site at <u>www.sandiego.gov/development-services</u>. Upon request, this information is available in alternative formats for persons with disabilities.

8. ACTION ITEMS:

A. Project No. 549188; 440 1/3 35th Street (Homes at 35th & J), Mount Hope

Site Development Permit (Process 3) and Tentative Map (Process 4) for the subdivision of 21 lots and the development of 20 dwelling units, each with a companion unit with separate entry way, totaling 29,110 square feet of floor area with open parking (Affordable Housing Expedite Program). The project includes 15 percent affordable units (two units), density bonus of 50 percent, and is requesting four deviations. The 0.89-acre site is located in the RM-1-1 zone(s) of the Southeastern San Diego Community Plan Area within Council District 9. Presented by Craig Howard, DeBartolo + Rimanic Design Studio (DBRDS). See the minutes from the Projects Committee of May 20, 2019.

Craig Howard said his firm resubmitted this project to the City about two and a half weeks ago, so there is no further feedback from the City. This project proposes to use the City's Small Lot Ordinance regulations to construct 18 detached for-sale 2-bedroom units with an attached lower-level companion unit with separate entry. In addition, there will be 2 very low income affordable 3-bedroom units per the City's Affordable Housing regulations. The two lower levels will be stucco, and the top level wood. The units will have solar panels, and rain water will be captured and reclaimed. They have no ideas at what price they will market these units. The intent is to have owner-occupants reside there, but the developer can't control if investors buy the units. The nearest mass transit is almost half a mile away.

The developer seeks the support of the project with the following Small Lot Ordinance incentives (these are not deviations):

- 1. remove the angled building requirement of Municipal Code section 131.0444.
- 2. increase the maximum Floor Area Ration (FAR) allowed from 0.75:1 to 0.78:1.
- 3. Decrease the required rear setback from 15'0" to 5'0".
- 4. Increase the height limit from 36'0" to 42'0".
- 5. Decrease the required front setback from 15'0" to 6'6".

The concern from the Projects Committee were read, including the concerns of area residents. The designer made the following changes or comments regarding the feedback from the Projects meeting:

- Investigated provided angled street parking, but this isn't possible since the street isn't at least 40 feet wide.
- Lighting: provided an illustration showing possible placement of lights throughout the project area, including a new street light on the sidewalk.
- Added pedestrian gates for the drive aisle, so people cannot easily wander into this parking area that don't live on site.
- There isn't enough room to add additional bike lockers.
- Explored saving and moving the existing tree that is on site, but since the site will be totally graded it doesn't appear there is a spot to relocate the tree while construction work would take place. Cost to move tree: \$2,000-\$3,000.
- They will look at a 75-foot area in the middle of the site for possible a dog run or a place where residents can gather or barbeque.

Craig Howard said that the distance from the furthest unit to the trash cans is about 225 feet, and that the trash cans cannot be moved to a more central location since the trash trucks must access the trash bins through the drive aisle and parking lot. This parking lot and drive aisle is large enough to accommodate fire trucks.

The SSDPG had the following concerns:

- This project is not "20 units with a companion unit," it's really 40 total units. This \checkmark is high density with absolutely no amenities for residents. It may meet the City's requirement to have 21 parking spaces (the current design has 24 parking spaced), but, as area residents have attested, street parking is already highly packed, with neighbors already illegally parking on both sides of the too-narrow street. Widening the street to bring in additional street parking will not net additional spaces, since the existing neighborhood is already using that area for parking. It's quite possible that each resident in 40 units will have a car; realistically, it's quite possible there will be two adults with vehicles. How will the area absorb up to 80 resident vehicles when the lot can only accommodate 24 parking spaces? Where will guests park? How far away will residents who actually can park in the lot need to go to bring groceries to their homes? How will move-ins occur if there is no ability to park near the home unit? Who decides who gets an assigned parking spot in the parking lot? Is there an HOA-type organization to these unit-with-companion-unit homes? How are group site concerns addressed?
- ✓ Six units have no patios, so there is no outside space for these residents to use. These are not condos. It would almost be better if these were condos so patio space and amenities could be designed into the project.
- ✓ We encourage all developers to use products and not cheapen out when it comes to installing good windows and quality lighting products. These buildings should not look flimsy due to poor quality materials.
- ✓ The City may not have asked the developer for a lighting plan, but since this will not be gated and area residents have stated that there is a problem with homeless people gathering on that street and in the nearby canyon, lighting will be very important for security. In looking at the proposed location of possible lights, the SSDPG saw the need for additional lights between the buildings so there are no dark corridors.
- ✓ Will there be security cameras on the property, including on the parked cars, the bike storage, and the trash/recycle areas? The designer said that they do not yet have SDPD review, so at this time no security cameras are planned.
- ✓ If landscaping will be used to screen these units from looking into the yards and windows of existing homes, will mature trees be used so it doesn't take years to block the view?
- ✓ It's not feasible to think that all residents will be able to carry their trash almost the length of a city block to reach the trash receptacle area. Will there be trash bins located closer to the outer areas that can be pushed to the trash collection area, so that seniors don't have to find a way to haul their trash so far away? The designer said that there is no room for trash bins other than in the existing location.

- ✓ Would a possible dog run next to a possible barbeque area, all within a 75-foot area, really be compatible?
- ✓ We are not against development in our area, but we ask every developer to envision living in what they are proposing we accept in our community. Would the owner of this property want to live there? Want their family member to live there? Would they be happy with having the small parking lot for 40 units? This project could be designed to be quite an asset if it had less units and more living space for residents. As currently designed, it is way too dense and not very livable. Why build for-sale homes that from the start are designed to be overcrowded and unpleasant to live in?

Motion by Capella, seconded by Womack, to not support this project as designed. Motion failed 5-7-0 (voted for the motion of non-support of the project: Capella, Taylor, Torio, Veach, Womack).

Motion by Magagna, seconded by Pargo, to support the project with the recommendations from the Projects Committee that this project needs better parking, lighting, security cameras, a plan on how to help residents get their trash to the trash bins, mature landscaping for screening for existing nearby homes, and some kind of recreation area as at least one amenity in this overly dense project. Approved 7-5-0 (voted for the motion of support with the SSDPG and area residents' concerns noted: Magagna, Pargo, Gomez, Leif, Noto, Torio, Urguby).

B. Project No. 598090, 2561 G Street, Dolan Duplex, Grant Hill

A Variance to reduce the front yard setback from a 15-foot minimum and 20-foot standard, to a 10-foot front yard setback, to construct a 3,980-square-foot, three stories, two dwelling units over garages located at 2561 G Street (Process 3). The 0.08-acre site is located within the RM-2-5 zone of the Southeastern Community Plan area. Council District 8. Presented by Randy Biegenzahn, Ehm Architecture. See the minutes from the Projects Committee of May 20, 2019.

The designer provided a new update from the City. This project is in the Transit Overlay Zone, so parking is not an issue (the project does have underground resident parking). This was designed to the old codes; current codes require a 20-foot setback (instead of 15 feet) and a 20-foot driveway if the site is over 50 feet wide (the site is 50.8 feet). The applicant seeks support of these two variances.

The project owner has been a lifelong resident on this block (since 1957) and owns other buildings on the block. This is designed to house two families. The trash cans will be gated on the side. The colorway for the building is designed to blend with the existing building on the block.

The SSDPG reiterated that the use of quality materials for windows and lights goes a long way in keeping the site from looking old quickly.

Motion by Urguby, seconded by Wesson, to support this project and the two variances requested. Approved 12-0-0.

Signature : Name of Individual (type or print):	tedevelopment Agency Fax No: Date:	Name of Individual (type or print): Image: Comparison of Compar	lency
Signature : Name of Individual (type or print): Owner Tenant/Lessee R Street Address: City/State/Zip: Phone No:	Fax No:	Owner Tenant/Lessee Redevelopment Ag Street Address:	lency
Signature : Name of Individual (type or print): 「Owner 「Tenant/Lessee 「R Street Address: City/State/Zip:		City/State/Zlp:	lency
Signature : Name of Individual (type or print): Owner	tedevelopment Agency	Cowner Contract Contr	lency
Signature : Name of Individual (type or print): Cowner CTenant/Lessee CR	edevelopment Agency	Owner Tenant/Lessee Redevelopment Ag	lency
Signature :		Name of Individual (type or print):	
	Date:	Signature : Date:	
Phone No:	Fax No:	Phone No: Fax No:	
City/State/Zip:	1999 - 1999 - 1999 - 1999 - 1999 - 1999 - 1999 - 1999 - 1999 - 1999 - 1999 - 1999 - 1999 - 1999 - 1999 - 1999 -	City/State/Zip:	
Street Address:	1944 (1949) - 1945 - 1947 - 1947 - 1947 - 1947 - 1947 - 1947 - 1947 - 1947 - 1947 - 1947 - 1947 - 1947 - 1947 -	Street Address:	
Owner Tenant/Lessee T	Redevelopment Agency	Owner Tenant/Lessee Redevelopment	Agency
signing the Ownership Disclosure State ove, will be filed with the City of San D low the owner(s) and tenant(s) (if appli- to have an interest in the property, reco dividuals who own the property, reco dividuals who own the property, A sign me the Assistant Executive Director of the avelopment Agreement (DDA) has been anager of any changes in ownership du	SHS-JLO-14-00 berty is held by Individual(s) ement, the owner(s) acknowledge t Diego on the subject property, with licable) of the above referenced pro- brded or otherwise, and state the ty hature is required of at least one o he San Diego Redevelopment Age in approved / executed by the City pring the time the application is bein prior to any public hearing on the learing process.	545-360-15-00) that an application for a permit, map or other matter, as iden the intent to record an encumbrance against the property operty. The list must include the names and addresses of pe of property interest (e.g., tenants who will benefit from th if the property owners. Attach additional pages if needed, may shall be required for all project parcels for which a Disy of Council. Note: The applicant is responsible for notifying ng processed or considered. Changes in ownership are to a subject property. Failure to provide accurate and current	A Please list all person the permit, a A signature position and the Project
Project Address:	er of 35th + 3 57)	
357# 4 J		Project No. For City Us	se Only
Approval Type: Check appropriate box Neighborhood Development Permit Variance [Tentative Map] Ves Project Title	for type of approval (s) requested: Site Development Permit ting Tentative Map Map Waiver	Neighborhood Use Permit Coastal Development P Planned Development Permit Conditional Use Permit T Land Use Plan Amendment • Other	
			osur emen

2

Printed on recycled paper. Visit our web site at <u>www.sandiego.gov/development-services</u> Upon request, this information is available in alternative formats for persons with disabilities.

DS-318 (5-05)

roject Title: 35TH 45	Project No. (For City Use Only)
Part II - To be completed when property is held by a corpo	pration or partnership
Legal Status (please check):	
Corporation Liability -or- General) What s	State? Corporate Identification No
as identified above, will be filed with the City of San Diego on the property. Please list below the names, titles and addresse otherwise, and state the type of property interest (e.g., tenants in a partnership who own the property). <u>A signature is require</u> property. Attach additional pages if needed. Note: The application ownership during the time the application is being processed of	acknowledge that an application for a permit, map or other matter, the subject property with the intent to record an encumbrance against as of all persons who have an interest in the property, recorded or s who will benefit from the permit, all corporate officers, and all partners and of at least one of the corporate officers or partners who own the ant is responsible for notifying the Project Manager of any changes in or considered. Changes in ownership are to be given to the Project subject property. Failure to provide accurate and current ownership dditional pages attached Yes No
Corporate/Partnership Name (type or print):	Corporate/Partnership Name (type or print): 35 + J PARTNERS, LLC
Downer Trenant/Lessee	Sowner Tenant/Lessee
Street Address: 363 5th ME # 203	Street Address: 363 5th AVE \$203
City/State/Zip: SAN DECLO CA GODOD	City/State/Zip: SAN DIET.O CA 92101 Phone No: Fax No:
Phone No: Fax No:	Phone No: (858) 220 - 5262 Fax No:
Name of Corporate Officer/Partner (type or print):	Name of Corporate Officer/Partner (type or print):
Title (type or print): MANAGING MEMBER	Title (type or prim):
Signature : Date: 4/14/17	Signature Mar Date: 417/1
Corporate/Partnership Name (type or print):	Corpørate/Parthership Name (type or print):
Sowner Tenant/Lessee	Owner Tenant/Lessee
Street Address: 363 5th ANE \$203	Street Address:
City/State/Zip: SAN DICTO CA 92/01	City/State/Zip:
1858) 220-5262	Phone No: Fax No:
Name of Corporate Officer/Partner (type or print): SCOTT LEWIS	Name of Corporate Officer/Partner (type or print):
Title (type or print): MEMBER	Title (type or print):
Signature : Date: 4/17/11	Signature : Date:
Corporate/Partnership Name (type or print):	Corporate/Partnership Name (type or print):
Owner Tenant/Lessee	Cowner CTenant/Lessee
Street Address:	Street Address:
City/State/Zip:	City/State/Zip:
Phone No: Fax No:	Phone No: Fax No:
Name of Corporate Officer/Partner (type or print):	Name of Corporate Officer/Partner (type or print):
Title (type or print):	Title (type or print):
Signature : Date:	Signature : Date:

Supplement to Ownership Disclosure Form for Project No. 549188

35th & J Partners LLC, a Nevada Limited Liability Company

 35th & J Partners LLC is 50% by JTB Investments LLC, and 50% by American Residential Holdings LLC

JTB Investments LLC, a California Limited Liability Company

• JTB Investments LLC is 100% owned by Jason Elbers

American Residential Holdings LLC, a Wyoming Limited Liability Company

• American Residential Holdings LLC is 100% owned by Michael Donovan

PROPOSED SMALL LOT SUBDIVISION PROJECT

545-260-13-00, 545-260-14-00, 545-260-15-00 CORNER OF 35TH STREET & J STREET, SAN DIEGO, CA 92102

545-260-13-00

THAT PORTION OF THE NORTHEAST QUARTER OF PUEBLO LOT 1152 OF THE PUEBLO LANDS OF SAN DIEGO. IN THE CITY OF SAN DIEGO, COUNTY OF SAN DIEGO, STATE OF CALIFORNIA, ACCORDING TO MAP BY JAMES PASCOE IN 1870, A COPY OF WHICH SAID MAP WAS FILED IN THE OFFICE OF THE COUNTY RECORDER OF SAN DIEGO COUNTY, NOVEMBER 14, 1921 AND IS KNOWN AS MISCELLANEOUS MAP NO. 36

545-260-14-00

ALL THAT PORTION OF THE NORTHEAST QUARTER OF PUEBLO LOT 1152, IN THE CITY OF SAN DIEGO, COUNTY OF SAN DIEGO, STATE OF CALIFORNIA, ACCORDING TO THE MAP MADE BY JAMES PASCOE IN 1870, A COPY OF WHICH SAID MAP WAS FILED IN THE OFFICE OF THE COUNTY RECORDER OF SAN DIEGO COUNTY, NOVEMBER 14, 1921, AND IS KNOWN AS MISCELLANEOUS MAP NO. 36

545-260-15-00 THE PORTION OF THE NORTHEAST QUARTER OF PUEBLO LOT 1152 OF THE PUEBLO LANDS OF SAN DIEGO, IN THE CITY OF SAN DIEGO, COUNTY OF SAN DIEGO, STATE OF CALIFORNIA, ACCORDING TO MAP THEREOF BY JAMES PASCOE IN 1870, A COPY OF WHICH SAID MAP WAS FILED IN THE OFFICE OF THE COUNTY RECORDER OF SAN DIEGO COUNTY, NOVEMBER 14, 1921, AND IS KNOWN AS MISCELLANEOUS MAP NO. 36

BUILDING USE DIAGRAM

LEVEL 3	R3
LEVEL 2	R3
LEVEL 1	R3

PROJECT TITLE

SITE AREA:	38,815 SQ.FT.
GEOLOGIC HAZARD CAT.:	GEO-HAZARD CATEGORY 52
ZONING:	RM-1-1 (RESIDENTIAL - MULTIPLE UNIT)
CURRENT USE:	VACANT LAND
OCCUPANCY:	R-3
CONSTRUCTION TYPE:	VB
DENSITY: (PER BASE ZONE)	1 DWELLING UNIT PER 3,000 SQ.FT. OF LOT AREA 38,815 / 3,000 = 12.94 UNITS
AFF. HOUSING DENSITY:	PRE-DENSITY BONUS UNITS: 12.94 12.94 x 15% (VERY-LOW INCOME) = 1.94 (2 VERY LOW INCOME DWELLING UNITS)
	15% VERY LOW INCOME UNIT RATIO = 50% DENSITY BONUS INCREASE + 5 INCENTIVES ALLOWED
	12.94 x 50% = 19.41 (WHICH ROUNDS UP TO 20 TOTAL DWELLING UNITS)
	18 MARKET RATE UNITS + 2 VERY LOW INCOME UNITS 20 TOTAL UNITS PROPOSED
PARKING:	WITHIN 0.5 MILE OF 32ND + COMMERCIAL TROLLEY STOP (0.4 MILES) 0.5 PARKING SPACES PER BEDROOM REQUIRED 46 BEDROOMS PROPOSED
	23 PARKING SPACES REQUIRED 24 PARKING SPACES PROPOSED
REQUIREMENTS OF TABL	E 143-03C (SMALL LOT SUBDIVISIONS)
SETBACK REQ'S:	PER BASE ZONE (BELOW)
MAX STRUCTURE HT.:	36'-0" 42'-0" PROPOSED (INCENTIVE 4)
	SUBJECT TO ANGLED BUILDING ENVELOPE PLANE AT SETBACK LINES OF PRE-SUBDIVIDED LOT (INCENTIVE 1)
ALLOWABLE FAR:	PER BASE ZONE (BELOW)
PRIVATE EXT. SPACE:	3,124 SQ.FT. PROVIDED (156 SQ.FT. AVERAGE PER UNIT) (EACH UNIT HAS A MINIMUM 60 SQ.FT. SPACE) (SEE DIAGRAMS ON SHEET A0.10)
REQUIREMENTS OF TABL	E 131-04G (RM ZONES)
ALLOWABLE FAR:	0.75 : 1 (29,111 SQ.FT.)
PROPOSED FAR:	0.78 : 1 (30,260 SQ.FT.)
FRONT SETBACK:	15'-0" MINIMUM REQUIRED 20'-0" STANDARD REQUIRED
	6'-0" PROPOSED (INCENTIVE 5)
SIDE SETBACK:	5'-0" MINIMUM REQUIRED 8'-0" STANDARD REQUIRED 5'-0" & 11'-0" PROPOSED
MIN. REAR SETBACK:	15'-0" REQUIRED 5'-0" PROPOSED (INCENTIVE 3)
INCENTIVES REQUESTED	
 INCENTIVE TO INCE INCENTIVE TO DEC 	OVE THE ANGLED BUILDING REQUIREMENT OF SDMC §131.0444 REASE MAXIMUM FAR FROM 0.75:1 (29,111sqft) TO 0.78:1 (30,260sqft) REASE THE REQUIRED REAR SETBACK OF THE RM-1-1 ZONE FROM 15'-0" TO 5'-0" REASE THE HEIGHT LIMIT FROM 36'-0" TO 42'-0"

INCENTIVE TO INCREASE THE HEIGHT LIMIT FROM 36'-0" TO 42'-0" 4. INCENTIVE TO DECREASE THE REQUIRED FRONT SETBACK OF THE RM-1-1 ZONE FROM 15'-0" TO 6'-6" 5.

DEVIATIONS REQUESTED: NONE

EXT. SPACE 141 SQ.FT. 164 SQ.FT. x10 TOTAL x8 TOTAL

* SEE FAR DIAGRAMS ON SHEET A0.10

\cap					
U					
, I	Ke Harris				
		REND	ERIN	G	
	1.	INDIVI AN EN STREE	dual 1Pty L Et in S	OPMENT F R-3 OCCU OT NEAR SAN DIEGO	PANCY 1 THE COF), CA 921
	2.	'VERY THE E TWO-L	LOW IGHTE EVEL	MARKET R. INCOME' A EEN (18) TC TWO-BED EVEL COMF	FFORDA DWN HOI ROOM D
	3. 4. 5.	TWEN GRADI MINOF IMPRC	TY FC E R LANI VEME	FORDABLE OUR (24) PA DSCAPE IN ENTS TO TI ONTING TH	ARKING S IPROVEI HE STRE
		SCOF	PE OF	WORK	
	(XX AX.XX	– DETAIL		
	4	XX AX.XX		ECTION NUMBER	
		< <u>x</u> >	- KEYNOT	Ē	
	(X'X") —	- CEILING	HEIGHT A.F.F.	
	<pre> </pre>	x xx	– NEW DC	OR/WINDOW NUM	IBER
		ARCH	HITEC	TURAL LEG	GEND
		LEVEL	1	UNIT TYPE 01 551 SQ.FT. (includes 480sqft companion unit)	UNIT TYPE 0 500 SQ.FT.
		LEVEL		551 SQ.FT. 393 SQ.FT.	567 SQ.FT. 458 SQ.FT.
		TOTAL		1,495 SQ.FT. x8 TOTAL	1,525 SQ.FT. x10 TOTAL
				11,960 SQ.FT.	15,250 SQ.FT

DEVELOPMENT SUMMARY

FAR CALCULATIONS

OTAL FAR*	L	1.04
0,260 SQ.FT.		
OTAL EXT. SPACE		
,124 SQ.FT.		

CTION NUMBER		X —	– GRID MARKER
Ξ	XX FF	(- ROOM TAG - FINISHED FLOOR ELEVATION
HEIGHT A.F.F.			– WALL TAG
DR/WINDOW NUM	IBER	4.	_ MATERIAL TAG
URAL LEC	GEND		
	GEND	UNIT TYPE 03	
UNIT TYPE 01 551 SQ.FT. (includes 480sqft companion unit)	1	UNIT TYPE 03 500 SQ.FT.	_
UNIT TYPE 01 551 SQ.FT. (includes 480sqft companion unit)	UNIT TYPE 02		_
UNIT TYPE 01 551 SQ.FT. (includes 480sqft companion unit)	UNIT TYPE 02 500 SQ.FT.	500 SQ.FT.	
UNIT TYPE 01 551 SQ.FT. (includes 480sqft companion unit) 551 SQ.FT.	UNIT TYPE 02 500 SQ.FT. 567 SQ.FT.	500 SQ.FT. 567 SQ.FT.	
UNIT TYPE 01 551 SQ.FT. (includes 480sqft companion unit) 551 SQ.FT. 393 SQ.FT. 1,495 SQ.FT.	UNIT TYPE 02 500 SQ.FT. 567 SQ.FT. 458 SQ.FT.	500 SQ.FT. 567 SQ.FT. 458 SQ.FT. 1,525 SQ.FT.	TOTAL FAR*
UNIT TYPE 01 551 SQ.FT. (includes 480sqft companion unit) 551 SQ.FT. 393 SQ.FT. 1,495 SQ.FT. x8 TOTAL	UNIT TYPE 02 500 SQ.FT. 567 SQ.FT. 458 SQ.FT. 1,525 SQ.FT.	500 SQ.FT. 567 SQ.FT. 458 SQ.FT. 1,525 SQ.FT. x2 TOTAL	
UNIT TYPE 01 551 SQ.FT. (includes 480sqft companion unit) 551 SQ.FT. 393 SQ.FT. 1,495 SQ.FT.	UNIT TYPE 02 500 SQ.FT. 567 SQ.FT. 458 SQ.FT. 1,525 SQ.FT. x10 TOTAL	500 SQ.FT. 567 SQ.FT. 458 SQ.FT. 1,525 SQ.FT.	TOTAL FAR* 30,260 SQ.FT.
UNIT TYPE 01 551 SQ.FT. (includes 480sqft companion unit) 551 SQ.FT. 393 SQ.FT. 1,495 SQ.FT. x8 TOTAL 11,960 SQ.FT.	UNIT TYPE 02 500 SQ.FT. 567 SQ.FT. 458 SQ.FT. 1,525 SQ.FT. x10 TOTAL 15,250 SQ.FT.	500 SQ.FT. 567 SQ.FT. 458 SQ.FT. 1,525 SQ.FT. x2 TOTAL 3,050 SQ.FT.	

REVISION CLOUD

EMENTS EET/SIDEWALK OF 35TH JECT PROPERTY

S ARE THREE (3) BEDROOM SPACES ARE PROPOSED AT

IITS AND TWO (2) UNITS ARE DABLE UNITS OME UNITS CONSIST OF A DWELLING UNIT ABOVE A NUNIT. THE TWO (2) 'VERY LOW

TO CONSTRUCT TWENTY (20) TOWN HOMES LOCATED ON ORNER OF 35TH STREET AND J 2102, OF WHICH EIGHTEEN (18)

The private on-site sew	er and water system shall be designed in accordance with the Uniform Plumbing Code.	
CODES	UMMARY	
SHEET LIST	DESIGN - DE BARTOLO RIMANIC DESIGN STUDIO	
A0.00	Title Sheet	
A0.10	Zoning Diagrams	
A0.15	Zoning Diagrams/Engineering Sections	
A0.20	Photographic Survey	
A1.01	Proposed Site Plan	
A1.02	Fire Access Plan	
A2.10 A2.11	Floor Plan - Level 1 Floor Plan - Level 2	
A2.11 A2.12	Floor Plan - Level 2 Floor Plan - Level 3	
A2.12 A2.13	Roof Plan	
A2.13 A2.14	Enlarged Floor Plans - Unit Type 1	
A2.15	Enlarged Floor Plans - Unit Type 2	
A2.16	Enlarged Floor Plans - Unit Type 3	
A2.17	Enlarged Floor Plans - 3-Bedroom Affordable Unit	
A3.00	Site Elevations	
A3.01	Site Elevations	
A4.00	Site Sections	
A4.01	Site Sections	
A4.02	Site Sections	
A4.03	Site Sections	
A5.00	Materials Board	
SHEET LIST	SURVEYOR - SPEAR & ASSOCIATES, INC.	
	Topographic Survey	
SHEET LIST	CIVIL - SNIPES-DYE ASSOCIATES	
C1	Tentative Map	
C2	Tentative Map	
C2 C3	Tentative Map	

LANDSCAPE - McCULLOUGH LANDSCAPE ARCHITECTURE

*The priva

Conceptual Grading Plan

Conceptual Grading Plan

Landscape Development Plan

Landscape MAWA Calculation

Landscape Plant Pictures

Landscape Calculation & Plant Schedule

	CALIFORNIA BUILDING CODE (CBC), 2016 EDITION
	CALIFORNIA MECHANICAL CODE (CMC), 2016 EDITION
	CALIFORNIA PLUMBING CODE (CPC), 2016 EDITION
	CALIFORNIA ELECTRICAL CODE (CEC), 2016 EDITION
	CALIFORNIA GREEN BUILDING CODE, 2016 EDITION
	REGULATIONS AND ORDINANCES OF THE CITY OF SAN DIEGO
WATER:	BY CONNECTION TO EXISTING
SEWER:	BY GRAVITY INTO EXISTING
DRAINAGE:	VIA 35TH STREET



APPLICABLE CODES: CALIFORNIA RESIDENTIAL CODE, 2016 EDITION

GAS + ELECTRICAL: SDG&E

NOTE TO CONTRACTOR:

REFER TO FIRE ACCESS PLAN, SHEET A1.02 FOR MORE INFORMATION

SHEET LIST

C4


C5

L1.01

L1.02

L1.03

SHEET LIST

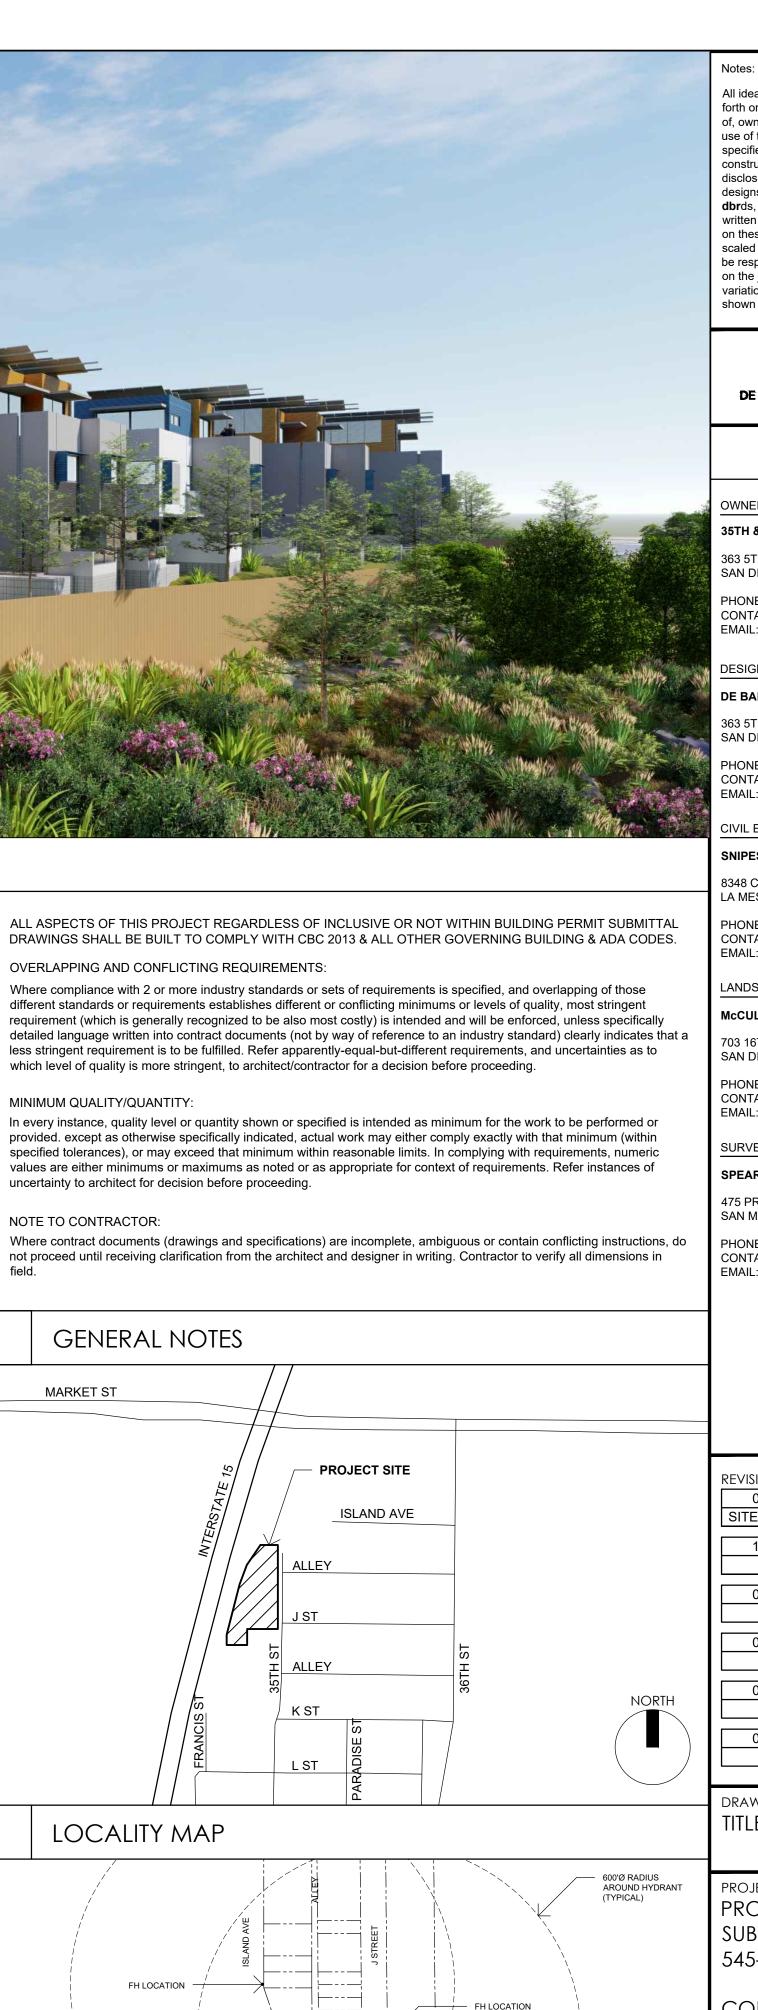

All ideas, arrangements, drawings and plans set forth on this sheet are the original work product of, owned by and are the property of **dbr**ds and use of this said work product is limited to a specified project of the purchaser, and for the construction of one building, any use, reuse or disclosure of said plans, reproductions, ideas, designs and/or arrangements, other than by dbrds, is strictly prohibited by law without the written permission of **dbr**ds. Written dimensions on these drawings shall have precedence over scaled dimensions; contractors shall verify, and be responsible for all dimensions and conditions on the job and this office must be notified of any variations from the dimensions and conditions shown these drawings. **DBR**DS DE BARTOLO + RIMANIC DESIGN STUDIO **PROJECT TEAM** OWNER: 35TH & J PARTNERS, LLC 363 5TH AVE, SUITE 203 SAN DIEGO, CA 92101 PHONE: (858) 220-5262 CONTACT: PAULY DE BARTOLO EMAIL: pauly@dbrds.com DESIGN: S DE BARTOLO + RIMANIC DESIGN STUDIO S 363 5TH AVE, SUITE 203 SAN DIEGO CA 92101 Ш PHONE: (858) 220-5262 PAULY DE BARTOLO CONTACT: \supset EMAIL: pauly@dbrds.com CIVIL ENGINEER S SNIPES-DYE ASSOCIATES S 348 CENTER DRIVE, SUITE G LA MESA, CA 91942 PHONE: (619) 697-9234 CONTACT: BILL SNIPES EMAIL: bill@snipesdye.com ANDSCAPE ARCHITECTURE McCULLOUGH LANDSCAPE ARCHITECTURE 703 16TH STREET, SUITE 100 SAN DIEGO, CA 92101 \mathbb{C} PHONE: (619) 296-3150 CONTACT: DAVID MCCULLOUGH EMAIL: david@mlasd.com \checkmark SURVEYOR **O** SPEAR & ASSOCIATES, INC. $\overline{}$ 475 PRODUCTION STREET \bigcirc SAN MARCOS, CA 92078 N HONE: (760) 736-2040 CONTACT: RAY SPEAR EMAIL: rspear@spearinc.net $\overline{}$ \bigcirc REVISION: 06.29.2017 DRAWN BY: CH SITE DEVELOPMENT PERMIT SUBMIT $\overline{}$ 11.06.2017 DRAWN BY: CH ~ CYCLE ISSUES 1 04.23.2018 DRAWN BY: CH CYCLE ISSUES 2 Ω 08.30.2018 DRAWN BY: CH CYCLE ISSUES 3 05.15.2019 DRAWN BY: CH CYCLE ISSUES 4 07.17.2019 DRAWN BY: CH CYCLE ISSUES 5 $\overline{}$ DRAWING TITLE: TITLE SHEET PROJECT: PROPOSED SMALL LOT SUBDIVISION PROJECT 545-260-13-00, 14-00, 15-00 CORNER OF 35TH ST & J ST SAN DIEGO CA 92102 15005 DBRDS PROJECT NO: **APRIL 2016** DATE

NORTH

DRAWN BY

SHEET NO:

SCALE

ATTACHMENT 16


S

C HM 16

СН


N/A

A0.00

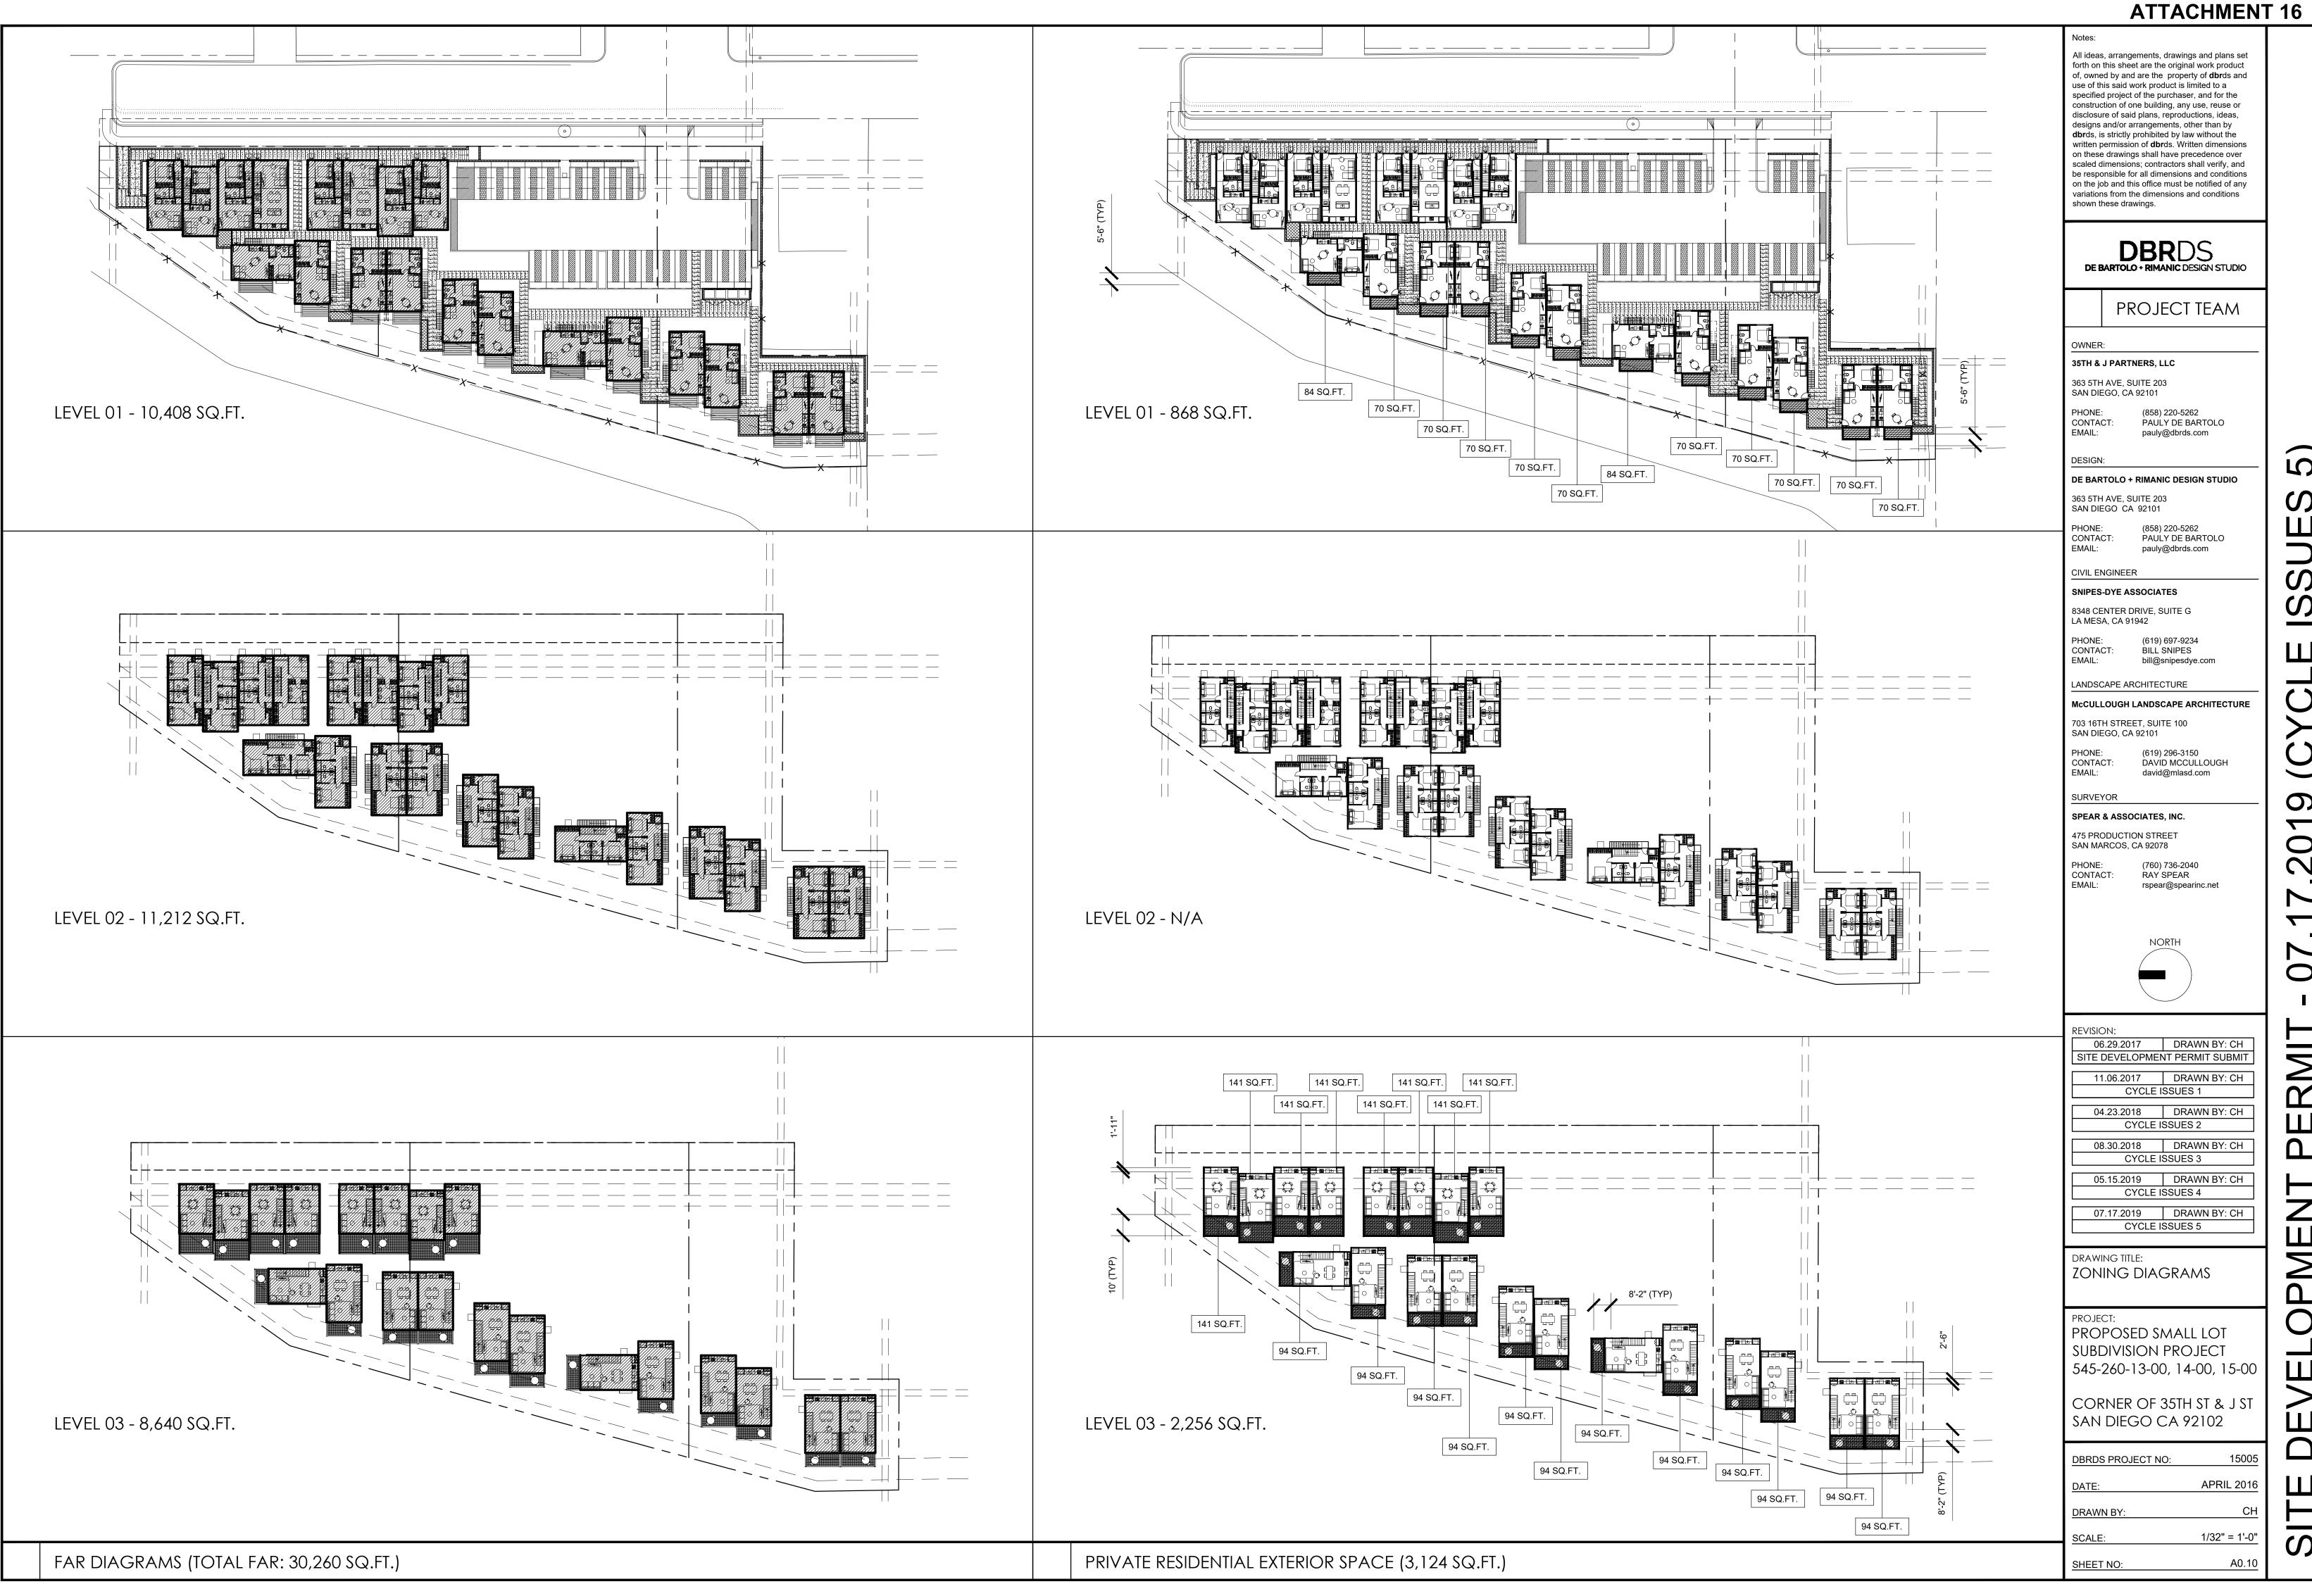

S S C. **O** 20 $\overline{}$ 0 **R**M Z Ш PM C /EL S

TTACHMENT 16

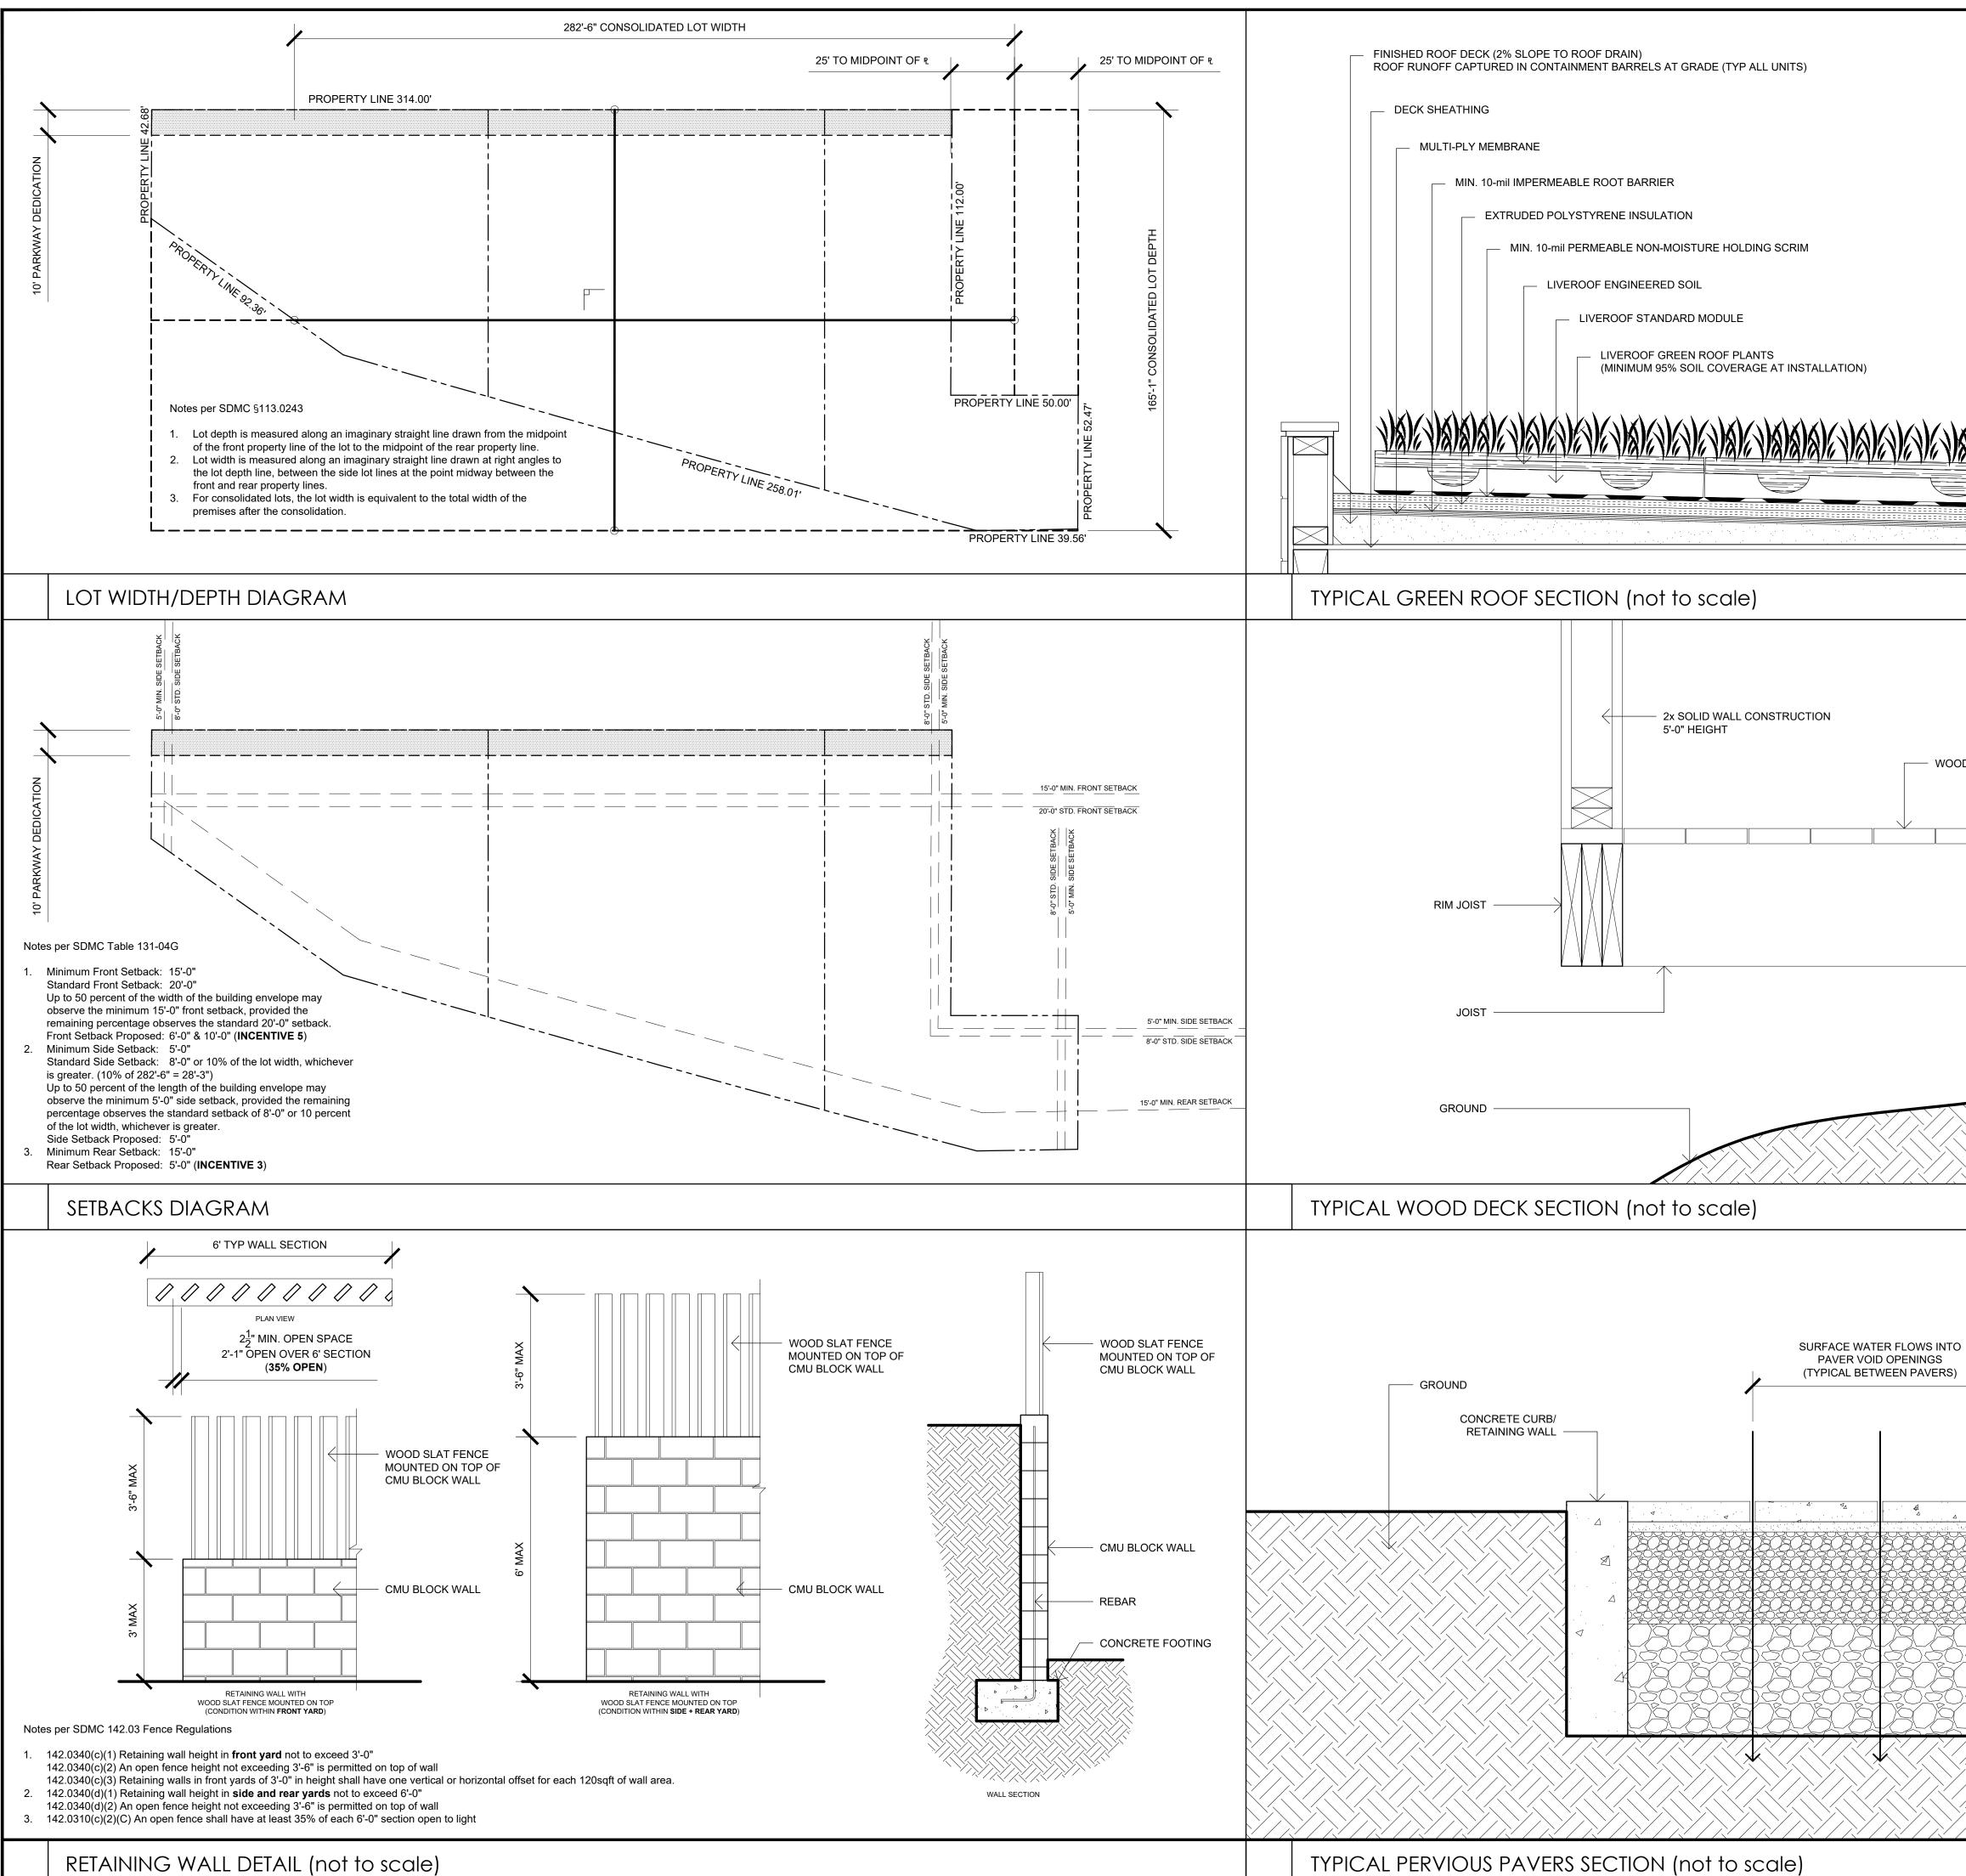

RETAINING WALL DETAIL (not to scale)

	ATTACHMENT 16	
	Notes: All ideas, arrangements, drawings and plans set forth on this sheet are the original work product of, owned by and are the property of dbr ds and use of this said work product is limited to a specified project of the purchaser, and for the construction of one building, any use, reuse or disclosure of said plans, reproductions, ideas, designs and/or arrangements, other than by dbr ds, is strictly prohibited by law without the written permission of dbr ds. Written dimensions on these drawings shall have precedence over scaled dimensions; contractors shall verify, and be responsible for all dimensions and conditions on the job and this office must be notified of any variations from the dimensions and conditions shown these drawings.	
	DBRDS DE BARTOLO + RIMANIC DESIGN STUDIO	
	PROJECT TEAM	
	OWNER: 35TH & J PARTNERS, LLC 363 5TH AVE, SUITE 203 SAN DIEGO, CA 92101	
	PHONE: (858) 220-5262 CONTACT: PAULY DE BARTOLO EMAIL: pauly@dbrds.com	
	DESIGN: DE BARTOLO + RIMANIC DESIGN STUDIO	
BUILDING WALL	363 5TH AVE, SUITE 203 SAN DIEGO CA 92101 PHONE: (858) 220-5262 CONTACT: PAULY DE BARTOLO EMAIL: pauly@dbrds.com CIVIL ENGINEER Image: Civil Engineer SNIPES-DYE ASSOCIATES 8348 CENTER DRIVE, SUITE G LA MESA, CA 91942 PHONE: PHONE: (619) 697-9234 CONTACT: BILL SNIPES EMAIL: bill@snipesdva.com	
LEDGER BOARD	EMAIL: bill@snipesdye.com LANDSCAPE ARCHITECTURE McCULLOUGH LANDSCAPE ARCHITECTURE 703 16TH STREET, SUITE 100 SAN DIEGO, CA 92101 PHONE: (619) 296-3150 CONTACT: DAVID MCCULLOUGH EMAIL: david@mlasd.com SURVEYOR O SPEAR & ASSOCIATES, INC.	
JOIST HANGER	475 PRODUCTION STREET SAN MARCOS, CA 92078 PHONE: (760) 736-2040 CONTACT: RAY SPEAR EMAIL: rspear@spearinc.net	
	NORTH C	
PERMEABLE SUB-BASE AGGREGATE	REVISION: 06.29.2017 DRAWN BY: CH SITE DEVELOPMENT PERMIT SUBMIT 11.06.2017 DRAWN BY: CH CYCLE ISSUES 1 04.23.2018 DRAWN BY: CH CYCLE ISSUES 2	
DRAINAGE AGGREGATE	CYCLE ISSUES 2 08.30.2018 DRAWN BY: CH CYCLE ISSUES 3 05.15.2019 DRAWN BY: CH CYCLE ISSUES 4 07.17.2019 DRAWN BY: CH CYCLE ISSUES 5	-
	ZONING DIAGRAMS / ENGINEERING DIAGRAMS PROJECT:	
	PROPOSED SMALL LOT SUBDIVISION PROJECT 545-260-13-00, 14-00, 15-00 CORNER OF 35TH ST & J ST	S 1-1
)	SAN DIEGO CA 92102DBRDS PROJECT NO:15005	
	DATE: APRIL 2016 DRAWN BY: CH SCALE: 1/32" = 1'-0"	
	SHEET NO: A0.15	




 \triangleright

ΗM

П

7




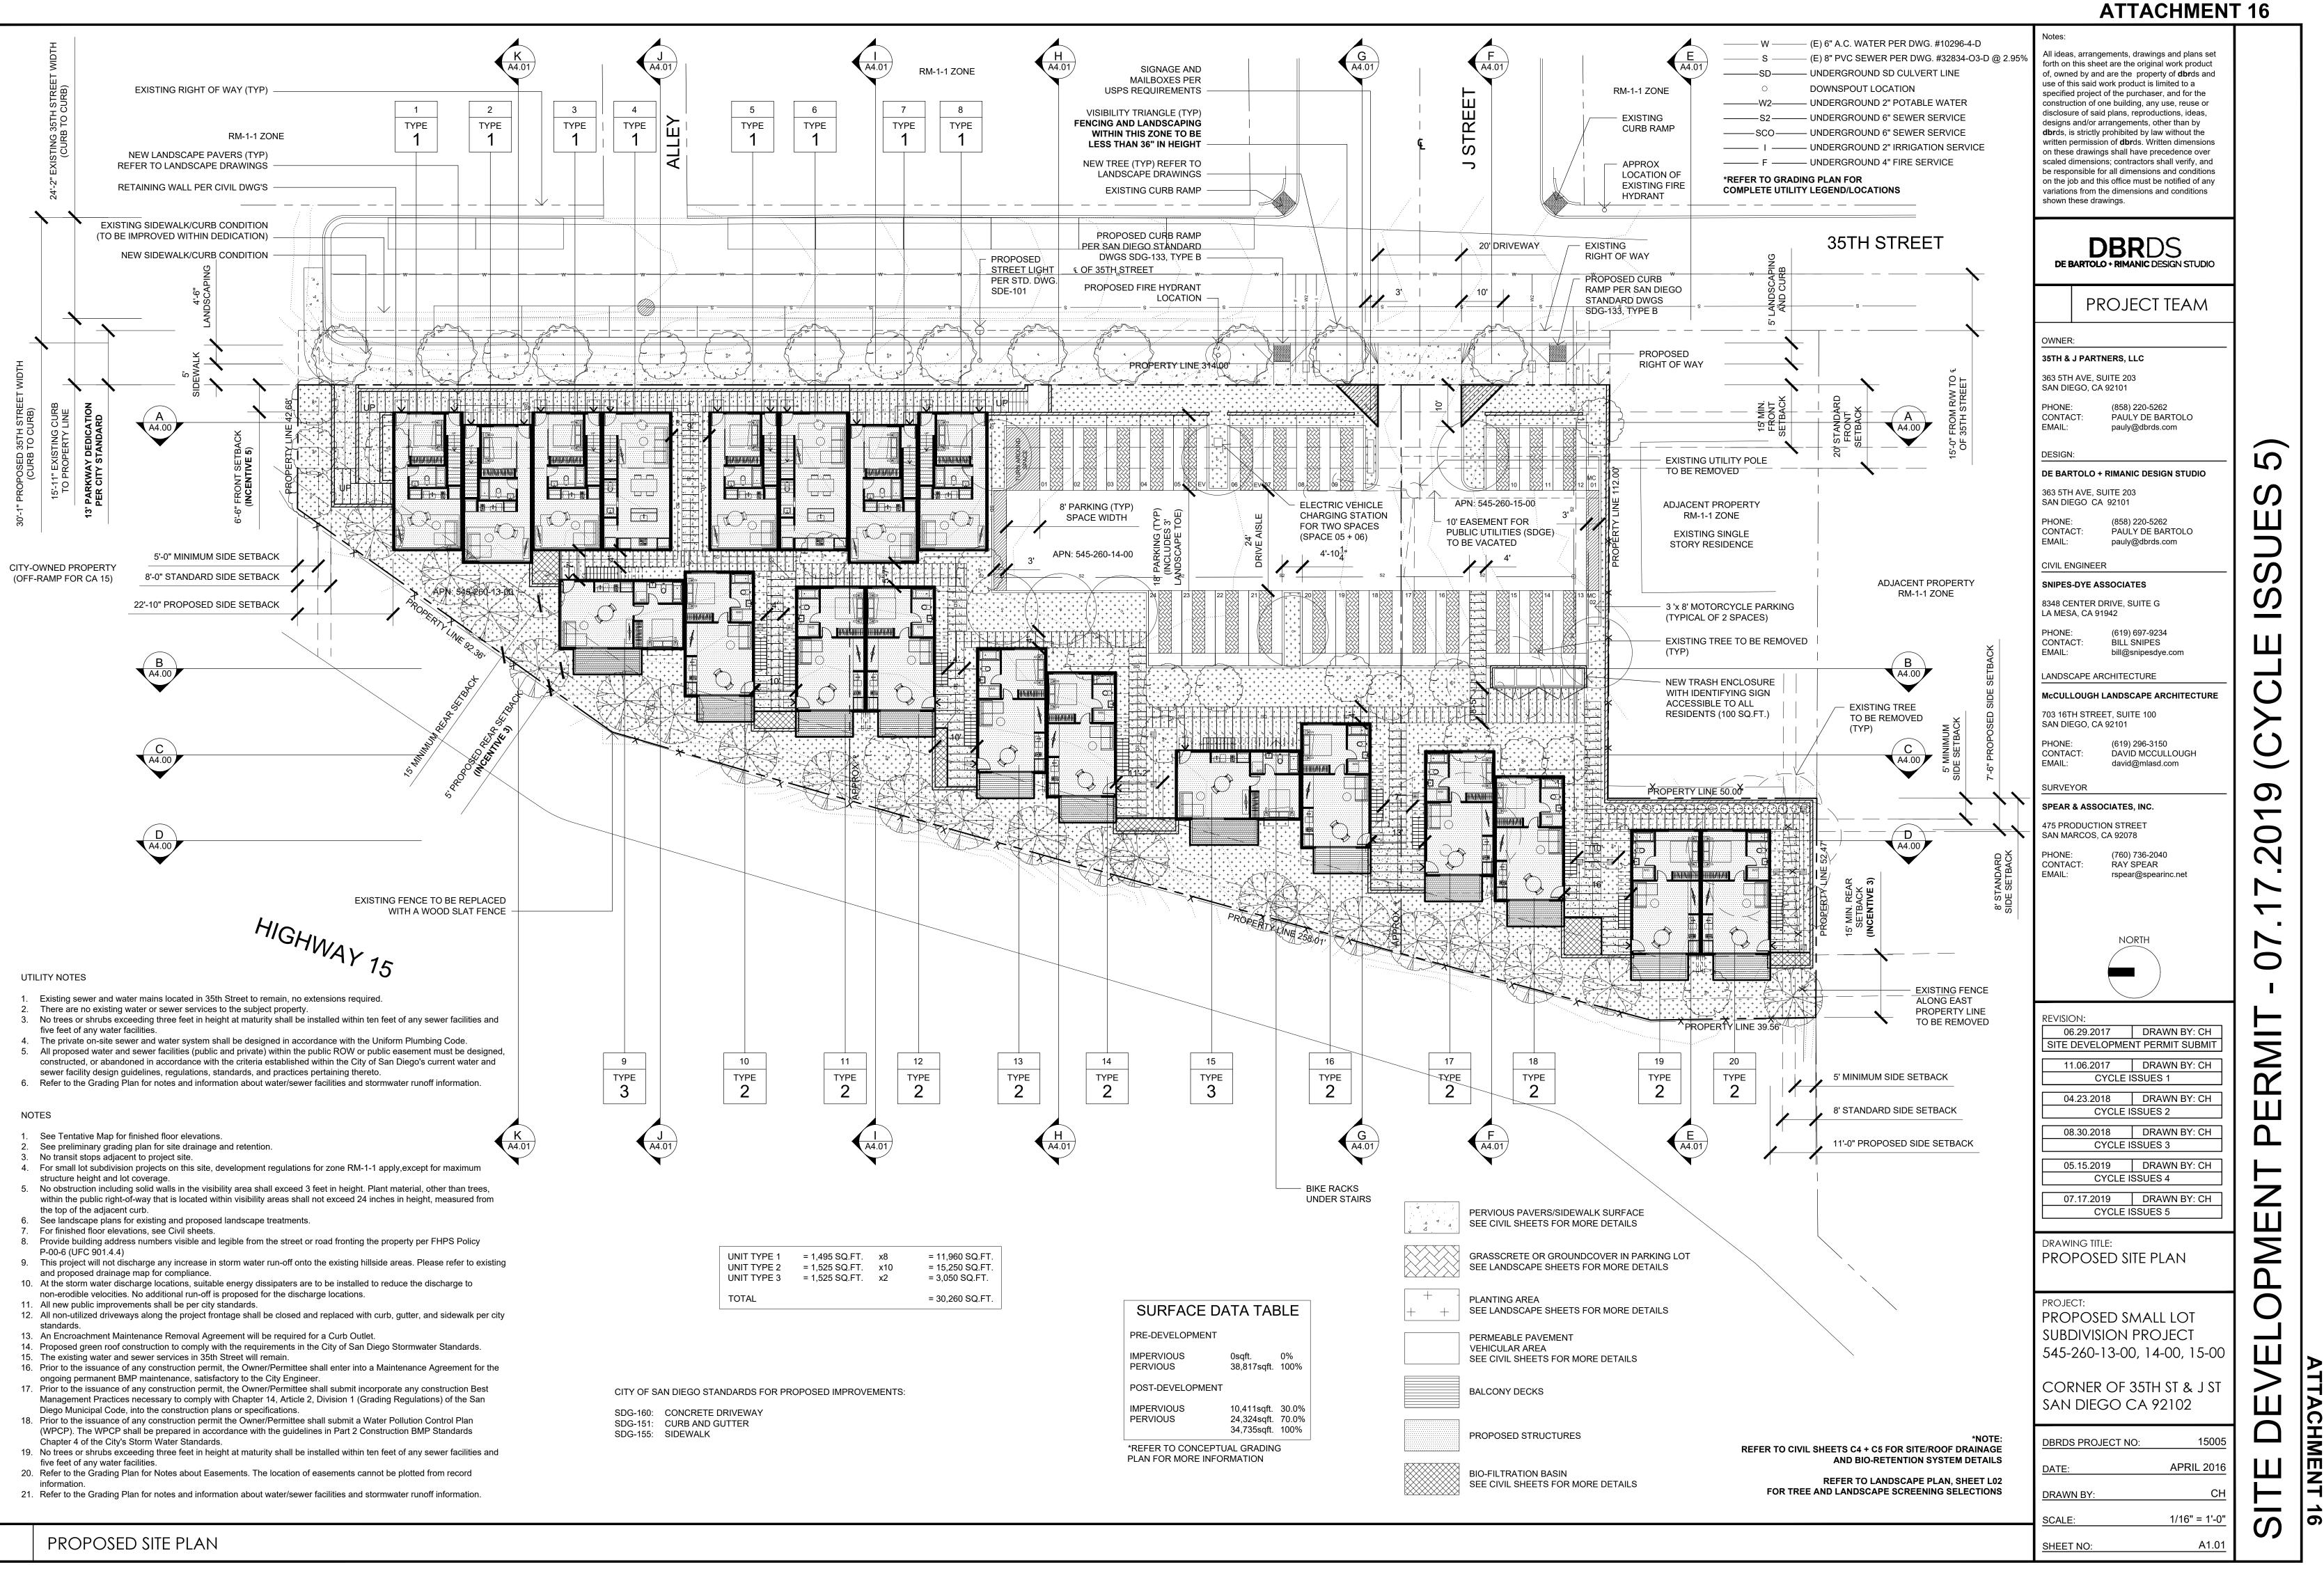

 \triangleright

HM

	30-1" WIDTH OF IMPROVED 35TH STREET 16:-7" BETWEEN EDGE OF BUILDING AND 35TH ST	600' RADIUS FROM HYDRANT

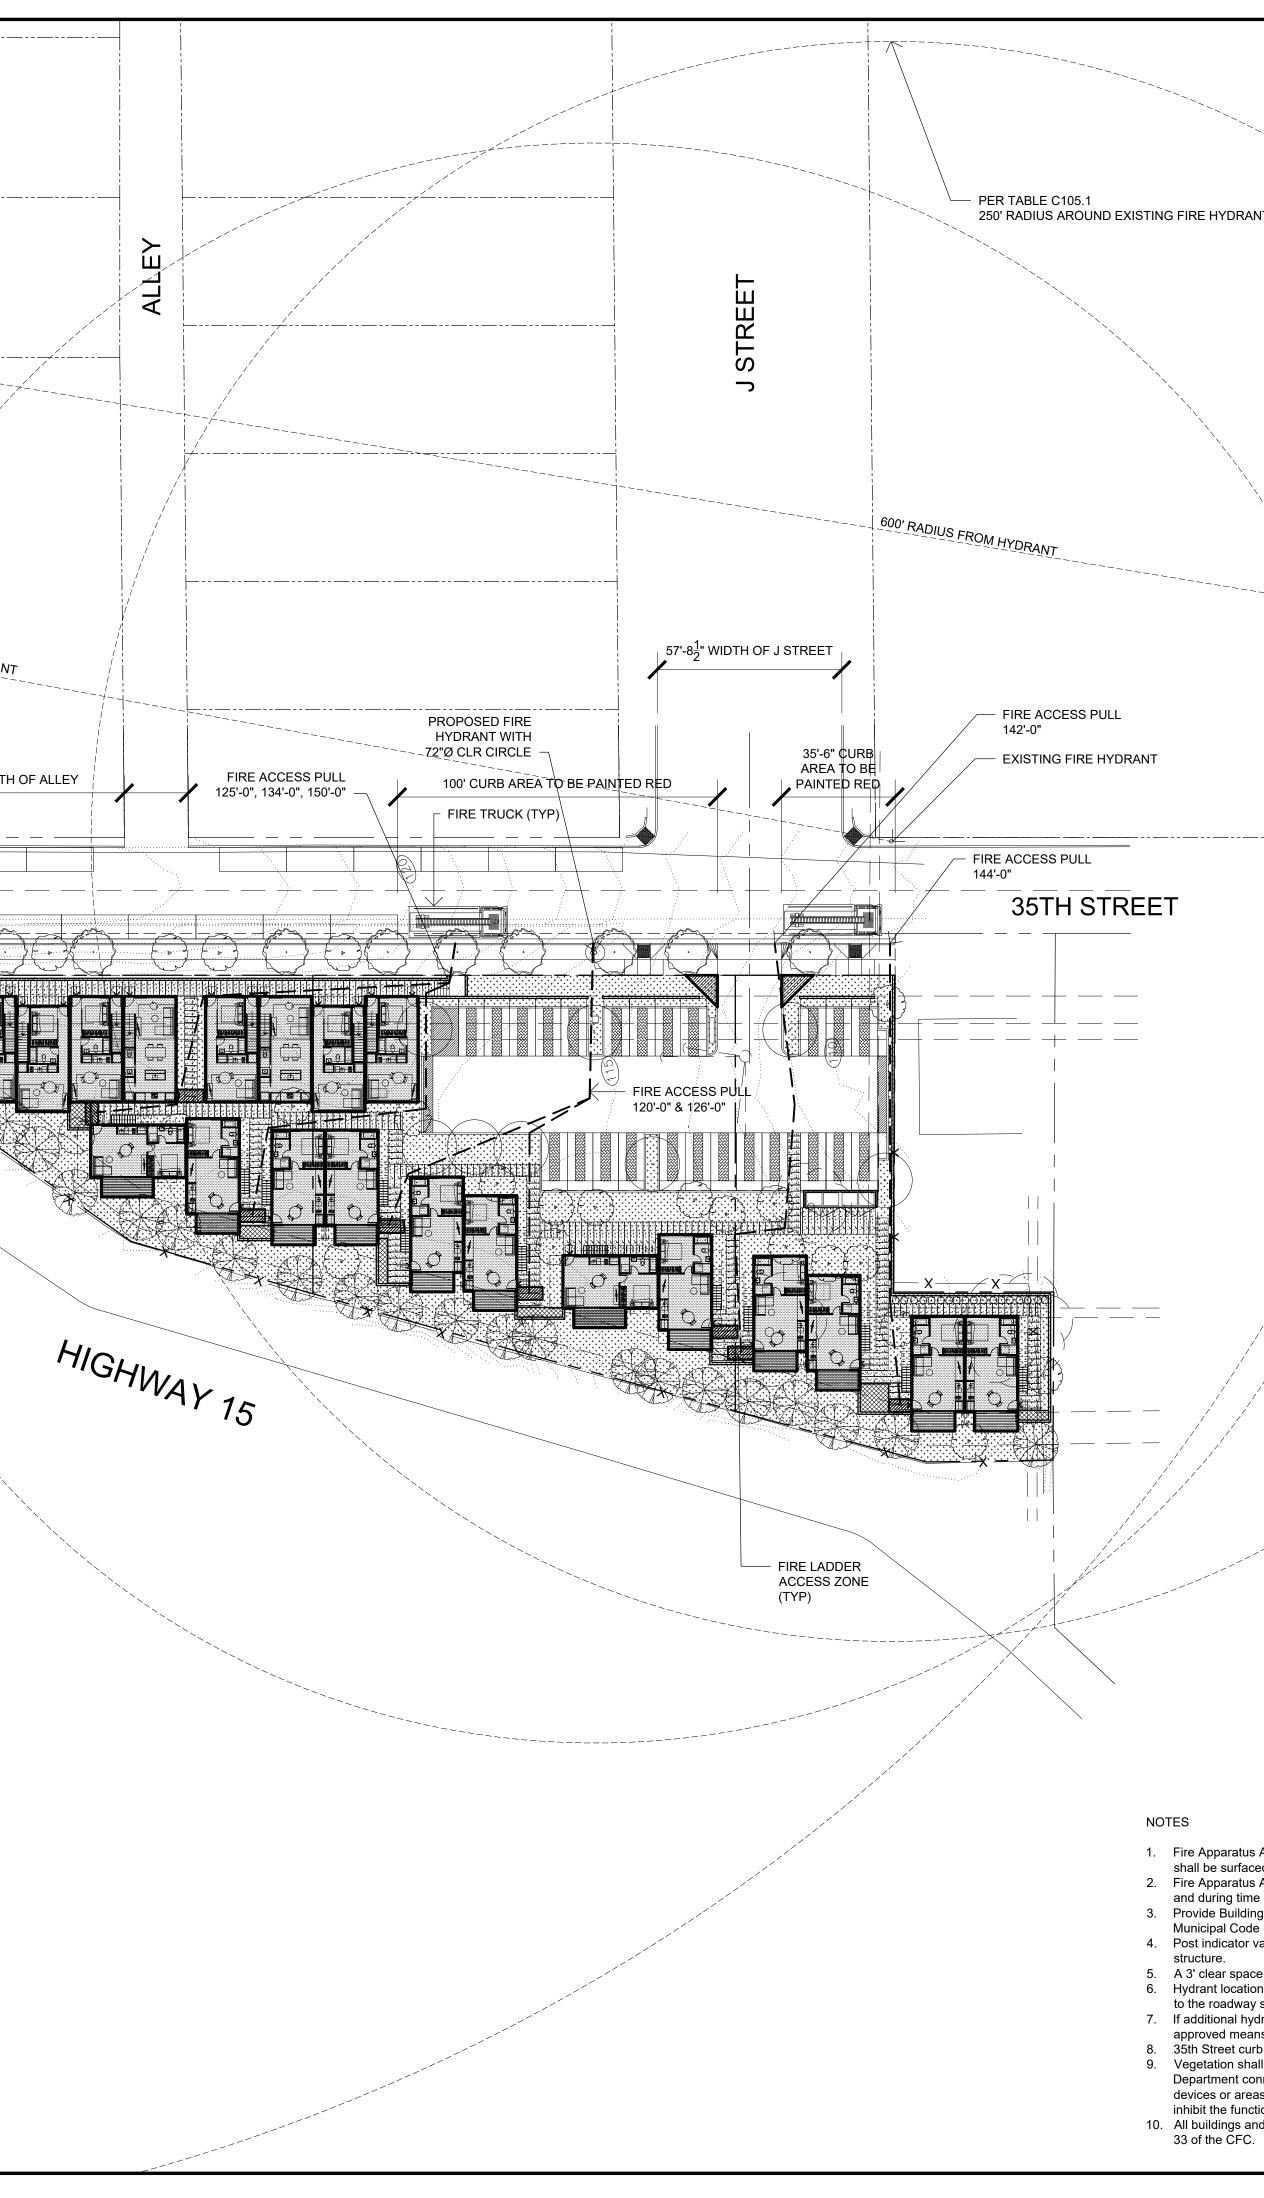

NT	
Access Roads shall be designed and maintained to support the imposed loads of fire apparatus and red so as to provide all weather driving capabilities. Access Roads and Water Supplies for fire protection, shall be installed and made serviceable prior to	
e of construction. ng Address numbers, visible and legible from the street or road fronting the property per San Diego e Section 95.0209.	
valves, fire department connections, and alarm bell are to be located on the address/access side of the	;

 A 3' clear space shall be maintained around the circumference of fire hydrants.
 Hydrant locations shall be identified by the installation of reflective blue colored markers. Such markers shall be affixed to the roadway surface, approximately centered between curbs, and at a right angle to the hydrant. 7. If additional hydrants are required and where fire hydrants are subject to impact by a motor vehicle, guard posts or other approved means shall comply with Section CFC 312.

8. 35th Street curb fronting project property shall be painted red/no parking.

Soft Street curb fronting project property shall be painted reacho parking.
 Vegetation shall be selected and maintained in such a manner as to allow immediate access to all hydrants valves, Fire Department connections, pull stations, extinguishers, sprinkler risers, alarm control panels, rescue windows, and other devices or areas used for firefighting purposes. Vegetation or building features shall not obstruct address numbers or inhibit the functioning of alarm bells, horns or strobes.
 All buildings and sites undergoing construction, alteration, or demolition shall comply with the requirements of Chapter 33 of the CFC.

Notes:	
All ideas, arrangements, drawings and plans set forth on this sheet are the original work product of, owned by and are the property of dbr ds and use of this said work product is limited to a specified project of the purchaser, and for the construction of one building, any use, reuse or disclosure of said plans, reproductions, ideas, designs and/or arrangements, other than by dbr ds, is strictly prohibited by law without the written permission of dbr ds. Written dimensions on these drawings shall have precedence over scaled dimensions; contractors shall verify, and be responsible for all dimensions and conditions on the job and this office must be notified of any variations from the dimensions and conditions shown these drawings.	
DBRDS DE BARTOLO + RIMANIC DESIGN STUDIO	
PROJECT TEAM	
OWNER: 35TH & J PARTNERS, LLC	
363 5TH AVE, SUITE 203 SAN DIEGO, CA 92101	
PHONE: (858) 220-5262 CONTACT: PAULY DE BARTOLO EMAIL: pauly@dbrds.com	
DESIGN:	
DE BARTOLO + RIMANIC DESIGN STUDIO	5
363 5TH AVE, SUITE 203 SAN DIEGO CA 92101	S S
PHONE:(858) 220-5262CONTACT:PAULY DE BARTOLOEMAIL:pauly@dbrds.com	Щ
	D C
SNIPES-DYE ASSOCIATES 8348 CENTER DRIVE, SUITE G	SSI
LA MESA, CA 91942	
PHONE: (619) 697-9234 CONTACT: BILL SNIPES EMAIL: bill@snipesdye.com	Щ
LANDSCAPE ARCHITECTURE	
703 16TH STREET, SUITE 100 SAN DIEGO, CA 92101	ΥC
PHONE: (619) 296-3150 CONTACT: DAVID MCCULLOUGH	Ú
EMAIL: david@mlasd.com	
SPEAR & ASSOCIATES, INC.	70
475 PRODUCTION STREET SAN MARCOS, CA 92078	0
PHONE:(760) 736-2040CONTACT:RAY SPEAREMAIL:rspear@spearinc.net	N
	17
NORTH	10
REVISION:	⊢
06.29.2017 DRAWN BY: CH SITE DEVELOPMENT PERMIT SUBMIT	ĪV
11.06.2017 DRAWN BY: CH CYCLE ISSUES 1	S
04.23.2018 DRAWN BY: CH CYCLE ISSUES 2	
08.30.2018 DRAWN BY: CH	
CYCLE ISSUES 3 05.15.2019 DRAWN BY: CH	
CYCLE ISSUES 4	5
CYCLE ISSUES 5	Ш
drawing title: FIRE ACCESS PLAN	Σ
, , , ,	Δ
project: PROPOSED SMALL LOT	Ο
SUBDIVISION PROJECT	
545-260-13-00, 14-00, 15-00	
CORNER OF 35TH ST & J ST SAN DIEGO CA 92102	
SAN DIEGO CA 92102	DE


1" = 30'-0"

A1.02

SCALE:


SHEET NO:

ATTACHMENT 16

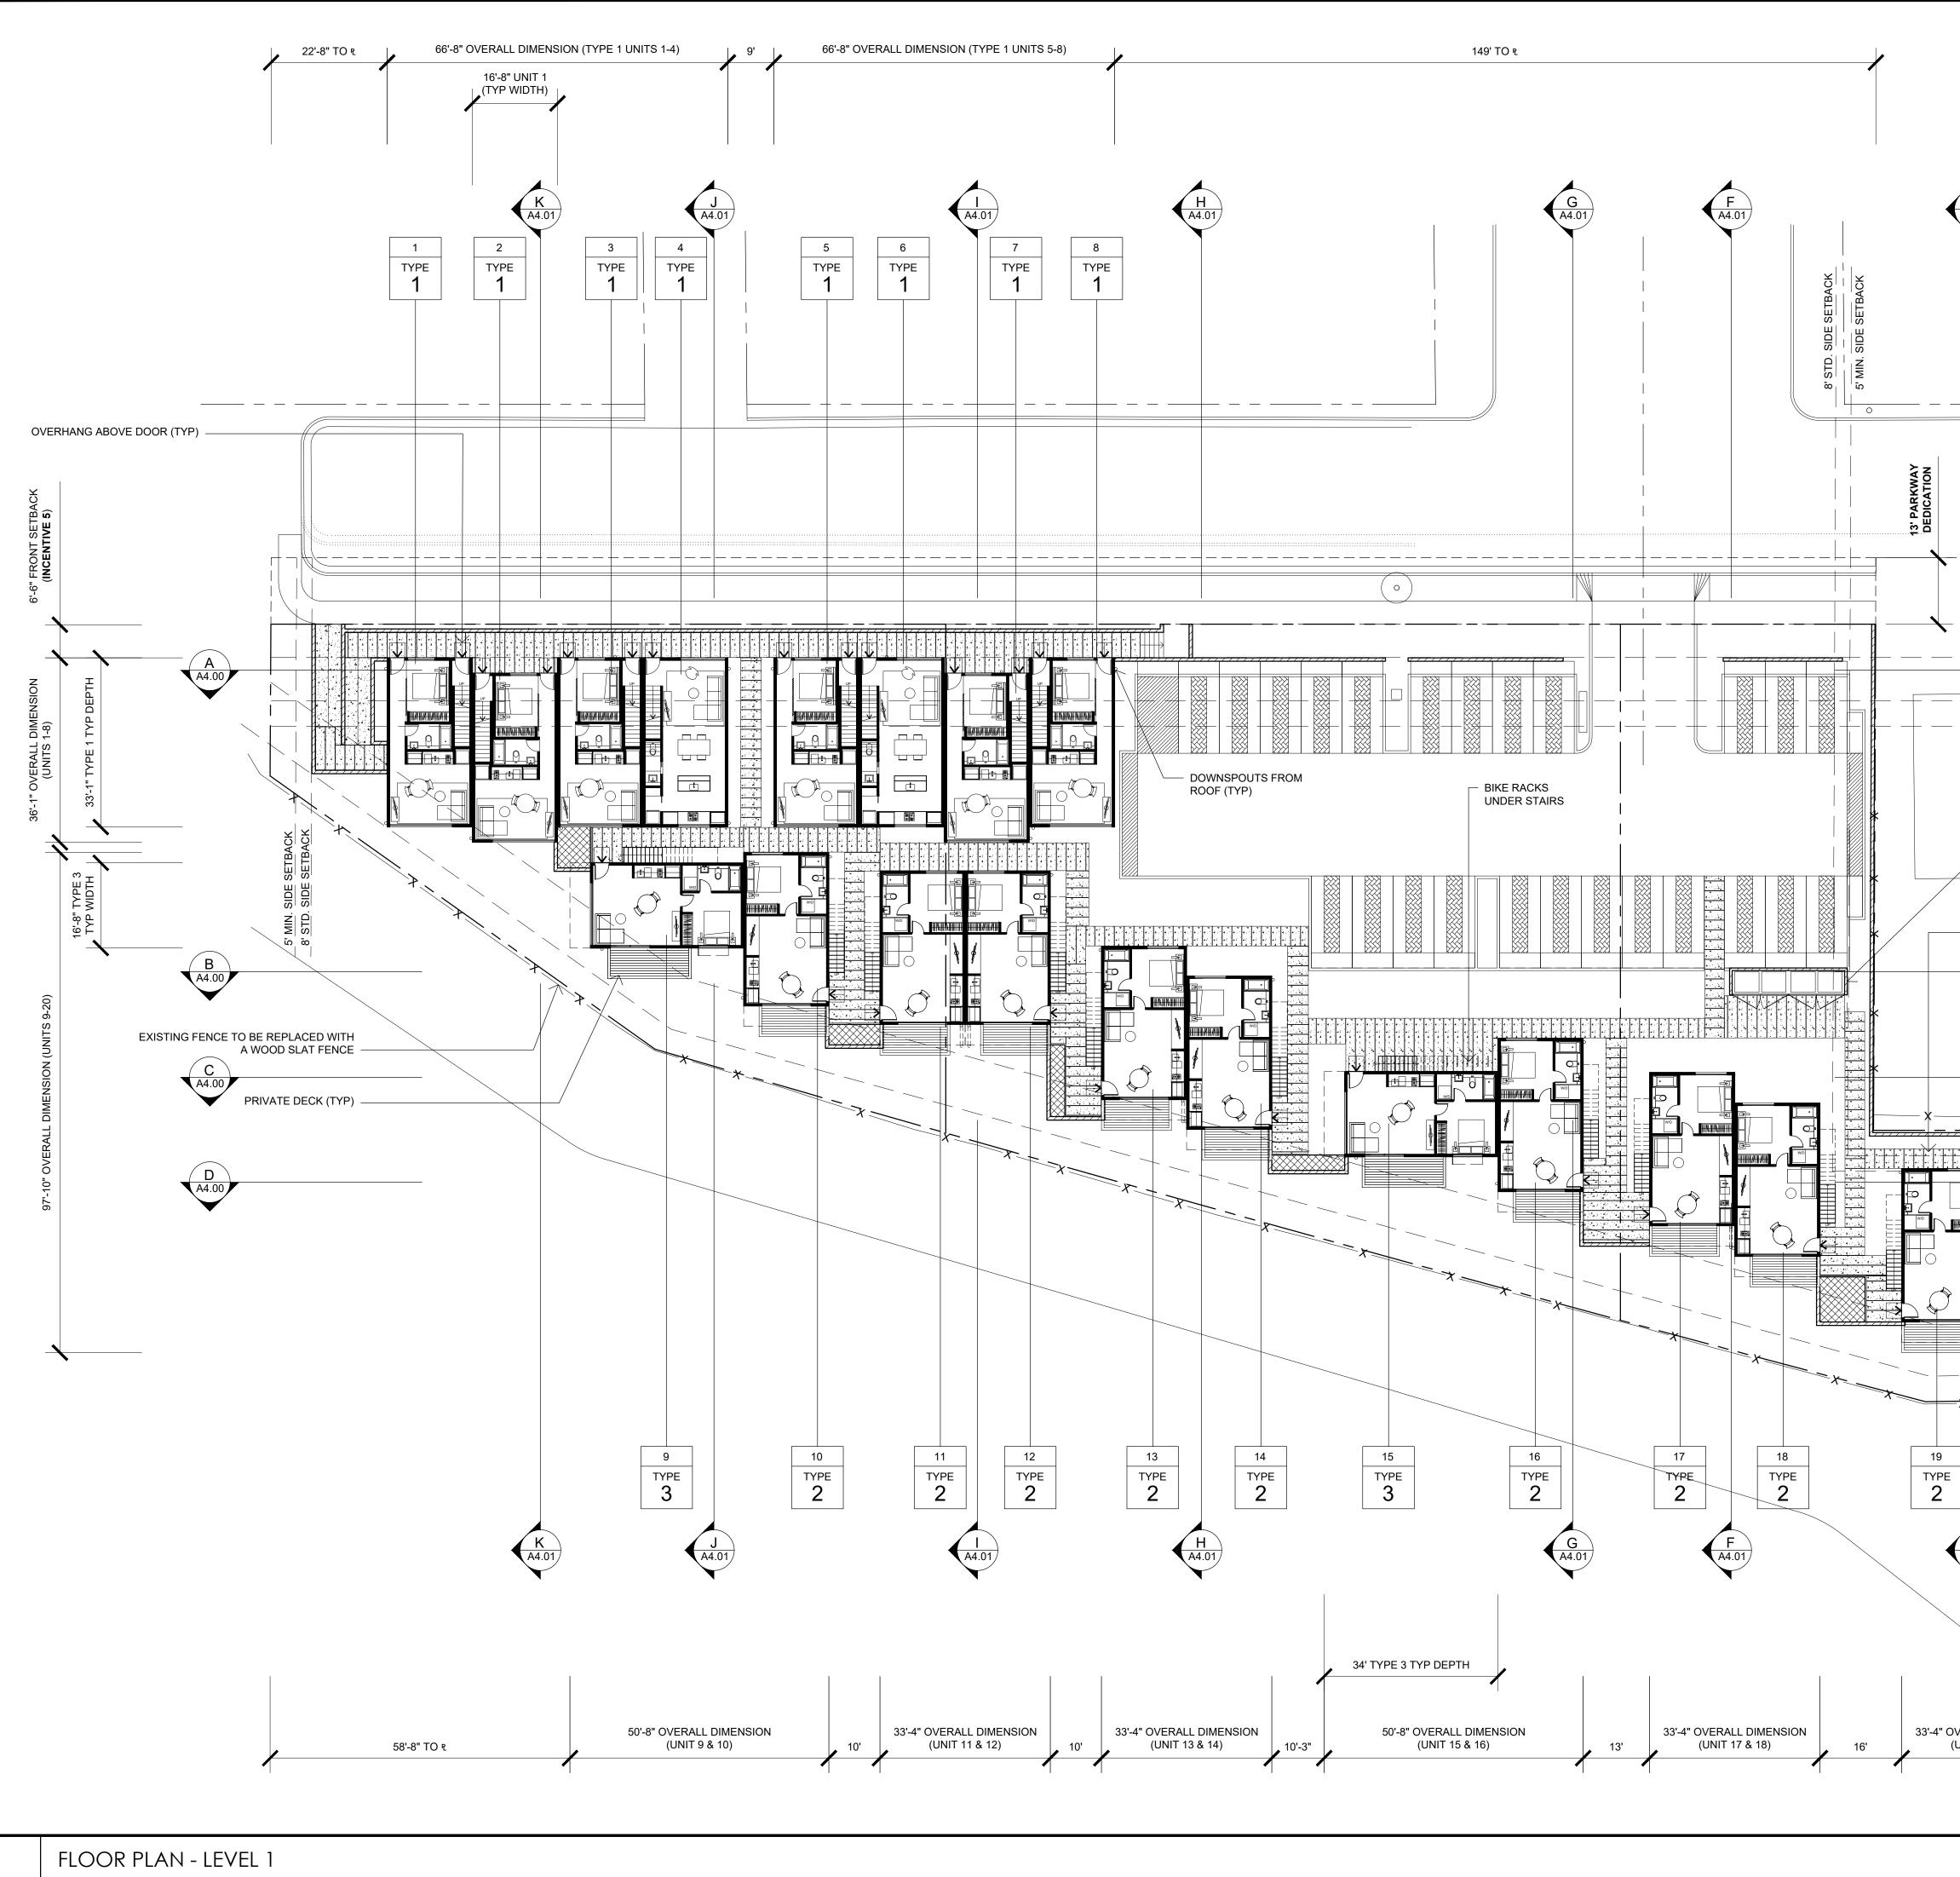


ATTACHMENT		⁻ 16
E A4.01	Notes: All ideas, arrangements, drawings and plans set for hon this sheet are the original work product of, owned by and are the property of dbrds and use of this said work product is limited to a specified project of the purchaser, and for the construction of one building, any use, reuse or disclosure of said plans, reproductions, ideas, designs and/or arrangements, other than by dbrds, is strictly prohibited by law without the written permission of dbrds. Written dimensions on these drawings shall have precedence over scaled dimensions; contractors shall verify, and be responsible for all dimensions and conditions on the job and this office must be notified of any variations from the dimensions and conditions shown these drawings.	
	DE BARTOLO + RIMANIC DESIGN STUDIO	
	PROJECT TEAM	
6'-6" PROPOSED FRONT SETBACK (INCENTIVE 5) 6'-6" PROPOSED FRONT SETBACK (INCENTIVE 5) A44.00 Image: Application of the set of the s	OWNER: 35TH & J PARTNERS, LLC 363 5TH AVE, SUITE 203 SAN DIEGO, CA 92101 PHONE: (858) 220-5262 CONTACT: PAULY DE BARTOLO EMAIL: pauly@dbrds.com DESIGN: D DE BARTOLO + RIMANIC DESIGN STUDIO 363 5TH AVE, SUITE 203 SAN DIEGO CA 92101 PHONE: (858) 220-5262 CONTACT: PAULY DE BARTOLO EMAIL: pauly@dbrds.com CIVIL ENGINEER SNIPES-DYE ASSOCIATES 8348 CENTER DRIVE, SUITE G LA MESA, CA 91942 PHONE: (619) 697-9234 CONTACT: BILL SNIPES EMAIL: bill@snipesdye.com LANDSCAPE ARCHITECTURE MCCULLOUGH LANDSCAPE ARCHITECTURE MCCULLOUGH LANDSCAPE ARCHITECTURE 703 16TH STREET, SUITE 100 SAN DIEGO, CA 92101 PHONE: PHONE: (619) 296-3150 CONTACT: DAVID MCCULLOUGH EMAIL: david@mlasd.com SURVEYOR SPEAR & ASSOCIATES, INC.	19 (CYCLE ISSUES 5)
B A4.00 A4.00	475 PRODUCTION STREET SAN MARCOS, CA 92078	01
SVRIJS JOG STD. FRONT SETBACK B'STD. FRONT SETBACK A4.00 A4.0	PHONE: (760) 736-2040 CONTACT: RAY SPEAR EMAIL: rspear@spearinc.net	T - 07.17.2
	06.29.2017 DRAWN BY: CH SITE DEVELOPMENT PERMIT SUBMIT 11.06.2017 DRAWN BY: CH	M
15' REQ. REAR SETBACK (INCENTIVE 3) 	CYCLE ISSUES 104.23.2018DRAWN BY: CHCYCLE ISSUES 208.30.2018DRAWN BY: CHCYCLE ISSUES 305.15.2019DRAWN BY: CHCYCLE ISSUES 407.17.2019DRAWN BY: CHCYCLE ISSUES 5	ENT PERMI
20 TYPE EXISTING FENCE 2 2 1 1 1 1 1 1 1 1 1 1 1 1 1 1 1 1 1	DRAWING TITLE: FLOOR PLAN	PME
E A4.01 16'-8" TYPE 2	LEVEL 1 PROJECT: PROPOSED SMALL LOT SUBDIVISION PROJECT 545-260-13-00, 14-00, 15-00	0
TXP WIDTH	CORNER OF 35TH ST & J ST SAN DIEGO CA 92102	JEVEl
DVERALL DIMENSION (UNIT 19 & 20) TO ፻	DBRDS PROJECT NO: 15005	
*NOTE: REFER TO CIVIL SHEETS C4 + C5 FOR SITE/ROOF DRAINAGE	DATE: APRIL 2016 DRAWN BY: CH	SITE
AND BIO-RETENTION SYSTEM DETAILS	<u>SCALE: 1/16" = 1'-0"</u>	S S
	SHEET NO: A2.10	~ •


16

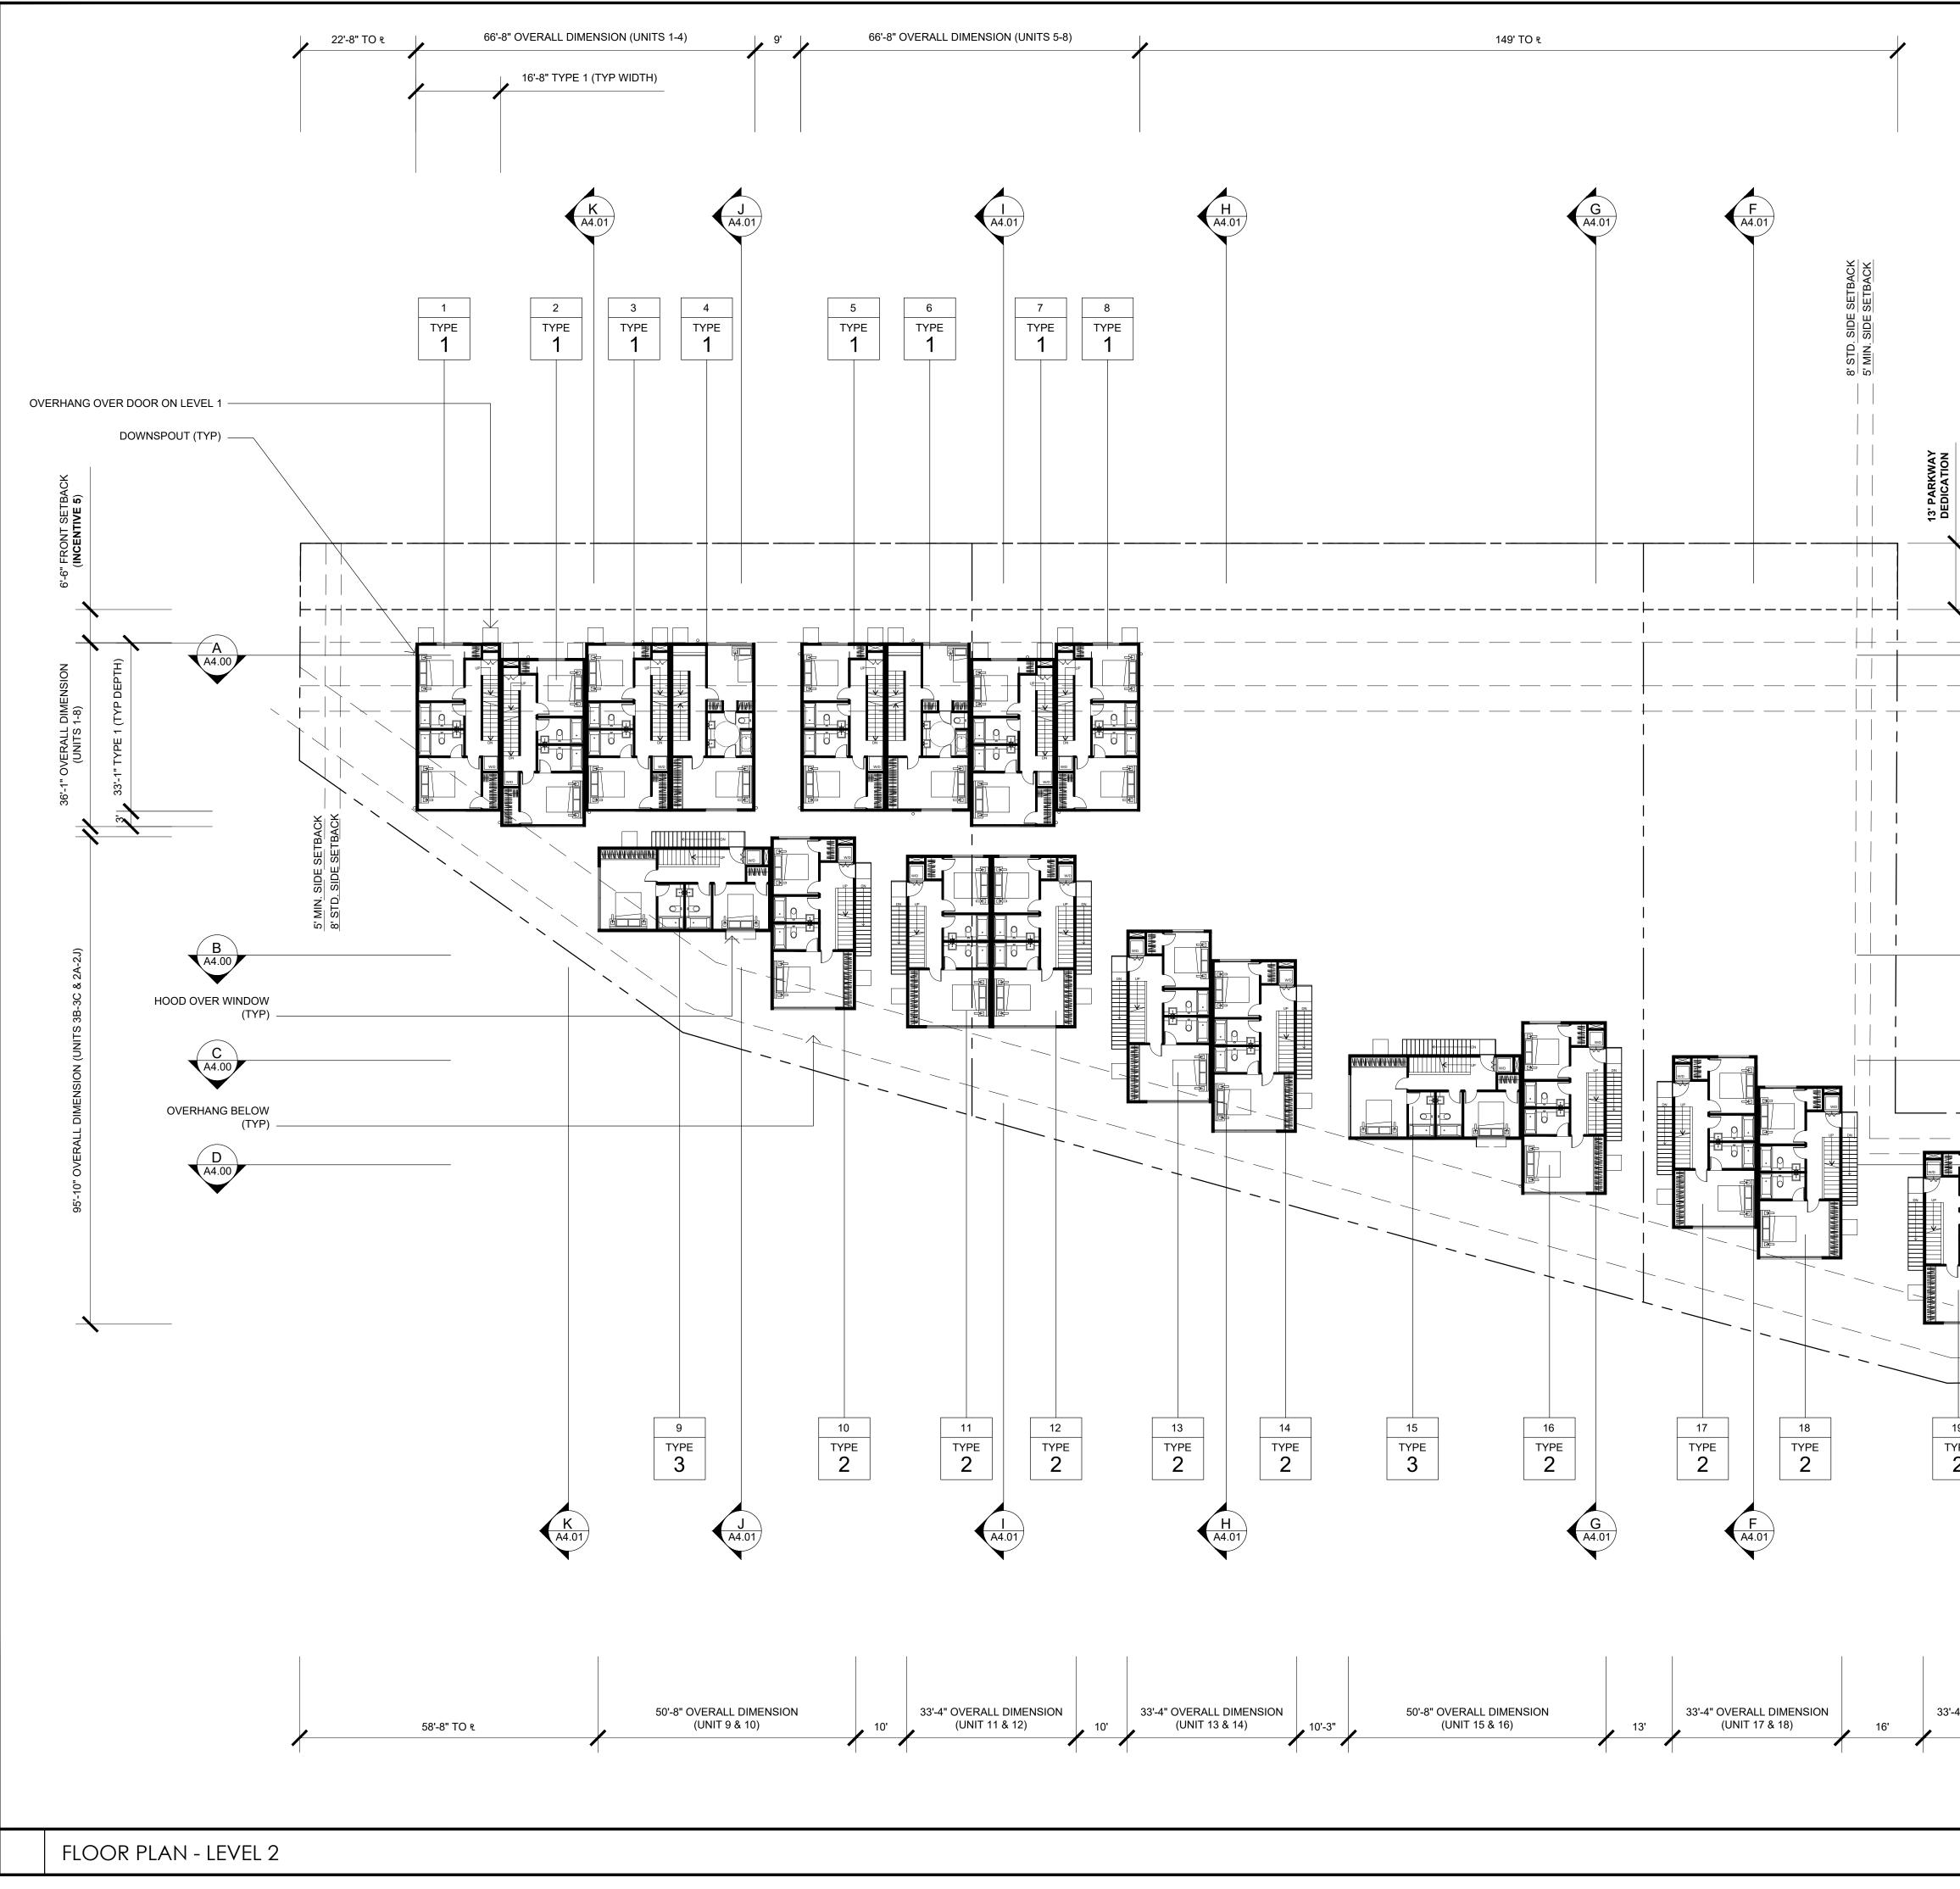


	ATTACHMENT 16	
E A4.01	Notes: All ideas, arrangements, drawings and plans set forth on this sheet are the original work product of, owned by and are the property of dbr ds and use of this said work product is limited to a specified project of the purchaser, and for the construction of one building, any use, reuse or disclosure of said plans, reproductions, ideas, designs and/or arrangements, other than by dbr ds, is strictly prohibited by law without the written permission of dbr ds. Written dimensions on these drawings shall have precedence over scaled dimensions; contractors shall verify, and be responsible for all dimensions and conditions on the job and this office must be notified of any variations from the dimensions and conditions shown these drawings.	
	DBRDS DE BARTOLO + RIMANIC DESIGN STUDIO	
	35TH & J PARTNERS, LLC 363 5TH AVE, SUITE 203 SAN DIEGO, CA 92101 PHONE: (858) 220-5262	
	CONTACT: PAULY DE BARTOLO EMAIL: pauly@dbrds.com DESIGN: Image: Control of the president studies	、
	363 5TH AVE, SUITE 203 SAN DIEGO, CA. 92101	
<u>6'-6" PROPOSED FRONT SETBACK (INCENTIVE 5)</u>	PHONE: (858) 220-5262 CONTACT: PAULY DE BARTOLO EMAIL: pauly@dbrds.com	
	PHONE: (858) 220-5262 CONTACT: PAULY DE BARTOLO EMAIL: pauly@dbrds.com CIVIL ENGINEER SNIPES-DYE ASSOCIATES 8348 CENTER DRIVE, SUITE G LA MESA, CA 91942	
	PHONE: (619) 697-9234 CONTACT: BILL SNIPES EMAIL: bill@snipesdye.com	
	LANDSCAPE ARCHITECTURE McCULLOUGH LANDSCAPE ARCHITECTURE 703 16TH STREET, SUITE 100	
	SAN DIEGO, CA 92101 PHONE: (619) 296-3150 CONTACT: DAVID MCCULLOUGH EMAIL: david@mlasd.com	,
B A4.00	SURVEYOR SPEAR & ASSOCIATES, INC.	
SIDE SETBACK	475 PRODUCTION STREET SAN MARCOS, CA 92078 PHONE: (760) 736-2040 CONTACT: RAY SPEAR EMAIL: rspear@spearinc.net	
C A4.00 G III III IIII IIII IIIII IIIII IIIIIII	EMAIL: rspear@spearinc.net	
5' MIN. SIDE SETBACK	NORTH NORTH	
	06.29.2017 DRAWN BY: CH SITE DEVELOPMENT PERMIT SUBMIT 11.06.2017 DRAWN BY: CH CYCLE ISSUES 1 04.23.2018 DRAWN BY: CH CYCLE ISSUES 2 08.30.2018 DRAWN BY: CH CYCLE ISSUES 3	
15' MIN. REAR SETBACK (INCENTIVE 3) Image: Constraint of the set back is the set	04.23.2018 DRAWN BY: CH CYCLE ISSUES 2	
19 YPE 2 2 2 19 19 20 TYPE 2 19 19 20 19 19 20 19 19 19 19 19 19 19 19 19 19	05.15.2019DRAWN BY: CHCYCLE ISSUES 407.17.2019DRAWN BY: CHCYCLE ISSUES 5	
	DRAWING TITLE: FLOOR PLAN LEVEL 2	
16'-8" TYPE 2	PROPOSED SMALL LOT	
(TYP WIDTH)	SUBDIVISION PROJECT 545-260-13-00, 14-00, 15-00 CORNER OF 35TH ST & J ST SAN DIEGO CA 92102	
-4" OVERALL DIMENSION (UNIT 19 & 20) TO r	DBRDS PROJECT NO: 15005 DATE: APRIL 2016	
	DRAWN BY: CH SCALE: 1/16" = 1'-0"	
	SHEET NO: A2.11	

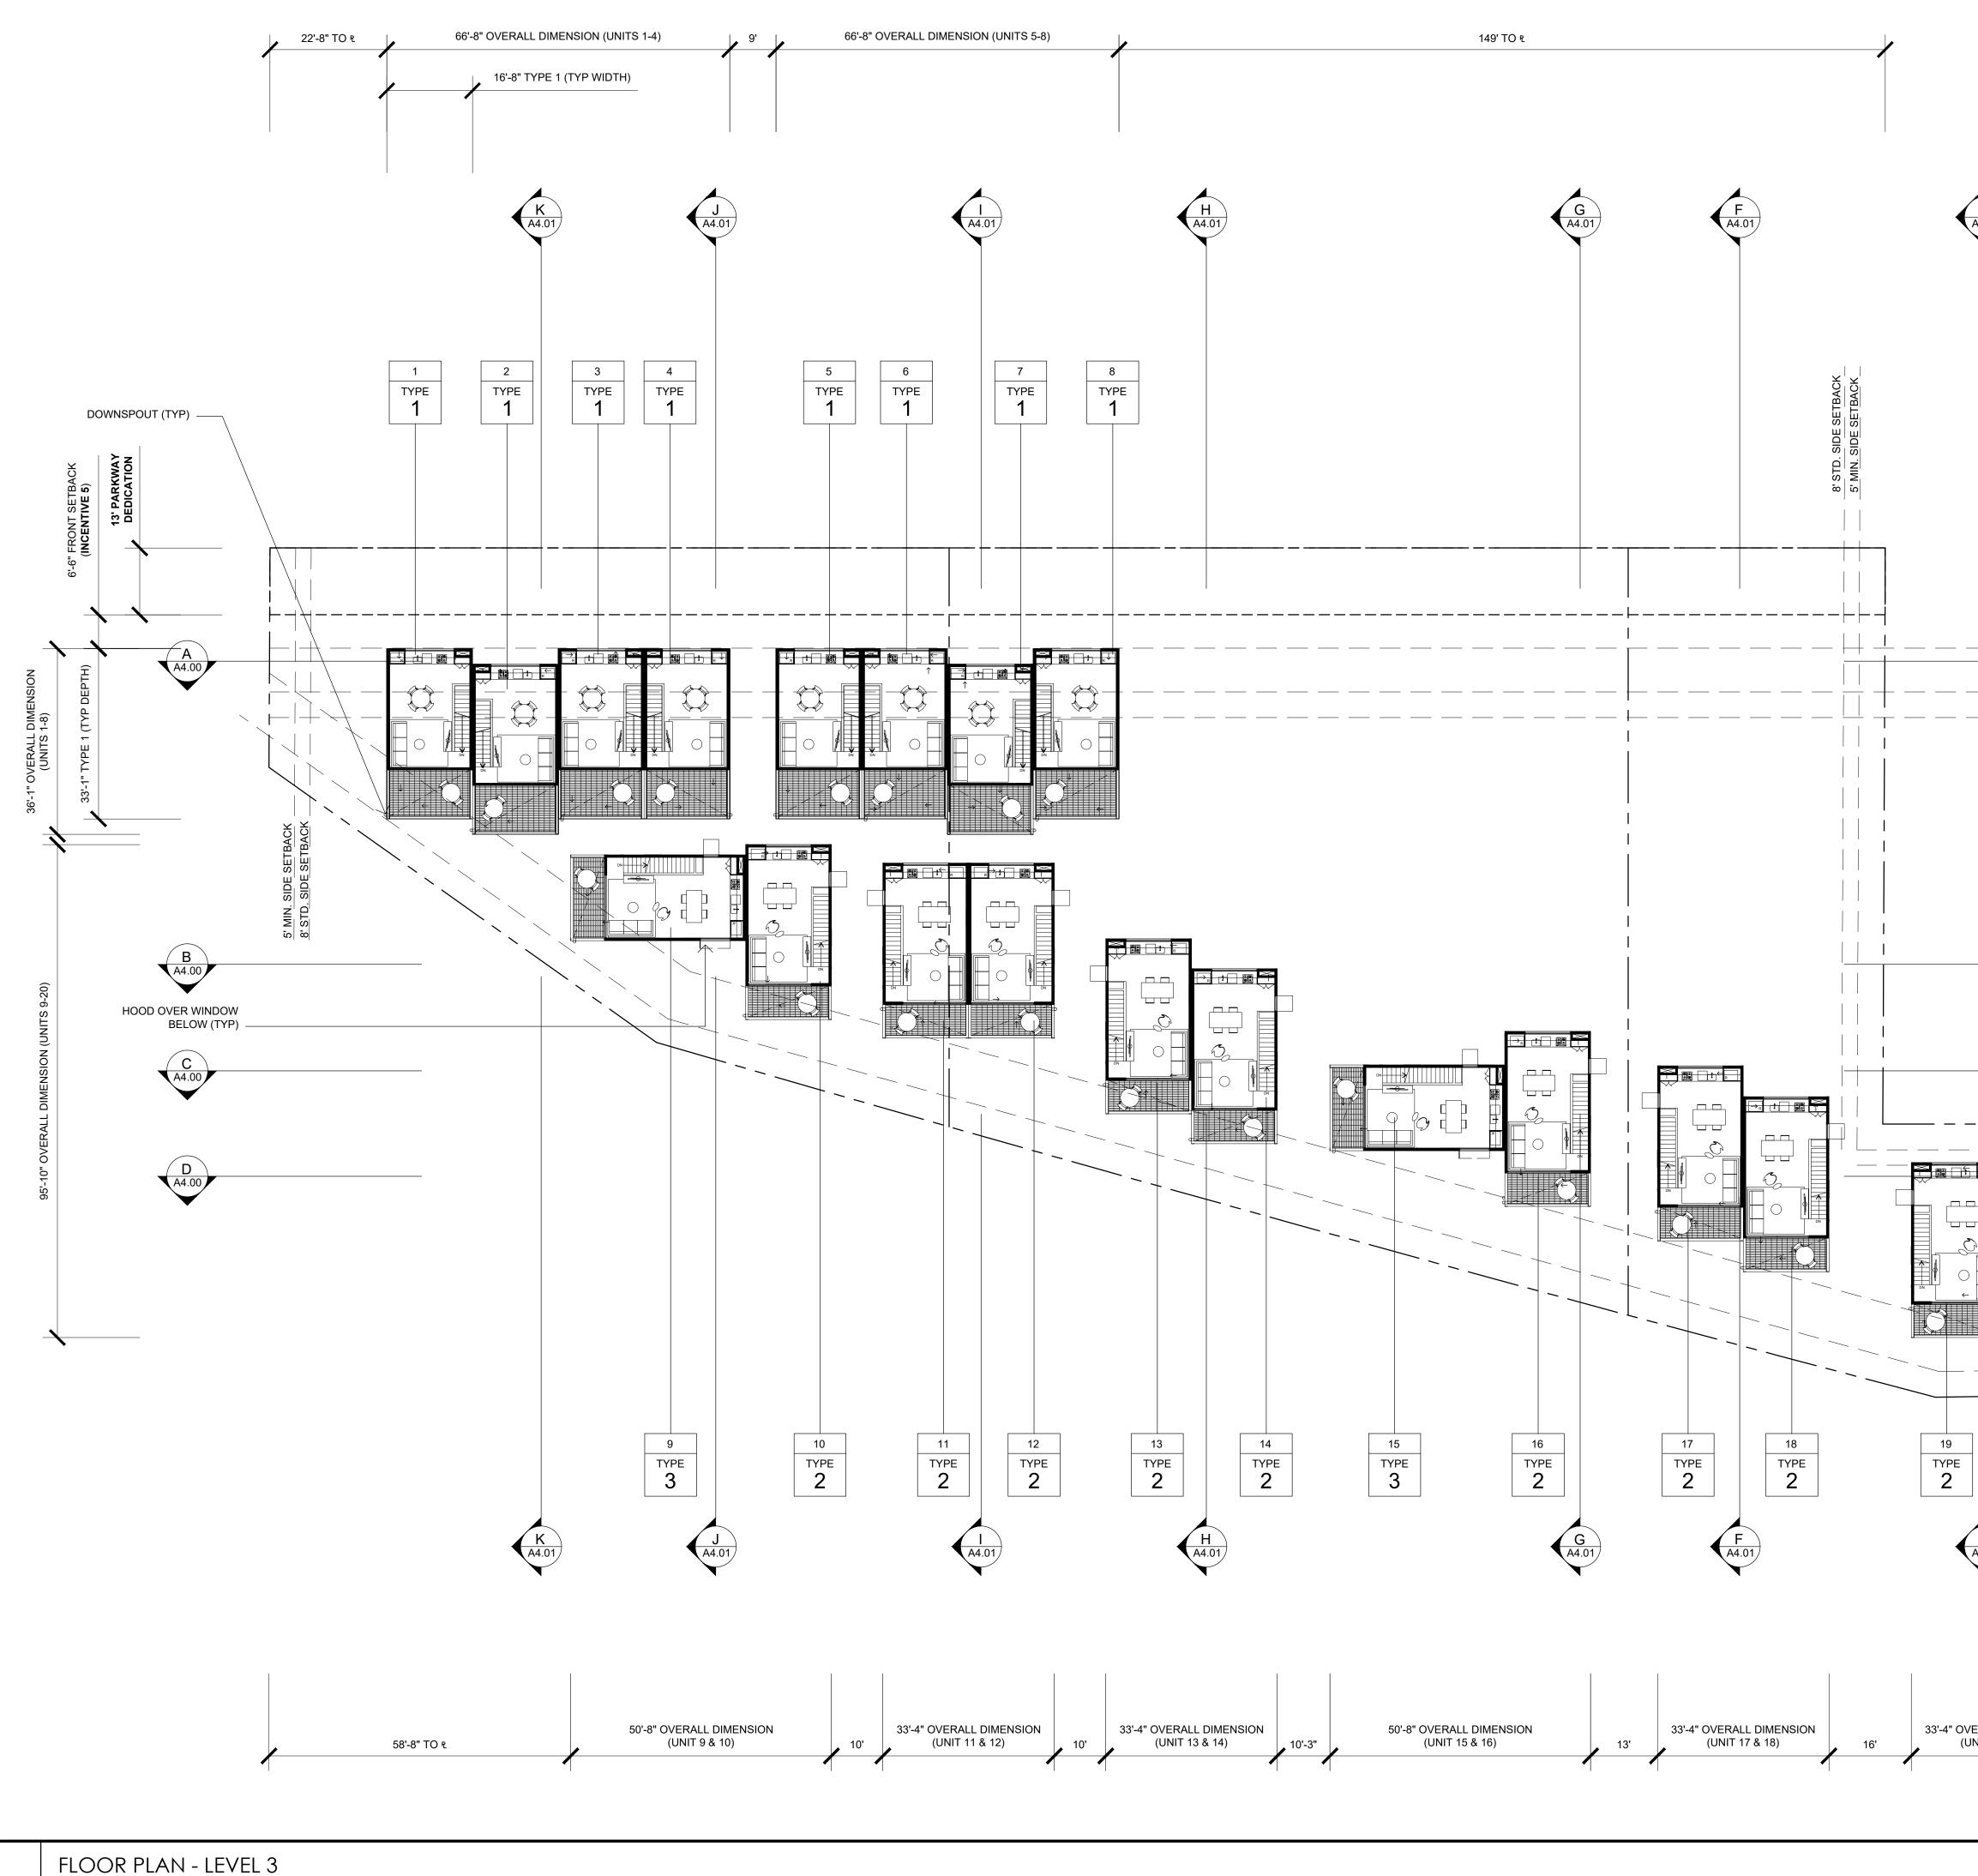

		<u> 16 </u>
E A4.01	Notes: All ideas, arrangements, drawings and plans set forth on this sheet are the original work product of, owned by and are the property of dbr ds and use of this said work product is limited to a specified project of the purchaser, and for the construction of one building, any use, reuse or disclosure of said plans, reproductions, ideas, designs and/or arrangements, other than by dbr ds, is strictly prohibited by law without the written permission of dbr ds. Written dimensions on these drawings shall have precedence over scaled dimensions; contractors shall verify, and be responsible for all dimensions and conditions on the job and this office must be notified of any variations from the dimensions and conditions shown these drawings.	
	DBRDS DE BARTOLO + RIMANIC DESIGN STUDIO	
	PROJECT TEAM	
	OWNER: 35TH & J PARTNERS, LLC 363 5TH AVE, SUITE 203 SAN DIEGO, CA 92101 PHONE: (858) 220-5262 CONTACT: PAULY DE BARTOLO EMAIL: pauly@dbrds.com DESIGN: DE BARTOLO + RIMANIC DESIGN STUDIO 363 5TH AVE, SUITE 203 SAN DIEGO CA 92101 PHONE: (858) 220-5262 CONTACT: PAULY DE BARTOLO	ISSUES 5)
6'-6" PROPOSED FRONT SETBACK (INCENTIVE 5)	EMAIL: pauly@dbrds.com CIVIL ENGINEER	D C
	SNIPES-DYE ASSOCIATES 8348 CENTER DRIVE, SUITE G	S
	LA MESA, CA 91942 PHONE: (619) 697-9234 CONTACT: BILL SNIPES	Ш
	EMAIL: bill@snipesdye.com LANDSCAPE ARCHITECTURE	(CYCLI
	McCULLOUGH LANDSCAPE ARCHITECTURE 703 16TH STREET, SUITE 100 SAN DIEGO, CA 92101	ХС
	PHONE: (619) 296-3150 CONTACT: DAVID MCCULLOUGH EMAIL: david@mlasd.com	Ú
	SURVEYOR	19
H A4.00	SPEAR & ASSOCIATES, INC. 475 PRODUCTION STREET SAN MARCOS, CA 92078	01
8' STD. SIDE SETBACK 5' MIN. SIDE SETBACK C V-6" TO R	PHONE: (760) 736-2040 CONTACT: RAY SPEAR EMAIL: rspear@spearinc.net	17.2
	NORTH	7
5' MIN. SIDE SETBACK 8' STD. FRONT SETBACK D A4.00		0
OVERHANG BELOW (TYP)	REVISION: 06.29.2017 DRAWN BY: CH SITE DEVELOPMENT PERMIT SUBMIT	PERMIT
$\begin{array}{c c} & & & & & & \\ \hline & & & & \\ \hline & & & & \\ \hline & & & &$	11.06.2017 DRAWN BY: CH CYCLE ISSUES 1 04.23.2018 DRAWN BY: CH	R
5' PROP. REAR SETBACK	CYCLE ISSUES 2 08.30.2018 DRAWN BY: CH	Ш
	CYCLE ISSUES 3 05.15.2019 DRAWN BY: CH CYCLE ISSUES 4	F
20 TYPE 2 1 1 2 2 1 1 1 1 1 1 1 1 1 1 1 1 1 1	07.17.2019 DRAWN BY: CH CYCLE ISSUES 5	ENT
	DRAWING TITLE: FLOOR PLAN LEVEL 3	OPME
A4.01 16'-8" TYPE 2	PROJECT: PROPOSED SMALL LOT SUBDIVISION PROJECT 545-260-13-00, 14-00, 15-00	
(TYP WIDTH)	CORNER OF 35TH ST & J ST SAN DIEGO CA 92102	EVEI
/ERALL DIMENSION 10'-11" JNIT 19 & 20) TO ዊ	DBRDS PROJECT NO: 15005	\square
	DATE: APRIL 2016 DRAWN BY: CH	Ш
	<u>SCALE: 1/16" = 1'-0"</u>	SITE
	SHEET NO: A2.12	

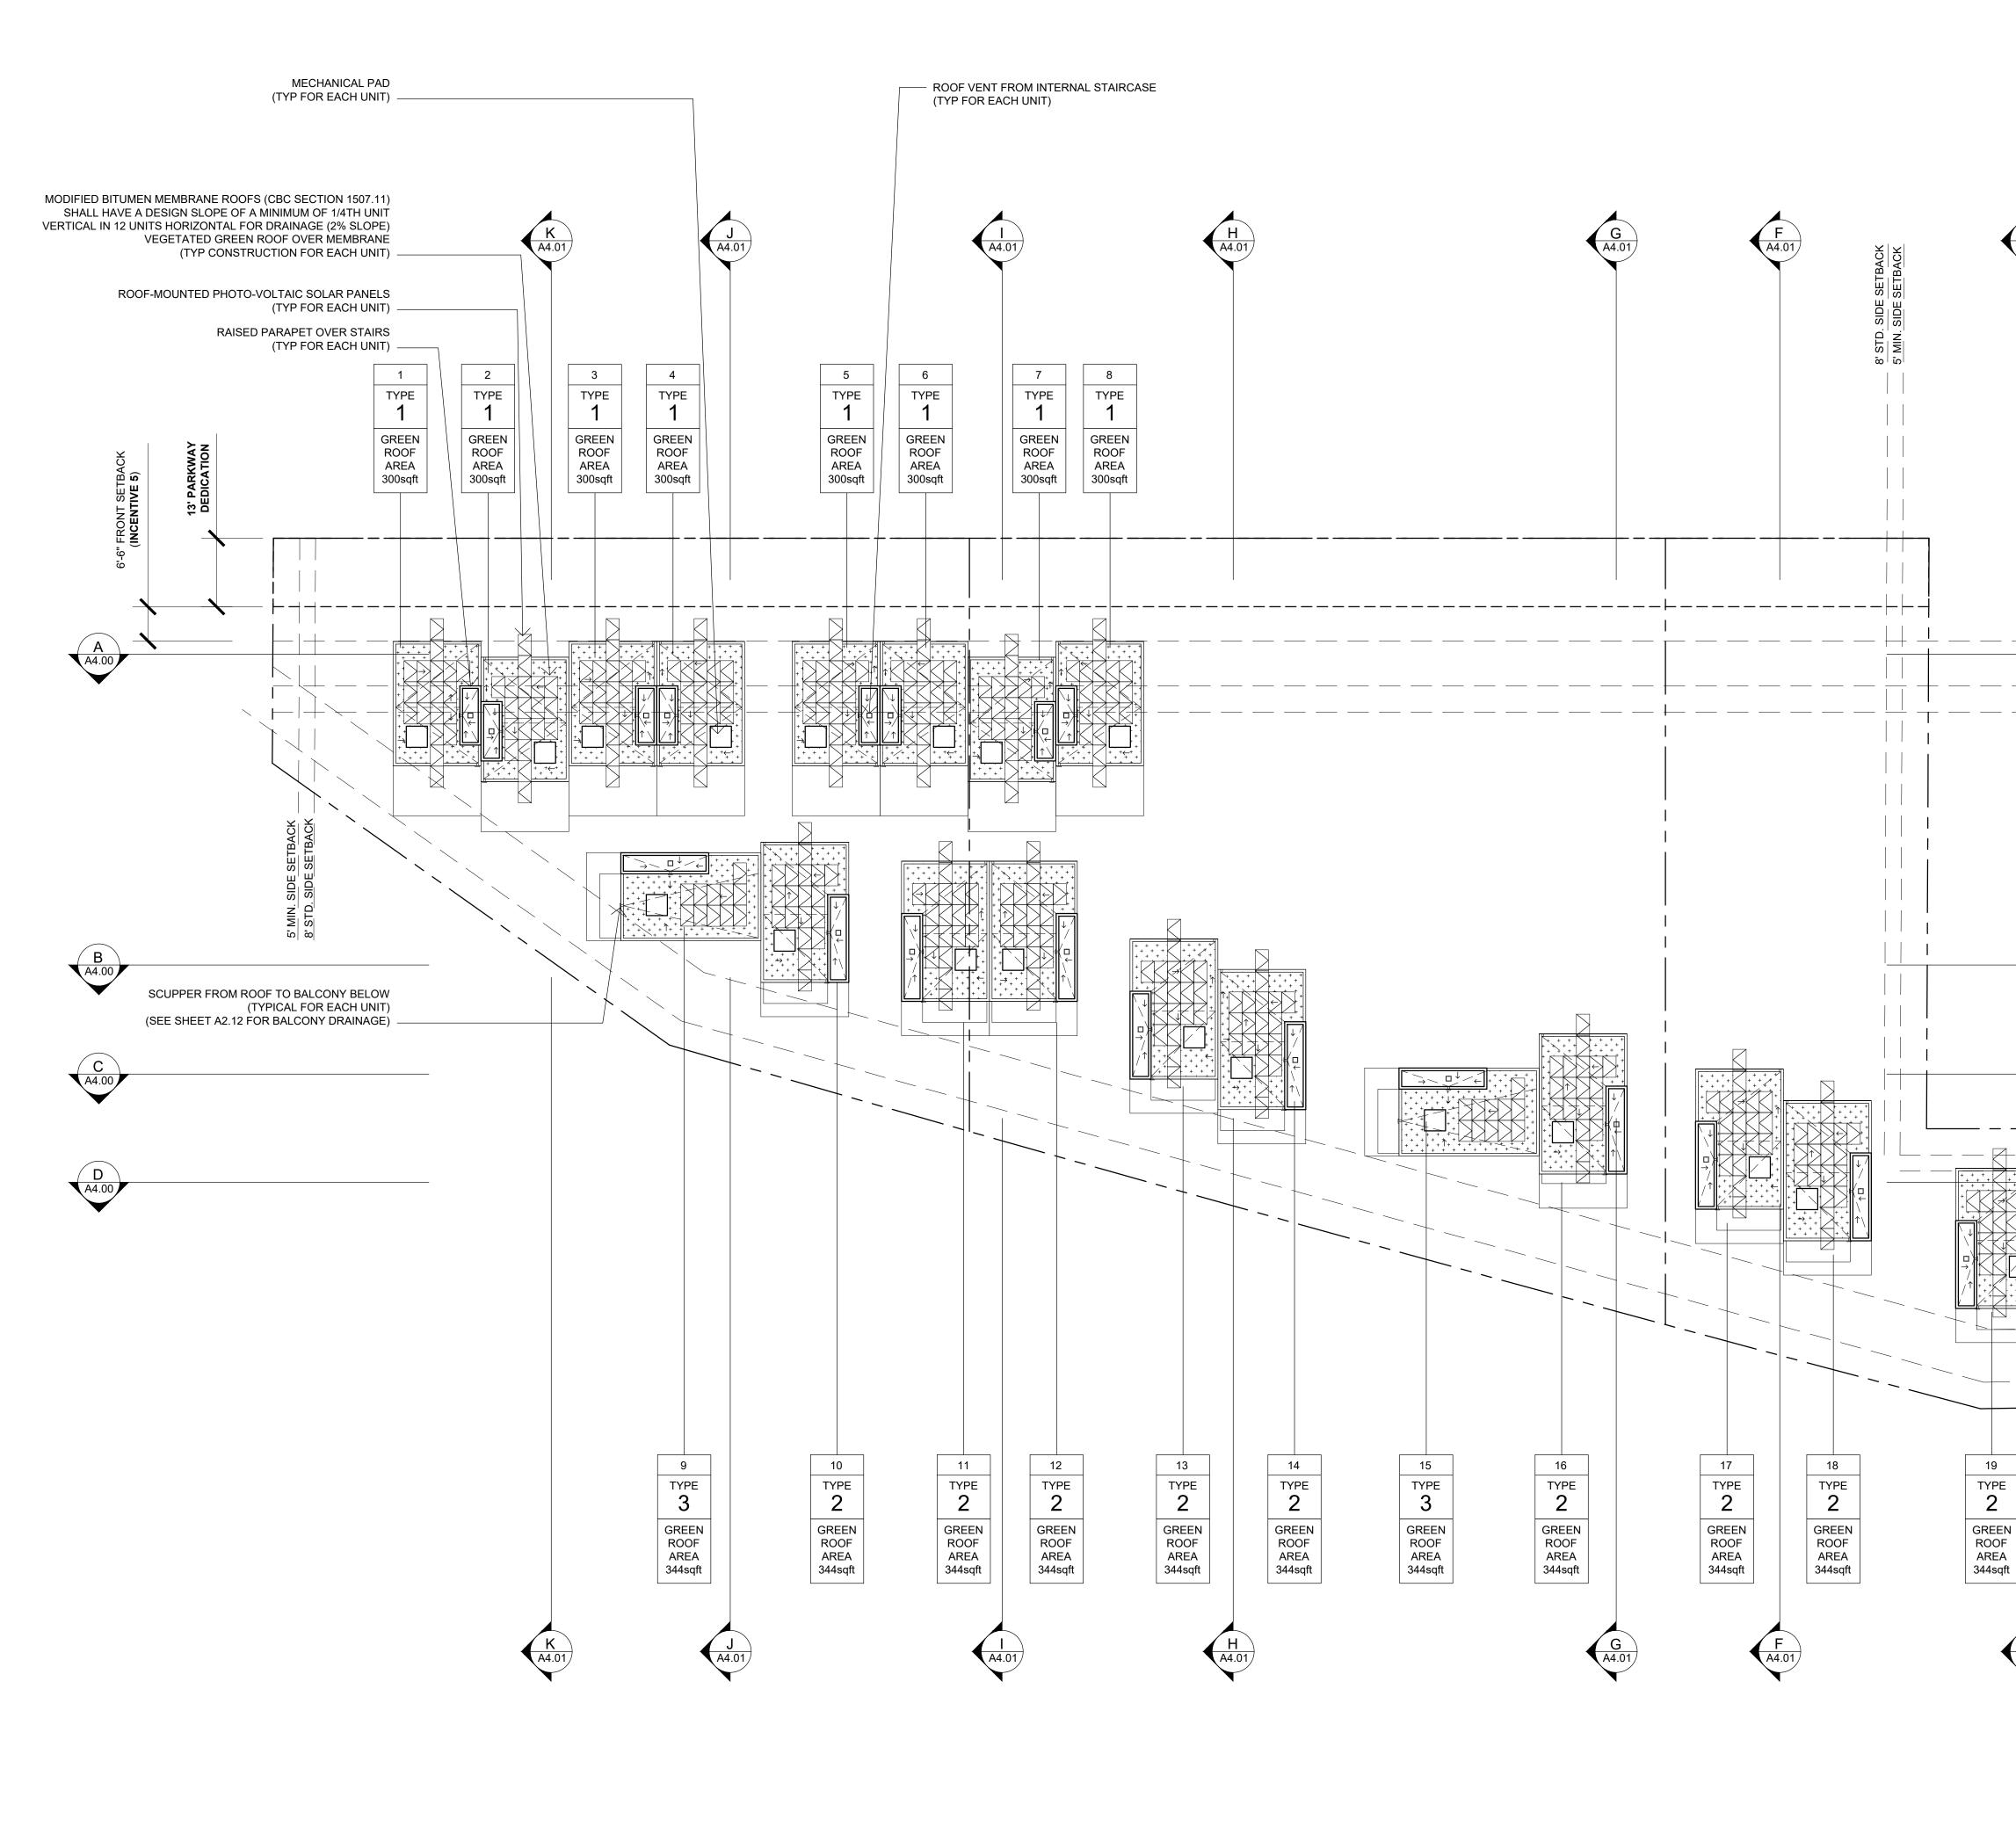

		ATTACHMENT	16
	← SLOPE DIRECTION	Notes: All ideas, arrangements, drawings and plans set forth on this sheet are the original work product of, owned by and are the property of dbr ds and use of this said work product is limited to a specified project of the purchaser, and for the construction of one building, any use, reuse or disclosure of said plans, reproductions, ideas, designs and/or arrangements, other than by dbr ds, is strictly prohibited by law without the written permission of dbr ds. Written dimensions on these drawings shall have precedence over scaled dimensions; contractors shall verify, and be responsible for all dimensions and conditions on the job and this office must be notified of any variations from the dimensions and conditions shown these drawings.	
E A4.01		DBRDS DE BARTOLO + RIMANIC DESIGN STUDIO	
		PROJECT TEAM	
		OWNER:35TH & J PARTNERS, LLC363 5TH AVE, SUITE 203 SAN DIEGO, CA 92101PHONE:(858) 220-5262 CONTACT:CONTACT:PAULY DE BARTOLO EMAIL:EMAIL:pauly@dbrds.comDESIGN:	ES 5)
6'-6" PROPOSED FRONT SETBACK (INCENTIVE 5)		CONTACT: PAULY DE BARTOLO EMAIL: pauly@dbrds.com	SUE
	A A4.00 B A4.00	CIVIL ENGINEER SNIPES-DYE ASSOCIATES 8348 CENTER DRIVE, SUITE G LA MESA, CA 91942 PHONE: (619) 697-9234 CONTACT: BILL SNIPES EMAIL: bill@snipesdye.com LANDSCAPE ARCHITECTURE McCULLOUGH LANDSCAPE ARCHITECTURE 703 16TH STREET, SUITE 100 SAN DIEGO, CA 92101 PHONE: (619) 296-3150 CONTACT: DAVID MCCULLOUGH EMAIL: david@mlasd.com SURVEYOR SPEAR & ASSOCIATES, INC. 475 PRODUCTION STREET SAN MARCOS, CA 92078 PHONE: (760) 736-2040 CONTACT: RAY SPEAR	2019 (CYCLE ISSUI
5' <u>MIN</u> . SIDE SE	C A4.00	EMAIL: rspear@spearinc.net	07.17.2
5' MIN. SIDE SETBACK		NORTH	- 07
15' MIN. REAR SETBACK (INCENTIVE 3) 5' PROP. REAR SETBACK (INCENTIVE 3)		REVISION: 06.29.2017 DRAWN BY: CH SITE DEVELOPMENT PERMIT SUBMIT 11.06.2017 DRAWN BY: CH CYCLE ISSUES 1 04.23.2018 DRAWN BY: CH CYCLE ISSUES 2 08.30.2018 DRAWN BY: CH CYCLE ISSUES 3 05.15.2019 DRAWN BY: CH CYCLE ISSUES 4 07.17.2019 DRAWN BY: CH CYCLE ISSUES 5 DRAWING TITLE: ROOF PLAN	OPMENT PERMIT -
AREA 344sqft		PROJECT: PROPOSED SMALL LOT SUBDIVISION PROJECT 545-260-13-00, 14-00, 15-00 CORNER OF 35TH ST & J ST SAN DIEGO CA 92102 DBRDS PROJECT NO: 15005	DEVELO
+ + GREEN ROOFS	*NOTE: ER TO CIVIL SHEETS C4 + C5 FOR SITE/ROOF DRAINAGE ETENTION SYSTEM DETAILS	DATE: APRIL 2016 DRAWN BY: CH SCALE: 1/16" = 1'-0"	SITE
		SHEET NO: A2.13	

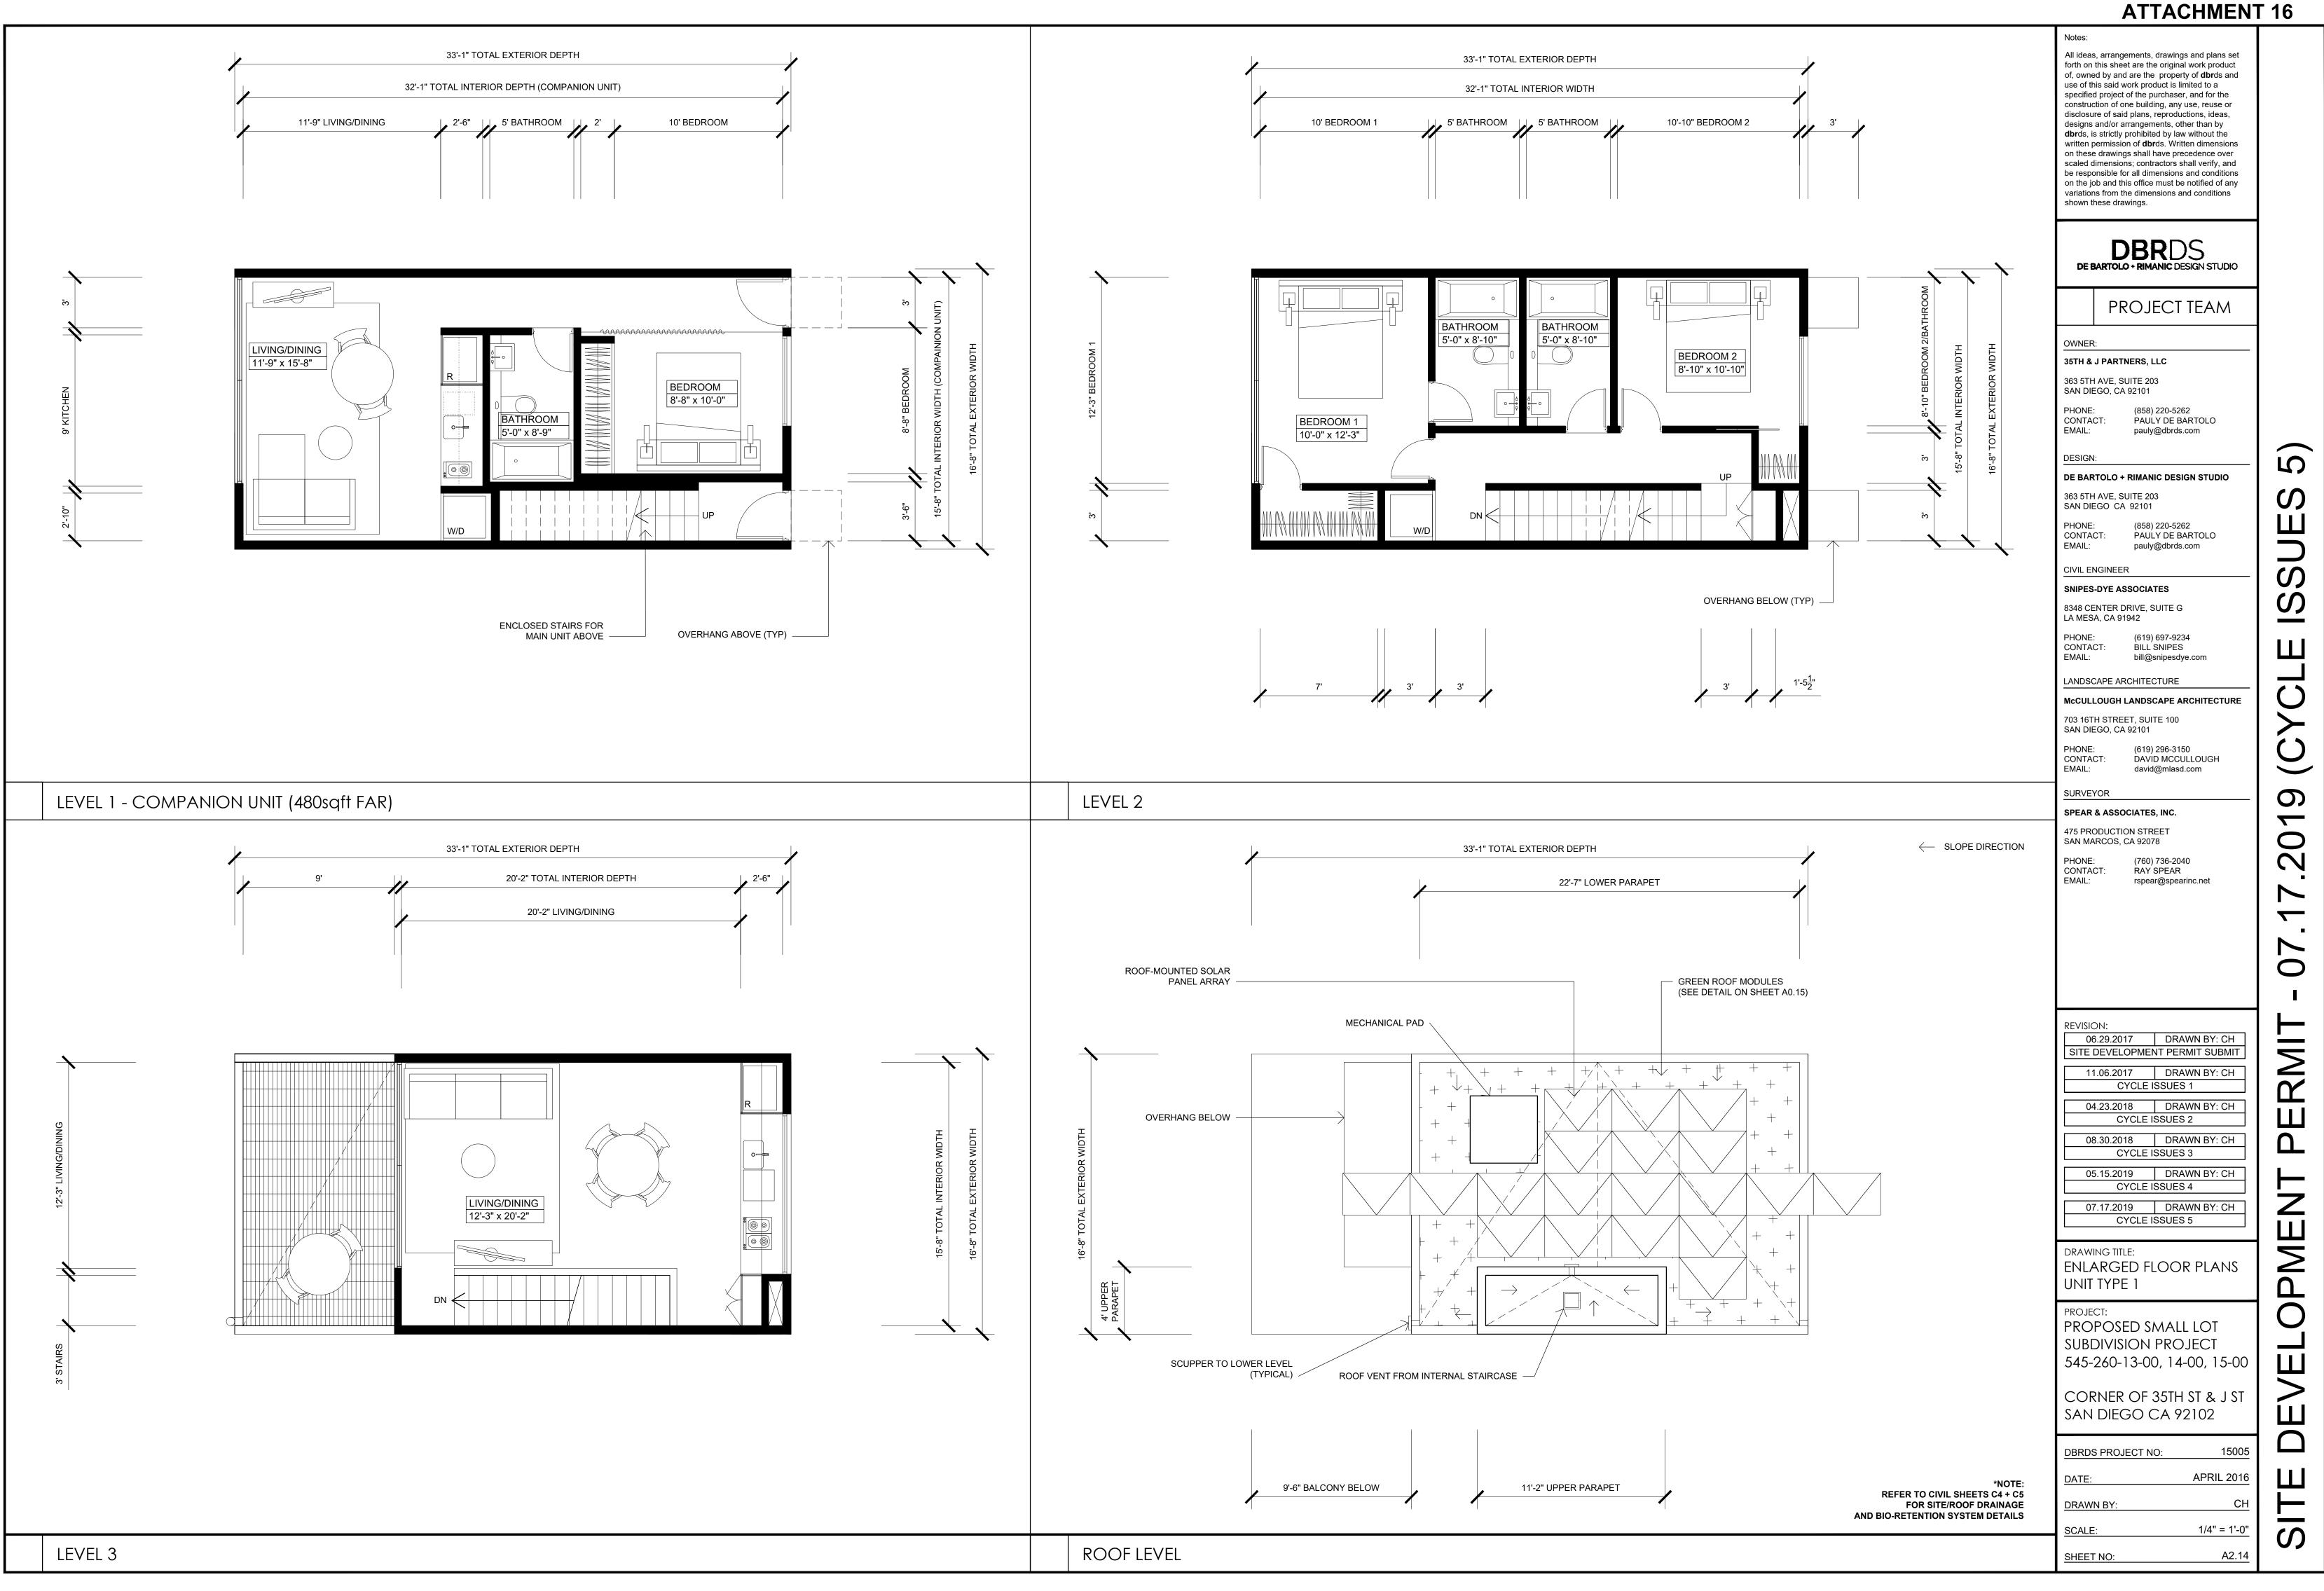


D **ACHMI** ENT


16




		ATTACHMEN	Г 16	-
10'-10" BEDROOM 2		Notes: All ideas, arrangements, drawings and plans set forth on this sheet are the original work product of, owned by and are the property of dbr ds and use of this said work product is limited to a specified project of the purchaser, and for the construction of one building, any use, reuse or disclosure of said plans, reproductions, ideas, designs and/or arrangements, other than by dbr ds, is strictly prohibited by law without the written permission of dbr ds. Written dimensions on these drawings shall have precedence over scaled dimensions; contractors shall verify, and be responsible for all dimensions and conditions on the job and this office must be notified of any variations from the dimensions and conditions shown these drawings.		
	MOC	DBRDS DE BARTOLO + RIMANIC DESIGN STUDIO		
BEDROOM 2	BEDROOM 2/BATHROOM IOR WIDTH RIOR WIDTH	PROJECT TEAM		
8'-10" x 10-10"	8'-10" BEDROOM 3 INTERIOR WIDTH EXTERIOR WIDTH	OWNER: 35TH & J PARTNERS, LLC		
	TOTAL EXTER	363 5TH AVE, SUITE 203 SAN DIEGO, CA 92101 PHONE: (858) 220-5262		
	3' 15'-8" 1 16'-8" T	CONTACT: PAULY DE BARTOLO EMAIL: pauly@dbrds.com	5)	
P W/D	õ	DE BARTOLO + RIMANIC DESIGN STUDIO 363 5TH AVE, SUITE 203 SAN DIEGO CA 92101	S S	
		PHONE: (858) 220-5262 CONTACT: PAULY DE BARTOLO EMAIL: pauly@dbrds.com	Ш	
		CIVIL ENGINEER SNIPES-DYE ASSOCIATES	SU	
		8348 CENTER DRIVE, SUITE G LA MESA, CA 91942 PHONE: (619) 697-9234	<u></u>	
		CONTACT: BILL SNIPES EMAIL: bill@snipesdye.com	Ш	
		McCULLOUGH LANDSCAPE ARCHITECTURE 703 16TH STREET, SUITE 100	X C	
		SAN DIEGO, CA 92101 PHONE: (619) 296-3150 CONTACT: DAVID MCCULLOUGH EMAIL: david@mlasd.com	\dot{O}	
		SURVEYOR SPEAR & ASSOCIATES, INC.	6	
		475 PRODUCTION STREET SAN MARCOS, CA 92078 PHONE: (760) 736-2040	50,	
		CONTACT: RAY SPEAR EMAIL: rspear@spearinc.net	2.7	
			7.1	
			0	
		REVISION: 06.29.2017 DRAWN BY: CH		
$ \xrightarrow{+} + + + + + + + + + + + + + + + + + + $		SITE DEVELOPMENT PERMIT SUBMIT	ERMIT	
		04.23.2018 DRAWN BY: CH CYCLE ISSUES 2		
		08.30.2018 DRAWN BY: CH CYCLE ISSUES 3 05.15.2019 DRAWN BY: CH		
		CYCLE ISSUES 4 07.17.2019 DRAWN BY: CH CYCLE ISSUES 5		
		DRAWING TITLE: ENLARGED FLOOR PLANS	Ш	
$\begin{array}{c c} + & + & + \\ + & + & + & + \\ + & + & + &$		UNIT TYPE 2	L L	
(SEE DETAIL ON ROOF-MOUNTED SOLAR		PROPOSED SMALL LOT SUBDIVISION PROJECT 545-260-13-00, 14-00, 15-00	VELO	A
E PANEL ARRAY		CORNER OF 35TH ST & J ST SAN DIEGO CA 92102	>	
		DBRDS PROJECT NO: 15005		ACHMENT
	*NOTE: C5 FOR SITE/ROOF DRAINAGE D-RETENTION SYSTEM DETAILS	DATE: APRIL 2016 DRAWN BY: CH	世	ENT
		SUFET NO: 02 15	IS	16
		SHEET NO: A2.15	<u> </u>	l

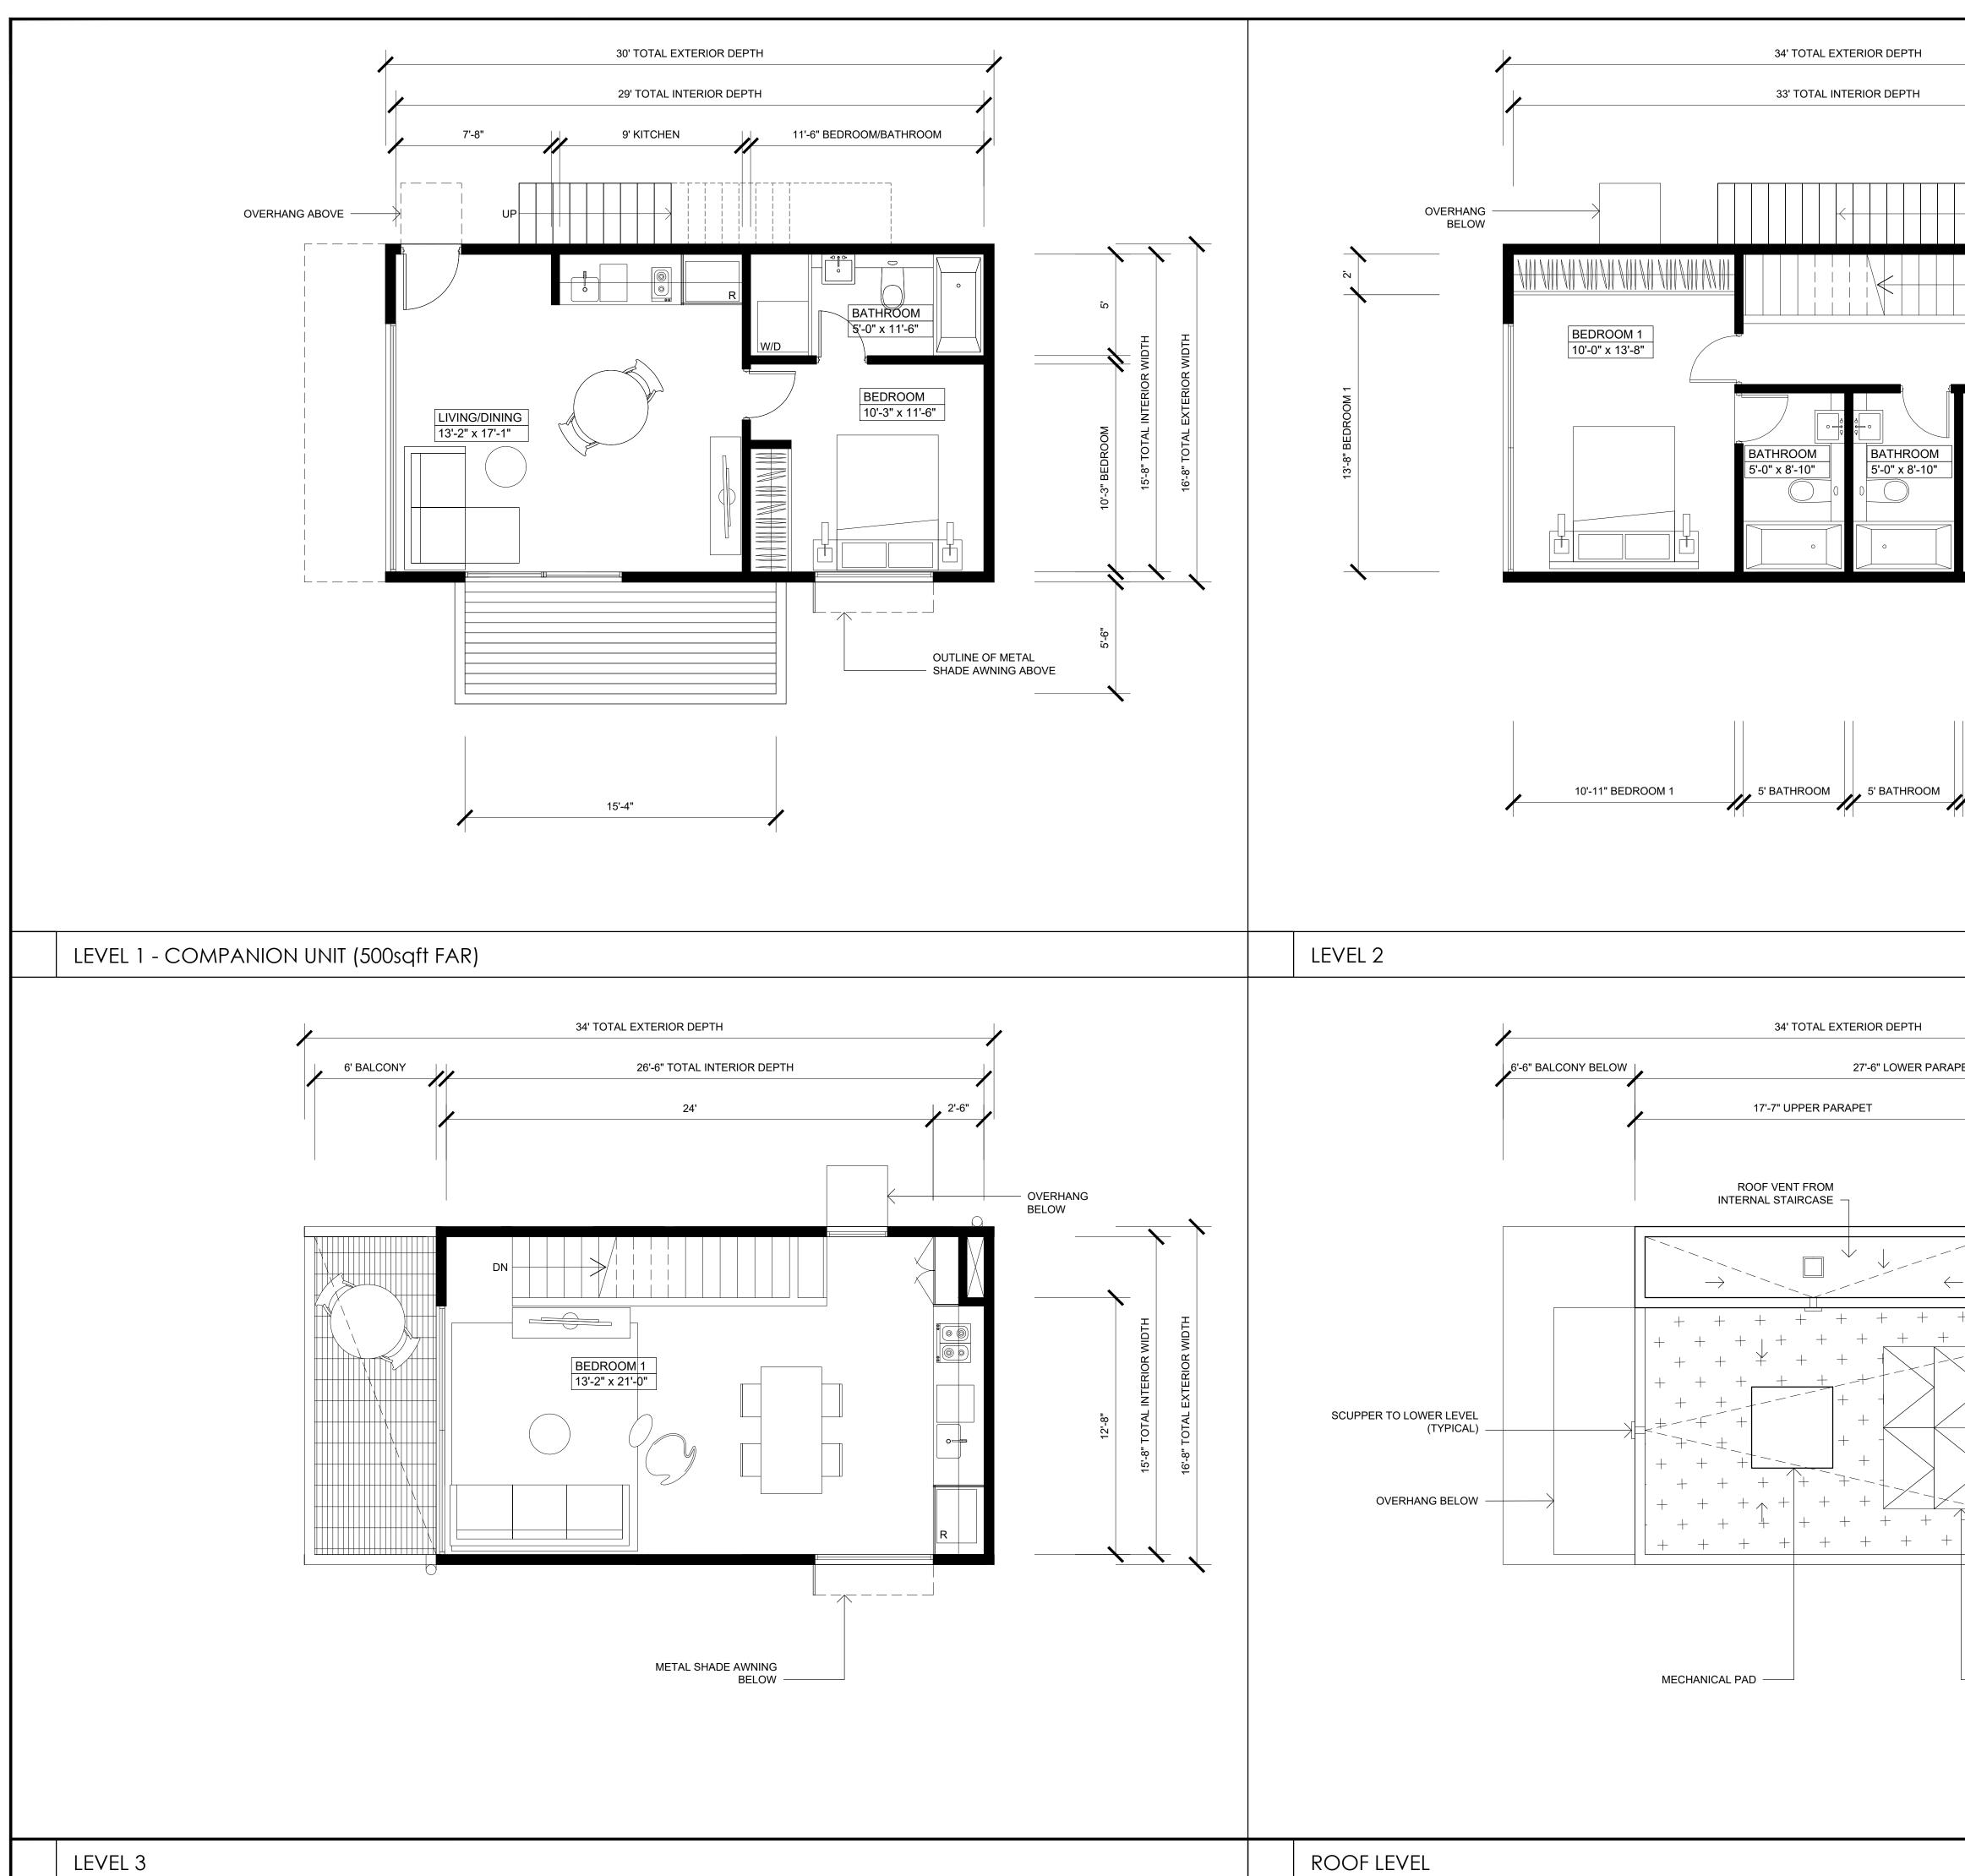

		<u> 16 </u>
DN OVERHANG ABOVE	Notes: All ideas, arrangements, drawings and plans set forth on this sheet are the original work product of, owned by and are the property of dbrds and use of this said work product is limited to a specified project of the purchaser, and for the construction of one building, any use, reuse or disclosure of said plans, reproductions, ideas, designs and/or arrangements, other than by dbrds, is strictly prohibited by law without the written permission of dbrds. Written dimensions on these drawings shall have precedence over scaled dimensions; contractors shall verify, and be responsible for all dimensions and conditions on the job and this office must be notified of any variations from the dimensions and conditions shown these drawings. DEBERES DEBERES DE BARTOLO + RIMANIC DESIGN STUDIO OWNER:	
OUTLINE OF METAL OUTLINE OF METAL SHADE AWNING ABOVE	DESIGN: DE BARTOLO + RIMANIC DESIGN STUDIO 363 5TH AVE, SUITE 203 SAN DIEGO CA 92101 PHONE: (858) 220-5262 CONTACT: PAULY DE BARTOLO EMAIL: PAULY DE BARTOLO ENIPES-DYE ASSOCIATES 8348 CENTER DRIVE, SUITE G S348 CENTER DRIVE, SUITE G AMESA, CA 91942 PHONE: (619) 697-9234 CONTACT: BILL SNIPES EMAIL: bill@snipesdye.com LANDSCAPE ARCHITECTURE MAIL: MCCULLOUGH LANDSCAPE ARCHITECTURE 703 16TH STREET, SUITE 100 AN DIEGO, CA 92101 PHONE: PHONE: (619) 296-3150 CONTACT: DAVID MCCULLOUGH EMAIL: david@mlasd.com SURVEYOR SURVEYOR	9 (CYCLE ISSUES 5)
$\leftarrow SLOPE DIRECTION$	SPEAR & ASSOCIATES, INC. 475 PRODUCTION STREET SAN MARCOS, CA 92078 PHONE: (760) 736-2040 CONTACT: RAY SPEAR EMAIL: rspear@spearinc.net MAIL: rspear@spearinc.net REVISION: 06.29.2017 DRAWN BY: CH SITE DEVELOPMENT PERMIT SUBMIT 11.06.2017 DRAWN BY: CH CYCLE ISSUES 1 04.23.2018 DRAWN BY: CH CYCLE ISSUES 2	ERMIT - 07.17.2019
GREEN ROOF MODULES (SEE DETAIL ON SHEET A0.15)	CYCLE ISSUES 208.30.2018DRAWN BY: CHCYCLE ISSUES 305.15.2019DRAWN BY: CHCYCLE ISSUES 407.17.2019DRAWN BY: CHCYCLE ISSUES 5DRAWING TITLE:ENLARGED FLOOR PLANSUNIT TYPE 3PROJECT:PROPOSED SMALL LOTSUBDIVISION PROJECT545-260-13-00, 14-00, 15-00CORNER OF 35TH ST & J STSAN DIEGO CA 92102	VELOPMENT P
*NOTE: REFER TO CIVIL SHEETS C4 + C5 FOR SITE/ROOF DRAINAGE AND BIO-RETENTION SYSTEM DETAILS	DBRDS PROJECT NO: 15005 DATE: APRIL 2016 DRAWN BY: CH SCALE: 1/4" = 1'-0" SHEET NO: A2.16	ACHMENT 16

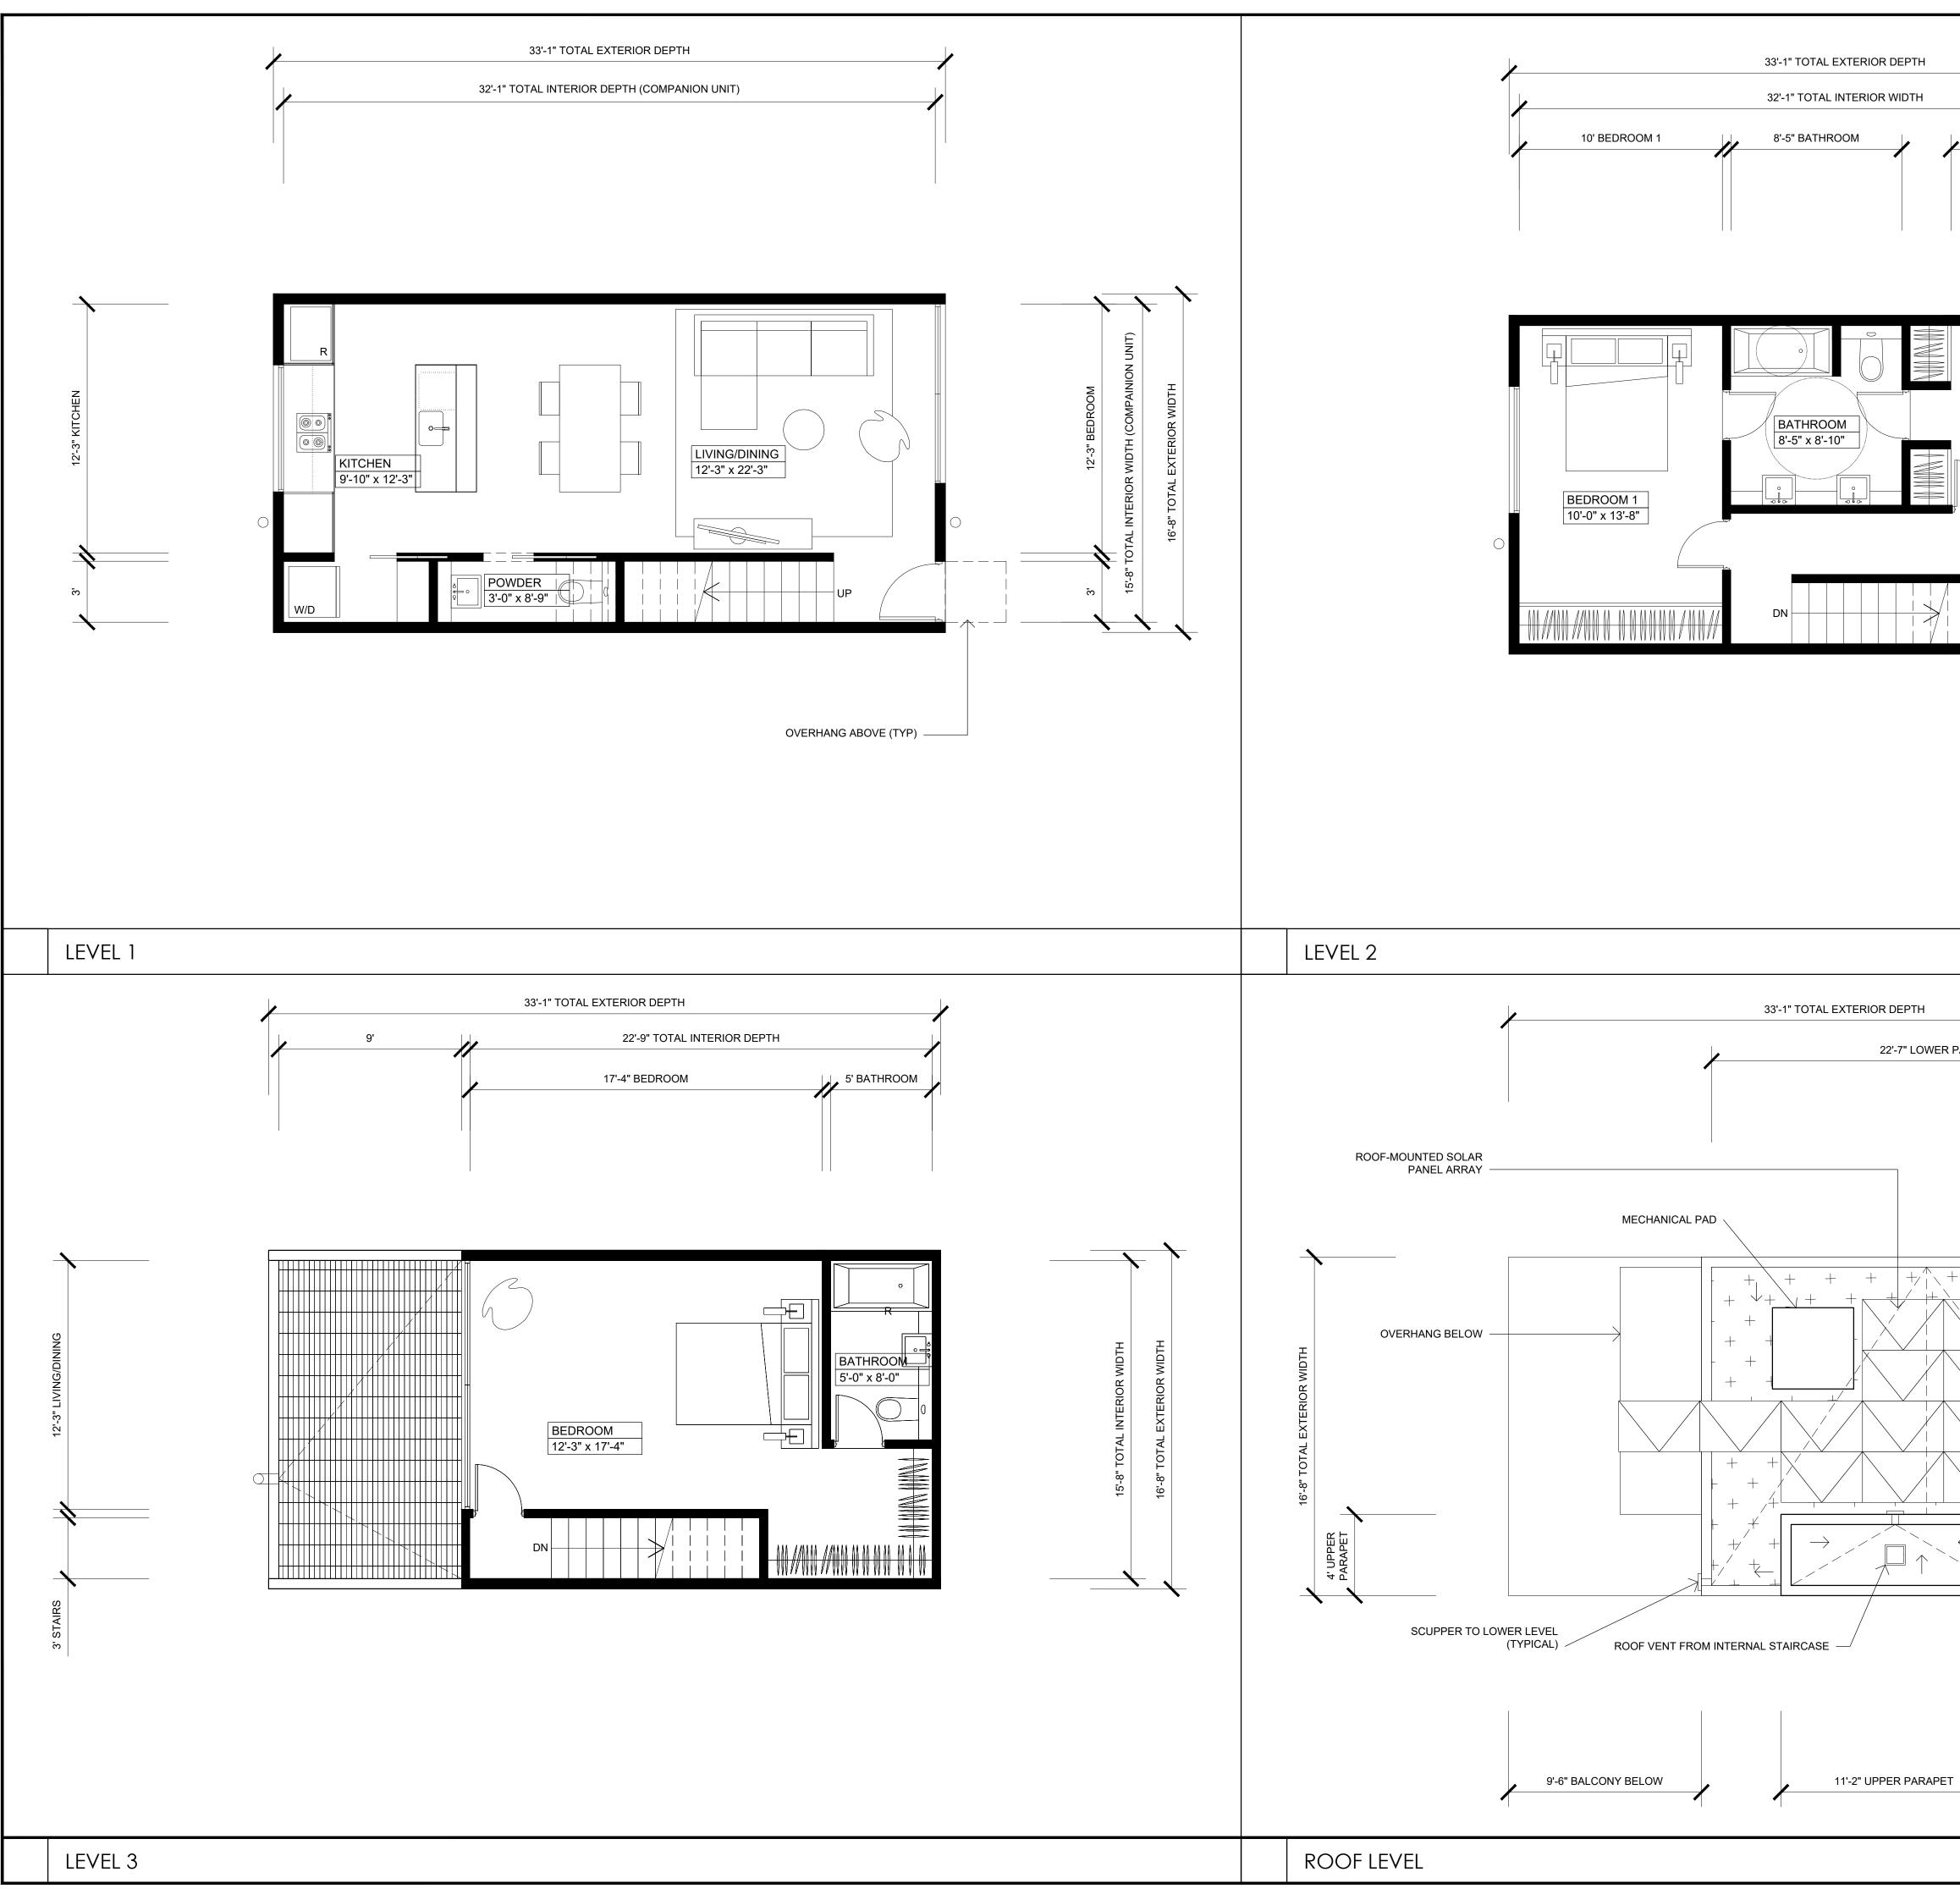

GREEN ROOF MODULES (SEE DETAIL ON SHEET A0.15)			⁻ 16	-
Image: construction in the second	10'-10" BEDROOM 2	All ideas, arrangements, drawings and plans set forth on this sheet are the original work product of, owned by and are the property of dbr ds and use of this said work product is limited to a specified project of the purchaser, and for the construction of one building, any use, reuse or disclosure of said plans, reproductions, ideas, designs and/or arrangements, other than by dbr ds, is strictly prohibited by law without the written permission of dbr ds. Written dimensions on these drawings shall have precedence over scaled dimensions; contractors shall verify, and be responsible for all dimensions and conditions on the job and this office must be notified of any variations from the dimensions and conditions		
Image: State in the state				
Image: State in the state	THROOM	PROJECT TEAM		
CRIVES DELON: (1/2)		35TH & J PARTNERS, LLC 363 5TH AVE, SUITE 203 SAN DIEGO, CA 92101 PHONE: (858) 220-5262 CONTACT: PAULY DE BARTOLO EMAIL: pauly@dbrds.com DESIGN: DE BARTOLO + RIMANIC DESIGN STUDIO		
PROPERTY TOOL MODULED C SLOPE DIRECTION MARKET SCARE MARKET SCARE PROPERTY TOOL MODULED C SLOPE DIRECTION MARKET SCARE MARKET SCARE PROPERTY TOOL MODULED C SLOPE DIRECTION MARKET SCARE MARKET SCARE PROPERTY TOOL MODULED C SLOPE DIRECTION MARKET SCARE MARKET SCARE PROPERTY TOOL MODULED C SLOPE DIRECTION MARKET SCARE MARKET SCARE PROPERTY TOOL MODULED C SLOPE DIRECTION MARKET SCARE MARKET SCARE PROPERTY TOOL MODULED C SLOPE DIRECTION MARKET SCARE MARKET SCARE PROPERTY TOOL MODULED C SLOPE DIRECTION MARKET SCARE MARKET SCARE PROPERTY TOOL MODULED C SLOPE DIRECTION MARKET SCARE MARKET SCARE PROPERTY TO TOOL MODULED C SLOPE DIRECTION TIPE MARKET SCARE MARKET SCARE PROPERTY TO TOOL MODULED C SLOPE TO TOOL MARKET SCARE MARKET SCARE MARKET SCARE PROPERTY TO TOOL MODULED C SLOPE TO TOOL MARKET SCARE MARKET SCARE MARKET SCARE PROPERTY TO TOOL MODULED C SLOPE TO TOOL MARKET SCARE MARKET SCARE MARKET SCARE PROPERTY TO TOOL MARKET SCARE MARKET SCARE MARKET SCAR	UP m	SAN DIEGO CA 92101 PHONE: (858) 220-5262 CONTACT: PAULY DE BARTOLO	Ш	
ATTACHMENT IS AND BID ARTERING STEMPTERS AND BID ARTERINGS STEMPTERS AND BID ARTERINGS STEMPTERS AND BID ARTERINGS STEMPTERS AND BID ARTERINGS STEMPTERS AND BID ARTERNING STEMPTERS	OVERHANG BELOW (TYP)	CIVIL ENGINEER SNIPES-DYE ASSOCIATES 8348 CENTER DRIVE, SUITE G LA MESA, CA 91942 PHONE: (619) 697-9234 CONTACT: BILL SNIPES EMAIL: bill@snipesdye.com	Ш	
CORRECT: BOUTSCALLOT SINGLAND TO THE STREAM OF THE STREAM		703 16TH STREET, SUITE 100	ХC	
SPEAR & A&BOOLTES, NC. THE TRODUCTION STREET SHORE THE CONTROL ACADOR PARAMET GREEN ROOF MODULES SET DETAIL ON SHEET AS 15) THE THE VELOWERST DETAILS GREEN ROOF MODULES SET DETAIL ON SHEET AS 15) THE VELOWERST DETAIL OF THE VELOWERST DETAILS THE VELOWERST DETAIL OF THE VELOWERST DETAILS THE VELOWERST DETAILS T		CONTACT: DAVID MCCULLOUGH EMAIL: david@mlasd.com	0)	
SEE DETAIL ON SHEET AO 15)	PARAPET	SPEAR & ASSOCIATES, INC.475 PRODUCTION STREET SAN MARCOS, CA 92078PHONE:(760) 736-2040 CONTACT:RAY SPEAR		
Image: construction of the system of the			- 07	
Image: Construction of the system details Image: Consthe system details Image: Construction of the syste		06.29.2017DRAWN BY: CHSITE DEVELOPMENT PERMIT SUBMIT11.06.2017DRAWN BY: CH	ZMIT.	
NOTE: REFER TO CIVIL SHEETS C4+C5 FOR SITE/ROOF DRAINAGE AND BIO-RETENTION SYSTEM DETAILS NOTE: REFER TO CIVIL SHEETS C4+C5 FOR SITE/ROOF DRAINAGE AND BIO-RETENTION SYSTEM DETAILS NOTE: REFER TO CIVIL SHEETS C4+C5 FOR SITE/ROOF DRAINAGE AND BIO-RETENTION SYSTEM DETAILS NOTE: NOTE: PROPOSED SMALL LOT SUBDIVISION PROJECT S45-260-13-00, 14-00, 15-00 CORNER OF 35TH ST & J ST SAN DIEGO CA 92102 DBRDS PROJECT NO: 15005 DATE: APRIL 2016 DRAWIN BY: CH SCALE: 1/4" = 1'-0"		CYCLE ISSUES 208.30.2018DRAWN BY: CHCYCLE ISSUES 305.15.2019DRAWN BY: CHCYCLE ISSUES 4	L L	
PROPOSED SMALL LOT SUBDIVISION PROJECT 545-260-13-00, 14-00, 15-00 CORNER OF 35TH ST & J ST SAN DIEGO CA 92102 DBRDS PROJECT NO: 15005 DATE: APRIL 2016 DRAWN BY: CH SCALE: 1/4" = 1'-0"		CYCLE ISSUES 5 DRAWING TITLE: ENLARGED FLOOR PLANS	5	
*NOTE: REFER TO CIVIL SHEETS C4 + C5 FOR SITE/ROOF DRAINAGE AND BIO-RETENTION SYSTEM DETAILS SAN DIEGO CA 92102 DBRDS PROJECT NO: 15005 DATE: APRIL 2016 DRAWN BY: CH SCALE: 1/4" = 1'-0"		PROPOSED SMALL LOT SUBDIVISION PROJECT 545-260-13-00, 14-00, 15-00	VELO	
AND BIO-RETENTION SYSTEM DETAILS SCALE: 1/4" = 1'-0"		SAN DIEGO CA 92102	Ш	TACH
	REFER TO CIVIL SHEETS C4 + C5 FOR SITE/ROOF DRAINAGE	DATE: APRIL 2016 DRAWN BY: CH	E	_
			U	

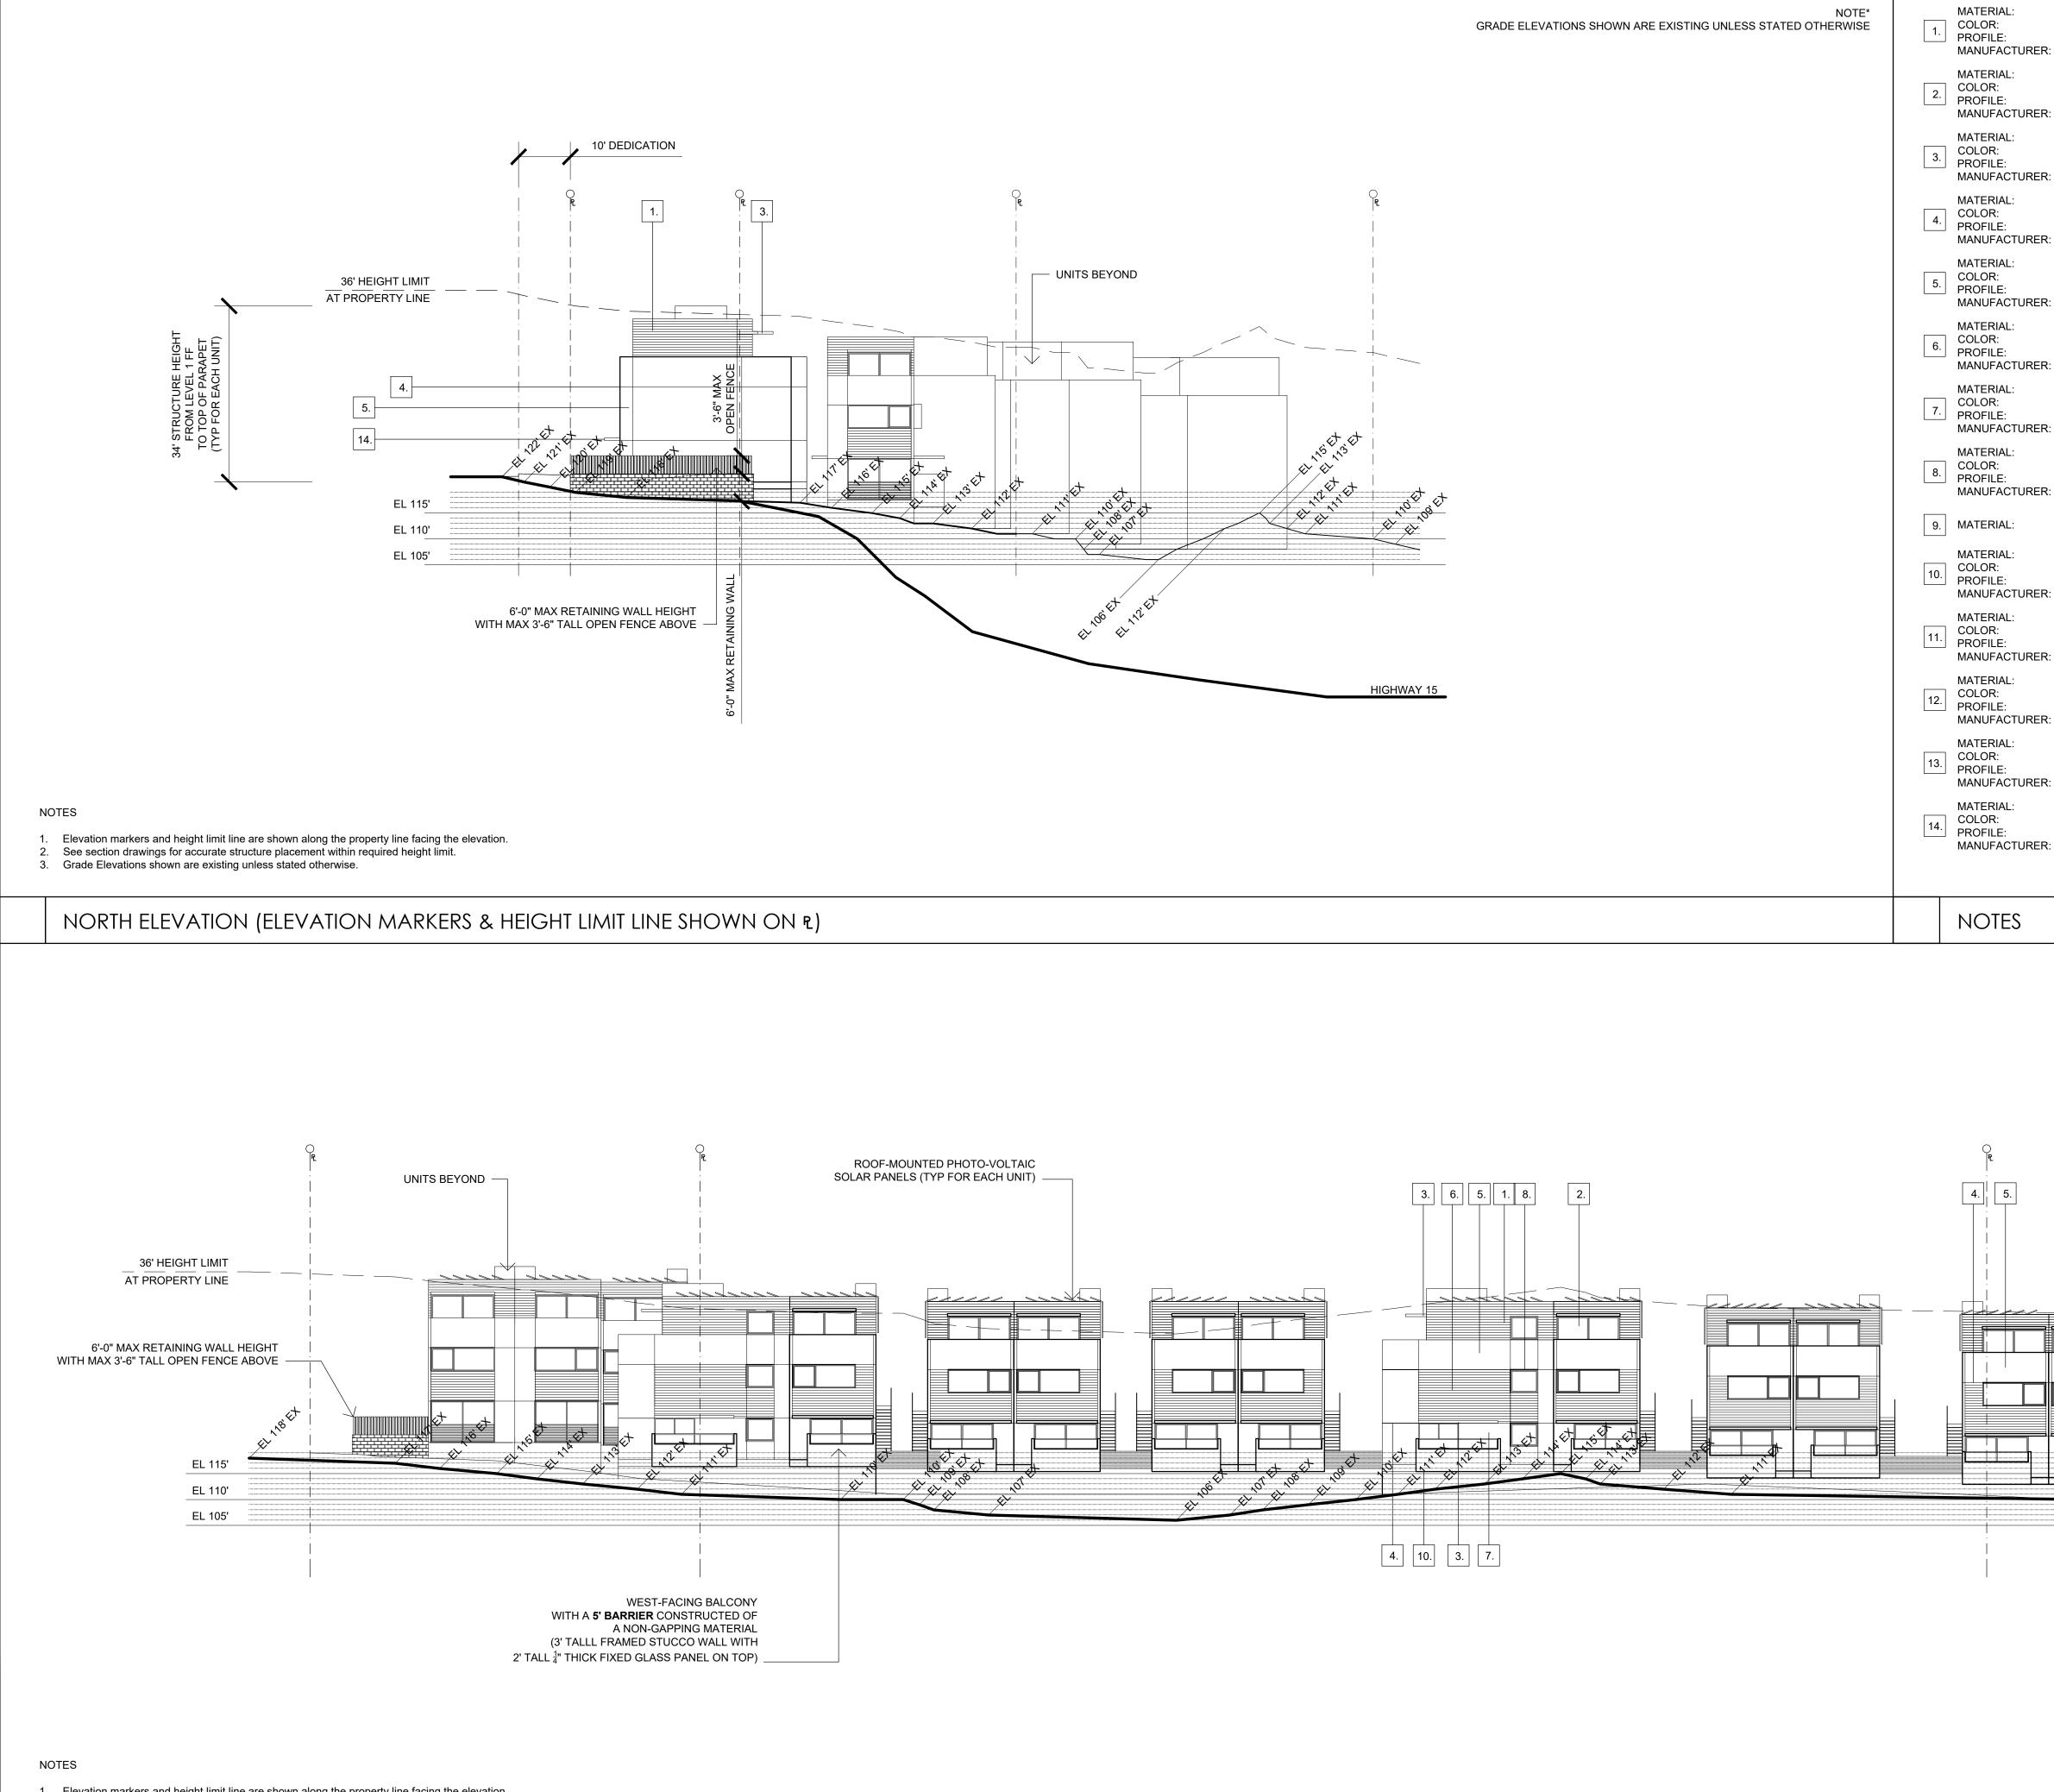

Elevation markers and height limit line are shown along the property line facing the elevation.
 See section drawings for accurate structure placement within required height limit.

See section drawings for accurate structure placement within requir
 Grade Elevations shown are existing unless stated otherwise.

Notes: WOOD SLAT SIDING BLUE All ideas, arrangements, drawings and plans set forth on this sheet are the original work product of, owned by and are the property of **dbr**ds and use of this said work product is limited to a NATURAL ANODIZED ALUMINUM FRAMED OPERABLE GLAZING & DOORS specified project of the purchaser, and for the GRAY construction of one building, any use, reuse or disclosure of said plans, reproductions, ideas, designs and/or arrangements, other than by dbrds, is strictly prohibited by law without the METAL AWNING written permission of **dbr**ds. Written dimensions on these drawings shall have precedence over GRAY scaled dimensions; contractors shall verify, and be responsible for all dimensions and conditions on the job and this office must be notified of any variations from the dimensions and conditions STUCCO SCORE LINES shown these drawings. 1/2"x1/2" **DBR**DS STUCCO WHITE DE BARTOLO + RIMANIC DESIGN STUDIO SMOOTH SANTA BARBARA FINISH WOOD SLAT SIDING **PROJECT TEAM** GRAY OWNER: STUCCO CHARCOAL 35TH & J PARTNERS, LLC SMOOTH SANTA BARBARA FINISH 363 5TH AVE, SUITE 203 SAN DIEGO, CA 92101 METAL SUN SHIELD BLUE PHONE: (858) 220-5262 PAULY DE BARTOLO CONTACT: EMAIL: pauly@dbrds.com DESIGN: NOT USED DE BARTOLO + RIMANIC DESIGN STUDIO BALCONY - STUCCO FINISH WHITE 363 5TH AVE, SUITE 203 SMOOTH SANTA BARBARA FINISH SAN DIEGO CA 92101 PHONE: (858) 220-5262 WOOD SLAT SIDING CONTACT: PAULY DE BARTOLO BROWN EMAIL: pauly@dbrds.com CIVIL ENGINEER STUCCO SNIPES-DYE ASSOCIATES GRAY SMOOTH SANTA BARBARA FINISH 8348 CENTER DRIVE, SUITE G LA MESA, CA 91942 WOOD SLAT SIDING PHONE: (619) 697-9234 CHARCOAL CONTACT: BILL SNIPES EMAIL: bill@snipesdye.com ANDSCAPE ARCHITECTURE METAL AWNING CHARCOAL McCULLOUGH LANDSCAPE ARCHITECTURE 703 16TH STREET, SUITE 100 SAN DIEGO, CA 92101 PHONE: (619) 296-3150 CONTACT: DAVID MCCULLOUGH EMAIL: david@mlasd.com SURVEYOR SPEAR & ASSOCIATES, INC. 475 PRODUCTION STREET SAN MARCOS, CA 92078 PHONE: (760) 736-2040 CONTACT: RAY SPEAR EMAIL: rspear@spearinc.net 2. 3. 11. revision: 06.29.2017 DRAWN BY: CH SITE DEVELOPMENT PERMIT SUBMIT 11.06.2017 DRAWN BY: CH CYCLE ISSUES 1 04.23.2018 DRAWN BY: CH CYCLE ISSUES 2 12. 08.30.2018 DRAWN BY: CH LEVEL OF PA CYCLE ISSUES 3 05.15.2019 DRAWN BY: CH TOP **CYCLE ISSUES 4** 07.17.2019 DRAWN BY: CH CYCLE ISSUES 5 DRAWING TITLE: ELEVATIONS 13. 10. PROJECT: PROPOSED SMALL LOT SUBDIVISION PROJECT 545-260-13-00, 14-00, 15-00 CORNER OF 35TH ST & J ST SAN DIEGO CA 92102 15005 DBRDS PROJECT NO: APRIL 2016 DATE: DRAWN BY:

S S Ш S S 0 $\overline{}$ O N $\overline{}$ \mathbf{O} $\overline{}$ \sim Ω Ш $\mathbf{<}$ \leq C Ш СН S

ATTACHMENT 16


TTACHMENT 16

1/16" = 1'-0"

A3.00

SCALE:

SHEET NO:

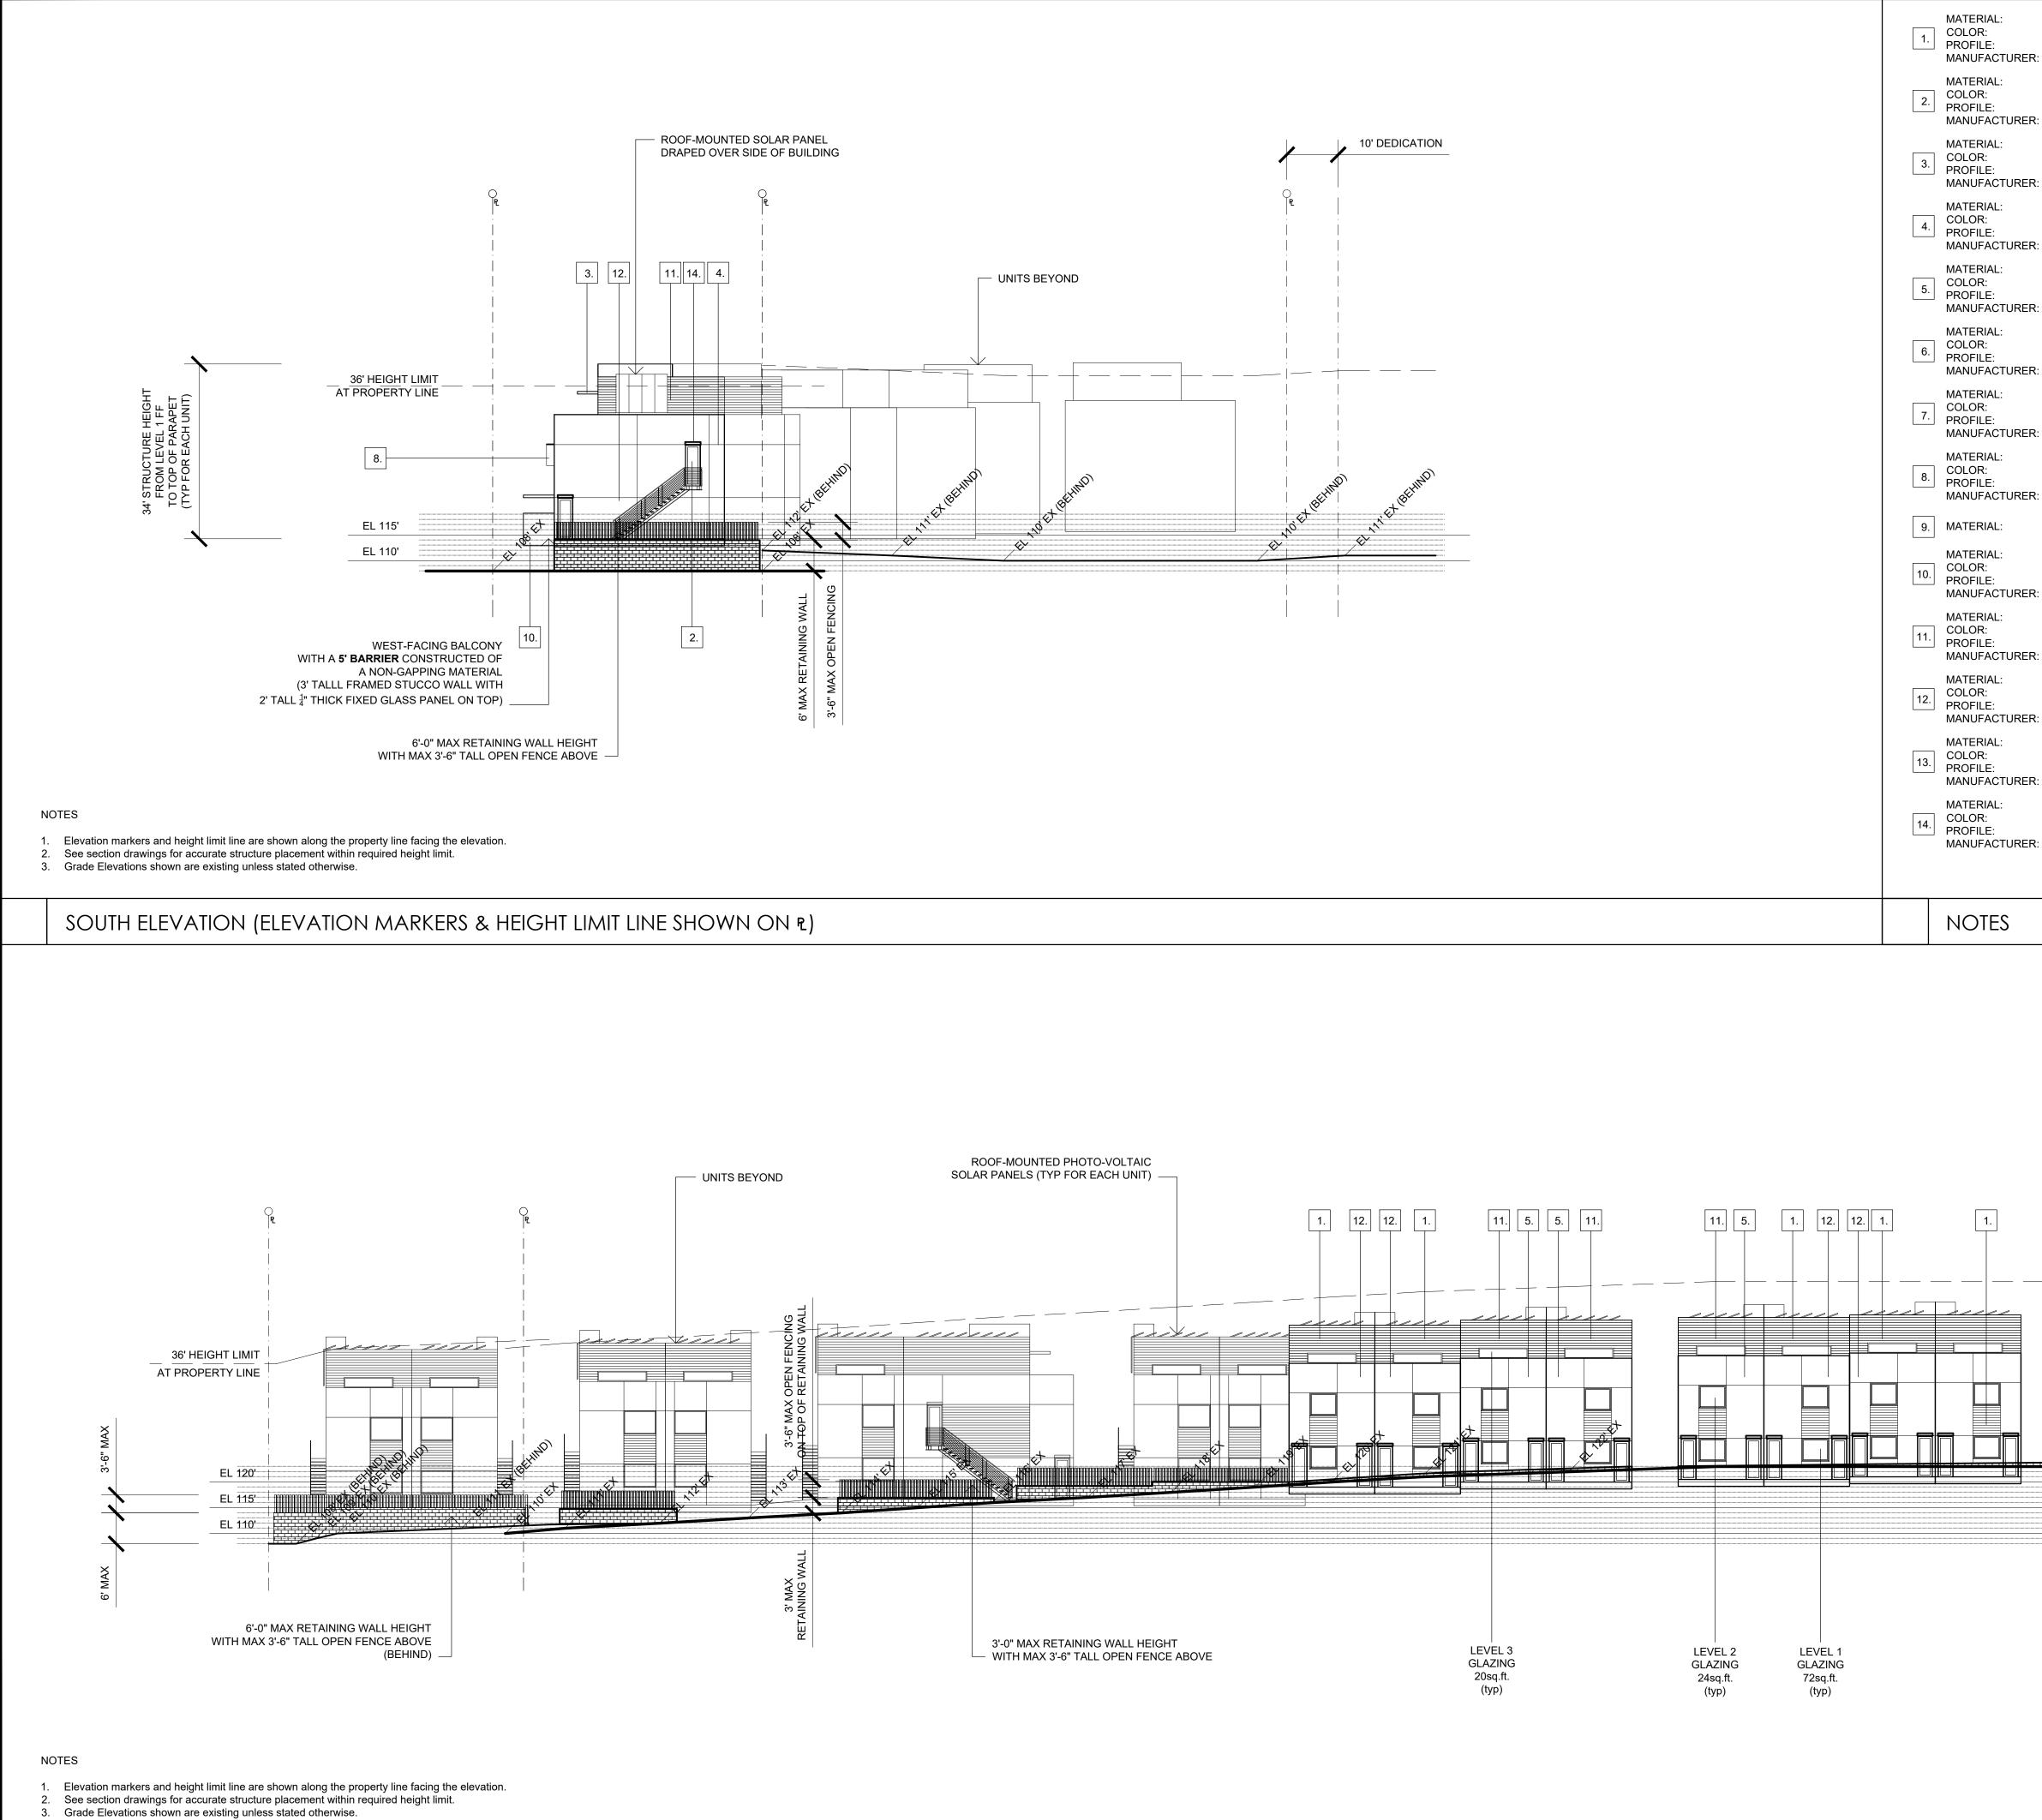

WOOD SLAT SIDING BLUE	Notes: All ideas, arrangements, drawings and plans set forth on this sheet are the original work product
NATURAL ANODIZED ALUMINUM FRAMED OPERABLE GLAZING & DOORS GRAY	of, owned by and are the property of dbr ds and use of this said work product is limited to a specified project of the purchaser, and for the construction of one building, any use, reuse or disclosure of said plans, reproductions, ideas, designs and/or arrangements, other than by
METAL AWNING GRAY	dbr ds, is strictly prohibited by law without the written permission of dbr ds. Written dimensions on these drawings shall have precedence over scaled dimensions; contractors shall verify, and be responsible for all dimensions and conditions
STUCCO SCORE LINES 1/2"x1/2"	on the job and this office must be notified of any variations from the dimensions and conditions shown these drawings.
STUCCO WHITE SMOOTH SANTA BARBARA FINISH	DBRDS DE BARTOLO + RIMANIC DESIGN STUDIO
WOOD SLAT SIDING GRAY	PROJECT TEAM
STUCCO	OWNER:
CHARCOAL SMOOTH SANTA BARBARA FINISH	35TH & J PARTNERS, LLC 363 5TH AVE, SUITE 203
METAL SUN SHIELD BLUE	SAN DIEGO, CA 92101 PHONE: (858) 220-5262 CONTACT: PAULY DE BARTOLO EMAIL: pauly@dbrds.com
NOT USED	DESIGN:
BALCONY - STUCCO FINISH	DE BARTOLO + RIMANIC DESIGN STUDIO
WHITE SMOOTH SANTA BARBARA FINISH	363 5TH AVE, SUITE 203 SAN DIEGO CA 92101
WOOD SLAT SIDING BROWN	PHONE:(858) 220-5262CONTACT:PAULY DE BARTOLOEMAIL:pauly@dbrds.com
STUCCO GRAY	CIVIL ENGINEER SNIPES-DYE ASSOCIATES
SMOOTH SANTA BARBARA FINISH	8348 CENTER DRIVE, SUITE G LA MESA, CA 91942
WOOD SLAT SIDING CHARCOAL	PHONE: (619) 697-9234 CONTACT: BILL SNIPES EMAIL: bill@snipesdye.com
METAL AWNING CHARCOAL	LANDSCAPE ARCHITECTURE
	McCULLOUGH LANDSCAPE ARCHITECTURE 703 16TH STREET, SUITE 100
	SAN DIEGO, CA 92101 PHONE: (619) 296-3150
	CONTACT: DAVID MCCULLOUGH EMAIL: david@mlasd.com
	SURVEYOR SPEAR & ASSOCIATES, INC.
	475 PRODUCTION STREET SAN MARCOS, CA 92078
	PHONE: (760) 736-2040 CONTACT: RAY SPEAR
	EMAIL: rspear@spearinc.net
	REVISION:
	06.29.2017 DRAWN BY: CH SITE DEVELOPMENT PERMIT SUBMIT
	11.06.2017 DRAWN BY: CH CYCLE ISSUES 1
	04.23.2018 DRAWN BY: CH
	CYCLE ISSUES 2 08.30.2018 DRAWN BY: CH
EVEL H EACH	CYCLE ISSUES 3
34' STRUCTURE HEIGHT FROM LEVEL 1 FF TO TOP OF PARAPET (TYP FOR EACH UNIT)	05.15.2019 DRAWN BY: CH CYCLE ISSUES 4
	07.17.2019 DRAWN BY: CH CYCLE ISSUES 5
	DRAWING TITLE: ELEVATIONS
	PROJECT: PROPOSED SMALL LOT SUBDIVISION PROJECT 545-260-13-00, 14-00, 15-00
	CORNER OF 35TH ST & J ST SAN DIEGO CA 92102
	DBRDS PROJECT NO: 15005
	DATE: APRIL 2016

ACHMEN

Τ

16

СН

1/16" = 1'-0"

A3.01


DRAWN BY:


SHEET NO:

SCALE:

ATTACHMENT 16


MANUFACTURER: MANUFACTURER: MANUFACTURER:

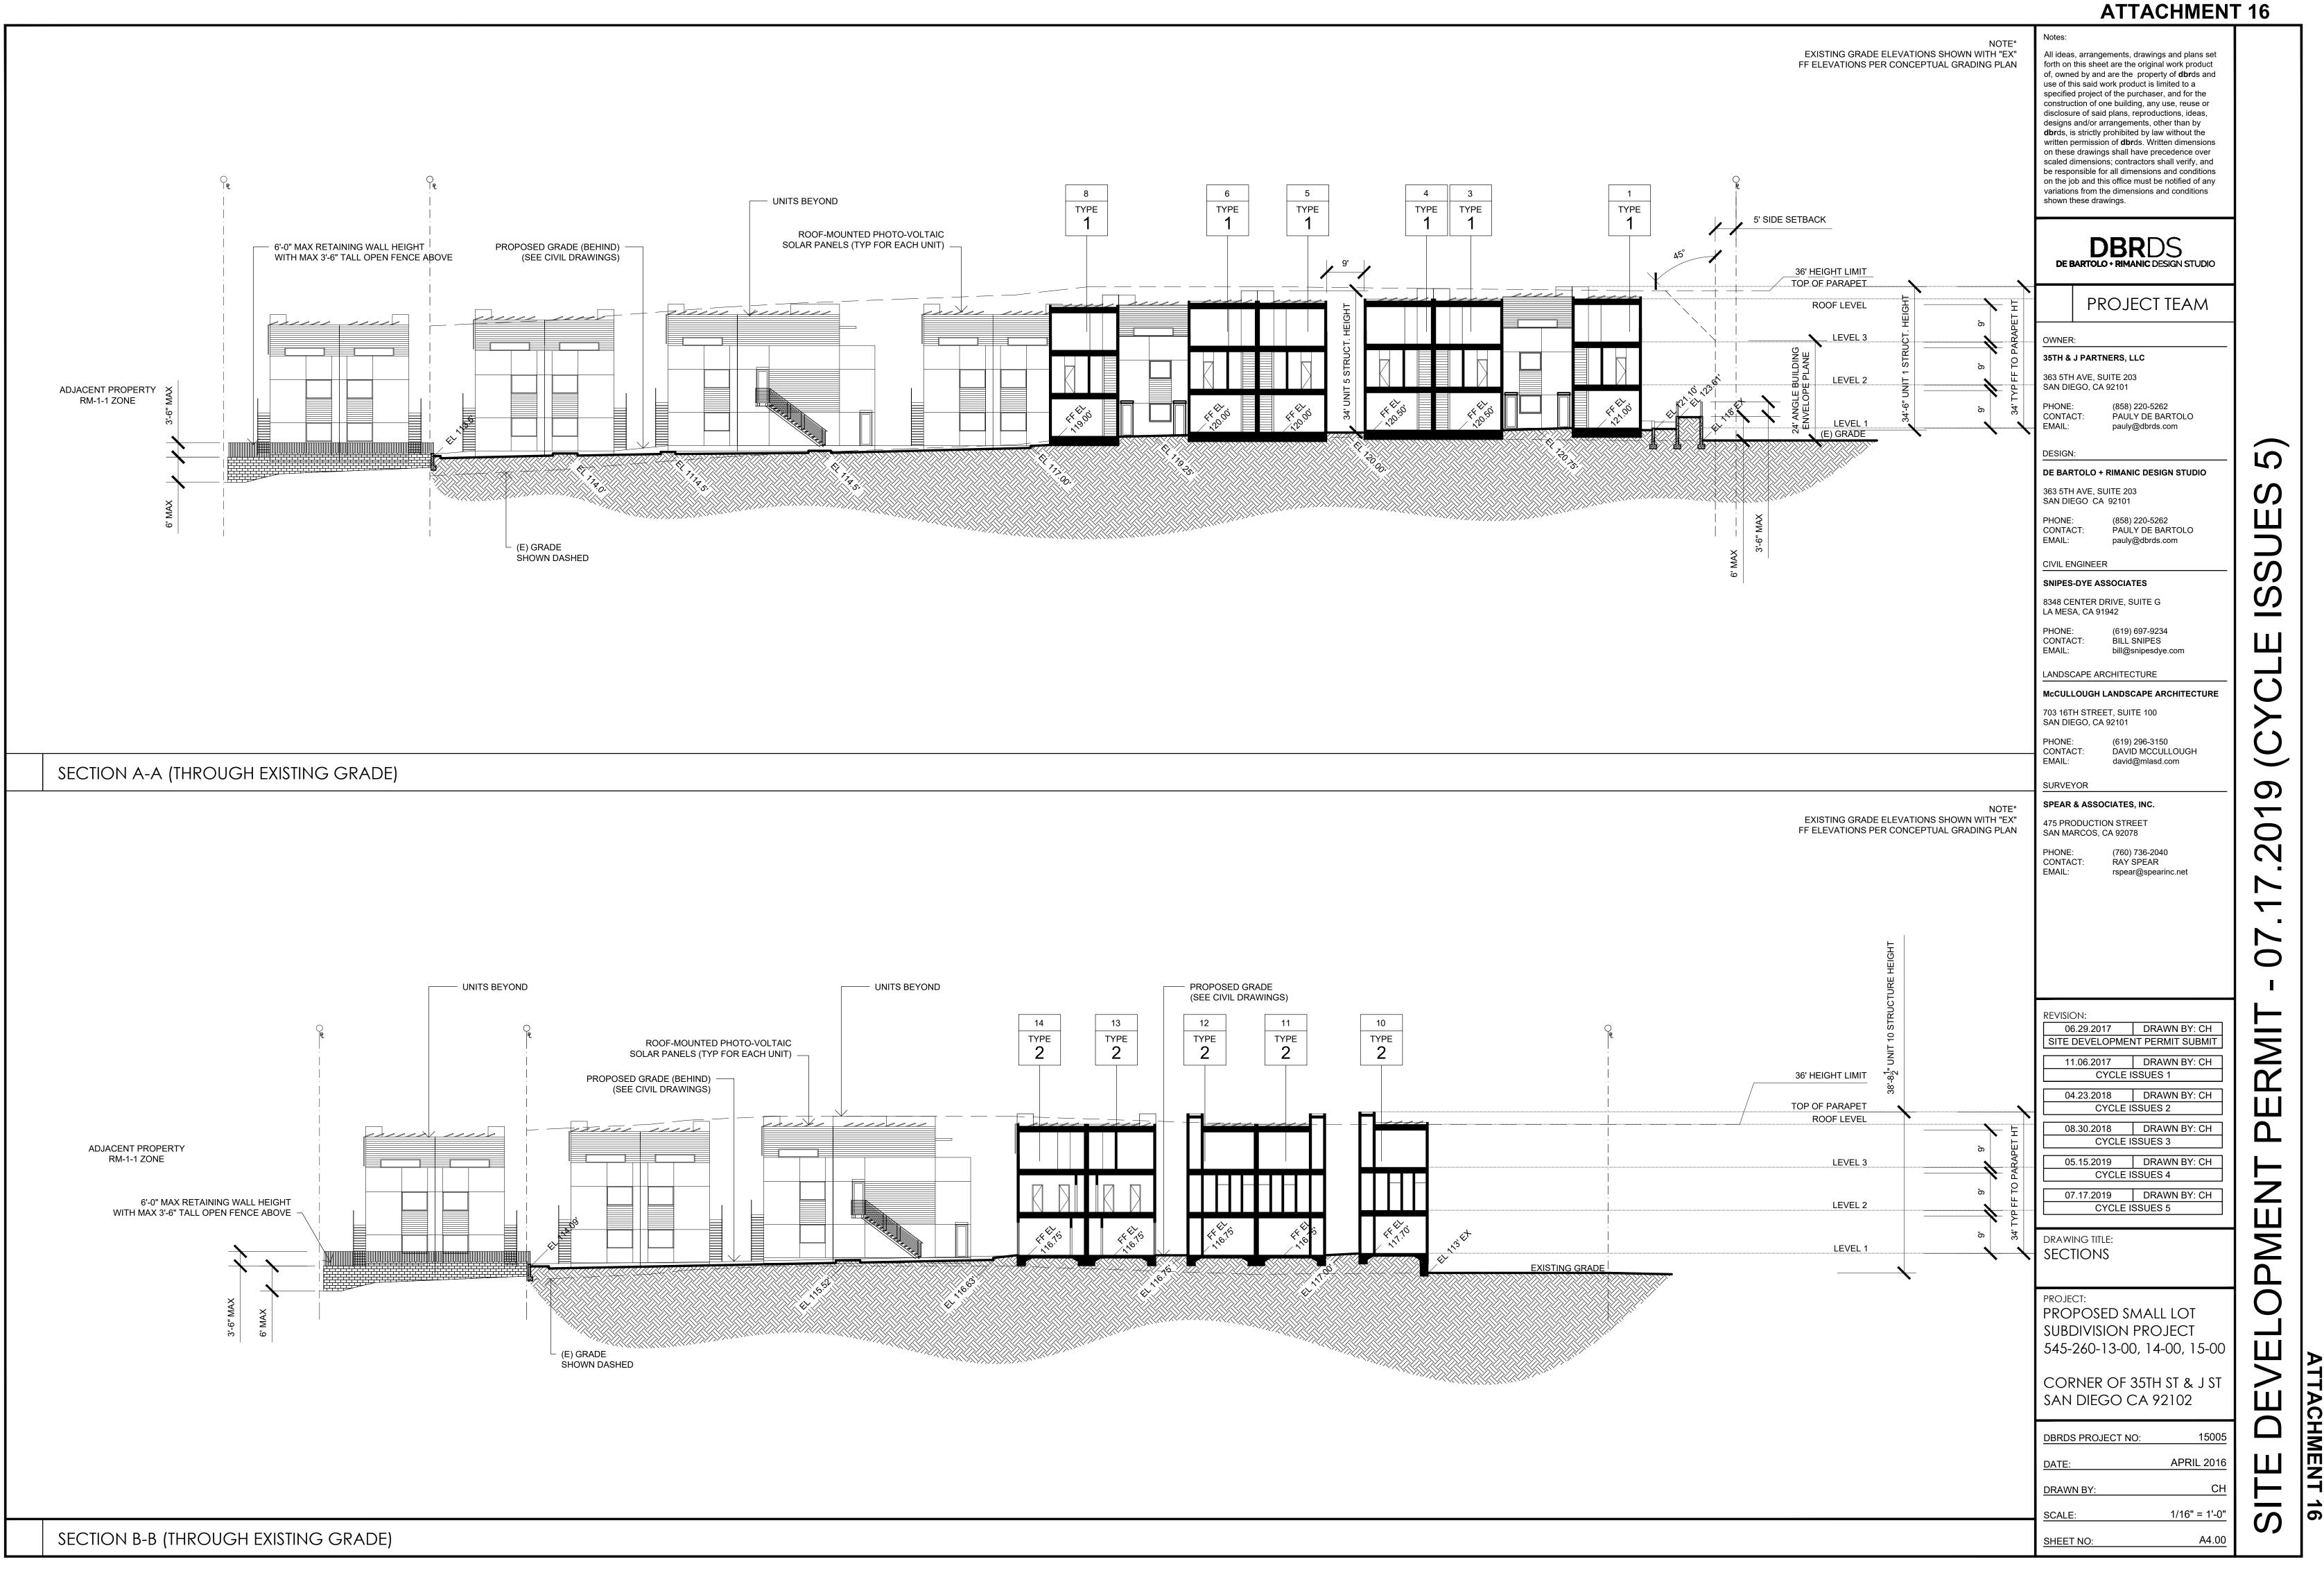


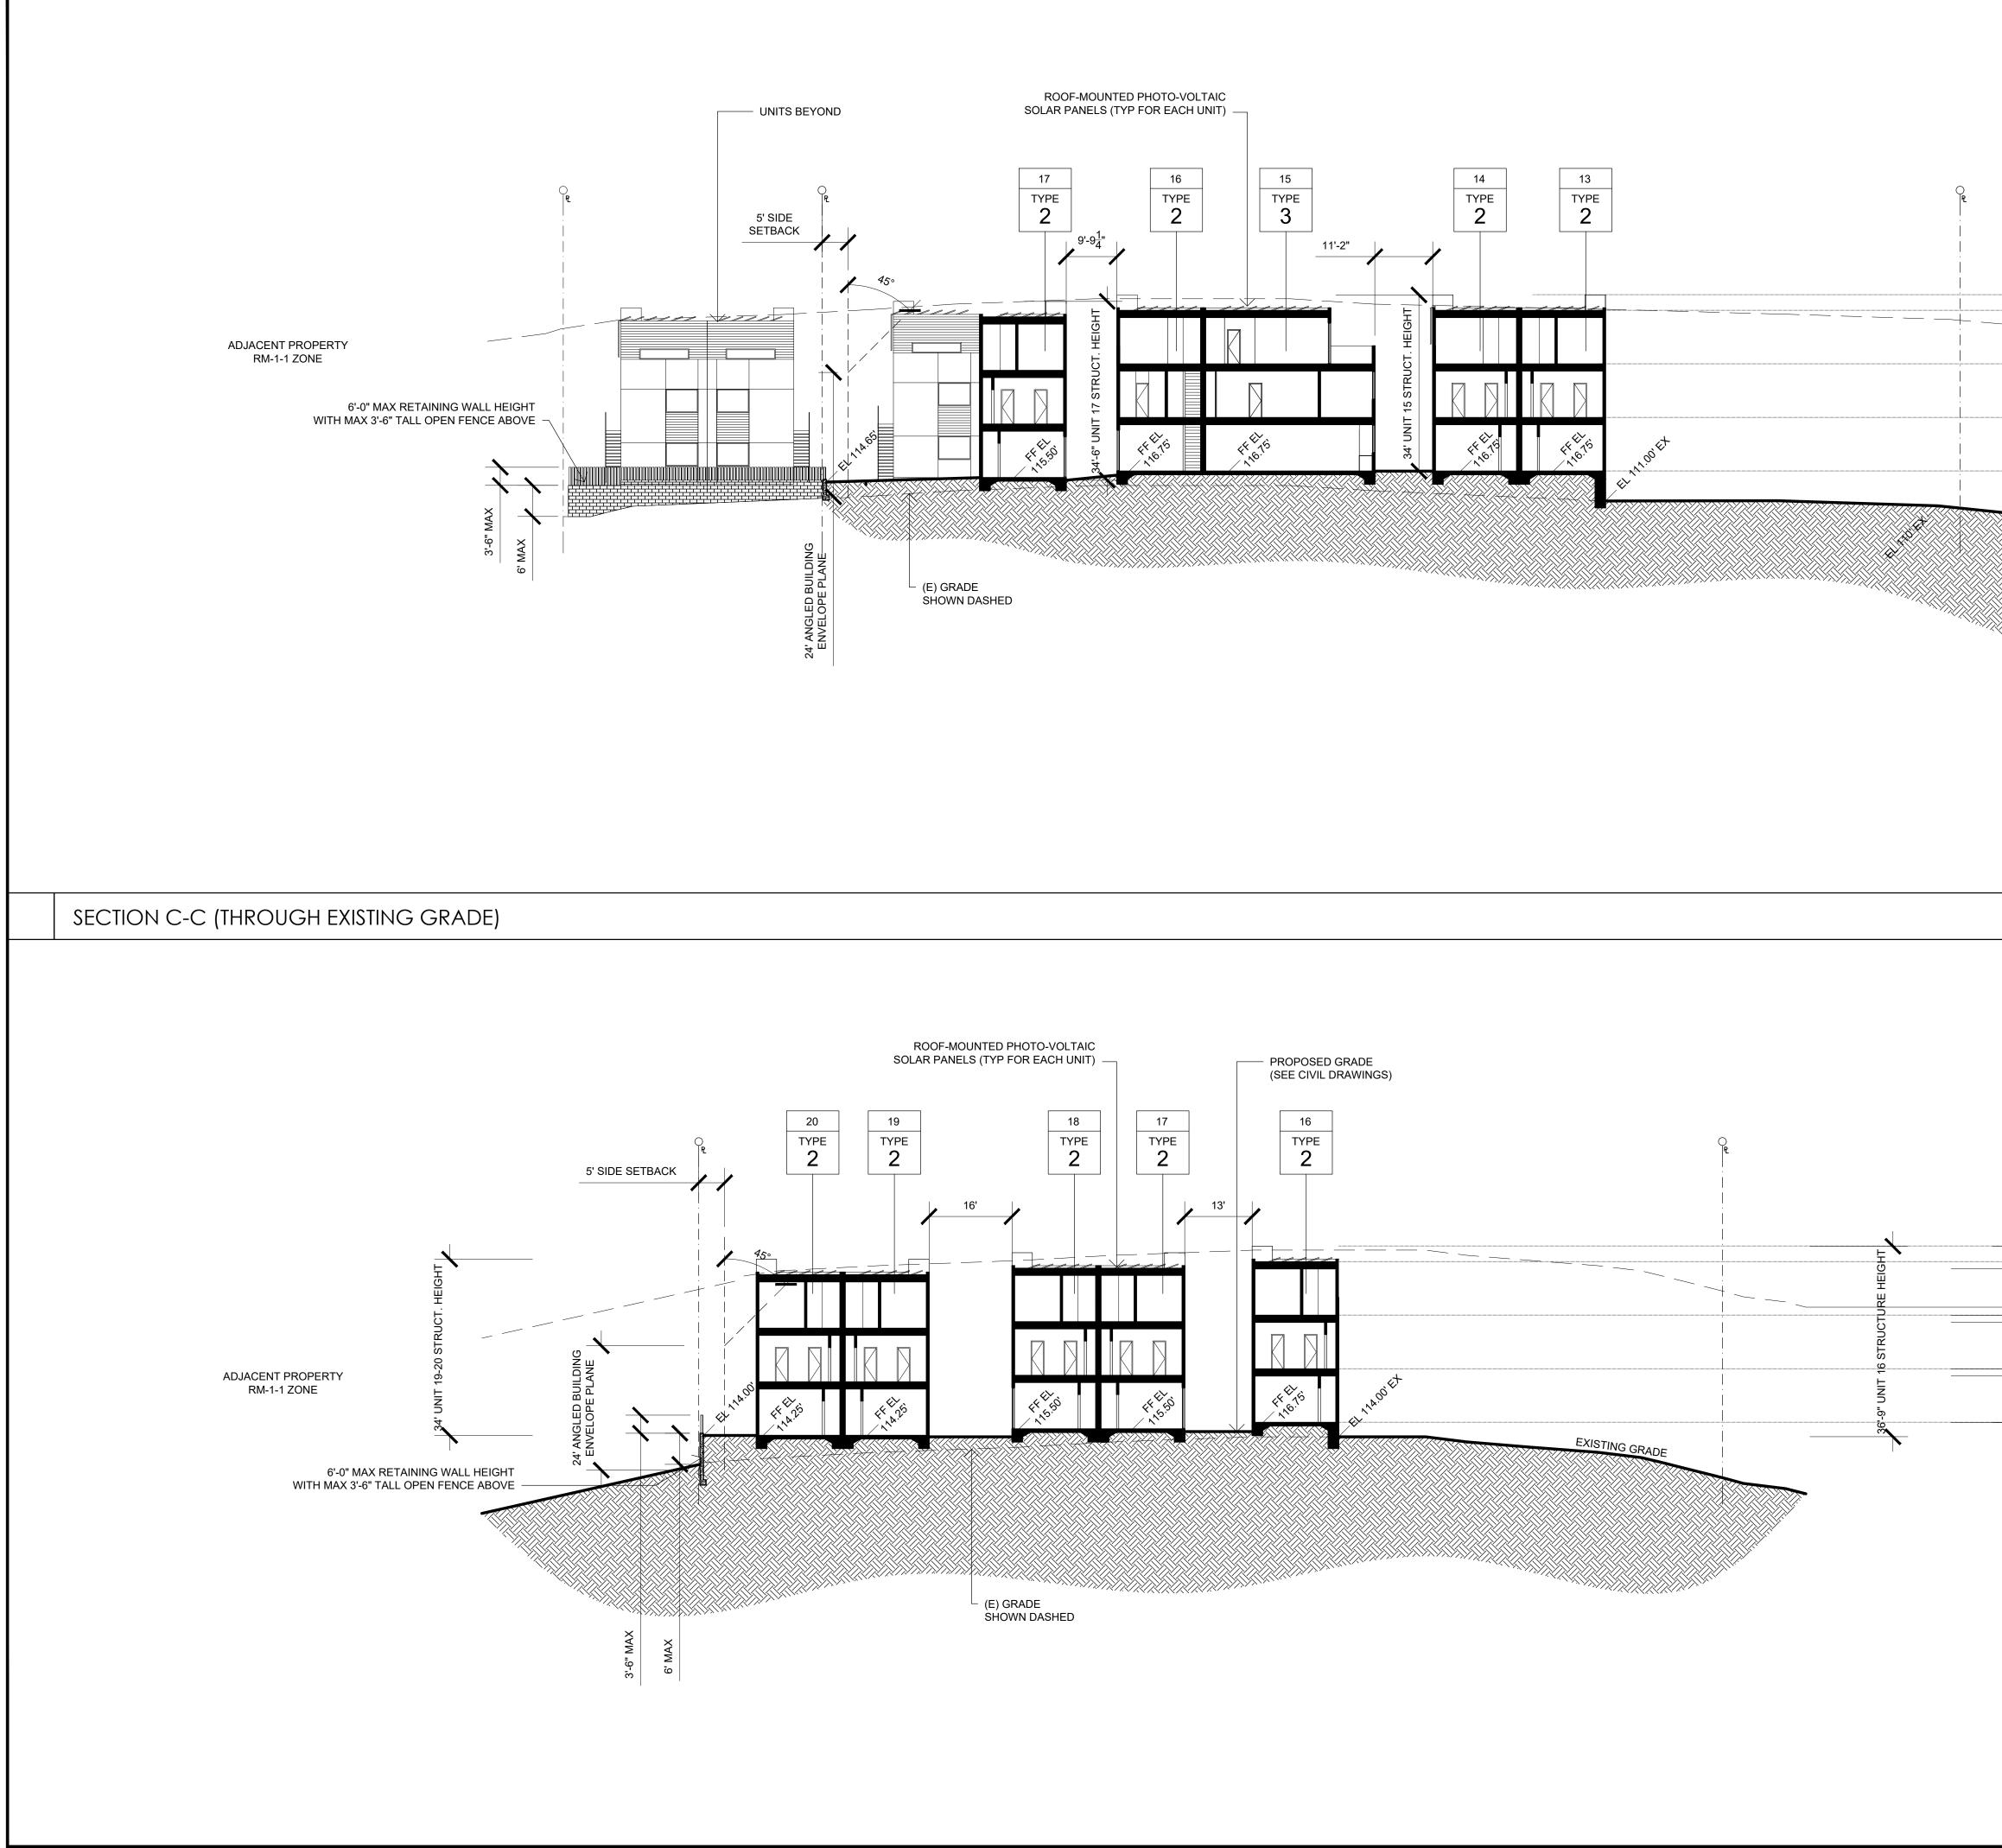

SECTION D-D (THROUGH EXISTING GRADE)

NOTE* EXISTING GRADE ELEVATIONS SHOWN WITH "EX" FF ELEVATIONS PER CONCEPTUAL GRADING PLAN o u s c d d d d d w v v v v v	Notes: All ideas, arrangements, drawings and plans set forth on this sheet are the original work product of, owned by and are the property of dbr ds and use of this said work product is limited to a specified project of the purchaser, and for the construction of one building, any use, reuse or disclosure of said plans, reproductions, ideas, designs and/or arrangements, other than by dbr ds, is strictly prohibited by law without the written permission of dbr ds. Written dimensions on these drawings shall have precedence over scaled dimensions; contractors shall verify, and be responsible for all dimensions and conditions on the job and this office must be notified of any variations from the dimensions and conditions shown these drawings.	
TOP OF PARAPET	DBRDS DE BARTOLO + RIMANIC DESIGN STUDIO	
ROOF LEVEL 	PROJECT TEAM	
	OWNER: 35TH & J PARTNERS, LLC 363 5TH AVE, SUITE 203 SAN DIEGO, CA 92101	
	PHONE: (858) 220-5262 CONTACT: PAULY DE BARTOLO EMAIL: pauly@dbrds.com	
A STATE	DE BARTOLO + RIMANIC DESIGN STUDIO 363 5TH AVE, SUITE 203 SAN DIEGO CA 92101 PHONE: (858) 220-5262 CONTACT: PAULY DE BARTOLO EMAIL: pauly@dbrds.com CIVIL ENGINEER SNIPES-DYE ASSOCIATES 8348 CENTER DRIVE, SUITE G LA MESA, CA 91942 PHONE: (619) 697-9234 CONTACT: BILL SNIPES EMAIL: bill@snipesdye.com LANDSCAPE ARCHITECTURE McCullough Landscape Architecture 703 16TH STREET, SUITE 100 SAN DIEGO, CA 92101 PHONE: (619) 296-3150 CONTACT: DAVID MCCULLOUGH EMAIL: david@mlasd.com	019 (CYCLE ISSUES 5)
TOP OF PARAPET ROOF LEVEL 30' HEIGHT LIMIT LEVEL 3 CLEVEL 2 CLEVEL 1 LEVEL 1 CLEVEL 1 CL	PHONE: (760) 736-2040 CONTACT: RAY SPEAR EMAIL: rspear@spearinc.net	SITE DEVELOPMENT PERMIT - 07.17.20 ^{91 Inamhority}

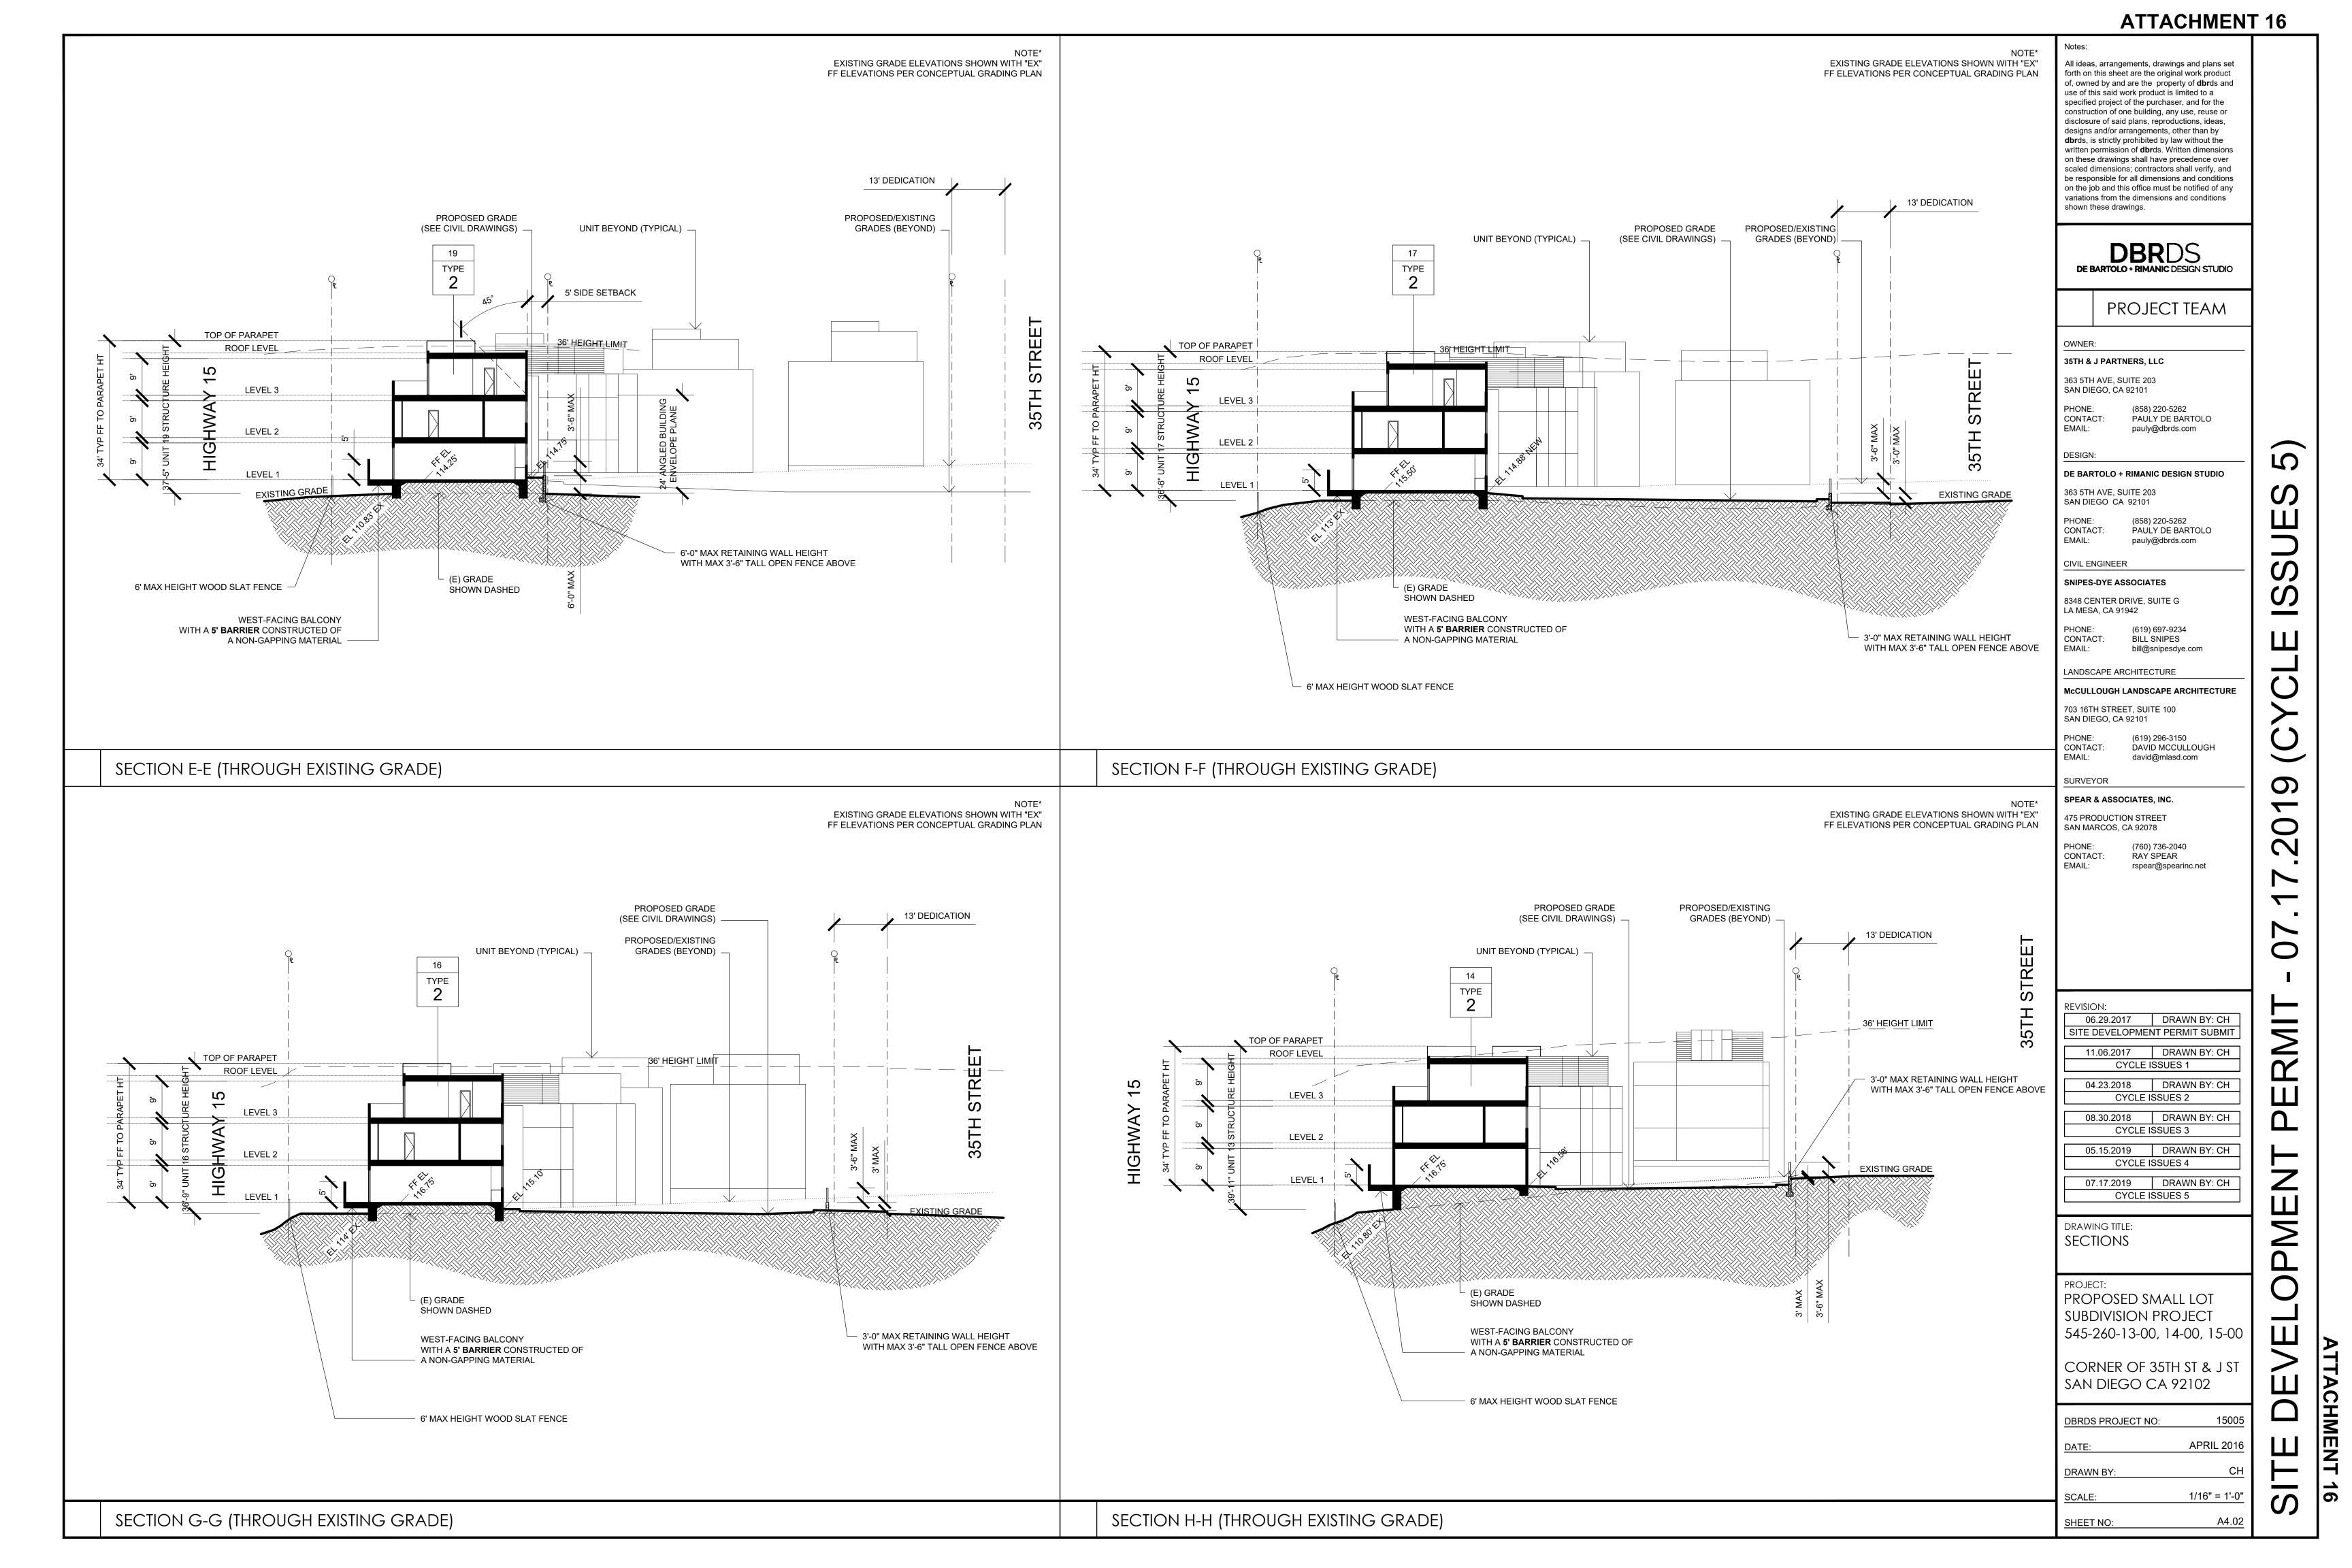


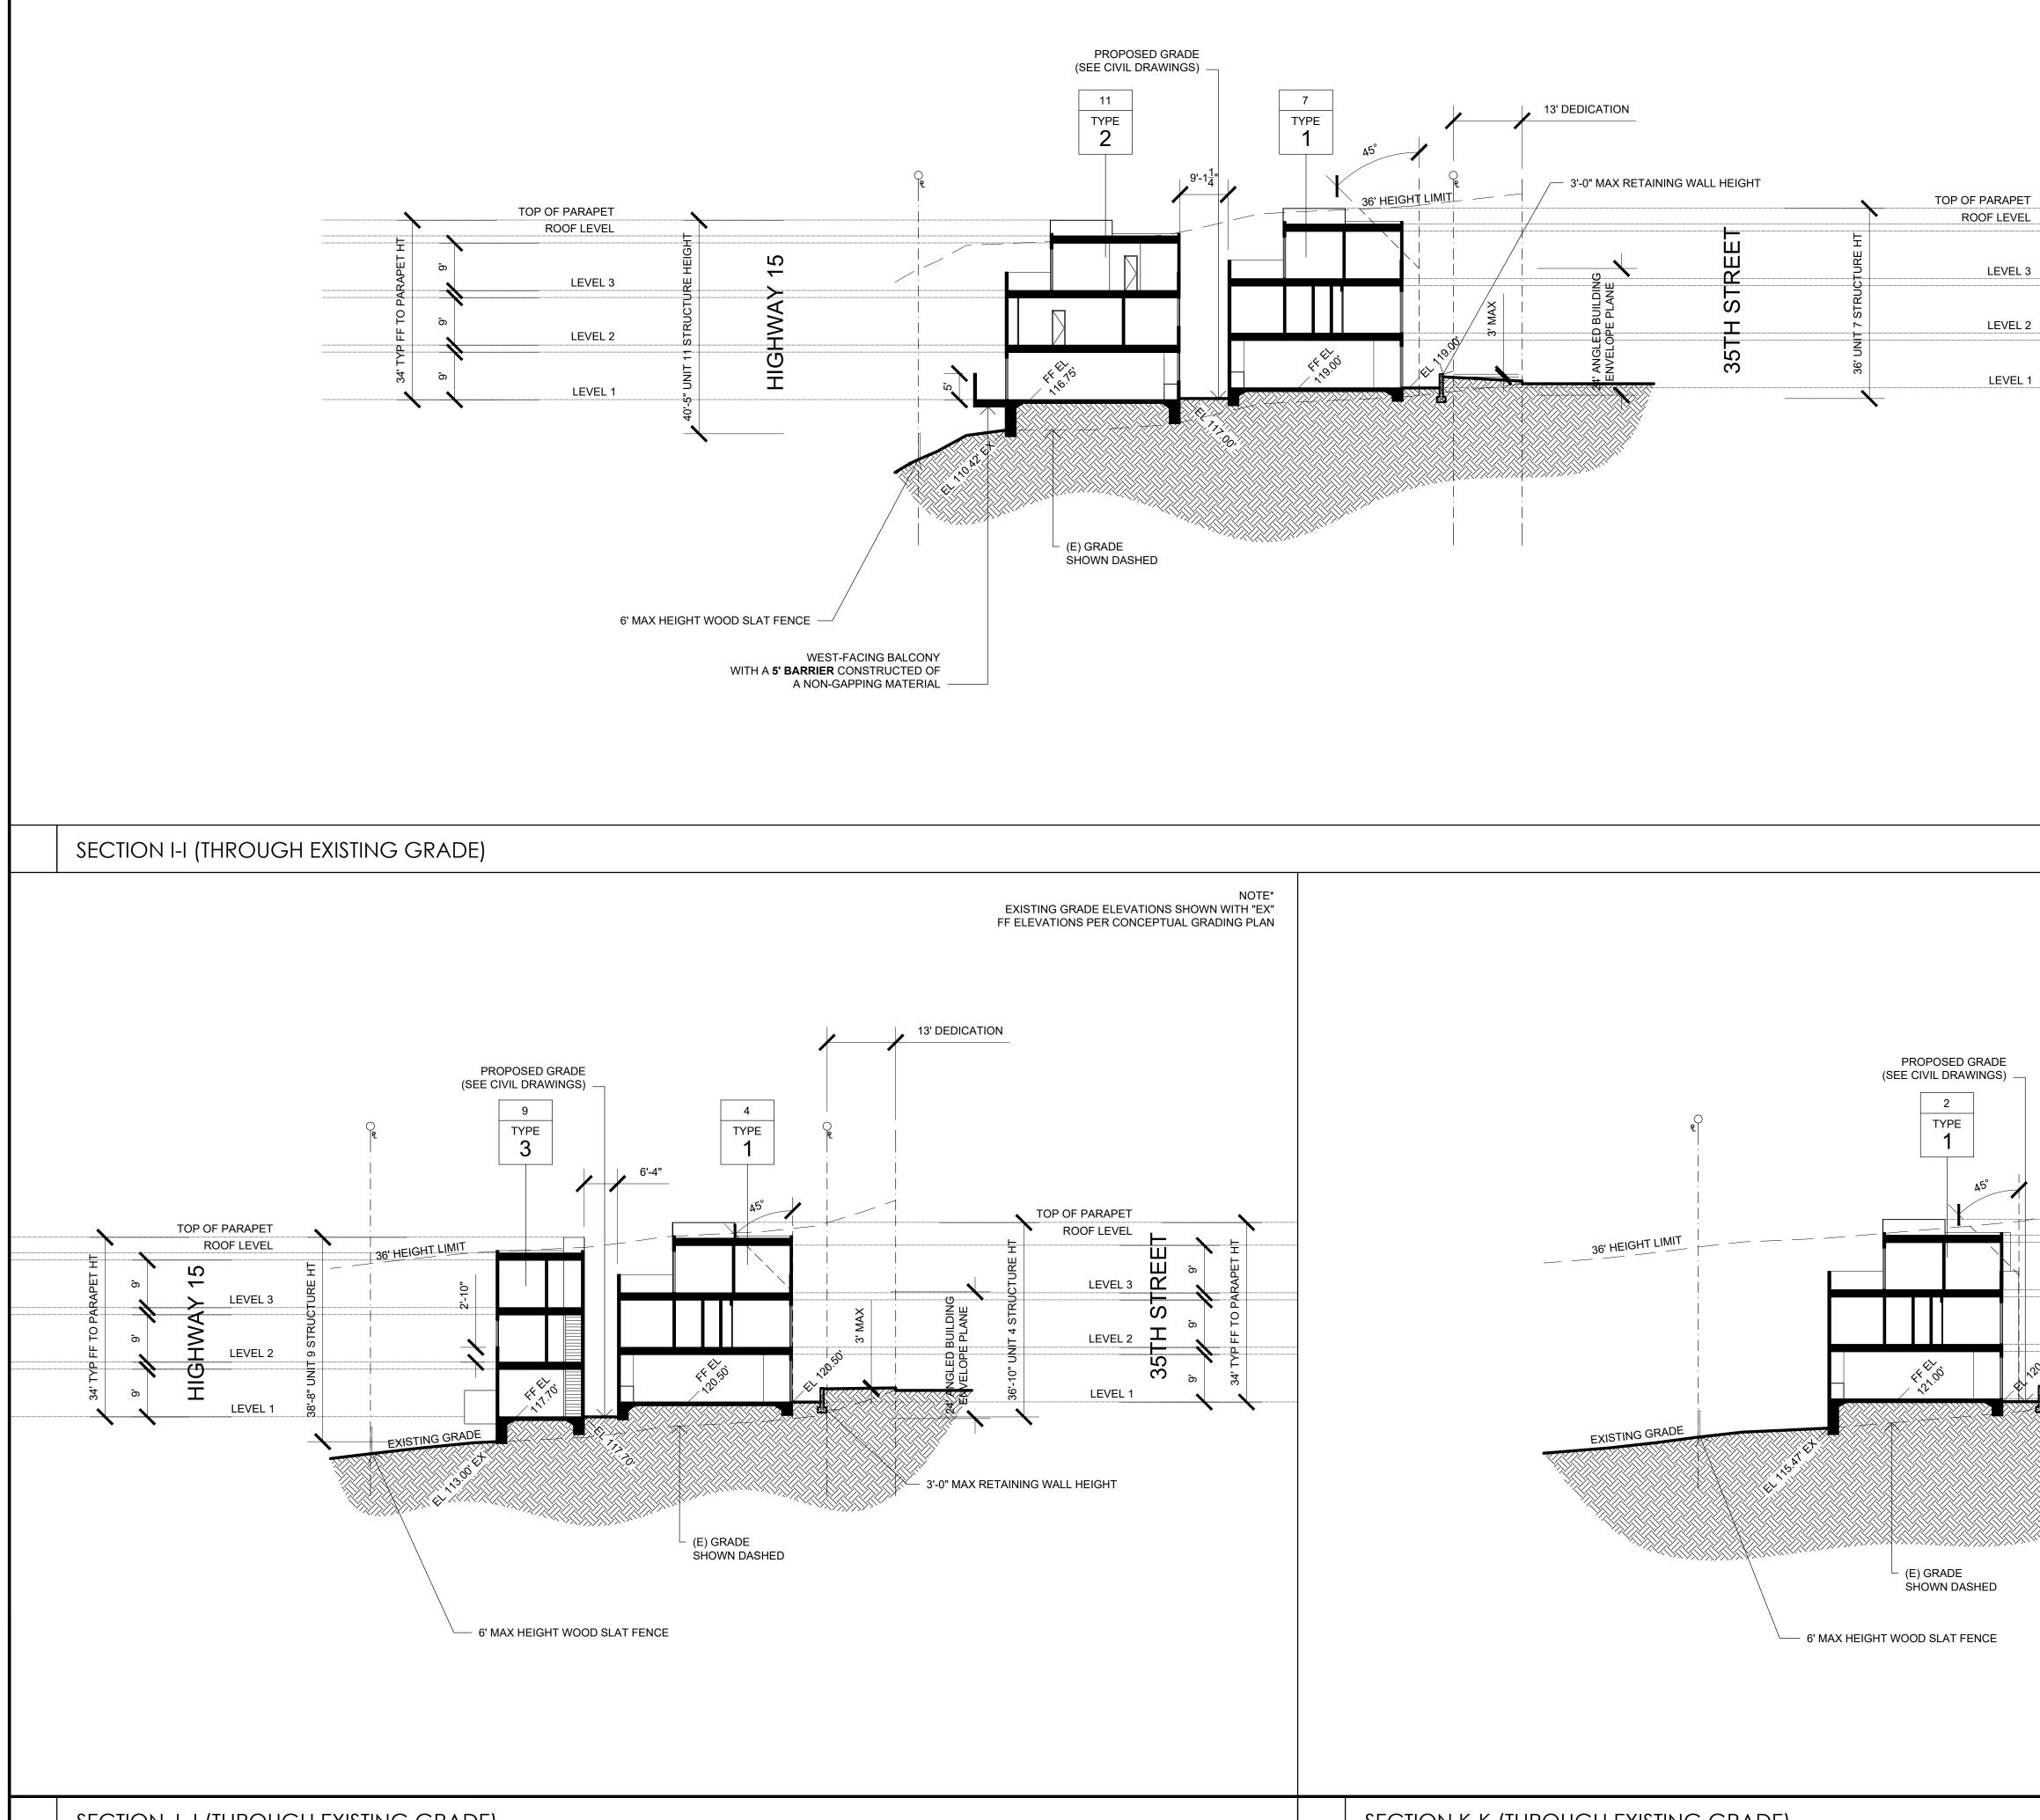

SECTION J-J (THROUGH EXISTING GRADE)

SECTION K-K (THROUGH EXISTING GRADE)


	ATTACHMENT 1	6
NOTE* EXISTING GRADE ELEVATIONS SHOWN WITH "EX FF ELEVATIONS PER CONCEPTUAL GRADING PLAN	Notes: All ideas, arrangements, drawings and plans set forth on this sheet are the original work product of, owned by and are the property of dbr ds and use of this said work product is limited to a specified project of the purchaser, and for the construction of one building, any use, reuse or disclosure of said plans, reproductions, ideas, designs and/or arrangements, other than by dbr ds, is strictly prohibited by law without the written permission of dbr ds. Written dimensions on these drawings shall have precedence over scaled dimensions; contractors shall verify, and be responsible for all dimensions and conditions on the job and this office must be notified of any variations from the dimensions and conditions shown these drawings.	
	DBRDS DE BARTOLO + RIMANIC DESIGN STUDIO	
9 PARAPET HI	PROJECT TEAM	
9, FF TO	OWNER: 35TH & J PARTNERS, LLC	
9° 34' T 7 P	363 5TH AVE, SUITE 203 SAN DIEGO, CA 92101	
	PHONE: (858) 220-5262 CONTACT: PAULY DE BARTOLO EMAIL: pauly@dbrds.com	\frown
	DESIGN: DE BARTOLO + RIMANIC DESIGN STUDIO	S
	363 5TH AVE, SUITE 203 SAN DIEGO CA 92101 PHONE: (858) 220-5262	က ။ ။
	CONTACT: PAULY DE BARTOLO EMAIL: pauly@dbrds.com	\mathbf{D}
	CIVIL ENGINEER SNIPES-DYE ASSOCIATES	SSUES 5)
		Щ
		\overline{O}
	703 16TH STREET, SUITE 100 SAN DIEGO, CA 92101 PHONE: (619) 296-3150	
	CONTACT: DAVID MCCULLOUGH EMAIL: david@mlasd.com	19 (C
NOTE* EXISTING GRADE ELEVATIONS SHOWN WITH "EX"	SPEAR & ASSOCIATES, INC.	
FF ELEVATIONS PER CONCEPTUAL GRADING PLAN	SAN MARCOS, CA 92078	20
	EMAIL: rspear@spearinc.net	~
13' DEDICATION		07.17.2
		0
	REVISION:	⊢∣
	06.29.2017 DRAWN BY: CH SITE DEVELOPMENT PERMIT SUBMIT	PERMIT
	11.06.2017 DRAWN BY: CH CYCLE ISSUES 1	
MAX MAX EPLANE BUILDING EPLANE BUILDING	04.23.2018 DRAWN BY: CH CYCLE ISSUES 2 08.30.2018 DRAWN BY: CH	Ш
3°. MAX 3°. MAX 3°. MAX 1 2 STRU 0 E PLA 1 2 STRU 0 F F 1 0 F F 1 0 F F 1 0 F F 1 0 F F F 1 0 F F F F F F F F F F F F F F F F F F F		
BO-PERIODELE	CYCLE ISSUES 4 07.17.2019 DRAWN BY: CH CYCLE ISSUES 5	IENT
	DRAWING IIILE:	
- 3'-0" MAX RETAINING WALL HEIGHT	SECTIONS	N M M C
	CORNER OF 35TH ST & J ST SAN DIEGO CA 92102	EVE
	DBRDS PROJECT NO: 15005	
	DATE: APRIL 2016 DRAWN BY: CH	Ш
	<u>SCALE: 1/16" = 1'-0"</u>	SITE
	SHEET NO: A4.03	• •

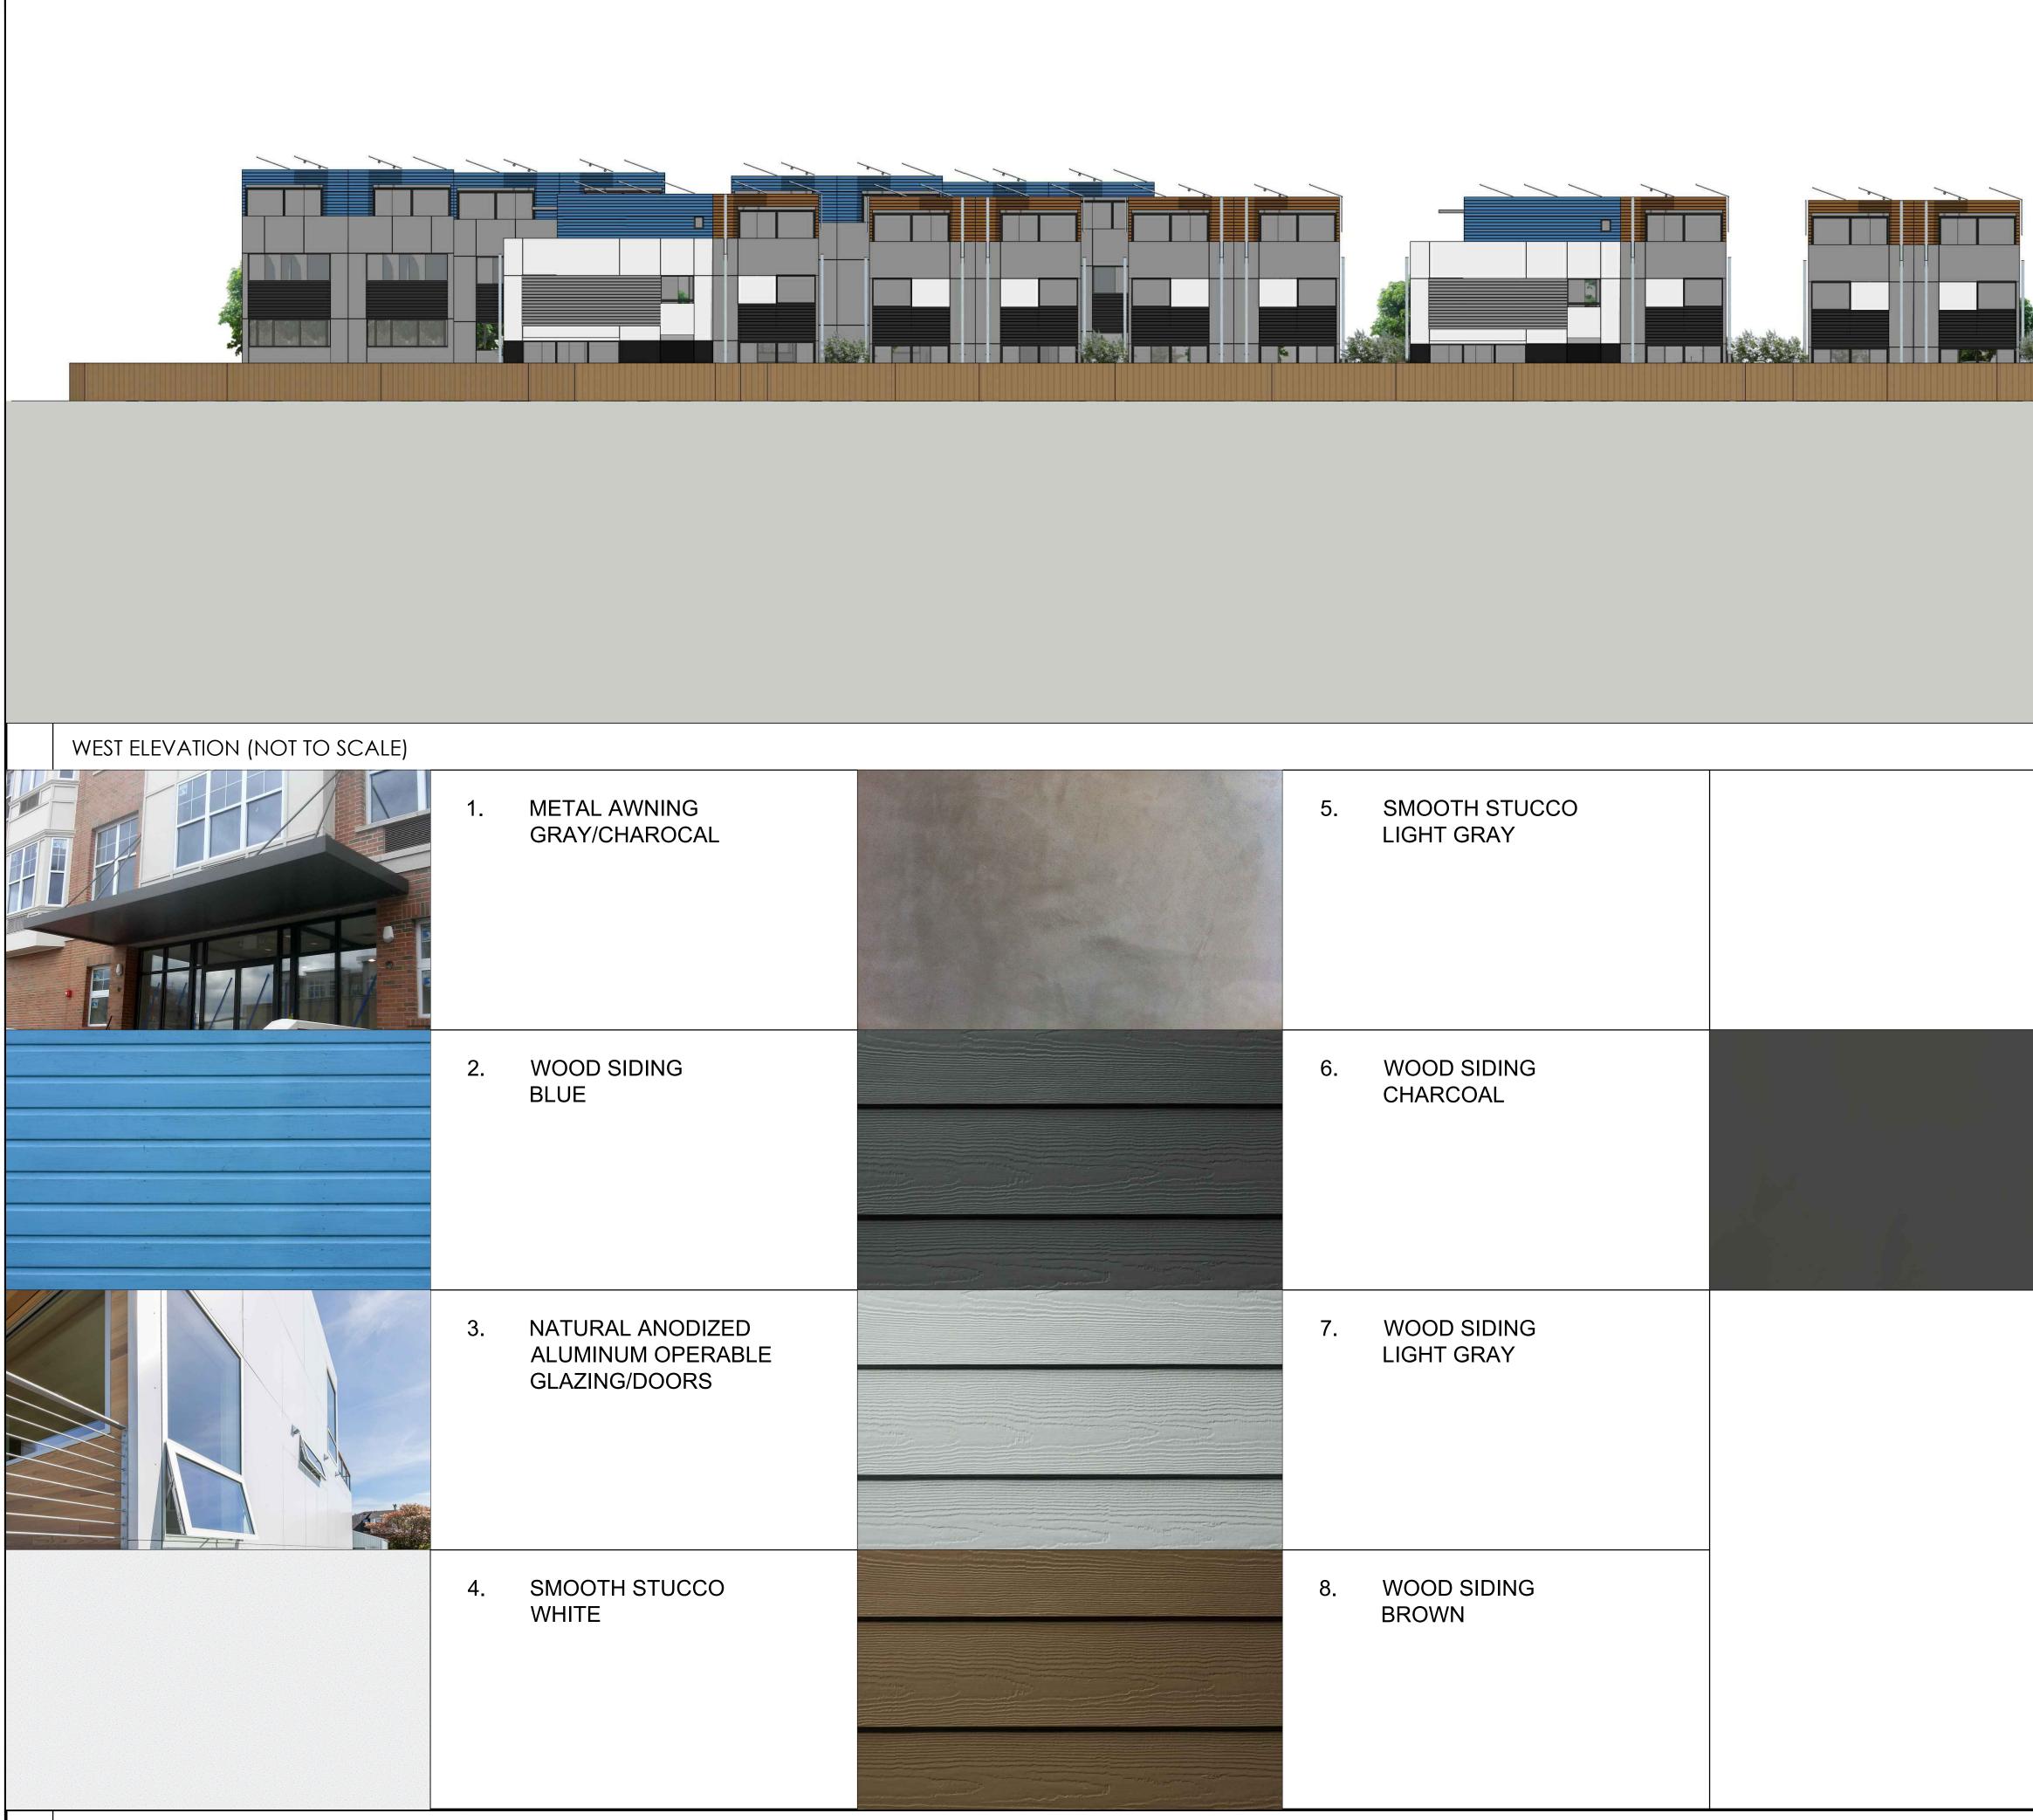


MATERIAL SELECTIONS

5. SMOOTH STUCCO LIGHT GRAY 6. WOOD SIDING 7. WOOD SIDING LIGHT GRAY 8. WOOD SIDING 8. WOOD SIDING			
CHARCOAL CHARCOAL 7. WOOD SIDING LIGHT GRAY 8. WOOD SIDING	5.		
LIGHT GRAY 8. WOOD SIDING	6.		
	7.		
	8.	BROWN	

			Г 16
		Notes: All ideas, arrangements, drawings and plans set forth on this sheet are the original work product of, owned by and are the property of dbr ds and use of this said work product is limited to a specified project of the purchaser, and for the construction of one building, any use, reuse or disclosure of said plans, reproductions, ideas, designs and/or arrangements, other than by dbr ds, is strictly prohibited by law without the written permission of dbr ds. Written dimensions on these drawings shall have precedence over scaled dimensions; contractors shall verify, and be responsible for all dimensions and conditions on the job and this office must be notified of any variations from the dimensions and conditions shown these drawings.	
		DE BARTOLO + RIMANIC DESIGN STUDIO	
		OWNER: 35TH & J PARTNERS, LLC 363 5TH AVE, SUITE 203 SAN DIEGO, CA 92101 PHONE: (858) 220-5262 CONTACT: PAULY DE BARTOLO EMAIL: pauly@dbrds.com DESIGN: DE BARTOLO + RIMANIC DESIGN STUDIO 363 5TH AVE, SUITE 203 SAN DIEGO CA 92101 PHONE: (858) 220-5262 CONTACT: PAULY DE BARTOLO BASS STH AVE, SUITE 203 SAN DIEGO CA 92101 PHONE: (858) 220-5262 CONTACT: PAULY DE BARTOLO EMAIL: pauly@dbrds.com CIVIL ENGINEER SNIPES-DYE ASSOCIATES 8348 CENTER DRIVE, SUITE G LA MESA, CA 91942 PHONE: (619) 697-9234 CONTACT: BILL SNIPES EMAIL: bill@snipesdye.com	E ISSUES 5)
		LANDSCAPE ARCHITECTURE McCULLOUGH LANDSCAPE ARCHITECTURE	C
9.	NOT USED SMOOTH STUCCO CHARCOAL	703 16TH STREET, SUITE 100 SAN DIEGO, CA 92101 PHONE: (619) 296-3150 CONTACT: DAVID MCCULLOUGH EMAIL: david@mlasd.com SURVEYOR SPEAR & ASSOCIATES, INC. 475 PRODUCTION STREET SAN MARCOS, CA 92078 PHONE: (760) 736-2040 CONTACT: RAY SPEAR EMAIL: rspear@spearinc.net	- 07.17.2019 (CY
		REVISION: 06.29.2017 DRAWN BY: CH SITE DEVELOPMENT PERMIT SUBMIT 11.06.2017 DRAWN BY: CH CYCLE ISSUES 1 04.23.2018 DRAWN BY: CH CYCLE ISSUES 2 08.30.2018 DRAWN BY: CH CYCLE ISSUES 3 05.15.2019 DRAWN BY: CH CYCLE ISSUES 4 07.17.2019 DRAWN BY: CH CYCLE ISSUES 5 DRAWING TITLE: MATERIALS BOARD	OPMENT PERMIT
		PROJECT: PROPOSED SMALL LOT SUBDIVISION PROJECT 545-260-13-00, 14-00, 15-00 CORNER OF 35TH ST & J ST SAN DIEGO CA 92102 DBRDS PROJECT NO: 15005 DATE: APRIL 2016 DRAWN BY: CH	SITE DEVELO
		SCALE: NTS	<u>.</u>
		SHEET NO: A5.00	

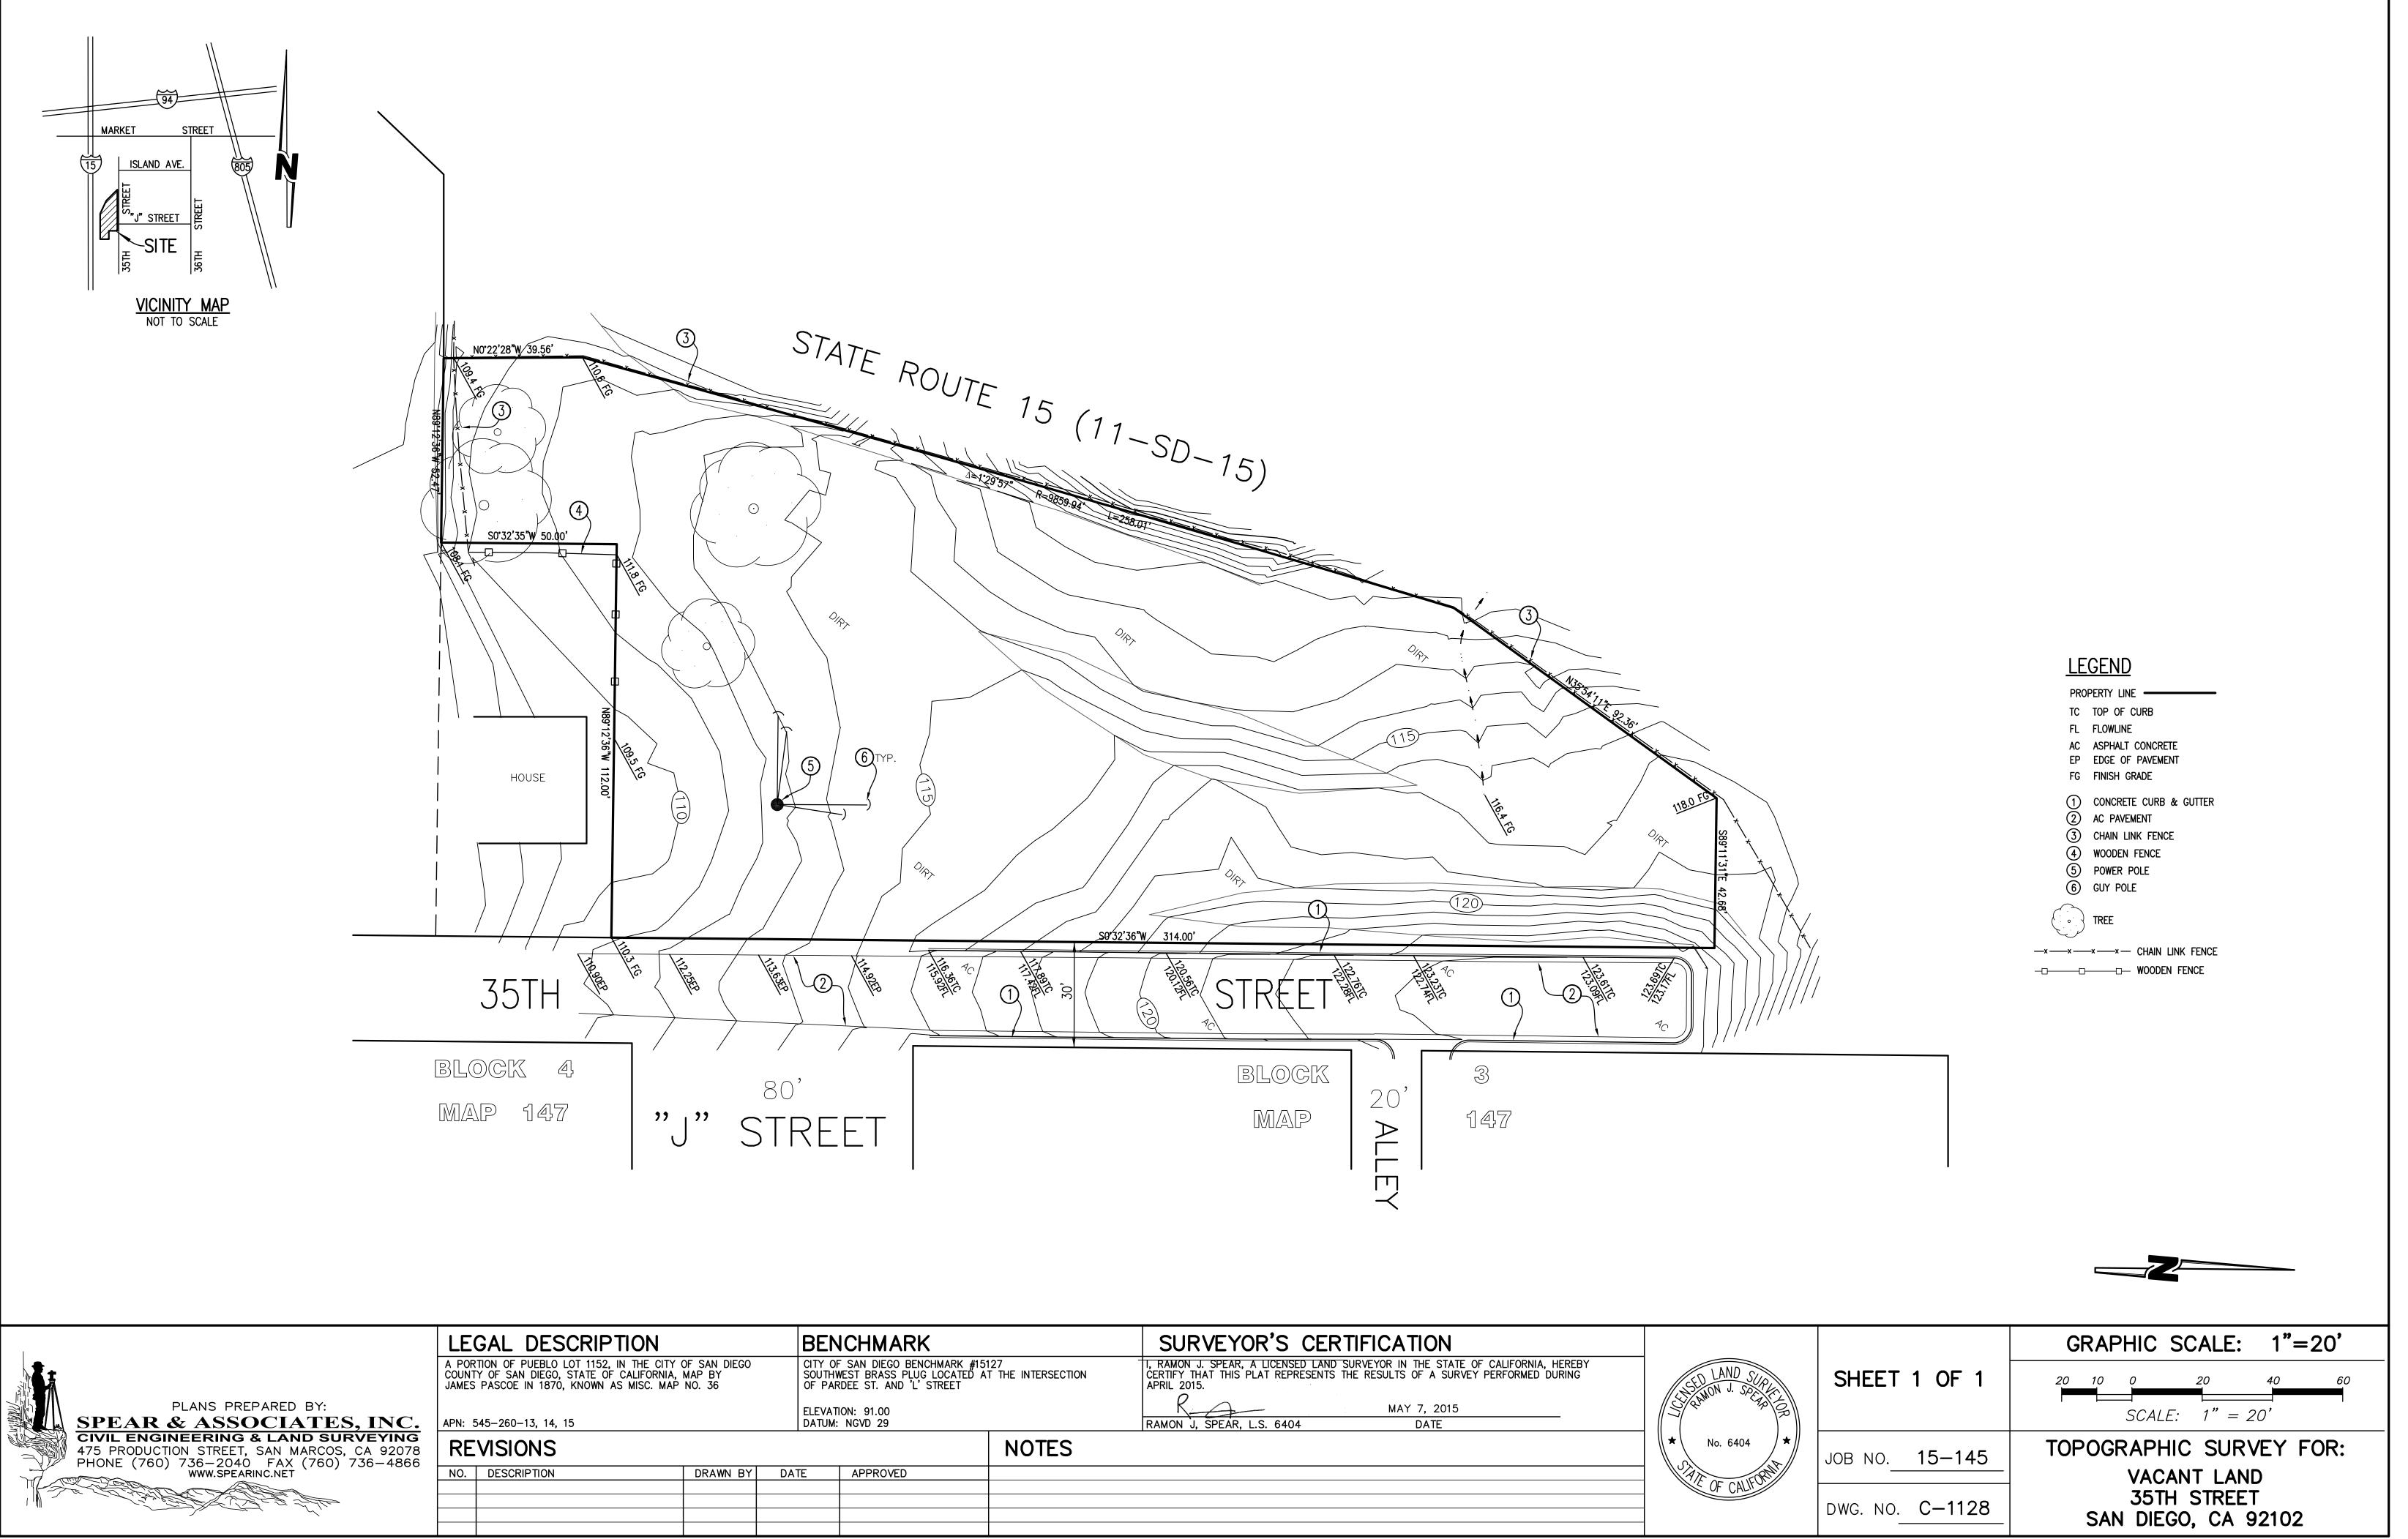

	A POR COUNT	GAL DESCRIPTION TION OF PUEBLO LOT 1152, IN THE CITY OF SAN DIEGO, STATE OF CALIFORNIA, PASCOE IN 1870, KNOWN AS MISC. MAP	MAP BY	CI1 SO	ENCHMARK TY OF SAN DIEGO BENCHMARK #15 DUTHWEST BRASS PLUG LOCATED A PARDEE ST. AND 'L' STREET	27 T THE INTERSECTION	SURVEYOR'S CERTIFICATION I, RAMON J. SPEAR, A LICENSED LAND SURVEYOR IN THE STATE OF CALIFORNIA, HEREBY CERTIFY THAT THIS PLAT REPRESENTS THE RESULTS OF A SURVEY PERFORMED DURING APRIL 2015.	
PLANS PREPARED BY: & ASSOCIATES, INC. SINEERING & LAND SURVEYING CTION STREET, SAN MARCOS, CA 92078 D) 736-2040 FAX (760) 736-4866		045-260-13, 14, 15 VISIONS			EVATION: 91.00 \TUM: NGVD 29	NOTES	RAMON J, SPEAR, L.S. 6404 DATE	×
0) 736–2040 FAX (760) 736–4866 www.spearinc.net	NO.	DESCRIPTION	DRAWN BY	DATE	APPROVED			

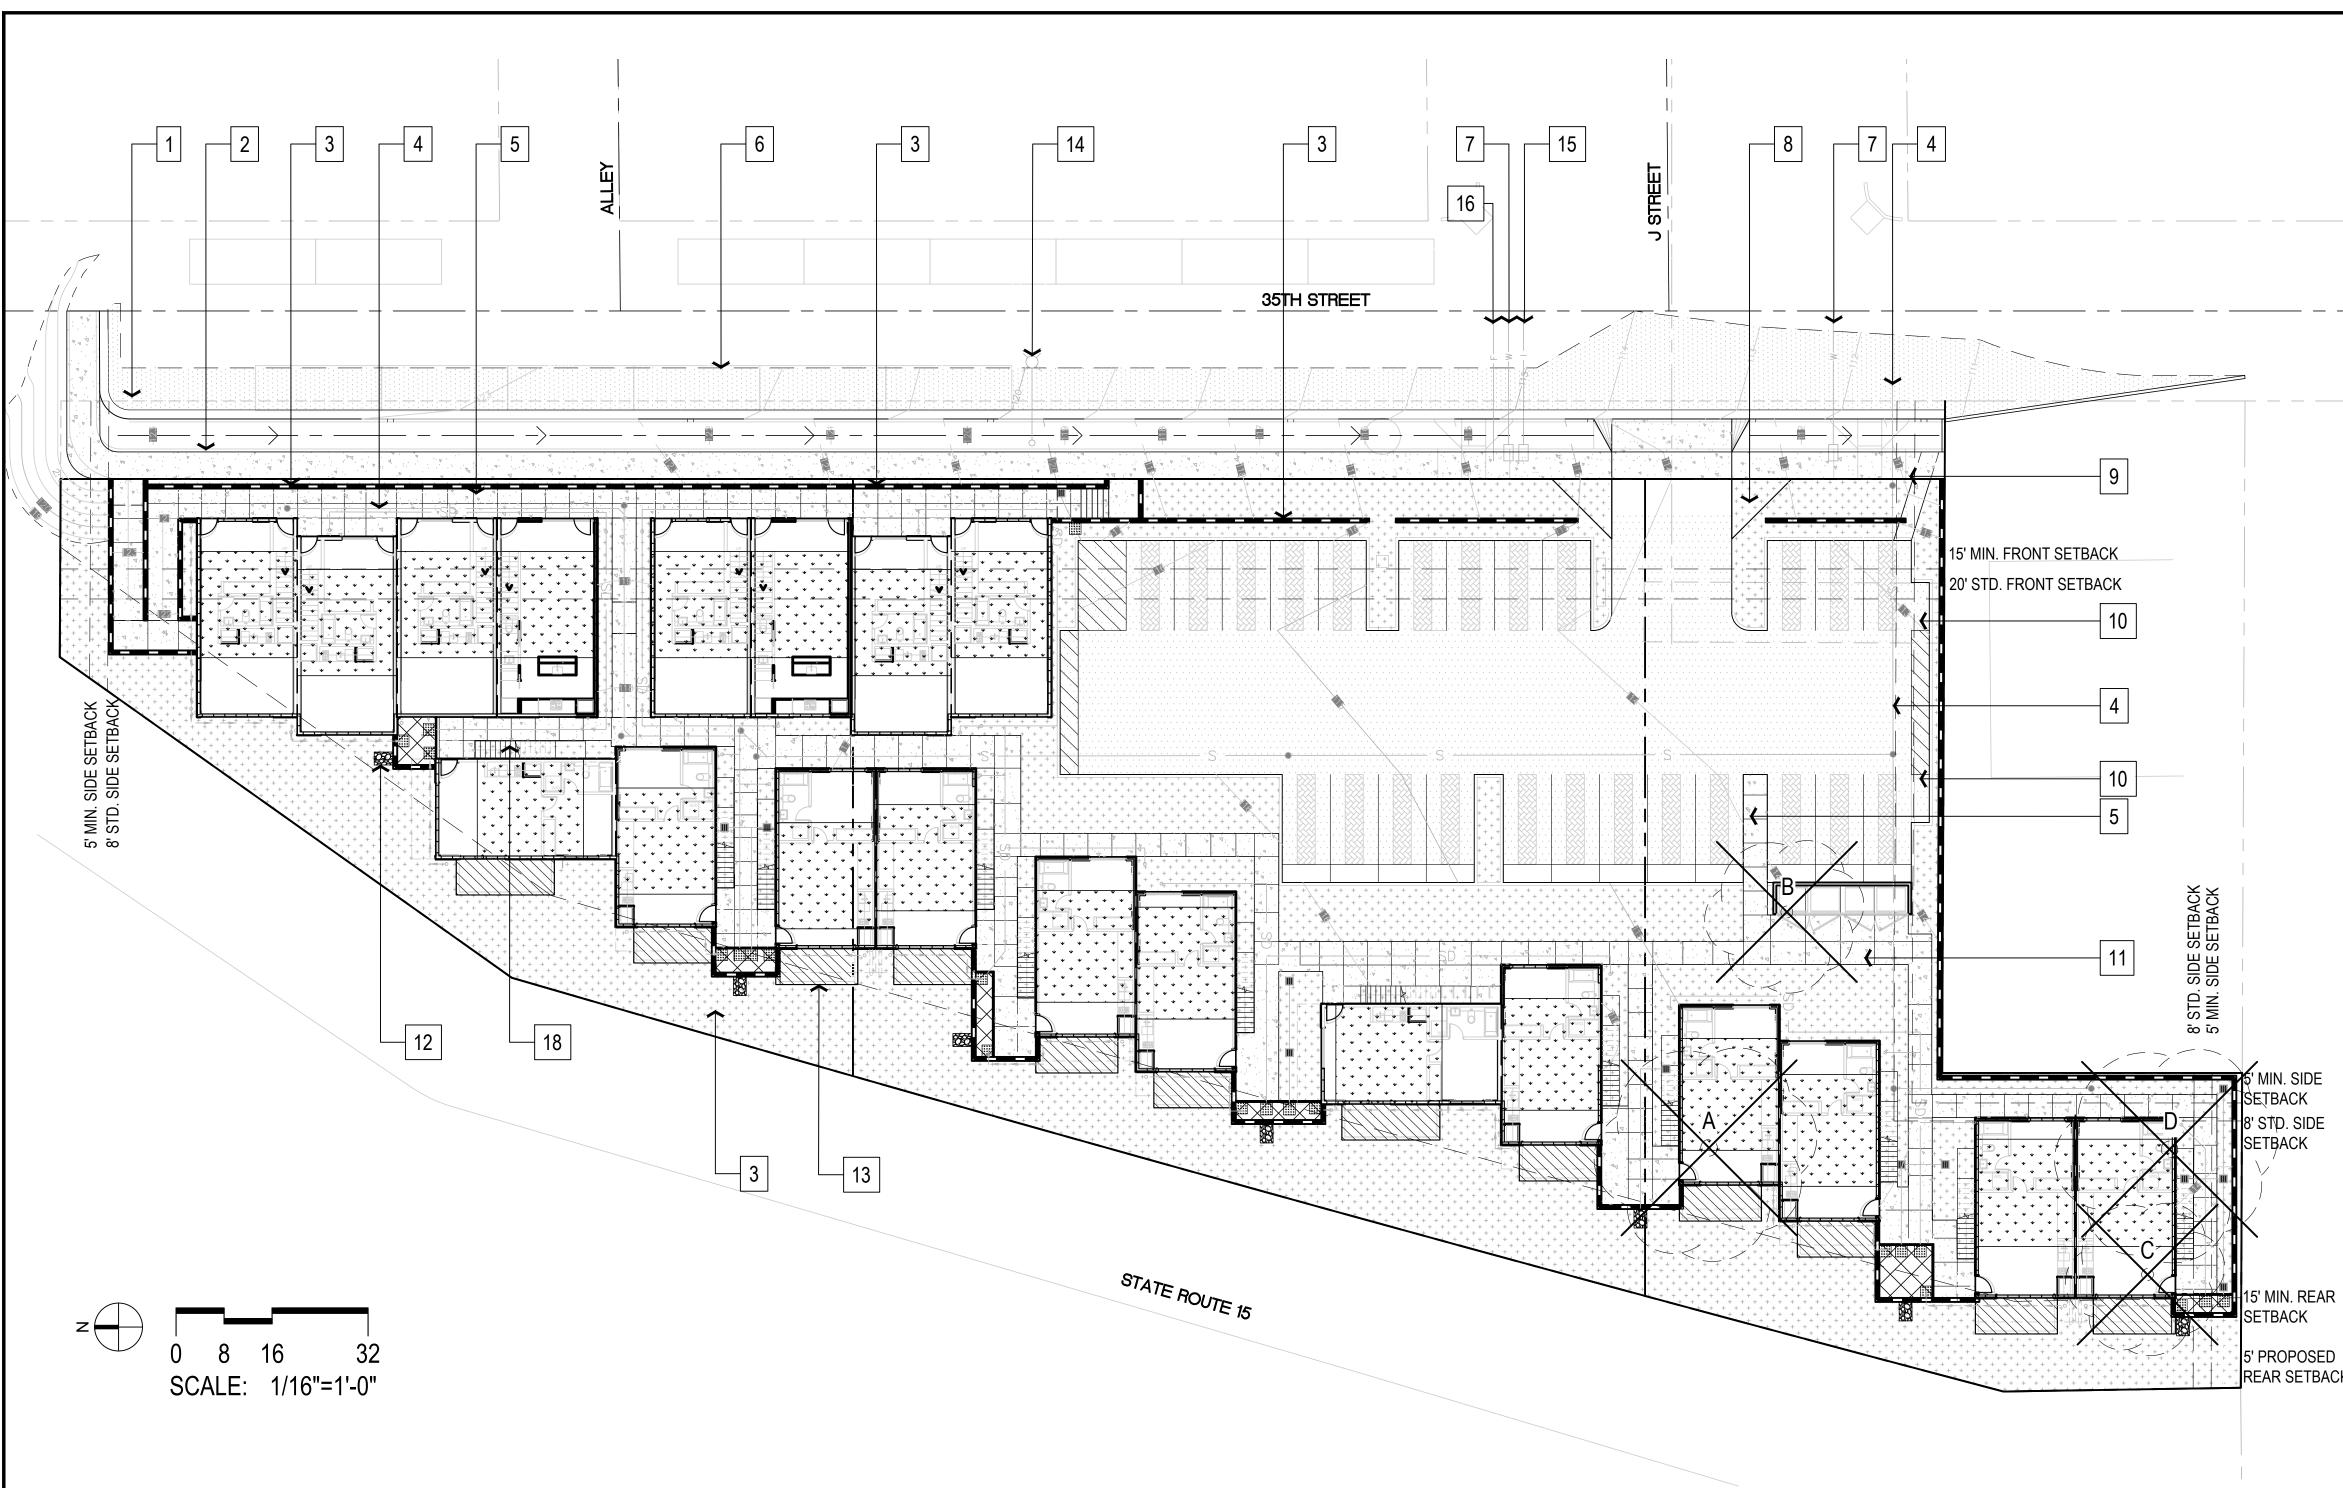

GENERAL LEGEND

- 1. NEW CURB & GUTTER (SEE CIVIL DRAWINGS)
- 2. PROPOSED SIDEWALK (SEE CIVIL DRAWINGS)
- RETAINING WALL (SEE CIVIL DRAWINGS) 3.
- 4. SEWER LATERALS (SEE CIVIL DRAWINGS)
- 5. CONCRETE WALKWAY
- 6. PROPOSED SAW CUT LINE (SEE CIVIL DRAWINGS)
- 7. WATER LINES (SEE CIVIL DRAWINGS)
- 8. VISIBILITY TRIANGLE (SEE CIVIL DRAWINGS)
- 9. DOWN DRAIN (SEE CIVIL DRAWINGS)
- 10. MOTORCYCLE PARKING
- 11. TRASH ENCLOSURE (SEE ARCHITECTURE DRAWINGS)
- 12. PROPOSED ROCK RIP-RAP (SEE CIVIL DRAWINGS)
- 13. DECK (SEE ARCHITECTURE DRAWINGS)
- 14. PROPOSED LIGHTING (SEE CIVIL DRAWINGS)
- 15. IRRIGATION LINES (SEE CIVIL DRAWINGS)
- 16. FIRE LINE (SEE CIVIL DRAWINGS)
- 17. PERMEABLE CONCRETE SPLASH PAD (SEE CIVIL DRAWINGS)
- 18. STAIRS (SEE ARCHITECTURAL DRAWINGS)

HARDSCAPE LEGEND

SYMBOL	DESCRIPTION		
	PROPOSED SIDEWALK (SEE CIVIL DRAWINGS)		X
	VEHICULAR RATED CONCRETE	TAG	BC CC
	PEDESTRIAN RATED CONCRETE, SCORE LINES SEE PLAN	A	SC CA
+ $+$ $+$ $+$ $+$	PLANTING AREA	В	JA JA
	GRASSCRATES OR GROUNDCOVERS	C	JA JA SC
	BIOFILTRATIONS SYSTEM (SEE CIVIL DRAWINGS)	D	CA
↓ ↓ ↓ ↓ ↓ ↓ ↓ ↓	GREENROOF (SEE CIVIL DRAWINGS)		

EXISTING TREE LEGEND

EXISTING TREE TO BE F	REMOVED	
BOTANICAL NAME COMMON NAME	<u>SIZE</u>	<u>REMARKS</u>
SCHINUS MOLLE CALIFORNIA PEPPER TREE	24" CALIPER	TO BE REMOVED
JACARANDA MIMOSIFOLIA JACARANDA	12" CALIPER	TO BE REMOVED
JACARANDA MIMOSIFOLIA JACARANDA	12" CALIPER	TO BE REMOVED
SCHINUS MOLLE CALIFORNIA PEPPER TREE	24" CALIPER	TO BE REMOVED

WATER CONSERVATION STATEMENT

IN RECOGNITION OF WATER AS A LIMITED RESOURCE IN SOUTHERN CALIFORNIA, THE FOLLOWING MEASURES WILL BE UNDERTAKEN TO REDUCE THIS PROJECT'S DEMAND ON THE CITY OF SAN DIEGO'S AVAILABLE WATER SUPPLY:

- 1. THE IRRIGATION SYSTEM WILL BE AUTOMATIC AND WILL INCORPORATE LOW 8. GRADED, DISTURBED, OR ERODED AREAS TO BE TREATED WITH NON-IRRIGATED HYDROSEED MIX SHALL RECEIVE AN INTERIM VOLUME SPRAY EMITTERS AND CONVENTIONAL LOW ANGLE SPRAY HEADS. DRIP BINDER/TACKIFIER AS NEEDED BETWEEN APRIL 2ND AND AUGUST 31ST FOR IRRIGATION SYSTEMS MAY BE EMPLOYED WHERE CONSIDERED TO BE EFFECTIVE AND FEASIBLE. IRRIGATION VALVES SHALL BE SEGREGATED TO ALLOW FOR THE DUST/EROSION CONTROL WITH SUBSEQUENT APPLICATION OF THE SYSTEM OPERATION IN RESPONSE TO ORIENTATION AND EXPOSURE HYDROSEED MIX DURING THE RAINY SEASON BETWEEN OCTOBER 1ST. AND APRIL 1ST. SUPPLEMENTAL MANUAL IRRIGATION WILL BE IMPLEMENTED II 2. TURF WILL BE RESTRICTED TO HIGHLY VISIBLE STREET FRONT AREAS AND/OR DEEMED NECESSARY BY THE PROJECT BIOLOGIST AND/OR THE DEVELOPMENT AREAS WHICH MAY RECEIVE SIGNIFICANT AMOUNTS OF USE AND ENJOYMENT BY THE GUESTS. THE SPECIFIED TURF WILL HAVE RELATIVELY LOW WATER AND SERVICES DEPARTMENT AND MAY INCLUDE HAND WATERING OR UTILIZATION OF A WATER TRUCK. IF USED, SUPPLEMENTAL WATERING FREQUENCIES MAINTENANCE REQUIREMENTS. WOULD MIMIC NATURAL RAINFALL CYCLES. PLANT MATERIAL WILL BE SPECIFIED IN CONSIDERATION OF NORTH, SOUTH, EAST
- AND WEST EXPOSURES.
- 4. SOIL WILL BE AMENDED AND PREPARED TO PROVIDE HEALTHY PLANT GROWTH AND COVERAGE AND TO PROVIDE FOR MAXIMUM MOISTURE RETENTION AND PERCOLATION. PLANTER BEDS WILL BE MULCHED TO RETAIN SOIL MOISTURE AND REDUCE EVAPOTRANSPIRATION FROM THE ROOT ZONES.
- 5. AN IRRIGATION SYSTEM SHALL BE PROVIDED AS REQUIRED FOR THE PROPER IRRIGATION, DEVELOPMENT AND MAINTENANCE OF THE VEGETATION. THE DESIGN OF THE SYSTEM SHALL PROVIDE ADEQUATE SUPPORT OF THE VEGETATION SELECTED.

ROOT BARRIER NOTE

NON-BIODEGRADEABLE ROOT BARRIERS SHALL BE INSTALLED AROUND ALL NEW STREET TREES PER LDC 142.0403.

DISTURBED AREA NOTE

ALL GRADED, DISTURBED OR ERODED AREAS THAT WILL NOT BE PERMANENTLY PAVED OR COVERED BY STRUCTURES SHALL BE PERMANENTLY RE-VEGETATED -AND IRRIGATED AS SHOWN IN TABLE 142-04F AND IN ACCORDANCE WITH THE STANDARDS IN THE LAND DEVELOPMENT MANUAL (142.0411(A)).

MAINTENANCE RESPONSIBILITY

ALL REQUIRED LANDSCAPE AREAS SHALL BE MAINTAINED BY THE OWNER. THE LANDSCAPE AREAS SHALL BE MAINTAINED IN A FREE OF DEBRIS AND LITTER AND ALL PLANT MATERIAL SHALL BE MAINTAINED IN A HEALTHY GROWING CONDITION. DISEASED OR DEAD PLANT MATERIAL SHALL BE SATISFACTORILY TREATED OR REPLACED PER THE CONDITIONS OF THIS PERMIT.

PLANT MATERIAL NEAR SEWER LINES

NO TREE OR SHRUB EXCEEDING 3' IN HEIGHT SHALL BE PLANTED WITHIN 10' OF ANY PUBLIC SEWER FACILITIES.

UTILITY SCREENING

ALL WATER, SEWER, AND GAS UTILITIES SHALL BE EFFECTIVELY SCREENED WITH PLANT MATERIAL AT THE TIME OF PLANT INSTALLATION.

MULCHING NOTE

ALL REQUIRED PLANTING AREAS SHALL BE COVERED WITH MULCH TO A MINIMUM DEPTH OF 3 INCHES. EXCLUDING SLOPES REQUIRING REVEGETATION AND AREAS PLANTED WITH GROUNDCOVER. ALL EXPOSED SOIL AREAS WITHOUT VEGETATION SHALL ALSO BE MULCHED TO THIS MINIMUM DEPTH

PUBLIC RIGHT OF WAY

ANY EXISTING CONCRETE STAMPS ON EXISTING R.O.W. CONCRETE SHALL BE PRESERVED IN PLACE.

GENERAL NOTE

ALL LANDSCAPE AND IRRIGATION SHALL CONFORM TO THE STANDARDS OF THE CITY-WIDE LANDSCAPE REGULATIONS AND ALL OTHER LANDSCAPE RELATED CITY AND REGIONAL STANDARDS

ADDITIONAL NOTES

- 1. ALL LANDSCAPE AREAS NOT CONTAINING TREES SHALL HAVE A MINIMUM FINISHED DIMENSION OF 3 FEET (WIDTH) MEASURED FROM THE INSIDE FACE OF PAVEMENT.
- 2. EACH TREE SHALL BE PLANTED IN AN AIR AND WATER PERMEABLE PLANTING AREA OF AT LEAST 40 SQUARE FEET WITH A MINIMUM FINISHED DIMENSION (WIDTH) OF 5 FEET MEASURED FROM THE INSIDE FACE OF PAVEMENT. THE PLANTING AREA SHALL BE UNENCUMBERED BY UTILITIES.
- 3. ALL IRRIGATION DESIGN AND INSTALLATION SHALL CONFORM WITH THE LANDSCAPE STANDARDS. IT IS THE RESPONSIBILITY OF THE DESIGNER TO BE FAMILIAR WITH AND IMPLEMENT THE LANDSCAPE STANDARDS.
- PROPOSED 4. ANY CHANGES TO THE SITE AND/OR LANDSCAPE PLANS SHALL BE SUBMITTED REAR SETBACK TO THE CITY LANDSCAPE PLANNER FOR REVIEW AND APPROVAL PRIOR TO PROCEEDING.
 - 5. ANY DISCREPANCY OR CONFLICTS IN DIMENSIONS, LANDSCAPE AREA OR MATERIAL SHALL BE BROUGHT TO THE ATTENTION OF THE CITY LANDSCAPE PLANNER, THE OWNERS, AND THE DESIGNER/ ARCHITECT PRIOR TO INSTALLATION.
 - 6. TREES REQUIRED BY THIS DIVISION SHALL BE SELF_SUPPORTING, WOODY PLANTS WITH AT LEAST ONE WELL_DEFINED TRUNK AND SHALL NORMALLY ATTAIN A MATURE HEIGHT AND SPREAD OF AT LEAST 15 FEET WITHIN 8 YEARS OF PLANTING.
 - 7. THE IRRIGATION SYSTEM SHALL BE INSTALLED WITH A RAIN SHUT-OFF DEVICE.

MINIMUM TREE SEPARATION DISTANCE

IMPROVEMENT	MINIMUM DISTANCE TO STR	REET TREE
TRAFFIC SIGNALS (STOP SIGN)		20 FEET
UNDERGROUND UTILITY LINES (EXCEP	SEWER LINES)	5 FEET
ABOVE GROUND UTILITY STRUCTURES		10 FEET
DRIVEWAY (ENTRIES)		10 FEET
INTERSECTIONS (INTERSECTING CURB	LINES OF TWO STREETS)	25 FEET
SEWER LINES		10 FEET

ATTACHMENT 16

All ideas, arrangements, drawings and plans set forth on this sheet are the original work product of, owned by and are the property of **dbr**ds and use of this said work product is limited to a specified project of the purchaser, and for the construction of one building, any use, reuse or disclosure of said plans, reproductions, ideas, designs and/or arrangements, other than by dbrds, is strictly prohibited by law without the ritten permission of dbrds. Written dimensions on these drawings shall have precedence over scaled dimensions; contractors shall verify, and be responsible for all dimensions and conditions on the job and this office must be notified of any variations from the dimensions and conditions shown these drawings.



PROJECT TEAM

OWNER:

35TH & J PARTNERS, LLC 363 5TH AVE, SUITE 203

SAN DIEGO, CA 92101 PHONE:

CONTACT: PAULY DE BARTOLO EMAIL: pauly@dbrds.com

DESIGN:

DE BARTOLO + RIMANIC DESIGN STUDIO 363 5TH AVE, SUITE 203

(858) 220-5262

PAULY DE BARTOLO

(858) 220-5262

SAN DIEGO CA 92101 PHONE: CONTACT:

EMAIL: pauly@dbrds.com

CIVIL ENGINEER

SNIPES-DYE ASSOCIATES 8348 CENTER DRIVE, SUITE G

_A MESA, CA 91942 PHONE: (619) 697-9234 CONTACT: BILL SNIPES

EMAIL: bill@snipesdye.com LANDSCAPE ARCHITECTURE

McCULLOUGH LANDSCAPE ARCHITECTURE 703 16TH STREET, SUITE 100 SAN DIEGO, CA 92101

(619) 296-3150

DAVID MCCULLOUGH

- PHONE: CONTACT: EMAIL:
- david@mlasd.com

SURVEYOR SPEAR & ASSOCIATES, INC.

475 PRODUCTION STREET SAN MARCOS, CA 92078

PHONE: CONTACT: EMAIL





REVISION:	
04.13.2017	DRAWN BY: CH
COMPLETENESS C	HECK SUBMITTAL
06.13.2017	DRAWN BY: DC
SITE DEVELOP	MENT PERMIT
09.15.2017	DRAWN BY: DC
REVIEW C	OMMENTS
04.11.2018	DRAWN BY: DC
REVIEW CC	MMENTS 2
06.25.2018	DRAWN BY: DC
CITY PLANNE	R COMMENTS
08.28.2018	DRAWN BY: DC
REVI	SION
07.17.2019	DRAWN BY: MB

DRAWING TITLE: LANDSCAPE

SHEET NO:

DEVELOPMENT PLAN

PROJECT: PROPOSED SMALL LOT SUBDIVISION PROJECT 545-260-13-00, 14-00, 15-00 CORNER OF 35TH ST & J ST SAN DIEGO CA 92102

DBRDS PROJECT NO:	15005
DATE:	AUGUST 2018
DRAWN BY:	DC
SCALE:	
SHEET NO:	L1.01

$\widetilde{\mathbf{N}}$	
\bigcirc	
I	
\geq	
Y	
Π	
Ζ	
Π	
Ш	
>	
Ш	
Ш	

0

 $\overline{}$

ATTACHMENT 16


ဟ

5: MIN. SIDE SETBACK			
Edis: NIW S BOIS: OLLS IN STREET TREE CALCULATIONS [142.0409]		
35TH STREET LENGTH OF STREET FRONTAGE STREET TREES REQUIRED ((1) 24" BOX PER 30 STREET TREES PROVIDED LANDSCAPE CALCULATIONS [14]	14		ST
STREET YARD [142.0404] TOTAL AREA (BY 35TH STREET)	PLANTING AREA PROVIDED	EXCESS AREA PROVIDED	
2226 SF x 50% = 1113 SF	931 SF	-182 SF	
PLANTING POINTS REQUIRED	PLANTING POINTS PROVIDED	EXCESS POINTS PROVIDED	
2226 SF x 0.05 = 111 POINTS POINTS ACHIEVED WITH TREES (MIN. 50%) POINTS USED TO REDUCE LANDSCARE AREA	603 POINTS 200 POINTS	492 POINTS	
POINTS USED TO REDUCE LANDSCAPE AREA (MAX. 25%) PLANTING AREA PROVIDED AFTER 142.0405(A)(3)	278 POINTS 1209 SF		
REMAINING YARD [142.0405(B)(2)]			
REQUIRED PLANTING AREA	PLANTING AREA PROVIDED	EXCESS AREA PROVIDED	
10228 SQ FT X 30% = 3068 SQ FT	6960 SQ FT	3892 SQ FT	
REQUIRED PLANTING POINTS 10228 SQ FT X 0.05 = 511 POINTS	PLANT POINTS PROVIDED 2776 POINTS	POINTS ACHIEVED WITH TREES (MIN 50%) 1090 POINTS	
VEHICULAR USE AREAS (> 6,000 SF) [142.0406-	142.04.07]		LEGEND

REQUIRED PLANTING AREA PLANTING AREA PROVIDED EXCESS AREA PROVIDED INSIDE STREET YARD 1579 SQ FT 1208 SQ FT 7418 SQ FT X 0.05 = 371 SQ FT REQUIRED PLANT POINTS PLANT POINTS PROVIDED EXCESS POINTS PROVIDED INSIDE STREET YARD 1073 POINTS 523 POINTS 7418 SQ FT X 0.05 = 371 POINTS POINTS PROVIDED WITH TREES (MIN 50%) 550 POINTS

<u>SYMBOL</u>

 \cdot / /

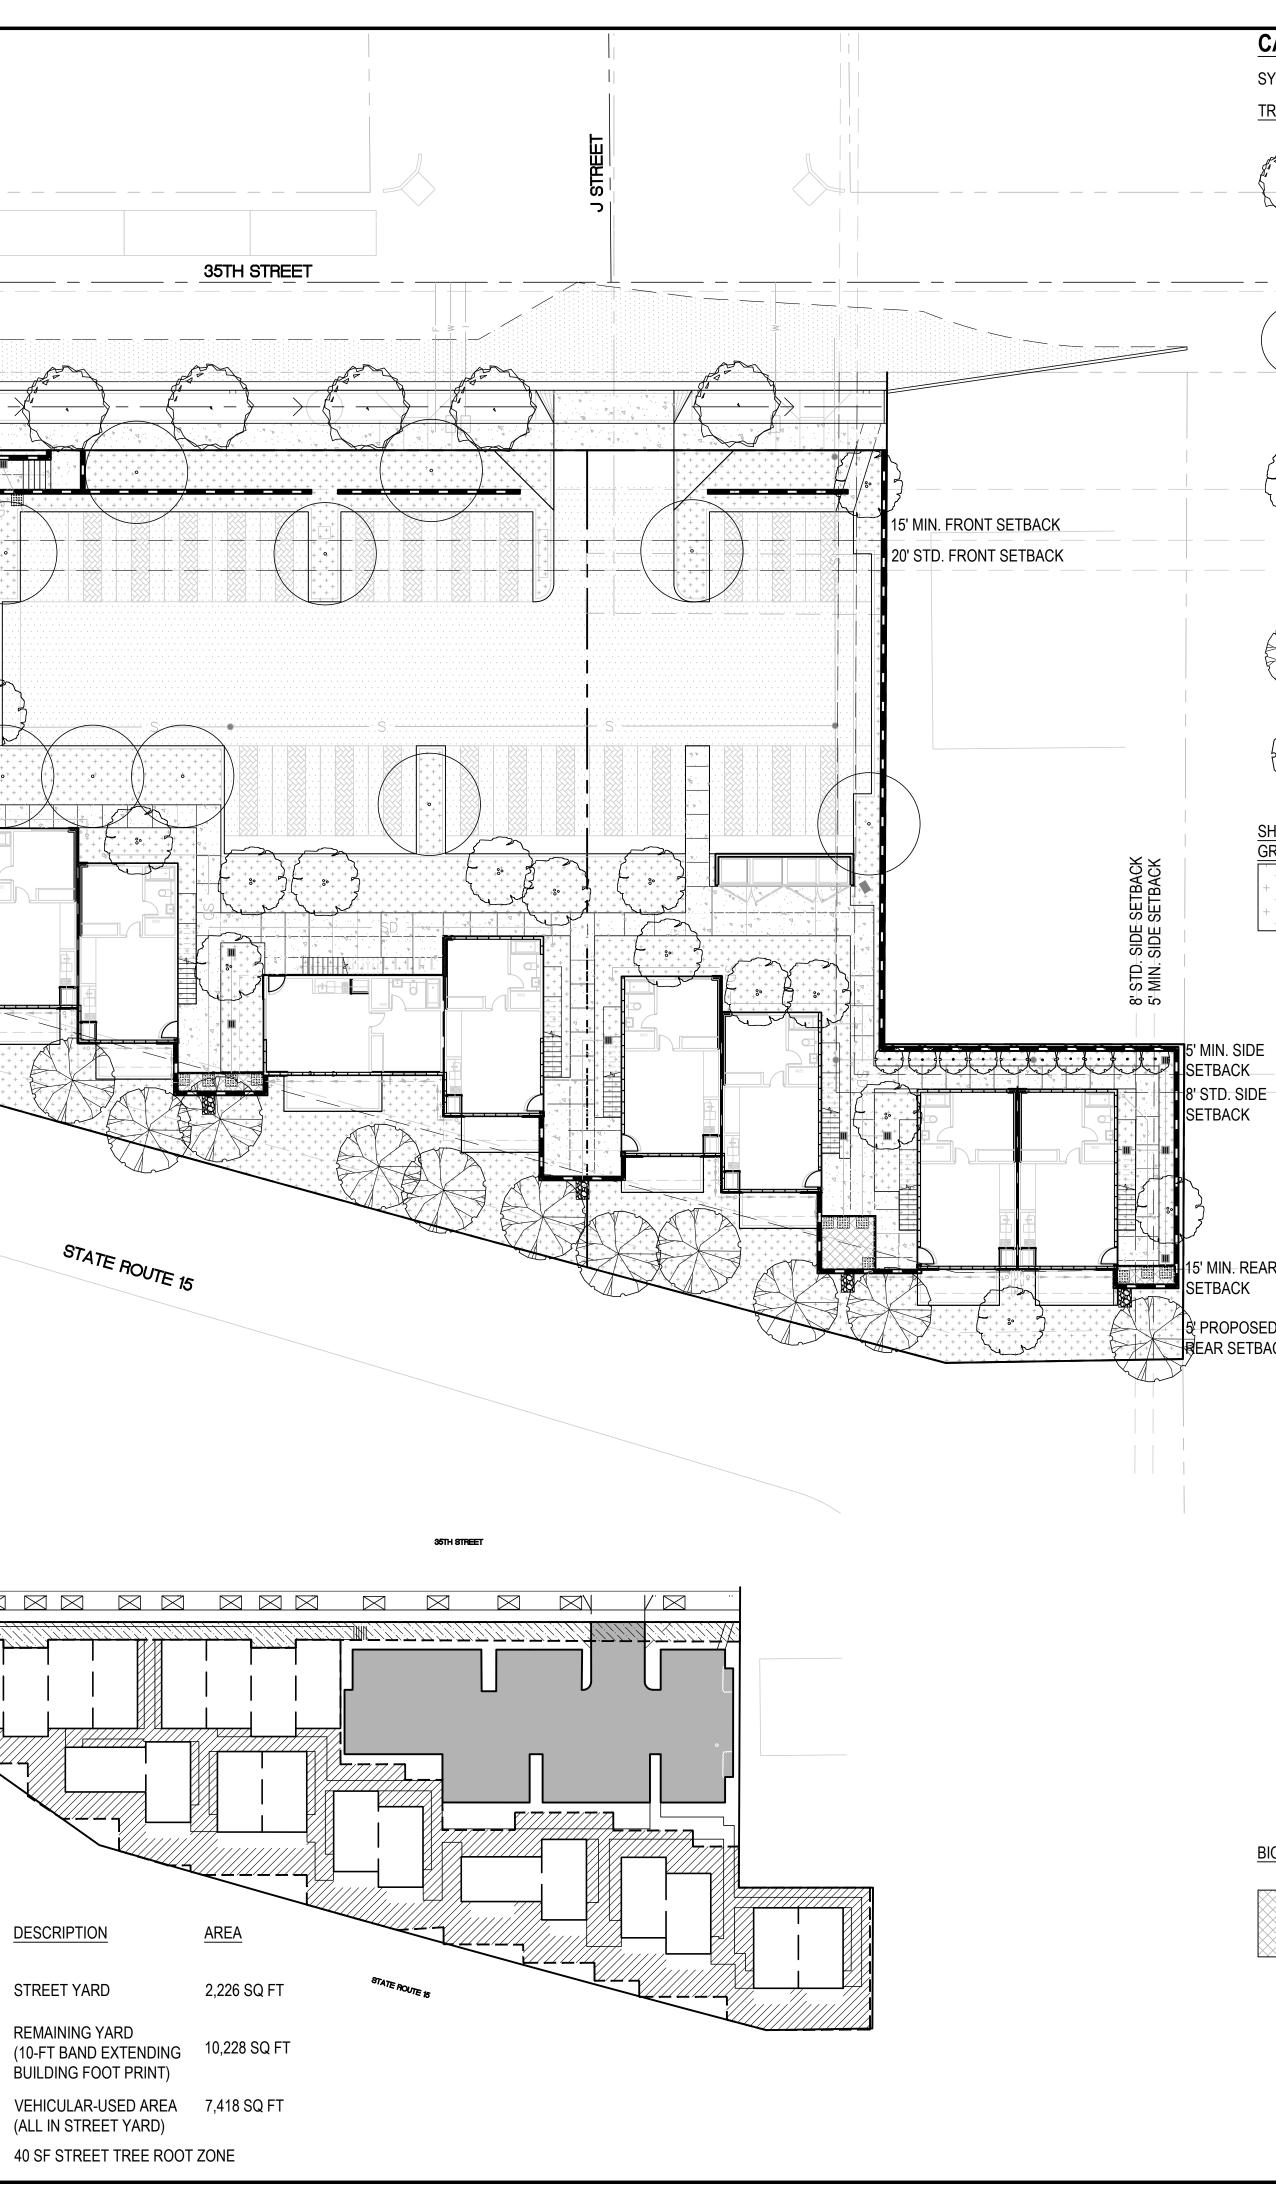

				ATTACHMENT	16
CANDIDATE	E PLANT MATERIAL			Notes:	
SYMBOL	BOTANICAL NAME	DESCRIPTION	SIZE	All ideas, arrangements, drawings and plans set forth on this sheet are the original work product of, owned by and are the property of dbr ds and	
TREES:	<u>STREET TREE</u> PODOCARPUS GRACILIAR	(25'-40' SPREAD)	36" BOX	use of this said work product is limited to a specified project of the purchaser, and for the construction of one building, any use, reuse or disclosure of said plans, reproductions, ideas,	
£ . }	FERN PINE MAGNOLIA GRANDIFLORA			designs and/or arrangements, other than by dbr ds, is strictly prohibited by law without the	
	SOUTHERN MAGNOLIA			written permission of dbr ds. Written dimensions on these drawings shall have precedence over	
• -	KOELREUTERIA PANICULATA GOLDENRAIN TREE			scaled dimensions; contractors shall verify, and be responsible for all dimensions and conditions	
	LOPHOSTEMON CONFERTUS BRISBANE BOX			on the job and this office must be notified of any variations from the dimensions and conditions	
	PINE SSP.			shown these drawings.	
	PARKING LOT TREE				
(• •)	PINUS CANARIENSIS HYMENOSPORUM FLAVUM	(25'-40' SPREAD)	36" BOX	DBRDS	
				DE BARTOLO + RIMANIC DESIGN STUDIO	
	PINUS TORREYANA PINUS ELDARICA				
				PROJECT TEAM	
\sim				TROJECTIEAN	
	SHADE CANOPY/ ACCENT TREE	(25'-40' SPREAD)	36" BOX	OWNER:	
	ULMUS PARVIFOLIA			35TH & J PARTNERS, LLC	
	TABEBUIA IPE ALBIZIA JULIBRISSIN			363 5TH AVE, SUITE 203	
	ARBUTUS 'MARINA'			SAN DIEGO, CA 92101	
	LIQUIDAMBER STYRACIFLUA 'PALO ALTO' CERCIS OCCIDENTALIS			PHONE: (858) 220-5262 CONTACT: PAULY DE BARTOLO	
	BETULA PAPYRIFERA			EMAIL: pauly@dbrds.com	
AA	TREE ON SLOPE			DESIGN:	
		(15'-20' SPREAD)	24" BOX	DE BARTOLO + RIMANIC DESIGN STUDIO	
	PINUS TORREYANA			363 5TH AVE, SUITE 203	
~~~~~~~~~~~~~~~~~~~~~~~~~~~~~~~~~~~~~~~				SAN DIEGO CA 92101	
{ • }	CUPRESSUS SEMPERVIRENS 'MONSHEL' PODOCARPUS GRACILIOR	(15'-18' HIGH)	24" BOX	PHONE: (858) 220-5262 CONTACT: PAULY DE BARTOLO	
La de la della del	PODOCARPUS MACROPHYLLUS			EMAIL: pauly@dbrds.com	
	BAMBUSA MULTIPLEX 'ALPHONSE KARR'				
SHRUBS, VINES	—			SNIPES-DYE ASSOCIATES	
GROUNDCOVER	· -			8348 CENTER DRIVE, SUITE G LA MESA, CA 91942	
+ $+$ $+$ $+$ $+$ $+$	EVERGREEN ACCENT SHRUB			PHONE: (619) 697-9234	
+ + + + + + + + + + + + + + + + + + +		2'-4' HT., 3'-4' O.C.	50% MIN. 5 GAL.	CONTACT: BILL SNIPES EMAIL: bill@snipesdye.com	
•	STRELITZIA REGINAE STRELITZIA NICHOLAI	4'-5' HT., 4' O.C. 8'-10' HT.	50% MIN. 15 GAL. 50% MIN. 15 GAL.		
	AGAPANTHUS AFRICANUS	2'-3' HT., 2' O.C.	50% MIN. 5 GAL.	LANDSCAPE ARCHITECTURE	
	CLIVIA MINIATA	1'-2' HT., 18" O.C.	50% MIN. 5 GAL.	McCULLOUGH LANDSCAPE ARCHITECTURE	
	LEPTOSPERMUM LAEVIGATUM	2'-3' HT., 2' O.C.	50% MIN. 5 GAL.	703 16TH STREET, SUITE 100 SAN DIEGO, CA 92101	
	LOMANDRA LONGIFOLIA	2'-3' HT., 2' O.C.	50% MIN. 5 GAL.	PHONE: (619) 296-3150	
E	EVERGREEN SCREENING SHRUB			CONTACT: DAVID MCCULLOUGH EMAIL: david@mlasd.com	
	PITTOSPORUM TOBIRA 'VARIEGATA' XYLOSMA CONGESTUM 'COMPACTA'	4'-5' HT., 4' O.C. 3'-4' HT., 3' O.C.	50% MIN. 5 GAL. 50% MIN. 5 GAL.	SURVEYOR	
	LIGUSTRUM JAPONICUM 'TEXANUM'	4'-5' HT., 4' O.C.	50% MIN. 5 GAL.	SPEAR & ASSOCIATES, INC.	0)
	FIEJOA SELLOWIANA	4'-5' HT., 4' O.C.	50% MIN. 5 GAL.	475 PRODUCTION STREET	
	EUGENIA UNIFLORA	10'-25' HT., 6' O.C.	50% MIN. 5 GAL.	SAN MARCOS, CA 92078	0
	EVERGREEN FLOWERING VINE			PHONE: (760) 736-2040 CONTACT: RAY SPEAR	$\sim$
	GREWIA OCCIDENTALIS		50% MIN. 5 GAL.	EMAIL: rspear@spearinc.net	<b>N</b>
AR —			50% MIN. 5 GAL. 50% MIN. 5 GAL.		
	CLYTOSTOMA CALLISTEGIOIDES BOUGAINVILLEA SPP.		50% MIN. 5 GAL.		
ED — BACK	DISTICTIS SPP.		50% MIN. 5 GAL.	FORTON	$\sim$
	PYROSTEGIA VENUSTA		50% MIN. 5 GAL.	NOT FOR CONSTRUCTION	Ō
	ROSA SPP.		50% MIN. 5 GAL.	ONSI	
			50% MIN. 5 GAL.		
	WISTERIA SINENSIS EVERGREEN FLOWERING GROUND COVER		50% MIN. 5 GAL.		
	FESTUCA OVINA 'GLAUCA'	10" HT., 12" O.C.	5 GAL.		
	LIRIOPE MUSCARI	24" HT., 18" O.C.	5 GAL.	REVISION:	RM
	CRASSULA FALCATA	12" HT., 12" O.C.	5 GAL.	04.13.2017 DRAWN BY: CH	
	ROSMARINUS OFFICINALIS	18" HT., 18" O.C.	FLATS	COMPLETENESS CHECK SUBMITTAL 06.13.2017 DRAWN BY: DC	
	BOUGAINVILLEA 'RASBERRY ICE'	24" HT., 30" O.C.	5 GAL.	SITE DEVELOPMENT PERMIT	Ш
	SENECIO MANDRALISCAE ECHEVERIA HYBRIDS	12" HT., 12" O.C. 6" HT., 10" O.C.	4" POTS 4" POTS	09.15.2017 DRAWN BY: DC REVIEW COMMENTS	$\overline{\mathbf{n}}$
	ARMERIA MARITIMA	6" HT., 6" O.C.	FLATS	04.11.2018 DRAWN BY: DC	
	AGAPANTHUS 'PETER PAN'	10" HT., 6" O.C.	FLATS	REVIEW COMMENTS 2 06.25.2018 DRAWN BY: DC	
	CEANOTHUS GRISEUS HORIZONTALIS	24" HT., 36" O.C.	5 GAL.	CITY PLANNER COMMENTS	Ż
		8" HT., 12" O.C.	FLATS	08.28.2018 DRAWN BY: DC REVISION	
	MYOPORUM PACIFICUM THYMUS PRAECOX ARCTICUS 'REITER'S'	18" HT., 24" O.C. 8" HT., 8" O.C.	FLATS FLATS	07.17.2019 DRAWN BY: MB	
	TRACHELOSPERMUM JASMINOIDES	18" HT., 18" O.C.	5 GAL.	DRAWING TITLE:	Σ
	HEUCHERA SANGUINEA	8" HT., 8" O.C.	5 GAL.	LANDSCAPE CALCULATION	$\leq$
V	GAZANIA SPP.	8" HT., 8" O.C.	FLATS	& PLANT SCHEDULE	
BIORETENTION S	SHRUBS			PROJECT:	$\bigcirc$
	CAREX BROMOIDES / BROME-LIKE SEDGE		1 GAL.	PROPOSED SMALL LOT	
	CAREX PHYLLOCEPHALA `SPARKLER` / SEDG		1 GAL.	SUBDIVISION PROJECT	
	DIANELLA CAERULEA `CASSA BLUE` / CASSA I DIANELLA TASMANICA / FLAX LILY	BLUE FLAX LILY	1 GAL. 1 GAL.	545-260-13-00, 14-00, 15-00	Ш >
	GAURA LINDHEIMERI / WHITE GAURA MUHLENBERGIA CAPILLARIS / PINK MUHLY		1 GAL. 1 GAL.	CORNER OF 35TH ST & J ST	>
	MUHLENBERGIA LINDHEIMERI / LINDHEIMER`S		1 GAL.	SAN DIEGO CA 92102	Í
	NASSELLA TENUISSIMA / TEXAS NEEDLE GRA YUCCA FILAMENTOSA / ADAM`S NEEDLE	00	1 GAL. 1 GAL.		Ц
				DBRDS PROJECT NO: 15005	$\square$
				DATE: AUGUST 2018	щ
		16 32		DRAWN BY: DC	
	SCALE:	1/16"=1'-0"		SCALE:	S
					U)
				SHEET NO: L1.02	



Reference Evapotranspi	ration (ET _o )	47	Proj	ect Type	Residen	tial	0.5
Hydrozone # / Planting	Plant	Irrigation	Irrigation	ETAF	Landscape	ETAF x	Estimated Total
Description ^a	Factor (PF)		Efficiency	(PF/IE)	Area (Sq. Ft.)	Area	Water Use
Decempteri			(IE) ^c	,			(ETWU) ^d
Regular Landscape Are	as		[(-)				()
1	0.4	Drip	0.81	0.49	1424	703	2049
2		Drip	0.81	0.49	2975	1469	4281
3		Drip	0.81	0.49	1955	965	2813
4		Overhead	0.75	0.53	5317	2836	8263
5	0.3	Drip	0.81	0.37	285	106	307
			0.75	0.00		0	
			0.75	0.00		0	
			0.75	0.00		0	
			0.75	0.00		0	
			0.75			0	
			0.75	0.00		0	
			0.75	0.00		0	
				Totals	11956	6079	17714
Special Landscape Area	as						
				1		0	
				1		0	
				1		0	
				1		0	
				Totals	0	0	
					ET	NU Total	17714
			Maximum Allo	wed Wa	ter Allowance (	MAWA) ^e	19161
ETAF Calculations							
Regular Landscape Area		1	-		r Regular		
Total ETAF x Area	6079		-		st be 0.55 or		
Total Area	11956	4			l areas, and		
Average ETAF	0.51		0.45 or belo	w for no	n-residential		
				areas.			

# WATER CONSERVATION STATEMENT

IN RECOGNITION OF WATER AS A LIMITED RESOURCE IN SOUTHERN CALIFORNIA, THE FOLLOWING MEASURES WILL BE UNDERTAKEN TO REDUCE THIS PROJECT'S DEMAND ON THE CITY OF SAN DIEGO'S AVAILABLE WATER SUPPLY:

- EXPOSURE.
- EAST, AND WEST EXPOSURES.
- ROOT ZONES.

1. THE IRRIGATION SYSTEM WILL BE AUTOMATIC AND WILL INCORPORATE LOW VOLUME SPRAY EMITTERS AND CONVENTIONAL LOW ANGLE SPRAY HEADS. DRIP IRRIGATION SYSTEMS MAY BE EMPLOYED WHERE CONSIDERED TO BE EFFECTIVE AND FEASIBLE. IRRIGATION VALVES SHALL BE SEGREGATED TO ALLOW FOR THE SYSTEM OPERATION IN RESPONSE TO ORIENTATION AND

2. TURF WILL BE RESTRICTED TO HIGHLY VISIBLE STREET FRONT AREAS AND/OR AREAS WHICH MAY RECEIVE SIGNIFICANT AMOUNTS OF USE AND ENJOYMENT BY THE GUESTS. THE SPECIFIED TURF WILL HAVE RELATIVELY LOW WATER AND MAINTENANCE REQUIREMENTS.

3. PLANT MATERIAL WILL BE SPECIFIED IN CONSIDERATION OF NORTH, SOUTH,

4. SOIL WILL BE AMENDED AND PREPARED TO PROVIDE HEALTHY PLANT GROWTH AND COVERAGE AND TO PROVIDE FOR MAXIMUM MOISTURE RETENTION AND PERCOLATION. PLANTER BEDS WILL BE MULCHED TO RETAIN SOIL MOISTURE AND REDUCE EVAPOTRANSPIRATION FROM THE

5. AN IRRIGATION SYSTEM SHALL BE PROVIDED AS REQUIRED FOR THE PROPER IRRIGATION, DEVELOPMENT AND MAINTENANCE OF THE VEGETATION. THE DESIGN OF THE SYSTEM SHALL PROVIDE ADEQUATE SUPPORT OF THE VEGETATION SELECTED.

#### LEGEND



	ATTACHMENT	<u> 16                                   </u>
	Notes: All ideas, arrangements, drawings and plans set forth on this sheet are the original work product of, owned by and are the property of <b>dbr</b> ds and use of this said work product is limited to a specified project of the purchaser, and for the construction of one building, any use, reuse or disclosure of said plans, reproductions, ideas, designs and/or arrangements, other than by <b>dbr</b> ds, is strictly prohibited by law without the written permission of <b>dbr</b> ds. Written dimensions on these drawings shall have precedence over scaled dimensions; contractors shall verify, and be responsible for all dimensions and conditions on the job and this office must be notified of any variations from the dimensions and conditions shown these drawings.	
	DBRDS DE BARTOLO + RIMANIC DESIGN STUDIO	
	PROJECT TEAM	
RONT SETBACKRONT SETBACK	OWNER: <b>35TH &amp; J PARTNERS, LLC</b> 363 5TH AVE, SUITE 203 SAN DIEGO, CA 92101 PHONE: (858) 220-5262 CONTACT: PAULY DE BARTOLO EMAIL: pauly@dbrds.com DESIGN: DE BARTOLO + RIMANIC DESIGN STUDIO	
	363 5TH AVE, SUITE 203 SAN DIEGO CA 92101 PHONE: (858) 220-5262 CONTACT: PAULY DE BARTOLO EMAIL: pauly@dbrds.com CIVIL ENGINEER SNIPES-DYE ASSOCIATES	
8" STD. SIDE SETBACK 5" MIN. SIDE SETBACK	8348 CENTER DRIVE, SUITE G LA MESA, CA 91942 PHONE: (619) 697-9234 CONTACT: BILL SNIPES EMAIL: bill@snipesdye.com LANDSCAPE ARCHITECTURE McCULLOUGH LANDSCAPE ARCHITECTURE 703 16TH STREET, SUITE 100 SAN DIEGO, CA 92101 PHONE: (619) 296-3150 CONTACT: DAVID MCCULLOUGH	
5' MIN. SIDE SETBACK 8' STD. SIDE SETBACK 15' MIN. REAR SETBACK 9' PROPOSED BEAR SETBACK	EMAIL:       david@mlasd.com         SURVEYOR         SPEAR & ASSOCIATES, INC.         475 PRODUCTION STREET         SAN MARCOS, CA 92078         PHONE:       (760) 736-2040         CONTACT:       RAY SPEAR         EMAIL:       rspear@spearinc.net	T - 07.17.2019
	REVISION:04.13.2017DRAWN BY: CHCOMPLETENESS CHECK SUBMITTAL06.13.2017DRAWN BY: DCSITE DEVELOPMENT PERMIT09.15.2017DRAWN BY: DCREVIEW COMMENTS04.11.2018DRAWN BY: DCREVIEW COMMENTS 206.25.2018DRAWN BY: DCCITY PLANNER COMMENTS08.28.2018DRAWN BY: DCREVISION07.17.2019DRAWN BY: MBDRAWING TITLE:LANDSCAPE MAWACALCULATIONPROJECT:PROPOSED SMALL LOTSUBDIVISION PROJECT5.45.260.13.00.14.00.15.00	ELOPMENT PERMIT
z 0 8 16 32 SCALE: 1/16"=1'-0"	545-260-13-00, 14-00, 15-00         CORNER OF 35TH ST & J ST         SAN DIEGO CA 92102         DBRDS PROJECT NO:         15005         DATE:         AUGUST 2018         DRAWN BY:       DC         SCALE:	SITE DEVEI
	SHEET NO: L1.03	U





## SHRUB, VINE & GROUNDCOVER





**ATTACHMENT 16** 

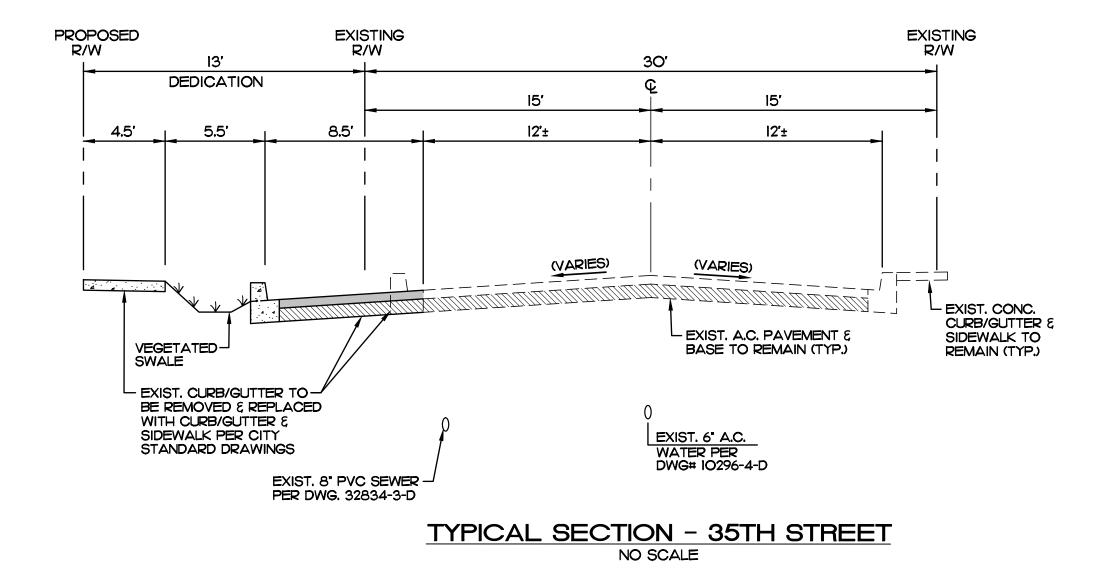

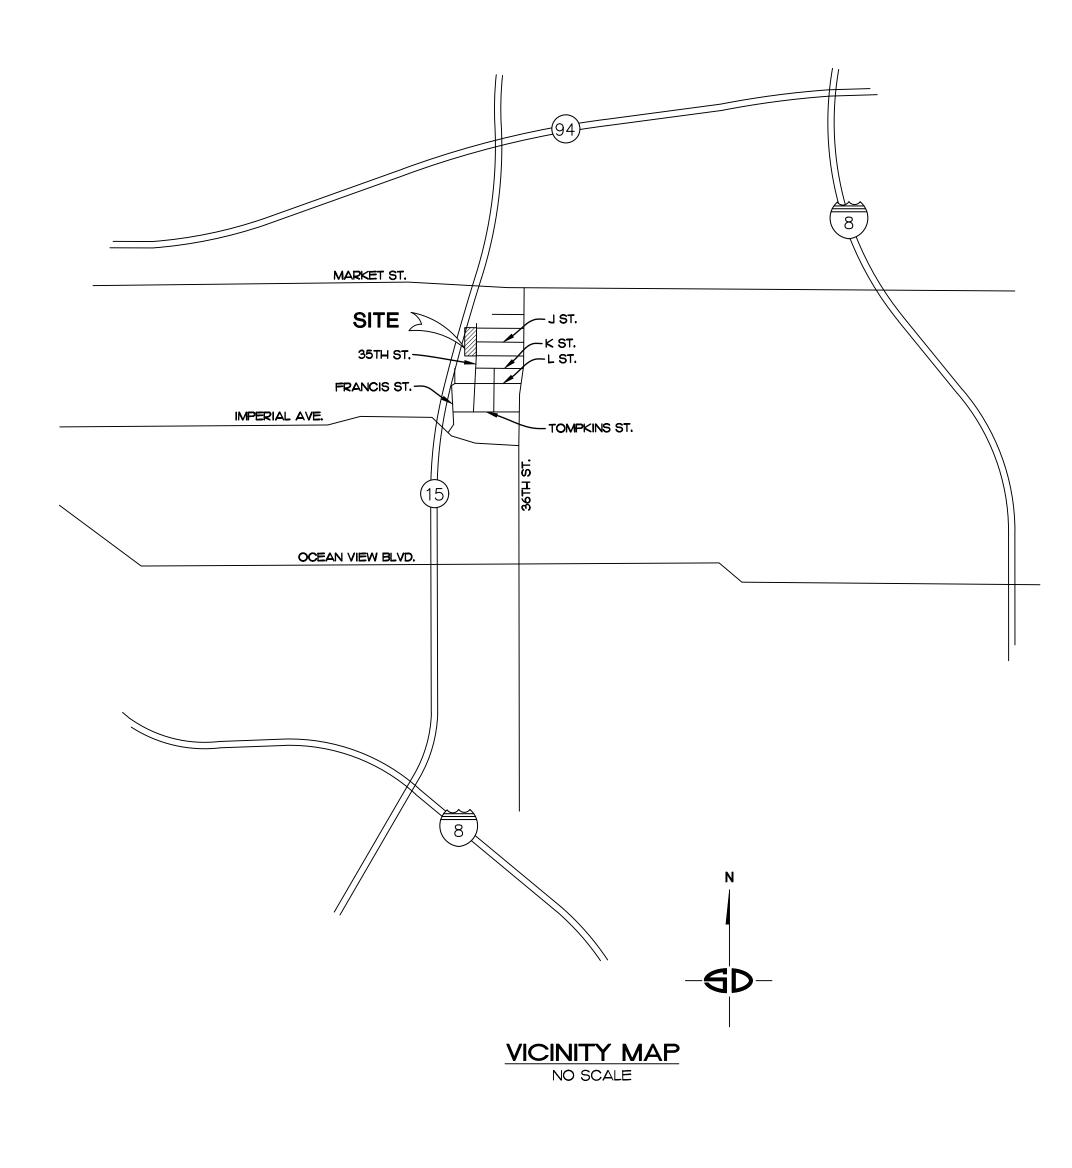

# TENTATIVE MAP NO. 1937933 FOR 35TH STREET SMALL LOT SUBDIVISION

#### AREA

GROSS AREA = 0.89 ACRES NET AREA = 0.80 ACRES

#### ACCESS NOTE

ACCESS TO SUBJECT PROPERTY : 35TH STREET

#### FLOOD ZONE

THE PROPERTY DESCRIBED ON THIS SURVEY DOES NOT LIE WITHIN A SPECIAL FLOOD HAZARD AREA ("SFHA") AS DEFINED BY THE FEDERAL EMERGENCY MANAGEMETN AGENCY. THE PROPERTY LIES WITHIN ZONE "X" OF THE FLOOD INSURANCE INSURANCE RATE MAP AS IDENTIFIED AS COMMUNITY MAP NO. 06073CI903IF BEARING AN EFFECTIVE DATE OF JUNE 19, 1997, PANEL 1903 OF 2375.

#### GENERAL NOTE

I. NUMBER OF EXISTING LOTS : 3 NUMBER OF PROPOSED LOTS : 21

- 2. NO EXISTING OR PROPOSED BUS STOPS ADJACENT TO SUBJECT PROPERTY.
- 3. ALL ONSITE UTILITY SERVICES SHALL BE PLACED UNDERGROUND.

#### UTILITIES

SEWER AND WATER - CITY OF SAN DIEGO STORM DRAIN - CITY OF SAN DIEGO GAS AND ELECTRIC - SAN DIEGO GAS & ELECTRIC TELEPHONE - ATET FIRE & POLICE - CITY OF SAN DIEGO TELEVISION - COX COMMUNICATIONS SCHOOL DISTRICT - CITY OF SAN DIEGO

#### LEGAL DESCRIPTION

A PORTION OF THE NORTHEAST QUARTER OF PUEBLO LOT 1152, IN THE CITY OF SAN DIEGO, COUNTY OF SAN DIEGO, STATE OF CALIFORNIA, ACCORDING TO MAP MADE BY JAMES PASCOE IN 1870, A COPY OF WHICH SAID MAP WAS FILED IN THE OFFICE OF THE COUNTY RECORDER OF SAN DIEGO COUNTY, NOVEMBER 14, 1921, AND IS KNOWN AS MM NO. 36.

#### ASSESSOR'S PARCEL NO.

#### 545-260-13, 14 E 15

#### COORDINATE INDEX

NAD 27 - 198, 1731 NAD 83 - 1838, 6291

#### TOPOGRAPHIC SOURCE

SPEAR & ASSOCIATES 475 PRODUCTION STREET SAN MARCOS, CA 92078 FIELD SURVEY DATE : MAY 7, 2015

#### **ZONING INFORMATION**

EXISTING/PROPOSED ZONE : RM-I-I SOUTHEASTERN SAN DIEGO PLANNED DISTRICT TRANSIT AREA OVERLAY ZONE WITHIN SOUTHEASTERN SAN DIEGO COMMUNITY PLAN AREA

#### BENCHMARK

CITY OF SAN DIEGO SWBP INTERSECTION OF PARDEE STREET AND L STREET (NO. 15127) ELEVATION = 91.04, NGVD 29 MSL

#### SHEET INDEX

- CI TITLE/NOTE SHEET
- C2 TENTATIVE MAP I OF 2 C3 - TENTATIVE MAP 2 OF 2
- C4 CONCEPTUAL GRADING/UTILITY PLAN 1 OF 2 C5 - CONCEPTUAL GRADING/UTILITY PLAN 2 OF 2

#### MAPPING NOTE

A FINAL MAP SHALL BE FILED AT THE COUNTY RECORDER'S OFFICE PRIOR TO THE EXPIRATION OF THE TENTATIVE MAP, IF APPROVED. A DETAILED PROCEDURE OF SURVEY SHALL BE SHOWN ON THE FINAL MAP AND ALL PROPERTY CORNERS SHALL BE MARKED WITH DURABLE SURVEY MONUMENTS.

#### **PROJECT NOTES**

- THIS PROJECT WILL NOT DISCHARGE ANY INCREASE IN STORM WATER RUN-OFF ONTO THE EXISTING HILLSIDE AREAS. PLEASE REFER TO EXISTING AND PROPOSED DRAINAGE MAP FOR COMPLIANCE.
- 2. AT THE STORM WATER DISCHARGE LOCATIONS, SUITABLE ENERGY DISSIPATORS ARE TO BE INSTALLED TO REDUCE THE DISCHARGE TO NON-ERODIBLE VELOCITIES.
- 3. MULTIPLE STORM WATER DISCHARGE LOCATIONS OR OTHER SIMILAR DEVICES SHALL BE USED TO MIMIC THE EXISTING DRAINAGE SYSTEM.
- 4. NO ADDITIONAL RUN-OFF IS PROPOSED FOR THE DISCHARGE LOCATIONS.
- 5. ALL NEW PUBLIC IMPROVEMENTS SHALL BE PER CITY STANDARDS.
- 6. ALL NON-UTILITIZED DRIVEWAYS ALONG THE PROJECT FRONTAGE SHALL BE CLOSED AND REPLACED WITH CURB, GUTTER & SIDEWALK PER CITY STANDARDS.
- 7. AN EMRA WILL BE REQUIRED FOR CURB OUTLET.
- 8. ALL STORM WATER BMPS, INCLUDING BIOFILTRATION SYSTEMS, SHALL BE IN ACCORDANCE WITH THE CITY OF SAN DIEGO STORM WATER STANDARDS.
- 9. PRIOR TO THE ISSUANCE OF ANY CONSTRUCTION PERMIT, THE OWNER/PERMITEE SHALL ENTER INTO A MAINTENANCE AGREEMENT FOR THE ONGOING PERMANENT BMP MAINTENANCE, SATISFACTORY TO THE CITY ENGINEER, IF NECESSARY.
- IO. PRIOR TO THE ISSUANCE OF ANY CONSTRUCTION PERMIT, THE OWNER/PERMITEE SHALL INCORPORATE ANY CONSTRUCTION BEST MANAGEMENT PRACTICE NECESSARY TO COMPLY WITH CHAPTER 14, ARTICLE 2, DIVISION I (GRADING REGULATIONS) OF THE SAN DIEGO MUNICIPAL CODE, INTO THE CONSTRUCTION PLANS OR SPECIFICATIONS, AS NECESSARY.
- II. PRIOR TO THE ISSUANCE OF ANY CONSTRUCTION PERMIT, THE OWNER/PERMITEE SHALL SUBMIT A WATER POLLUTION CONTROL PLAN (WPCP). THE WPCP SHALL BE PREPARED IN ACCORDANCE WITH THE GUIDELINES IN PART 2 CONSTRUCTION BMP STANDARDS, CHAPTER 4 OF THE CITY'S STORM WATER STANDARDS.
- 12. THE OWNER/PERMITEE ACKNOWLEDGES THE REQUIREMENT TO IMPLEMENT THE SPECIFIC PALEONTOLOGICAL RESOURCES MITIGATION, MONITORING AND REPORTING PROGRAM REQUIREMENTS.

#### UTILITY TABLE

#	UTILITY	CONDITION	LOCATION	OVERHEAD/UNDERGROU
	8" PVC SEWER	EXISTING	PUBLIC ROW	UNDERGROUND
2>	6" AC WATER	EXISTING	PUBLIC ROW	UNDERGROUND
3>	ELECTRICAL/TELECOM	EXISTING	PUBLIC ROW	OVERHEAD
4>	6" SEWER SERVICE (PRIVATE)	PROPOSED	ON-SITE	UNDERGROUND
5>	SD CULVERT (PRIVATE)	PROPOSED	ON-SITE	UNDERGROUND
6	ELECTRICAL	EXISTING	ON-SITE	OVERHEAD
7>	4" FIRE SERVICE	PROPOSED	PUBLIC ROW	UNDERGROUND
8>	2" POTABLE WATER	PROPOSED	PUBLIC ROW	UNDERGROUND
9>	2" IRRIGATION SERVICE	PROPOSED	PUBLIC ROW	UNDERGROUND
0	6" SEWER SERVICE (PRIVATE)	PROPOSED	PUBLIC ROW	UNDERGROUND

# OWNER/APPLICANT/DEVE

35TH ξ J PARTNERS, LLC 363 5TH AVENUE, #203 SAN DIEGO, CA 92101

MICHAEL DONOVAN

#### DATE

#### ENGINEER OF WORK

#### Snipes-Dye associates civil engineers and land surveyors

3348 CENTER DRIVE, STE. G, LA MESA, CA 91942 (19) 697-9234 FAX (619) 460-2033 8/14/19 R.C.E. 50477 A. SNIPES R.C.E EXPIRES 06-30-21 WILLIAM

# **ATTACHMENT 16**


2' WATER SERVICE	2910 (619) 697-9234, FAX (619) 460-2033
TEM       STMBOL         CENTER INE	910 (619) 697-9234, FAX (619) 460-203
RIGHT OF WAY       Right OF WAY         PROPERTY LINE/TM BOLDDARY       Right OF WAY         RINET, FLOW DIRECTION       RINET, FLOW DIRECTION         RINET, FLOW DIRECTION       RINET, SEWER LINE         RINET, ROWER POLE       RINET, SEWER LINE         RINET, ROWER POLE       RINET, SEWER LINE         RINET, ROWER POLE       RINET, SEWER WOLLMENTS, AS NOTED         RINET, SEWER WOLLMENTS, AS NOTED       RINET, SEWER WOLLMENTS, AS NOTED         RINET, SEWER WOLLMENTS, AS NOTED       RINET, SEWER WOLLMENTS, AS NOTED         RINET, SEWER WOLLMENTS, AS NOTED       RINET, SEWER WAY         RINET, SEWER WAY       RINET         RINET, SEWER WAY       RINET, SEWER WAY         RINET, SEWER WAY       RINET         RINET, SEWER WAY       RINET <td>910 (619) 697-9234, FAX (619) 460-203</td>	910 (619) 697-9234, FAX (619) 460-203
PROPERTY LIVETM BOLINDARY         EXIST, FLOW OF RECTION         EXIST, FLOW FROMENTS, AS NOTED         EXIST, FLOWER POLE         EXIST, CONTOUR         EXIST, FLOWER POLE         EXIST, CONTOUR         EXIST, CONTOUR         EXIST, CONTOUR         EXIST, CONTOUR         EXIST, CONTOUR         EXIST, CONTOUR         EXIST, ELEVATION         CONCRETE SIDEWALK         ON         EXIST, ELEVATION         CLARE CLARANCE         CURB CLARENCE         CIRCUMUT (PRIVATE)         SEMER CLARANCE         EXIST, ELEVATION	910 (619) 697-9234, FAX (619) 460-203
EXIST. CLUB & GLITER   EXIST. FLOW DIRECTION   EXIST. FLOW DIRECTION   EXIST. WATER LINE   EXIST. RECEVER LINE   EXIST. RECEVER LINE   EXIST. FRE +/DRANT   EXIST. SURVEY MONLMENTS, AS NOTED   EXIST. SURVEY MONLMENTS, AS NOTED   EXIST. CONTOLE   EXIST. FRE +/DRANT   EXIST. ELEVATION   X 122 64, 122 64, 124 64, 124 64,	910 (619) 697-9234, FAX (619) 460-203
EXIST. PLOW DIRECTION         EXIST. WATER LIVE         EXIST. WATER LIVE         EXIST. SERVER LIVE         EXIST. SERVER LIVE         EXIST. SERVER MONUMENTS, AS NOTED         EXIST. CONCUL         EXIST. SERVER MONUMENTS, AS NOTED         EXIST. SERVER MONUMENTS, AS NOTED         EXIST. CONCUL         EXIST. CONCUL         EXIST. CONCUL         EXIST. CONCUL         EXIST. CONCUL         EXIST. CONCUL         CONCRETE SIDEWALK         CONCRETE SIDEWALK         CR3 OUT.ET         BACKFLOW PREVENTER (CRIVATE)         SEVER C. EANOLT (RRIVATE)         SEVER C. EANOLT (RRIVATE) </td <td>910 (619) 697-9234, FAX (619) 460-203</td>	910 (619) 697-9234, FAX (619) 460-203
EXST. WATER LINE       w       w       w         EXST. SEWER LINE       S       S         EXST. FIRE ITZRANT       DOI         EXST. FIRE ITZRANT       DOI         EXST. ROWER POLE       S         EXST. CONTOLE       S         EXST. ROWER POLE       S         EXST. ROWER POLE       S         EXST. CONTOLE       S         EXST. CONTOLE       S         EXST. CONTOLE       S         CONCRETE SIDEWALK       S         DRIVEY       S         CONCRETE SIDEWALK       S         DRIVEY       S         SHOTLET       S         BACKLOW PREVENTER (RRIVATE)       S         SWER CLEANOLT CRIVATED       S         CONCRETE SERVICE       T         PERVEABLE PAVENENT FARING LOT SUPACE (SD-C)       S         AC PAVENENT E ASE PER C	910 (619) 697-9234, FAX (619) 460-203
EXST. WATER LINE       w       w       w         EXST. SEWER LINE       S       S         EXST. FIRE ITZRANT       DOI         EXST. FIRE ITZRANT       DOI         EXST. ROWER POLE       S         EXST. CONTOLE       S         EXST. ROWER POLE       S         EXST. ROWER POLE       S         EXST. CONTOLE       S         EXST. CONTOLE       S         EXST. CONTOLE       S         CONCRETE SIDEWALK       S         DRIVEY       S         CONCRETE SIDEWALK       S         DRIVEY       S         SHOTLET       S         BACKLOW PREVENTER (RRIVATE)       S         SWER CLEANOLT CRIVATED       S         CONCRETE SERVICE       T         PERVEABLE PAVENENT FARING LOT SUPACE (SD-C)       S         AC PAVENENT E ASE PER C	910 (619) 697-9234, FAX (619) 460-20
ENST. SEWER LINE       S         ENST. FIRE HYDRAAT       DO         ENST. FIRE HYDRAAT       DO         ENST. COVTOLE       ENST. COVTOLE         ENST. COVTOLE       ENST. CONTOLE         ENST. CONTOLE       ENST. CONTOLE         CORD OUTLET       ENST. CONTOLE         BACKFLOW PREVENTER (RRIVATE)       S         CURB OUTLET       S         BACKFLOW PREVENTER (RRIVATE)       S         CURB OUTLET       S         BACKFLOW PREVENTER (RRIVATE)       S         CURB OUTLET       S         BACKFLOW PREVENTER (RRIVATE)       S         SERVER CEANOLF (PRIVATE)       S         <	910 (619) 697-9234, FAX (619) 460-
EXIST. FIRE HYDRANT       DOC         EXIST. FORMER FOLE       EXIST. CONTOL®         EXIST. CONTOL®       X 123.64, 123.64, 124.64, 124.64, 124	910 (619) 697-9234, FAX (619) 46
EXIST. POWER PICE EXIST. SURVEY MONLMENTS, AS NOTED CONCRETE SIDEWALK CONCRETE SID	910 (619) 697-9234, FAX (619) 4
EXIST. FORMER POLE EXIST. SURVEY MONLIMENTS, AS NOTED EXIST. SURVEY AND A CONTROL EXIST. SURVEY AND A CONTROL OVERETE SIDEWALK  PROPOSED OF THE GOURD & GUTTER ORNER (PRIVATE) OF THE GOURD & GUTTER OF	910 (619) 697-9234, FAX (619) -
ENST. CONTOLE       123.64       123.64       910 (619) 697-9234, FAX (61
EXIST. CONTOUR EXIST.	910 (619) 697-9234, FAX (
PROPOSED       * TYPE & QLR8 & BUTTER	910 (619) 697-9234, FAX (
PROPOSED       * TYPE & QLR8 & BUTTER	910 (619) 697-923
6" TIPE 6 CURB & GUTTER       Image: Concrete spoewalk       Image: Concrete spoewalk         DRIVEWAY       Image: Concrete spoewalk       Image: Concrete spoewalk         DRIVEWAY       Image: Concrete spoewalk       Image: Concrete spoewalk         CLRB QUTLET       Image: Concrete spoewalk       Image: Concrete spoewalk         BACK=LOW PREVENTER (PRIVATE)       Image: Concrete spoewalk       Image: Concrete spoewalk         6" FIRE SERVICE       Image: Concrete spoewalk       Image: Concrete spoewalk         2" WATER SERVICE       Image: Concrete spoewalk       Image: Concrete spoewalk         2" WATER SERVICE       Image: Concrete spoewalk       Image: Concrete spoewalk         2" REFAILE PAVEVENT PARKING LOT SLEFACE (SD C)       Image: Concrete spoewalk       Image: Concrete spoewalk         PERVIOUS PAVERS SIDEWALK SURFACE (SD C)       Image: Concrete spoewalk       Image: Concrete spoewalk       Image: Concrete spoewalk         10C       HOUSING LNIT WITH GREEN ROOF       Image: Concrete spoewalk       Image: Concrete spoewalk       Image: Concrete spoewalk       Image: Concrete spoewalk         10C       Image: Concrete spoewalk	910 (619) 697-923
CONCRETE SIDEWALK       Image: Concrete Sidewalk         DRIVEWAY       Image: Concrete Sidewalk         CLR3 OUTLET       Image: Concrete Sidewalk         BACKFLOW PREVENTER (PRIVATE)       Image: Concrete Sidewalk         6' FREE SERVICE       F         2' WATER SERVICE       F         6' SEWER LATERAL (PRIVATE)       S         SEWER CLEANOUT (PRIVATE)       SSOO         2' IRRIGATION SERVICE       Image: Concrete Sidewalk         PERVICUS PAVERS SIDEWALK SURFACE (SD-C)       Image: Concrete Sidewalk         ID RECTION OF PLOW       Image: Concrete Sidewalk       Image: Concrete Sidewalk         ID RECTION OF PLOW       Image: Concrete Sidewalk       Image: Concrete Sidewalk       Image: Concrete Sidewalk         ID RECENT CONCRETE SPLASH PAD       Image: Concrete Sidewalk       Image: Concrete Sidewalk       Image: Concrete Sidewalk	910 (619) 697-923
CONCRETE SIDEWALK	910 (619) 697-923
CURB OUTLET       Image: Comparison of the service         6' FIRE SERVICE       F         2' WATER SERVICE       F         6' SEWER LATERAL (PRIVATE)       S         5' SEWER LATERAL (PRIVATE)       S         5' SEWER LATERAL (PRIVATE)       S         2' WATER SERVICE       Image: Comparison of the service         2' IRRIGATION SERVICE       Image: Comparison of the service         2' IRRIGATION SERVICE       Image: Comparison of the service         PROPOSED CONTOUR       II350         SPOT ELEVATION       II350         PERMEABLE PAVEMENT PARKING LOT SURFACE (SD-C)       Image: Comparison of the service         AC, PAVEMENT & BASE PER CITY STANDARDS       Image: Comparison of the service         RETAINING WALL       Image: Comparison of the service       Image: Comparison of the service         AC, PAVEMENT & BASE PER CITY STANDARDS       Image: Comparison of the service       Image: Comparison of the service         ID       HOUSING UNIT WITH GREEN ROOF       Image: Comparison of the service       Image: Comparison of the service         ID       HOUSING UNIT WITH GREEN ROOF       Image: Comparison of the service       Image: Comparison of the service         ID       Image: Comparison of the service       Image: Comparison of the service       Image: Comparison of the service       Image: Comparison of the	910 (619) 697-9
CURB OUTLET       Image: Comparison of the service         6' FIRE SERVICE       F         2' WATER SERVICE       F         6' SEWER LATERAL (PRIVATE)       S         SEWER CLEANOUT (PRIVATE)       S         SEWER CLEANOUT (PRIVATE)       S         SEWER CLEANOUT (PRIVATE)       S         SEWER CLEANOUT (PRIVATE)       S         SPOT ELEVATION       III350         PERVICUS PAVERS SIDEWALK SURFACE (SD-C)       IIII         AC, PAVEMENT E BASE PER CITY STANDARDS       IIIIIIIIIIIIIIIIIIIIIIIIIIIIIIIIIIII	910 (619) 697-
CLRB OUTLET       Image: ClrB OUTLET         BACKFLOW PREVENTER (PRIVATE)       Image: ClrB OUTLET         6' FIRE SERVICE       Image: ClrB OUTLET         2' WATER SERVICE       Image: ClrB OUTLET         2' WATER SERVICE       Image: ClrB OUTLET         2' REGATION SERVICE       Image: ClrB OUTLET         2' IRRIGATION SERVICE       Image: ClrB OUTLET         2' IRRIGATION SERVICE       Image: ClrB OUTLET         PERMEABLE PAVEMENT PARKING LOT SURFACE (SD-C)       Image: ClrB OUTLET         PERVIOUS PAVERS SIDEWALK SURFACE (SD-C)       Image: ClrB OUTLET         RETAINING WALL       Image: ClrB OUTLET         AC: PAVEMENT & BASE PER OITY STANDARDS       Image: ClrB OUTLET         RIP-RAP PAD       Image: ClrB OUTLET         RIP-RAP PAD       Image: ClrB OUTLET         RIP-RAP PAD       Image: ClrB OUTLET         BIOFILITRATION SYSTEM (EP-I)       Image: ClrB OUTLET         VEGETATED SWALE (FT-I)       Image: ClrB OUTLET         PERMEABLE CONCRETE SPLASH PAD       Image: ClrB OUTLET         Image: ClrB OUTLET	910 (619) 69
BACKFLOW PREVENTER (PRIVATE)         6' FIRE SERVICE         2' WATER SERVICE         2' WATER SERVICE         5' SEWER LATERAL (PRIVATE)         SEWER LATERAL (PRIVATE)         SEWER LATERAL (PRIVATE)         SEWER CLEANOUT (PRIVATE)         SPOT ELEVATION         PROPOSED CONTOLR         SPOT ELEVATION         BIOPICE         PERVIOUS PAVERS SIDEWALK SURFACE (SD-C)         AC. PAVEMENT & BASE PER CITY STANDARDS         RETAINING WALL         AREA DRAIN INLET         RIP-RAP PAD         DIRECTION OF FLOW         DIRECTION OF FLOW         VEGETATED SWALE (FT-1)         VEGETATED SWALE (FT-1)         VEGETATED SWALE (FT-1)         VEGETATED SWALE (FT-1)	910 (619) 6:
2' WATER SERVICE	<b>910(619)</b>
2' WATER SERVICE	<b>910(6</b>
2' WATER SERVICE	<b>910(6</b>
G' SEWER LATERAL (PRIVATE)       S       S         SEWER CLEANOUT (PRIVATE)	
SEWER CLEANOUT (PRIVATE)  SEWER CLEANOUT (PRIVATE)  SEWER CLEANOUT (PRIVATE)  ()  SEWER CLEANOUT  ()  SEWER CLEANOUT (PRIVATE)  ()  SEWER CLEANOUT (PRIVATE) (PRIVATE)  ()  SEWER CLEANOUT (PRIVATE) (PRIVATE)  ()  SEWER CLEANOUT (PRIVATE) (PRIVATE	
SEWER CLEANOUT (PRIVATE)	
2' IRRIGATION SERVICE PROPOSED CONTOUR SPOT ELEVATION UI350 PERMEABLE PAVEMENT PARKING LOT SURFACE (SD-C) II350 PERVIOUS PAVERS SIDEWALK SURFACE (SD-C) AC, PAVEMENT & BASE PER CITY STANDARDS RETAINING WALL AREA DRAIN INLET RIP-RAP PAD DRECTION OF FLOW FFM075 STREET LIGHT BIOFILITRATION SYSTEM (B=-1) VEGETATED SWALE (FT-1) PERMEABLE CONCRETE SPLASH PAD	
PROPOSED CONTOUR	
PROPOSED CONTOUR	
SPOT ELEVATION       II3.50         PERMEABLE PAVEMENT PARKING LOT SURFACE (SD-C)       III.100         PERVIOUS PAVERS SIDEWALK SURFACE (SD-C)       III.100         A.C. PAVEMENT & BASE PER CITY STANDARDS       IIII.100         RETAINING WALL       IIII.100         AREA DRAIN INLET       IIIIII.100         DIRECTION OF FLOW       IIII.100         BIOFILTRATION SYSTEM (BF-I)       IIIII.100         VEGETATED SWALE (FT-I)       IIIIIIIIIIIIIIIIIIIIIIIIIIIIIIIIIIII	ġ
PERMEABLE PAVEMENT PARKING LOT SURFACE (SD-C) PERVIOUS PAVERS SIDEWALK SURFACE (SD-C) A.C. PAVEMENT & BASE PER CITY STANDARDS RETAINING WALL AREA DRAIN INLET RIP-RAP PAD DIRECTION OF FLOW HOUSING UNIT WITH GREEN ROOF STREET LIGHT BIOFILTRATION SYSTEM (BF-1) VEGETATED SWALE (FT-1) PERMEABLE CONCRETE SPLASH PAD	
PERVIOUS PAVERS SIDEWALK SURFACE (SD-C)	6
PERVIOUS PAVERS SIDEWALK SURFACE (SD-C)	
A.C. PAVEMENT & BASE PER CITY STANDARDS	
A.C. PAVEMENT & BASE PER CITY STANDARDS	
RETAINING WALLAREA DRAIN INLETI     Image: Constraint of the second	
AREA DRAIN INLET	Ν
AREA DRAIN INLET	
RIP-RAP PAD   DIRECTION OF FLOW     HOUSING UNIT WITH GREEN ROOF     STREET LIGHT   BIOFILTRATION SYSTEM (BF-I)   VEGETATED SWALE (FT-I)     VEGETATED SWALE (FT-I)     VEGETATED SWALE (FT-I)	Ľ,
DIRECTION OF FLOW	
Image: Description of the second s	
HOUSING UNIT WITH GREEN ROOF	5
HOUSING UNIT WITH GREEN ROOF	<b>I</b>
HOUSING UNT WITH GREEN ROOF         STREET LIGHT         BIOFILTRATION SYSTEM (BF-I)         VEGETATED SWALE (FT-I)         PERMEABLE CONCRETE SPLASH PAD	Ш,
BIOFILTRATION SYSTEM (BF-I)       Image: Constant of the system (BF-I)         VEGETATED SWALE (FT-I)       Image: Constant of the system	
BIOFILTRATION SYSTEM (BF-I)       Image: Constant of the system (BF-I)	DRI
VEGETATED SWALE (FT-I)	
VEGETATED SWALE (FT-I)	ER
PERMEABLE CONCRETE SPLASH PAD	
PERMEABLE CONCRETE SPLASH PAD	
	<b>– 8</b>
	m
	0
UNDERGROUND ROOF DRAIN CULVERT	
ROOF DRAIN DOWNSPOUT LOCATIONO	
PEDESTRIAN RAMP	Ũ
PEDESTRIAN RAMP	
LOPER NAME : SNIPES-DYE ASSOCIATES REVISION 13 :	
ADDRESS : 8348 CENTER DRIVE, SUITE G REVISION IO : [1]	
LA MESA, CA 91942 REVISION 9 :	
PHONE : (619) 697-9234 REVISION 6 : 5/14/19 REVISION 6 : 5/12/19	
REVISION 6 : 5/13/19 REVISION 5 : 1/21/19	🖪
PROJECT ADDRESS :     REVISION 5 : 1/21/19       300 BLOCK 35TH STREET     REVISION 3 : 7/17/18	
SAN DIEGO, CA 92102	
$\frac{z}{2} = 0$	S
	<b>E</b> NI
	<b>JNZ</b> (-0
CIVIL         TENTATIVE MAP NO. 1937933         DEP#         PTS NO 549188	<b>E</b> NI


TENTATIVE MAP LEGEND

Ь

1.0.# 24007282

FOR SMALL LOT SUBDIVISION

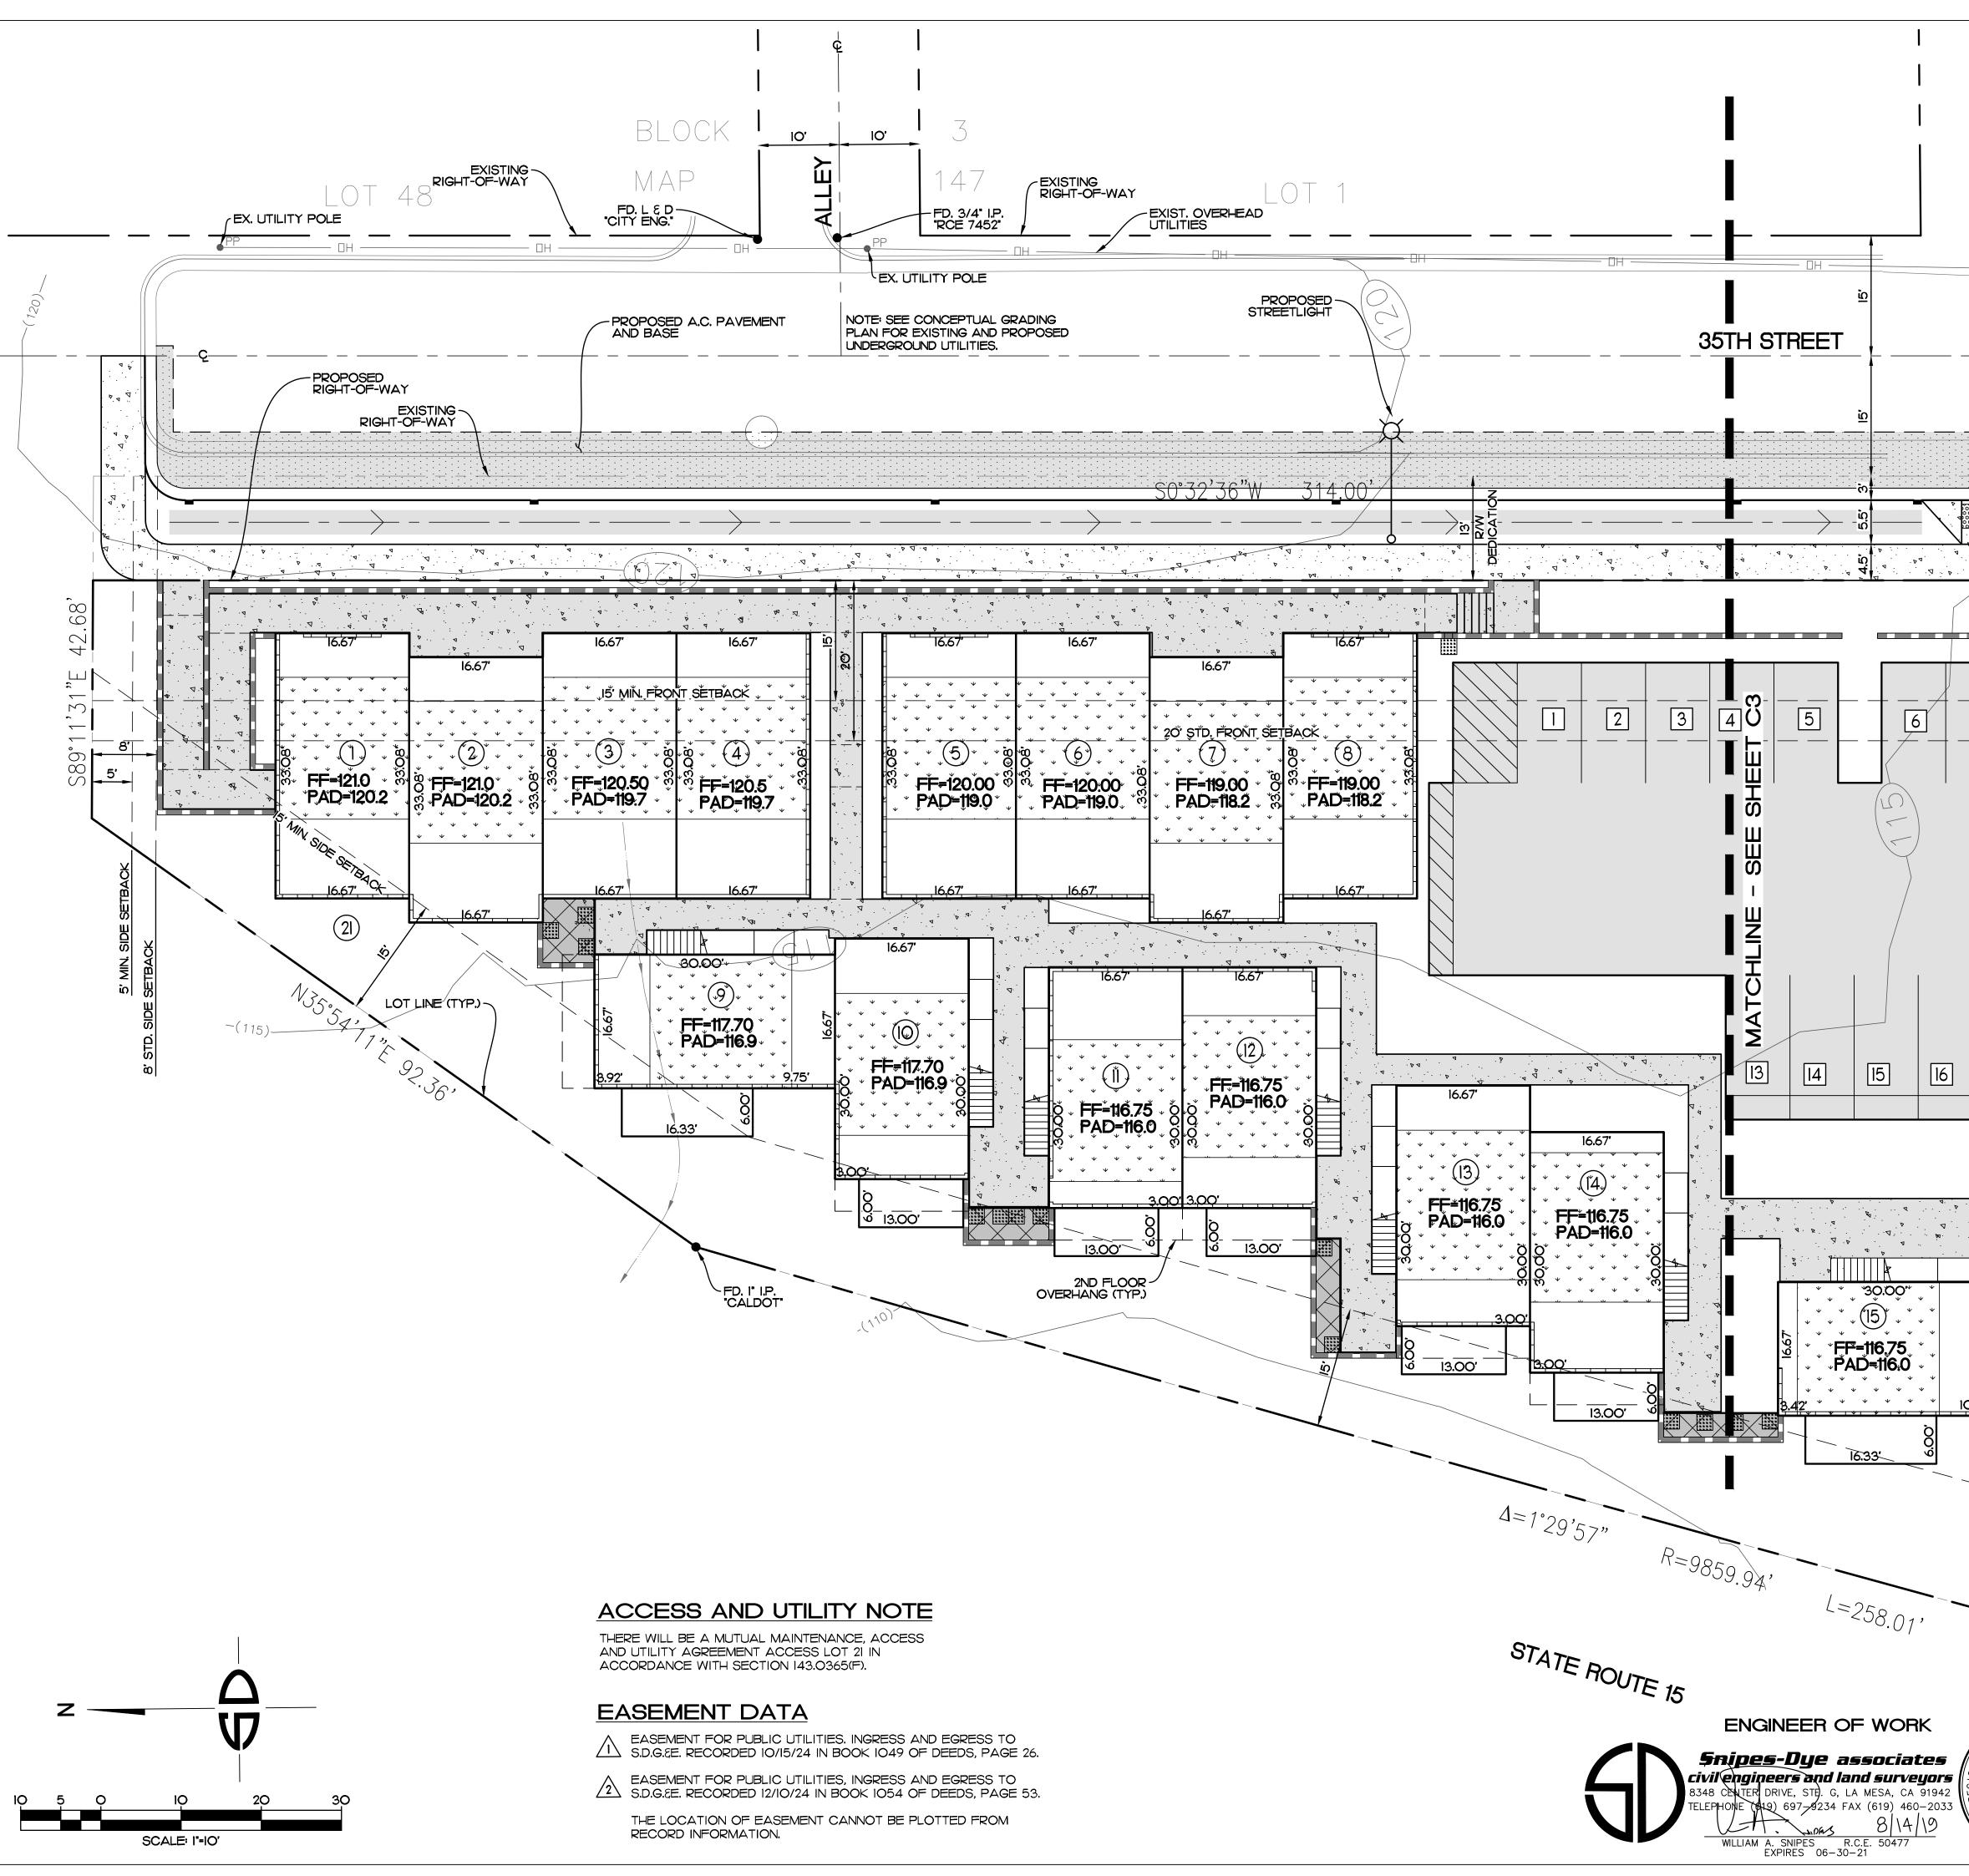

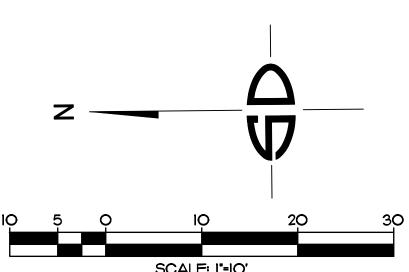

| 1

LOT NUMBER	
EASEMENT DATA	
PROPERTY LINE	_
PARKING SPACE	

PROPOSED LOT LINE

)) 697-9234, FAX (619) 460-2033	(613)	0162-	91942	A, CA !	LA MES	5UITE 6, LA MESA, CA 91942-2910 (619	ЪĨ	8348 CENTER DRIVI	IJ41	80	<b>DYE A550CIATE5</b>	₹ AVIPES-DYE	1	(6-∀) I9OO
	3/21/2018	DAIE												SHEETS
35TH STREET TENTATIVE MAP	WAS	CHECKED												N C C
JOB NAME	BW									;  				C (
		DRAWN								SDA	PER REVIEW COMMENTS	8/31/17   REVISE PER REVIEV	3	
	S M	DESIGNER		ВҮ		REVISION DESCRIPTION	REVIS	DATE	BY NO	B	REVISION DESCRIPTION	DATE REV	NO	SHEET

r	-		-		-	
LOT NO.	GROSS LOT AREA (SF)	FLOOR AREA (SF)	FLOOR AREA RATIO	NO. OF STORIES	NO. OF BEDROOMS	FOOTPRINT (SF)
1	551	1495	2.60	3	2	551
2	551	1495	2.60	З	2	551
3	551	1495	2.60	3	2	551
4	551	1434	2.60	3	3	551
5	551	1434	2.60	3	2	551
6	551	1434	2.60	3	3	551
7	551	1434	2.60	3	2	551
8	551	1434	2.60	3	2	551
9	500	1525	2.29	3	2	500
10	500	1434	2.20	3	2	500
11	500	1434	2.20	3	2	500
12	500	1434	2.20	3	2	500
13	500	1525	2.20	3	2	500
14	500	1434	2.20	3	2	500
15	500	1525	2.29	3	2	500
16	500	1434	2.20	3	2	500
17	500	1434	2.20	3	2	500
18	500	1434	2.20	3	2	500
19	500	1434	2.20	3	2	500
20	500	1434	2.20	3	2	500
21	30,988	NA	NA	NA	NA	NA

PREPARED BY:

NAME : ADDRESS :

LA MESA, CA 91942 (619) 697-9234 PHONE :

SNIPES-DYE ASSOCIATES


8348 CENTER DRIVE, SUITE G

PROJECT ADDRESS

300 BLOCK 35TH STREET

SAN DIEGO, CA 921O2 PROJECT NAME :

35TH STREET TENTATIVE MAP

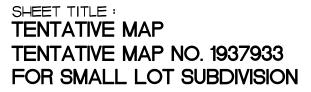


REVISION 14 :
REVISION 13 :
REVISION 12 :
REVISION II :
REVISION 10 :
REVISION 9 :
REVISION 8 : 8/14/19
REVISION 7 : 6/21/19
REVISION 6 : 5/13/19
REVISION 5 : 1/21/19
REVISION 4 : 8/23/18
REVISION 3 : 7/17/18
REVISION 2 : 3/21/18
REVISION 1 : 8/31/17
ORIGINAL : 5/22/17

SHEET 2 OF 5 DEP# _____PTS_NO_549188

1.0.# 24007282

TENTATIVE MAP SHEET

₽ĞÂ

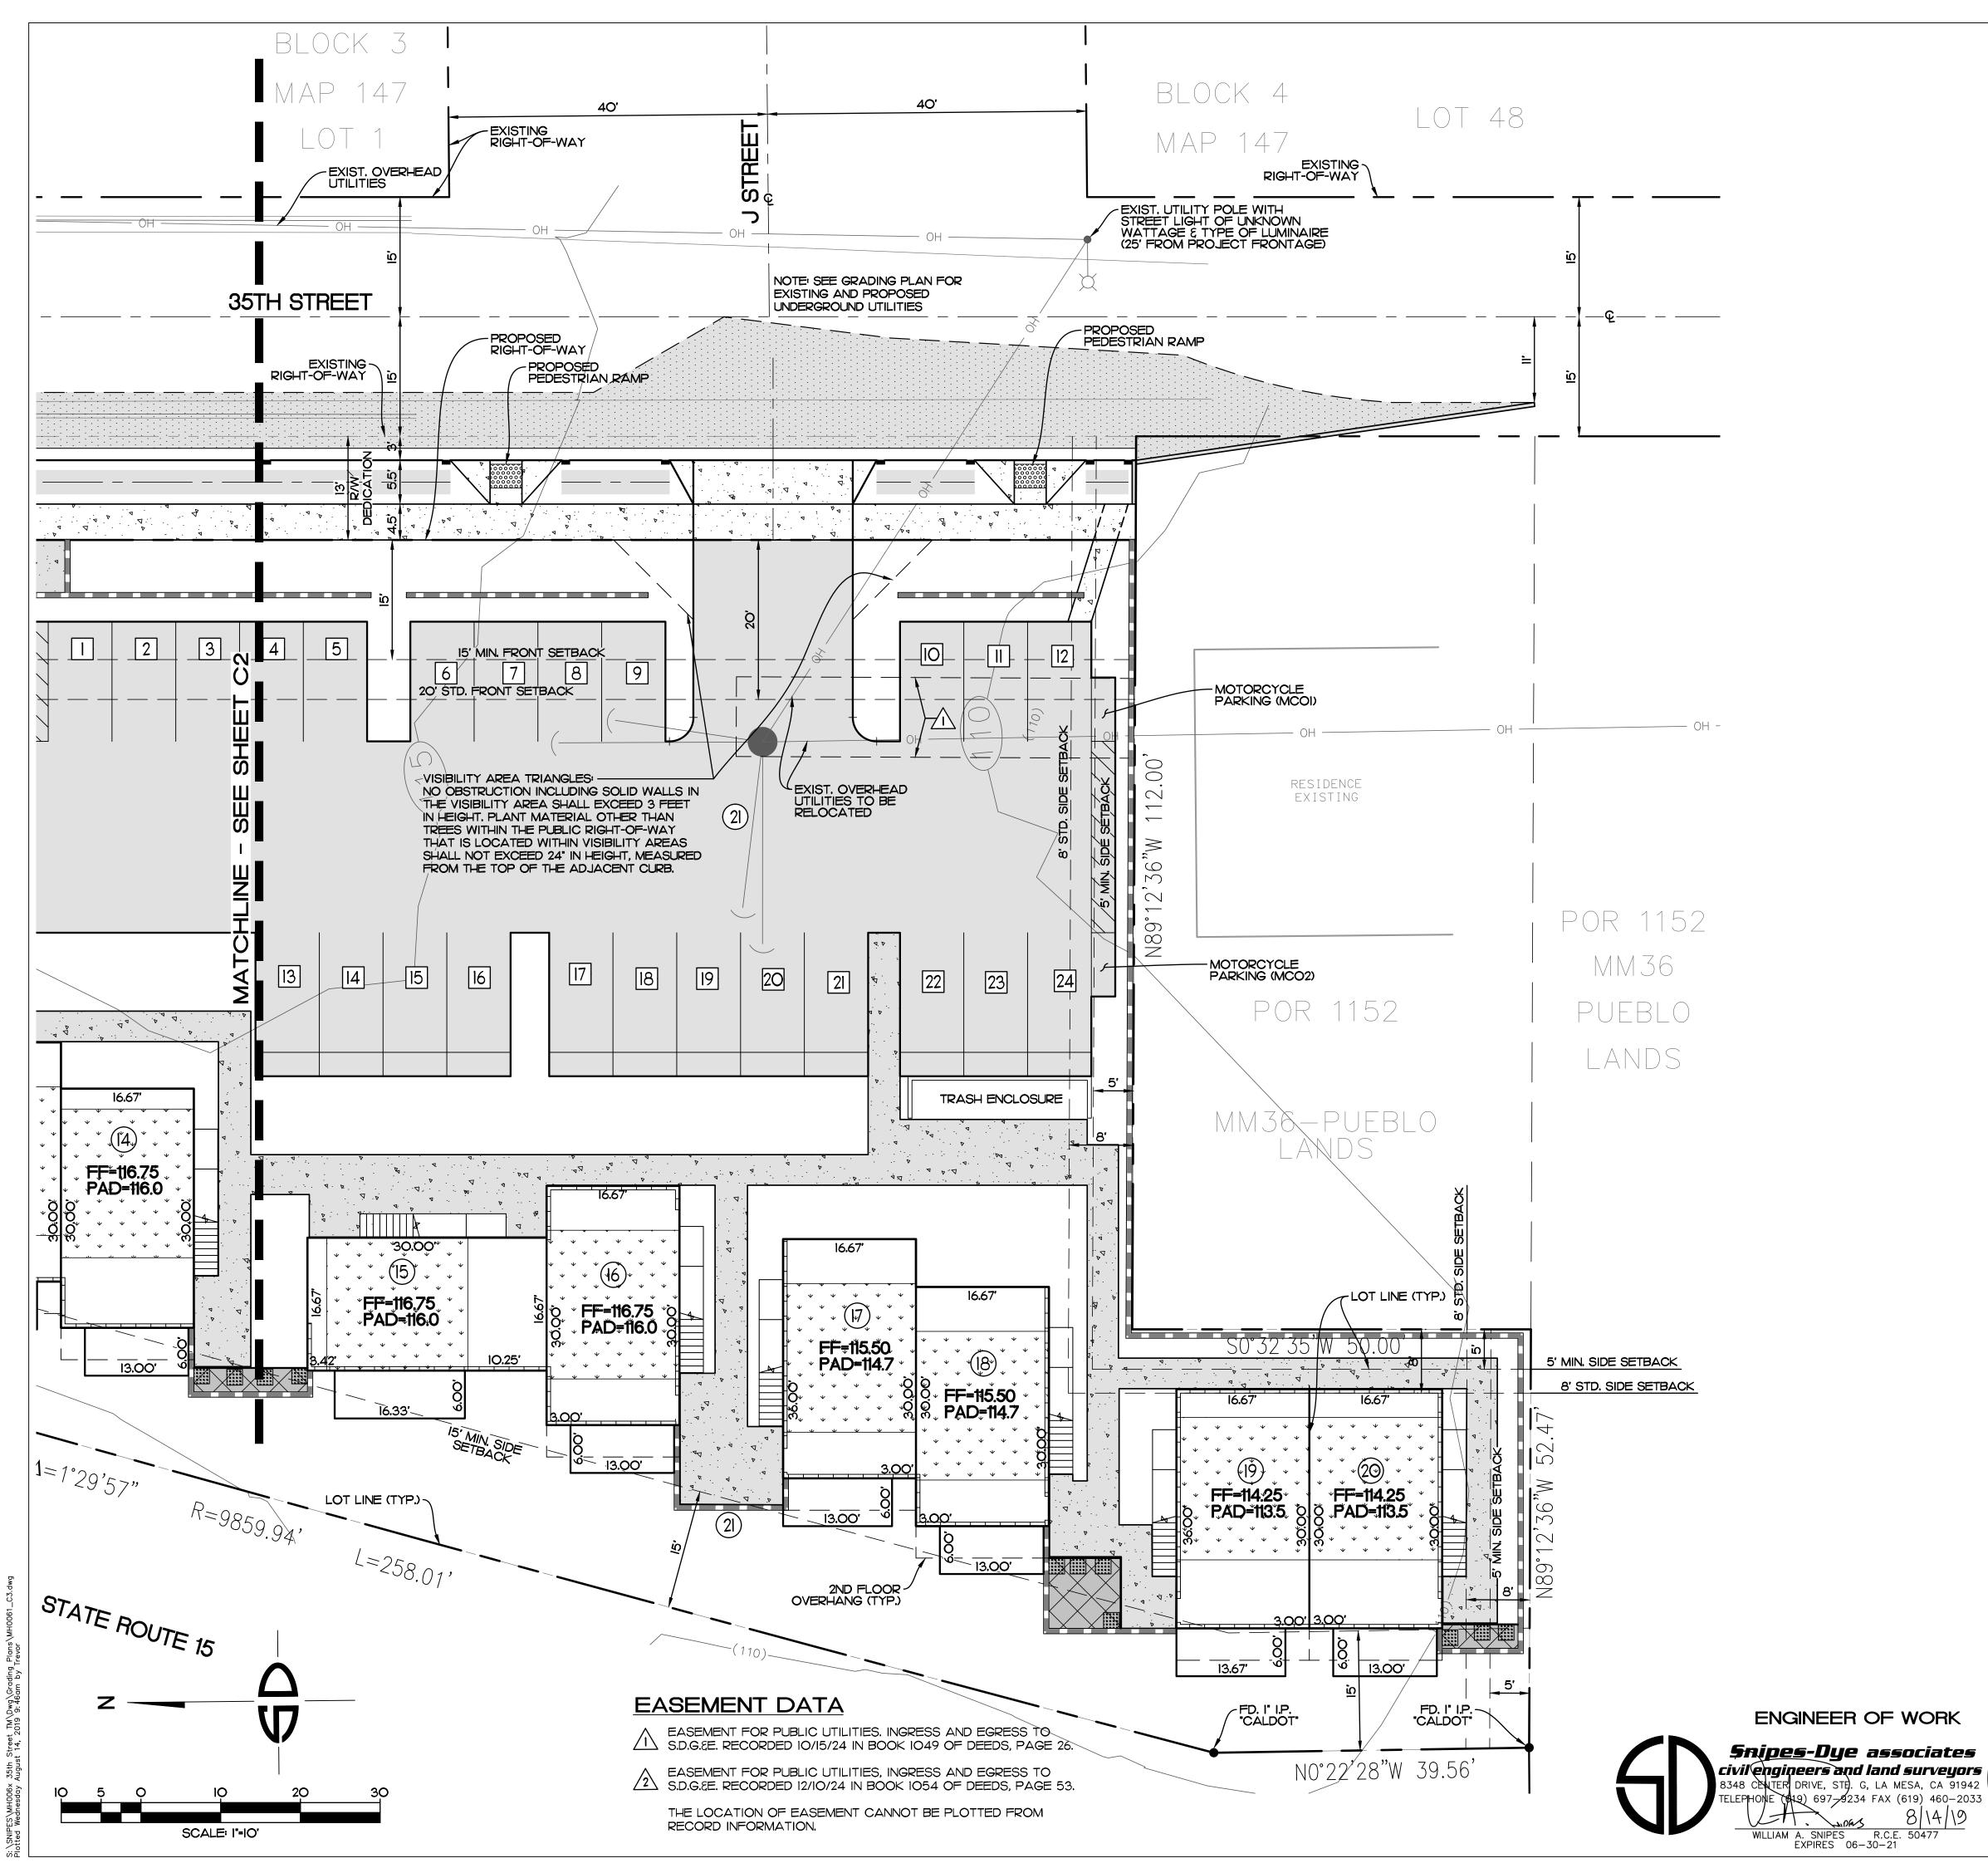

LEGEND	

LOT NUMBER	( <b>1</b> )
EASEMENT DATA	$\triangle$
PROPERTY LINE	
PARKING SPACE	

PROPOSED LOT LINE

						ATTACHMENT 16	MENT 16
5UITE G, LA MESA, CA 91942-2910 (619) 697-9234, FAX (619) 460-2033	942-2910 (619) 6:	; LA MESA, CA 91	8348 CENTER DRIVE, SUITE G	18 CEN	834	<b>5NIPES-DYE A550CIATE5</b>	JOB NO. МНОО6І (Д-9)
	^{DALE} 3/21/2018						5 SHEETS
35TH STREET TENTATIVE MAP	CHECKED WAS						۔ در
JOB NAME	BW				, , , ,		C
	DRAWN				SDA	1   8/31/17   REVISE PER REVIEW COMMENTS	
TENTATIVE NAD							SHEEL

## ACCESS AND UTILITY NOTE

THERE WILL BE A MUTUAL MAINTENANCE, ACCESS AND UTILITY AGREEMENT ACCESS LOT 21 IN ACCORDANCE WITH SECTION 143.0365(F).

PREPARED	BY
FREFARED	


SNIPES-DYE ASSOCIATES NAME : 8348 CENTER DRIVE, SUITE G ADDRESS : LA MESA, CA 91942 (619) 697-9234 PHONE :

PROJECT ADDRESS

300 BLOCK 35TH STREET SAN DIEGO, CA 92102

PROJECT NAME :

35TH STREET TENTATIVE MAP

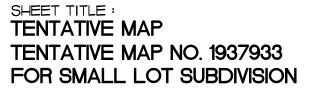

REVISION 14 :	


SHEET	3	OF	5
DEP# _	PT	<u>s no</u>	549188

1.0.# 24007282


TENTATIVE MAP SHEET

	PROFESSION	
REGISTERE	No. 50477 ℃	ENGINE
REG 1	( ≥ No. 50477 5 Exp. 06-30-21	NEER
<b>\</b>	CIVIL CIVIL	
	OF CALIF	•

8/14/19

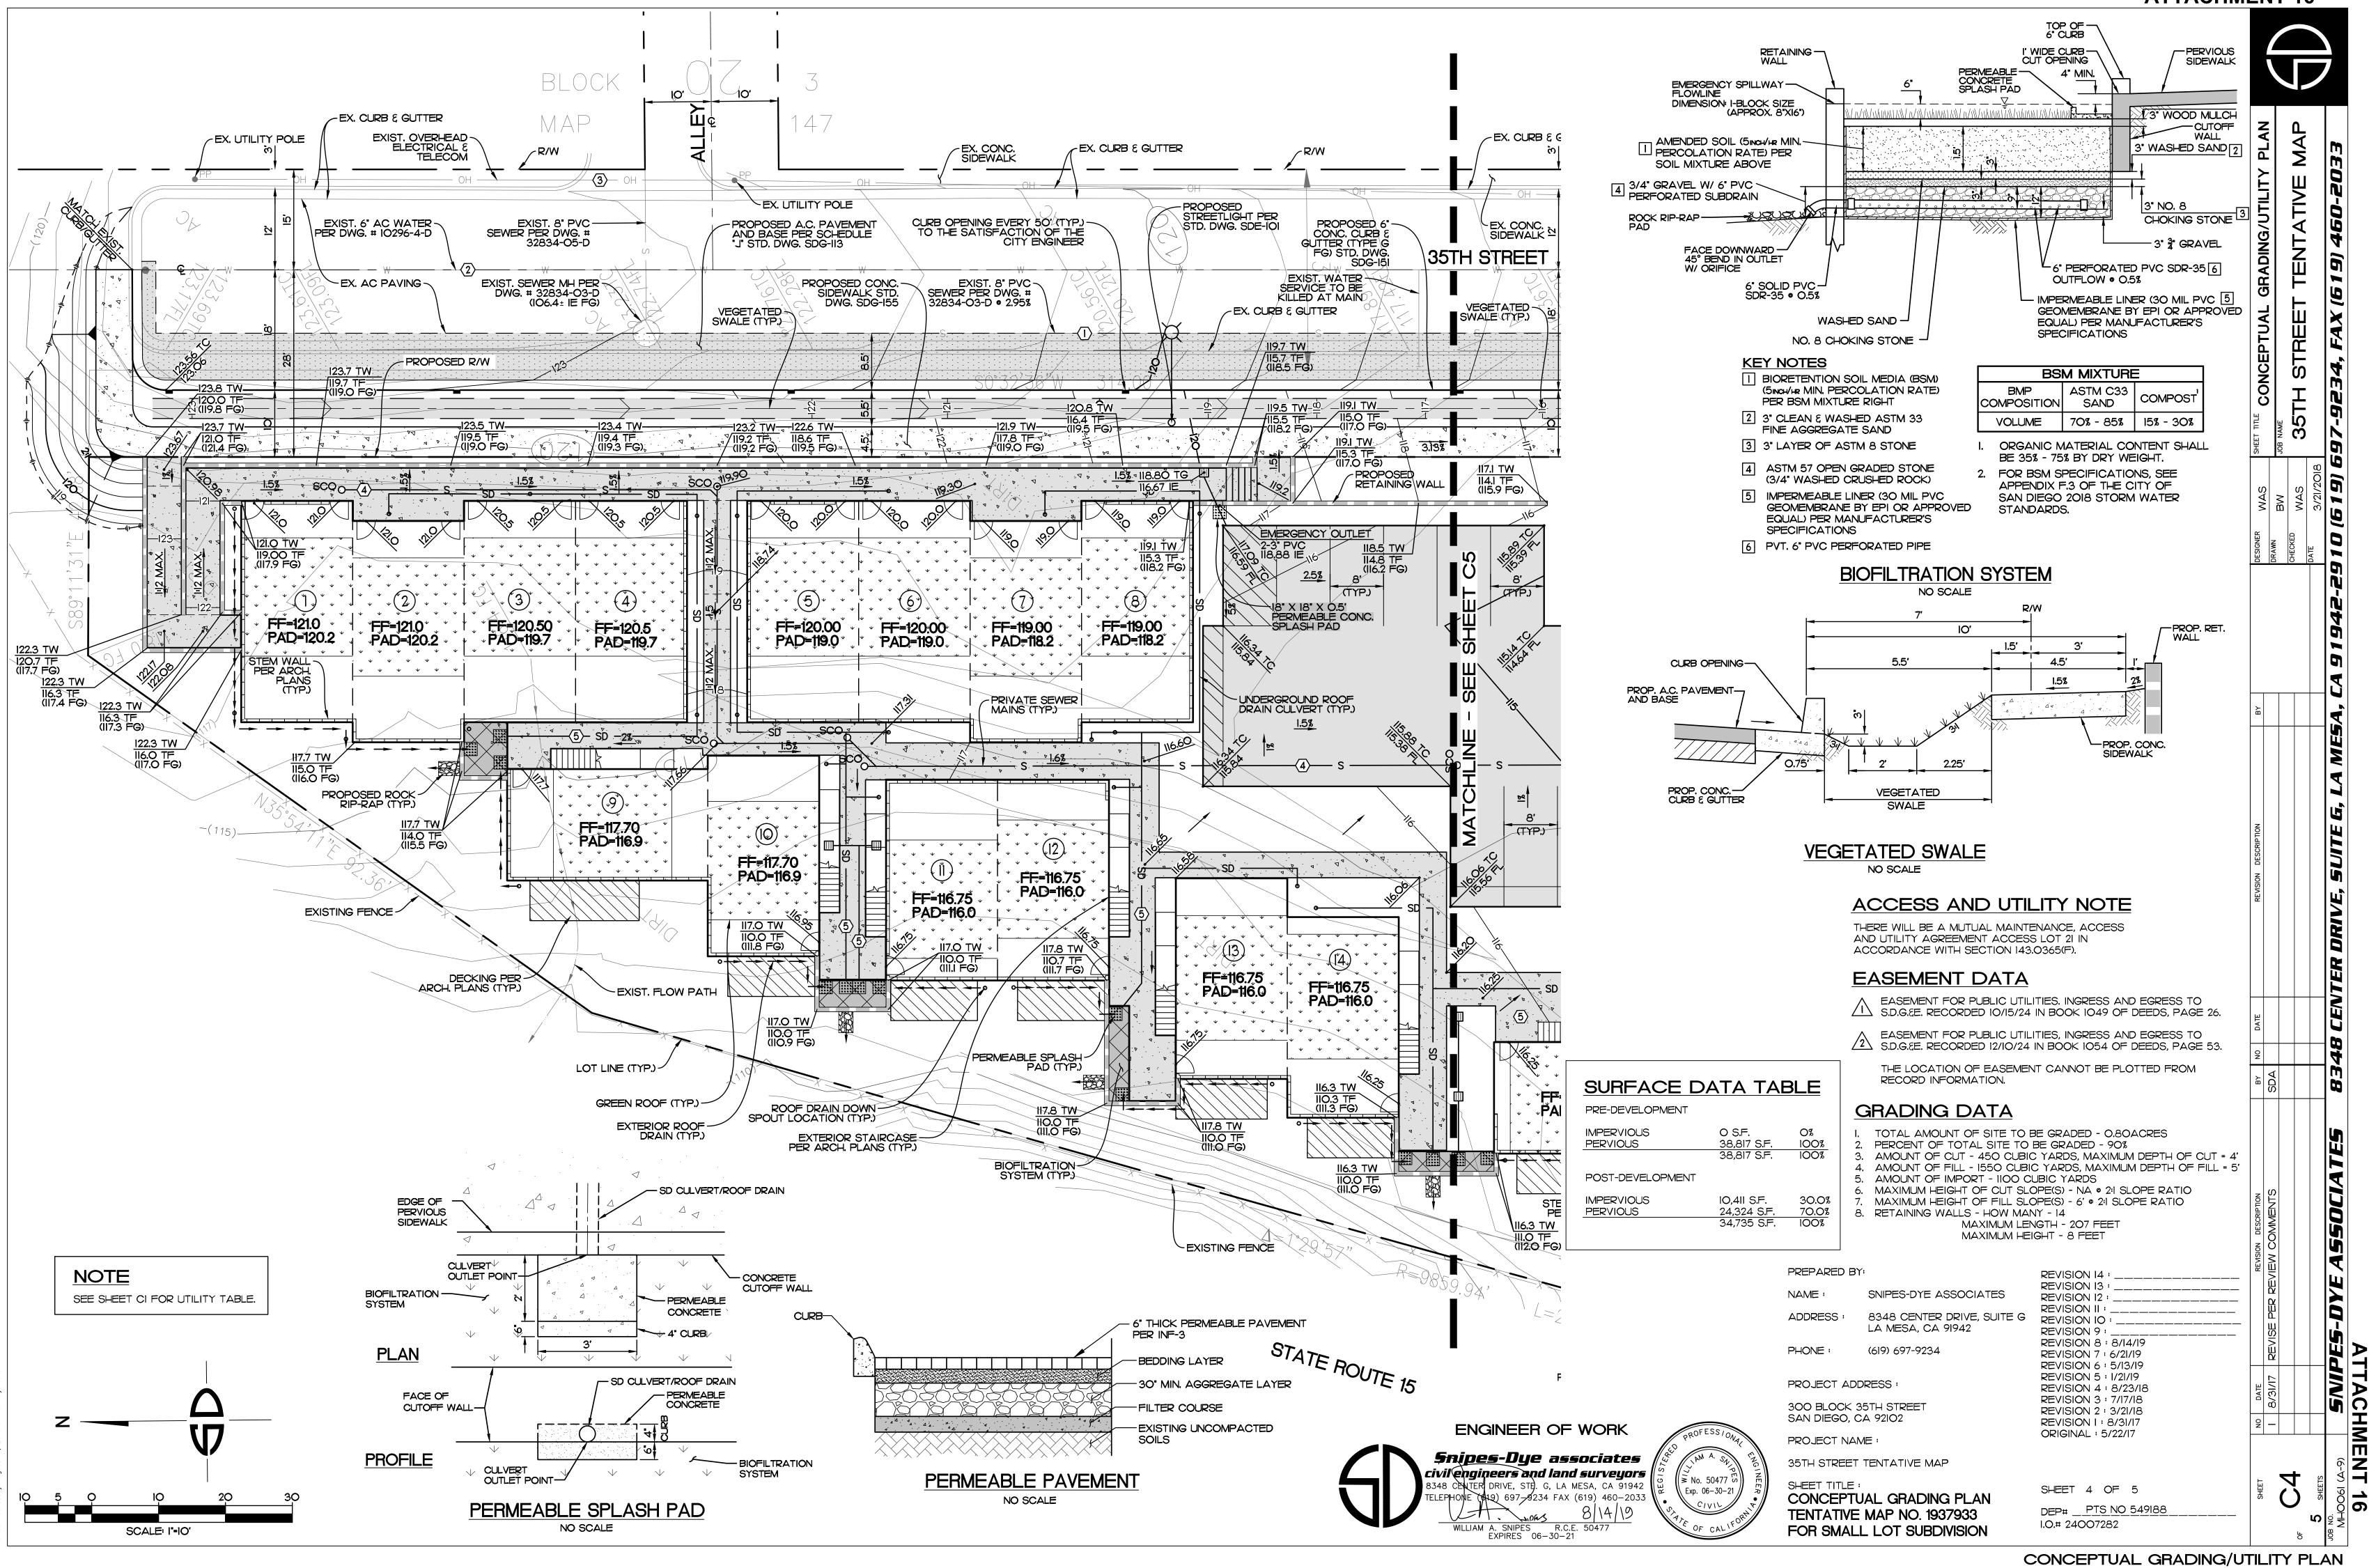



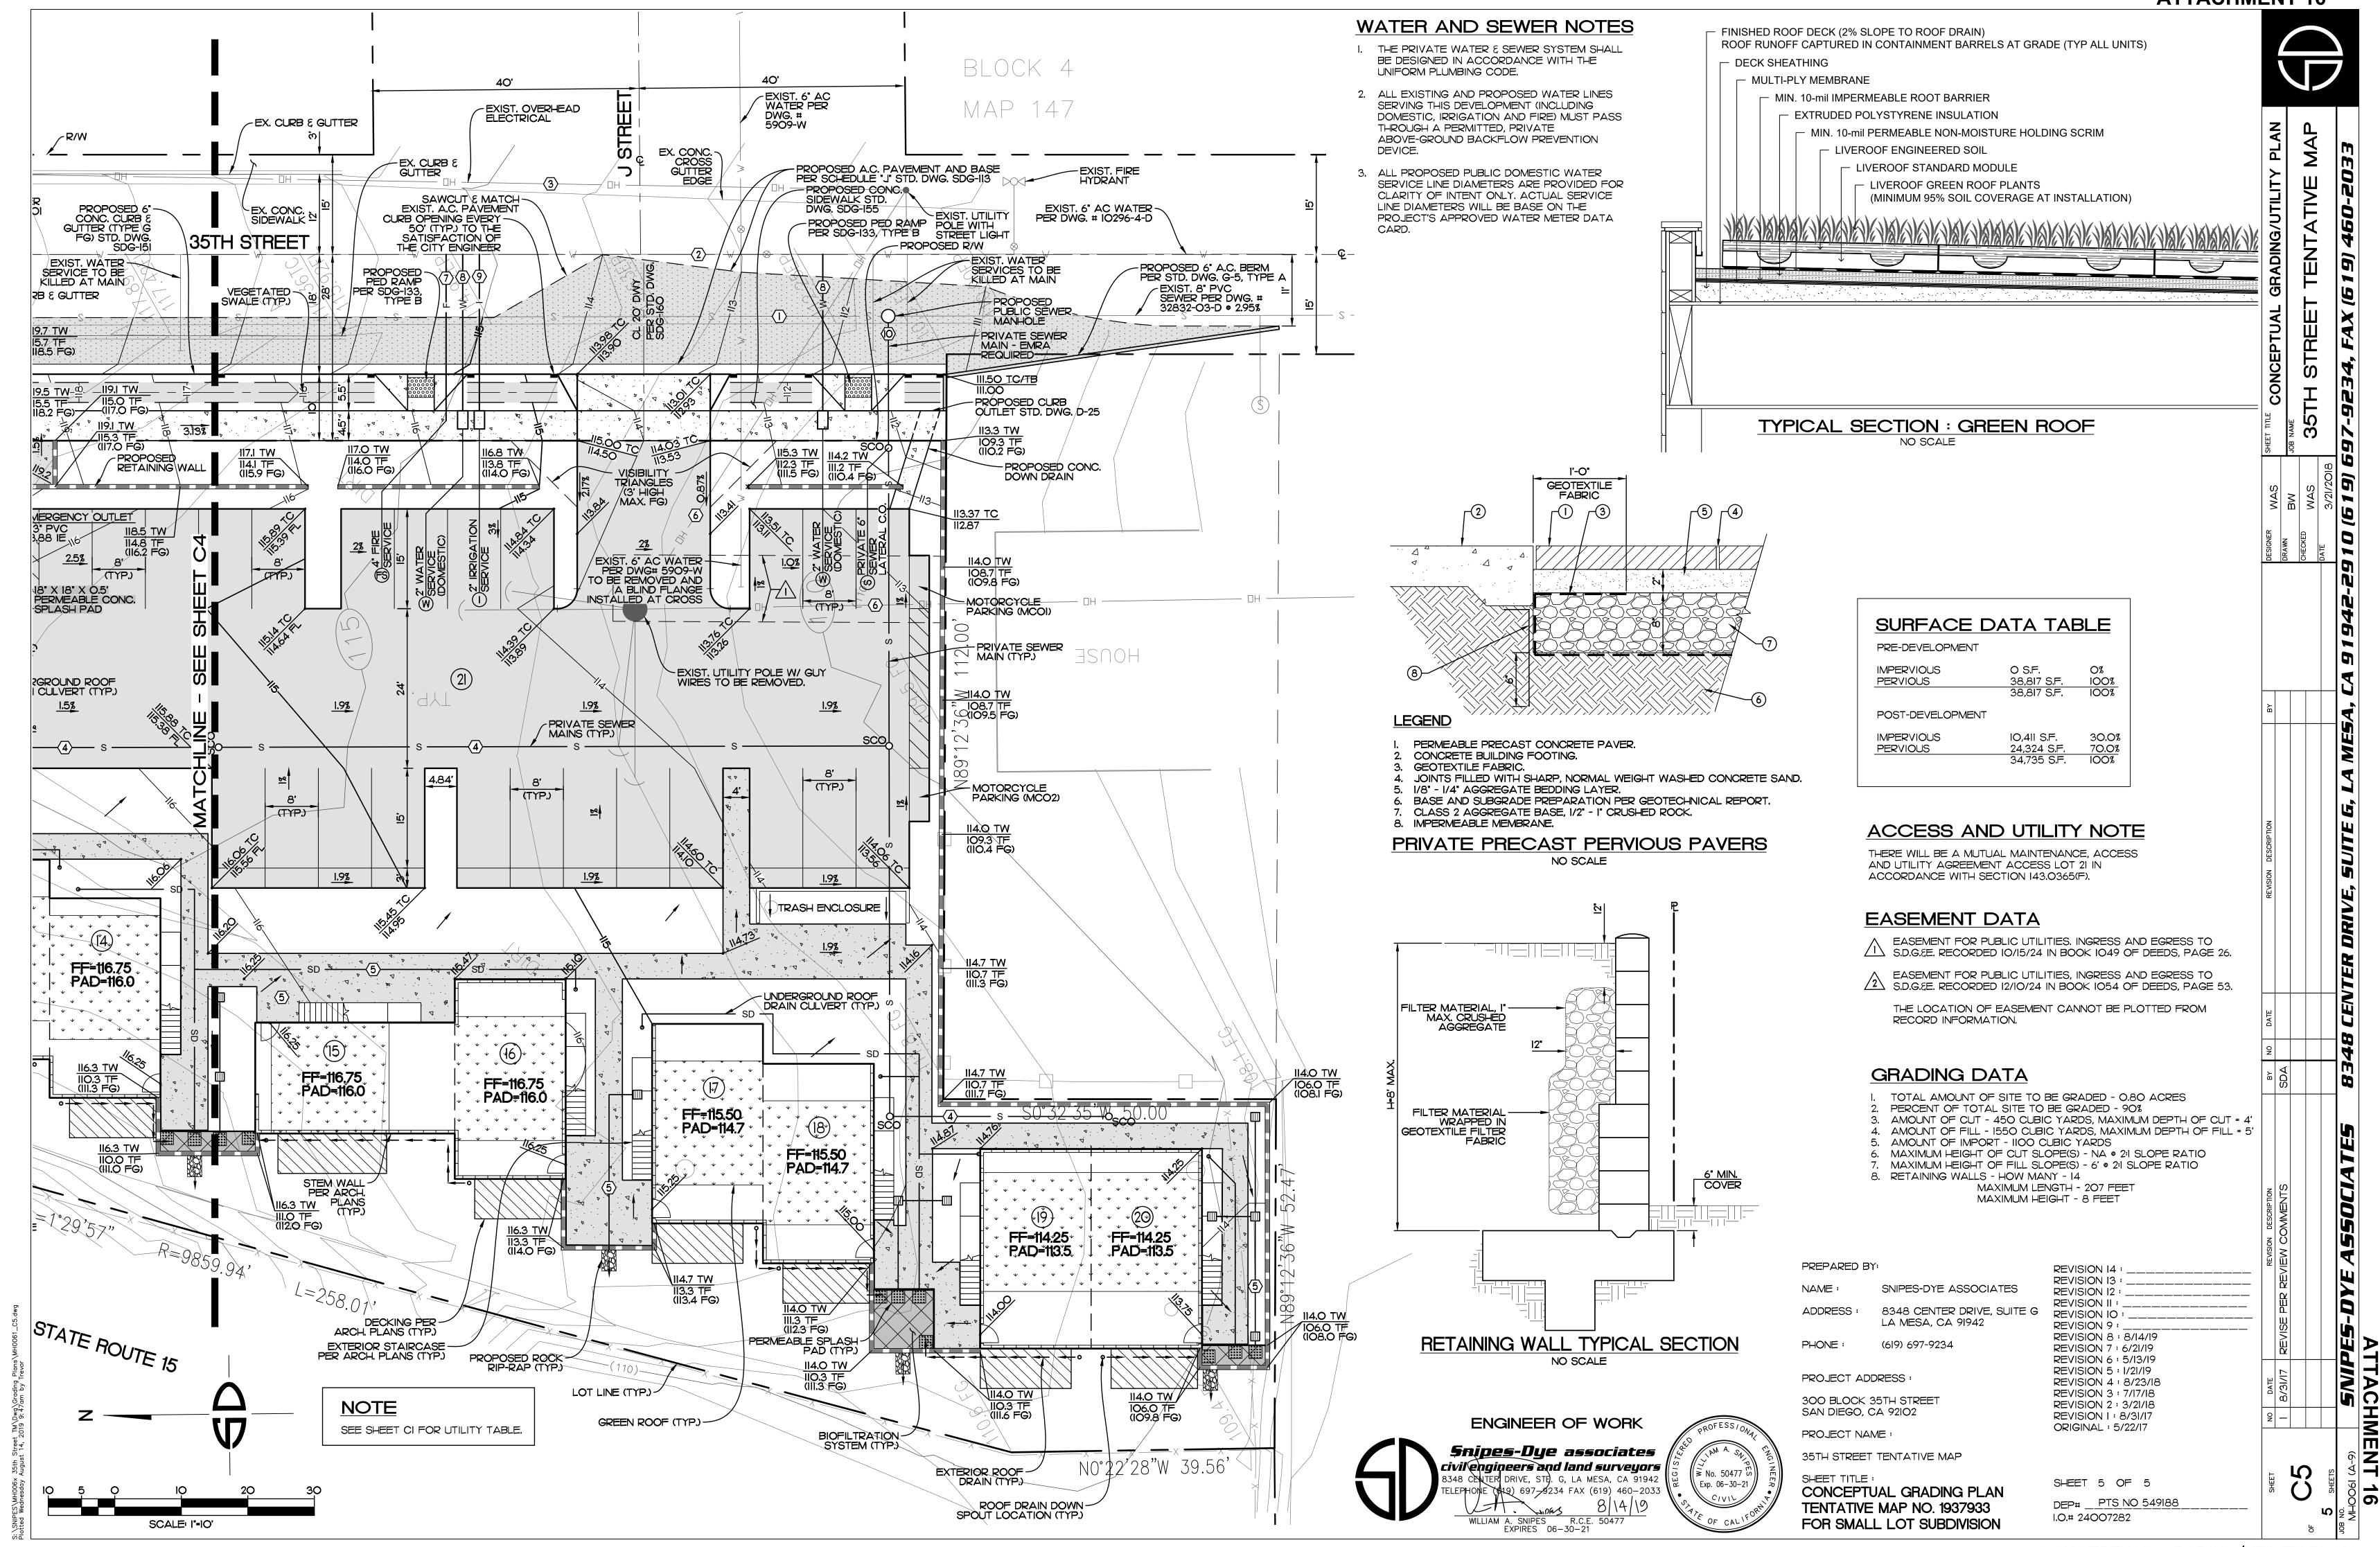

CONCEPTUAL GRADING/UTILITY PLAN