

Report to the Planning Commission

DATE ISSUED: September 2, 2021 REPORT NO. PC-21-035

HEARING DATE: September 9, 2021

SUBJECT: T-MOBILE BAY POINT APARTMENTS Process Four Decision

PROJECT NUMBER: 678588

OWNER/APPLICANT: 700 Bay Pointe, LLC, Owner / Delilah Bruzee, Applicant

SUMMARY

<u>Issue</u>: Should the Planning Commission approve a Wireless Communication Facility located at 3910 Ingraham Street within the Pacific Beach Community Planning area?

Staff Recommendation:

1. APPROVE Conditional Use Permit Approval No. 2539308 and Planned Development Permit Approval No. 2539310.

<u>Community Planning Group Recommendation</u>: On June 9, 2021, the Pacific Beach Community Planning Group has voted 14-0-0 to approve the project without conditions (Attachment 10).

<u>Environmental Review</u>: This project was determined to be categorically exempt from the California Environmental Quality Act (CEQA) pursuant to Section 15301 (Existing Facilities) of the State CEQA Guidelines. This project is not pending an appeal of the environmental determination. The environmental exemption determination for this project was made July 16, 2021 and the opportunity to appeal that determination ended July 30, 2021.

<u>Fiscal Impact Statement</u>: All costs associated with the processing of this project are paid by the applicant.

Code Enforcement Impact: None.

<u>Housing Impact Statement</u>: This project application is for a Wireless Communication Facility and is not associated with residential development.

BACKGROUND

The project proposes the continued use of an existing T-Mobile Wireless Communication Facility (WCF) located at 3910 Ingraham Street on a 12-acre site encompassing the Bay Pointe Apartments. The site is zoned RM-3-7 (Residential-Multiple Unit) within the Pacific Beach Community Plan. The project site is currently developed with a multi-family housing complex that includes 505 multi-family units, swimming pool and passive landscape areas. Land uses surrounding the project site include single- and multi-family residential unit developments adjacent to the site and a commercial development to the south (Attachments 1-3). The existing WCF was previously approved on January 30, 2014 under Project No. 286694 with a 10-year expiration and included six antennas. The associated WCF equipment operates inside a 144-square foot equipment room.

Council Policy 600-43 assigns preference levels to WCFs proposed on different land uses. This site is considered a Preference Four location due to its location within a residential zone on a premises that contains residential development. A WCF at this location requires approval of a Conditional Use Permit (CUP), Process 4 decision in accordance with San Diego Municipal Code (SDMC) Section 141.0420(c). In addition, a Planned Development Permit (PDP) is required in accordance with SDMC Section 143.0402 due to a proposed deviation of the antenna enclosure extending past 18 inches from the building face. Sites proposed in Preference Four locations must provide justification why higher preference sites (Preference 1, 2, and 3 sites) were not utilized. The justification as to the continued utilization of the site indicated that the existing location allows for a wide coverage factor and provides coverage to the Pacific Beach community and surrounding residential developments by increasing cellular reception effectiveness, including emergency communications. Other preference sites were not sought out due to the new site buildout may adversely affect the community. The project's development permits will be consolidated under a Process Four decision pursuant to SDMC Section 112.0103(a).

DISCUSSION

Project Description:

The Project proposes the continued use of a WCF utilized by T-Mobile. The existing six panel antennas, eight Remote Radio Units (RRUs) and three Tower Mounted Amplifiers (TMAs) will be removed. The proposed WCF consists of nine new antennas where six antennas will be concealed in new antenna skirts and three antennas concealed in a new Fiberglass Reinforced Panel (FRP) box. The 144-square foot equipment room, located on grade on the west elevation, will remain. No other changes are proposed at this time. The facility has been designed in a way that is architecturally integrated with the building and have camouflaged the antennas to be less visible by locating all the antennas near the facia, with three panel antennas and one RRU being concealed in a FRP box that will match the existing stucco texture and paint color of the wall and other vertical elements; and six panel antennas and one RRU with antenna skirts that match the existing green siding, located on the north and east sides of the building (Attachment 11 and Figures 1 and 2).



Figure 1: Proposed Photo Simulation of antenna skirts that match the existing green siding



Figure 2: Proposed Photo Simulation of FRP box that will match existing stucco wall and vertical elements

Community Plan Analysis:

The Pacific Beach Community Plan does not address WCFs as a specific land use however, the City of San Diego's General Plan (UD-15) requires that the visual impact of wireless facilities be minimized by concealing WCF's inside existing structures or using screening techniques to hide or blend them with the surrounding area. The plan also calls for these facilities to be designed to be aesthetically pleasing and respectful of the neighborhood context. Furthermore, the plan states that equipment associated with wireless facilities shall be concealed from view.

Pursuant to the <u>SDMC Section 141.0420</u>, WCFs are permitted in all zones citywide with the appropriate permit process. WCFs are separately regulated uses, which have limitations or require compliance with conditions in order to minimize potential impacts. The intent of the regulations is to camouflage facilities from public view. The antennas associated with this project are concealed within a FRP box and antenna skirts that will be matched to the paint and texture of the existing building and blending with the built environment. The location of the antennas in this area have been an established use for the WCF for over 10 years and the continued use of this site will not bring any new changes and will maintain the same profile in this location. The equipment associated with the facility will continue to operate inside a 144-square foot equipment room that is located on grade, adjacent to an existing building, painted and textured to match the existing building.

Project-Related Issues:

<u>Deviations</u>- The project requests a deviation from the applicable development regulations as allowed with the approval of a PDP. An applicant may request deviations in accordance with a PDP decided in accordance with Process Four, provided that the findings in <u>SDMC Section 126.0605</u> are made. The following Table 1 is a matrix of the proposed deviation, which is followed by the justifications for the deviations:

DEVIATIONS SUMMARY Table 1				
Deviation Description	Deviation from SDMC	Allowed/Required	Proposed	
WCF Projection from	SDMC Section	Maximum Projection	19 to 23-inch	
Building Wall	141.0420(e)(8)(B)	of 18-inches	projection	

Justification – A deviation to the protrusion of the antennas from the face of the building façade is being requested for the WCF for the proper operation of the equipment. The project proposes adding a FRP box housing three antennas and six antennas with antenna skirts, with color and texture matched to integrate to the existing building. With larger sized antennas, the mounting hardware and necessary antenna azimuth make the 18-inch required distance impossible without impacting the main structure. The proposed distance, 19-inches to 23-inches, is the minimum T-Mobile can achieve, while giving the antennas, mounting hardware and necessary azimuth enough room to operate. The carrier has designed the facility in a way that is architecturally integrated with the building and have camouflaged the antennas to be less visible that complies with the City of San Diego Development Services WCF guidelines (Figures 1 and 2). Two design factors weigh into the rationale for the requested height deviation:

- 1. The WCF Guidelines, which were adopted in 2019, includes requirements for antennas size, amid growing new technology sizes. In this case, the antennas need to protrude up to 5 inches to function as intended. The proposed FRP box and antenna skirts will match the color and texture of the building they are mounted on.
- 2. The existing WCF provides critical voice and data service throughout the surrounding area. Continued operation of this site is necessary to maintain the existing levels of service to the area for T-Mobile customers. The site is an integral part of telecommunication networks, as the site's operation is closely coordinated with other sites in the area. Coverage maps demonstrate the existing coverage and the predicted loss of coverage without the WCF (Attachment 7). Although the underlying zone allows a maximum of 18 inches protrusion, without a maximum increase of five inches, could result in significant impacts to those within the surrounding area. A degradation of the existing service could have a significant impact on customers and essential emergency communication services.

The above deviation has been analyzed by City staff and determined to be consistent with the goals and recommendations of the General Plan, the Pacific Beach Community Plan, the SDMC and the purpose and intent of the Wireless Communication Ordinance. The project has been designed to address the physical environment and would not adversely impact the public's health or safety. Apart from the above deviation, the proposed project will continue to provide wireless communication service to the surrounding area and emergency essential communications services.

Conclusion:

Based on its design, the project complies with the WCF Regulations pursuant to <u>SDMC section</u> <u>141.0420</u>. City staff has prepared draft findings in the affirmative to approve the project and recommends approval of the PDP and CUP (Attachment 5 and 6).

ALTERNATIVES

- 1. Approve Planned Development Permit No. 2539310 and Conditional Use Permit No. 2539308, with modifications.
- 2. Deny Planned Development Permit No. 2539310 and Conditional Use Permit No. 2539308, if the Planning Commission makes written findings based on substantial evidence that the approval is not authorized by state or local zoning law.

Respectfully submitted,

William Zounes for Tim Daly Assistant Deputy Director

William Journes

Development Services Department

Lan Heacox


lan Heacox

Development Project Manager Development Services Department

TD/IH

Attachments:

- 1. Aerial Photograph
- 2. Community Plan Land Use Map
- 3. Project Location Map
- 4. Project Data Sheet
- 5. Draft Permit Resolution with Findings
- 6. Draft Permit with Conditions
- 7. Coverage Maps
- 8. Environmental Exemption
- 9. Ownership Disclosure Form
- 10. Community Planning Group Recommendation
- 11. Photo Survey
- 12. Photo Simulations
- 13. Project Plans

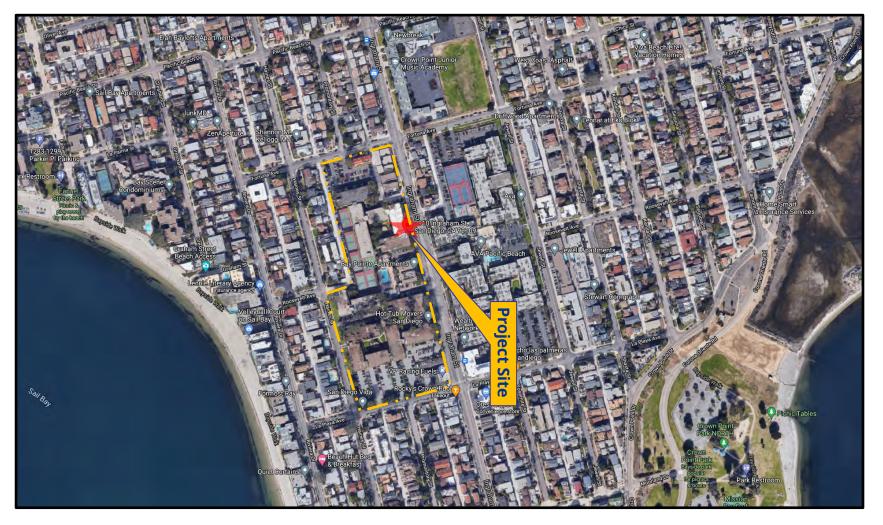







Pacific Beach Land Use Map


T-Mobile Bay Point Apartments Project No. 678588 3910 Ingraham Street





Project Location Map

<u>T-Mobile Bay Point Apartments Project No. 678588</u> 3910 Ingraham Street

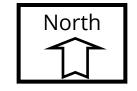

		PROJECT DATA SHEET		
PROJECT NAME:		T-Mobile Bay Point Apartments		
PROJECT DESCRIPTION:		The continued operation of a Wireless Communication Facility (WCF) utilized by T-Mobile. The existing WCF consists of façade mounted antennas located at 3910 Ingraham Street		
COMMUNITY PLAN AREA:		Pacific Beach		
DISCRETIONARY ACTIONS:		Planned Development Permit/Conditional Use Permit		
COMMUNITY PLAN LAND USE DESIGNATION:		Pacific Beach		
		ZONING INFORMATION:		
ZONE:	RM-3-7			
HEIGHT LIMIT:	40 feet			
LOT SIZE:	12-acres			
FLOOR AREA RATIO:	N/A			
FRONT SETBACK:	10/20 feet			
SIDE SETBACK:	5 feet			
STREETSIDE SETBACK	: 10 feet			

	LAND USE DESIGNATION & ZONE	EXISTING LAND USE	
NORTH:	NORTH: Residential; RM-1-1 Residential		
SOUTH:	Commercial; CN-1-2	Commercial/Neighborhood	
EAST:	Residential; RM-3-7	Residential	
WEST:	Residential; RM-1-1	Residential	
DEVIATIONS OR VARIANCES REQUESTED (INCENTIVES):	Length of extension of antennas over 18-inches		
COMMUNITY PLANNING GROUP RECOMMENDATION:	On June 9, 2021 the Pacific Beach Community Planning Group voted 14-0-0 to recommend approval of the project without conditions.		

REAR SETBACK:

PARKING:

5 feet

N/A

PLANNING COMMISSION
RESOLUTION NO. _____
CONDITIONAL USE PERMIT NO. 2539308
PLANNED DEVELOPMENT PERMIT NO. 2539310
T-MOBILE BAY POINT APT. PROJECT NO. 678588

WHEREAS, 700 BAY POINTE, LLC, OWNER, Owner, and T-MOBILE USA, Permittee, filed an application with the City of San Diego for a permit for a Wireless Communication Facility (as described in and by reference to the approved Exhibits "A" and corresponding conditions of approval for the associated Permit Nos. 2539308 and 2539310), on portions of a 12.0-acre site;

WHEREAS, the project site is located at 3910 Ingraham Street in the RM-3-7 zone of the Pacific Beach Community Plan; and

WHEREAS, the project site is legally described as Parcel 1: Lot 2 of South Bay Club

Apartments – Mission Bay, in the City of San Diego, County of San Diego, State of California,

according to map thereof no. 5935, filed in the Office of the County Recorder of San Diego County,

August 10, 1967. Parcel 2: Lot 1 South Bay Apartments – Mission Bay, Resubdivision No. 1, in the City

of San Diego, County of San Diego, State of California, according to map thereof no. 6237, filed in the

Office of the County Recorder of San Diego County, November 26, 1968; and

WHEREAS, on July 16, 2021, the City of San Diego, as Lead Agency, through the Development Services Department, made and issued an Environmental Determination that the project is exempt from the California Environmental Quality Act (CEQA) (Public Resources Code Section 21000 et seq.) under CEQA Guideline Section 15301 (Existing facilities); and there was no appeal of the Environmental Determination filed within the time period provided by San Diego Municipal Code Section 112.0520; and

WHEREAS, on September 9, 2021, the Planning Commission of the City of San Diego considered Conditional Use Permit No. 2539308 and Planned Development Permit No. 2539310 pursuant to the Land Development Code of the City of San Diego; NOW, THEREFORE,

BE IT RESOLVED by the Planning Commission of the City of San Diego, that it adopts the following findings with respect to Conditional Use Permit No. 2539308 and Planned Development Permit No. 2539310:

A. CONDITIONAL USE PERMIT SAN DIEGO MUNICIPAL CODE (SDMC) Section 126.0305

- 1. Findings for all Conditional Use Permits:
 - a. The proposed development will not adversely affect the applicable land use plan.

The project proposes the continued use of a Wireless Communication Facility (WCF) by T-Mobile. The proposed wireless facility will contain three (3) panel antennas and one (1) Remote Radio Unit (RRU) screened behind one (1) Fiberglass Reinforced Panel (FRP) Box painted and textured to match the existing building; six (6) panel antennas and two (2) RRUs façade mounted with antenna skirts painted and textured to match the existing building. Accessory equipment continues to operate inside a 144-square foot equipment room. The WCF is located at 3910 Ingraham St. San Diego, CA 92109 in the RM-3-7 zone of the Pacific Beach Community Planning area. The WCF was previously approved for a Conditional Use Permit (CUP) on January 20, 2014 with a 10-year term.

The City of San Diego's General Plan (UD-15) requires that the visual impact of wireless facilities be minimized by concealing them inside existing structures or using screening techniques to hide or blend them into the surrounding area. The plan also calls for these facilities to be designed to be aesthetically pleasing and respectful of the neighborhood context. Furthermore, the plan states that equipment associated with wireless facilities shall be concealed from view.

Pursuant to the San Diego Land Development Code (SDMC) Section 142.0420, WCFs are permitted in all zones citywide with the appropriate permit process. Wireless Communication Facilities are separately regulated uses, which have limitations or require compliance with conditions in order to minimize potential impacts. The intent of the regulations is to camouflage facilities from public view. For the proposed project, the façade mounted antennas are screened and well-integrated with the existing architecture of the building and any potential visual impacts will be minimized.

Pursuant to SDMC Section 141.0420(c)(2) when the WCF is in a residential zone on a premise that contains residential development, a Conditional Use Permit (CUP) is required. Additionally, in accordance to SDMC Section 143.0402, deviations from applicable zoning regulations require a Planned Development Permit (PDP). SDMC 141.0420(g)(8) states that panel antennas shall be mounted no more than 12 inches away from a building façade and shall appear as an integral part of the building. They may be mounted up to 18 inches away from a building façade when the applicant provides evidence demonstrating that the wireless communication facility cannot operate without incorporating a tilt greater than 12 inches. With newer technology and larger sized antennas, T-Mobile requires up to 23 inches for this modification. The facility has been designed in a way that is architecturally integrated with the building and have camouflaged the antennas to be less visible.

As a result, the project compiles with SDMC Section 141.0420, the WCF Design Guidelines, as well as the City's General Plan. The proposed development would not adversely affect the Pacific Beach Community Plan or the City of San Diego General Plan. Therefore, the proposed development will not adversely affect the applicable land use plan.

b. The proposed development will not be detrimental to the public health, safety and welfare.

The project was determined to be exempt from CEQA pursuant to Section 15301 (Existing Facilities). The conditions of approval for the project will require compliance with several operational constraints and development controls intended to assure the continued public health, safety and welfare to include but not limited to height limitation, concealment requirements, and electromagnetic fields controls. All proposed improvement plans associated with the project will be reviewed prior to issuance of construction permits and inspected during construction to assure the project will meet or exceed all relevant and applicable building, electrical, mechanical, plumbing and fire codes.

The Telecommunication Act of 1996 preempts local governments from regulating the "placement, construction and modification of wireless communication facilities on the basis of the environmental effects of Radio Frequency (RF) emissions to the extent that such facilities comply with the Federal Communication Commission's (FCC) standards for such emissions. A Radio Frequency – Electromagnetic Energy (RF-EME) Compliance Report (NSB) dated April 2, 2021 from EBI Consulting, was submitted to the City verifying that the proposed project meets or exceeds the requirements of the FCC. The report will be stamped as Exhibit "A" and provided within the project file. Therefore, the proposed development will not be detrimental to the public health, safety, and welfare.

 The proposed development will comply with the regulations of the Land Development Code including any allowable deviations pursuant to the Land Development Code The project proposes the continued use of a WCF. The project complies with the City of San Diego WCF Regulations (SDMC Section 141.0420) and applicable development regulations of the RM-3-7 Zone.

Deviations to the SDMC may be processed through a PDP in accordance with SDMC 126.0601 and 143.0401. The purpose of the PDP is to establish a review process for development that allows an applicant to request greater flexibility from the strict application of the regulations than would be allowed through a deviation process. The intent is to encourage imaginative and innovative planning and to assure that the development achieves the purpose and intent of the applicable land use plan and that it would be preferable to what would be achieved by strict conformance with the regulations.

SDMC 141.0420(g)(8) states that panel antennas shall be mounted no more than 12 inches away from a building façade and shall appear as an integral part of the building. They may be mounted up to 18-inches away from a building façade when the applicant provides evidence demonstrating that the wireless communication facility cannot operate without incorporating a tilt greater than 12 inches. A deviation is being requested to increase the projection of the antenna concealment up to 23inches from the face of the building. The proposed FRP screening box and antenna skirts require a longer distance for adequate operation of the WCF. The measurements of the antennas, mounting hardware, and the required antenna azimuth make the 18-inch distance unfeasible. The proposed distances for the antennas range from 19-inches to 23-inches and allow T-Mobile to have enough room for the antennas, required mounting hardware, the required azimuth and concealing the antennas to comply with the City of San Diego Development Services WCF concealment guidelines. The WCF ordinance, found in Chapter 14, Article 4, Division 20, required the maximum distance of 18-inches when antennas and equipment were smaller and the requirements were restricted. Due to the high demand of WCFs, the antennas are larger to assist the need for increasing capacity and demand.

The facility has been designed in a way that is architecturally integrated with the building and have camouflaged the antennas to be less visible by locating all the antennas near the facia, with three (3) panel antennas and one (1) RRU being concealed in a FRP box that will match the existing stucco texture and paint color; three (3) panel antennas and one (1) RRU with antenna skirts that match the existing green siding, located on the north and east sides of the building.

The project was originally approved on January 30, 2014 (Project No. 286694). In order to continue providing service to the surrounding area, the antennas need to be updated with newer antenna models and remain at the height and orientation they were originally installed as the network was developed using those metrics for coverage. The proposed WCF will provide a critical voice and data service throughout the surrounding area. The continued operation of this site is necessary to maintain the existing levels of service to the area for T-Mobile customers. The site is an

integral part of telecommunication networks, as the site's operation is closely coordinated with other sites in the area. Coverage maps demonstrate the existing coverage provided on the subject property and the predicted loss of coverage without the antenna upgrade. A degradation of the existing service could have a significant impact on customers and essential emergency communication services. Expiration dates are imposed on WCFs to review and modify these facilities to comply with current design standards. The subject project is conditioned to expire 10-years from its approval date.

Based on these considerations, this project complies with the permit and design requirements for WCF's as identified in the SDMC. Therefore, the proposed development will comply with the regulations of the Land Development Code including any proposed deviations pursuant to SDMC Section 126.0602(b)(1) that are appropriate for this location and will result in a more desirable project than would be achieved if designed in strict conformance with the development regulations of the applicable zone, and any allowable deviations that are otherwise authorized pursuant to the Land Development Code.

d. The proposed use is appropriate at the proposed location.

The project proposes the continued use of a Wireless Communication Facility (WCF) with all the antennas mounted near the facia, with three (3) panel antennas and one (1) RRU being concealed in a FRP box that will match the existing stucco texture and paint color; three (3) panel antennas and one (1) RRU with antenna skirts that match the existing green siding, located on the north and east sides of the building.

A site justification analysis was prepared by T-Mobile and accepted by City staff demonstrating a need for this WCF. According to the justification analysis, without the existing coverage footprint from the existing WCF, the loss of the coverage could result in significant impacts to the neighborhood and those living, working, and traveling through the surrounding area. Additionally, a loss of service could possibly have a significant impact on customers and essential communications services. The WCF is appropriately designed at the location and integrates with the existing building by matching the paint color and the texture of the FRP box and antenna skirts to the existing building. The FRP box and antenna skirts further complement the existing building design by matching existing vertical design elements. The design is consistent with the City's General Plan for wireless facilities. A 10-year term will be included as a condition of approval to ensure that the design and use is still appropriate at that time. As demonstrated by the justification analysis and the design, the existing WCF is appropriate at the existing location.

B. PLANNED DEVELOPMENT PERMIT SDMC Section 126.0605

1. Findings for all Planned Development Permits:

a. The proposed development will not adversely affect the applicable land use plan.

Please see CUP Finding No. 1 above for facts supporting this Finding. For the reasons described in that Finding, which are hereby incorporated into this Finding by reference, the proposed development will not adversely affect the applicable land use plan.

b. The proposed development will not be detrimental to the public health, safety and welfare.

Please see CUP Finding No. 2 above for facts supporting this Finding. For the reasons described in that Finding, which are hereby incorporated into this Finding by reference, the proposed development will not be detrimental to the public health, safety, and welfare.

c. The proposed development will comply with the regulations of the Land Development Code including any proposed deviations pursuant to Section 126.0602(b)(1) that are appropriate for this location and will result in a more desirable project than would be achieved if designed in strict conformance with the development regulations of the applicable zone, and any allowable deviations that are otherwise authorized pursuant to the Land Development Code.

Please see CUP Finding No. 3 above for facts supporting this Finding. For the reasons described in that Finding, which are hereby incorporated into this Finding by reference, the proposed development will comply with the regulations of the Land Development Code including any proposed deviations pursuant to SDMC Section 126.0602(b)(1) that are appropriate for this location and will result in a more desirable project than would be achieved if designed in strict conformance with the development regulations of the applicable zone, and any allowable deviations that are otherwise authorized pursuant to the Land Development Code.

The above findings are supported by the minutes, maps and exhibits, all of which are incorporated herein by this reference.

BE IT FURTHER RESOLVED that, based on the findings hereinbefore adopted by the Planning Commission, Conditional Use Permit No. 2539308 And Planned Development Permit No. 2539310 is hereby GRANTED by the Planning Commission to the referenced Owner/Permittee, in the form,

ATTACHMENT 5

exhibits, terms and conditions as set forth in Permit No. 2539308 and 2539310, a copy of which is attached hereto and made a part hereof.

lan Heacox Development Project Manager Development Services

Adopted on: September 9, 2021

IO#: 11004545

RECORDING REQUESTED BY
CITY OF SAN DIEGO
DEVELOPMENT SERVICES
PERMIT INTAKE, MAIL STATION
501

WHEN RECORDED MAIL TO PROJECT MANAGEMENT PERMIT CLERK MAIL STATION 501

INTERNAL ORDER NUMBER: 11004545 SPACE ABOVE THIS LINE FOR RECORDER'S USE

CONDITIONAL USE PERMIT NO. 2539308 PLANNED DEVELOPMENT PERMIT NO. 2539310 T-MOBILE BAY POINT APARTMENTS PROJECT NO. 678588 PLANNING COMMISSION

This Conditional Use Permit No. 2539308 and Planned Development Permit No. 2539310 is granted by the Planning Commission of the City of San Diego to 700 Bay Pointe, LLC, Owner, and T-Mobile USA, permittee, pursuant to San Diego Municipal Code [SDMC] section 141.0420, 126.0602 and 126.0303. The 12.0 -acre site is located at 3910 Ingraham Street in the RM-3-7 zone of the Pacific Beach Community Plan. The project site is legally described as: Parcel 1: Lot 2 of South Bay Club Apartments – Mission Bay, in the City of San Diego, County of San Diego, State of California, according to map thereof no. 5935, filed in the Office of the County Recorder of San Diego County, August 10, 1967. Parcel 2: Lot 1 South Bay Apartments – Mission Bay, Resubdivision No. 1, in the City of San Diego, County of San Diego, State of California, according to map thereof no. 6237, filed in the Office of the County Recorder of San Diego County, November 26, 1968.

Subject to the terms and conditions set forth in this Permit, permission is granted to Owner and Permittee for a Wireless Communication Facility (WCF) described and identified by size, dimension, quantity, type, and location on the approved exhibits [Exhibit "A"] dated September 9, 2021, on file in the Development Services Department.

The project shall include:

- a. The continued operation of a Wireless Communication Facility (WCF) consisting nine (9) panel antennas measuring 33.1" by 20.6" by 8.6" and 50.94" by 12.01" by 6.5" and 56.6" by 12.9" by 8.7" and three (3) Remote Radio Units (RRUs);
- b. One (1) Fiberglass Reinforced Panel (FRP) transparent screen wall mounted on the west building wall covering three (3) panel antennas and one (1) RRU painted and textured to match the existing building;

Three (3) panel antennas mounted on the north face building wall covered with antenna skirts painted and textured to match existing structure;

- Three (3) panel antennas mounted on the north east building wall covered with antenna skirts painted and textured to match existing structure;
- c. A deviation from SDMC Section 141.0420(e)(8)(B) allowing the antenna concealment to protrude up to 23-inches from the building face where up to 18-inches is allowed;
- d. The equipment associated with this project will continue to operate inside a 144-square-foot equipment room on grade, below the stairwell and on the west elevation; and
- e. Public and private accessory improvements determined by the Development Services Department to be consistent with the land use and development standards for this site in accordance with the adopted community plan, the California Environmental Quality Act [CEQA] and the CEQA Guidelines, the City Engineer's requirements, zoning regulations, conditions of this Permit, and any other applicable regulations of the SDMC.

STANDARD REQUIREMENTS:

- 1. This permit must be utilized within thirty-six (36) months after the date on which all rights of appeal have expired. If this permit is not utilized in accordance with Chapter 12, Article 6, Division 1 of the SDMC within the 36-month period, this permit shall be void unless an Extension of Time has been granted. Any such Extension of Time must meet all SDMC requirements and applicable guidelines in effect at the time the extension is considered by the appropriate decision maker. This permit must be utilized by September 23, 2024.
- 2. This permit and corresponding use of this site shall **expire on September 23, 2031.** Upon expiration of this approval, the facilities and improvements described herein shall be removed from this site and the property shall be restored to its original condition preceding approval of this permit unless the applicant of record files a new application for a facility which will be subject to compliance with all regulations in effect at the time.
- 3. No later than ninety (90) days prior to the expiration of this approval, the Owner/Permittee may submit a new application to the Development Services Department for consideration with review and a decision by the appropriate decision maker at that time. Failure to submit prior to the deadline will be cause for enforcement for noncompliance, which may include penalties and fines.
- 4. Under no circumstances, does approval of this permit authorize the Owner/Permittee to utilize this site for WCF purposes beyond the permit expiration date. Use of this permit approval beyond the expiration date of this permit is prohibited.
- 5. No permit for the construction, occupancy, or operation of any facility or improvement described herein shall be granted, nor shall any activity authorized by this Permit be conducted on the premises until:
 - a. The Owner/Permittee signs and returns the Permit to the Development Services Department; and

- b. The Permit is recorded in the Office of the San Diego County Recorder.
- 6. While this Permit is in effect, the subject property shall be used only for the purposes and under the terms and conditions set forth in this Permit unless otherwise authorized by the appropriate City decision maker.
- 7. This Permit is a covenant running with the subject property and all of the requirements and conditions of this Permit and related documents shall be binding upon the Owner/Permittee and any successor(s) in interest.
- 8. The continued use of this Permit shall be subject to the regulations of this and any other applicable governmental agency.
- 9. Issuance of this Permit by the City of San Diego does not authorize the Owner/Permittee for this Permit to violate any Federal, State or City laws, ordinances, regulations or policies including, but not limited to, the Endangered Species Act of 1973 [ESA] and any amendments thereto (16 U.S.C. § 1531 et seq.).
- 10. The Owner/Permittee shall secure all necessary building permits. The Owner/Permittee is informed that to secure these permits, substantial building modifications and site improvements may be required to comply with applicable building, fire, mechanical, and plumbing codes, and State and Federal disability access laws.
- 11. Construction plans shall be in substantial conformity to Exhibit "A." Changes, modifications, or alterations to the construction plans are prohibited unless appropriate application(s) or amendment(s) to this Permit have been granted.
- 12. All of the conditions contained in this Permit have been considered and were determined necessary to make the findings required for approval of this Permit. The Permit holder is required to comply with each and every condition in order to maintain the entitlements that are granted by this Permit.

If any condition of this Permit, on a legal challenge by the Owner/Permittee of this Permit, is found or held by a court of competent jurisdiction to be invalid, unenforceable, or unreasonable, this Permit shall be void. However, in such an event, the Owner/Permittee shall have the right, by paying applicable processing fees, to bring a request for a new permit without the "invalid" conditions(s) back to the discretionary body which approved the Permit for a determination by that body as to whether all of the findings necessary for the issuance of the proposed permit can still be made in the absence of the "invalid" condition(s). Such hearing shall be a hearing de novo, and the discretionary body shall have the absolute right to approve, disapprove, or modify the proposed permit and the condition(s) contained therein.

13. The Owner/Permittee shall defend, indemnify, and hold harmless the City, its agents, officers, and employees from any and all claims, actions, proceedings, damages, judgments, or costs, including attorney's fees, against the City or its agents, officers, or employees, relating to the issuance of this permit including, but not limited to, any action to attack, set aside, void, challenge,

or annul this development approval and any environmental document or decision. The City will promptly notify Owner/Permittee of any claim, action, or proceeding and, if the City should fail to cooperate fully in the defense, the Owner/Permittee shall not thereafter be responsible to defend, indemnify, and hold harmless the City or its agents, officers, and employees. The City may elect to conduct its own defense, participate in its own defense, or obtain independent legal counsel in defense of any claim related to this indemnification. In the event of such election, Owner/Permittee shall pay all of the costs related thereto, including without limitation reasonable attorney's fees and costs. In the event of a disagreement between the City and Owner/Permittee regarding litigation issues, the City shall have the authority to control the litigation and make litigation related decisions, including, but not limited to, settlement or other disposition of the matter. However, the Owner/Permittee shall not be required to pay or perform any settlement unless such settlement is approved by Owner/Permittee.

LANDSCAPE REQUIREMENTS:

- 14. The Owner/Permittee shall be responsible for the maintenance of all landscape improvements shown on the approved plans, including in the right-of-way, unless long-term maintenance of said landscaping will be the responsibility of another entity approved by the Development Services Department. All required landscape shall be maintained consistent with the Landscape Standards in a disease, weed, and litter free condition at all times. Severe pruning or "topping" of trees is not permitted.
- 15. If any required landscape (including existing or new plantings, hardscape, landscape features, etc.) indicated on the approved construction documents is damaged or removed, the Owner/Permittee shall repair and/or replace in kind and equivalent size per the approved documents to the satisfaction of the Development Services Department within 30 days of damage or Certificate of Occupancy.

PLANNING/DESIGN REQUIREMENTS:

- 16. Every aspect of this project is considered an element of concealment including but not limited to the dimensions, bulk and scale, color, materials and texture. Any future modifications to this permit must not defeat concealment.
- 17. No overhead cabling is permitted.
- 18. The WCF shall conform to the approved construction plans.
- 19. Photo simulations shall be printed in color on the construction plans.
- 20. The City may require the Owner/Permittee to provide a topographical survey conforming to the provisions of the SDMC may be required if the City determines during construction, that there may be a conflict between the building(s) under construction and a condition of this Permit or a regulation of the underlying zone. The cost of any such survey shall be borne by the Owner/Permittee.

- 21. The Owner/Permittee shall install and maintain appropriate warning signage on the WCF as required by State and Federal regulations. The Owner/Permittee shall be responsible for complying with all State and Federal regulations.
- 22. Antennas and associated components, such as, but not limited to, remote radio units (RRUs), surge suppressors, etc., shall not exceed the height of any existing or proposed screen walls.
- 23. Use of or replacement of any building façade or mechanical screen with RF-transparent material for purposes of concealing antennas shall not result in any noticeable lines or edges in the transition to the original building. All RF-transparent material shall be painted and textured to match the original building and adjacent building surfaces.
- 24. The accuracy and validity of the RF Compliance Report, submitted by the Permittee, shall be assured while the WCF is in operation. If requested by the City, Owner/Permittee shall provide an updated RF Compliance Report to address any issues associated with the emitting components of the WCF.
- 25. All equipment, including transformers, emergency generators and air conditioners belonging to the Owner/Permittee shall be designed and operated consistent with the City noise ordinance. Ventilation openings shall be baffled and directed away from residential areas. Vibration resonance of operating equipment in the equipment enclosures shall be eliminated.
- 26. All facilities and related equipment shall be maintained in good working order. Any damaged equipment shall be repaired or replaced within thirty (30) calendar days of notification by the City of San Diego.
- 27. The Owner/Permittee shall notify the City within 30 days of the sale or transfer of this site to any other provider or if the site is no longer operational, in which case, the removal and the restoration of this site to its original condition is required.

Façade Mounted Antennas:

- 28. Antennas shall be painted and textured to match the building to the satisfaction of the Development Services Department.
- 29. All conduits related to this project shall be concealed inside the proposed side and bottom skirts painted to match the surface to which they are attached to the satisfaction of the Development Services Department.
- 30. No exposed pipes or mounting apparatus absent antennas shall be present at any time. Mounting pipes shall not be longer than the antennas.
- 31. Bottom chin covers shall be installed to current and future antennas. Chin covers shall be molded fiberglass to match the exact antenna dimensions and profile to the satisfaction of the Development Services Department. The chin covers shall be painted to match the antennas.

32. All bottom-fed conduits shall be routed directly into the port-holes at the same height level to avoid any excessive looping. All conduits must be organized and grouped within reason to the satisfaction of the Development Services Department.

INFORMATION ONLY:

- Please note that a Telecom Planning Inspection Issue will be placed on the project prior to
 Final Clearance from the City's Building Inspector to ensure compliance with the approved
 plans and associated conditions. Prior to calling for your Final Inspection from your building
 inspection official, please contact the Development Services Department Wireless
 Communication Facilities staff listed on City webpage,
 https://www.sandiego.gov/development-services/codes-regulations/wireless-communication-facilities, to schedule an inspection of the completed facility. Please schedule this
 administrative inspection at least five working days ahead of the requested Final Inspection
 date.
- The issuance of this development permit alone does not allow the immediate commencement or continued operation of the proposed use on site. The operation allowed by this discretionary permit may only begin or recommence after all conditions listed on this permit are fully completed and all required ministerial permits have been issued and received final inspection.
- Any party on whom fees, dedications, reservations, or other exactions have been imposed as
 conditions of approval of this permit, may protest the imposition within ninety days of the
 approval of this development permit by filing a written protest with the City Clerk pursuant to
 California Government Code-section 66020.
- This development may be subject to impact fees at the time of construction permit issuance.

APPROVED by the Planning Commission of the City of San Diego on September 9, 2021.

ATTACHMENT 6

Planned Development Permit No. 2539310 Conditional Use Permit No. 2539308 September 9, 2021

AUTHENTICATED BY THE CITY OF SAN D	IEGO DEVELOPMENT SERVICES DEPARTMENT
lan Heacox	
Development Project Manager	
NOTE: Notary acknowledgment	
must be attached per Civil Code section 1189 et seq.	

The undersigned Owner/Permittee, by execution hereof, agrees to each and every condition of this Permit and promises to perform each and every obligation of Owner/Permittee hereunder.

700 Bay Pointe, LLC Owner
By NAME: TITLE:
T-Mobile USA Permittee
By NAME: TITLE:

NOTE: Notary acknowledgments must be attached per Civil Code section 1189 et seq.

·· T·· Mobile·


SD06471A Coverage Maps

RF Team - San Diego Market

T-Mobile Area with SD06471A



-- T--Mobile Area without SD06471A

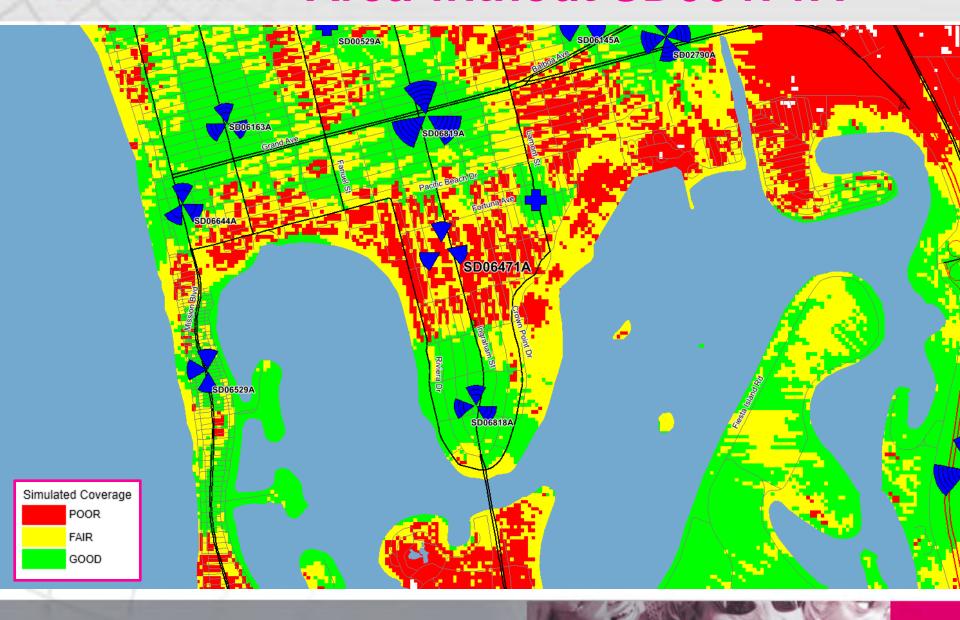

	NOTICE OF E	XEMPTION	
(Check	k one or both)		
TO:	X Recorder/County Clerk	FROM:	CITY OF SAN DIEGO
	P.O. Box 1750, MS A-33		DEVELOPMENT SERVICES DEPARTMENT
	1600 Pacific Hwy, Room 260		1222 First Avenue, MS 501
	San Diego, CA 92101-2422		SAN DIEGO, CA 92101
	Office of Planning and Research		
	1400 TENTH STREET, ROOM 121		•
	SACRAMENTO, CA 95814		
Proje	ct No.: 678588	Project Title: T-	-Mobile Bay Point
PROJEC	TT LOCATION-SPECIFIC: The project is located at 3	910 Ingraham Str	eet, San Diego, CA 92109
PROJEC	CT LOCATION-CITY/COUNTY: San Diego/San Diego		
Devel (WCF) (RRUs panel squar zone, only a	RIPTION OF NATURE AND PURPOSE OF THE PROPERTY opment Permit (PDP) to modify and to continuous. The project would remove 6 panel antennas as in install 3 RRUs, and remove 3 TMAs. All 6 shrot transparent screen wall. The associated equipment room. The project is located the Coastal Zone N-APP-2, and the CHLOZ 2. The required for routine maintenance and repair	e the use of an ex and install 9 pane ouds would be rep oment would cont at 3910 Ingraham he WCF is unman s.	kisting Wireless Communication Facility el antennas, remove 8 remote radio units olaced with the addition of 1 fiber glass tinue to operate inside an existing 144-in Street, San Diego, CA 92109 in the RM-3-7 ned and technicians would visit the site
	of Person or Agency Carrying Out Project: Delia San Diego, CA 92130. (858) 799-0575	ah Bruzee, OBO T	-Mobile, 10590 W. Ocean Air Drive Suite
EXEMP () () () (X) ()	PT STATUS: (CHECK ONE) MINISTERIAL (SEC. 21080(b)(1); 15268); DECLARED EMERGENCY (SEC. 21080(b)(3); 15269 EMERGENCY PROJECT (SEC. 21080(b)(4); 15269 CATEGORICAL EXEMPTION: 15302 (Replacement STATUTORY EXEMPTION:	(b)(c)	on)

REASONS WHY PROJECT IS EXEMPT: The City of San Diego conducted an environmental review which determined that the proposed project is exempt from CEQA pursuant to CEQA Guidelines Section 15302. CEQA Section 15302 allows for the replacement or reconstruction of existing structures and facilities where the new structure will be located on the same site and will have substantially the same purpose and capacity as the structure being replaced. The proposed project is modifying the existing facility and would replace old equipment with new without expanding the use of the WCF. No environmental impacts were identified for the proposed project and none of the exceptions described in CEQA Guidelines Section 15300.2 apply.

LEAD AGENCY CONTACT PERSON: Jeffrey Szymanski

TELEPHONE: 619 446-5324

IF FILED BY APPLICANT:

- 1. ATTACH CERTIFIED DOCUMENT OF EXEMPTION FINDING.
- 2. HAS A NOTICE OF EXEMPTION BEEN FILED BY THE PUBLIC AGENCY APPROVING THE PROJECT?

SIZNUZ PLANNET

() YES () NO

IT IS HEREBY CERTIFIED THAT THE CITY OF SAN DIEGO HAS DETERMINED THE ABOVE ACTIVITY TO BE EXEMPT FROM CEQA

SIGNATURE/TITLE

8/3/2021

DATE

CHECK ONE:

(X) SIGNED BY LEAD AGENCY

CLERK OR OPR:

DATE RECEIVED FOR FILING WITH COUNTY



City of San Diego Development Services 1222 First Ave., MS 302 San Diego, CA 92101 (619) 446-5000

Ownership Disclosure Statement

FORM

DS-318

October 2017

Approval Type: Check appropriate box for type of Neighborhood Development Permit □ Site □ Tentative Map □ Vesting Tentative Map □ Neighborhood Development Permit □ Site □ Tentative Map □ Neighborhood Development Permit □ Neighborhood Developme	Development Permit 🛭 Planned 🛭	evelopment Permit	☐ Conditional Use P	ent Permit ermit 🗖 Variance
Project Title:		Project No	o. For City Use Only	:
Project Address:				
Specify Form of Ownership/Legal Status (ple	ease check):			
lue Corporation lue Limited Liability -or- lue Gene	ral – What State?C	orporate Identificatio	n No	
☐ Partnership ☐ Individual				
By signing the Ownership Disclosure Statemen with the City of San Diego on the subject pro owner(s), applicant(s), and other financially intindividual, firm, co-partnership, joint venture, with a financial interest in the application. If t individuals owning more than 10% of the shar officers. (A separate page may be attached if n ANY person serving as an officer or director A signature is required of at least one of the notifying the Project Manager of any changes ownership are to be given to the Project Manaaccurate and current ownership information of	perty with the intent to record a erested persons of the above refassociation, social club, fraternal the applicant includes a corporation. If a publicly-owned corporation of the nonprofit organization of the nonprofit organization of the nonprofit organization in ownership during the time the ger at least thirty days prior to a	in encumbrance againgle erenced property. A organization, corporation, include the name profit organization or as trustee or beneval pages if needed, e application is being ny public hearing on	nst the property. F financially intereste ation, estate, trust, r clude the names, til s, titles, and addres a trust, list the name ficiary of the nonp Note: The applical g processed or cons	Please list below the d party includes any eceiver or syndicate cles, addresses of all ses of the corporate les and addresses of profit organization. In the sidered. Changes in
Property Owner				
Name of Individual:		Owner	☐ Tenant/Lessee	☐ Successor Agency
Street Address:				
City:			State:	Zip:
Phone No.:	Fax No.:	Email:		
Signature: <u>See attached Letter</u>	of Authorization	Date:		
Additional pages Attached:	□ No			
Applicant				
Name of Individual:		Owner	☐ Tenant/Lessee	☐ Successor Agency
Street Address:				
City:			State:	Zip:
Phone No.:	Fax No.:	Email:		
Signature: Delilah Bruzee		Date:	2/17/21	
Additional pages Attached:	□ No			
Other Financially Interested Persons				
Name of Individual:			☐ Tenant/Lessee	☐ Successor Agency
Street Address:				
City:			State:	Zip:
Phone No.:	Fax No.:	Email:		
Signature:				
Additional pages Attached:				



October 14, 2020

To: Md7, LLC Delilah Bruzee, Land Use 10590 W Ocean Air Drive, Suite 300 San Diego, CA 92130 (858) 799-0575 dbruzee@md7.com

From:

Conrad Prebys Trust 5847 El Cajon Blvd San Diego, CA 92115

Re:

Property Owner Letter of Authorization

Site ID:

SD06471A

Site Address:

3910 Ingraham St, San Diego, CA, 92109

Parcel ID:

423-423-13-00

Dear Sir or Madam:

This is to certify that I, MIRIA Castro am the legal property owner of record, and hereby authorize Md7, LLC, as agent for T-Mobile West, LLC, to file the documents necessary to obtain the permit approvals for T-Mobile West, LLC to make modifications to its existing cell site located at 3910 Ingraham St, San Diego, CA, 92109.

By:

Property Owner Signature

Name and Title

Milein Castro - Director of Operations ime and Title 19-540-9434/858-273-0733 ext 121

May 2020



City of San Diego Development Services


Community Planning Committee Distribution Form

Project Name: Project Number: 678588			
3910 Ingraham St T-Mobile Bay Pointe Apts CUP 678588 Community: Pacific Beach			
Facilic Deach			
' ' '		ation (project ma //aca.accela.com/	nager and applicant), <u>'SANDIEGO</u> .
Select "Search for Project Stat	us" and input th	e Project Number	r to access project information.
● Vote to Approve □ Vote to Approve with Conditions Listed Below □ Vote to Approve with Non-Binding Recommendations Listed Below □ Vote to Deny			
# of Members Yes	# of Members	No	# of Members Abstain
14	0		0
Conditions or Recommendation	s: 		
□ No Action (Please specify, e.g., Need further in	nformation, Split vote	, Lack of quorum, etc.	.)
NAME: Ed Gallagher			
TITLE: Chair, Development Subcommittee			DATE: June 09, 2021
Attach additional pages if necessary (maximum 3 attachments).			



3910 Ingraham St., San Diego CA 92109

Map

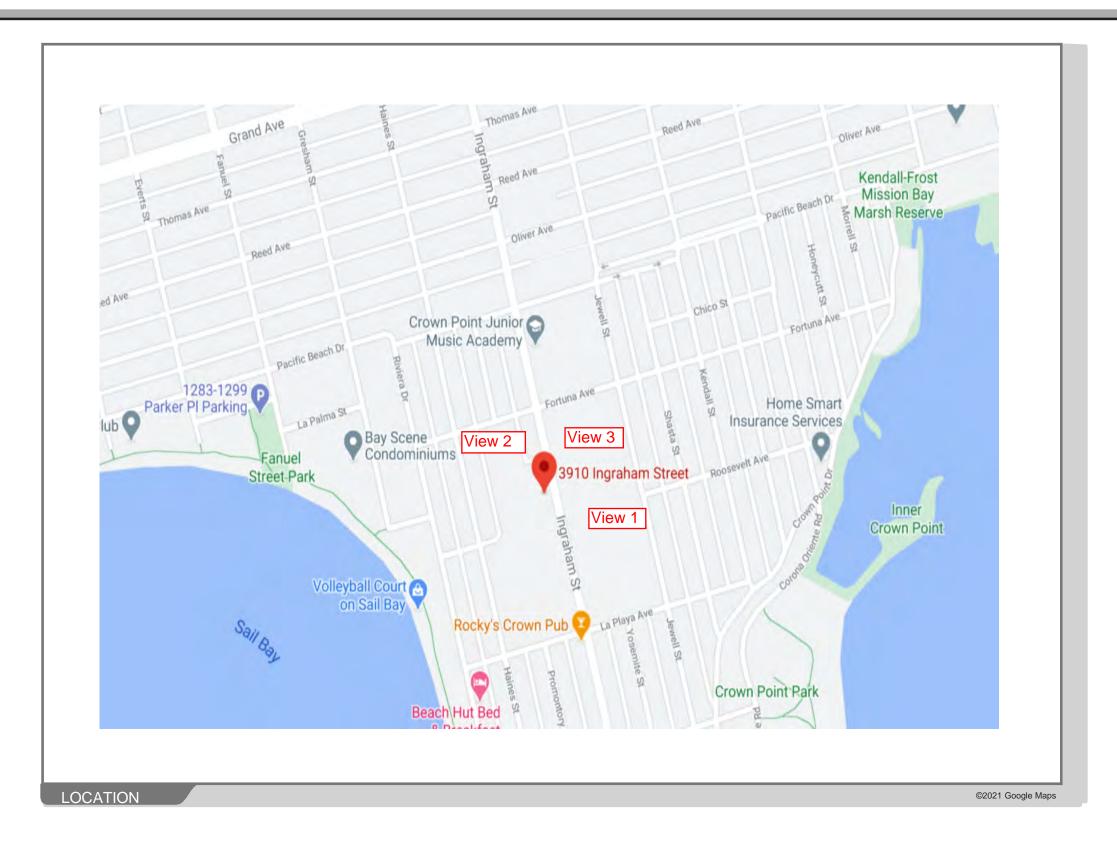



3910 Ingraham St., San Diego CA 92109





3910 Ingraham St., San Diego CA 92109





3910 Ingraham St., San Diego CA 92109






SD06471A



3910 INGRAHAM STREET SAN DIEGO CA 92109

VIEW 1



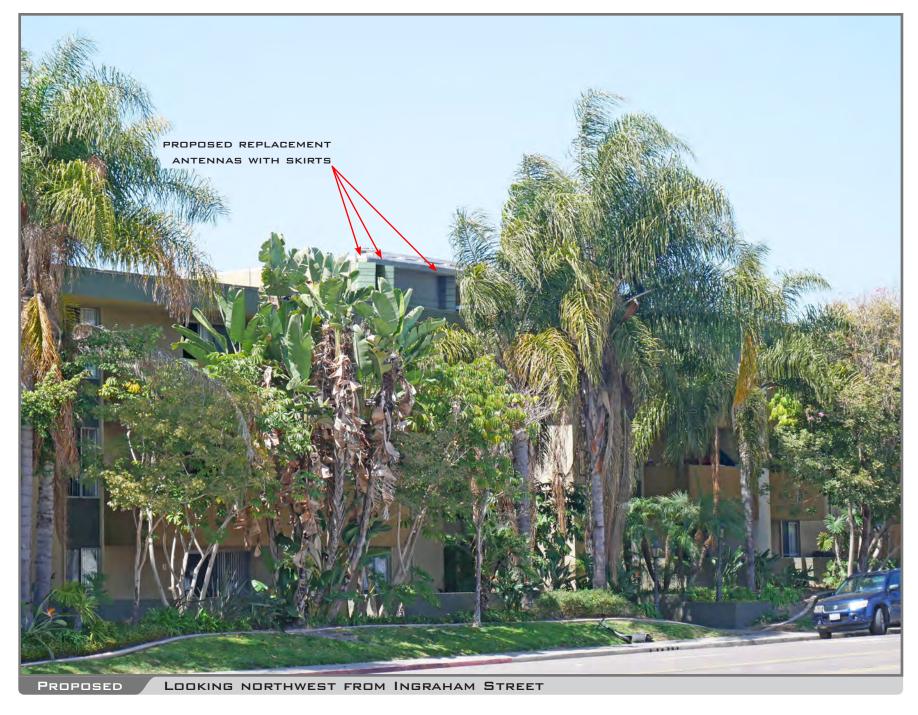





3910 INGRAHAM STREET SAN DIEGO CA 92109

VIEW 2









3910 INGRAHAM STREET SAN DIEGO CA 92109

VIEW 3





BAY POINTE APARTMENTS SITE NAME:

SITE ADDRESS: 3910 INGRAHAM ST SAN DIEGO, CA 92109

T-MOBILE SITE NUMBER: SD06471A

> PROJECT: **ANCHOR**

SITE TYPE: **ROOF TOP**

PROJECT INFORMATION

BAY POINTE APARTMENT SITE NAME: SITE ADDRESS 3910 INGRAHAM ST SAN DIEGO, CA 92109

SAN DIEGO COUNTY COUNTY 32° 47′ 28.80″ N (32.79133397°) LATITUDE: 117' 14' 19.59" W (-117.23877700') LONGITUDE:

48.0' AMSI GROUND ELEVATION

STRUCTURE HEIGHT: 26'-6" (TOP OF BUILDING) JURISDICTION: CITY OF SAN DIEGO PARCEL: 423-423-1300

ZONING: KM - 3 - 7UNMANNED TELECOMMUNICATION FACILITY OCCUPANCY:

CONSTRUCTION INFORMATION:

AREA OF CONSTRUCTION: CONSTRUCTION TYPE:

UNMANNED TELECOMMUNICATIONS FACILITY PROPOSED USE: FACILITY IS UNMANNED AND NOT FOR HUMAN HABITATION. HANDICAPPED ACCESS NOT REQUIRED HANDICAP REQUIREMENTS:

EXISTING/NO CHANGE

TOWER OWNER:

PROPERTY OWNER:

700 BAY POINTE LLC C/O PROGRESS MANAGEMENT 3866 INCRAHAM ST SAN DIEGO, CA 92109

APPLICANT: T-MOBILE USA, INC

10509 VISTA SORRENTO PARKWAY, SUITE 206 SAN DIEGO, CA 92121

VICINITY MAP lán Baylofts Apartments 💽 Crown Point Junior ana Condos Ava O 0

DIRECTIONS

DIRECTIONS TO SITE (FROM T-MOBILE10509, VISTA SORRENTO PARKWAY, SUITE 206 SAN DIEGO, CA 92121)

- HEAD NORTHWEST ON VISTA SORRENTO PKWY TOWARD LUSK BLVD TURN LEFT ON TO SORRENTO VALLEY BLVD TURN RIGHT ON TO ROSELLE ST TURN LEFT TO MERGE ON TO 1–5 S TAKE EXIT 23 TOWARD BALBOA AVE/GARNET AVE MERGE ON TO MISSION BAY DR TURN RIGHT ON TO GARNET AVE CONTINUE ON TO GARNET AVE CONTINUE ON TO BALBOA AVE TURN LEFT ON TO INGRAHAM ST DESTINATION WILL BE ON THE RIGHT

- DESTINATION WILL BE ON THE RIGHT

SECTION 11B-203.5 (MACHINERY SPACES)

ACCESSIBILITY REQUIREMENTS

FACILITY IS UNMANNED AND NOT FOR HUMAN HABITATION, HANDICAP ACCESS IS NOT REQUIRED PER CBC 2019
SECTION 11B-203.4 (LIMITED ACCESS SPACES)

PROJECT TEAM

CONSTRUCTION MANAGER: T-MOBILE USA

10509 VISTA SORRENTO PKWY, SUITE 206

SAN DIEGO, CA 92121 PHONE: (760) 644-1027

SITE ACQUISITION AGENT:

10590 WEST OCEAN AIR DRIVE, SUITE 300 SAN DIFGO, CA 92130 PHONE: (619) 947-0762

ZONING/PERMITTING AGENT:

JUSTIN CAUSEY

SAN DIEGO, CA 92130 PHONE: (858) 291-1869

ARCHITECT & ENGINEERING MORRISON HERSHFIELD

LESLIE BRADLEY 600 STEWART STREET SUITE 200

SEATTLE, WA 98101 PHONE: (206) 992-1684

ENGINEER:

TED HAILE MORRISON HERSHFIELD CORP. PHONE: (503) 595-9128 thaile@morrisonhershfield.com

ARCHITECT:

MORRISON HERSHEIFI D. CORP. PHONE: (954) 577-4655

10590 WEST OCEAN AIR DRIVE, SUITE 300 RF ENGINEER: T-MOBILE USA

PEDRO ABE 10509 VISTA SORRENTO PKWY, SUITE 200 SAN DIEGO, CA 92121

SCOPE OF WORK

EXISTING EQUIPMENT TOTAL:
ANTENNAS: 6

PROPOSED EQUIPMENT TOTAL ANTENNAS: 9

T-MOBILE PROPOSES TO MODIFY AN EXISTING UNMANNED TELECOMMUNICATIONS FACILITY WITH THE FOLLOWING:

 REMOVE (6) PANEL ANTENNAS
 REMOVE (8) RADIOS
 REMOVE (3) TMAS INSTALL (9) PANEL ANTENNAS

(3) RRUS INSTALL ADD
 ADD (2) 6x12 HCS 6AWG (2X30M) (4) 6x12 HCS 4AWG (2x70M & 2x120M)

(6) SHROUDS (6) SHROUDS REMOVE INSTALL

 INSTALL RF TRANSPARENT SCREEN WALL AT GRADE LEVEL

(1) PBC 6500 CABINET REMOVE INSTALL PBC 6200 EQUIPMENT CABINET INSTALL BB6630 ON 19 INCH RACK INSTALL BB6648 ON 19 INCH RACK

 INSTALL) IXRE ROUTER CABINET POWER TO 8xPSU UPGRADE (1) VOLTAGE BOOSTER PSU 4813

• PROJECT VALUATION: \$40,000 NO PROPOSED BATTERY WORK

DESIGN BASED ON:

RFDS ANCHOR VERSION 6, DATED 12/14/2020 1:53:27 PM

APPROVALS

SIGNATURE

PROJECT MANAGER	
T-MOBILE RF ENGINEER	
SITE ACQUISITION	
CONSTRUCTION MANAGER	
SITE OWNER	
T-MOBILE DEVELOPMENT MANAGER	
T-MOBILE CONSTRUCTION MANAGER	
T-MOBILE OPS MANAGER	
T-MOBILE REGULATORY REVIEW	
T-MOBILE PROJECT MANAGER	

GROUNDING DETAILS CODE COMPLIANCE

INDEX OF DRAWINGS

DESCRIPTION

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E-1

TITLE SHEET

SITE PLAN

GENERAL NOTES

EQUIPMENT PLAN

ROOF PLAN

PLUMBING DIAGRAM

NORTH FLEVATION

WEST ELEVATION

SOUTH ELEVATION

CONSTRUCTION DETAILS

ELECTRICAL DETAILS

CONSTRUCTION DETAILS

CONSTRUCTION DETAILS

EAST ELEVATION

EXISTING ANTENNA CONFIGURATION

PROPOSED ANTENNA CONFIGURATION /1

ALL WORK AND MATERIALS SHALL BE PERFORMED AND INSTALLED IN
ACCORDANCE WITH THE CURRENT CONDITIONS OF THE FOLLOWING CODES AS ADOPTED BY THE LOCAL GOVERNING AUTHORITIES. NOTHING IN THESE PLANS IS TO BE CONSTRUED TO PERMIT WORK NOT CONFORMING TO THESE CODES:

CALIFORNIA STATE AND LOCAL BUILDING CODES WITH THE FOLLOWING

2019 CALIFORNIA BUILDING CODE (CBC) 2019 CALIFORNIA MECHANICAL CODE (CMC) 2019 CALIFORNIA PLUMBING CODE (CPC) 2019 CALIFORNIA ENERGY CODE (CEC) 2019 CALIFORNIA FIRE CODE (CFC)
2019 CALIFORNIA ELECTRICAL CODE (CEC)

CONTRACTOR TO CALL TO VERIFY UTILITIES AT

DO NOT SCALE DRAWINGS

CONTRACTOR SHALL VERIFY ALL PLANS & EXISTING DIMENSIONS & CONDITIONS ON THE JOB SITE & SHALL IMMEDIATELY NOTIFY THE ARCHITECT OR ENGINEER IN WRITING OF ANY DISCREPANCIES BEFORE PROCEEDING WITH THE WORK OR BE RESPONSIBLE FOR SAME



T Mobile



10590 WEST OCEAN AIR DRIVE

PLANS PREPARED BY



MORRISON HERSHFIELD 600 STEWART STREET, SUITE 200 Tel: 206.268.7370 www.morrisonhershfield.com

MH PROJECT NUMBER: 203531900

	П	REV.	DATE	ISSUED FOR	BY
	П	Α	10/09/20	90% REVIEW	GE
٦	П	0	12/23/20	100% CONSTRUCTION	MI
Ш		1	05/27/21	JX COMMENTS	JR
11					
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$\ \ $	П				
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+		SET N	OT TO BE	USED FOR CONSTRUC	CTIO

UNLESS SIGNED BY DESIGN PROFESSIONAL AND STAMPED APPROVED BY MUNICIPALITY



05/27/2021 1:54PM

BAY POINTE APARTMENT

T-MOBILE SITE I.D.

SD06471A

3910 INGRAHAM ST SAN DIEGO, CA 92109

SHEET NAME

TITLE SHEET

SHEET NUMBER

T-1

ELECTRICAL GENERAL NOTES ARCHITECTURAL GENERAL NOTES **ABBREVIATIONS** GA GAUGE GALV GALVANIZED GC GENERAL CONTRACTOR GRND GROUND GYP BD GYPSUM WALL BOARD WORK SHALL COMPLY WITH ALL APPLICABLE CODES, ORDINANCES, AND REGULATIONS. ALL NECESSARY LICENSES, ABOVE GROUND LEVEL **PLYWD** PLYWOOD PRESSURE TREATED PRO.I EXAMINE THE SITE CONDITIONS VERY CAREFULLY AND THE SCOPE OF PROPOSED WORK TOGETHER WITH THE WORK OF PROP (P) ALL OTHER TRADES AND INCLUDE IN THE BID PRICE ALL COSTS FOR WORK SUCH AS EQUIPMENT AND WIRING MADE NECESSARY TO ACCOMMODATE THE ELECTRICAL SYSTEMS SHOWN AND SYSTEMS OF OTHER TRADES. 2. THE GENERAL CONTRACTOR AND EACH SUBCONTRACTOR SHALL BE RESPONSIBLE FOR VERIFYING DIMENSIONS AND CONDITIONS AT THE JOB SITE WHICH COULD AFFECT THE WORK UNDER THIS CONTRACT. ALL MANUFACTURERS RECOMMENDED SPECIFICATIONS, EXCEPT THOSE SPECIFICATIONS HEREIN, WHERE MOST STRINGENT SHALL BE COMPLIED QTY QUANITY BLK BLOCKING OBTAIN ALL PERMITS, PAY ASSOCIATED FEES AND SCHEDULE INSPECTION HVAC HEATING VENTILATION AIR PROVIDE ALL LAGOR, MATERIAL, EQUIPMENT, INSURANCE, AND SERVICES TO COMPLETE THIS PROJECT IN ACCORDANCE WITH THE CONTRACT DOCUMENTS AND PRESENT IT AS FULLY OPERATIONAL TO THE SATISFACTION OF T-MOBILE & CLG CEILING CONDITIONING REQ REQUIRED THE CONTRACTOR SHALL VERIFY THAT NO CONFLICTS EXIST BETWEEN THE LOCATIONS OF ANY AND ALL MECHANICAL, ELECTRICAL, PLUMBING, OR STRUCTURAL ELEMENTS, AND THAT ALL REQUIRED CLEARANCES FOR INSTALLATION AND MAINTENANCE ARE MET. NOTIFY THE CONSULTANT OF ANY CONFLICTS. THE CONSULTANT HAS THE RIGHT TO MAKE MINOR MODIFICATIONS IN THE DESIGN OF THE CONTRACT WITHOUT THE CONTRACTOR GETTING ADDITIONAL CENTERI INF HOR7 HORIZONTAL CLEAR CONCRETE ROUGH OPENING RIGHT OF WAY LAND/TOWER OWNER CONC CONST CONT PRIOR TO BEGINNING WORK COORDINATE ALL POWER AND TELCO WORK WITH THE LOCAL UTILITY COMPANY AS IT MAY APPLY TO THIS SITE. ALL WORK TO COMPLY WITH THE RULES AND REGULATIONS OF THE UTILITIES INVOLVED GENERAL CONTRACTOR IS RESPONSIBLE FOR VED. REQUESTING CONNECTION OF COMMERCIAL POWER FROM THE POWER INFORMATION CONTINUOUS INSIDE DIAMETER SIMILAR 4. THE CONTRACTOR SHALL BE RESPONSIBLE FOR DAILY CLEAN UP OF ALL TRADES AND REMOVE ALL DEBRIS FROM THE CONSTRUCTION SITE. AT THE COMPLETION OF THE PROJECT, THE CONTRACTOR SHALL THOROUGHLY CLEAN THE BUILDING, SITE, AND ANY OTHER SURROUNDING AREAS TO A BETTER THAN NEW CONDITION. INSU INSULATION SPEC SPECIFICATION COMPANY, ELECTRICAL CONTRACTOR SHALL COORDINATE THIS WORK WITH THE GENERAL CONTRACTOR DIA DIAG DIM DBL DN DWG 10590 WEST OCEAN AIR DRIVE SQUARE FOOT STAINLESS STEEL DIAMETER INTERIOR DIAGONAL DIMENSION DOUBLE IBC INTERNATIONAL BUILDING CODE SUITE 300 SAN DIEGO. CA 92130 5. FARRICATION AND INSTALLATION OF THE COMPLETE FLECTRICAL SYSTEM SHALL RE DONE IN A FIRST CLASS. STEEL STRUCTURAL WORKMANSHIP PER NECA STANDARD 1-2000 BY QUALIFIED PERSONNEL EXPERIENCED IN SUCH WORK AND SHALL SCHEDULE THE WORK IN AN ORDERLY MANNER SO AS NOT TO IMPEDE PROGRESS OF THE PROJECT. THE CONTRACTOR IS RESPONSIBLE FOR ADEQUATELY BRACING AND PROTECTING ALL WORK DURING CONSTRUCTION AGAINST DAMAGE, BREAKAGE, COLLAPSE, ETC. ACCORDING TO APPLICABLE CODES, STANDARDS, AND GOOD LBS POUNDS STD SUSP DOWN DRAWING SUSPENDED PLANS PREPARED BY CONSTRUCTION PRACTICES. MANUFACTURER WHERE ONE DETAIL IS SHOWN FOR ONE CONDITION, IT SHALL APPLY FOR ALL LIKE OR SIMILAR CONDITIONS, EVEN THOUGH NOT SPECIFICALLY MARKED ON THE DRAWINGS OR REFERRED TO IN THE SPECIFICATIONS, UNLESS NOTED OTHERWISE. MAXIMUM THRU THROUGH B. BASIC MATERIALS AND METHODS ELECTRICAL ELEVATION MECHANICAL TNNG TYP TINNED ALL ELECTRICAL WORK SHALL CONFORM TO THE EDITION OF THE NEC ACCEPTED BY THE LOCAL JURISDICTION AND TO THE APPLICABLE LOCAL CODES AND REGULATIONS. WHERE NEW PAVING, CONCRETE SIDEWALKS OR PATHS MEET EXISTING CONSTRUCTION, THE CONTRACTOR SHALL MATCH THE EXISTING PITCH, GRADE, AND ELEVATION SO THE ENTIRE STRUCTURE SHALL HAVE A SMOOTH TRANSITION. UNDERGROUND UNLESS NOTED OTHERWISE MORRISON HERSHFIELD MISCELLANEOUS UG UNO ARRANGE CONDUIT, WIRING, EQUIPMENT, AND OTHER WORK GENERALLY AS SHOWN, PROVIDING PROPER CLEARANCES AND ACCESS. CAREFULLY EXAMINE ALL CONTRACT DRAWINGS AND FIT THE WORK IN EACH LOCATION WITHOUT SUBSTANTIAL ALTERATION. WHERE DEPARTURES ARE PROPOSED BECAUSE OF FIELD CONDITIONS OR OTHER CAUSES, PREPARE AND SUBMIT DETAILED DRAWINGS FOR ACCEPTANCE. **EXISTING** 600 STEWART STREET, SUITE 200 EXTERIOR SEATTLE, WA 98101 8. THE GENERAL CONTRACTOR SHALL OBTAIN WRITTEN CONFIRMATION OF THE EXPECTED DATE OF COMPLETION OF THE NOT APPLICABLE VERIFY IN FIELD Tel: 206.268.7370 CONNECTION FROM THE POWER COMPANY FINISH NIC NTS NOT IN CONTRACT VERT VERTICAL www.morrisonhershfield.com NOT TO SCALE IF THE POWER COMPANY IS UNABLE TO PROVIDE THE POWER CONNECTION BY OWNER'S REQUIRED DATE, THE GENERAL CONTRACTOR SHALL PROVIDE AND MAINTAIN A TEMPORARY GENERATOR UNTIL THE POWER COMPANY CONNECTION IS COMPLETED. COSTS ASSOCIATED WITH THE TEMPORARY GENERATOR TO BE APPROVED BY THE OWNER. FLUORESCENT WP W/ W/O WATER PROOF MH PROJECT NUMBER: 203531900 3. THE CONTRACT DRAWINGS ARE GENERALLY DIAGRAMMATIC AND ALL OFFSETS, BENDS, FITTINGS AND ACCESSORIES ARE WITH WITHOUT ON CENTER NOT NECESSARILY SHOWN. PROVIDE ALL SUCH ITEMS AS MAY BE REQUIRED TO FIT THE WORK TO THE CONDITIONS. OUTSIDE DIAMETER SEAL AROUND CONDUITS AND AROUND CONDUCTORS WITHIN CONDUITS ENTERING THE MODULAR CABINETS WHERE REV. DATE ISSUED FOR 10. PLANS PART OF THIS SET ARE COMPLEMENTARY. INFORMATION IS NOT LIMITED TO ONE PLAN. DRAWINGS AND SPECIFICATIONS ARE INSTRUMENTS OF SERVICE AND SHALL REMAIN THE PROPERTY OF THE ARCHITECT, WHETHER THE PROJECT FOR WHICH THEY ARE MADE IS EXECUTED OR NOT. THEY ARE NOT TO BE USED BY THE OWNER ON OTHER PROJECTS OR EXTENSION TO THIS PROJECT EXCEPT BY AGREEMENT IN WRITING AND WITH APPROPRIATE COMPENSATION TO MORRISON HERSHFIELD. THESE PLANS WERE PREPARED TO BE SUBMITTED TO GOVERNMENTAL BUILDING AUTHORITIES FOR REVIEW FOR COMPLIANCE WITH APPLICABLE CODES AND IT IS THE SOLE RESPONSIBILITY OF THE PENETRATION OCCURS WITH A SILICONE SEALANT TO PREVENT MOISTURE PENETRATION INTO BUILDING 10/09/20 90% REVIEW ---- UGT ---- UG TELCO CONDUIT — UGP —— UG POWER CONDUIT 0 12/23/20 100% CONSTRUCTION MLG LINESS NOTED OTHERWISE ALL CONDUCTORS SHALL BE COPPER MINIMUM SIZE #12 AWG WITH THERMOPLASTIC 05/27/21 JX COMMENTS INSULATION CONFORMING TO NEMA WC5 OR CROSS-LINKED POLYETHYLENE INSULATION CONFORMING TO NEMA WC7. (TYPES THHN). INSULATION SHALL BE RATED FOR 90 DEG. CONDUCTORS SHALL BE COLOR CODED IN ACCORDANCE OWNER AND/OR CONTRACTOR TO BUILD ACCORDING TO APPLICABLE BUILDING CODES 11. IF CONTRACTOR OR SUB-CONTRACTOR FIND IT NECESSARY TO DEVIATE FROM ORIGINAL APPROVED PLANS, THEN IT IS THE CONTRACTOR'S AND THE SUB-CONTRACTOR'S RESPONSIBILITY TO PROVIDE THE ARCHITECT WITH (4) COPIES OF THE PROPOSED CHANGES FOR HIS APPROVAL BEFORE PROCEEDING WITH THE WORK. IN ADDITION THE CONTRACTOR AND SUB-CONTRACTORS SHALL BE RESPONSIBLE FOR PROCURING ALL INCESSARY PAPROVALS FROM THE BUILDING AUTHORITIES FOR THE PROPOSED CHANGES BEFORE PROCEEDING WITH THE WORK. THE CONTRACTOR AND SUB-CONTRACTOR SHALL BE RESPONSIBLE FOR PROCURING ALL NECESSARY INSPECTIONS AND APPROVALS FROM BUILDING AUTHORITIES DURING THE EXECUTION OF THE WORK. 2. CONDUCTOR LENGTHS SHALL BE CONTINUOUS FROM TERMINATION TO TERMINATION WITHOUT SPLICES. SPLICES ARE NOT ACCEPTABLE. IF SPLICES ARE UNAVOIDABLE PRIOR APPROVAL FROM THE ENGINEER MUST BE OBTAINED. ALL LIGHTNING PROTECTION GROUNDING OF THE ELECTRICAL EQUIPMENT SHALL BE CARRIED OUT IN ACCORDANCE WITH SET NOT TO BE USED FOR CONSTRUCTION 12. IN EVERY EVENT, THESE CONSTRUCTION DOCUMENTS AND SPECIFICATIONS SHALL BE INTERPRETED TO BE A MINIMUM UNLESS SIGNED BY DESIGN PROFESSIONAL AND STAMPED APPROVED BY MUNICIPALITY ACCEPTABLE MEANS OF CONSTRUCTION BUT THIS SHALL NOT RELIEVE THE CONTRACTOR SUB-CONTRACTOR AND/OR SUPPLIER/MANUFACTURER FROM PROVIDING A COMPLETE AND CORRECT JOB WHEN ADDITIONAL ITEMS ARE REQUIRED TO THE MINIMUM SPECIFICATION. IF ANY ITEMS NEED TO EXCEED THESE MINIMUM SPECIFICATIONS TO PROVIDE A COMPLETE, ADEQUATE AND SAFE WORKING CONDITION, THEN IT SHALL BE THE DEEMED AND UNDERSTOOD TO BE ALL GROUND LUG AND COMPRESSION CONNECTIONS SHALL BE COATED WITH ANTI-OXIDANT AGENT, SUCH AS NO-OX, NOALOX, PENETROX OR KOPRSHIELD. LICENSURE: ALL EXTERIOR GROUNDING CONDUCTORS INCLUDING EXTERIOR GROUND RING SHALL BE #2 AWG SOLID BARE TINNED COPPER. MAKE ALL GROUND CONNECTIONS AS SHORT AND DIRECT AS POSSIBLE. AVOID SHARP BENDS. THE RADIUS OF ANY BEND SHALL NOT BE LESS THAN 8" AND THE ANGLE OF ANY BEND SHALL NOT EXCEED 90'. GROUNDING INCLUDED IN THE DRAWINGS. FOR EXAMPLE, IF AN ITEM AND/OR PIECE OF EQUIPMENT REQUIRES A LARGER WIRE SIZE (I.E. ELECTRICAL WIRE), STRONGER OR LARGER PIPING, INCREASED QUANTITY (I.E. STRUCTURAL ELEMENTS), REDUCED SPACING, AND/OR INCREASED LENGTH (I.E. BOLT LENGTHS, BAR LENGTHS) THEN IT SHALL BE DEEMED AND FESSIO UNDERSTOOD TO BE INCLUDED IN THE BID/PROPOSAL. THESE DOCUMENTS ARE MEANT AS A GUIDE AND ALL ITEMS REASONABLY INFERRED SHALL BE DEEMED TO BE INCLUDED. CONDUCTORS SHALL BE ROUTED DOWNWARD TOWARD THE BURIED GROUND RING REPAIR ALL GALVANIZED SURFACES THAT HAVE BEEN DAMAGED BY THERMO-WELDING WITH ERICO T-319 GALVANIZING 13. THESE CONTRACT DOCUMENTS AND SPECIFICATIONS SHALL NOT BE CONSTRUED TO CREATE A CONTRACTUAL RELATIONSHIP OF ANY KIND BETWEEN THE ARCHITECT AND THE CONTRACTOR. 5. ALL EXTERNAL GROUND CONNECTIONS SHALL BE EXOTHERMICALLY WELDED. ALL EXOTHERMIC WELDS TO EXTERIOR GROUND RING SHALL BE THE PARALLEL TYPE, EXCEPT FOR THE GROUND RODS WHICH ARE TEE EXOTHERMIC WELDS. REPAIR ALL GALVANIZED SURFACES THAT HAVE BEEN DAMAGED BY EXOTHERMIC WELDING. USE SPRAY GALVANIZER C 81056 EXP. 9.30.21 SUCH AS HOLUB LECTROSOL #15-501. afros OTATE OF CALIFOR 05/27/2021 1:54PM **COMPOUND NOTES** PROJECT INFORMATION IMPORTANT NOTICE THE EXISTING CONDITIONS REPRESENTED HEREIN ARE BASED ON VISUAL OBSERVATIONS AND INFORMATION PROVIDED BY OTHERS. MORRISON HERSHFIELD CORPORATION CANNOT GUARANTEE THE CORRECTNESS NOR COMPLETENESS OF THE EXISTING CONDITIONS SHOWN AND ASSUMES NO RESPONSIBILITY THEREOF. CONTRACTOR AND HIS SUB-CONTRACTORS SHALL VISIT THE SITE AND VERIFY ALL EXISTING CONDITIONS AS REQUIRED FOR PROPER EXECUTION OF PROJECT. REPORT ANY CONFLICTS OR DISCREPANCIES TO THE CONSULTANT PRIOR TO CONSTRUCTION. THIS IS AN UNMANNED AND RESTRICTED ACCESS EQUIPMENT AND WILL BE USED FOR THE TRANSMISSION OF RADIO CONTRACTOR AND SUBCONTRACTORS SHALL VERIFY ALL UTILITY SERVICE CONNECTION LOCATIONS PRIOR TO SUBMITTING BID AND PROCEEDING WITH WORK. IT IS RECOMMENDED THAT THE CONTRACTOR VISIT THE SITE AND VERIFY ALL SIGNALS FOR THE PURPOSE OF PROVIDING PUBLIC CELLULAR SERVICE SITE NAME DIMENSIONS AND NOTES BEFORE SUBMITTING BID AND PROCEEDING WITH WORK. **BAY POINTE** SOIL AT THIS SITE IS UNDISTURBED ROCK AND SAND ADEQUATE OF SUPPORTING THE DESIGN LOAD OF 2000 P.S.F. IF OTHER CONDITIONS ARE ENCOUNTERED, NOTIFY MORRISON HERSHFIELD BEFORE PROCEEDING WITH WORK. THIS VALUE IS CONSIDERED SAFE WITH RESPECT TO ACTUAL FAILURE OF THE SUPPORTING GROUND, BUT DOES NOT NECESSARILY ENSURE THE PREVENTION OF EXCESSIVE FOUNDATION MOVEMENTS. 3. NO POTABLE WATER SUPPLY IS TO BE PROVIDED AT THIS LOCATION **APARTMENT** 4. NO WASTE WATER WILL BE GENERATED AT THIS LOCATION. 5. NO SOLID WASTE WILL BE GENERATED AT THIS LOCATION 3. IN ORDER TO AVOID ANY CONFLICTS. CONTRACTOR SHALL COORDINATE ALL HIS PRACTICAL TRADES. T-MOBILE SITE I.D. 6. T-MOBILE MAINTENANCE CREW (TYPICALLY ONE PERSON) WILL MAKE AN AVERAGE OF ONE TRIP PER MONTH AT ONE THE POWER CABINET MUST BE CLEAR OF FLAMMABLE MATERIAL WITHIN 12 INCHES OF THE CABINET, INCLUDING ABOVE THE CABINET. SD06471A THE POWER CABINET MUST BE MOUNTED ON THE FOUNDATION TO ALLOW WATER TO DRAIN FROM THE DRAIN OUTLET AND AWAY FROM THE CABINET. **LEGEND** SITE ADDRESS: TO ENSURE SERVICEABLE ABILITY, THE DOORS OF CABINETS WILL REQUIRE AN OPENING RADIUS OF 36 INCHES OF CLEARANCE FROM THE CLOSED POSITION TO THE OPEN POSITION. 3910 INGRAHAM ST SITE GENERAL NOTES BUILDING/WALL/DETAIL SECTION LARGE SCALE DETAIL SAN DIEGO, CA 92109 - DETAIL NUMBER - DETAIL NUMBER SHEET NAME 1. RESTORE EXISTING ASPHALT AND/OR CONCRETE COMPOUND TO IT'S ORIGINAL CONDITION. 2. CONTRACTOR SHALL DETECT AND MARK ANY UNDERGROUND LINES, PIPING, PRIOR TO START OF EXCAVATION. **GENERAL NOTES** WHERE DETAILED WHERE DETAILED REFERENCE ELEVATION DETAIL BUG ∠ DETAIL NUMBER SHEET NUMBER T-2 - REFERENCED - SHEET NUMBER

GD

NOTE: THIS IS NOT A SURVEY. ALL INFORMATION AND TRUE NORTH HAVE BEEN OBTAINED FROM EXISTING DRAWINGS AND JURISDICTIONAL GIS INFORMATION AND ARE APPROXIMATE.


NOTES: 1. THIS PROJECT PROPOSES NO WORK WITHIN THE PUBLIC RIGHT-OF-WAY.

THIS PROJECT PROPOSES NO DEVELOPMENT IMPROVEMENTS OUTSIDE THE EXISTING BUILDING FOOTPRINT FOR THIS DISCRETIONARY REVIEW AND THEREFORE DOES NOT REQUIRE ANY PERMANENT STORM WATER BEST MANAGEMENT PRACTICES

IF ANY EXISTING LANDSCAPING INDICATED ON THE APPROVED CONSTRUCTION DOCUMENTS OR OTHERWISE LOCATED AT THE SITE IS DAMAGED OR REMOVED DURING CONSTRUCTION, IT SHALL BE REPAIRED AND/OR REPLACED IN KIND AND EQUIVALENT SIZE TO THE SATISFACTION OF THE DEVELOPMENT WITHIN 30 DAYS OF DAMAGE.

CONSTRUCTION ON THE BETA SECTOR SHALL BE COMPLETED FROM THE ROOFTOP TO ELIMINATE ANY DAMAGE TO THE EXISTING LANDSCAPING AT THIS ENTRANCE TO THE BUILDING. APPROPRIATE PEDESTRIAN ACCESS INSTRUCTIONS AND CAUTIONS SHALL BE PLACED TO MAXIMIZE THE SAFETY OF THE BUILDING TENANTS WHEN MOBILIZING THROUGH THE AREA

24"x36" SCALE: 1" = 100'-0" 11"x17" SCALE: 1" = 200'-0"

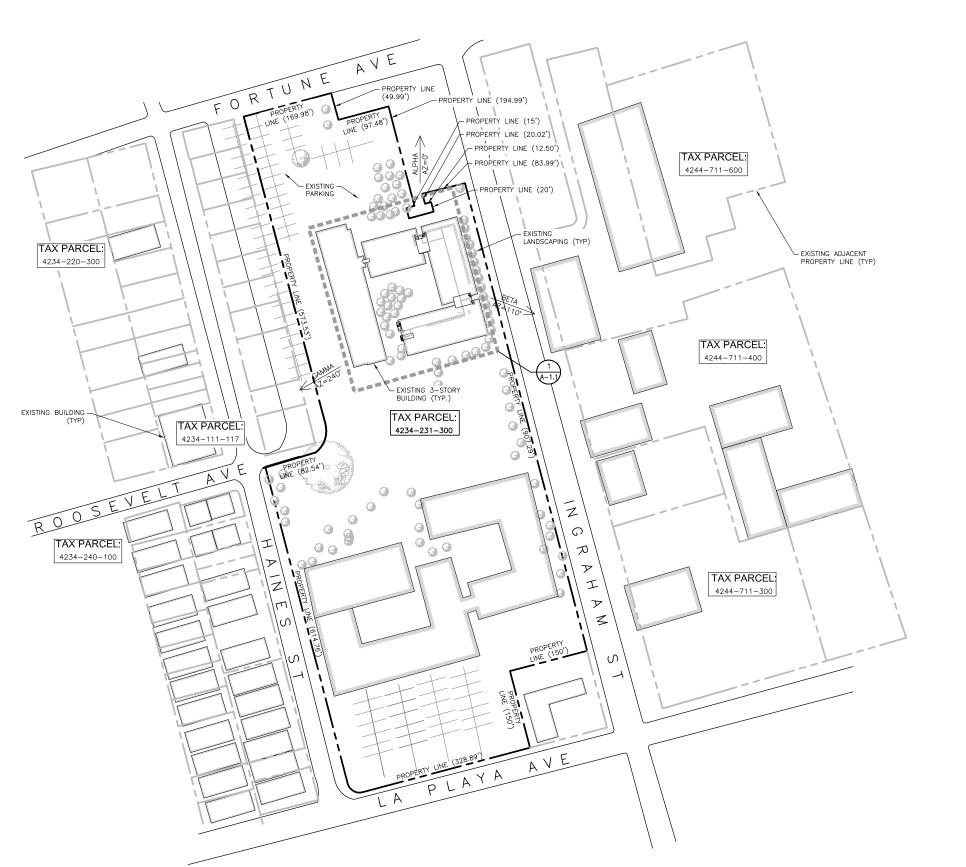



Know what's below. Call before you dig.

SITE PLAN

T Mobile



10590 WEST OCEAN AIR DRIVE SUITE 300 SAN DIEGO, CA 92130

PLANS PREPARED BY:



MORRISON HERSHFIELD

600 STEWART STREET, SUITE 200 SEATTLE, WA 98101 Tel: 206.268.7370 www.morrisonhershfield.com MH PROJECT NUMBER: 203531900

REV.	DATE	ISSUED FOR	BY
A	10/09/20	90% REVIEW	GD
0	12/23/20	100% CONSTRUCTION	MLG
1	05/27/21	JX COMMENTS	JR

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05/27/2021 1:54PM

BAY POINTE APARTMENT

T-MOBILE SITE I.D.

SD06471A

SITE ADDRESS:


3910 INGRAHAM ST SAN DIEGO, CA 92109

SHEET NAME:

SITE PLAN

SHEET NUMBER:

A-1

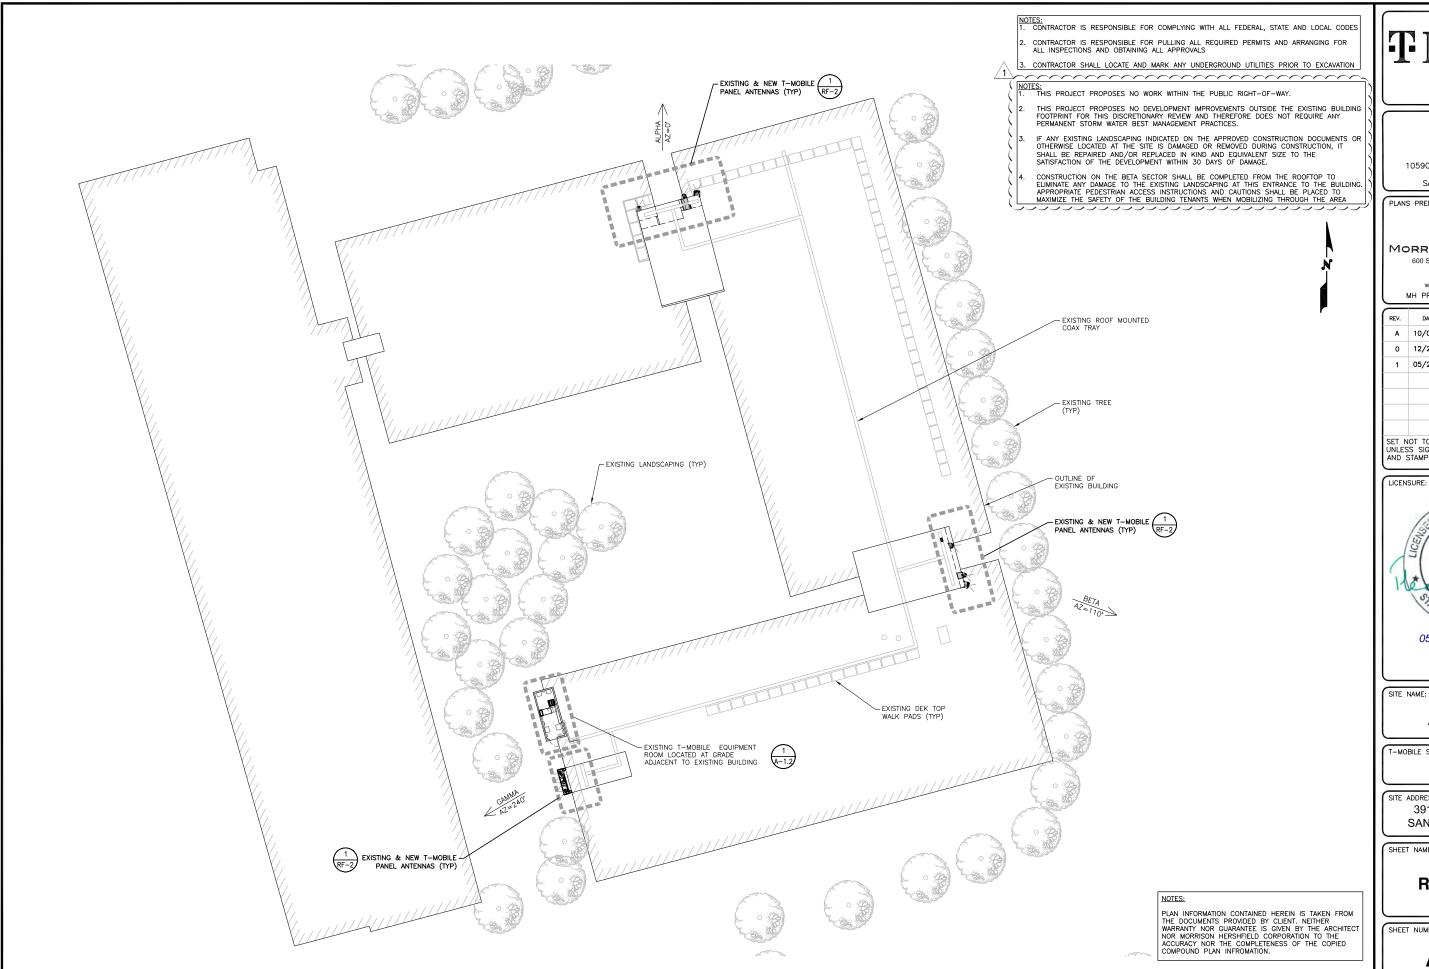

24"x36" SCALE: 1/16" = 1'-0" 11"x17" SCALE: 1/32" = 1'-0" 16' 12' 8' 4' 0"

T Mobile



10590 WEST OCEAN AIR DRIVE SUITE 300 SAN DIEGO, CA 92130

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BAY POINTE APARTMENT

T-MOBILE SITE I.D.

SD06471A

SITE ADDRESS:

3910 INGRAHAM ST SAN DIEGO, CA 92109

SHEET NAME:

ROOF PLAN

SHEET NUMBER:

ROOF PLAN

A-1.1



- INSTALL (1) BB6630 FOR L2500 AND (1) BB6648 FOR N2500 ON EXISTING 19" FIBER RACK (ERICSSON) INSTALL (1) PBC 6200 CABINET INSTALL (1) IXRE ROUTER INSTALL (8) PSU'S VOLTAGE BOOSTER







10590 WEST OCEAN AIR DRIVE SUITE 300 SAN DIEGO, CA 92130

PLANS PREPARED BY:



MORRISON HERSHFIELD 600 STEWART STREET, SUITE 200

SEATTLE, WA 98101 Tel: 206.268.7370 www.morrisonhershfield.com MH PROJECT NUMBER: 203531900

	REV.	DATE	ISSUED FOR	BY
П	Α	10/09/20	90% REVIEW	GD
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T-MOBILE SITE I.D.

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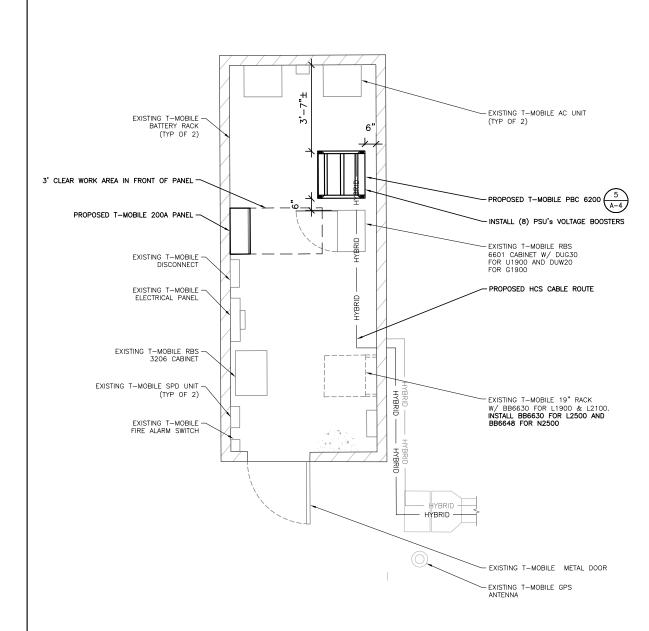
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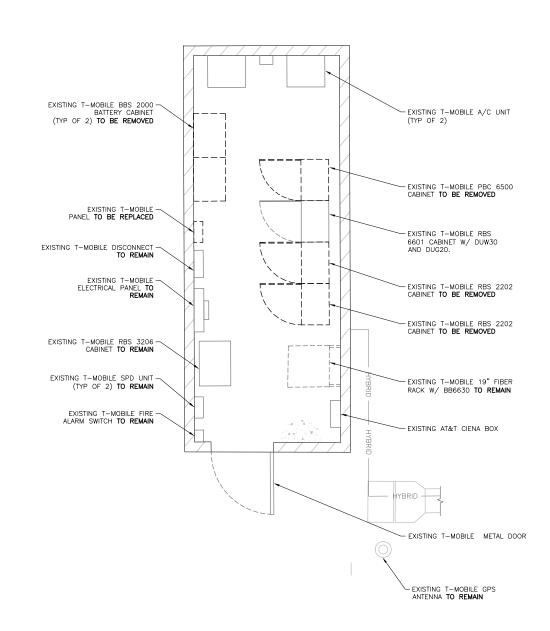
SHEET NAME:

EQUIPMENT PLAN

SHEET NUMBER:

A-1.2





24"x36" SCALE: 3/8" = 1'-0" 11"x17" SCALE: 3/16" = 1'-0" 2' 1' 0"

EXISTING EQUIPMENT PLAN 2 24"x36" SCALE: 3/8" = 1'-0" 11"x17" SCALE: 3/16" = 1'-0" 2' 1' 0"

PROPOSED EQUIPMENT PLAN

	EXISTING ANTENNA AND COAX SCHEDULECHOR VERSION 6, DATED 12/14/2020 1:53:27 PM								
AZIMUTH	RAD CENTER	NUMBER OF ANTENNAS	VENDOR	MODEL	ELEC TILT	MECH DOWNTILT	FEEDER NUMBER & TYPE	FEEDER LENGTH	ADDITIONAL EQUIPMENT
0.	35'-5"	1	ERICSSON	AIR21 KRC118023-1_B2A_B4P (QUAD)	7* 0*	0*	(2) 1-5/8" COAX (2) 1-5/8" LMU COAX (2) FIBER JUMPER (1) ERICSSON 3x6 HCS	375' 375' 16' 120M	(1) GENERIC TWIN STYLE 1B TMA (2) TRX RADIOS
0,	35'-5"	1	ERICSSON	AIR21 KRC 118023-1_B2P_B4A (QUAD)	7*	0,	(1) FIBER JUMPER	16'	
AZIMUTH	RAD CENTER	NUMBER OF ANTENNAS	VENDOR	MODEL	ELEC TILT	MECH DOWNTILT	FEEDER NUMBER & TYPE	FEEDER LENGTH	ADDITIONAL EQUIPMENT
110°	32'-10"	1	ERICSSON	AIR21 KRC118023-1_B2A_B4P (QUAD)	0° 2°	0•	(2) 1-5/8" COAX (2) 1-5/8" LMU COAX (2) FIBER JUMPER (1) ERICSSON 3x6 HCS	217' 217' 16' 70M	(1) GENERIC TWIN STYLE 1B TMA (4) TRX RADIOS

ELEC TILT

MECH DOWNTILT


AIR21 KRC 118023-1_B2P_B4A (QUAD)

MODEL

AIR21 KRC118023-1_B2A_B4P (QUAD)

AIR21 KRC 118023-1_B2P_B4A (QUAD)



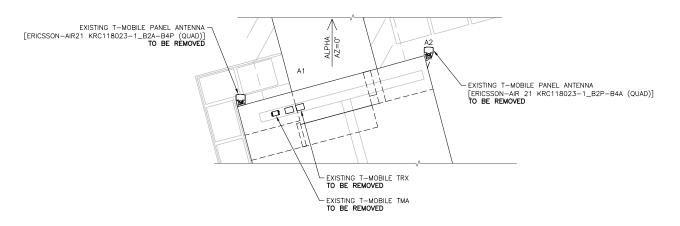

16'

FEEDER LENGTH

93' 93' 16' 30M

FEEDER NUMBER & TYPE


(2) 7/8" COAX (2) 7/8" LMU COAX (2) FIBER JUMPER (1) ERICSSON 3x6 HCS


(1) FIBER JUMPER

ADDITIONAL EQUIPMENT

(1) GENERIC TWIN STYLE 1B TMA

(2) TRX RADIOS

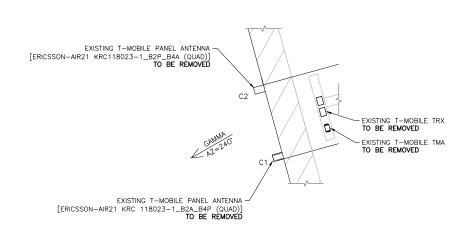

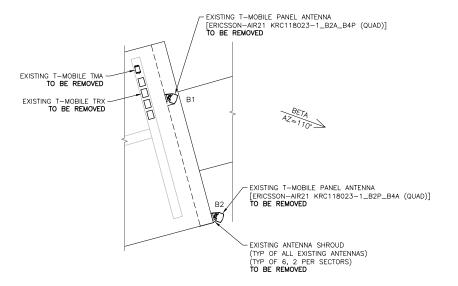

10590 WEST OCEAN AIR DRIVE SUITE 300 SAN DIEGO, CA 92130

PLANS PREPARED BY:



MORRISON HERSHFIELD 600 STEWART STREET, SUITE 200 SEATTLE, WA 98101 Tel: 206.268.7370 www.morrisonhershfield.com

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0	12/23/20	100% CONSTRUCTION	MLG
1	05/27/21	JX COMMENTS	JR
	A	A 10/09/20 0 12/23/20	A 10/09/20 90% REVIEW

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05/27/2021 1:54PM

BAY POINTE APARTMENT

T-MOBILE SITE I.D.

SD06471A

SITE ADDRESS:

3910 INGRAHAM ST SAN DIEGO, CA 92109

SHEET NAME:

EXISTING CONFIGURATION

SHEET NUMBER:

RF-1

24"x36" SCALE: 3/16" = 1'-0" 11"x17" SCALE: 3/32" = 1'-0" 4' 2' 0"

SECTOR ALPHA

A2

В1

B2

SECTOR GAMMA

C1

C2

TECH

U1900 G1900 U2100

L2100 TECH

U1900 G1900 U2100

L2100

TECH

U1900 G1900

U2100

L2100

110°

AZIMUTH

240°

240°

32'-10"

RAD CENTER

33'-8"

33'-8"

NUMBER OF ANTENNAS

ERICSSON

VENDOR


FRICSSON


ERICSSON

NOTES:

1. ALL PROPOSED EQUIPMENT IS LOW VOLTAGE, DC 1. ALL PROPOSED EQUIPMENT IS LOW VOLTAGE, DC POWER
POWER
2. COORDINATE WITH CONSTRUCTION MANAGER FOR CURRENT RFDS PRIOR TO CONSTRUCTION
3. CABLE LENGTH IS APPROXIMATE. CONTRACTOR TO FIELD VERIFY CABLE LENGTHS PRIOR TO ORDERING, FABRICATION, OR INSTALLATION OF CABLES.
4. NO WORK SHALL COMMENCE WITHOUT THE APPROVED TOWER/ANTENNA MOUNT STRUCTURAL ANALYSIS REPORT (SIGNED AND SEALED) PROVIDED BY OTHERS UNDER SEPARATE COVER. CONTRACTOR PRIOR TO INSTALLATION OF ANTENNAS, EQUIPMENT AND COAX CABLES SHALL REVIEW THE APPROVED TOWER STRUCTURAL ANALYSIS PROVIDED BY T-MOBILE AND MODIFY, IF REQUIRED, ALL APPLICABLE MEMBERS AS 4415 B25 RRU FEEDER ADDITIONAL LENGTH EQUIPMENT REQUIRED, ALL APPLICABLE MEMBERS AS INDICATED IN THE CERTIFIED STRUCTURAL 4415 B25 RRU (4) FIBER JUMPER AIR6449 B41 (ACTIVE 16' 30M (1) ÉRICSSON 3x6 HCS ANTENNA-MASSIVE MIMO) (1) PSU 4813 14'-0' - PROPOSED T-MOBILE PANEL ANTENNA [ERICSSON-AIR6449 B41 (ACTIVE ANTENNA MASSIVE MIMO)] ON NEW WALL MOUNT 3'-0" PROPOSED T-MOBILE PANEL ANTENNA [ERICSSON-AIR32 KRD901146-1_B66A_B2A (OCTO)] ON NEW WALL MOUNT

- PROPOSED T-MOBILE 4415 B25 RRU $\frac{1}{A-3}$ - PROPOSED WING WALL PROPOSED T-MOBILE PANEL ANTENNA [ANDREW-HBXX-6516DS-A2M (QUAD)]
MOUNTED TO NEW WALL MOUNT ON NEW WING WALL

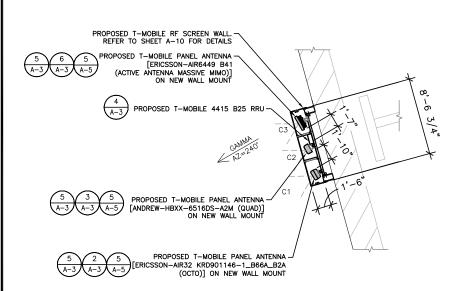

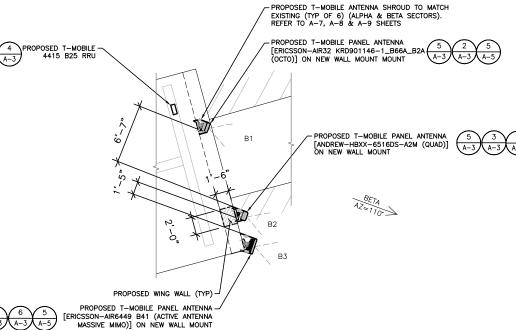



10590 WEST OCEAN AIR DRIVE SUITE 300 SAN DIEGO, CA 92130

PLANS PREPARED BY




MORRISON HERSHFIELD 600 STEWART STREET, SUITE 200 SEATTLE, WA 98101

Tel: 206.268.7370 www.morrisonhershfield.com MH PROJECT NUMBER: 203531900

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BAY POINTE APARTMENT

T-MOBILE SITE I.D.

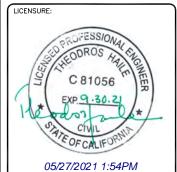SD06471A

SITE ADDRESS:

3910 INGRAHAM ST SAN DIEGO, CA 92109

SHEET NAME:

PROPOSED CONFIGURATION

SHEET NUMBER:

RF-2

L2500 N2500

240°


NOTE: PAINT ANTENNAS & SKIRTS TO MATCH BUILDING

33'-8'

FRICSSON

C3

Section 3 - Proposed Template Images

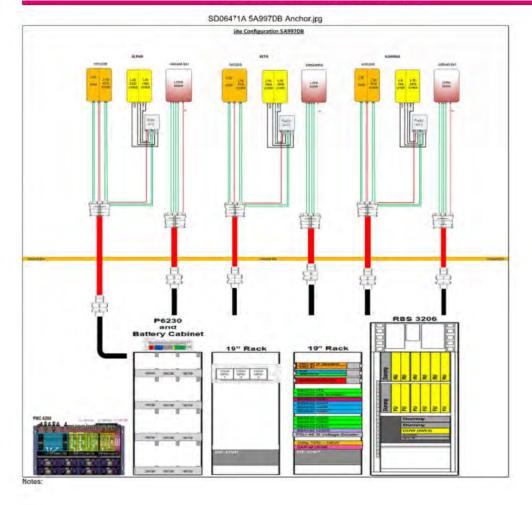

10590 WEST OCEAN AIR DRIVE SUITE 300 SAN DIEGO, CA 92130

PLANS PREPARED BY:




MORRISON HERSHFIELD 600 STEWART STREET, SUITE 200 SEATTLE, WA 98101 Tel: 206.268.7370 www.morrisonhershfield.com

MH PROJECT NUMBER: 203531900

REV.	DATE	ISSUED FOR	BY
A	10/09/20	90% REVIEW	GD
0	12/23/20	100% CONSTRUCTION	MLG
1	05/27/21	JX COMMENTS	JR

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BAY POINTE APARTMENT

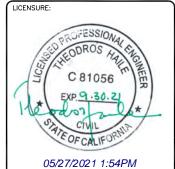T-MOBILE SITE I.D.

SD06471A

SITE ADDRESS:

3910 INGRAHAM ST SAN DIEGO, CA 92109


SHEET NAME:

PLUMBING DIAGRAM

RF-3

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PLUMBING DIAGRAM

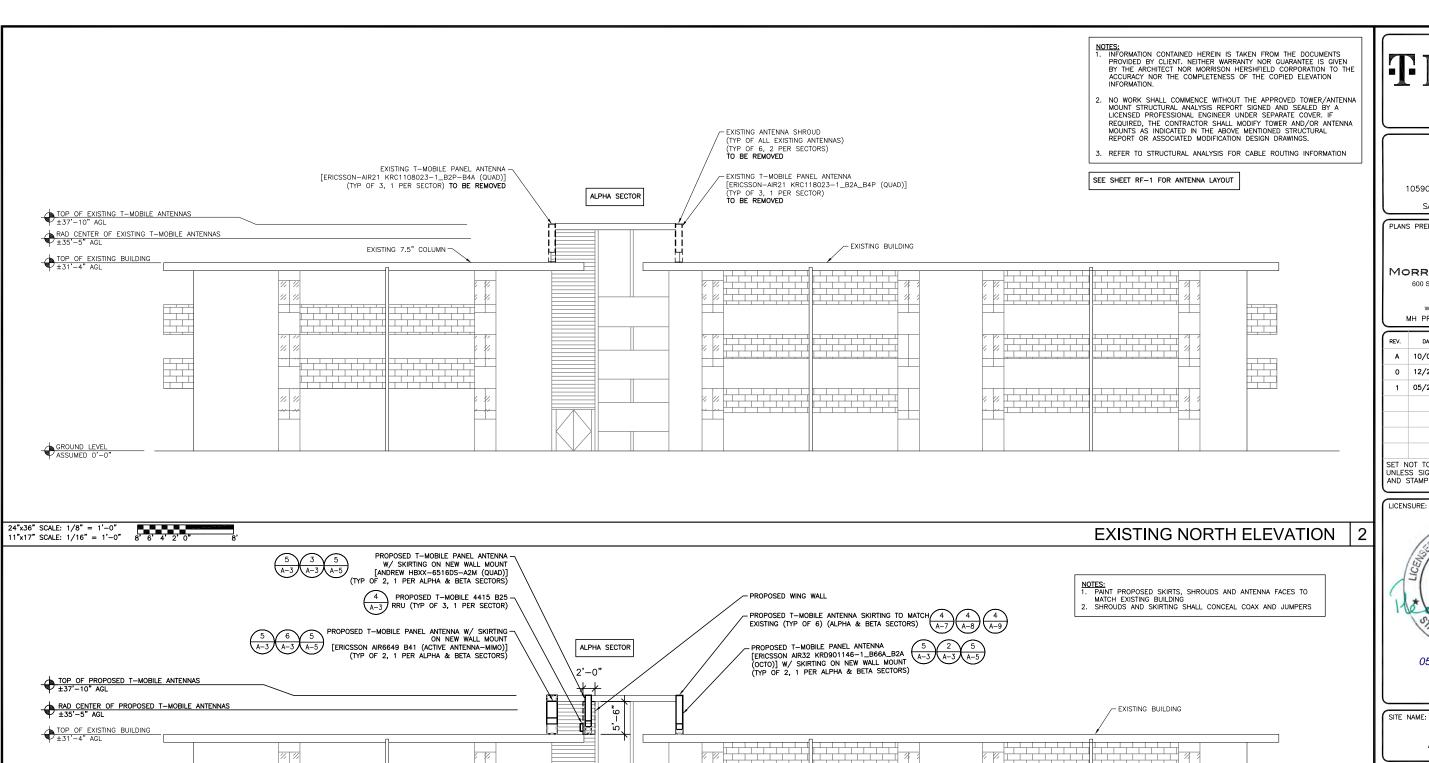

24"x36" SCALE: 1/8" = 1'-0" 11"x17" SCALE: 1/16" = 1'-0" 8' 6' 4' 2' 0"

T Mobile^{*}



10590 WEST OCEAN AIR DRIVE SUITE 300 SAN DIEGO, CA 92130

PLANS PREPARED BY:



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	A 0	A 10/09/20 0 12/23/20	A 10/09/20 90% REVIEW 0 12/23/20 100% CONSTRUCTION

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SITE ADDRESS:

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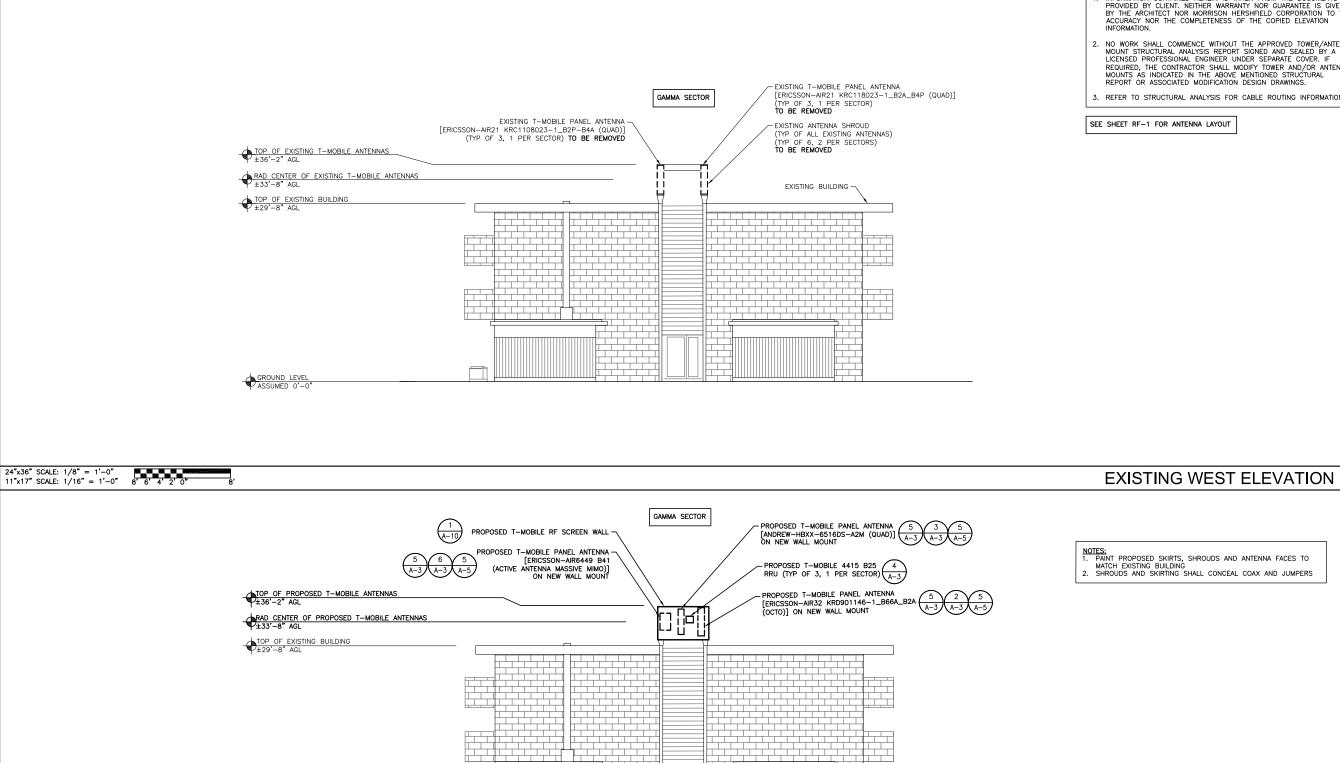
SHEET NAME:

NORTH **ELEVATION**

SHEET NUMBER:

A-2

PROPOSED NORTH ELEVATION



24"x36" SCALE: 1/8" = 1'-0" 11"x17" SCALE: 1/16" = 1'-0" 8' 6' 4' 2' 0"

- NOTES:

 1. INFORMATION CONTAINED HEREIN IS TAKEN FROM THE DOCUMENTS PROVIDED BY CLIENT. NEITHER WARRANTY NOR GUARANTEE IS GIVEN BY THE ARCHITECT NOR MORRISON HERSHFIELD CORPORATION TO THE ACCURACY NOR THE COMPLETENESS OF THE COPIED ELEVATION NEGODALATION.
- NO WORK SHALL COMMENCE WITHOUT THE APPROVED TOWER/ANTENNA MOUNT STRUCTURAL ANALYSIS REPORT SIGNED AND SEALED BY A LICENSED PROFESSIONAL ENGINEER UNDER SEPARATE COVER. IF REQUIRED, THE CONTRACTOR SHALL MODIFY TOWER AND/OR ANTENNA MOUNTS AS INDICATED IN THE ABOVE MENTIONED STRUCTURAL REPORT OR ASSOCIATED MODIFICATION DESIGN DRAWINGS.
- 3. REFER TO STRUCTURAL ANALYSIS FOR CABLE ROUTING INFORMATION

SEE SHEET RF-1 FOR ANTENNA LAYOUT



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SITE ADDRESS:

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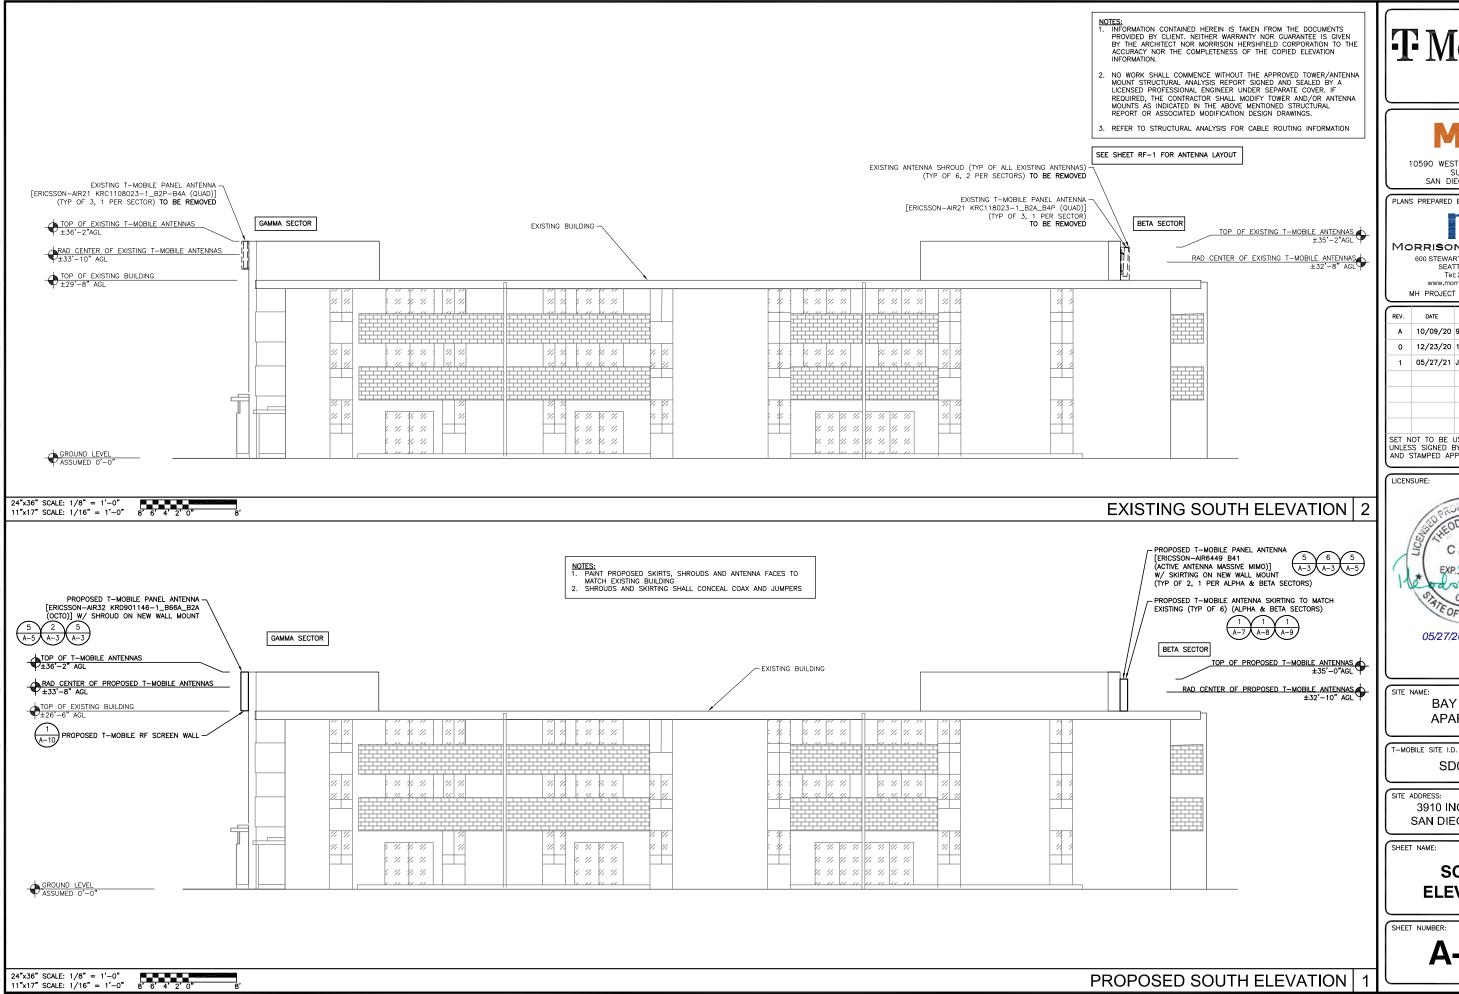
SHEET NAME:

WEST ELEVATION

SHEET NUMBER:

A-2.1

- EXISTING BUILDING



T Mobile



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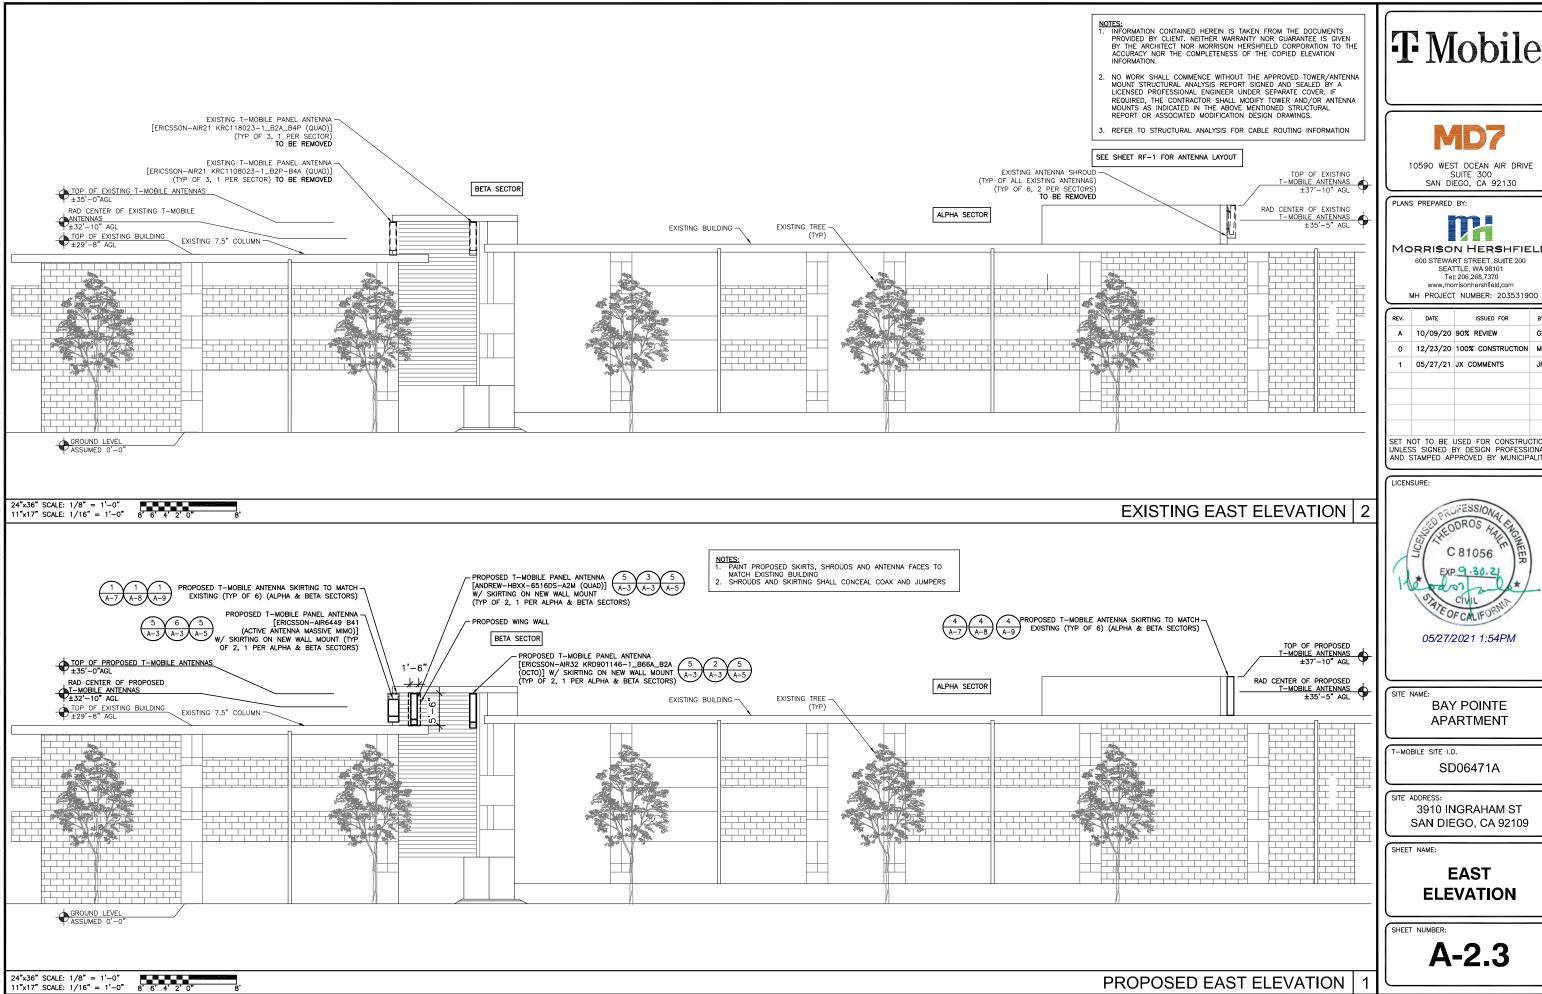
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> SOUTH **ELEVATION**

A-2.2



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			_
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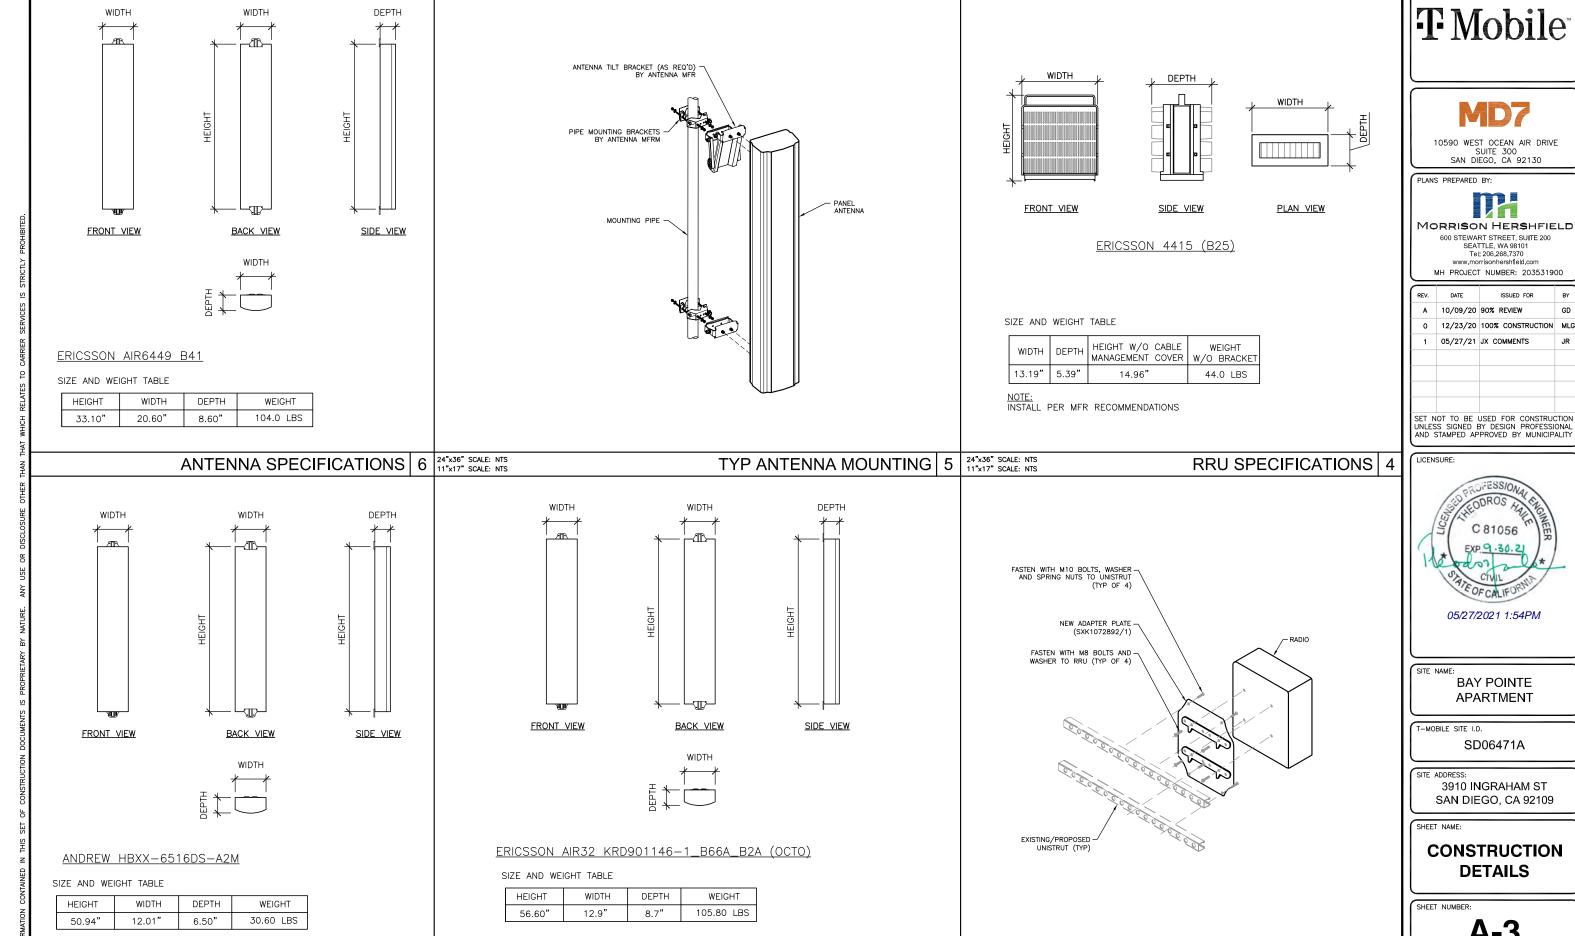
BAY POINTE APARTMENT

SD06471A

3910 INGRAHAM ST SAN DIEGO, CA 92109

> **EAST ELEVATION**

A-2.3



ANTENNA SPECIFICATIONS

3

ANTENNA SPECIFICATIONS 2 24"x36" SCALE: NTS 11"x17" SCALE: NTS

T Mobile^{*}



10590 WEST OCEAN AIR DRIVE SUITE 300 SAN DIEGO, CA 92130




600 STEWART STREET, SUITE 200 SEATTLE, WA 98101

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REV.	DATE	ISSUED FOR	BY
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0	12/23/20	100% CONSTRUCTION	MLG
1	05/27/21	JX COMMENTS	JR
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BAY POINTE APARTMENT


SD06471A


TYPICAL RADIO MOUNTING

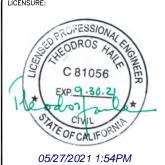3910 INGRAHAM ST SAN DIEGO, CA 92109

CONSTRUCTION **DETAILS**

A-3

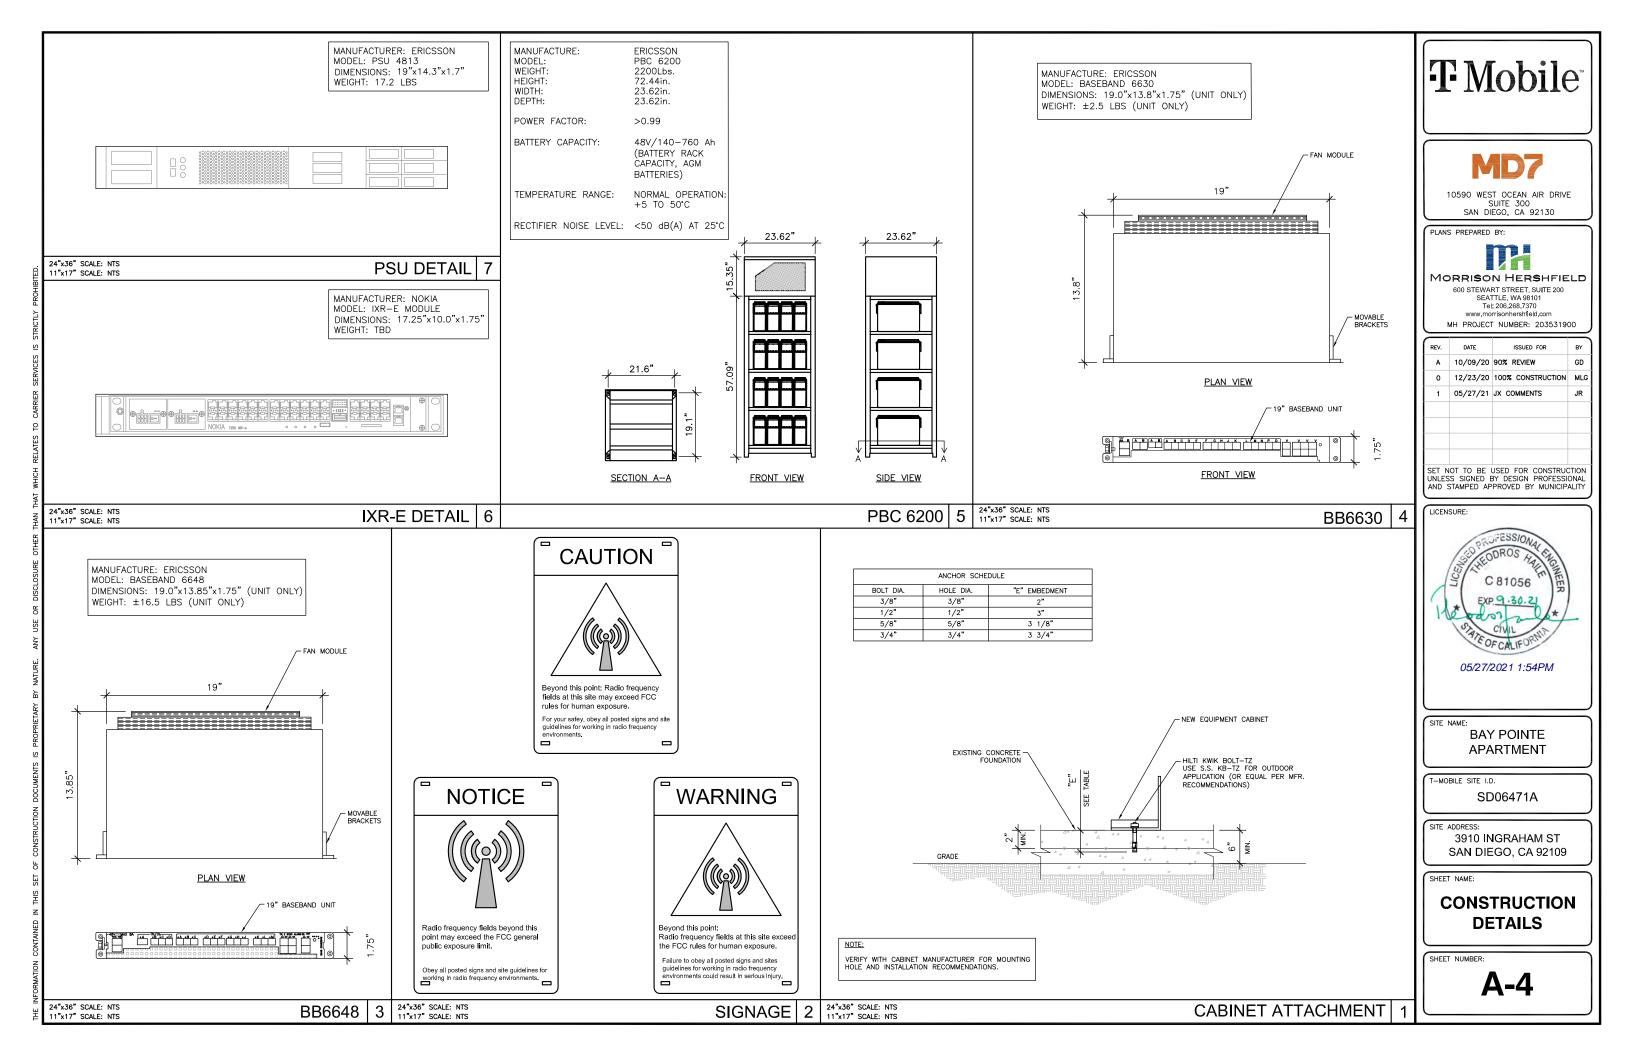

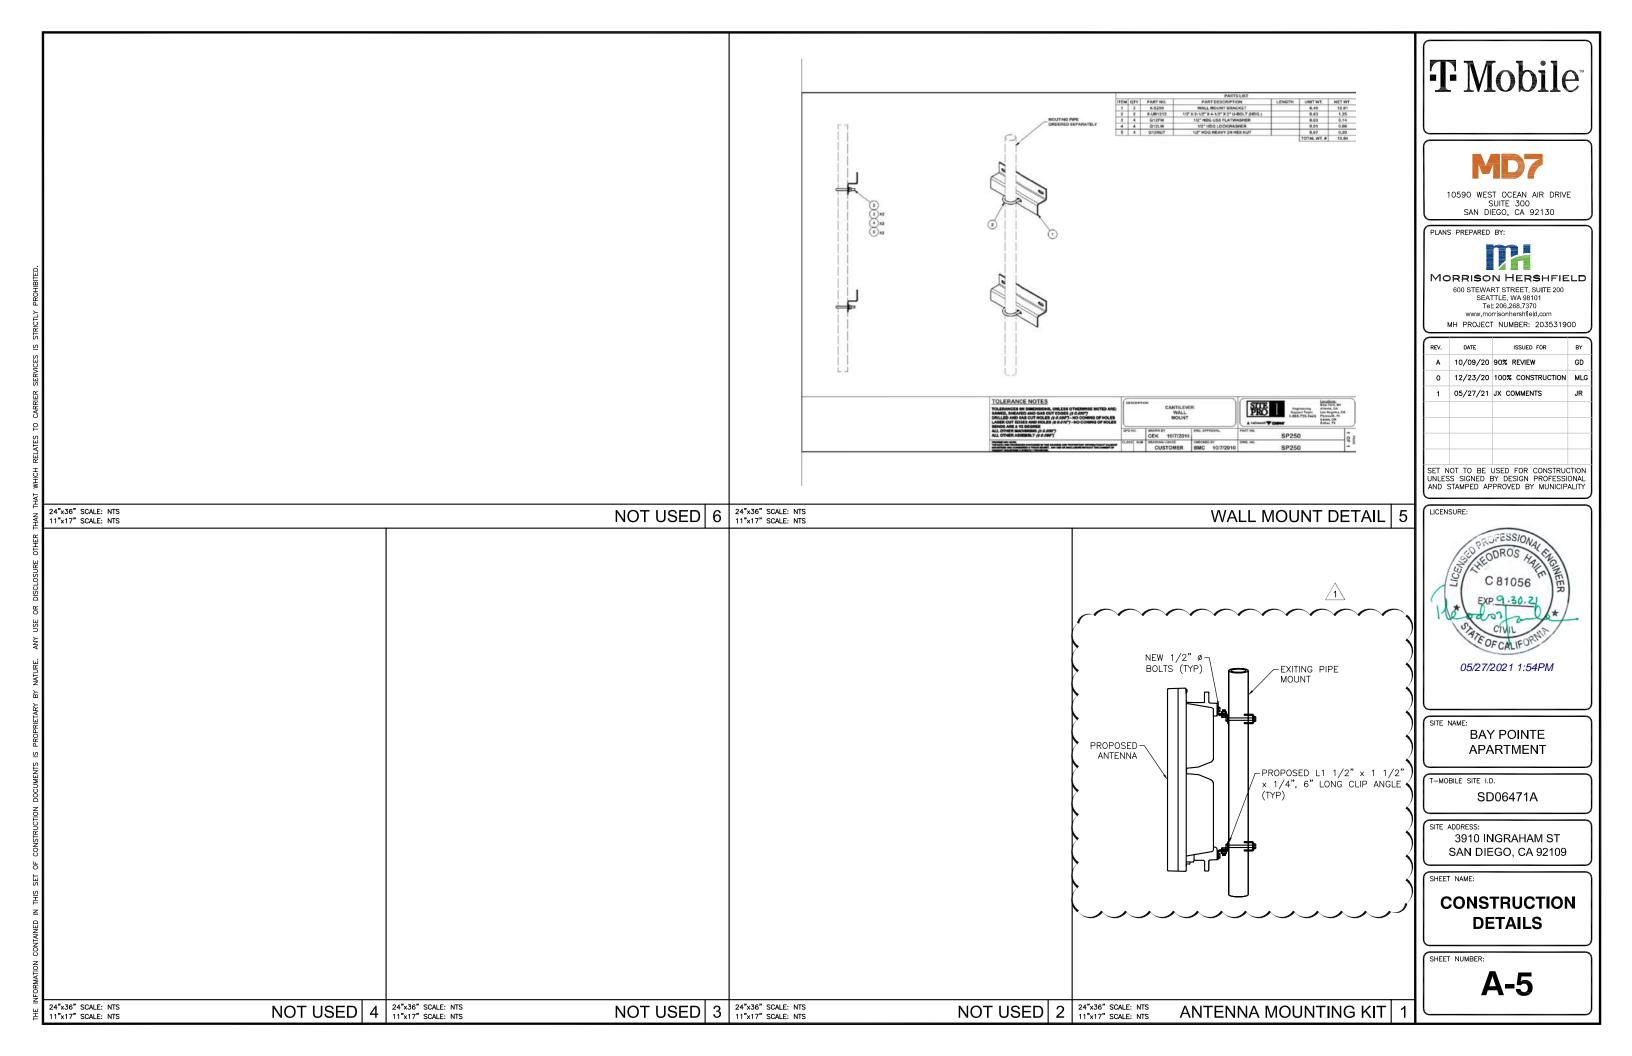

Product Datasheet



Group Datasheet HB114-U6S12-xxx-LI Series

HYBRIFLEX™ RRH Hybrid Cable Solution 6x12, 6AWG

Product Description

RFS' HYBRIFLEX Remote Radio Head (RRH) hybrid feeder cabling solution combines optical fiber and DC power for RRHs in a single lightweight aluminum corrugated cable, making it the world's most innovative solution for RRH deployments.

This low-inductance version of HYBRILEV allows mobile operators deploying an RRH architecture to deploy >400ft sites without the danger of power-cycling their RRHs due to voltage swings, which could occur in some specific instances. It combines bend-insensitive single-mode fiber (12 pairs of DLC connectors), 6 pairs of low-induc-tance DC wires and 9 pairs of 18AWG wires used to carry alarm signals. The package also includes a special RF3-designed DC insulating book, used to properly protect and insulate the DC wires after stripping the jacket, avoiding possible short-circuits while wiring it to the distribution boxes. Standard RFS CELLFLEX® accessories can be used with HYBRIFLEX cable.


Outer Conductor Armor:	Corrugated Aluminum	imm önäl	36.0 (1.42)				
lacket:	Flame Ratardant	Irono (inti)	39.0 (1.54)				
UV-Protection:	Individual and External 3	lacket	Yes				
Mechanical Properties							
Weight, Approximate		[kg/m (lb/ft)]	2.52 (1.70)				
Minimum Bending Radius Single Bending	,	[mm (in)]	152 (6)				
Minimum Bending Radius Repeated Banding		[mm (in)]	254 (10)				
Recommended/Maximum	Clamp Specing	[m (ft)]	1.0 / 1.2 (3.25 / 4.0)				
Electrical Properties							
DC-Resistance Outer Con-		[Ω/km (Ω/1000°t)]	0.9 (0.27)				
DC-Resistance Power Cab		[Q/km (Q/1000°t)]	1.4 (0.42)				
Inductance @100-1000Hz		[µH/m (µH/ft)]	< 0.19 (0.06)				
Fiber Optic Properties							
Version			Single-made				
Quantity, Fiber Count			24 (12 pairs)				
Core/Clad			9/125				
Primary Coating (Acrylate)		[µm]	245				
Secondary Coating Diame		[µm]	900				
Minimum Bending Redius		[mm (in)]	137 (5.4)				
Optical Loss @ wavelength		d3/km	0.5				
Optical Loss @ wavelength		d3/km	0.5				
DC Power Cable Proper	ties						
Size (Power)		[mm² (AWG)]	13.3 (6)				
Quantity, Wire Count (Pov	ver)		12 (6 concentric wires)				
Size (Alarm)		[mm² (AWG)]	0.8 (*8)				
Quantity, Wire Count (Ala	rm)		18 (9 stranded pairs)				
Туре			PVC/Nylon				
Frimary Jacket Diameter, I	lominal	[mm (in)]	9.3 (0.365)				
Environment		the section of					
Installation Temperature		[*C (*F)]	-20 to +65 (-4 to +149)				
Operation Temperature		[°C (°F)]	-40 to +65 (-40 to +149)				
Storage Temperature		[°C (°F)]	-40 to +70 (-40 to +158)				
Standards (meets or exc	eeds)						
Jacket	UL2882 Type RHC, UL	Listed					
Fiber Optic	UL Listed Type OFNR (L	JL1666), RoHS Compl	iart				
Alarm Wires	III Strandard 1962 1591 159 1 5470 Ol and Carolina 9001						
Power Wires			n, RoHS/REACH Compliant				

HB114-U6512-xxx-LI series | Print Date: 12.6.2015 | Rev: P4 | Rev Date: 12.6.2015

- Patented DC Wire Insulator —
 Used at the DC wire connection in distribution boxes
- prevents potential short circuits
- Aluminum corrugated armor with outstanding bending characteristics Minimizes installation time and enables mechanical
- protection and shielding
- Same accessories as 1-1/4" coaxial cable
- Outer conductor grounding
 Eliminates typical grounding requirements and saves on installation costs
- Lightweight solution and compact design Decreases tower loading
- Robust cabling
 Eliminates need for expensive cable trays and ducts
- Optical fiber and power cables housed in single corrugated cable
 Saves CAPEX by standardizing RRH cable installation and reducing installation requirements
- Outdoor, flame-retardant jacket
 Ensures long-lasting cable protection

www.rfsworld.com

24"x36" SCALE: NTS 11"x17" SCALE: NTS HCS SPECIFICATION 6 24"x36" SCALE: NTS 11"x17" SCALE: NTS

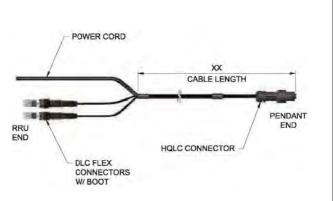

BAY POINTE

T-MOBILE SITE I.D.

SD06471A

APARTMENT

SITE ADDRESS:

3910 INGRAHAM ST SAN DIEGO, CA 92109

SHEET NAME:

CONSTRUCTION **DETAILS**

SHEET NUMBER:

A-6

RFS The Clear Choice®

24"x36" SCALE: NTS 11"x17" SCALE: NTS 24"x36" SCALE: NTS 11"x17" SCALE: NTS NOT USED 4 NOT USED 3 |

24"x36" SCALE: NTS

11"x17" SCALE: NTS

HCS 2.0 JUMPER CABLE 2

NOT USED

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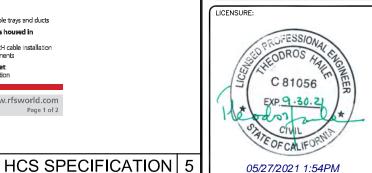


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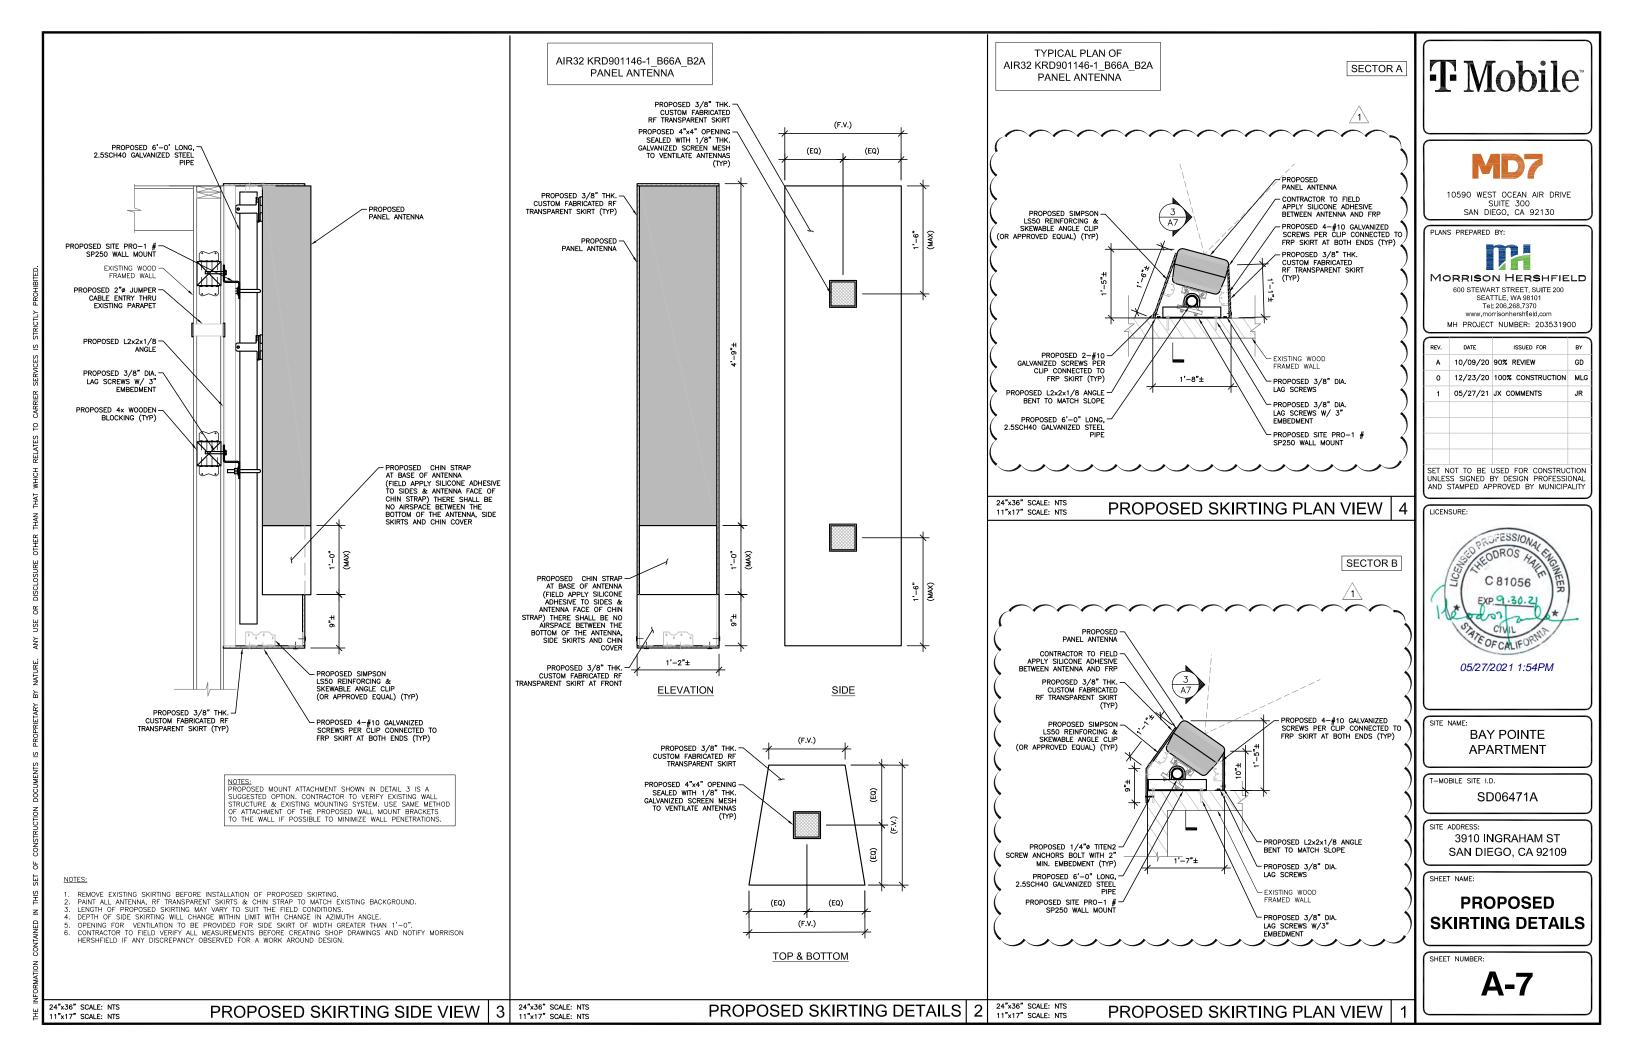
MH PROJECT NUMBER: 203531900


ĺ	REV.	DATE	ISSUED FOR	BY
	Α	10/09/20	90% REVIEW	GD
	0	12/23/20	100% CONSTRUCTION	MLG
	1	05/27/21	JX COMMENTS	JR


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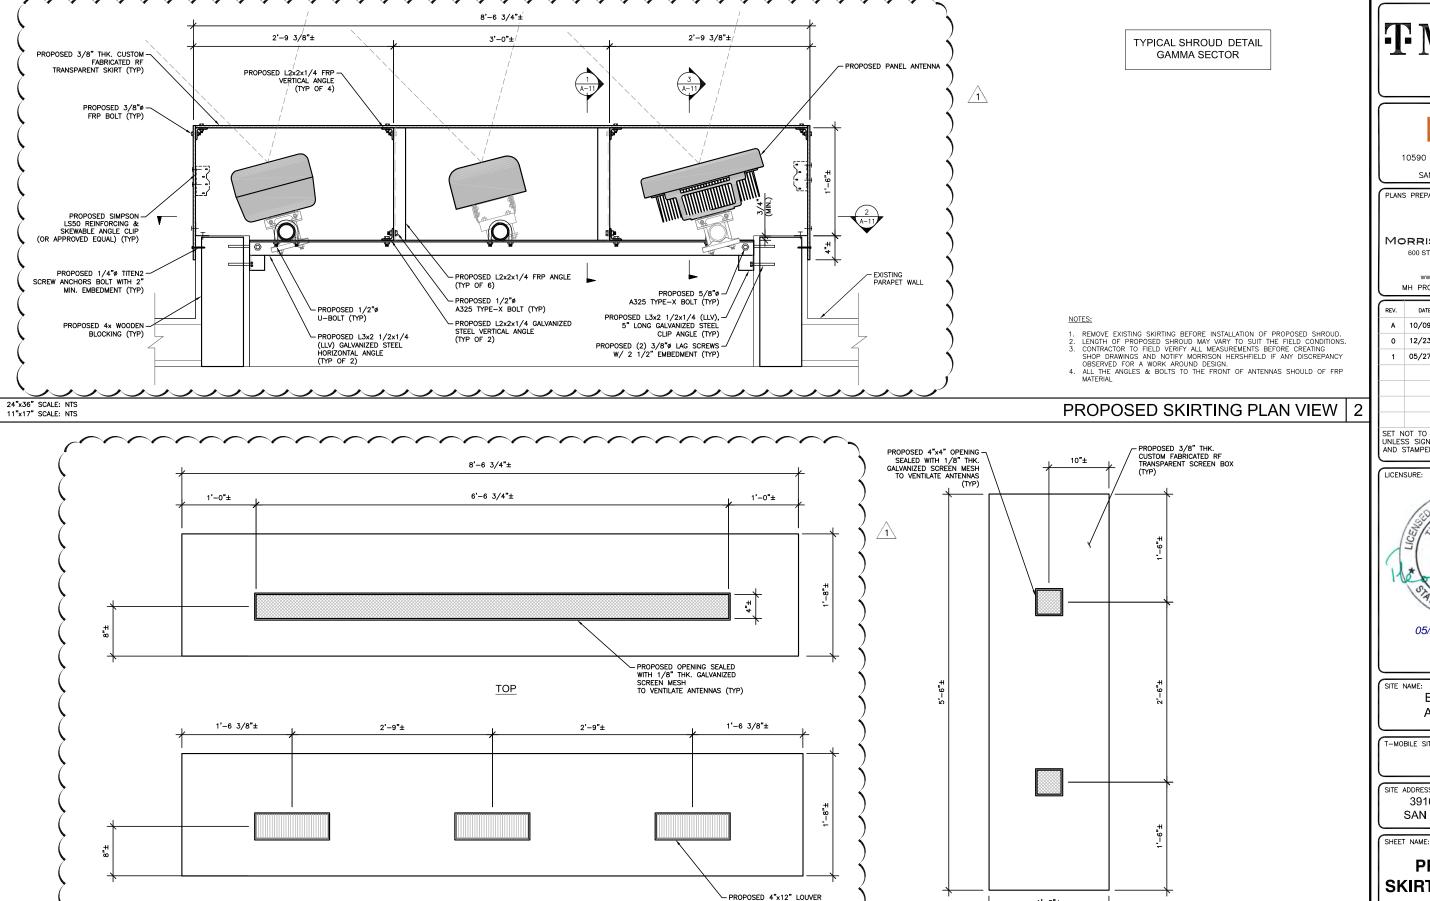


05/27/2021 1:54PM





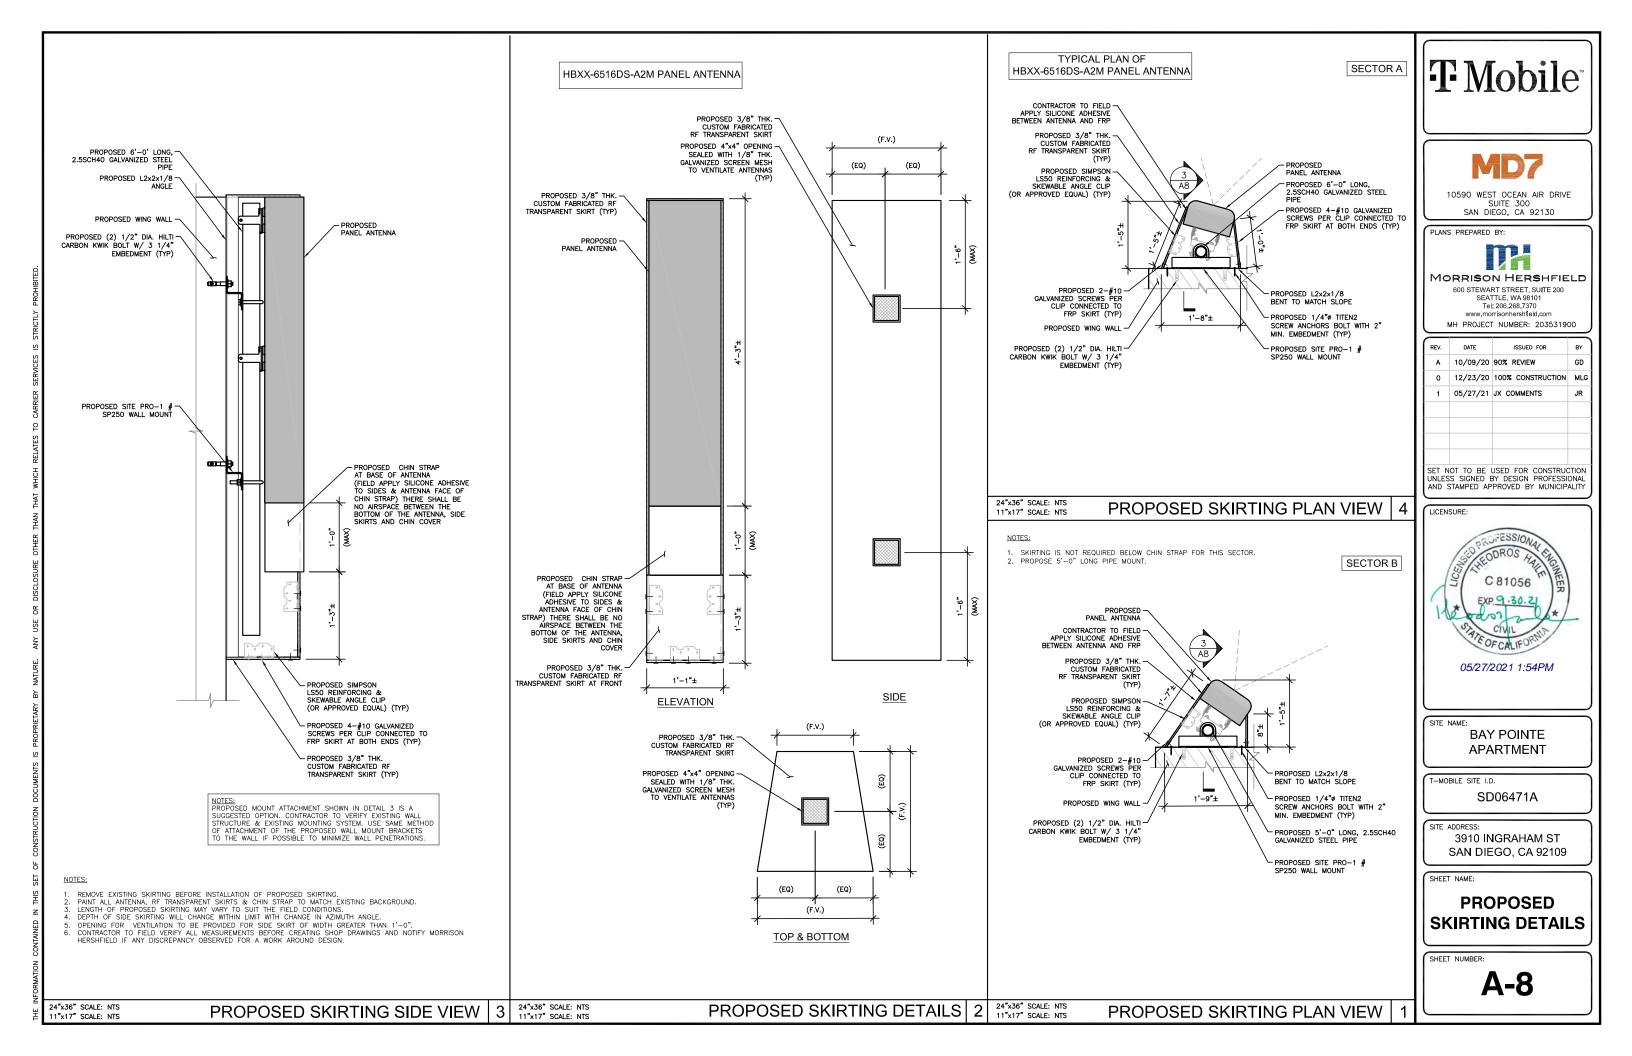

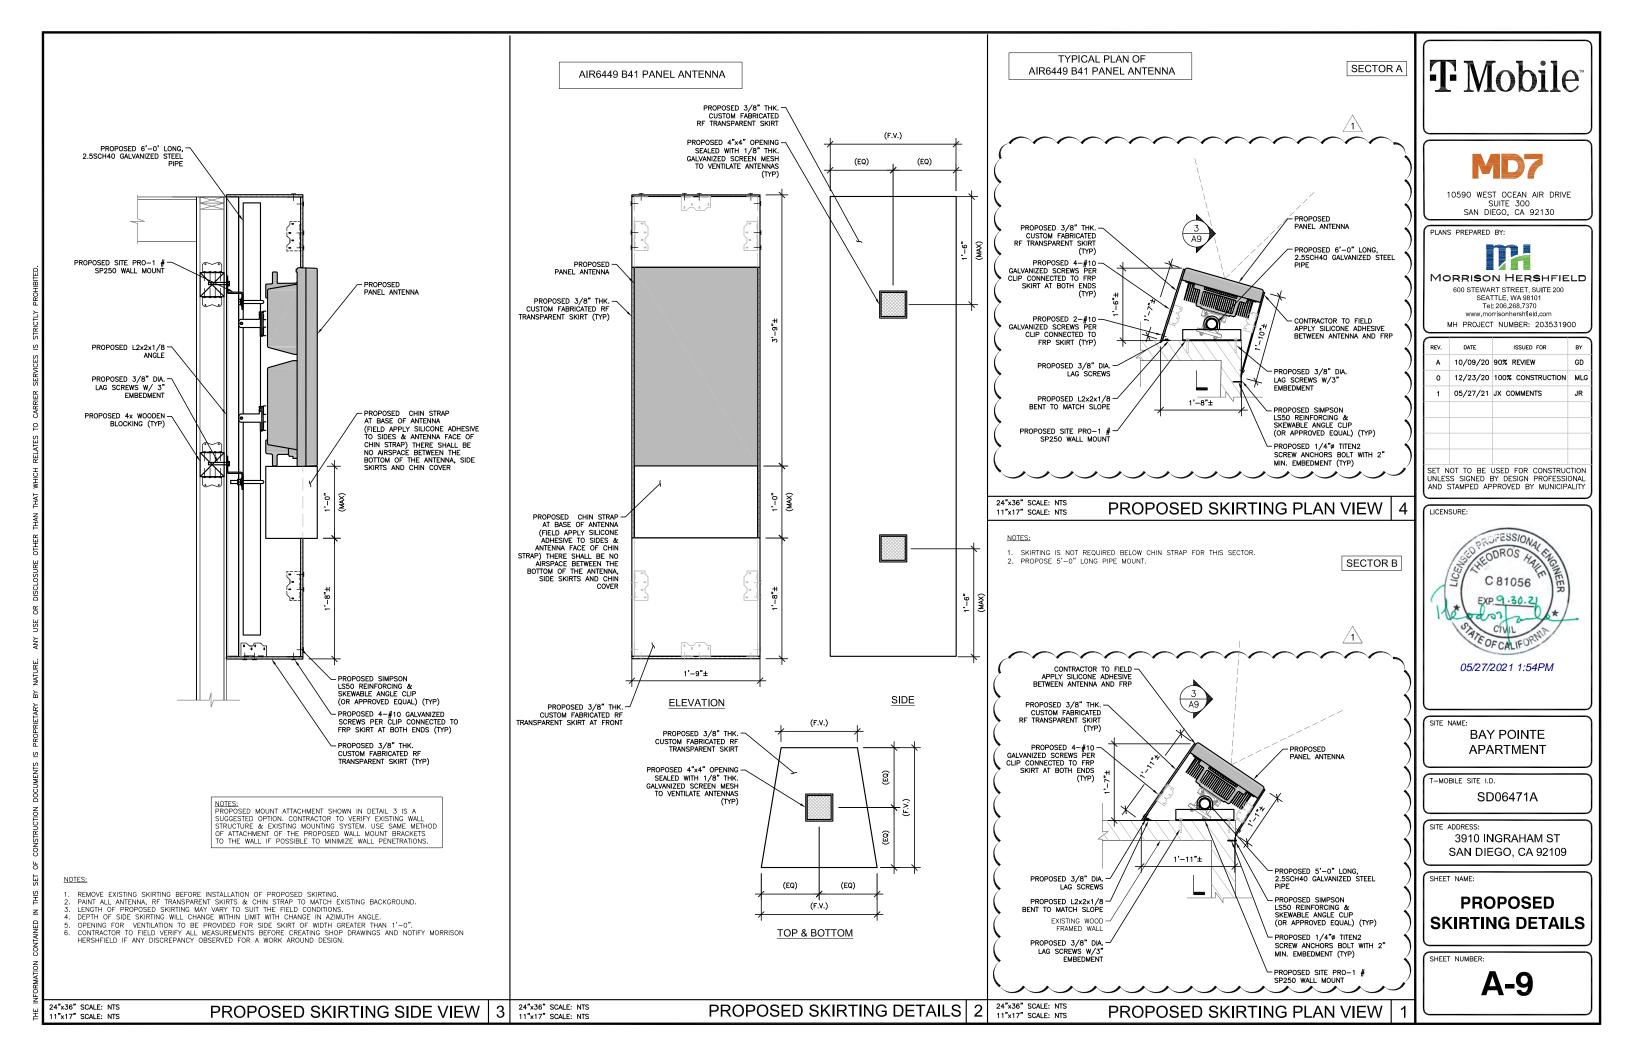

воттом

24"x36" SCALE: NTS

11"x17" SCALE: NTS



10590 WEST OCEAN AIR DRIVE SUITE 300 SAN DIEGO, CA 92130

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BAY POINTE APARTMENT

T-MOBILE SITE I.D.

SD06471A

SITE ADDRESS:

3910 INGRAHAM ST SAN DIEGO, CA 92109

PROPOSED SKIRTING DETAILS


SHEET NUMBER:

1'-8"±

SIDE

PROPOSED SKIRTING DETAILS

A-10

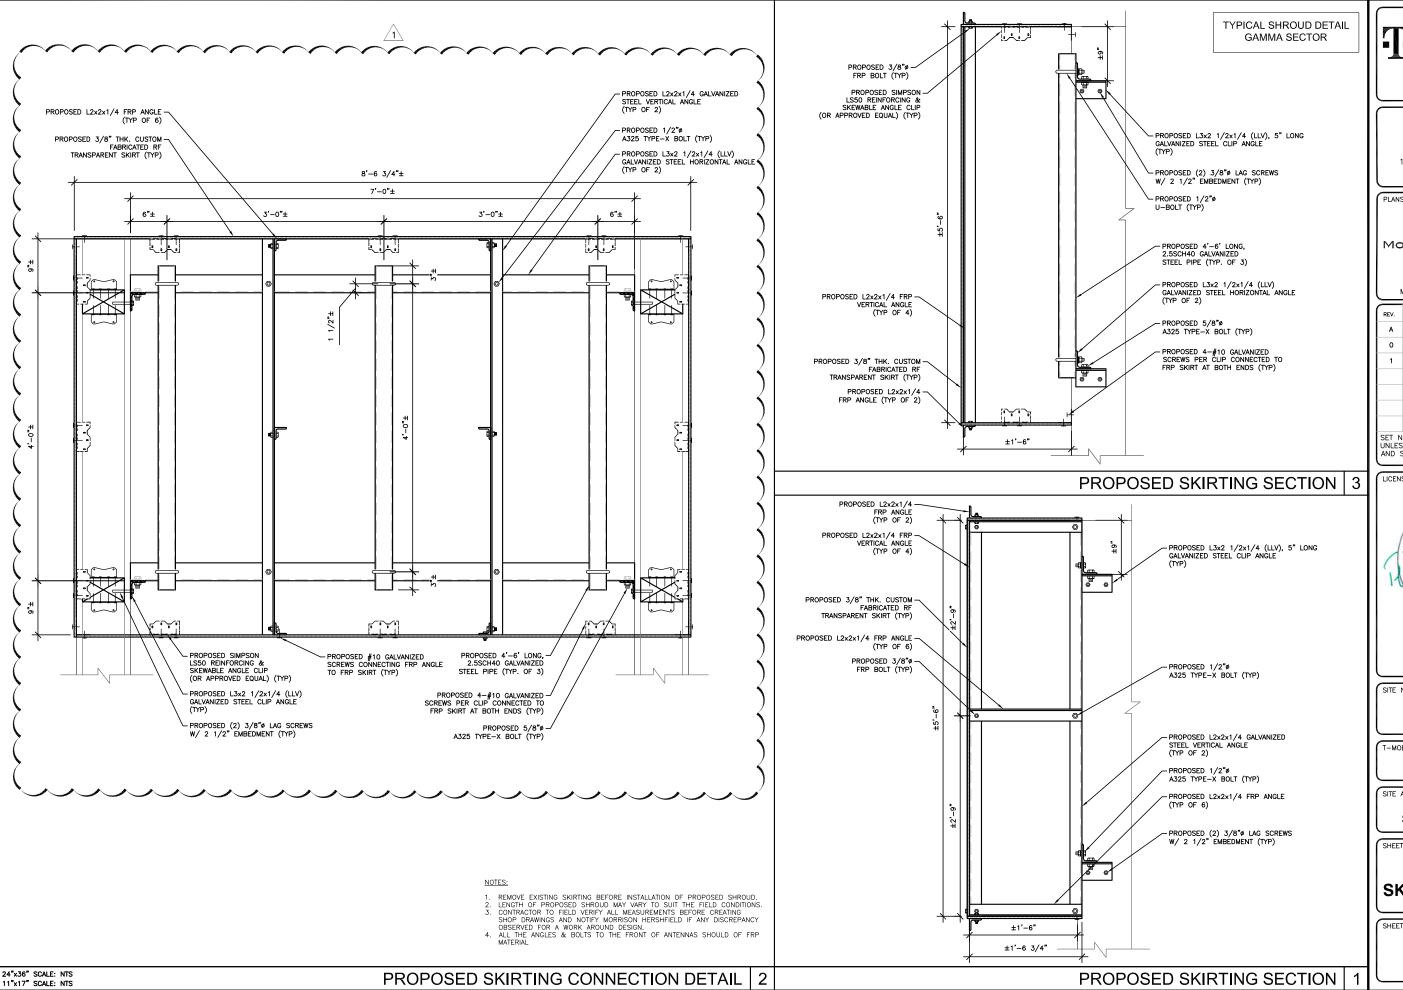

T Mobile



10590 WEST OCEAN AIR DRIVE SUITE 300 SAN DIEGO, CA 92130

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T-MOBILE SITE I.D.

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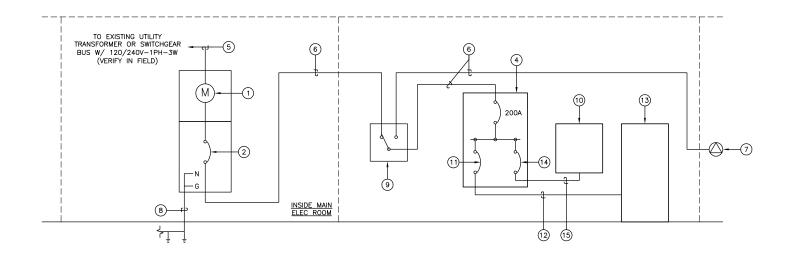
3910 INGRAHAM ST SAN DIEGO, CA 92109

SHEET NAME:

PROPOSED SKIRTING DETAILS

SHEET NUMBER:

A-11



REFERENCE NOTES:

- 1 EXISTING T-MOBILE METER TO REMAIN. VERIFY IN FIELD.
- 2 EXISTING T-MOBILE 200A-2P MAIN TO REMAIN. VERIFY IN FIELD.
- 3 NEW 2" RMC CONDUIT W/ (3)#1/0 + (1)#6 GND THHN CU ELECTRICAL FEEDERS
- 4 EXISTING T-MOBILE 200A, 120/240C-10-3W, AC PANEL (PANEL "A") EQUIPPED W/ A 200A-2P MAIN CIRCUIT BREAKER TO REMAIN.
- (5) EXISTING MIN (3) #3/0 AWG COPPER IN 2" CONDUIT. VERIFY IN FIELD.
- $\begin{tabular}{lll} \hline \begin{tabular}{lll} \hline \end{tabular} \hline \end{tabular} \end{tabul$
- \bigcirc EXISTING T-MOBILE GENERATOR TAP BOX 200A, 120/240V, 1 PHASE, 3 WIRE TO REMAIN.
- (8) EXISTING MIN #4 AWG COPPER GROUND ELECTRODE CONDUCTOR BONDED TO MIN (2) 5/8"0x8"-0" LONG GROUND ELECTRODES SPACED A MIN OF 6'-0" APART & BONDED TO BUILDING GROUND SYSTEM. VERIFY EXISTING SERVICE EQUIPMENT IN FIELD.
- (9) CONTRACTOR TO REMOVE EXISTING 100A MANUAL TRANSFER SWITCH W/ A NEW 200A, 2-POLE, 240V, DOUBLE THROW MANUAL TRANSFER SWITCH. PROVIDE MECH ATTACHED ENGRAVED LAGEL INDICATING "T-MOBILE MTS"
- (10) EXISTING T-MOBILE 125A, 120/240V-1ø-3W, M.L.O. AC PANEL (SUB-PANEL "B")
- 11) NEW (8) 20A-2P BRANCH BREAKERS FOR A TOTAL OF (8) RECTIFIER
- (12) NEW (2) #12 AWG CU & #12 GROUND IN 3/4" RMC FOR EACH RECTIFIER CIRCUIT
- 13) NEW PBC6200 POWER RACK TO REPLACE EXISTING PBC6500 POWER RACK.
- (14) EXISTING 125A-2P BRANCH BREAKER FOR SUB-PANEL "B".
- (15) EXISTING (3) #1 AWG CU & (1) #6 AWG GROUND IN 2" CONDUIT.



10590 WEST OCEAN AIR DRIVE SUITE 300 SAN DIEGO, CA 92130

PLANS PREPARED BY:



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BAY POINTE APARTMENT

T-MOBILE SITE I.D.

SD06471A

SITE ADDRESS:

3910 INGRAHAM ST SAN DIEGO, CA 92109

SHEET NAME:

ELECTRICAL DETAILS

SHEET NUMBER:


E-1


24"x36" SCALE: NTS ONE-LINE DIAGRAM | 2

/OLTAGE	: 120/240V	PHASE:		1ø		٧	VIRE:	3									
	REAKER: 200A	BUSS R		200A			AIC:	65K	AIC								
MOUNT:		NEUTRAL		YES			ROUND B	AR: YES									
	URE TYPE: NEMA-1	N TO G		NO			PANEL SIZI										
	STATUS: NEW	INTERNA		YES				ME: PPC	'A'								
СКТ	LOAD DESCRIPTION		I	BREAKER STATUS	CONN LOAD	DEMAND FACTOR	DEMAND		I	DEMAND LOAD	DEMAND FACTOR	CONN LOAD	BREAKER STATUS	BREAKER POLES	BREAKER AMPS	LOAD DESCRIPTION	(
1	EXISTING LIGHTING	20	1	ON	420	1.25	525	525		0	1.00	0	ON	2	15	EXISTING AHU #2	
3	EXISTING RECEPTACLE	20	1	ON	540	1.00	540		540	0	1.00	0					
5	EXISTING RECEPTACLE	20	1	ON	540	1.00	540	1340		800	1.00	800	ON	2	15	EXISTING AHU #1	
7	EXISTING SMOKE DETECTOR	20	1	ON	180	1.00	180		980	800	1.00	800					
9	EXISTING EXT GFI RECEPT	20	1	ON	180	1.00	180	1680		1500	1.00	1500	ON	2	20	EXISTING CU #1	
11	NEW RECTIFIER	20	2	ON	1440	1.00	1440		2940	1500	1.00	1500					
13					1440	1.00	1440	1440		0	1.00	0	ON	2	20	EXISTING CU #2	
15	NEW RECTIFIER	20	2	ON	1440	1.00	1440		1440	0	1.00	0					
17					1440	1.00	1440	2880		1440	1.00	1440	ON	2	20	NEW RECTIFIER	
19	NEW RECTIFIER	20	2	ON	1440	1.00	1440		2880	1440	1.00	1440					
21					1440	1.00	1440	2880		1440	1.00	1440	ON	2	20	NEW RECTIFIER	
23	NEW RECTIFIER	20	2	ON	1440	1.00	1440		2880	1440	1.00	1440					
25					1440	1.00	1440	1440								-	
27	EXISTING SUB-PANEL "B"	125	2	ON	2880	1.00	2880		2880	0	1.00	0	ON	2	50	EXISTING TVSS	
29					2880	1.00	2880	2880		0	1.00	0					
		-		Ph	HASE DEM	AND LOAD	TOTAL	15065	14540								•
					TOTAL DE	MAND LOA	D (VA)	29	305								

NOTE: ** = EXISTING T-MOBILE CIRCUIT RELOCATED FROM DECOMISSIONED PANEL TO NEW PANEL


24"x36" SCALE: NTS 11"x17" SCALE: NTS PANEL SCHEDULE

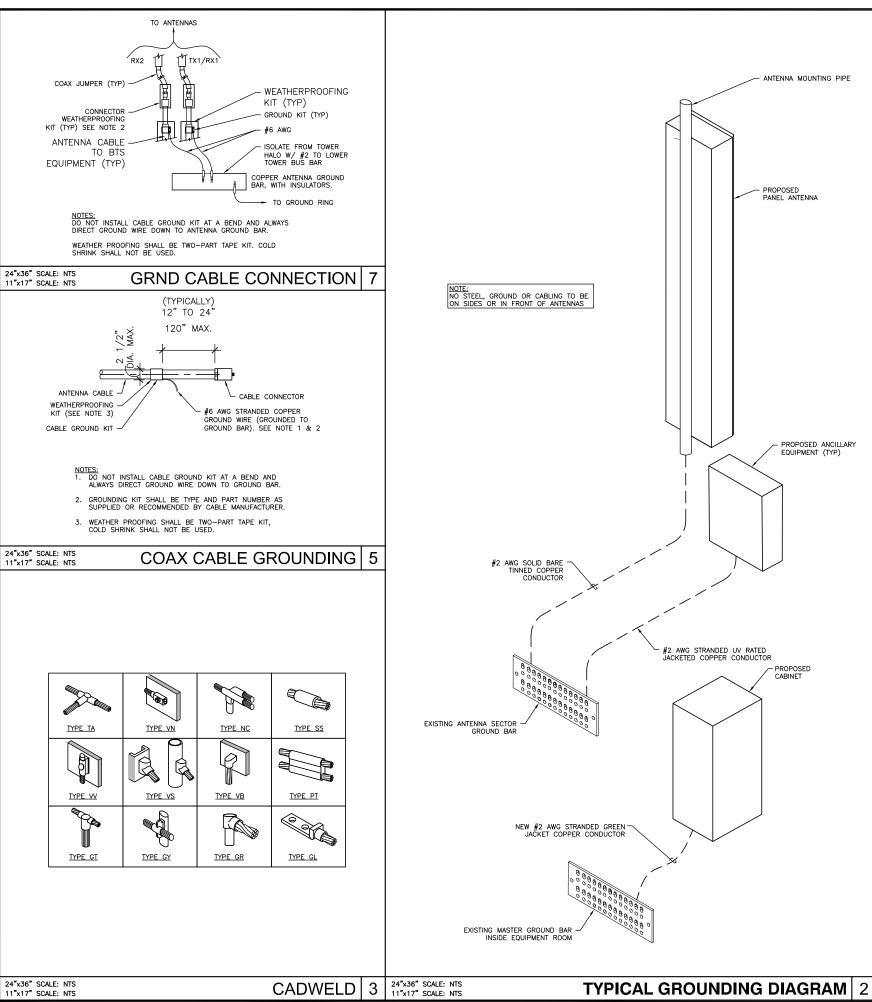

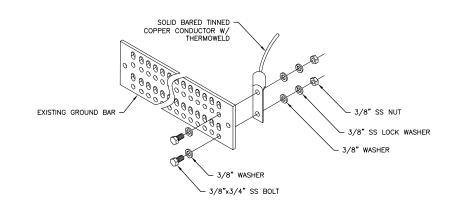

24"x36" SCALE: NTS 11"x17" SCALE: NTS

TYPICAL GROUND BAR CONNECTION 6

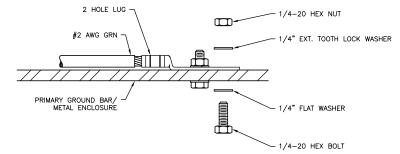



INSTALLATION NOTES:

- 1. SELECT BOLT LENGTH TO PROVIDE A MINIMUM OF TWO EXPOSED THREADS.
- 2. BURNISH MOUNTING SURFACE TO REMOVE PAINT IN THE AREA OF LUG CONTACT.
- 3. APPLY ANTI-OXIDANT COMPOUND TO MATING SURFACE OF LUG AND WIPE CLEAN EXCESS COMPOUND.
- 4. USE SOLID COPPER WIRE AND MECHANICAL 2-HOLF LUG FOR ALL EXTERIOR GROUNDING

24"x36" SCALE: NTS 11"x17" SCALE: NTS

GROUND CONNECTION 4

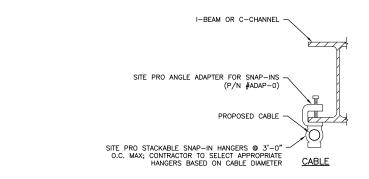

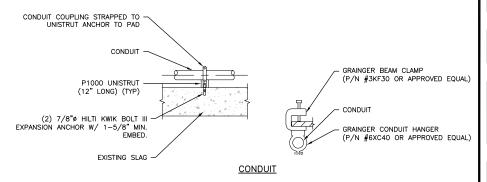



SUITE 300 SAN DIEGO, CA 92130

PLANS PREPARED BY



MORRISON HERSHFIELD 600 STEWART STREET, SUITE 200 SEATTLE, WA 98101

Tel: 206.268.7370 www.morrisonhershfield.com MH PROJECT NUMBER: 203531900

REV.	DATE	ISSUED FOR	BY
A	10/09/20	90% REVIEW	GD
0	12/23/20	100% CONSTRUCTION	MLG
1	05/27/21	JX COMMENTS	JR
SET N	IOT TO BE	USED FOR CONSTRUC	HOLE

SET NOT TO BE USED FOR CONSTRUCTION UNLESS SIGNED BY DESIGN PROFESSIONAL AND STAMPED APPROVED BY MUNICIPALITY



05/27/2021 1:54PM

BAY POINTE APARTMENT

T-MOBILE SITE I.D.

SD06471A

SITE ADDRESS:

3910 INGRAHAM ST SAN DIEGO, CA 92109

SHEET NAME:

GROUNDING DETAILS

SHEET NUMBER

E-2

TYPICAL CONDUIT SUPPORT