

#### THE CITY OF SAN DIEGO

### Report to the Planning Commission

September 2, 2021	REPORT NO. PC-21-035
September 9, 2021	
T-MOBILE BAY POINT APARTMENTS Process Four Dec	ision
<u>678588</u>	
700 Bay Pointe, LLC, Owner / Delilah Bruzee, Applicar	nt
	September 9, 2021 T-MOBILE BAY POINT APARTMENTS Process Four Dec <u>678588</u>

#### <u>SUMMARY</u>

<u>Issue</u>: Should the Planning Commission approve a Wireless Communication Facility located at 3910 Ingraham Street within the Pacific Beach Community Planning area?

#### Staff Recommendation:

1. APPROVE Conditional Use Permit Approval No. 2539308 and Planned Development Permit Approval No. 2539310.

<u>Community Planning Group Recommendation</u>: On June 9, 2021, the Pacific Beach Community Planning Group has voted 14-0-0 to approve the project without conditions (Attachment 10).

<u>Environmental Review</u>: This project was determined to be categorically exempt from the California Environmental Quality Act (CEQA) pursuant to Section 15301 (Existing Facilities) of the State CEQA Guidelines. This project is not pending an appeal of the environmental determination. The environmental exemption determination for this project was made July 16, 2021 and the opportunity to appeal that determination ended July 30, 2021.

<u>Fiscal Impact Statement</u>: All costs associated with the processing of this project are paid by the applicant.

Code Enforcement Impact: None.

<u>Housing Impact Statement</u>: This project application is for a Wireless Communication Facility and is not associated with residential development.

#### BACKGROUND

The project proposes the continued use of an existing T-Mobile Wireless Communication Facility (WCF) located at 3910 Ingraham Street on a 12-acre site encompassing the Bay Pointe Apartments. The site is zoned RM-3-7 (Residential-Multiple Unit) within the Pacific Beach Community Plan. The project site is currently developed with a multi-family housing complex that includes 505 multi-family units, swimming pool and passive landscape areas. Land uses surrounding the project site include single- and multi-family residential unit developments adjacent to the site and a commercial development to the south (Attachments 1-3). The existing WCF was previously approved on January 30, 2014 under Project No. 286694 with a 10-year expiration and included six antennas. The associated WCF equipment operates inside a 144-square foot equipment room.

<u>Council Policy 600-43</u> assigns preference levels to WCFs proposed on different land uses. This site is considered a Preference Four location due to its location within a residential zone on a premises that contains residential development. A WCF at this location requires approval of a Conditional Use Permit (CUP), Process 4 decision in accordance with <u>San Diego Municipal Code (SDMC) Section</u> 141.0420(c). In addition, a Planned Development Permit (PDP) is required in accordance with <u>SDMC Section 143.0402</u> due to a proposed deviation of the antenna enclosure extending past 18 inches from the building face. Sites proposed in Preference Four locations must provide justification why higher preference sites (Preference 1, 2, and 3 sites) were not utilized. The justification as to the continued utilization of the site indicated that the existing location allows for a wide coverage factor and provides coverage to the Pacific Beach community and surrounding residential developments by increasing cellular reception effectiveness, including emergency communications. Other preference sites were not sought out due to the new site buildout may adversely affect the community. The project's development permits will be consolidated under a Process Four decision pursuant to <u>SDMC Section 112.0103(a)</u>.

#### DISCUSSION

#### Project Description:

The Project proposes the continued use of a WCF utilized by T-Mobile. The existing six panel antennas, eight Remote Radio Units (RRUs) and three Tower Mounted Amplifiers (TMAs) will be removed. The proposed WCF consists of nine new antennas where six antennas will be concealed in new antenna skirts and three antennas concealed in a new Fiberglass Reinforced Panel (FRP) box. The 144-square foot equipment room, located on grade on the west elevation, will remain. No other changes are proposed at this time. The facility has been designed in a way that is architecturally integrated with the building and have camouflaged the antennas to be less visible by locating all the antennas near the facia, with three panel antennas and one RRU being concealed in a FRP box that will match the existing stucco texture and paint color of the wall and other vertical elements; and six panel antennas and one RRU with antenna skirts that match the existing green siding, located on the north and east sides of the building (Attachment 11 and Figures 1 and 2).



Figure 1: Proposed Photo Simulation of antenna skirts that match the existing green siding



Figure 2: Proposed Photo Simulation of FRP box that will match existing stucco wall and vertical elements

#### Community Plan Analysis:

The Pacific Beach Community Plan does not address WCFs as a specific land use however, the City of San Diego's General Plan (UD-15) requires that the visual impact of wireless facilities be minimized by concealing WCF's inside existing structures or using screening techniques to hide or blend them with the surrounding area. The plan also calls for these facilities to be designed to be aesthetically pleasing and respectful of the neighborhood context. Furthermore, the plan states that equipment associated with wireless facilities shall be concealed from view.

Pursuant to the <u>SDMC Section 141.0420</u>, WCFs are permitted in all zones citywide with the appropriate permit process. WCFs are separately regulated uses, which have limitations or require compliance with conditions in order to minimize potential impacts. The intent of the regulations is to camouflage facilities from public view. The antennas associated with this project are concealed within a FRP box and antenna skirts that will be matched to the paint and texture of the existing building and blending with the built environment. The location of the antennas in this area have been an established use for the WCF for over 10 years and the continued use of this site will not bring any new changes and will maintain the same profile in this location. The equipment associated with the facility will continue to operate inside a 144-square foot equipment room that is located on grade, adjacent to an existing building, painted and textured to match the existing building.

#### Project-Related Issues:

<u>Deviations</u>- The project requests a deviation from the applicable development regulations as allowed with the approval of a PDP. An applicant may request deviations in accordance with a PDP decided in accordance with Process Four, provided that the findings in <u>SDMC Section 126.0605</u> are made. The following Table 1 is a matrix of the proposed deviation, which is followed by the justifications for the deviations:

DEVIATIONS SUMMARY Table 1				
Deviation Description	<b>Deviation from SDMC</b>	Allowed/Required	Proposed	
WCF Projection from	SDMC Section	Maximum Projection	19 to 23-inch	
Building Wall	<u>141.0420(e)(8)(B)</u>	of 18-inches	projection	

*Justification* – A deviation to the protrusion of the antennas from the face of the building façade is being requested for the WCF for the proper operation of the equipment. The project proposes adding a FRP box housing three antennas and six antennas with antenna skirts, with color and texture matched to integrate to the existing building. With larger sized antennas, the mounting hardware and necessary antenna azimuth make the 18-inch required distance impossible without impacting the main structure. The proposed distance, 19-inches to 23-inches, is the minimum T-Mobile can achieve, while giving the antennas, mounting hardware and necessary azimuth enough room to operate. The carrier has designed the facility in a way that is architecturally integrated with the building and have camouflaged the antennas to be less visible that complies with the City of San Diego Development Services WCF guidelines (Figures 1 and 2). Two design factors weigh into the rationale for the requested height deviation: 1. The WCF Guidelines, which were adopted in 2019, includes requirements for antennas size, amid growing new technology sizes. In this case, the antennas need to protrude up to 5 inches to function as intended. The proposed FRP box and antenna skirts will match the color and texture of the building they are mounted on.

2. The existing WCF provides critical voice and data service throughout the surrounding area. Continued operation of this site is necessary to maintain the existing levels of service to the area for T-Mobile customers. The site is an integral part of telecommunication networks, as the site's operation is closely coordinated with other sites in the area. Coverage maps demonstrate the existing coverage and the predicted loss of coverage without the WCF (Attachment 7). Although the underlying zone allows a maximum of 18 inches protrusion, without a maximum increase of five inches, could result in significant impacts to those within the surrounding area. A degradation of the existing service could have a significant impact on customers and essential emergency communication services.

The above deviation has been analyzed by City staff and determined to be consistent with the goals and recommendations of the General Plan, the Pacific Beach Community Plan, the SDMC and the purpose and intent of the Wireless Communication Ordinance. The project has been designed to address the physical environment and would not adversely impact the public's health or safety. Apart from the above deviation, the proposed project will continue to provide wireless communication service to the surrounding area and emergency essential communications services.

#### Conclusion:

Based on its design, the project complies with the WCF Regulations pursuant to <u>SDMC section</u> <u>141.0420</u>. City staff has prepared draft findings in the affirmative to approve the project and recommends approval of the PDP and CUP (Attachment 5 and 6).

#### **ALTERNATIVES**

- 1. Approve Planned Development Permit No. 2539310 and Conditional Use Permit No. 2539308, with modifications.
- 2. Deny Planned Development Permit No. 2539310 and Conditional Use Permit No. 2539308, if the Planning Commission makes written findings based on substantial evidence that the approval is not authorized by state or local zoning law.

Respectfully submitted,

William Joures

William Zounes for Tim Daly Assistant Deputy Director Development Services Department


San Heacox

lan Heacox Development Project Manager Development Services Department

TD/IH

Attachments:


- 1. Aerial Photograph
- 2. Community Plan Land Use Map
- 3. Project Location Map
- 4. Project Data Sheet
- 5. Draft Permit Resolution with Findings
- 6. Draft Permit with Conditions
- 7. Coverage Maps
- 8. Environmental Exemption
- 9. Ownership Disclosure Form
- 10. Community Planning Group Recommendation
- 11. Photo Survey
- 12. Photo Simulations
- 13. Project Plans

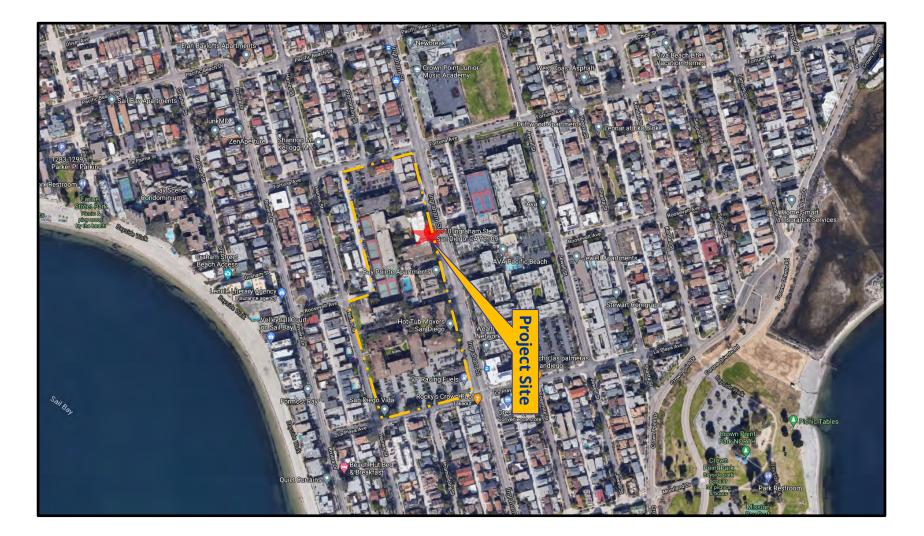




## **Aerial Photograph**

<u>T-Mobile Bay Point Apartments Project No. 678588</u> 3910 Ingraham Street

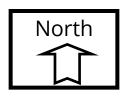

**ATTACHMENT 1** 

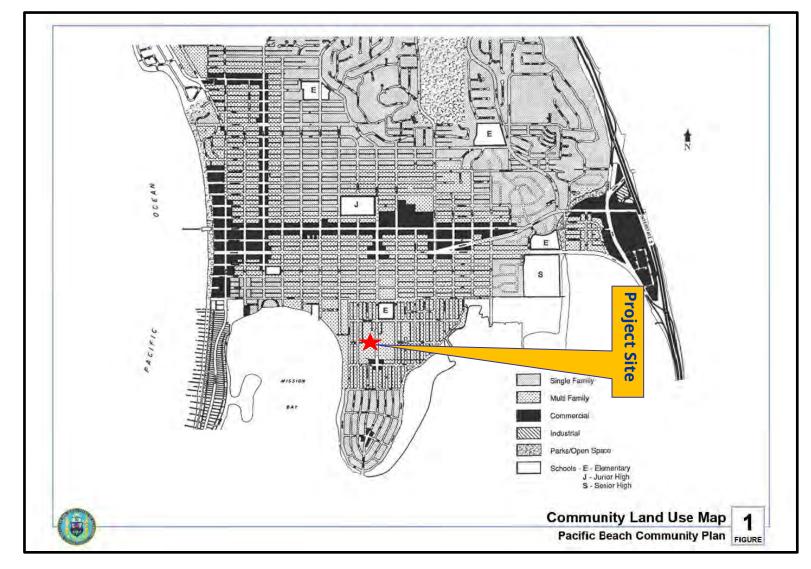




### **Pacific Beach Land Use Map**

T-Mobile Bay Point Apartments Project No. 678588

3910 Ingraham Street




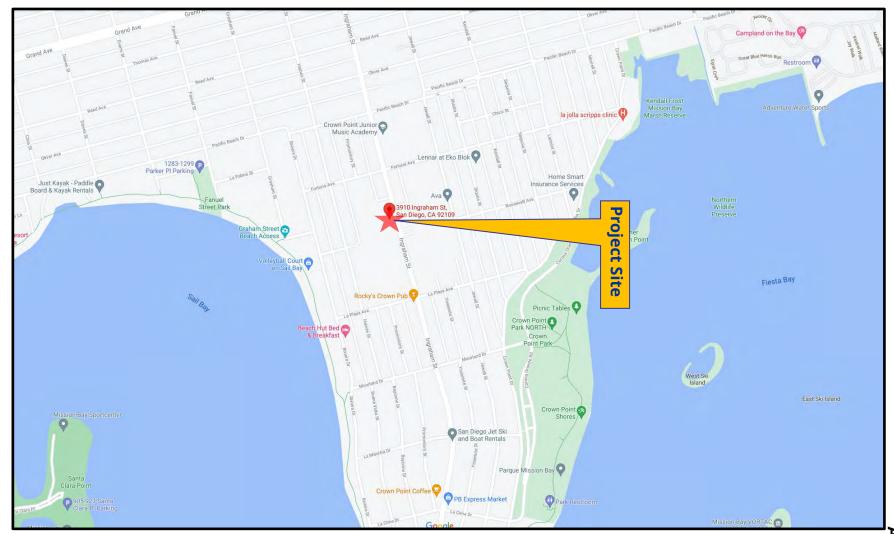



### **Project Location Map**

<u>T-Mobile Bay Point Apartments Project No. 678588</u> 3910 Ingraham Street

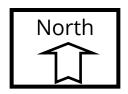

ATTACHMENT 3

#### **ATTACHMENT 4**

		PROJECT DATA SHEET		
PROJECT NAME:	T-Mobile Bay Point Apartments			
PROJECT DESCRIPTION:		The continued operation of a Wireless Communication Facility (WCF) utilized by T-Mobile. The existing WCF consists of façade mounted antennas located at 3910 Ingraham Street		
COMMUNITY PLAN A	REA:	Pacific Beach		
DISCRETIONARY ACTI	IONS:	Planned Development Permit/Conditional Use Permit		
COMMUNITY PLAN LAND USE DESIGNATION:		Pacific Beach		
		ZONING INFORMATION:		
ZONE:	RM-3-7			
HEIGHT LIMIT:	40 feet			
LOT SIZE:	12-acres			
FLOOR AREA RATIO:	N/A			
FRONT SETBACK:	10/20 feet			
SIDE SETBACK:	5 feet			
STREETSIDE SETBACK	<b>:</b> 10 feet			
REAR SETBACK:	5 feet			
PARKING:	N/A			
		LAND USE DESIGNATION & ZONE	EXISTING LAND USE	
NORTH:		Residential; RM-1-1	Residential	
SOUTH:		Commercial; CN-1-2	Commercial/Neighborhood	
EAST:		Residential; RM-3-7	Residential	
WEST:		Residential; RM-1-1	Residential	
DEVIATIONS OR VARI REQUESTED (INCENTI		0		
COMMUNITY PLANNING GROUP RECOMMENDATION:		On June 9, 2021 the Pacific Beach Community Planning Group voted 14-0-0 to recommend approval of the project without conditions.		

#### **ATTACHMENT 5**

#### PLANNING COMMISSION RESOLUTION NO. \_\_\_\_\_ CONDITIONAL USE PERMIT NO. 2539308 PLANNED DEVELOPMENT PERMIT NO. 2539310 T-MOBILE BAY POINT APT. PROJECT NO. 678588

WHEREAS, 700 BAY POINTE, LLC, OWNER , Owner, and T-MOBILE USA, Permittee, filed an application with the City of San Diego for a permit for a Wireless Communication Facility (as described in and by reference to the approved Exhibits "A" and corresponding conditions of approval for the associated Permit Nos. 2539308 and 2539310), on portions of a 12.0-acre site;

WHEREAS, the project site is located at 3910 Ingraham Street in the RM-3-7 zone of the Pacific Beach Community Plan; and

WHEREAS, the project site is legally described as Parcel 1: Lot 2 of South Bay Club Apartments – Mission Bay, in the City of San Diego, County of San Diego, State of California, according to map thereof no. 5935, filed in the Office of the County Recorder of San Diego County, August 10, 1967. Parcel 2: Lot 1 South Bay Apartments – Mission Bay, Resubdivision No. 1, in the City of San Diego, County of San Diego, State of California, according to map thereof no. 6237, filed in the Office of the County Recorder of San Diego County, November 26, 1968; and

WHEREAS, on July 16, 2021, the City of San Diego, as Lead Agency, through the Development Services Department, made and issued an Environmental Determination that the project is exempt from the California Environmental Quality Act (CEQA) (Public Resources Code Section 21000 et seq.) under CEQA Guideline Section 15301 (Existing facilities); and there was no appeal of the Environmental Determination filed within the time period provided by San Diego Municipal Code Section 112.0520; and WHEREAS, on September 9, 2021, the Planning Commission of the City of San Diego

considered Conditional Use Permit No. 2539308 and Planned Development Permit No. 2539310

pursuant to the Land Development Code of the City of San Diego; NOW, THEREFORE,

BE IT RESOLVED by the Planning Commission of the City of San Diego, that it adopts the

following findings with respect to Conditional Use Permit No. 2539308 and Planned Development

Permit No. 2539310:

#### A. CONDITIONAL USE PERMIT SAN DIEGO MUNICIPAL CODE (SDMC) Section 126.0305

#### 1. Findings for all Conditional Use Permits:

### a. The proposed development will not adversely affect the applicable land use plan.

The project proposes the continued use of a Wireless Communication Facility (WCF) by T-Mobile. The proposed wireless facility will contain three (3) panel antennas and one (1) Remote Radio Unit (RRU) screened behind one (1) Fiberglass Reinforced Panel (FRP) Box painted and textured to match the existing building; six (6) panel antennas and two (2) RRUs façade mounted with antenna skirts painted and textured to match the existing building. Accessory equipment continues to operate inside a 144-square foot equipment room. The WCF is located at 3910 Ingraham St. San Diego, CA 92109 in the RM-3-7 zone of the Pacific Beach Community Planning area. The WCF was previously approved for a Conditional Use Permit (CUP) on January 20, 2014 with a 10-year term.

The City of San Diego's General Plan (UD-15) requires that the visual impact of wireless facilities be minimized by concealing them inside existing structures or using screening techniques to hide or blend them into the surrounding area. The plan also calls for these facilities to be designed to be aesthetically pleasing and respectful of the neighborhood context. Furthermore, the plan states that equipment associated with wireless facilities shall be concealed from view.

Pursuant to the San Diego Land Development Code (SDMC) Section 142.0420, WCFs are permitted in all zones citywide with the appropriate permit process. Wireless Communication Facilities are separately regulated uses, which have limitations or require compliance with conditions in order to minimize potential impacts. The intent of the regulations is to camouflage facilities from public view. For the proposed project, the façade mounted antennas are screened and well-integrated with the existing architecture of the building and any potential visual impacts will be minimized.

Pursuant to SDMC Section 141.0420(c)(2) when the WCF is in a residential zone on a premise that contains residential development, a Conditional Use Permit (CUP) is required. Additionally, in accordance to SDMC Section 143.0402, deviations from applicable zoning regulations require a Planned Development Permit (PDP). SDMC 141.0420(g)(8) states that panel antennas shall be mounted no more than 12 inches away from a building façade and shall appear as an integral part of the building. They may be mounted up to 18 inches away from a building façade when the applicant provides evidence demonstrating that the wireless communication facility cannot operate without incorporating a tilt greater than 12 inches. With newer technology and larger sized antennas, T-Mobile requires up to 23 inches for this modification. The facility has been designed in a way that is architecturally integrated with the building and have camouflaged the antennas to be less visible.

As a result, the project compiles with SDMC Section 141.0420, the WCF Design Guidelines, as well as the City's General Plan. The proposed development would not adversely affect the Pacific Beach Community Plan or the City of San Diego General Plan. Therefore, the proposed development will not adversely affect the applicable land use plan.

### b. The proposed development will not be detrimental to the public health, safety and welfare.

The project was determined to be exempt from CEQA pursuant to Section 15301 (Existing Facilities). The conditions of approval for the project will require compliance with several operational constraints and development controls intended to assure the continued public health, safety and welfare to include but not limited to height limitation, concealment requirements, and electromagnetic fields controls. All proposed improvement plans associated with the project will be reviewed prior to issuance of construction permits and inspected during construction to assure the project will meet or exceed all relevant and applicable building, electrical, mechanical, plumbing and fire codes.

The Telecommunication Act of 1996 preempts local governments from regulating the "placement, construction and modification of wireless communication facilities on the basis of the environmental effects of Radio Frequency (RF) emissions to the extent that such facilities comply with the Federal Communication Commission's (FCC) standards for such emissions. A Radio Frequency – Electromagnetic Energy (RF-EME) Compliance Report (NSB) dated April 2, 2021 from EBI Consulting, was submitted to the City verifying that the proposed project meets or exceeds the requirements of the FCC. The report will be stamped as Exhibit "A" and provided within the project file. Therefore, the proposed development will not be detrimental to the public health, safety, and welfare.

c. The proposed development will comply with the regulations of the Land Development Code including any allowable deviations pursuant to the Land Development Code The project proposes the continued use of a WCF. The project complies with the City of San Diego WCF Regulations (SDMC Section 141.0420) and applicable development regulations of the RM-3-7 Zone.

Deviations to the SDMC may be processed through a PDP in accordance with SDMC 126.0601 and 143.0401. The purpose of the PDP is to establish a review process for development that allows an applicant to request greater flexibility from the strict application of the regulations than would be allowed through a deviation process. The intent is to encourage imaginative and innovative planning and to assure that the development achieves the purpose and intent of the applicable land use plan and that it would be preferable to what would be achieved by strict conformance with the regulations.

SDMC 141.0420(g)(8) states that panel antennas shall be mounted no more than 12 inches away from a building facade and shall appear as an integral part of the building. They may be mounted up to 18-inches away from a building façade when the applicant provides evidence demonstrating that the wireless communication facility cannot operate without incorporating a tilt greater than 12 inches. A deviation is being requested to increase the projection of the antenna concealment up to 23inches from the face of the building. The proposed FRP screening box and antenna skirts require a longer distance for adequate operation of the WCF. The measurements of the antennas, mounting hardware, and the required antenna azimuth make the 18-inch distance unfeasible. The proposed distances for the antennas range from 19-inches to 23-inches and allow T-Mobile to have enough room for the antennas, required mounting hardware, the required azimuth and concealing the antennas to comply with the City of San Diego Development Services WCF concealment guidelines. The WCF ordinance, found in Chapter 14, Article 4, Division 20, required the maximum distance of 18-inches when antennas and equipment were smaller and the requirements were restricted. Due to the high demand of WCFs, the antennas are larger to assist the need for increasing capacity and demand.

The facility has been designed in a way that is architecturally integrated with the building and have camouflaged the antennas to be less visible by locating all the antennas near the facia, with three (3) panel antennas and one (1) RRU being concealed in a FRP box that will match the existing stucco texture and paint color; three (3) panel antennas and one (1) RRU with antenna skirts that match the existing green siding, located on the north and east sides of the building.

The project was originally approved on January 30, 2014 (Project No. 286694). In order to continue providing service to the surrounding area, the antennas need to be updated with newer antenna models and remain at the height and orientation they were originally installed as the network was developed using those metrics for coverage. The proposed WCF will provide a critical voice and data service throughout the surrounding area. The continued operation of this site is necessary to maintain the existing levels of service to the area for T-Mobile customers. The site is an

integral part of telecommunication networks, as the site's operation is closely coordinated with other sites in the area. Coverage maps demonstrate the existing coverage provided on the subject property and the predicted loss of coverage without the antenna upgrade. A degradation of the existing service could have a significant impact on customers and essential emergency communication services. Expiration dates are imposed on WCFs to review and modify these facilities to comply with current design standards. The subject project is conditioned to expire 10-years from its approval date.

Based on these considerations, this project complies with the permit and design requirements for WCF's as identified in the SDMC. Therefore, the proposed development will comply with the regulations of the Land Development Code including any proposed deviations pursuant to SDMC Section 126.0602(b)(1) that are appropriate for this location and will result in a more desirable project than would be achieved if designed in strict conformance with the development regulations of the applicable zone, and any allowable deviations that are otherwise authorized pursuant to the Land Development Code.

#### d. The proposed use is appropriate at the proposed location.

The project proposes the continued use of a Wireless Communication Facility (WCF) with all the antennas mounted near the facia, with three (3) panel antennas and one (1) RRU being concealed in a FRP box that will match the existing stucco texture and paint color; three (3) panel antennas and one (1) RRU with antenna skirts that match the existing green siding, located on the north and east sides of the building.

A site justification analysis was prepared by T-Mobile and accepted by City staff demonstrating a need for this WCF. According to the justification analysis, without the existing coverage footprint from the existing WCF, the loss of the coverage could result in significant impacts to the neighborhood and those living, working, and traveling through the surrounding area. Additionally, a loss of service could possibly have a significant impact on customers and essential communications services. The WCF is appropriately designed at the location and integrates with the existing building by matching the paint color and the texture of the FRP box and antenna skirts to the existing building. The FRP box and antenna skirts further complement the existing building design by matching existing vertical design elements. The design is consistent with the City's General Plan for wireless facilities. A 10-year term will be included as a condition of approval to ensure that the design and use is still appropriate at that time. As demonstrated by the justification analysis and the design, the existing WCF is appropriate at the existing location.

#### B. PLANNED DEVELOPMENT PERMIT SDMC Section 126.0605

#### 1. Findings for all Planned Development Permits:

### a. The proposed development will not adversely affect the applicable land use plan.

Please see CUP Finding No. 1 above for facts supporting this Finding. For the reasons described in that Finding, which are hereby incorporated into this Finding by reference, the proposed development will not adversely affect the applicable land use plan.

### b. The proposed development will not be detrimental to the public health, safety and welfare.

Please see CUP Finding No. 2 above for facts supporting this Finding. For the reasons described in that Finding, which are hereby incorporated into this Finding by reference, the proposed development will not be detrimental to the public health, safety, and welfare.

c. The proposed development will comply with the regulations of the Land Development Code including any proposed deviations pursuant to Section 126.0602(b)(1) that are appropriate for this location and will result in a more desirable project than would be achieved if designed in strict conformance with the development regulations of the applicable zone, and any allowable deviations that are otherwise authorized pursuant to the Land Development Code.

Please see CUP Finding No. 3 above for facts supporting this Finding. For the reasons described in that Finding, which are hereby incorporated into this Finding by reference, the proposed development will comply with the regulations of the Land Development Code including any proposed deviations pursuant to SDMC Section 126.0602(b)(1) that are appropriate for this location and will result in a more desirable project than would be achieved if designed in strict conformance with the development regulations of the applicable zone, and any allowable deviations that are otherwise authorized pursuant to the Land Development Code.

The above findings are supported by the minutes, maps and exhibits, all of which are

incorporated herein by this reference.

BE IT FURTHER RESOLVED that, based on the findings hereinbefore adopted by the Planning

Commission, Conditional Use Permit No. 2539308 And Planned Development Permit No. 2539310 is

hereby GRANTED by the Planning Commission to the referenced Owner/Permittee, in the form,

exhibits, terms and conditions as set forth in Permit No. 2539308 and 2539310, a copy of which is attached hereto and made a part hereof.

Ian Heacox Development Project Manager Development Services

Adopted on: September 9, 2021

IO#: 11004545

RECORDING REQUESTED BY CITY OF SAN DIEGO DEVELOPMENT SERVICES PERMIT INTAKE, MAIL STATION 501

#### WHEN RECORDED MAIL TO PROJECT MANAGEMENT PERMIT CLERK MAIL STATION 501

#### INTERNAL ORDER NUMBER: 11004545 SPACE ABOVE THIS LINE FOR RECORDER'S USE

#### CONDITIONAL USE PERMIT NO. 2539308 PLANNED DEVELOPMENT PERMIT NO. 2539310 **T-MOBILE BAY POINT APARTMENTS PROJECT NO. 678588** PLANNING COMMISSION

This Conditional Use Permit No. 2539308 and Planned Development Permit No. 2539310 is granted by the Planning Commission of the City of San Diego to 700 Bay Pointe, LLC, Owner, and T-Mobile USA, permittee, pursuant to San Diego Municipal Code [SDMC] section 141.0420, 126.0602 and 126.0303. The 12.0 -acre site is located at 3910 Ingraham Street in the RM-3-7 zone of the Pacific Beach Community Plan. The project site is legally described as: Parcel 1: Lot 2 of South Bay Club Apartments – Mission Bay, in the City of San Diego, County of San Diego, State of California, according to map thereof no. 5935, filed in the Office of the County Recorder of San Diego County, August 10, 1967. Parcel 2: Lot 1 South Bay Apartments – Mission Bay, Resubdivision No. 1, in the City of San Diego, County of San Diego, State of California, according to map thereof no. 6237, filed in the Office of the County Recorder of San Diego County, November 26, 1968.

Subject to the terms and conditions set forth in this Permit, permission is granted to Owner and Permittee for a Wireless Communication Facility (WCF) described and identified by size, dimension, quantity, type, and location on the approved exhibits [Exhibit "A"] dated September 9, 2021, on file in the Development Services Department.

The project shall include:

- a. The continued operation of a Wireless Communication Facility (WCF) consisting nine (9) panel antennas measuring 33.1" by 20.6" by 8.6" and 50.94" by 12.01" by 6.5" and 56.6" by 12.9" by 8.7" and three (3) Remote Radio Units (RRUs);
- b. One (1) Fiberglass Reinforced Panel (FRP) transparent screen wall mounted on the west building wall covering three (3) panel antennas and one (1) RRU painted and textured to match the existing building;

Three (3) panel antennas mounted on the north face building wall covered with antenna skirts painted and textured to match existing structure;

Three (3) panel antennas mounted on the north east building wall covered with antenna skirts painted and textured to match existing structure;

- c. A deviation from SDMC Section 141.0420(e)(8)(B) allowing the antenna concealment to protrude up to 23-inches from the building face where up to 18-inches is allowed;
- d. The equipment associated with this project will continue to operate inside a 144-square-foot equipment room on grade, below the stairwell and on the west elevation; and
- e. Public and private accessory improvements determined by the Development Services Department to be consistent with the land use and development standards for this site in accordance with the adopted community plan, the California Environmental Quality Act [CEQA] and the CEQA Guidelines, the City Engineer's requirements, zoning regulations, conditions of this Permit, and any other applicable regulations of the SDMC.

#### **STANDARD REQUIREMENTS**:

1. This permit must be utilized within thirty-six (36) months after the date on which all rights of appeal have expired. If this permit is not utilized in accordance with Chapter 12, Article 6, Division 1 of the SDMC within the 36-month period, this permit shall be void unless an Extension of Time has been granted. Any such Extension of Time must meet all SDMC requirements and applicable guidelines in effect at the time the extension is considered by the appropriate decision maker. This permit must be utilized by September 23, 2024.

2. This permit and corresponding use of this site shall **expire on September 23, 2031.** Upon expiration of this approval, the facilities and improvements described herein shall be removed from this site and the property shall be restored to its original condition preceding approval of this permit unless the applicant of record files a new application for a facility which will be subject to compliance with all regulations in effect at the time.

3. No later than ninety (90) days prior to the expiration of this approval, the Owner/Permittee may submit a new application to the Development Services Department for consideration with review and a decision by the appropriate decision maker at that time. Failure to submit prior to the deadline will be cause for enforcement for noncompliance, which may include penalties and fines.

4. Under no circumstances, does approval of this permit authorize the Owner/Permittee to utilize this site for WCF purposes beyond the permit expiration date. Use of this permit approval beyond the expiration date of this permit is prohibited.

5. No permit for the construction, occupancy, or operation of any facility or improvement described herein shall be granted, nor shall any activity authorized by this Permit be conducted on the premises until:

a. The Owner/Permittee signs and returns the Permit to the Development Services Department; and

b. The Permit is recorded in the Office of the San Diego County Recorder.

6. While this Permit is in effect, the subject property shall be used only for the purposes and under the terms and conditions set forth in this Permit unless otherwise authorized by the appropriate City decision maker.

7. This Permit is a covenant running with the subject property and all of the requirements and conditions of this Permit and related documents shall be binding upon the Owner/Permittee and any successor(s) in interest.

8. The continued use of this Permit shall be subject to the regulations of this and any other applicable governmental agency.

9. Issuance of this Permit by the City of San Diego does not authorize the Owner/Permittee for this Permit to violate any Federal, State or City laws, ordinances, regulations or policies including, but not limited to, the Endangered Species Act of 1973 [ESA] and any amendments thereto (16 U.S.C. § 1531 et seq.).

10. The Owner/Permittee shall secure all necessary building permits. The Owner/Permittee is informed that to secure these permits, substantial building modifications and site improvements may be required to comply with applicable building, fire, mechanical, and plumbing codes, and State and Federal disability access laws.

11. Construction plans shall be in substantial conformity to Exhibit "A." Changes, modifications, or alterations to the construction plans are prohibited unless appropriate application(s) or amendment(s) to this Permit have been granted.

12. All of the conditions contained in this Permit have been considered and were determined necessary to make the findings required for approval of this Permit. The Permit holder is required to comply with each and every condition in order to maintain the entitlements that are granted by this Permit.

If any condition of this Permit, on a legal challenge by the Owner/Permittee of this Permit, is found or held by a court of competent jurisdiction to be invalid, unenforceable, or unreasonable, this Permit shall be void. However, in such an event, the Owner/Permittee shall have the right, by paying applicable processing fees, to bring a request for a new permit without the "invalid" conditions(s) back to the discretionary body which approved the Permit for a determination by that body as to whether all of the findings necessary for the issuance of the proposed permit can still be made in the absence of the "invalid" condition(s). Such hearing shall be a hearing de novo, and the discretionary body shall have the absolute right to approve, disapprove, or modify the proposed permit and the condition(s) contained therein.

13. The Owner/Permittee shall defend, indemnify, and hold harmless the City, its agents, officers, and employees from any and all claims, actions, proceedings, damages, judgments, or costs, including attorney's fees, against the City or its agents, officers, or employees, relating to the issuance of this permit including, but not limited to, any action to attack, set aside, void, challenge,

or annul this development approval and any environmental document or decision. The City will promptly notify Owner/Permittee of any claim, action, or proceeding and, if the City should fail to cooperate fully in the defense, the Owner/Permittee shall not thereafter be responsible to defend, indemnify, and hold harmless the City or its agents, officers, and employees. The City may elect to conduct its own defense, participate in its own defense, or obtain independent legal counsel in defense of any claim related to this indemnification. In the event of such election, Owner/Permittee shall pay all of the costs related thereto, including without limitation reasonable attorney's fees and costs. In the event of a disagreement between the City and Owner/Permittee regarding litigation issues, the City shall have the authority to control the litigation and make litigation related decisions, including, but not limited to, settlement or other disposition of the matter. However, the Owner/Permittee shall not be required to pay or perform any settlement unless such settlement is approved by Owner/Permittee.

#### LANDSCAPE REQUIREMENTS:

14. The Owner/Permittee shall be responsible for the maintenance of all landscape improvements shown on the approved plans, including in the right-of-way, unless long-term maintenance of said landscaping will be the responsibility of another entity approved by the Development Services Department. All required landscape shall be maintained consistent with the Landscape Standards in a disease, weed, and litter free condition at all times. Severe pruning or "topping" of trees is not permitted.

15. If any required landscape (including existing or new plantings, hardscape, landscape features, etc.) indicated on the approved construction documents is damaged or removed, the Owner/Permittee shall repair and/or replace in kind and equivalent size per the approved documents to the satisfaction of the Development Services Department within 30 days of damage or Certificate of Occupancy.

#### PLANNING/DESIGN REQUIREMENTS:

16. Every aspect of this project is considered an element of concealment including but not limited to the dimensions, bulk and scale, color, materials and texture. Any future modifications to this permit must not defeat concealment.

17. No overhead cabling is permitted.

- 18. The WCF shall conform to the approved construction plans.
- 19. Photo simulations shall be printed in color on the construction plans.

20. The City may require the Owner/Permittee to provide a topographical survey conforming to the provisions of the SDMC may be required if the City determines during construction, that there may be a conflict between the building(s) under construction and a condition of this Permit or a regulation of the underlying zone. The cost of any such survey shall be borne by the Owner/Permittee.

21. The Owner/Permittee shall install and maintain appropriate warning signage on the WCF as required by State and Federal regulations. The Owner/Permittee shall be responsible for complying with all State and Federal regulations.

22. Antennas and associated components, such as, but not limited to, remote radio units (RRUs), surge suppressors, etc., shall not exceed the height of any existing or proposed screen walls.

23. Use of or replacement of any building façade or mechanical screen with RF-transparent material for purposes of concealing antennas shall not result in any noticeable lines or edges in the transition to the original building. All RF-transparent material shall be painted and textured to match the original building and adjacent building surfaces.

24. The accuracy and validity of the RF Compliance Report, submitted by the Permittee, shall be assured while the WCF is in operation. If requested by the City, Owner/Permittee shall provide an updated RF Compliance Report to address any issues associated with the emitting components of the WCF.

25. All equipment, including transformers, emergency generators and air conditioners belonging to the Owner/Permittee shall be designed and operated consistent with the City noise ordinance. Ventilation openings shall be baffled and directed away from residential areas. Vibration resonance of operating equipment in the equipment enclosures shall be eliminated.

26. All facilities and related equipment shall be maintained in good working order. Any damaged equipment shall be repaired or replaced within thirty (30) calendar days of notification by the City of San Diego.

27. The Owner/Permittee shall notify the City within 30 days of the sale or transfer of this site to any other provider or if the site is no longer operational, in which case, the removal and the restoration of this site to its original condition is required.

#### Façade Mounted Antennas:

28. Antennas shall be painted and textured to match the building to the satisfaction of the Development Services Department.

29. All conduits related to this project shall be concealed inside the proposed side and bottom skirts painted to match the surface to which they are attached to the satisfaction of the Development Services Department.

30. No exposed pipes or mounting apparatus absent antennas shall be present at any time. Mounting pipes shall not be longer than the antennas.

31. Bottom chin covers shall be installed to current and future antennas. Chin covers shall be molded fiberglass to match the exact antenna dimensions and profile to the satisfaction of the Development Services Department. The chin covers shall be painted to match the antennas.

32. All bottom-fed conduits shall be routed directly into the port-holes at the same height level to avoid any excessive looping. All conduits must be organized and grouped within reason to the satisfaction of the Development Services Department.

#### **INFORMATION ONLY:**

- Please note that a Telecom Planning Inspection Issue will be placed on the project prior to Final Clearance from the City's Building Inspector to ensure compliance with the approved plans and associated conditions. Prior to calling for your Final Inspection from your building inspection official, please contact the Development Services Department Wireless Communication Facilities staff listed on City webpage, <u>https://www.sandiego.gov/development-services/codes-regulations/wireless-communicationfacilities</u>, to schedule an inspection of the completed facility. Please schedule this administrative inspection at least five working days ahead of the requested Final Inspection date.
- The issuance of this development permit alone does not allow the immediate commencement or continued operation of the proposed use on site. The operation allowed by this discretionary permit may only begin or recommence after all conditions listed on this permit are fully completed and all required ministerial permits have been issued and received final inspection.
- Any party on whom fees, dedications, reservations, or other exactions have been imposed as conditions of approval of this permit, may protest the imposition within ninety days of the approval of this development permit by filing a written protest with the City Clerk pursuant to California Government Code-section 66020.
- This development may be subject to impact fees at the time of construction permit issuance.

APPROVED by the Planning Commission of the City of San Diego on September 9, 2021.

#### **ATTACHMENT 6**

Planned Development Permit No. 2539310 Conditional Use Permit No. 2539308 September 9, 2021

AUTHENTICATED BY THE CITY OF SAN DIEGO DEVELOPMENT SERVICES DEPARTMENT

lan Heacox Development Project Manager

NOTE: Notary acknowledgment must be attached per Civil Code section 1189 et seq.

**The undersigned Owner/Permittee**, by execution hereof, agrees to each and every condition of this Permit and promises to perform each and every obligation of Owner/Permittee hereunder.

700 Bay Pointe, LLC Owner

By \_\_\_\_\_ NAME: TITLE:

T-Mobile USA Permittee

By \_\_\_\_\_ NAME: TITLE:

NOTE: Notary acknowledgments must be attached per Civil Code section 1189 et seq.

## ·· T ·· Mobile·

## **SD06471A Coverage Maps**

## **RF Team - San Diego Market**




## ·· T·· Mobile· Area with SD06471A





## •• T•• Mobile• Area without SD06471A

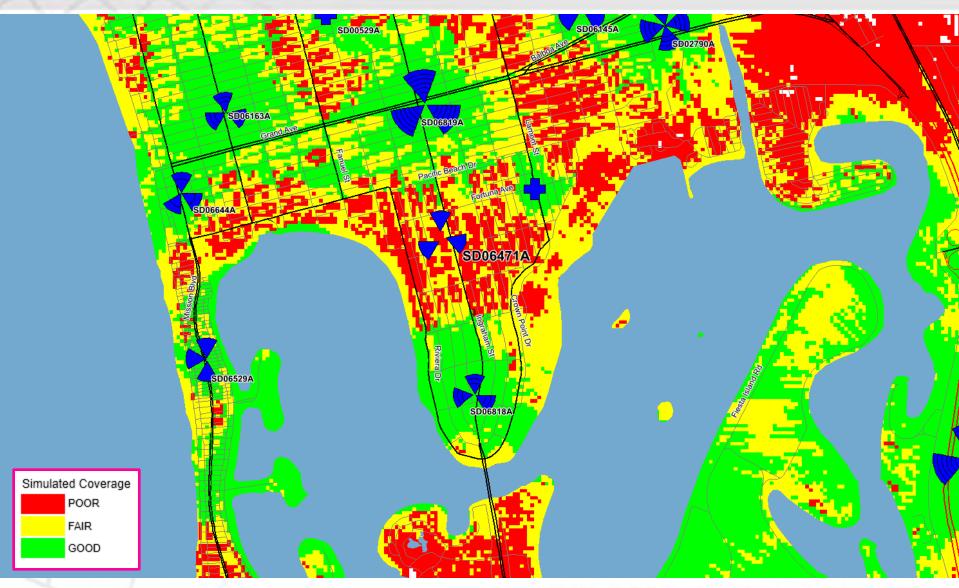



#### NOTICE OF EXEMPTION

#### (Check one or both)

TO:

X \_\_\_\_\_RECORDER/COUNTY CLERK P.O. BOX 1750, MS A-33 1600 Pacific Hwy, Room 260 San Diego, CA 92101-2422

FROM: CITY OF SAN DIEGO DEVELOPMENT SERVICES DEPARTMENT 1222 FIRST AVENUE, MS 501 SAN DIEGO, CA 92101

\_\_\_\_\_OFFICE OF PLANNING AND RESEARCH 1400 TENTH STREET, ROOM 121 SACRAMENTO, CA 95814

Project No.: 678588

Project Title: T-Mobile Bay Point

PROJECT LOCATION-SPECIFIC: The project is located at 3910 Ingraham Street, San Diego, CA 92109

PROJECT LOCATION-CITY/COUNTY: San Diego/San Diego

<u>DESCRIPTION OF NATURE AND PURPOSE OF THE PROJECT</u>: Conditional Use Permit (CUP) and Planned Development Permit (PDP) to modify and to continue the use of an existing Wireless Communication Facility (WCF). The project would remove 6 panel antennas and install 9 panel antennas, remove 8 remote radio units (RRUs), install 3 RRUs, and remove 3 TMAs. All 6 shrouds would be replaced with the addition of 1 fiber glass panel transparent screen wall. The associated equipment would continue to operate inside an existing 144square-foot equipment room. The project is located at 3910 Ingraham Street, San Diego, CA 92109 in the RM-3-7 zone, the Coastal Zone N-APP-2, and the CHLOZ 2. The WCF is unmanned and technicians would visit the site only as required for routine maintenance and repairs.

NAME OF PERSON OR AGENCY CARRYING OUT PROJECT: Deliah Bruzee, OBO T-Mobile, 10590 W. Ocean Air Drive Suite 300, San Diego, CA 92130. (858) 799-0575

#### EXEMPT STATUS: (CHECK ONE)

- () MINISTERIAL (SEC. 21080(b)(1); 15268);
- () DECLARED EMERGENCY (SEC. 21080(b)(3); 15269(a));
- () EMERGENCY PROJECT (SEC. 21080(b)(4); 15269 (b)(c)..
- (X) CATEGORICAL EXEMPTION: 15302 (Replacement or Reconstruction)
- () STATUTORY EXEMPTION:

<u>REASONS WHY PROJECT IS EXEMPT</u>: The City of San Diego conducted an environmental review which determined that the proposed project is exempt from CEQA pursuant to CEQA Guidelines Section 15302. CEQA Section 15302 allows for the replacement or reconstruction of existing structures and facilities where the new structure will be located on the same site and will have substantially the same purpose and capacity as the structure being replaced. The proposed project is modifying the existing facility and would replace old equipment with new without expanding the use of the WCF. No environmental impacts were identified for the proposed project and none of the exceptions described in CEQA Guidelines Section 15300.2 apply.

#### LEAD AGENCY CONTACT PERSON: Jeffrey Szymanski

TELEPHONE: 619 446-5324

IF FILED BY APPLICANT:

- 1. ATTACH CERTIFIED DOCUMENT OF EXEMPTION FINDING.
- 2. HAS A NOTICE OF EXEMPTION BEEN FILED BY THE PUBLIC AGENCY APPROVING THE PROJECT?
  - () YES () NO

IT IS HEREBY CERTIFIED THAT THE CITY OF SAN DIEGO HAS DETERMINED THE ABOVE ACTIVITY TO BE EXEMPT FROM CEQA

SIZNICE PLANNET SIGNATURE/TITLE

8/3/2021 DATE

CHECK ONE: (X) SIGNED BY LEAD AGENCY CLERK OR OPR:

DATE RECEIVED FOR FILING WITH COUNTY



**City of San Diego Development Services** 1222 First Ave., MS 302 San Diego, CA 92101 (619) 446-5000

### Ownership Disclosure Statement

FORM	
)S-31	8

October 2017

Approval Type: Check appropriat □ Neighborhood Development P □ Tentative Map □ Vesting Tent	ermit 🛯 Site 🛛	Development Permit 🗖 Planne	d Development Permit	Conditional Use P	ermit 🛯 Variance
Project Title:			Project No	. For City Use Only	:
Project Address:					
Specify Form of Ownership/Leg			Corporate Identification	n No	
□ Partnership □ Individual	, o. <u> </u>				
By signing the Ownership Disclos with the City of San Diego on the owner(s), applicant(s), and other individual, firm, co-partnership, j with a financial interest in the ap- individuals owning more than 10 officers. (A separate page may b <b>ANY</b> person serving as an offic A signature is required of at lead notifying the Project Manager of ownership are to be given to the accurate and current ownership	ne subject pro financially int joint venture, oplication. If t 0% of the shar e attached if r er or director st one of the f any changes Project Mana	perty with the intent to recon erested persons of the above association, social club, frater the applicant includes a corpo es. If a publicly-owned corpo necessary.) If any person is a r of the nonprofit organizatio property owners. Attach add in ownership during the time ager at least thirty days prior t	rd an encumbrance again referenced property. A nal organization, corpora ration or partnership, in- ration, include the name tonprofit organization or on or as trustee or bene litional pages if needed. e the application is being o any public hearing on t	nst the property. P financially interester tion, estate, trust, r clude the names, tit s, titles, and addres: a trust, list the nam ficiary of the nong Note: The applicar g processed or cons	lease list below the d party includes any eceiver or syndicate les, addresses of all ses of the corporate es and addresses of orofit organization. It is responsible for idered. Changes in
Property Owner					
Name of Individual:			Owner 🗆 Owner	Tenant/Lessee	Successor Agency
Street Address:					
City:					
Phone No.:		Fax No.:	Email:		
Signature: <u>See attac</u>	hed Letter	of Authorization	Date:		
Additional pages Attached:	Yes	D No			
Name of Individual:			🔲 Owner	Tenant/Lessee	Successor Agency
Street Address:					
City:				State:	Zip:
Phone No.:		Fax No.:	Email:		
Signature: Delilah B	uzee		Date:	2/17/21	
Additional pages Attached:	Yes	No			
Other Financially Interested Pe	ersons				
Name of Individual:			🛛 Owner	Tenant/Lessee	Successor Agency
Street Address:					
City:				State:	Zip:
Phone No.:		Fax No.:	Email:		
Signature:			Date:		
Additional pages Attached:	🗅 Yes	🗖 No			

Printed on recycled paper. Visit our web site at <u>www.sandiego.gov/development-services</u>. Upon request, this information is available in alternative formats for persons with disabilities.



October 14, 2020

To: Md7, LLC Delilah Bruzee, Land Use 10590 W Ocean Air Drive, Suite 300 San Diego, CA 92130 (858) 799-0575 dbruzee@md7.com

From: **Conrad Prebys Trust** 5847 El Cajon Blvd San Diego, CA 92115

Re:	<b>Property Owner Letter of Authorization</b>
Site ID:	SD06471A
Site Address:	3910 Ingraham St, San Diego, CA, 92109
Parcel ID:	423-423-13-00

Dear Sir or Madam:

This is to certify that I, MIRIAN CASTO am the legal property owner of record, and hereby authorize Md7, LLC, as agent for T-Mobile West, LLC, to file the documents necessary to obtain the permit approvals for T-Mobile West, LLC to make modifications to its existing cell site located at 3910 Ingraham St, San Diego, CA, 92109.

By:

**Property Owner Signature** Anthorized tger


Name and Title

<u>Milein Castro - Director</u> of operations une and Title <u>19-540-9434 / 858-273-0733</u> ext 121 619-5-40-9434 Phone


13/200

10590 W. Ocean Air Drive, Suite 300 San Diego, CA 92130

Page 3	City of San Diego · Information Bulletin 620				May 2020
SD	-	City of San Diego velopment Services			anning ibution Form
Project Name: <b>3910 Ingraham St T</b> Community: <b>Pacifi</b>	<u>Mobile Bay Po</u> c Beach	ointe Apts CUF	Project Numbe P 678588	r:	
	log into Op	enDSD at <u>htt</u>	rmation (project ma <u>os://aca.accela.com/</u> the Project Number	<u>SANDIEGO</u> .	
<ul> <li>Vote to Appro</li> <li>Vote to Appro</li> <li>Vote to Appro</li> <li>Vote to Appro</li> <li>Vote to Deny</li> </ul>	ve with Condition		w endations ListedBelow	1	
# of Members Yes	)	# of Membe	rs No	# of Members Ab	ostain
14			0	0	
Conditions or Reco			ote, Lack of quorum, etc.	)	
NAME: Ed Gallagh	er				
TITLE: Chair, Deve	TITLE: Chair, Development Subcommittee			DATE: June 09,	2021
	Attach additic	onal pages if n	ecessary (maximum 3	attachments).	

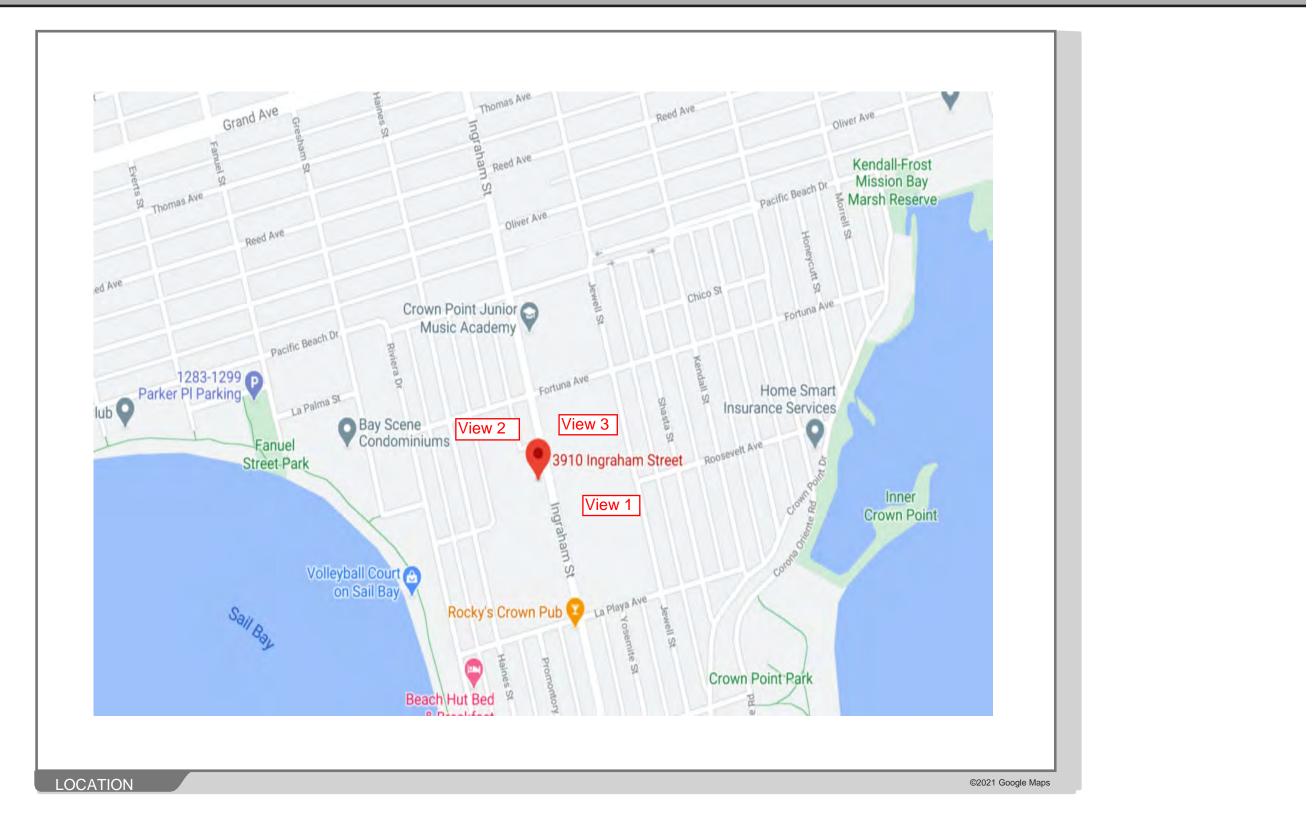



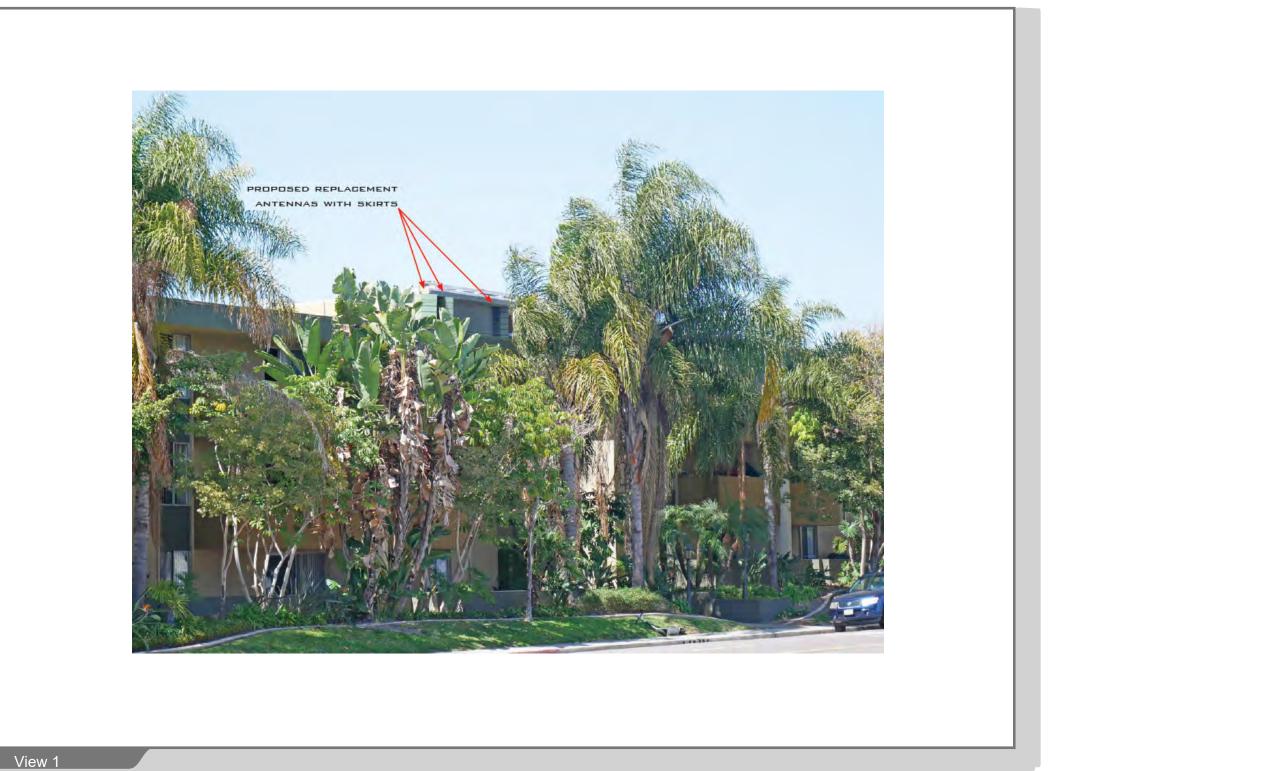













## SD06471A




3910 INGRAHAM STREET SAN DIEGO CA 92109

VIEW 1





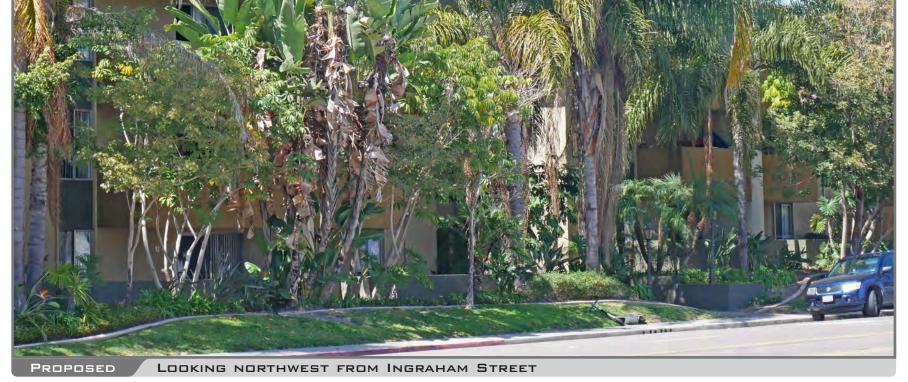




3910 INGRAHAM STREET SAN DIEGO CA 92109



VIEW 2

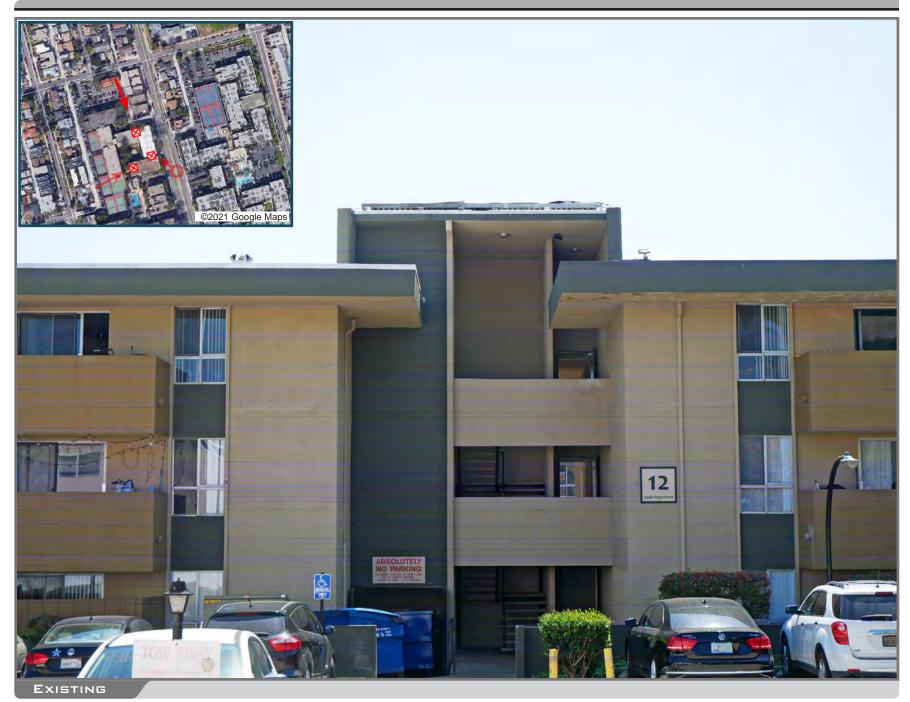





3910 INGRAHAM STREET SAN DIEGO CA 92109



VIEW 3



Existing

PROPOSED REPLACEMENT ANTENNAS BEHIND NEW REPLACEMENT SCREEN



PROPOSED

LOOKING NORTHEAST FROM SITE

# **T**Mobile

BAY POINTE APARTMENTS

SITE ADDRESS:

SITE NAME:

3910 INGRAHAM ST SAN DIEGO, CA 92109

SD06471A

ANCHOR

T-MOBILE SITE NUMBER:


PROJECT:


SITE TYPE: ROOF TOP


PROJECT INFORMATION	VICINITY MAP	DIRECTIONS	INDEX
SITE NAME:       BAY POINTE APARTMENT         SITE ADDRESS:       3910 INGRAHAM ST SAN DIEGO, CA 92109         COUNTY:       SAN DIEGO COUNTY         LATITUDE:       32' 47' 28.80" N (32.79133397')         LONGITUDE:       117' 14' 19.59" W (-117.23877700')         GROUND ELEVATION:       48.0' AMSL         STRUCTURE HEIGHT:       26'-6" (TOP OF BUILDING)         JURISDICTION:       CITY OF SAN DIEGO         PARCEL:       423-423-1300         ZONING:       KM-3-7         OCCUPANCY:       UNMANNED TELECOMMUNICATION FACILITY         CONSTRUCTION INFORMATION:       AREA OF CONSTRUCTION:         AREA OF CONSTRUCTION:       EXISTING/NO CHANGE         CONSTRUCTION TYPE:       N/A         PROPOSED USE:       UNMANNED TELECOMMUNICATIONS FACILITY         HANDICAP REQUIREMENTS:       FACILITY IS UNMANNED AND NOT FOR HUMAN HABITATION. HANDICAPPED ACCESS NOT REQUIRED         TOWER OWNER:       -	Elán Baylofts Apartments Elán Baylofts Apartme	DIRECTIONS TO SITE (FROM T-MOBILE10509, VISTA SORRENTO PARKWAY, SUITE 206 SAN DIEGO, CA 92121) HEAD NORTHWEST ON VISTA SORRENTO PKWY TOWARD LUSK BLVD TURN LEFT ON TO SORRENTO VALLEY BLVD TURN RIGHT ON TO ROSELLE ST TURN LEFT TO MERCE ON TO 1-5 S TAKE EXIT 23 TOWARD BALBOA AVE/GARNET AVE MERCE ON TO MISSION BAY DR TURN RIGHT ON TO GARNET AVE CONTINUE ON TO BALBOA AVE CONTINUE ON TO GRAND AVE TURN LEFT ON TO INGRAHAM ST DESTINATION WILL BE ON THE RIGHT	SHEET     DE       T-1     TITLE SHEET       T-2     GENERAL NOTES       A-1     SITE PLAN       A-1.1     ROOF PLAN       A-1.2     EQUIPMENT PLAN       RF-2     PROPOSED ANTENNA       RF-3     PLUMBING DIAGRAM       A-2.1     WEST ELEVATION       A-2.1     WEST ELEVATION       A-2.1     WEST ELEVATION       A-2.3     EAST ELEVATION       A-3     CONSTRUCTION DETA       A-4     CONSTRUCTION DETA
PROPERTY OWNER: 700 BAY POINTE LLC C/O PROGRESS MANAGEMENT 3866 INGRAHAM ST SAN DIEGO, CA 92109 APPLICANT: T-MOBILE USA, INC 10509 VISTA SORRENTO PARKWAY, SUITE 206 SAN DIEGO, CA 92121	Bay Pointe Apartments O	ACCESSIBILITY REQUIREMENTS FACILITY IS UNMANNED AND NOT FOR HUMAN HABITATION. HANDICAP ACCESS IS NOT REQUIRED PER CBC 2019 SECTION 11B-203.4 (LIMITED ACCESS SPACES) SECTION 11B-203.5 (MACHINERY SPACES)	A-5 CONSTRUCTION DETA A-6 CONSTRUCTION DETA A-7 CONSTRUCTION DETA A-8 CONSTRUCTION DETA A-9 CONSTRUCTION DETA A-10 CONSTRUCTION DETA
PROJECT TEAM	SCOPE OF WORK	APPROVALS	A-11 CONSTRUCTION DETAI
CONSTRUCTION MANAGER: T-MOBILE USA MIKE SEBESTA 10509 VISTA SORRENTO PKWY, SUITE 206 SAN DIEGO, CA 92121 PHONE: (760) 644-1027ARCHITECT & ENGINEERING MORRISON HERSHFIELD LESLIE BRADLEY 600 STEWART STREET SUITE 200 SEATTLE, WA 98101 PHONE: (206) 992-1684 Ibradley@morrisonhershfield.comSITE ACQUISITION AGENT: M07 JOHN STURGES 10590 WEST OCEAN AIR DRIVE, SUITE 300 SAN DIEGO, CA 92130 PHONE: (619) 947-0762ENGINEER: TO HAILE MORRISON HERSHFIELD CORP. PHONE: (503) 595-9128 thaile@morrisonhershfield.comZONING/PERMITTING AGENT: M07 JUSTIN CAUSEY 10590 WEST OCEAN AIR DRIVE, SUITE 300 SAN DIEGO, CA 92130 PHONE: (858) 291-1869ARCHITECT: ROBERT LARA MORRISON HERSHFIELD CORP. PHONE: (954) 577-4655MD7 JUSTIN CAUSEY 10590 WEST OCEAN AIR DRIVE, SUITE 300 SAN DIEGO, CA 92130 PHONE: (858) 291-1869FM CONCENTING AGENT: SON DIEGO, CA 92130 PHONE: (954) 577-4655MD7 JUSTIN CAUSEY 10590 WEST OCEAN AIR DRIVE, SUITE 300 SAN DIEGO, CA 92130 PHONE: (858) 291-1869FM CONCENTING AGENT: SON DIEGO, CA 92121	T-MOBILE PROPOSES TO MODIFY AN EXISTING UNMANNED TELECOMMUNICATIONS FACILITY WITH THE FOLLOWING: AT ANTENNA LEVEL • REMOVE (6) PANEL ANTENNAS • REMOVE (6) PANEL ANTENNAS • INSTALL (9) PANEL ANTENNAS • INSTALL (9) PANEL ANTENNAS • INSTALL (3) RRUS • ADD (2) 6x12 HCS 6AWG (2x30M) • ADD (4) 6x12 HCS 6AWG (2x30M) • ADD (2) 6x12 HCS 6AWG (2x30M) • ADD (4) 6x12 HCS 6AWG (2x30M) • REMOVE (6) SHROUDS • INSTALL (1) RF TRANSPARENT SCREEN WALL EXISTING EQUIPMENT TOTAL: • INSTALL (1) RF TRANSPARENT SCREEN WALL EXISTING EQUIPMENT TOTAL: • ATTENNAS: 6 • AT GRADE LEVEL RAUGON CABINET • INSTALL (1) PBC 6500 CABINET • INSTALL (1) BB6630 ON 19 INCH RACK PROPOSED EQUIPMENT TOTAL: • INSTALL (1) BB6643 ON 19 INCH RACK RADIOS: 3 • INSTALL (1) BB6648 ON 19 INCH RACK RADIOS: 3 • INSTALL (1) BB6648 ON 19 INCH RACK RADIOS: 3 • INSTALL (1) VOLTAGE BOOSTER PSU 4813 • PROJECT VALUATION: \$40,000 • NO PROPOSED BATTERY WORK DESIGN BASED ON: RFDS ANCHOR VERSION 6, DATED 12/14/2020 1:53:27 PM	APPROVAL     SIGNATURE     DATE       PROJECT MANAGER	E-2 GROUNDING DETAILS  CODE  ALL WORK AND MATERIALS SHALL ACCORDANCE WITH THE CURRENT ADOPTED BY THE LOCAL GOVERNIN IS TO BE CONSTRUED TO PERMIT  CALIFORNIA STATE AND LOCAL BUIL REFERENCE CODE:  2019 CALIFORNIA BUILDING C 2019 CALIFORNIA ENERGY CC 2019 CALIFORNIA ENERGY CC 2019 CALIFORNIA ELECTRICAL  CONTRACTOR TO CALL TO VER LEAST TWO WORKING DAYS PR  DO NOT SCALE DRA CONTRACTOR SHALL VERIFY ALL PL  CONTRACTOR SHALL VERIFY ALL PL  CONTRACTOR SHALL VERIFY ALL PL  MITING OF ANY DISCREPANCIES B WITH THE WORK OR BE RESPONSI

	<b>F</b> Mobile <sup>®</sup>						
	MD7 10590 WEST OCEAN AIR DRIVE SUITE 300 SAN DIEGO, CA 92130						
	PLANS PREPARED BY: MORRISON HERSHFIELD 600 STEWART STREET, SUITE 200 SEATTLE, WA 98101 Tel; 206,268,7370 www.morrisonhershfield.com MH PROJECT NUMBER: 203531900						
	REV. DATE ISSUED FOR BY						
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BUILDING CODES WITH THE FOLLOWING	SITE ADDRESS: 3910 INGRAHAM ST SAN DIEGO, CA 92109						
ICAL CODE (CMC) NG CODE (CPC) CODE (CEC) IDE (CFC)	SHEET NAME:						
VERIFY UTILITIES AT	TITLE SHEET						
PRAWINGS PLANS & EXISTING THE JOB SITE & SHALL TECT OR ENGINEER IN S BEFORE PROCEEDING NSIBLE FOR SAME. Know what's below. Call before you dig.	SHEET NUMBER: T-1						


ARCHITECTURAL GENERAL NOTES	ELECTRICAL GENERAL NOTES	ABBREVIATIONS	
<ol> <li>WORK SHALL COMPLY WITH ALL APPLICABLE CODES, ORDINANCES, AND REGULATIONS. ALL NECESSARY LICENSES, CERTIFICATES, ETC., REQUIRED BY AUTHORITY HAVING JURISDICTION SHALL BE PROCURED AND PAID FOR BY THE CONTRACTOR.</li> <li>THE GENERAL CONTRACTOR AND EACH SUBCONTRACTOR SHALL BE RESPONSIBLE FOR VERIFYING DIMENSIONS AND CONDITIONS AT THE JOB SITE WHICH COULD AFFECT THE WORK UNDER THIS CONTRACT. ALL MANUFACTURERS BEFCOMMENDED SEPCIFICATIONS EXCEPT THOSE SPECIFICATIONS HEREIN. WHERE MOST STRUCENTS HALL BE COMPLIED</li> </ol>	<ul> <li>A. GENERAL</li> <li>1. EXAMINE THE SITE CONDITIONS VERY CAREFULLY AND THE SCOPE OF PROPOSED WORK TOGETHER WITH THE WORK OF ALL OTHER TRADES AND INCLUDE IN THE BID PRICE ALL COSTS FOR WORK SUCH AS EQUIPMENT AND WIRING MADE NECESSARY TO ACCOMMODATE THE ELECTRICAL SYSTEMS SHOWN AND SYSTEMS OF OTHER TRADES.</li> </ul>	AGL ABOVE GROUND LEVEL GA GAUGE PLYWODD A/C AIR CONDITIONING GALV GALVANIZED PT PRESSURE TREATED APPROX APPROXIMATELY GC GENERAL CONTRACTOR PROJ PROJECT AZ AZIMUTH GRND GROUND PROP PROPERTY GYP BD GYPSUM WALL BOARD (P) PROPOSED BLDG BUILDING HT HEIGHT OTY OILANITY	<b>F</b> Mobile <sup>®</sup>
<ul> <li>CONDITIONS AT THE JOB SITE WHICH COULD AFFECT THE WORK UNDER THIS CONTRACT. ALL MANUFACTURERS SPECTRATIONS, EXCENT THOSE SPECIFICATIONS FLEXEN, WHERE MOST STRINGENT SHALL BE COMPLET WITH.</li> <li>THE CONTRACTOR SHALL VERIFY THAT NO CONFLICTS EXIST BETWEEN THE LOCATIONS OF ANY AND ALL MECHANICAL, ELECTRICAL, PLUMBING, OR STRUCTURAL ELEVENTS, AND THAT ALL REQUIRED CLEARANCES FOR INSTALLATION AND MAINTEMANCE ARE MET. NOTIFY THE CONSULTAT OF ANY CONFLICTS. THE CONSULTAT THAS THE RIGHT TO MAKE MINOR MODIFICATIONS IN THE DESIGN OF THE CONTRACT WITHOUT THE CONTRACTOR GETIMA DUDITIONAL COMPENSATION.</li> <li>THE CONTRACTOR SHALL BE RESPONSIBLE FOR DAILY CLEAN UP OF ALL TRADES AND REMOVE ALL DEBRIS FROM THE CONSTRUCTION STICE THE CONSULTATION OF THE PROJECT, THE CONTRACTOR SHALL THOROUGHLY CLEAN THE BUILDING, STE, AND ANY OTHER SURROUNDING AREAS TO A BETTER THAN NEW CONDITION.</li> <li>THE CONTRACTOR IS RESPONSIBLE FOR ONE CONDITION, IT SHALL APPLY FOR ALL LIKE OR SIMULAR CONDITION ADAINS THE ANAGE, BEAKAGE, COLLAPSE, ETC. ACCORDING TO APPLICABLE CODES, STANDARDS, AND GOOD CONSTRUCTION PRACTICES.</li> <li>WHERE NEW PAYING, CONCRETE SIDEMALKS OR PATHS MEET EXISTING CONSTRUCTION, THE CONTRACTOR SHALL MARC CONDITIONS, EVEN THOUGH NOT SPECIFICALLY MARKED ON THE DRAWINGS OR REFERRED TO IN THE SPECIFICATIONS, UNLESS NOTED OTHERWISE.</li> <li>WHERE NEW PAYING, CONCRETE SIDEMALKS OR PATHS MEET EXISTING CONSTRUCTION, THE CONTRACTOR SHALL MATCH THE POWER COMPANY.</li> <li>IF THE POWER COMPANY IS UNABLE TO PROVIDE THE POWER CONSTRUCTION, THE CONTRACTOR SHALL MATCH THE POWER COMPANY.</li> <li>IF THE POWER COMPANY IS UNABLE TO PROVIDE THE EXISTING CONSTRUCTION, THE CONTRACTOR SHALL MATCH THE POWER COMPANY.</li> <li>IF THE POWER COMPANY IS UNABLE TO PROVIDE THE EXISTING CONSTRUCTION, THE CONTRACTOR SHALL MATCH THE POWER COMPANY.</li> <li>IF THE POWER COMPANY IS UNABLE TO PROVIDE THE WORK ROUTH THE POWER COMPANY.</li> <li>IF THE POWER COMPANY IS UNABLE TO PROVIDE THE CONTRACTOR SHALL MARE ASSOCIAD STRUCTIONS AND SPECIFICATIO</li></ul>	<ol> <li>OBTAIN ALL PERMITS, PAY ASSOCIATED FEES AND SCHEDULE INSPECTION.</li> <li>PROVIDE ALL LACOR, MATERIAL, EQUIPMENT, INSURANCE, AND SERVICES TO COMPLETE THIS PROJECT IN ACCORDANCE WITH THE CONTRACT DOCUMENTS AND PRESENT IT AS FULLY OPERATIONAL TO THE SATISFACTION OF T-MOBILE &amp; LAND/TOWER OWNER</li> <li>PRIOR TO BEGINNING WORK COORDINATE ALL POWER AND TELCO WORK WITH THE LOCAL UTILITY COMPANY AS IT MAY APPLY TO THIS SITE. ALL WORK TO COMPLY WITH THE RULES AND REGULATIONS OF THE UTILITIES INVOLVED GENERAL CONTRACTOR IS RESPONSIBLE FOR YED. REQUESTING COMPLAY WITH THE GENERAL CONTRACTOR.</li> <li>FABRICATION AND INSTALLATION OF THE COMPLETE ELECTRICAL SYSTEM SHALL BE DONE IN A PRIST CLASS WORKMANDHIP PER INCE STANLATION OF THE COMPLETE ELECTRICAL. SYSTEM SHALL BE DONE IN A INSTALLATION AND OT TAGED STANL COORDNATE THIS WORK WITH THE GENERAL CONTRACTOR.</li> <li>FABRICATION AND INSTALLATION OF THE COMPLETE ELECTRICAL SYSTEM SHALL BE DONE IN A INFET CLASS WORKMANDHIP PER INCE STANLATION OF THE 2000 EF 01 QUILIFED PERSONEL EXPERIENCED IN SUCH WORK AND SHALL SCHEDULE THE WORK IN AN ORDERLY MANNER SO AS NOT TO IMPEDE PROGRESS OF THE PROJECT.</li> <li>BASIC MATERIALS AND METHODS</li> <li>ALL ELECTRICAL WORK SHALL CONFORM TO THE EDITION OF THE NEC ACCEPTED BY THE LOCAL JURISDICTION AND TO THE APPLICABLE LOCAL CODES AND REGULATIONS.</li> <li>ARRANGE CONDUIT, WIRING EDITION OF THE WORK OBLERATLY AS SHOWN, PROVIDING PROPER CLEARANCES AND ACCESS, CAREPULLY EXAMINE ALL SOUTHERS ARE PROPOSED BECAUSE OF FIELD CONDUTIONS OR OTHER CAUSES, PREFAREA AND SUBMIT TO BRAILE DEVENTION WITHOUT SUBSTANTIAL ALTERATION, WERKE DEFARTURES ARE PROPOSED BECAUSE OF FIELD CONDUTIONS OR OTHER CAUSES, PREFARE AND SUBMIT AND AROUND. REVOVE ALL SOUTH REVEAL MOSTING TO A DEAL OSCITANCE.</li> <li>THE CONTRACT DRAWINGS ARE GENERALLY DARGRAMATIC AND ALL OFFSETS, BENDS, FITTINGS AND ACCESSORIES ARE NOT MACCESSARILY SHOWN, PROVOE ALL SUCH THERE AS ANY BE REQUIRED IN FIT HE WORK TO THEE CONDITONS.</li> <li>SEAL</li></ol>	BLDG     BULDING     HT     HEIGHT     QTY     QUANITY       CLC     CEULING     HT     HCGUT     GTY     QUANITY       CC     CEULING     HT     HCGUT     FEGUIRED     FEGUIRED       QC     CENTERINE     HOZ     HOZ     FEGUIRED     FEW     ROW       CONC     CELER     HR     HOUR     ROW     ROUGH OPENING       CONST     CONSTRUCTION     IN     INCH     SHT     SHET       DET     DETAIL     INFO     INFO     INFO     SHT     SHET       DIA     DIAMETER     INT     INTERIOR     SF     SQUARE FOOT       DIA     DIAMETER     IBC     INTERIOR     STUD     STUD     STUD       DIA     DIAMETER     IBC     INTERIOR     STUD     STUD     STUD       DIA     DIAMETER     IBC     INTERIOR     STUD     STUD     STUD       DIM     DOWN     MCR     MARAER     SUSPENDED     STUD     STUD     STUD       DIN     DOWN     MCR     MARAER     SUSPENDED     SUSPENDED     SUSPENDED       EA     EACH     MAX     MAXMAM     THRU     TINRED     INNED       ELCC     ELEVATION     MT     MICA<	INCOMPOSED BY DESIGN PROFESSIONAL A 10/09/20 90% REVIEW GD 0 12/23/20 100% CONSTRUCTION MLG 1 05/27/21 JX COMMENTS JR SET NOT TO BE USED FOR CONSTRUCTION ULCENSURE:
COMPOUND NOTES	GROUND RING SHALL BE THE PARALLEL TYPE, EXCEPT FOR THE GROUND RODS WHICH ARE TEE EXOTHERMIC WELDS. REPAIR ALL GALVANIZED SURFACES THAT HAVE BEEN DAMAGED BY EXOTHERMIC WELDING. USE SPRAY GALVANIZER SUCH AS HOLUB LECTROSOL #15-501. <b>PROJECT INFORMATION</b>	IMPORTANT NOTICE	EXP.9.30.21 H* CANAL STATE OF CALIFORNIA 05/27/2021 1:54PM
<ol> <li>CONTRACTOR AND SUBCONTRACTORS SHALL VERIFY ALL UTILITY SERVICE CONNECTION LOCATIONS PRIOR TO SUBMITTING BID AND PROCEEDING WITH WORK. IT IS RECOMMENDED THAT THE CONTRACTOR VISIT THE SITE AND VERIFY ALL DIMENSIONS AND NOTES BEFORE SUBMITTING BID AND PROCEEDING WITH WORK.</li> <li>SOIL AT THIS SITE IS UNDISTURBED ROCK AND SAND ADEQUATE OF SUPPORTING THE DESIGN LOAD OF 2000 P.S.F. IF OTHER CONDITIONS ARE ENCOUNTERED, NOTIFY MORRISON HERSHFIELD BEFORE PROCEEDING WITH WORK. THIS VALUE IS CONSIDERED SAFE WITH RESPECT TO ACTUAL FAILURE OF THE SUPPORTING GROUND, BUT DOES NOT NECESSARILY ENSURE THE PREVENTION OF EXCESSIVE FOUNDATION MOVEMENTS.</li> <li>IN ORDER TO AVOID ANY CONFLICTS, CONTRACTOR SHALL COORDINATE ALL HIS PRACTICAL TRADES.</li> <li>THE POWER CABINET MUST BE CLEAR OF FLAMMABLE MATERIAL WITHIN 12 INCHES OF THE CABINET, INCLUDING ABOVE</li> </ol>	<ol> <li>THIS IS AN UNMANNED AND RESTRICTED ACCESS EQUIPMENT AND WILL BE USED FOR THE TRANSMISSION OF RADIO SIGNALS FOR THE PURPOSE OF PROVIDING PUBLIC CELLULAR SERVICE.</li> <li>THIS FACILITY WILL CONSUME NO UNRECOVERABLE ENERGY.</li> <li>NO POTABLE WATER SUPPLY IS TO BE PROVIDED AT THIS LOCATION.</li> <li>NO WASTE WATER WILL BE GENERATED AT THIS LOCATION.</li> <li>NO SOLID WASTE WILL BE GENERATED AT THIS LOCATION.</li> <li>NO SOLID WASTE WILL BE GENERATED AT THIS LOCATION.</li> <li>T-MOBILE MAINTENANCE CREW (TYPICALLY ONE PERSON) WILL MAKE AN AVERAGE OF ONE TRIP PER MONTH AT ONE HOUR PER VIST.</li> </ol>	THE EXISTING CONDITIONS REPRESENTED HEREIN ARE BASED ON VISUAL OBSERVATIONS AND INFORMATION PROVIDED BY OTHERS. MORRISON HERSHFIELD CORPORATION CANNOT GUARANTEE THE CORRECTNESS NOR COMPLETENESS OF THE EXISTING CONDITIONS SHOWN AND ASSUMES NO RESPONSIBILITY THEREOF. CONTRACTOR AND HIS SUB-CONTRACTORS SHALL VISIT THE SITE AND VERIFY ALL EXISTING CONDITIONS AS REQUIRED FOR PROPER EXECUTION OF PROJECT. REPORT ANY CONFLICTS OR DISCREPANCIES TO THE CONSULTANT PRIOR TO CONSTRUCTION.	SITE NAME: BAY POINTE APARTMENT T-MOBILE SITE I.D. SD06471A
THE CABINET. 5. THE POWER CABINET MUST BE MOUNTED ON THE FOUNDATION TO ALLOW WATER TO DRAIN FROM THE DRAIN OUTLET AND AWAY FROM THE CABINET.		LEGEND	SDU047TA
6. TO ENSURE SERVICEABLE ABILITY, THE DOORS OF CABINETS WILL REQUIRE AN OPENING RADIUS OF 36 INCHES OF CLEARANCE FROM THE CLOSED POSITION TO THE OPEN POSITION.	<b>SITE GENERAL NOTES</b> <ol> <li>restore existing asphalt and/or concrete compound to it's original condition.</li> <li>contractor shall detect and mark any underground lines, piping, prior to start of excavation.</li> </ol>	BUILDING/WALL/DETAIL SECTION LARGE SCALE DETAIL DETAIL NUMBER DETAIL NUMBER MHERE DETAILED REFERENCE ELEVATION DETAIL BUG	3910 INGRAHAM ST SAN DIEGO, CA 92109 SHEET NAME: GENERAL NOTES
		LELEVATION DETAIL BOG DETAIL NUMBER DRAWING DRAWING	SHEET NUMBER: T-2

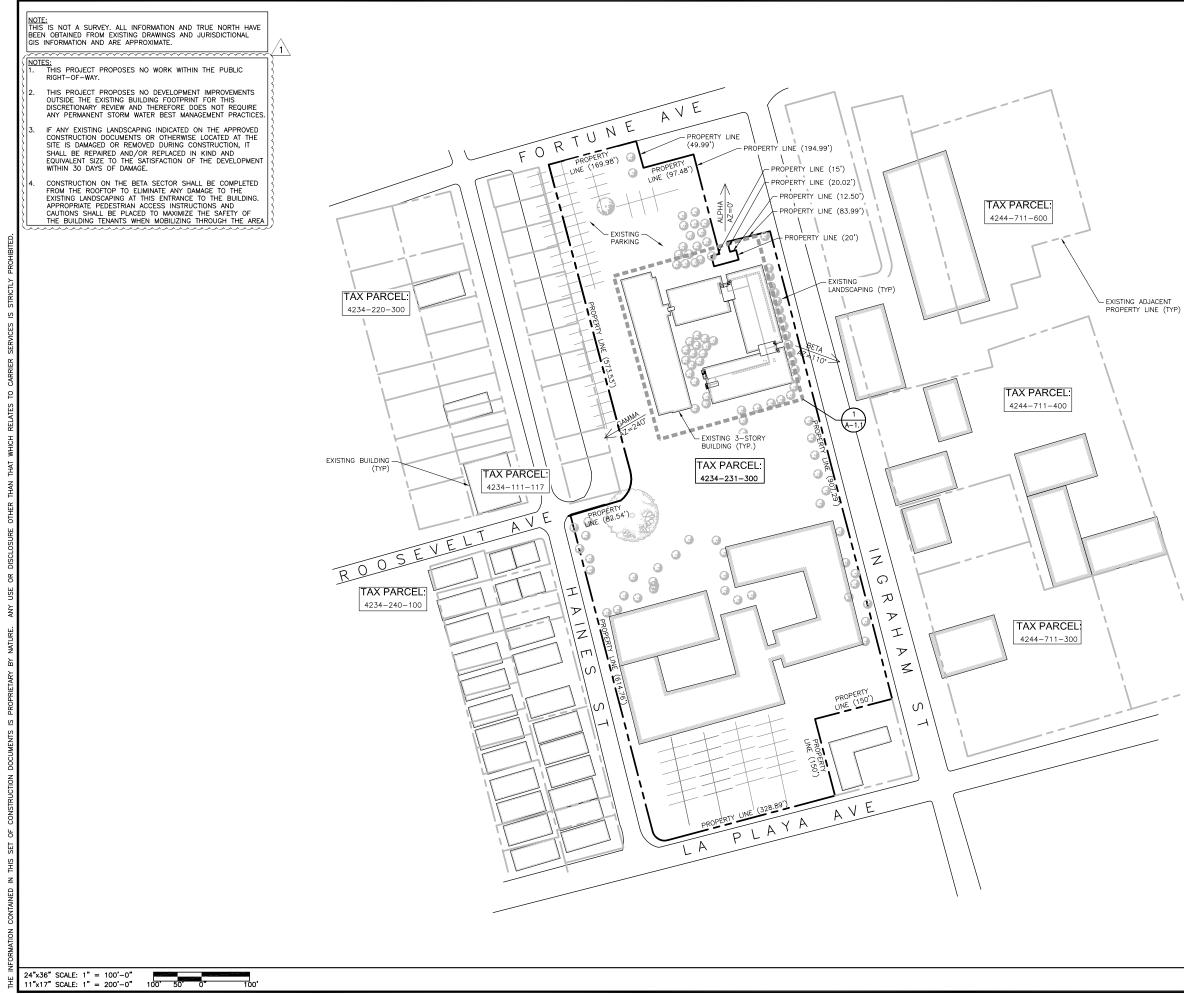

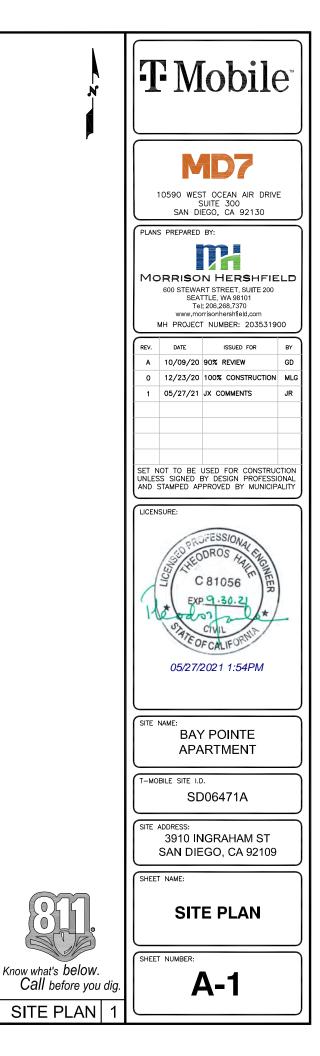


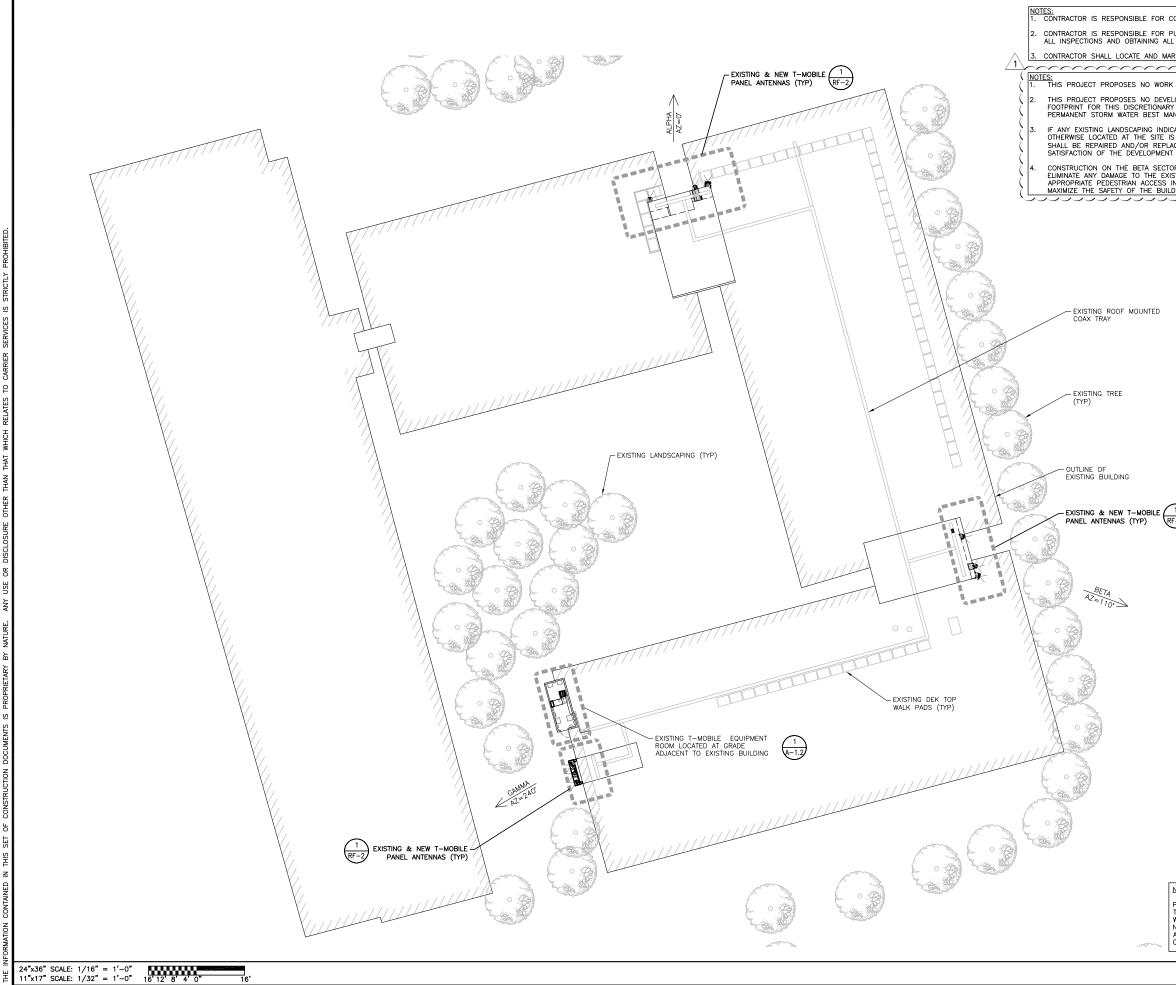

COMPLYING WITH ALL FEDERAL, STATE AND LOCAL CODES PULLING ALL REQUIRED PERMITS AND ARRANGING FOR LL APPROVALS IARK ANY UNDERGROUND UTILITIES PRIOR TO EXCAVATION RK WITHIN THE PUBLIC RIGHT-OF-WAY.	
ELOPMENT IMPROVEMENTS OUTSIDE THE EXISTING BUILDIN RY REVIEW AND THEREFORE DOES NOT REQUIRE ANY MANAGEMENT PRACTICES. IICATED ON THE APPROVED CONSTRUCTION DOCUMENTS OF IS DAMAGED OR REMOVED DURING CONSTRUCTION, IT LACED IN KIND AND EQUIVALENT SIZE TO THE TWITHIN 30 DAYS OF DAMAGE. TOR SHALL BE COMPLETED FROM THE ROOFTOP TO KISTING LANDSCAPING AT THIS ENTRANCE TO THE BUILDING INSTRUCTIONS AND CAUTIONS SHALL BE PLACED TO LDING TENANTS WHEN MOBILIZING THROUGH THE AREA N	R ND7 10590 WEST OCEAN AIR DRIVE SUITE 300
1 RF-2	A 10/09/20 90% REVIEW GD 0 12/23/20 100% CONSTRUCTION MLG 1 05/27/21 JX COMMENTS JR SET NOT TO BE USED FOR CONSTRUCTION UNLESS SIGNED BY DESIGN PROFESSIONAL AND STAMPED APPROVED BY MUNICIPALITY LICENSURE: C 81056 EXP. 9.30.2 C 81056 EXP. 9.30 C 81056 EXP. 9.30 EXP. 9.30 EXP. 9.30 EXP. 9.30 EXP
	SITE NAME: BAY POINTE APARTMENT T-MOBILE SITE I.D. SD06471A SITE ADDRESS: 3910 INGRAHAM ST SAN DIEGO, CA 92109 SHEET NAME:
NOTES: PLAN INFORMATION CONTAINED HEREIN IS TAKEN FROM THE DOCUMENTS PROVIDED BY CLIENT. NEITHER WARRANTY NOR GUARANTEE IS GIVEN BY THE ARCHITECT NOR MORRISON HERSHFIELD CORPORATION TO THE ACCURACY NOR THE COMPLETENESS OF THE COPIED COMPOUND PLAN INFROMATION. ROOF PLAN	T SHEET NUMBER: A-1.1

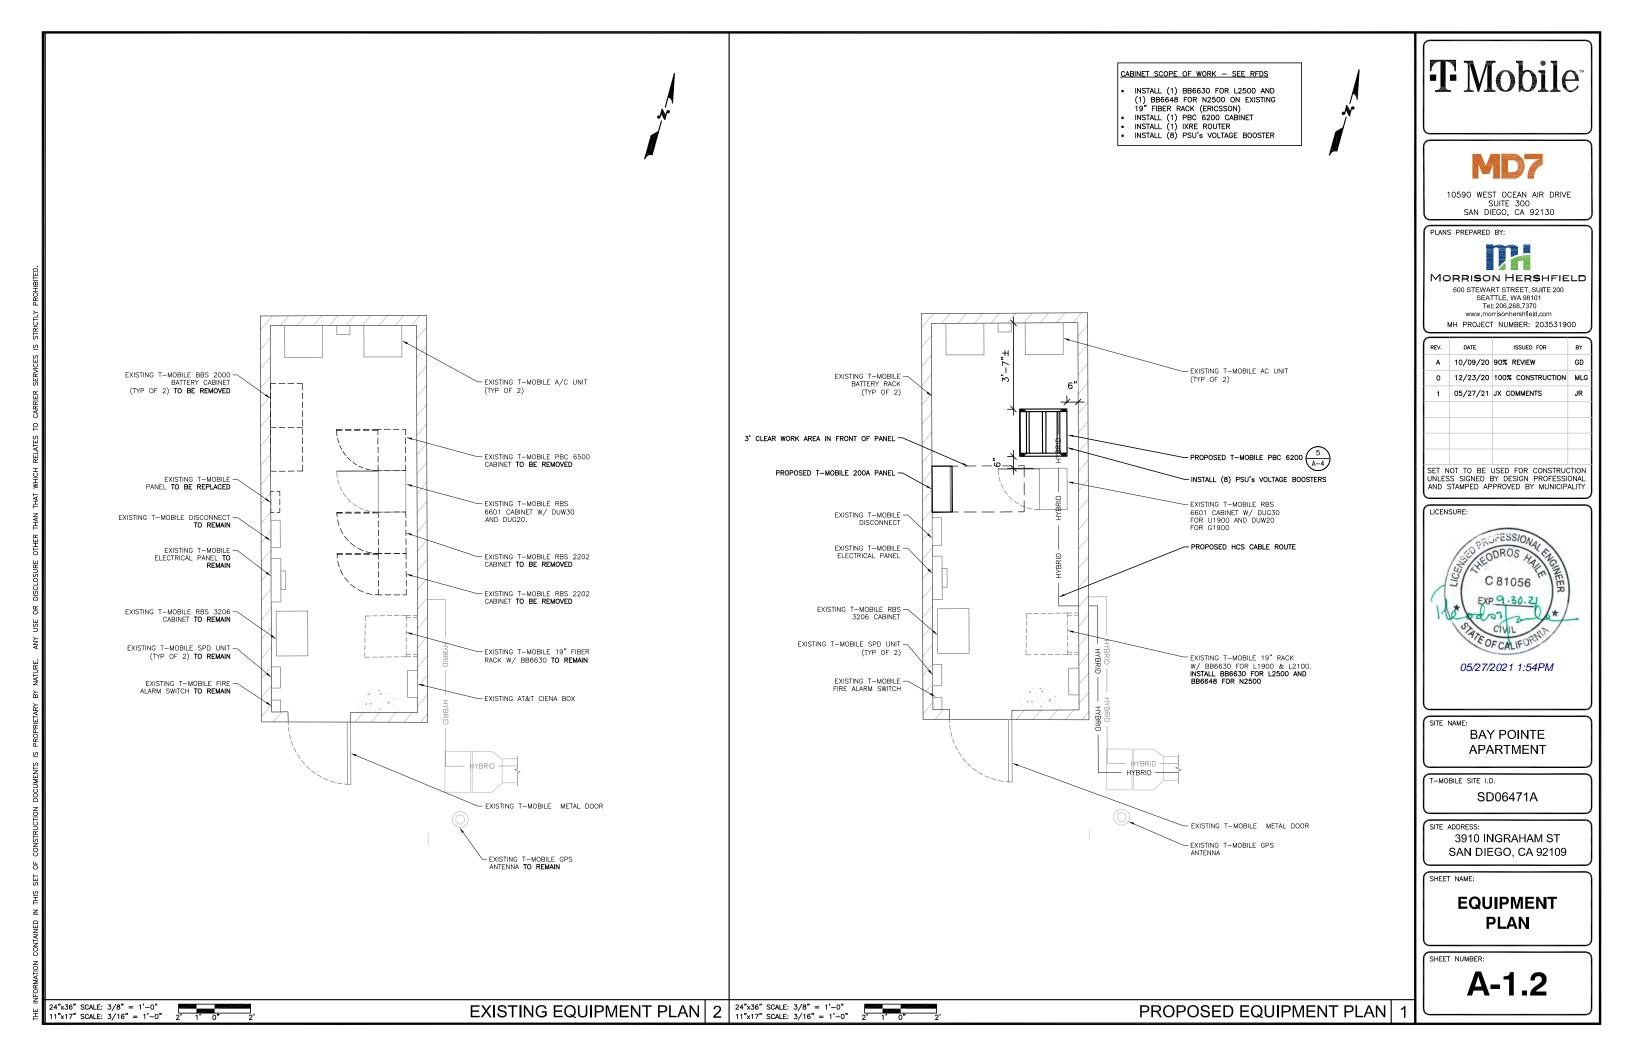


						EXISTING ANTENNA AND C	OAX	SCHEDUL	CHOR VERSION 6, DATED 1	2/14/2020	D 1:53:27 PM		
SECTOR ALPHA	TECH	AZIMUTH	RAD CENTER	NUMBER OF ANTENNAS	VENDOR	MODEL	elec Tilt	MECH DOWNTILT	FEEDER NUMBER & TYPE	FEEDER LENGTH	ADDITIONAL EQUIPMENT		
A1	U1900 G1900 U2100	0,	35'-5"	1	ERICSSON	AIR21 KRC118023-1_B2A_B4P (QUAD)	7 <b>.</b> 0'	0,	(2) 1-5/8" COAX (2) 1-5/8" LMU COAX (2) FIBER JUMPER (1) ERICSSON 3x6 HCS	375' 375' 16' 120M	(1) GENERIC TWIN STYLE 1B TMA (2) TRX RADIOS		
A2	L2100	0.	35'-5"	1	ERICSSON	AIR21 KRC 118023-1_B2P_B4A (QUAD)	7'	0.	(1) FIBER JUMPER	16'			
SECTOR BETA	TECH	AZIMUTH	RAD CENTER	NUMBER OF ANTENNAS	VENDOR	MODEL	elec Tilt	MECH DOWNTILT	FEEDER NUMBER & TYPE	FEEDER LENGTH	ADDITIONAL EQUIPMENT		
B1	U1900 G1900 U2100	110	32'-10"	1	ERICSSON	AIR21 KRC118023-1_B2A_B4P (QUAD)	0' 2'	0.	(2) 1-5/8" COAX (2) 1-5/8" LMU COAX (2) FIBER JUMPER (1) ERICSSON 3x6 HCS	217' 217' 16' 70M	(1) GENERIC TWIN STYLE 1B TMA (4) TRX RADIOS		
B2	L2100	110'	32'-10"	1	ERICSSON	AIR21 KRC 118023-1_B2P_B4A (QUAD)	0. 0.		(1) FIBER JUMPER 16'				
SECTOR GAMMA	TECH	AZIMUTH	RAD CENTER	NUMBER OF ANTENNAS	VENDOR	MODEL	elec Tilt	MECH DOWNTILT	FEEDER NUMBER & TYPE	FEEDER LENGTH	ADDITIONAL EQUIPMENT		
C1	U1900 G1900 U2100	240	33'-8"	1	ERICSSON	AIR21 KRC118023-1_B2A_B4P (QUAD)	0' 5'	0.	<ul> <li>(2) 7/8" COAX</li> <li>(2) 7/8" LMU COAX</li> <li>(2) FIBER JUMPER</li> <li>(1) ERICSSON 3x6 HCS</li> </ul>	93' 93' 16' 30M	(1) GENERIC TWIN STYLE 1B TMA (2) TRX RADIOS		
C2	L2100	240'	33'-8"	1	ERICSSON	AIR21 KRC 118023-1_B2P_B4A (QUAD)	5'	0.	(1) FIBER JUMPER	16'			

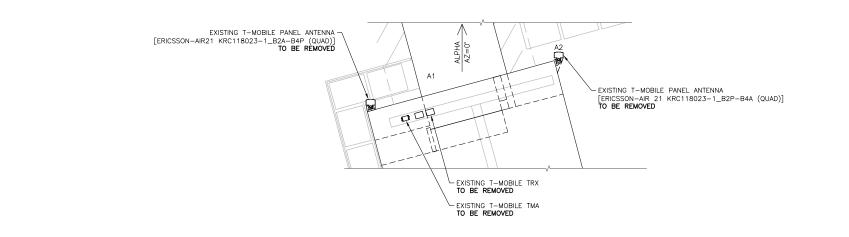




-1_B2A_B4P (QUAD)] SITE NAME: BAY POINTE APARTMENT T-MOBILE SITE I.D. SD06471A SITE ADDRESS: 3910 INGRAHAM ST SAN DIEGO, CA 92109 TING ANTENNAS)							
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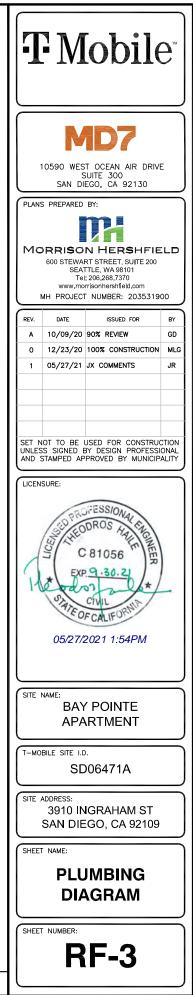
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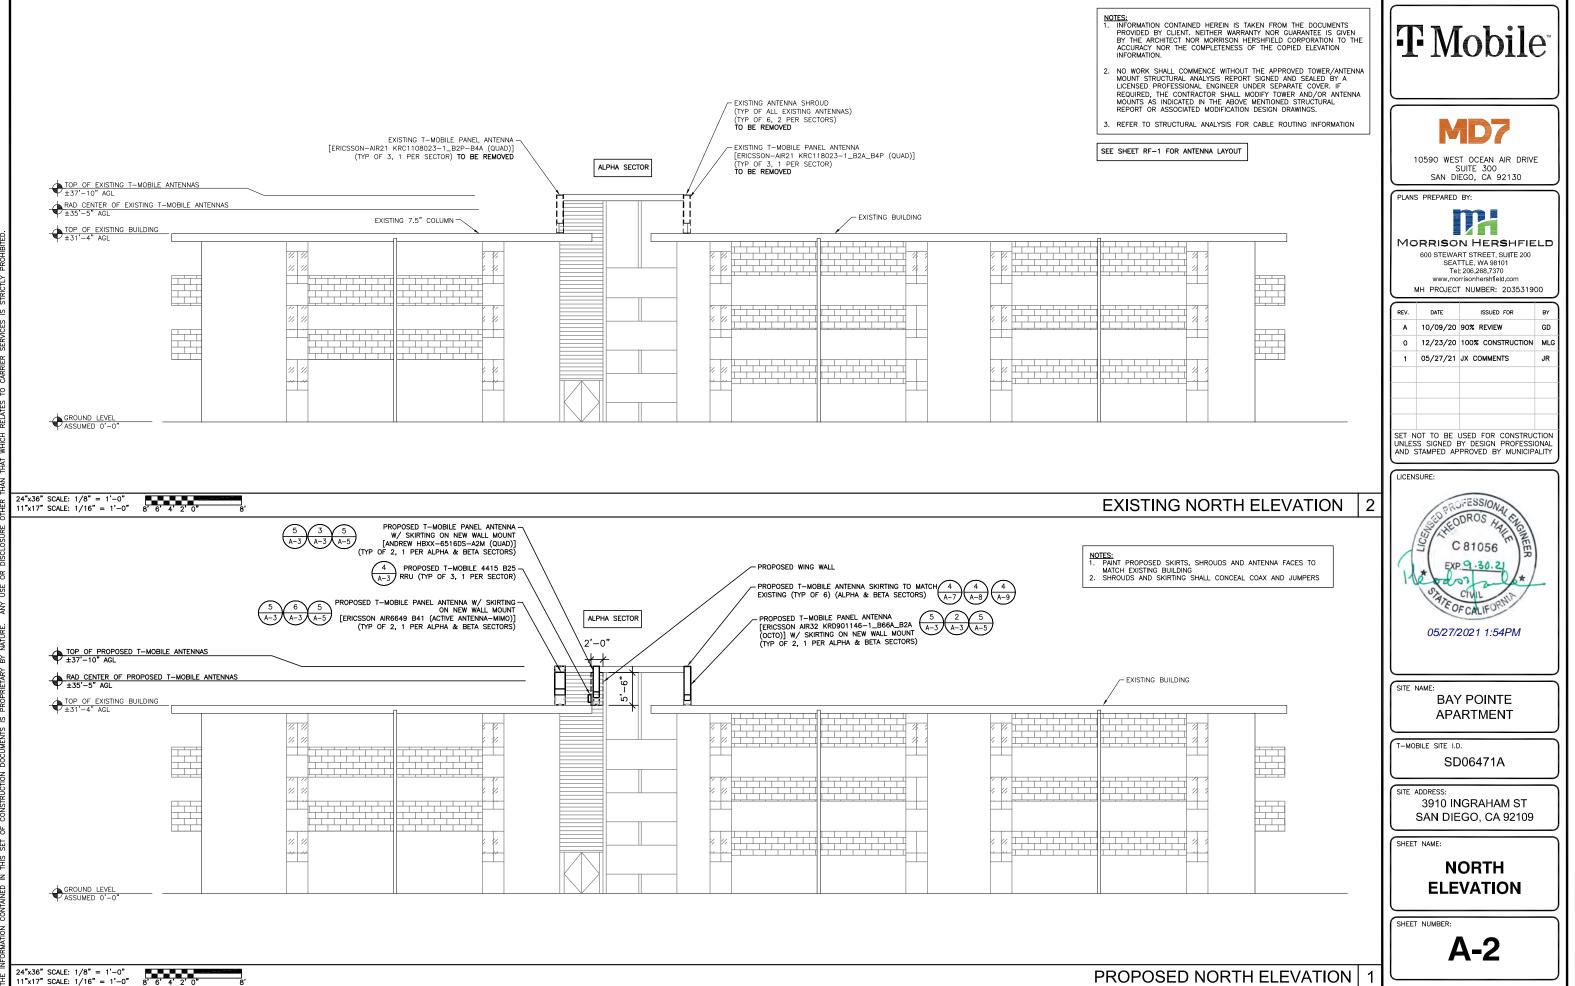
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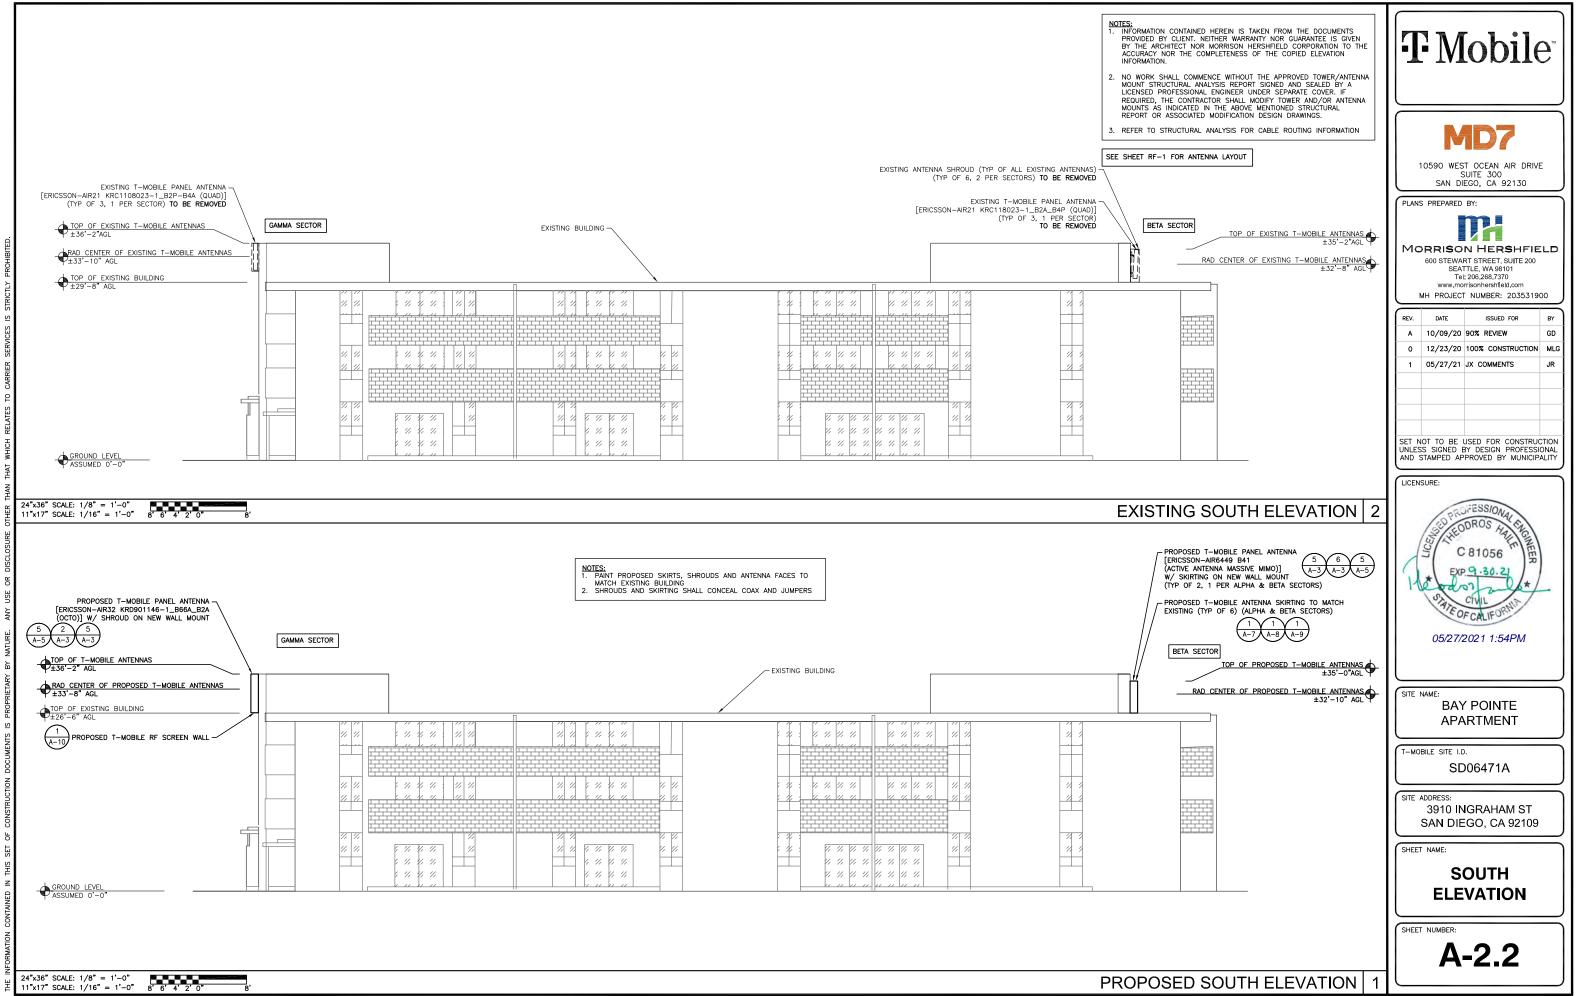


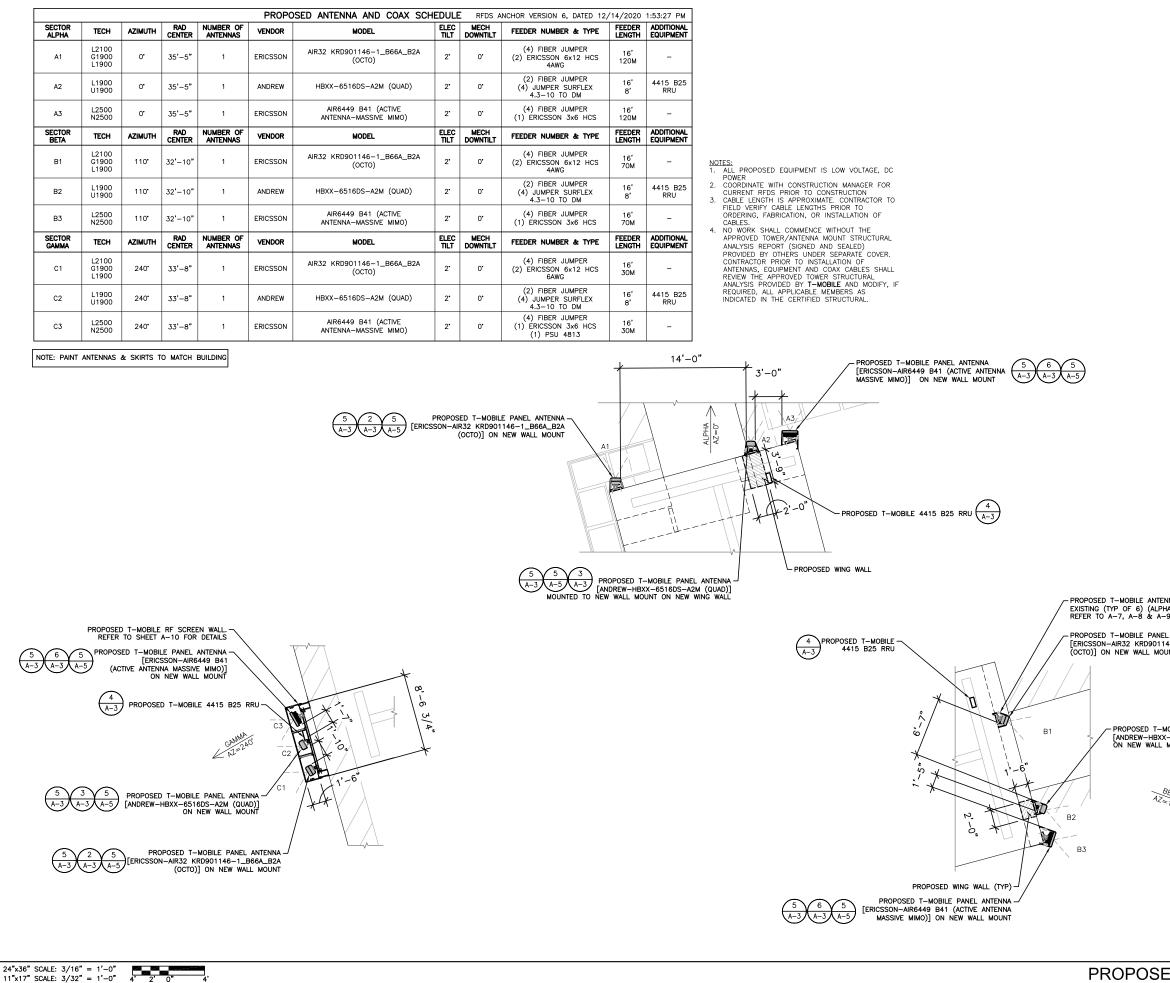
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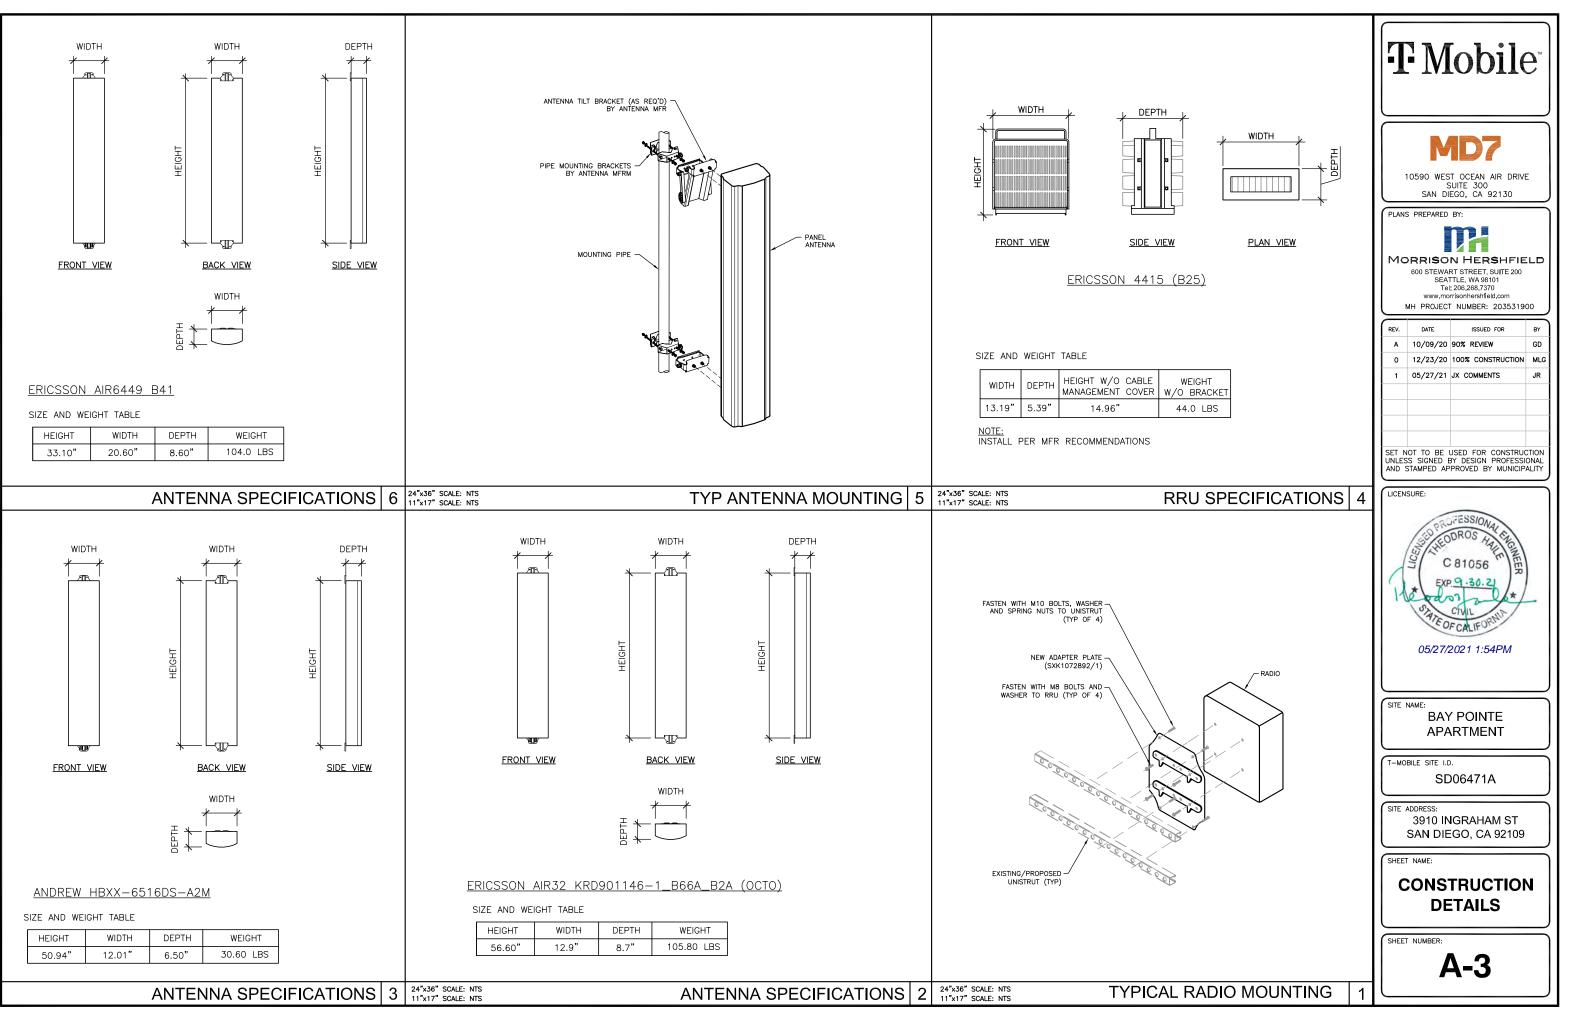



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	RAD_CENTER OF EXISTING T-MOBILE ANTENNAS +33"-8" AGL TOP OF EXISTING BUILDING +229"-8" AGL	
24"x36" SCALE: 1/8" = 1'-0" 11"x17" SCALE: 1/16" = 1'-0" 8' 6' 4' 2' 0"	€ROUND LEVEL ASSUMED 0'-0"	EXIS
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CONTAINED HEREIN IS TAKEN FROM THE DOCUMENTS CLIENT. NEITHER WARRANTY NOR GUARANTEE IS GIVEN TECT NOR WORRISON HERSHFIELD CORPORATION TO THE R THE COMPLETENESS OF THE COPIED ELEVATION **T** Mobile ALL COMMENCE WITHOUT THE APPROVED TOWER/ANTENNA TURAL ANALYSIS REPORT SIGNED AND SEALED BY A DFESSIONAL ENGINEER UNDER SEPARATE COVER. IF JE CONTRACTOR SHALL MODIFY TOWER AND/OR ANTENNA NDICATED IN THE ABOVE MENTIONED STRUCTURAL SSOCIATED MODIFICATION DESIGN DRAWINGS. MD7 UCTURAL ANALYSIS FOR CABLE ROUTING INFORMATION FOR ANTENNA LAYOUT 10590 WEST OCEAN AIR DRIVE SUITE 300 SAN DIEGO, CA 92130 PLANS PREPARED BY: P MORRISON HERSHFIELD 600 STEWART STREET, SUITE 200 SEATTLE, WA 98101 Tel: 206.268.7370 www.morrisonhershfield.com MH PROJECT NUMBER: 203531900 REV. DATE ISSUED FOR BY GD A 10/09/20 90% REVIEW 0 12/23/20 100% CONSTRUCTION MLG 1 05/27/21 JX COMMENTS JR SET NOT TO BE USED FOR CONSTRUCTION UNLESS SIGNED BY DESIGN PROFESSIONAL AND STAMPED APPROVED BY MUNICIPALITY LICENSURE: ING WEST ELEVATION FESSION 2 FODROS HALL C 81056 EXP. 9.30.21 afraba SKIRTS, SHROUDS AND ANTENNA FACES TO BUILDING KIRTING SHALL CONCEAL COAX AND JUMPERS STATEOFCALIFOR 05/27/2021 1:54PM SITE NAME: BAY POINTE APARTMENT T-MOBILE SITE I.D. SD06471A SITE ADDRESS: 3910 INGRAHAM ST SAN DIEGO, CA 92109 SHEET NAME: WEST ELEVATION SHEET NUMBER: A-2.1 SED WEST ELEVATION 1







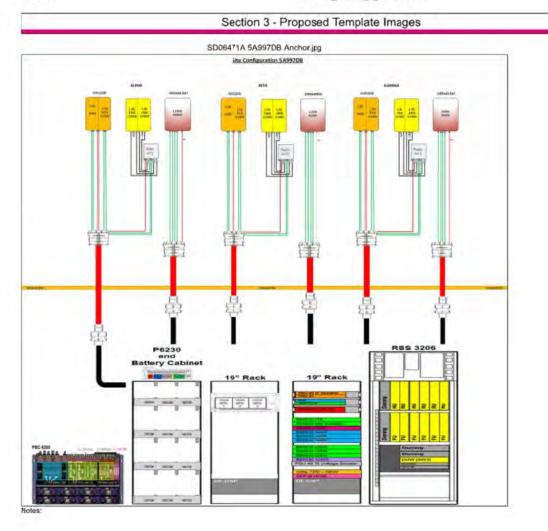


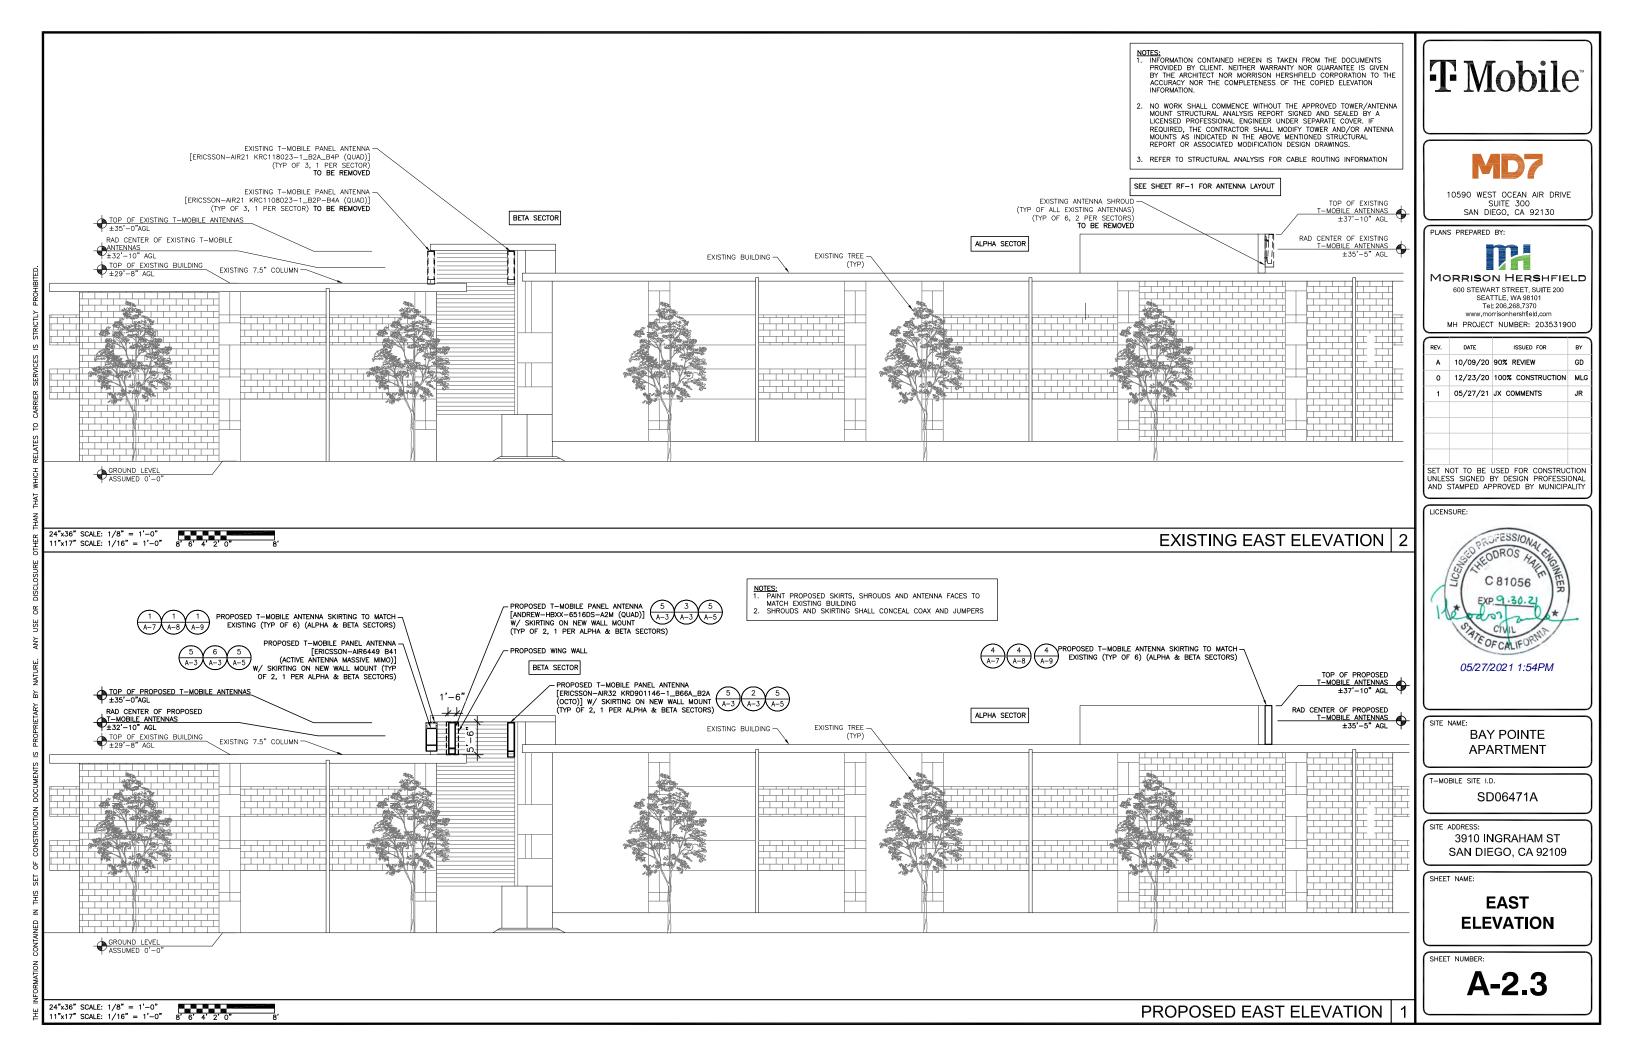


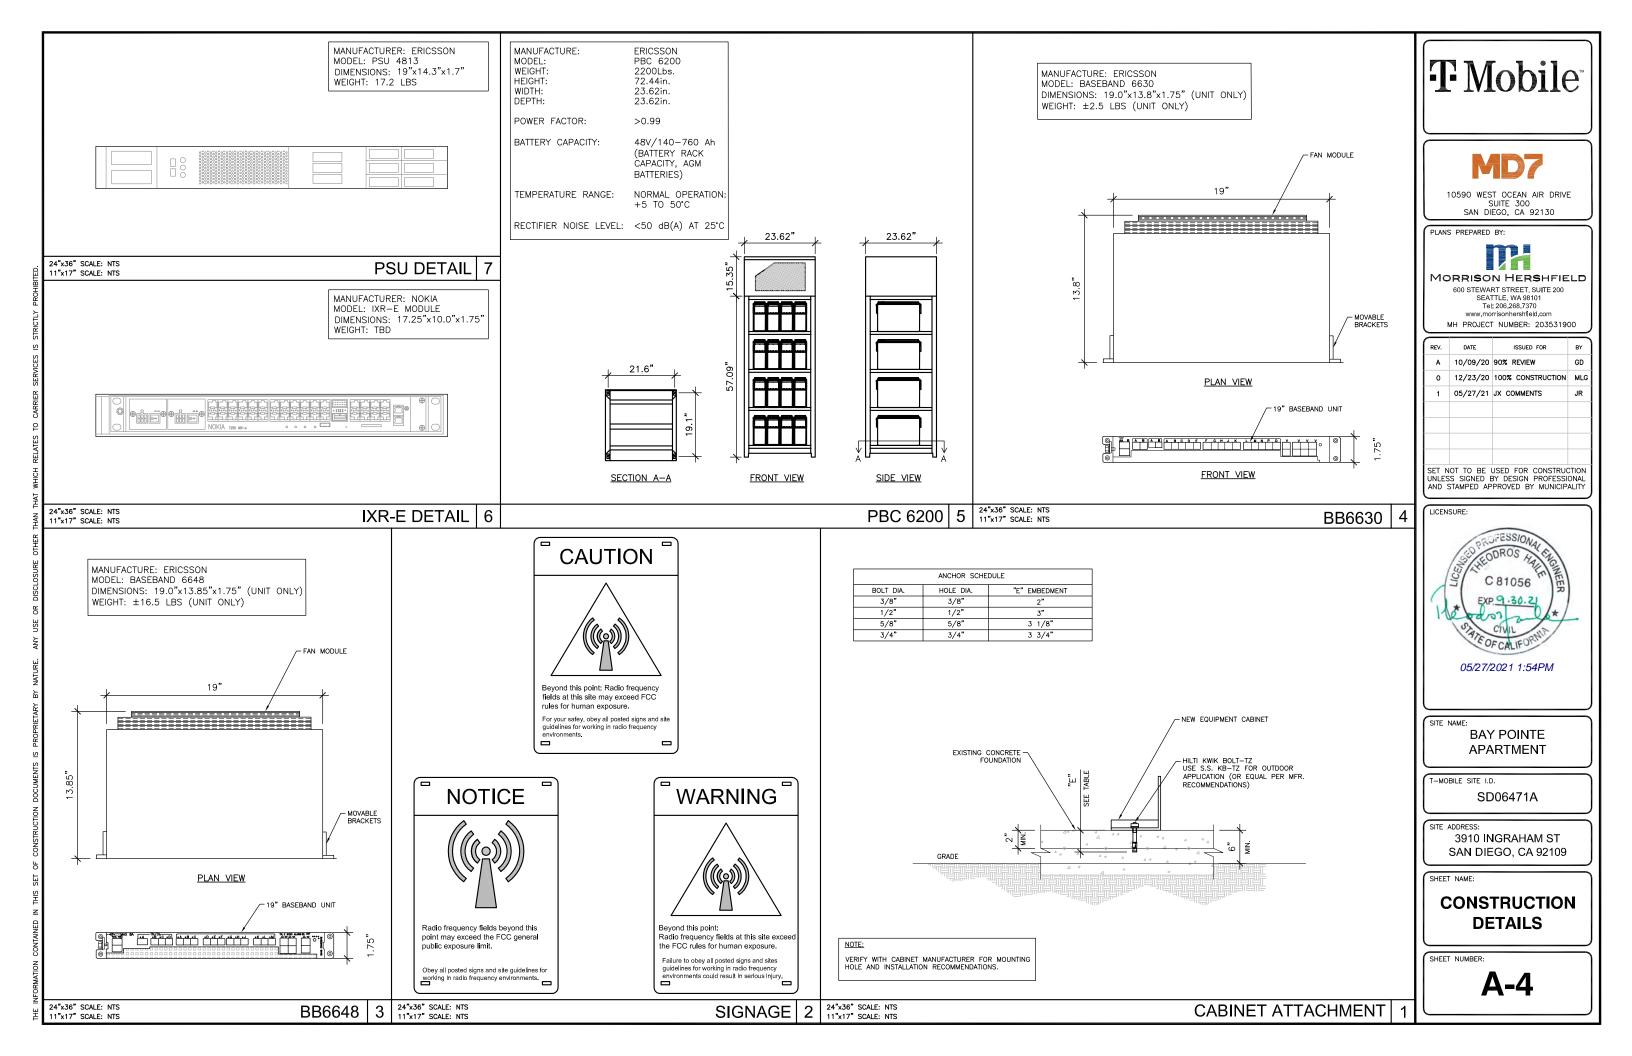
AT WHICH RELATES TO CARRIER SERVICES IS STRICTLY PROHIBITED.					
HAN THA	24"x36" SCALE: NTS 11"x17" SCALE: NTS		NOT USED 6	"x36" SCALE: NTS "x17" SCALE: NTS	
INFORMATION CONTAINED IN THIS SET OF CONSTRUCTION DOCUMENTS IS PROPRIETARY BY NATURE. ANY USE OR DISCLOSURE OTHER	24*X36* SCALE: NTS 11*X17* SCALE: NTS	D 4 24"x36" SCALE: NTS 11"x17" SCALE: NTS	NOT USED 3 24	"X36" SCALE: NTS "X17" SCALE: NTS	NOT USED 2 24"×36" SCALE: MTS ANT

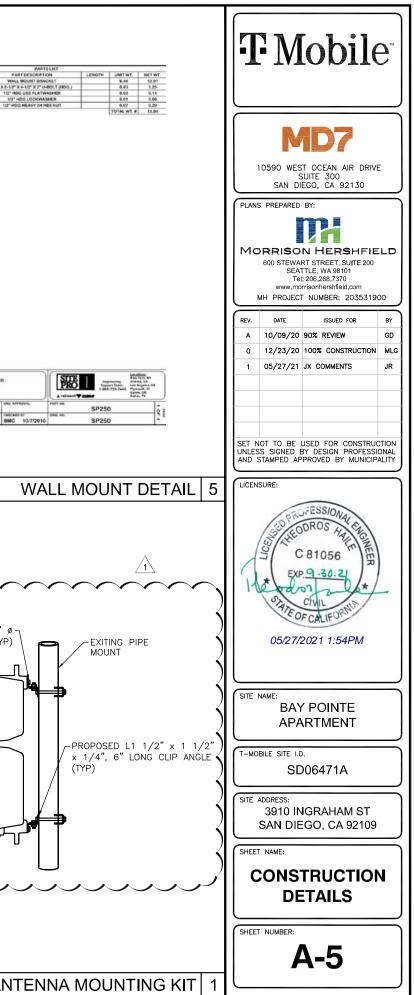


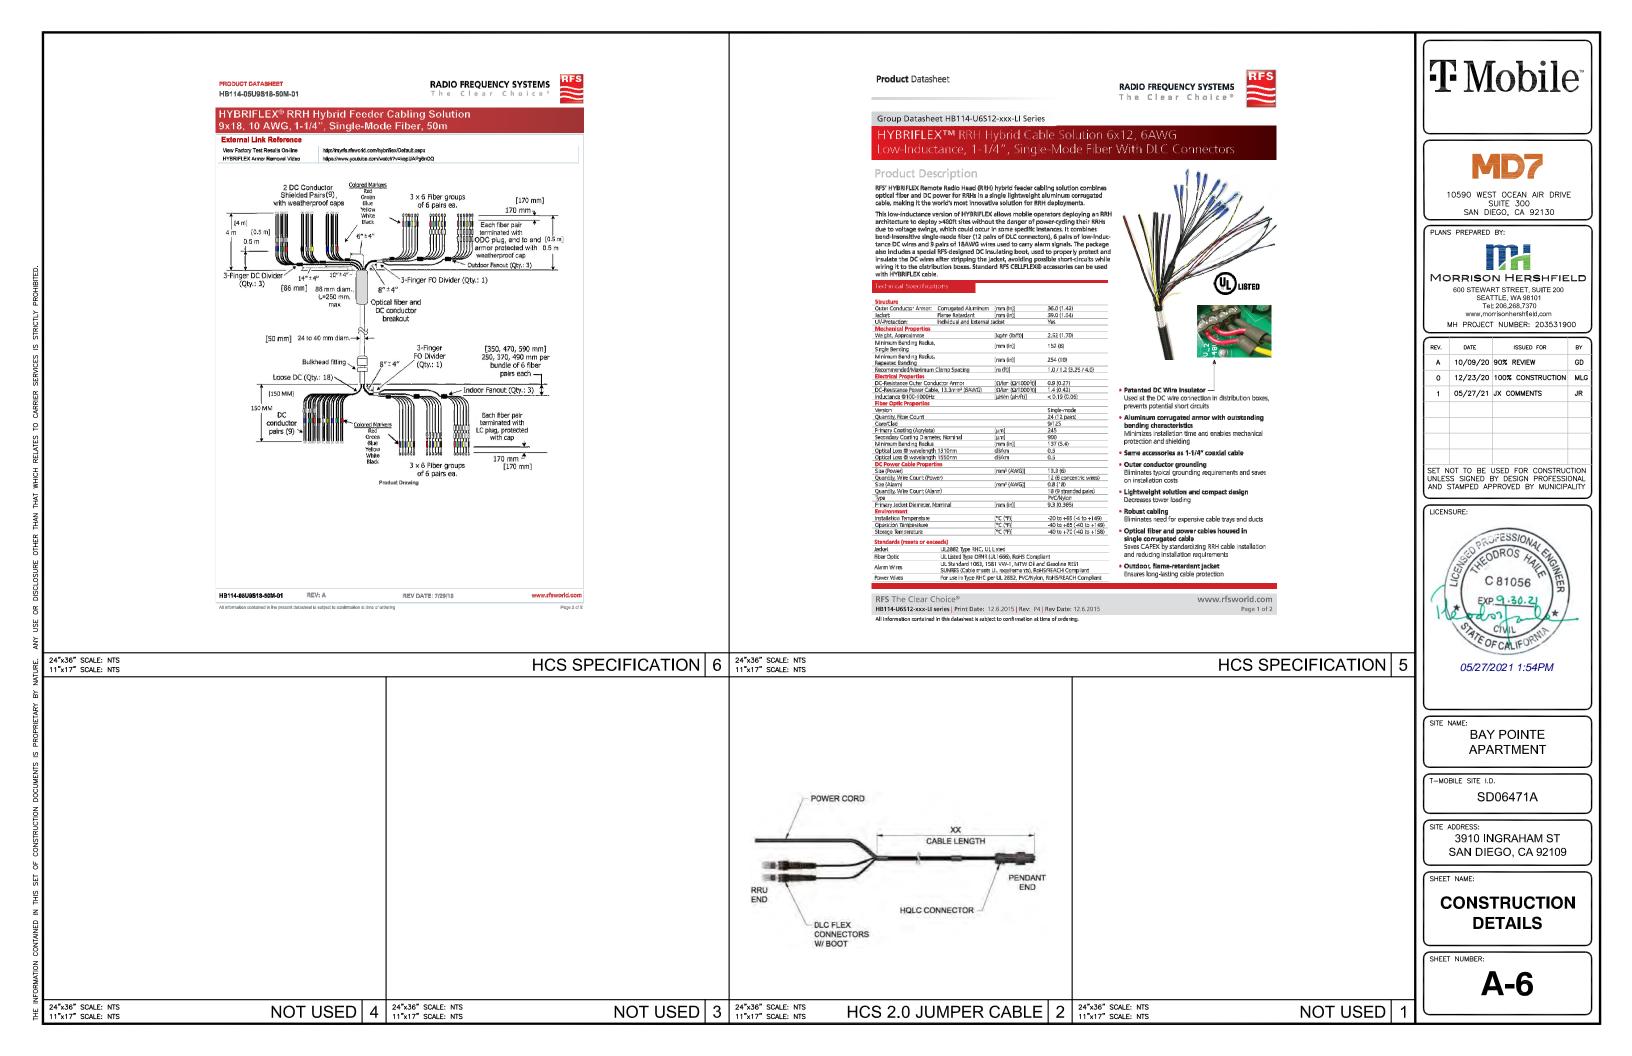


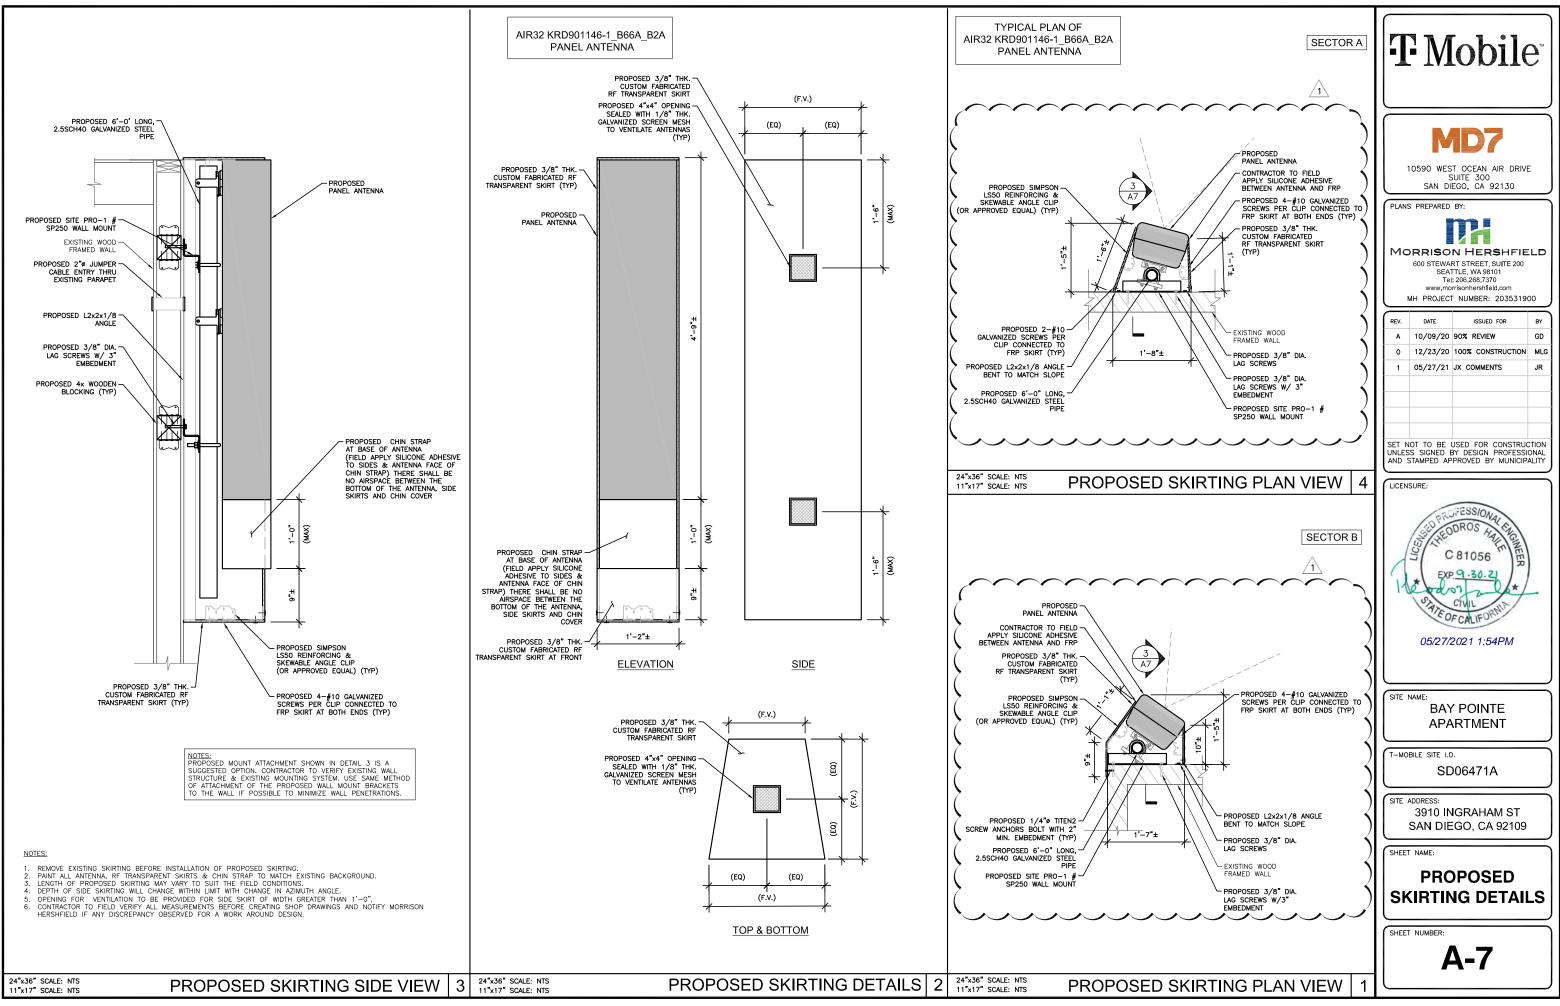

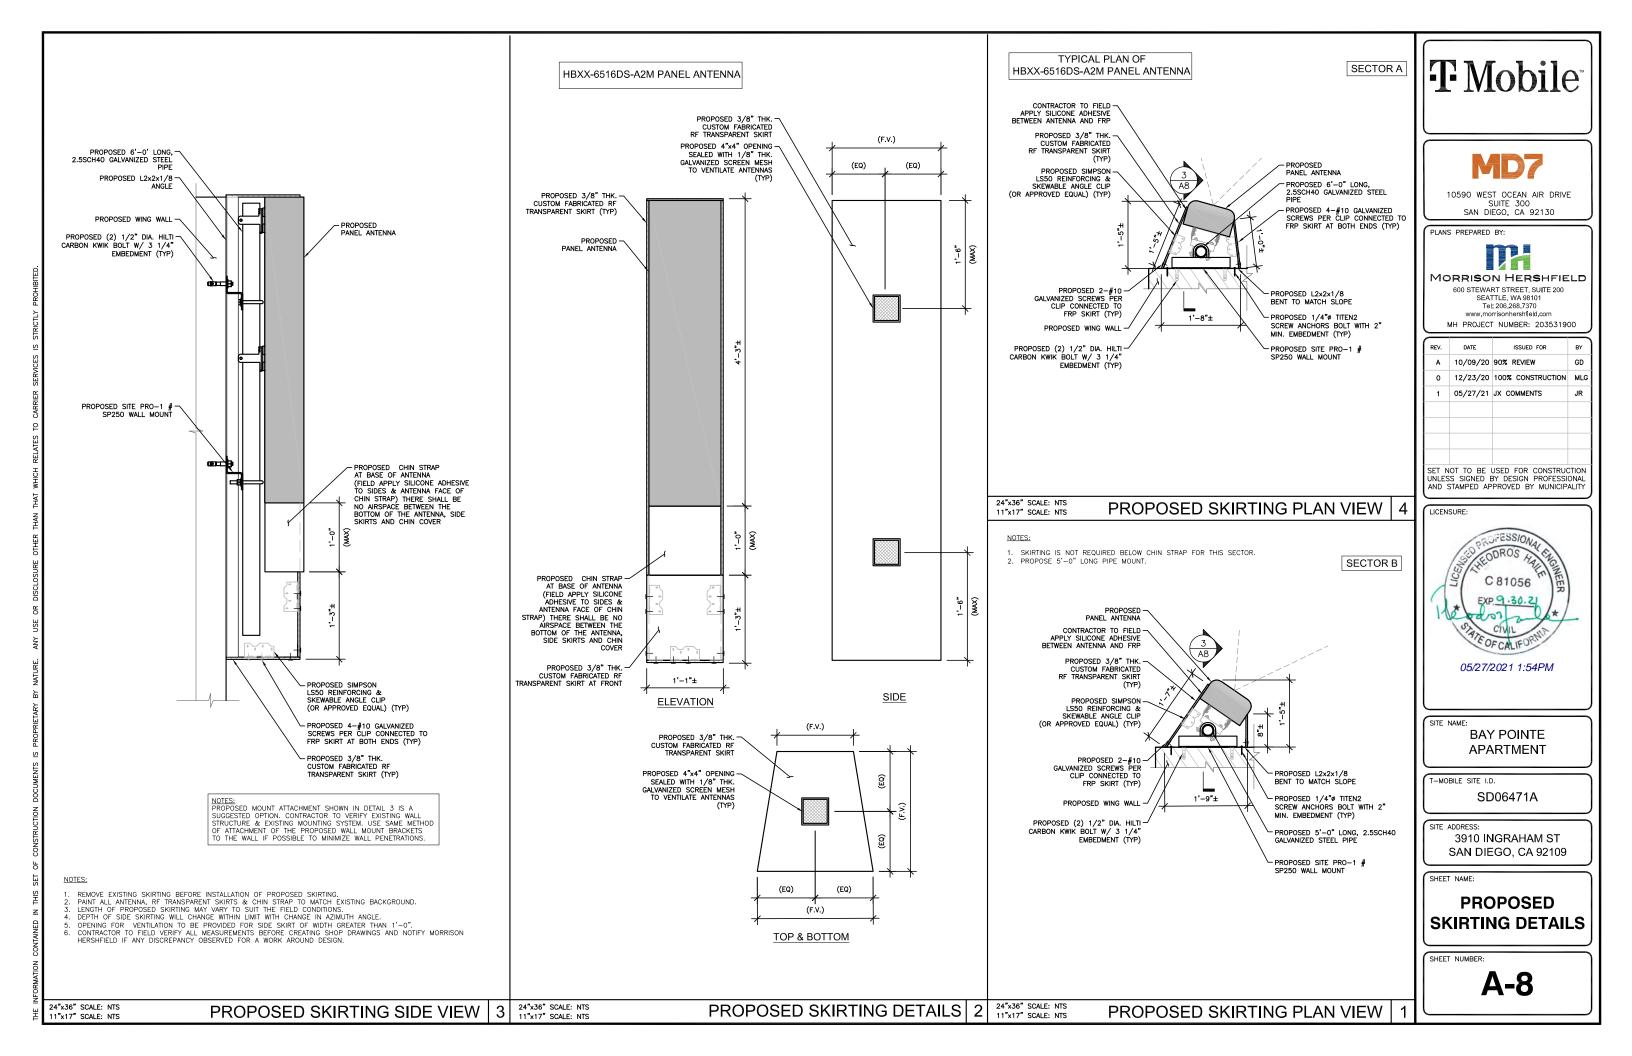

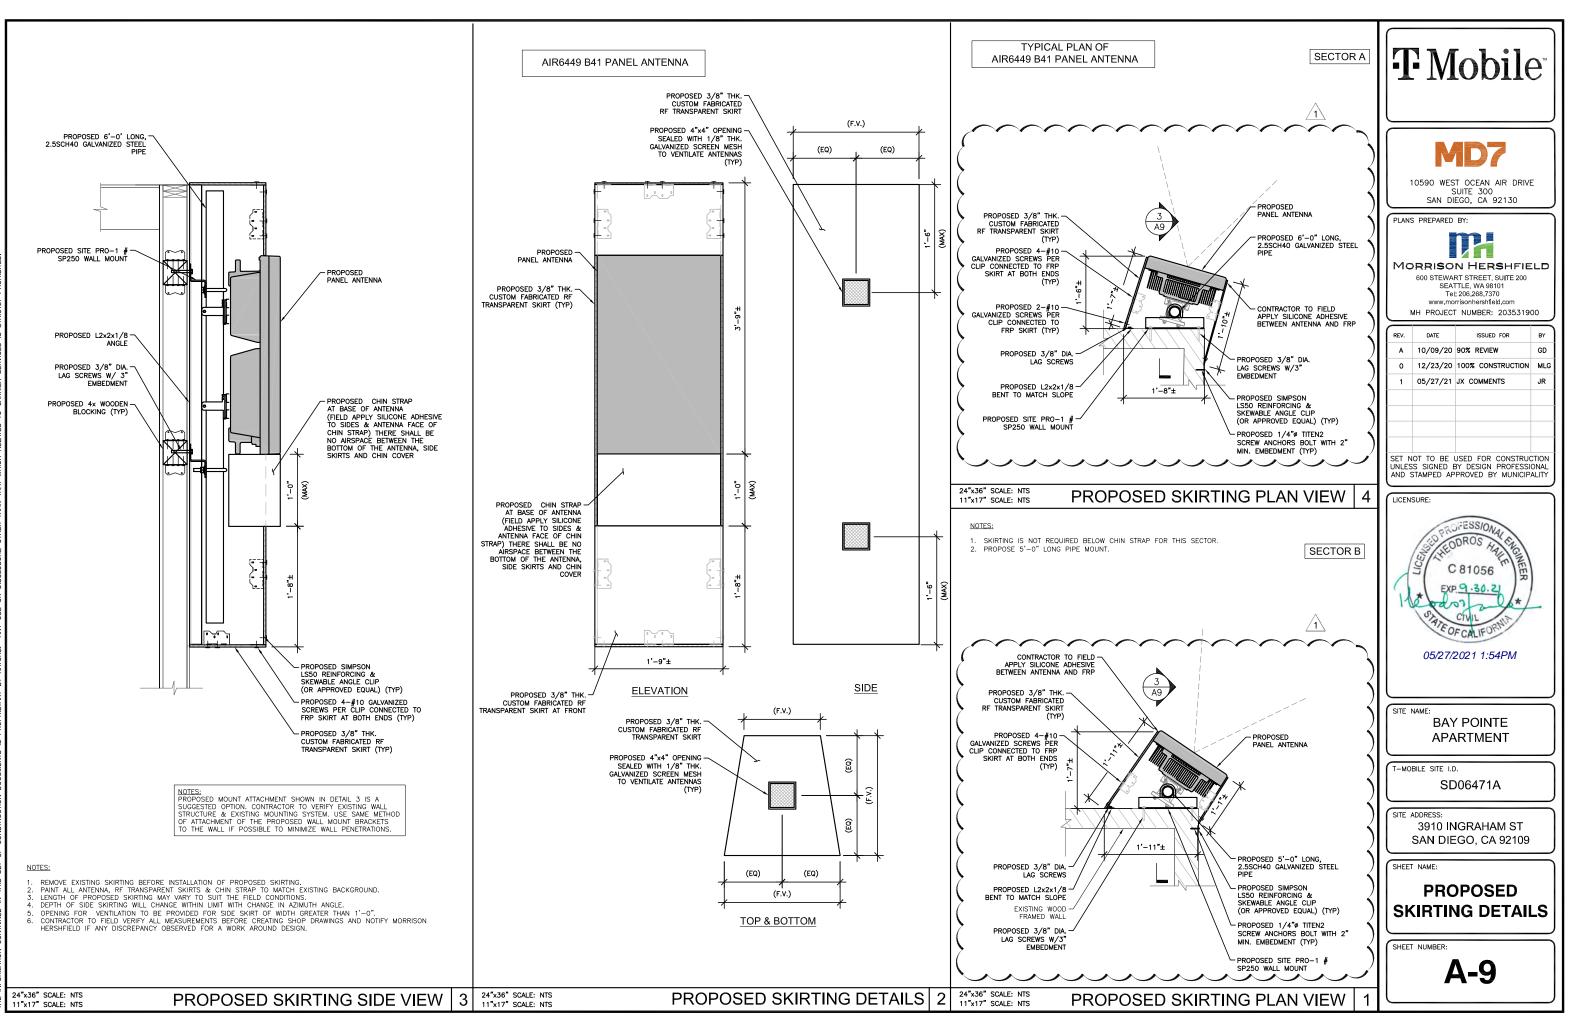

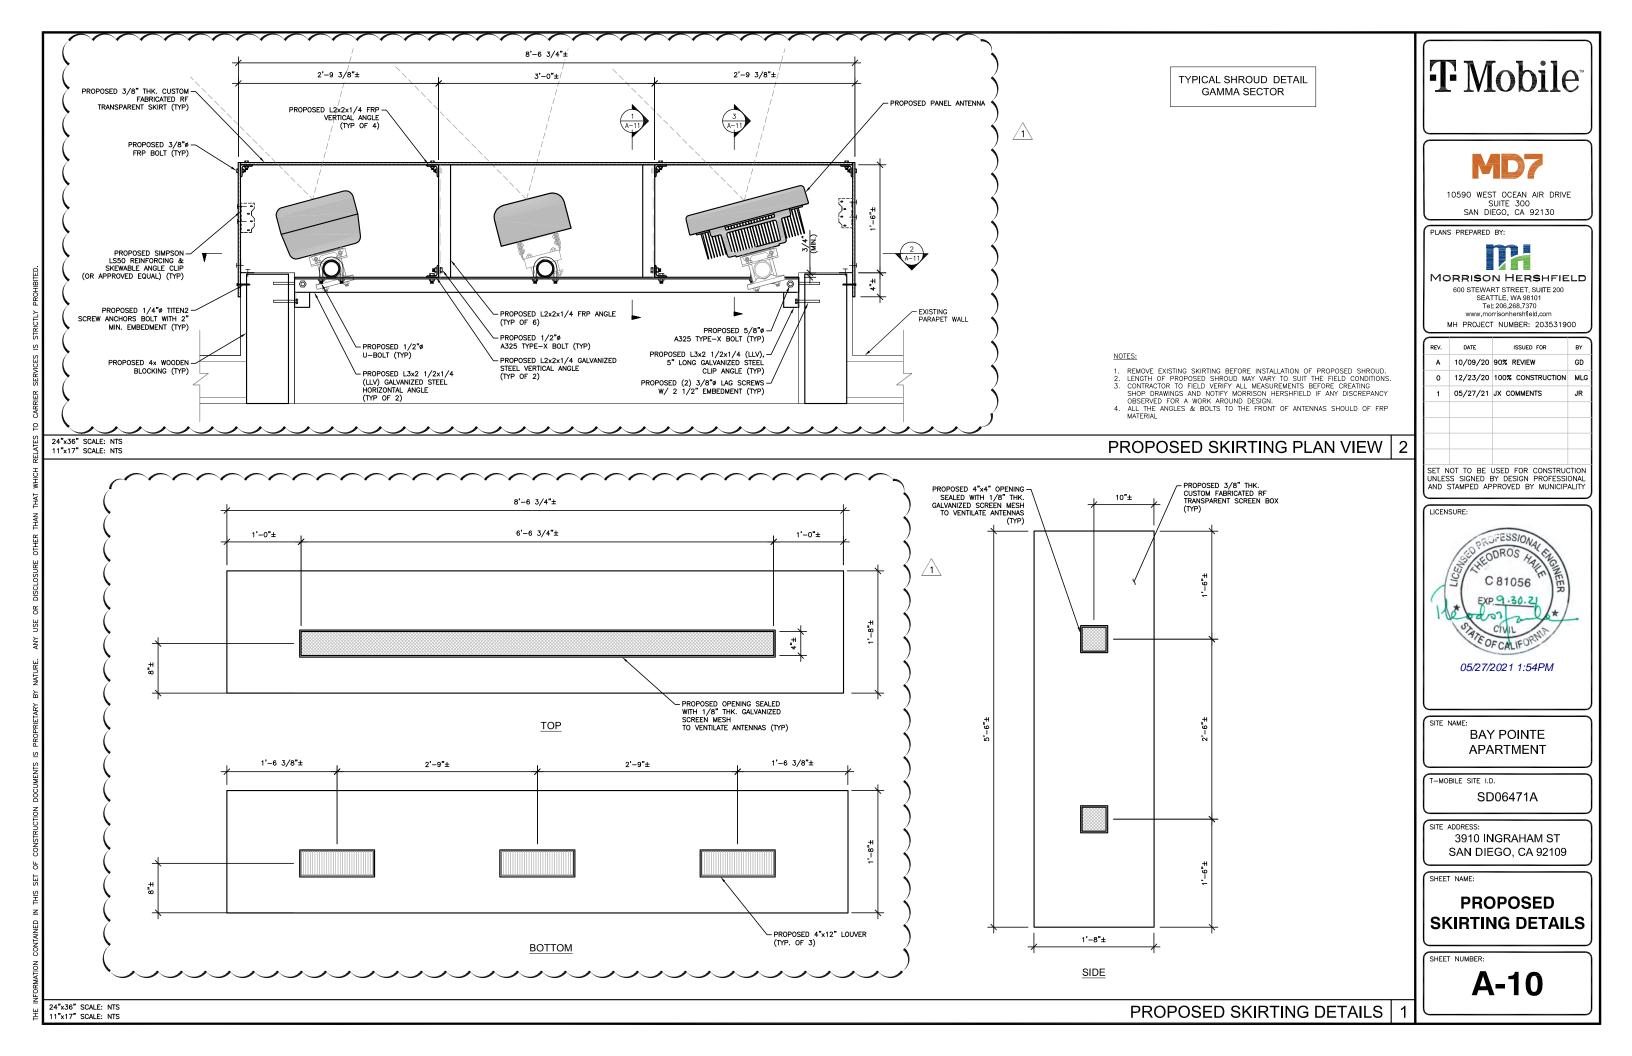

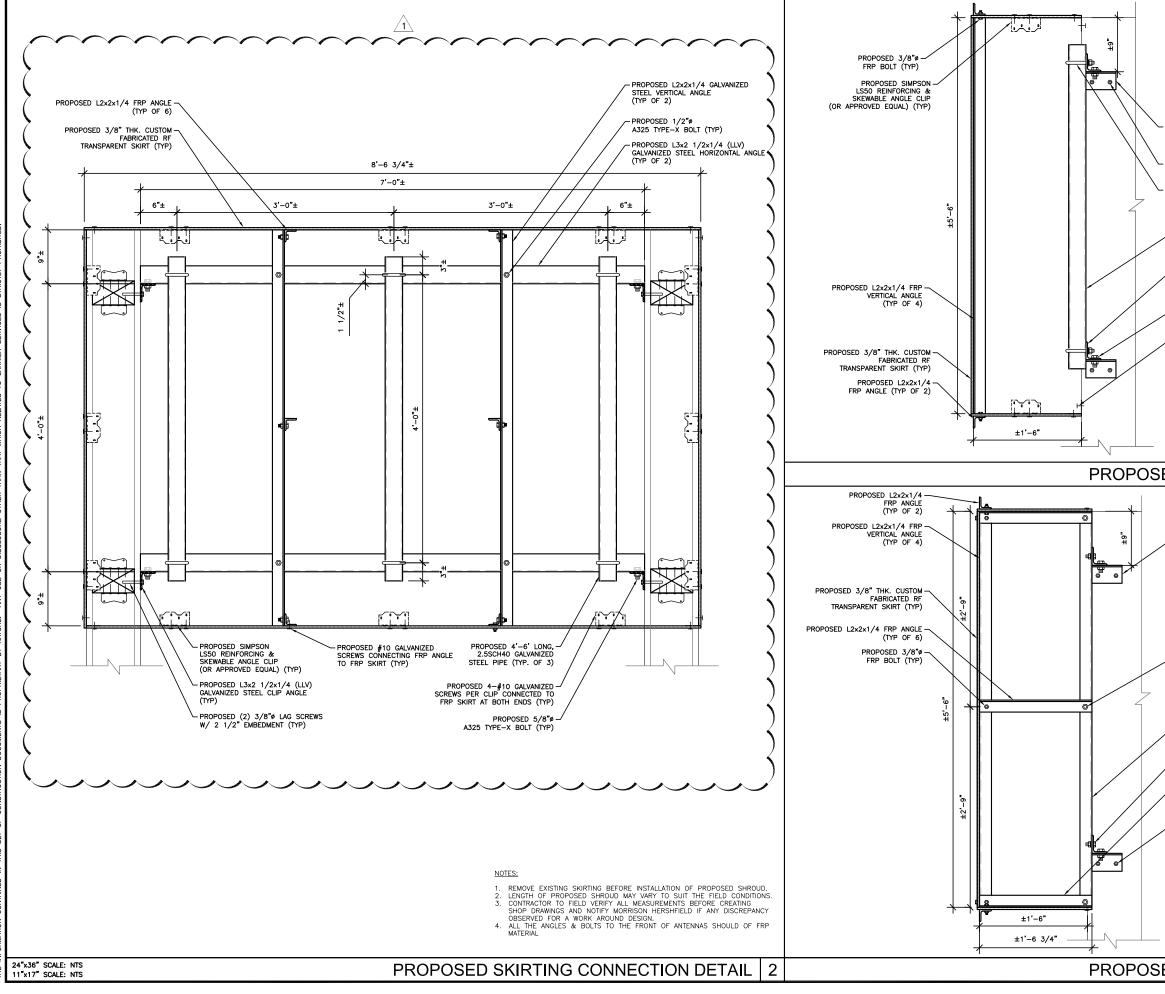

TYPICAL SHROUD DETAIL GAMMA SECTOR	<b>F</b> Mobile <sup>*</sup>
<ul> <li>PROPOSED L3x2 1/2x1/4 (LLV), 5" LONG GALVANIZED STEEL CLIP ANGLE (TYP)</li> <li>PROPOSED (2) 3/8"# LAG SCREWS W/ 2 1/2" EMBEDMENT (TYP)</li> <li>PROPOSED 1/2"# U-BOLT (TYP)</li> <li>PROPOSED 4'-6' LONG, 2.5SCH40 GALVANIZED STEEL PIPE (TYP. OF 3)</li> <li>PROPOSED L3x2 1/2x1/4 (LLV) GALVANIZED STEEL HORIZONTAL ANGLE (TYP OF 2)</li> <li>PROPOSED 5/8"# A325 TYPE-X BOLT (TYP)</li> <li>PROPOSED 4-#10 GALVANIZED SCREWS PER CLIP CONNECTED TO FRP SKIRT AT BOTH ENDS (TYP)</li> </ul>	ID590 WEST OCEAN AIR DRIVE SUITE 300 SAN DIEGO, CA 92130 PLANS PREPARED BY: IDCCA MORRISON HERSHFIELD 600 STEWART STREET. SUITE 200 SEATTLE, WA 98101 TEI: 206.208.730 WWW.morrisonhershifield.com MH PROJECT NUMBER: 203531900 MH PROJECT NUMBER: 203531900
SED SKIRTING SECTION 3 PROPOSED L3x2 1/2x1/4 (LLV), 5° LONG GALVANIZED STEEL CLIP ANGLE	SET NOT TO BE USED FOR CONSTRUCTION UNLESS SIGNED BY DESIGN PROFESSIONAL AND STAMPED APPROVED BY MUNICIPALITY
PROPOSED 1/2"¢ A325 TYPE-X BOLT (TYP) PROPOSED L2x2x1/4 GALVANIZED STEEL VERTICAL ANGLE (TYP OF 2) PROPOSED 1/2"¢ A325 TYPE-X BOLT (TYP) PROPOSED L2x2x1/4 FRP ANGLE (TYP OF 6) PROPOSED (2) 3/8"¢ LAG SCREWS W/ 2 1/2" EMBEDMENT (TYP)	SITE NAME: BAY POINTE APARTMENT T-MOBILE SITE I.D. SD06471A SITE ADDRESS: 3910 INGRAHAM ST SAN DIEGO, CA 92109 SHEET NAME:
SED SKIRTING SECTION 1	PROPOSED SKIRTING DETAILS

ILITY MICHGEAR ID) (M) (M) (M) (M) (M) (M) (M) (M) (M) (M											-0			<ul> <li>2 EXISTING T-MOBIL</li> <li>3 NEW 2" RMC CON FEEDERS</li> <li>4 EXISTING T-MOBIL</li> <li>4 EXISTING T-MOBIL</li> <li>5 EXISTING MIN (3)</li> <li>6 EXISTING MIN 2"</li> <li>6 EXISTING T-MOBIL</li> <li>7 EXISTING T-MOBIL</li> <li>8 EXISTING T-MOBIL</li> <li>8 EXISTING MIN 44 TO MIN (2) 5/8", 6'-0" APART &amp; E SERVICE EQUIPMEI</li> <li>9 CONTRACTOR TO F A NEW 200A, 2-1 SWITCH. PROVIDE "T-MOBILE MTS"</li> <li>10 EXISTING T-MOBIL (SUB-PANEL "B")</li> <li>11 NEW (8) 20A-2P CIRCUIT</li> <li>12 NEW (2) #12 AWC RECTIFIER CIRCUIT</li> <li>13 NEW PBC6200 PO RACK.</li> <li>14 EXISTING 125A-2F</li> </ul>	E METER E 200A-2 IDUIT W/ E 200A, 1 200A-2P I #3/0 AW/ RMC W/ ( ACH TO N E GENERA N. AWG COPF 0X8'-0" LI CONDED TO TO NI IN FIEL REMOVE E1 20LE, 240 MECH ATT E 125A, 1 BRANCH I G CU & # WER RACK P BRANCH	TO REMAIN. VERIFY IN FIELD. 2P MAIN TO REMAIN. VERIFY IN FIELD. (3)#1/0 + (1)#6 GND THHN CU ELECTRICAL 120/240C-1ø-3W, AC PANEL (PANEL "A") MAIN CIRCUIT BREAKER TO REMAIN. NG COPPER IN 2" CONDUIT. VERIFY IN FIELD. (3)#3/0 + (1)#6 GND THHN CU ELECTRICAL NEW PPC ATOR TAP BOX - 200A, 120/240V, 1 PHASE, PPER GROUND ELECTRODE CONDUCTOR BONDED LONG GROUND ELECTRODES SPACED A MIN OF 0 BULDING GROUND SYSTEM. VERIFY EXISTING LD. EXISTING 100A MANUAL TRANSFER SWITCH W/ OY, DOUBLE THROW MANUAL TRANSFER TACHED ENGRAVED LAGEL INDICATING 120/240V-1ø-3W, M.L.O. AC PANEL BREAKERS FOR A TOTAL OF (8) RECTIFIER #12 GROUND IN 3/4" RMC FOR EACH KK TO REPLACE EXISTING PBC6500 POWER 4 BREAKER FOR SUB-PANEL "B". & (1) #6 AWG GROUND IN 2" CONDUIT.	PLANS PREPARED BY: MORRISON HERSHFIELD 600 STEWART STREET, SUITE 200 SEAT DIEGO, CA 92130 PLANS PREPARED BY: MORRISON HERSHFIELD 600 STEWART STREET, SUITE 200 SEATLE, WA 98101 Tei: 206.268.7370 WWW.morrisonhershfield.com MH PROJECT NUMBER: 203531900 <u>REV.</u> DATE ISSUED FOR BY A 10/09/20 90% REVIEW GD 0 12/23/20 100% CONSTRUCTION MLC 1 05/27/21 JX COMMENTS JR
SITE ID: SD06471A VOLTAGE: 120/240V MAIN BREAKER: 200A MOUNT: SURFACE ENCLOSURE TYPE: NEMA-1 PANEL STATUS: NEW	PHASE: BUSS RAT NEUTRAL N TO GNE INTERNAL	TING: BAR: D:	YES NO		A G P	IRE: IC: ROUND BA ANEL SIZE: ANEL NAME									(	ONE-LINE DIAGRAM 2	SET NOT TO BE USED FOR CONSTRUCTION UNLESS SIGNED BY DESIGN PROFESSIONAL AND STAMPED APPROVED BY MUNICIPALITY LICENSURE: CRUCE COROS AND THE CRUCE CRUCE CRUCE CRUCE CRUCE CRUCE CRUCE CRUCE CRUCE CRUCE CRU
PANEL STATUS: NEW CKT LOAD DESCRIPTION	BRFAKER B		YES BREAKER STATUS	CONN LOAD				B DEMAND	DEMAND FACTOR	CONN LOAD	BREAKER STATUS	BREAKER POLES	BREAKER AMPS	LOAD DESCRIPTION	скт	_	05/27/2021 1:54PM
1 EXISTING LIGHTING	20	1	ON	420	1.25	525	525	0	1.00	0	ON	2	15	EXISTING AHU #2	2		
3 EXISTING RECEPTACLE 5 EXISTING RECEPTACLE	20	1	ON ON	540 540	1.00	540 540	1340	0 800	1.00	0 800	ON	2	15	EXISTING AHU #1	4		
7 EXISTING SMOKE DETECTOR	20	1	ON	180	1.00	180	980	800	1.00	800		_			8	-	
9 EXISTING EXT GFI RECEPT	20	1	ON	180	1.00	180	1680	1500	1.00	1500	ON	2	20	EXISTING CU #1	10		APARTMENT
11 NEW RECTIFIER	20	2	ON	1440	1.00	1440	2940	1500	1.00	1500					12	_	T-MOBILE SITE I.D.
17	+	2	ON	1440 1440	1.00	1440 1440	1440 1440	0	1.00	0	ON	2	20	EXISTING CU #2	14	_	SD06471A
13	1 20 1	۷		1440	1.00	1440	2880	1440	1.00	1440	ON	2	20	NEW RECTIFIER	18		
15 NEW RECTIFIER	20		.		1.00	1440	2880	1440	1.00	1440		-			20		SITE ADDRESS:
	20	2	ON	1440			2880	1440	1.00	1440	ON	2	20	NEW RECTIFIER	22	-	3910 INGRAHAM ST
15 NEW RECTIFIER		2	ON	1440 1440	1.00	1440	2000	-	1.00	1440	1				24	7	SAN DIEGO, CA 92109
15 NEW RECTIFIER 17 19 NEW RECTIFIER		2	ON ON			1440 1440	2880	1440	1.00	1440					1		
15     NEW RECTIFIER       17	20			1440	1.00			1440	1.00	1440					26		SHEET NAME:
15     NEW RECTIFIER       17     NEW RECTIFIER       21     NEW RECTIFIER       23     NEW RECTIFIER       25     EXISTING SUB-PANEL "B"	20			1440 1440 1440 2880	1.00 1.00 1.00 1.00	1440 1440 2880	2880 1440 2880	0	1.00	0	ON	2	50	EXISTING TVSS	28	-	SHEET NAME:
15     NEW RECTIFIER       17     NEW RECTIFIER       21     NEW RECTIFIER       23     NEW RECTIFIER       25     NEW RECTIFIER	20 20 20	2	ON	1440 1440 1440 2880 2880	1.00 1.00 1.00 1.00 1.00	1440 1440 2880 2880	2880 1440 2880 2880 2880				ON	2	50			-	
15     NEW RECTIFIER       17     NEW RECTIFIER       21     NEW RECTIFIER       23     NEW RECTIFIER       25     EXISTING SUB-PANEL "B"	20 20 20	2	ON ON Pt	1440 1440 1440 2880 2880 HASE DEMA	1.00 1.00 1.00 1.00 1.00	1440 1440 2880 2880 OTAL	2880           1440           2880           2880           15065           14540	0	1.00	0	ON	2	50		28		SHEET NAME:
15     NEW RECTIFIER       17     NEW RECTIFIER       21     NEW RECTIFIER       23     NEW RECTIFIER       25     EXISTING SUB-PANEL "B"	20 20 20	2	ON ON Pt	1440 1440 2880 2880 HASE DEMA TOTAL DE	1.00 1.00 1.00 1.00 1.00	1440 1440 2880 2880 OTAL D (VA)	2880 1440 2880 2880 2880	0	1.00	0	ON	2	50		28		SHEET NAME: ELECTRICAL

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24"x36" SCALE: NTS 11"x17" SCALE: NTS

