

Report to the Planning Commission

DATE ISSUED: December 8, 2021 REPORT NO. PC-21-061

HEARING DATE: December 16, 2021

SUBJECT: CLAIREMONT SDP/TM. Process Four Decision

PROJECT NUMBER: <u>677814</u>

OWNER/APPLICANT: 3450 Clairemont LLC, Owner/Permittee and Warmington Residential, Owner

SUMMARY

<u>Issue(s)</u>: Should the Planning Commission approve a multi-family residential development consisting with the demolition of two existing buildings, and the construction of eight, three-story, 40-unit multi-residential townhome on a 3.28-acre site located at 3450 Clairemont Drive in the Clairemont Mesa Community Plan area?

Staff Recommendations:

- 1. ADOPT Negative Declaration No. 677814; and
- 2. APPROVE Site Development Permit No. 2487401 (SDP), Neighborhood Development Permit No. 2579728 (NDP), and Vesting Tentative Map No. 2487402 (VTM).

<u>Community Planning Group Recommendation</u>: On November 8, 2021, the Clairemont Mesa Community Planning Group voted 6-1-2 to recommend approval of the Project as proposed (Attachment No. 9).

Environmental Review:

Negative Declaration No. 677814 has been prepared for the Project in accordance with the State of California Environmental Quality Act (CEQA) Guidelines. No environmental impacts were identified (Attachment 8).

<u>Fiscal Impact Statement</u>: All costs related to processing this Project are covered by a deposit account maintained by the applicant.

Code Enforcement Impact: None.

Housing Impact Statement: The project would add 40 dwelling units to the Clairemont Mesa

Community Plan area and the City's housing stock on a site that is currently developed with a religious use. One unit of housing on site, or two percent of the units proposed, will be affordable for sale to median income housing at 100% of Area Median Income (AMI), fulfilling the requirements of the San Diego Municipal Code (SDMC) Section 142.1304(b)(1).

BACKGROUND

The Clairemont SDP/TM Project (Project) is located at 3450 Clairemont Drive on a 3.28-acre parcel lot on the west side of Clairemont Drive, north of Dakota Drive and south of Rappahannock Avenue. The site is within the RM-1-1 (Residential – Multiple Unit) Zone, Montgomery Field Airport Land Use Compatibility Overlay Zone, Clairemont Mesa Height Limit Overlay Zone, Montgomery Field Airport Influence Area – Review Area 2, Montgomery Field FAA Part 77 Noticing Area, and Very High Fire Hazard Severity Zone, and is designated for Low-Medium Residential (10-15 du/ac) in the Clairemont Mesa Community Plan.

The Project site is in a developed neighborhood with religious facilities to the north/northwest and south/southeast of the site; single dwelling units to the south and on the western side of the urban canyon; a school, skate and bike park, and recreation center on the east side of Clairemont Drive; and multi-residential dwelling units southeast of the site.

The Project site is developed with the two buildings that had been used as a church facility. While the property contains one building that is over 45 years old (built in 1955), City Historic Review staff has reviewed the building and building records and determined that due to alterations to the original structure, the property does not retain integrity to its original 1955 design and does not meet the local designation criteria as an individually significant resource under any adopted Historical Resources Board (HRB) Criteria. Therefore, the Project is not required to obtain a Site Development Permit in accordance with SDMC Section 143.0220.

DISCUSSION

Project Description:

The Project entails the demolition of two existing buildings totaling approximately 15,172 square feet, as well as associated improvements, and the redevelopment of the site with a townhome development totaling 89,250 square feet within eight, three-story buildings, with 40, two-story townhome units over garages. The units would be a mix of three- and four-bedroom units, each with 2.5 bathrooms, with one unit for affordable housing as noted above.

Access to the Project site will be from a driveway on Clairemont Drive. Two buildings would be located along Clairemont Drive, and the other buildings would be located along a private interior road. On the western portion of the Project site is a canyon area containing sensitive vegetation that will be maintained. While the area within and adjacent to the urban canyon contains sensitive vegetation, it is not within or adjacent to any Multi-Habitat Planning Area designated land. The development area and grading will be within existing developed and disturbed areas, with no

impacts to any biological resources on- or off-site.

The Project site is located on an existing bus route that currently provides service to Old Town and Westfield University Towne Center (UTC). In addition, the site is approximately 0.67 miles south of the Balboa Avenue and Clairemont Drive intersection, where there is bus service to the east and west, including the Balboa Station Trolley stop.

Required Actions:

- Vesting Tentative Map (VTM): A VTM is required in accordance with SDMC Section <u>125.0410</u> for the proposed subdivision;
- Site Development Permit (SDP): A SDP is required in accordance with SDMC Section <u>126.0502</u>
 (a) for the multiple unit residential development on a site that contains environmentally sensitive lands; and
- Neighborhood Development Permit (NDP): A NDP is required in accordance with SDMC Section 126.0402(g) for development proposing a retaining wall that exceeds the height permitted per SDMC section 142.0350 by 20% or less. There is a retaining wall that will exceed the allowable height of 12 feet by 2'-3" (total of 14'-3") for a portion of its length. The wall is outside of the required setbacks due to the grade variations of the Project site.

General Plan/Community Plan Analysis:

The Project site is in within the <u>Clairemont Mesa Community Planning</u> area. As proposed, the 40 multi-unit townhome development implements the recommended land use designation because it is consistent with the Low-Medium Residential land use designation and complies with the 10-15 dwelling unit per acre (DU/AC) maximum of up to 49.2 units, with a total of 40 units proposed.

Although the proposed Project does not appear to represent an abrupt change in height compared to the existing development to the north and south of the project site, the Clairemont Height Limit Overlay Zone restricts the development to a maximum height of 30 feet. As designed, the Project conforms to that 30-foot height limit.

Environmental Analysis:

The Project site is located in a fully developed area of the City. City staff reviewed the Project for the following environmental impacts; Aesthetics, Hazards & Hazardous Materials, Public Services Agriculture and Forestry Resources, Hydrology/Water Quality, Recreation, Air Quality, Land Use/Planning, Transportation/Traffic, Biological Resources, Tribal Cultural Resources, Noise, Paleontological Resources, Geology/Soils and Greenhouse Gas Emissions and determined that the proposed Project will not have any significant environmental effects and a Negative Declaration was prepared.

Conclusion:

City staff has reviewed the proposed Project and all issues identified through the review process have been resolved in conformance with adopted City Council policies and regulations of the Land Development Code. The Project meets all applicable regulations and policy documents, and staff supports the determination that the Project is consistent with the recommended land use plan, design guidelines, and development standards in effect for this site per the SDMC, the Clairemont Mesa Community Plan, and the General Plan. Therefore, City staff recommends the Planning Commission approve the Project as proposed.

ALTERNATIVES

- 1. ADOPT Negative Declaration No. 677814; and APPROVE Site Development Permit No. 2487401, Neighborhood Development Permit No. 2579728, and Vesting Tentative Map No. 2487402, with modifications.
- 2. DO NOT ADOPT Negative Declaration No. 677814; and DENY Site Development Permit No. 2487401, Neighborhood Development Permit No. 2579728, and Vesting Tentative Map No. 2487402, if the findings required to approve the Project cannot be affirmed.

Respectfully submitted,

Tim Daly

Assistant Deputy Director

Development Services Department

Martha Blake

Development Project Manager

Development Services Department

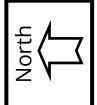
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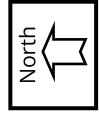
Attachments:


- 1. Project Location Map
- 2. Community Plan Land Use Map
- 3. Aerial Photograph
- 4. Draft Permit Resolution with Findings
- 5. Draft Permit with Conditions

- 6. Draft VTM Resolution with Findings
- 7. Draft VTM Conditions
- 8. Draft Environmental Resolution
- 9. Community Planning Group Recommendation
- 10. Ownership Disclosure
- 11. Development Plans

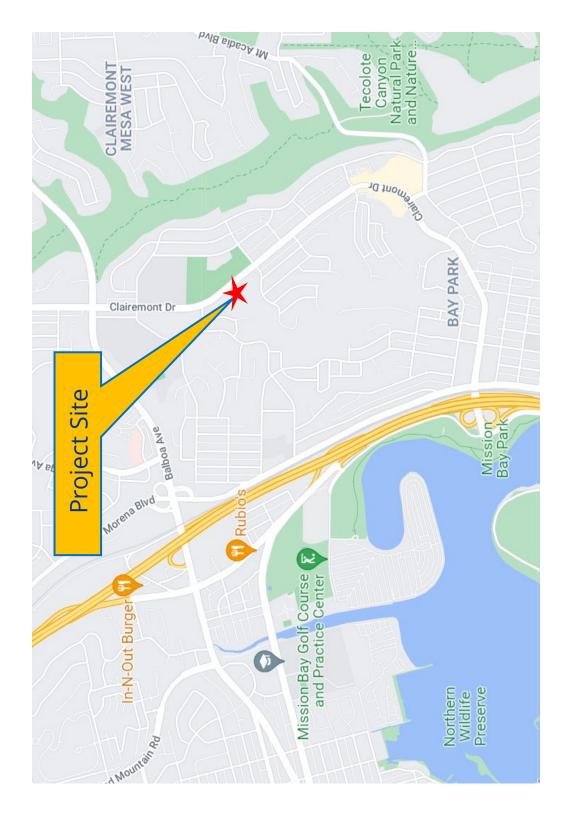ATTACHMENT 1









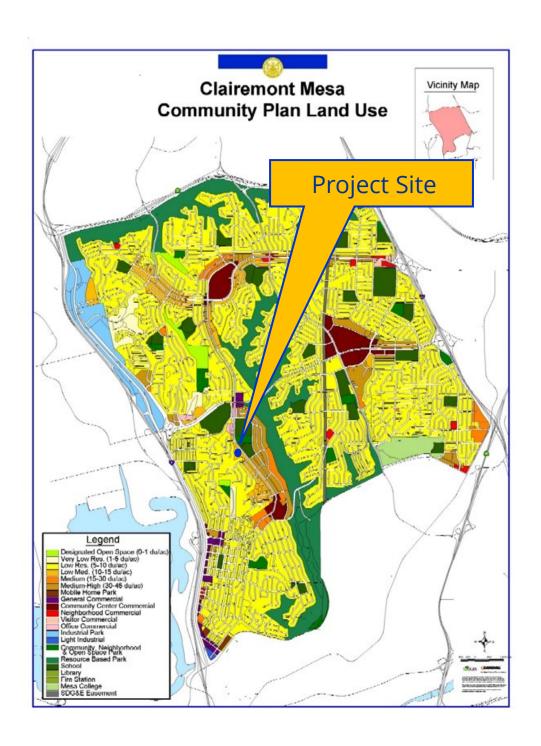
Project Location Map Clairemont SDP/VTM PROJECT NO. 677814






Land Use Map

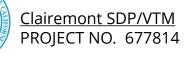

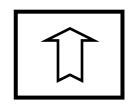

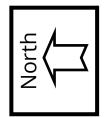



Aerial Photo



Clairemont SDP/VTM PROJECT NO. 677814

PLANNING COMMISSION RESOLUTION NO. SITE DEVELOPMENT PERMIT NO. 2487401 NEIGHBORHOOD DEVELOPMENT PERMIT NO. 2579728 CLAIREMONT SDP/TM - PROJECT NO. 677814

WHEREAS, 3450 CLAIREMONT, LLC, Owner/Permittee and WARMINGTON RESIDENTIAL,
Owner,, filed an application with the City of San Diego for a permit to demolish existing structures
and construct 40 dwelling units at 3450 Clairemont Drive on previously developed land (as described
in and by reference to the approved Exhibits "A" and corresponding conditions of approval for the
associated Site Development Permit No. 2487401 and Neighborhood Development Permit No.
2579728, on portions of a 3.28 -acre site;

WHEREAS, the project site is located at 3450 Clairemont Drive in the RM-1-1 (Zone,
Montgomery Field Airport Land Use Compatibility Overlay Zone, Clairemont Mesa Height Limit
Overlay Zone, Montgomery Field Airport Influence Area – Review Area 2, Montgomery Field FAA Part
77 Noticing Area, and Very High Fire Hazard Severity Zone of the Clairemont Mesa Community Plan;
WHEREAS, the project site is legally described as portions of Lot 978 of Claremont Unit No. 6,
Map No. 2865;

WHEREAS, on December 16, 2021, the PLANNING COMMISSION of the City of San Diego considered Site Development Permit No. 2487401 and Neighborhood Development Permit No. 2579728 pursuant to the Land Development Code of the City of San Diego;

NOW, THEREFORE,

BE IT RESOLVED by the Planning Commission of the City of San Diego, that it adopts the following findings with respect to the Site Development permit No. 2487401 and Neighborhood Development Permit No. 2579728:

Neighborhood Development Permit - San Diego Municipal Code (SDMC) Section 126.0404

A. Findings for all Neighborhood Development Permits

1. The proposed development will not adversely affect the applicable land use plan;

The Clairemont SDP/TM Project (Project) is located within the Clairemont Mesa Community Plan (CMCP), adopted on September 26, 1989, and amended on eight occasions, which is the applicable land use plan for the Project area along with the City's General Plan. The CMCP designates the Project site for Low-Medium Residential, at 10 to 15 dwelling units per acres. Based on the 3.28-acre site, 33 to 49 dwelling units would be allowed on the site and the Project proposes 40 multi-family residential units. The site is also within the Clairemont Height Limit Overlay Zone, which restricts the development to a maximum height of 30 feet. As designed, the Project conforms to that 30-foot height limit.

The Project design is consistent with the community's land use plan through the provision of 40 multi-family dwelling units. The proposed Project is consistent with the City's General Plan and implements the goals and policies for the provision of housing, including one onsite affordable housing. The Project site is located adjacent to one bus route that provides service to the north and south, including the Clairemont Drive Trolley station, and the Project is within 0.67 miles of two additional bus routes that provide access to the Balboa Avenue Trolley Station, as well as points to the east and west.

As the Project is consistent with the CMCP, the proposed development will not adversely affect the applicable land use plan.

2. The proposed development will not be detrimental to the public health, safety, and welfare.

The permits controlling the development and continued use of the Project contain conditions addressing the project compliance with the City's regulations and policies and other regional, state, and federal regulations to prevent detrimental impacts to the public health, safety, and welfare. Compliance with these regulations along with permit conditions and implementation of project design features will result in a project which will not be detrimental to the public health, safety, and welfare.

As the project is adjacent to vegetated areas that contain ESL, brush management measures are required. The Brush Management Program shall be based on a standard Zone One of 35 feet in width and a Zone Two of 65 feet in width, extending out from the structures towards the native/naturalized vegetation, consistent with SDMC section 142.0412. Zone One shall range from 14 feet to 17 feet in width with a corresponding Zone Two of 10 feet to 65 feet in width. The project has also been conditioned to include a radiant heat wall as shown on the Brush Management Plan at the interface of Zones One and Two as alternative compliance for the reduced Brush Management Zones. A Zone One condition shall be maintained in the yard space between the radiant heat wall and the habitable structure. The Brush Management Program, including the alternative compliance, have been reviewed and accepted by both Landscape and Fire Staff, and will not be detrimental to any public health, safety, or welfare.

The grading proposed in connection with the development will not result in soil erosion, silting of lower slopes, slide damage, flooding, severe scarring, or any other geological instability which would affect public health, safety, and welfare as approved by the City Engineer. Flooding or severe scarring will not occur as a result of grading operations. Conditions included within the permit require the timely planting of all slopes to prevent erosion and to provide additional slope stability, along with construction best management practices during work to ensure compliance with all applicable drainage and grading regulations.

Based upon the hydrology/drainage report, the implementation of the project will not cause a rise in 100-year flood water level across the site as well up and down-stream of the property.

The Project in within a developed community that is served by essential public services, including police, fire, and medical, as well as all utilities, such as electricity, water, and sewer. The project is required to comply with several operational constraints and development controls intended to assure the continued public health, safety, and welfare.

Storm water impacts from the proposed project would be avoided through best management practices (BMPs), including site design and the installation of appropriate filtration devices. All Uniform Building, Fire, Plumbing, Electrical, Mechanical Code, and Municipal Code regulations governing the construction and continued operation of the development apply to this site to prevent adverse effects to those persons or other properties in the vicinity. Prior to the actual construction of residential buildings on the subject property, City staff will review building permit plans against the Uniform Building Code to assure that structural, mechanical, electrical, plumbing, and access components of the project are designed to protect the public's health, safety, and welfare. Therefore, the project would not have a detrimental impact on public health, safety, and welfare.

3. The proposed development will comply with the applicable regulations of the Land Development Code.

The Project site is zoned RM-1-1 (Multi-family, allowing one dwelling unit per 3,000 square feet). The Project is consistent with the underlying zone and land use designation. To achieve the project objectives of a unified land use design and built elements that create a positive sense of character and community, the Project proposes land uses and compliance with development regulations as allowed by the San Diego Municipal Code (SDMC), including a Neighborhood Development Permit to allow for a wall that exceeds the allowable 12-foot height limit by 2'-3". This wall is allowed in accordance with SDMC section 142.0350 as it is less than 20% over the allowable height, and is located outside of the required setbacks. The wall will be screened with landscaping and will not be visible to dedicated open space areas or public rights-of-ways. The proposed wall will also minimize the grading into any slopes or sensitive habitat to ensure slope stability for the proposed development. Therefore, the proposed development will comply with the applicable regulations of the Land Development Code.

Site Development Permit - Section 126.0505

A. Findings for all Site Development Permits

1. The proposed development will not adversely affect the applicable land use plan.

Please see Neighborhood Development Permit Finding A.1 above.

2. The proposed development will not be detrimental to the public health, safety, and welfare.

Please see Neighborhood Development Permit Finding A.2 above.

3. The proposed development will comply with the applicable regulations of the Land Development Code.

Please see Neighborhood Development Permit Finding A.3 above.

Site Development Permit - Section 126.0505

- B. Supplemental Findings Environmentally Sensitive Lands
 - 1. The site is physically suitable for the design and siting of the proposed development and the development will result in minimum disturbance to environmentally sensitive lands.

The proposed development is located within the area covered by the Clairemont Mesa Community Plan, adopted on September 26, 1989, and amended on eight occasions, which is the applicable land use plan for the project area along with the City's General Plan.

The Project has been designed and sited to minimize disturbance of environmentally sensitive lands. Specifically, the Project avoids a disturbed wetland along the southern boundary of the property and will impact approximately 0.09-acres of Diegan coastal sage scrub (Tier II). The bulk of the impacts are related to removing and recompacting unsuitable fill material used in the creation of the existing development pad. The Project will revegetate the area outside of the building pad with a native plant mix, consistent with both City's Biology Guidelines and Landscape regulations. Therefore, the site is physically suitable for the design and siting of the proposed development and the development will result in minimum disturbance to environmentally sensitive lands

2. The proposed development will minimize the alteration of natural land forms and will not result in undue risk from geologic and erosional forces, flood hazards, or fire hazards.

The Project will not impact natural landforms or cause undue geologic or erosional forces, flood or fire hazards. The majority of the property was graded with the overall development

of the Clairemont Mesa community, including for Clairemont Drive and for the original development of this site in 1955, which resulted in little native vegetation remaining on-site. The Project's site plan limits development to the existing development pad with grading occurring outside of the pad to remove and recompact the supporting slopes with fill material that meets and exceeds the current grading standards of the City of San Diego and the State of California.

A site-specific Preliminary Geotechnical Investigation was prepared by Advanced Geotechnical Solutions, Inc., May 15, 2020, as well as a project-specific Addendum to Geotechnical Report. According to Geology of the San Diego Metropolitan Area, California, the project is assigned geologic risk category 52, which is characterized as other level areas, gently sloping to steep terrain, favorable geologic structure, low risk.

The site is located in the tectonically-active Southern California area, and will therefore likely experience shaking effects from earthquakes. The type and severity of seismic hazards affecting the site are to a large degree dependent upon the distance to the causative fault, the intensity of the seismic event, the direction of propagation of the seismic wave and the underlying soil characteristics. The seismic hazard may be primary, such as surface rupture and/or ground shaking, or secondary, such as liquefaction, seismically induced slope failure or dynamic settlement.

The State of California has mandated by the Alquist-Priolo Earthquake Fault Zoning Act (A-P) to delineate Fault-Rupture Hazard Zones in California. The project is not located in an A-P Zone. Redevelopment of the project site would be required to comply with seismic requirements of the California Building Code.

Implementation of proper engineering design and utilization of standard construction practices, to be verified at the building permit stage, would ensure that the potential for impacts from regional geologic hazards would be less than significant. Pursuant to project conditions of approval, the owner/permittee would be required to submit an updated geological investigation report or update letter to City staff for review and approval prior to project construction. The project would not result in a rupture of any known earthquake fault. Impacts would be less than significant.

The Project site is not within a known area subject to flooding nor will the design increase the storm water flow volumes or rates. In fact, the Project will increase the amount of onsite storm water treatment and retention per the requirements of the City of San Diego and Regional Water Control Board.

Implementation of the Project will include compliance with the City's exacting Brush Management requirements. The Project will include retaining walls and thinning of brush per the SDMC and Alternative Compliance. The Brush Management Program has been reviewed by the Fire Marshall and the Landscape Section of Development Services and deemed to meet and exceed the requirements of the SDMC. Therefore, the proposed development will minimize the alteration of natural land forms and will not result in undue risk from geologic and erosional forces, flood hazards, or fire hazards.

3. The proposed development will be sited and designed to prevent adverse impacts on any adjacent environmentally sensitive lands.

The Project is redeveloping a site that is currently developed with buildings and associated hardscape and ornamental landscape. Portions of the site include sensitive habitat, but those areas will be minimally disturbed, as the bulk of the proposed work is located in the existing development area.

The Project site includes a remnant, urban canyon that includes both native and non-native vegetation. Of the 2.34-acres of grading associated with the Project, the bulk of the area graded is currently developed, non-native vegetation, disturbed land, and ornamental. The grading will impact approximately 0.32 acres of vegetated area, including 0.09-acres of Diegan coastal sage scrub which is classified as sensitive vegetation community (Tier II). The City's policies and Biological Guidelines consider impacts less than a 0.10-acre as not significant impact and do not require mitigation. The regraded slopes, outside of the building pad, will be replanted with native plant materials appropriate with the site, soil, and aspect, including Diegan coastal sage scrub. The proposed Project includes modified Brush Management Zone 2 on the slopes which is considered "impact neutral."

The Project is redeveloping in an area that has been disturbed with existing development, and would implement all required development regulations to avoid any indirect impacts to adjacent environmentally sensitive lands (ESL); therefore, the project would avoid adverse impacts to ESL, both on- and off-site.

4. The proposed development will be consistent with the City of Sand Diego's Multiple Species Conservation Program (MSCP) Subarea Plan and Vernal Pool Habitat Conservation Plan (VPHCP).

The Project is not within or adjacent to the Multiple Habitat Planning Area (MHPA) nor any Vernal Pool habitat or the VPCHP. The site consists of mostly non-native vegetation and developed/disturbed areas. The Project proposes grading, which would impact approximately 0.32 acres, of which approximately 0.09-acres is Diegan coastal sage scrub. The City policies and Biological Guidelines consider impacts to less than 0.10-acres of Diegan coastal sage scrub as not significant and no mitigation is required. The slopes that are disturbed would be replanted with native plan materials that are appropriate to the site and soil, including Diegan coastal sage scrub. The proposed grading and revegetation is consistent with the City's Biological Guidelines, and the project does not have any impacts to either the MHPA or the VPHCP. Therefore, the proposed development will be consistent with the City of San Diego's MSCP Subarea Plan and VPHCP.

The above findings are supported by the minutes, maps and exhibits, all of which are incorporated herein by this reference.

ATTACHMENT 4

BE IT FURTHER RESOLVED that, based on the findings herein before adopted by the Planning Commission, Site Development Permit No. 2487401 and Neighborhood Development Permit No. 2579728 is hereby GRANTED by the Planning Commission to the referenced Owner/Permittee, in the form, exhibits, terms and conditions as set forth in Site Development Permit No. 2487401 and Neighborhood Development Permit No. 2579728, a copy of which is attached hereto and made a part hereof.

Martha Blake Development Project Manager Development Services

Adopted on: December 16, 2021

IO#: 24008739

RECORDING REQUESTED BY

CITY OF SAN DIEGO DEVELOPMENT SERVICES PERMIT INTAKE, MAIL STATION 501

WHEN RECORDED MAIL TO PROJECT MANAGEMENT PERMIT CLERK MAIL STATION 501

INTERNAL ORDER NUMBER: 24008739

SPACE ABOVE THIS LINE FOR RECORDER'S USE

SITE DEVELOPMENT PERMIT NO. 2487401

NEIGHBORHOOD DEVELOPMENT PERMIT NO. 2579728 CLAIREMONT SDP/TM PROJECT NO. 677814 PLANNING COMMISSION

This Site Development Permit No. 2487401 and Neighborhood Development Permit No. 2579728 [Permit] is granted by the Planning Commission of the City of San Diego to 3450 Clairemont LLC, a Delaware limited liability company, Owner/Permittee and Warmington Residential, Owner, pursuant to San Diego Municipal Code [SDMC] section 126.0505, 126.0404, and 126.0110. The 3.28 -acre site is located at 3450 Clairemont Drive in the RM-1-1 Zone of the Clairemont Mesa Community Plan. The project site is legally described as that portion of Lot 978 of Clairemont Unit No. 6, in the City of San Diego, County of San Diego, State of California, According to Map Thereof No. 2865, filed in the office of the County Recorder of San Diego County, April 18, 1952.

Subject to the terms and conditions set forth in this Permit, permission is granted to Owner/Permittee to demolish two existing buildings and construct a multiple-story, 40-unit townhome development, subject to the City's land use regulations described and identified by size, dimension, quantity, type, and location on the approved exhibits [Exhibit "A"] dated December 16, 2021, on file in the Development Services Department.

The project shall include:

- a. Demolition of two existing building and associated improvements and construction of a three-story, 89,250 square-foot, 40-unit townhome development;
- b. Landscaping (planting, irrigation and landscape related improvements);
- c. Off-street parking;
- d. Retaining wall up to 14'3" in height; and
- e. Public and private accessory improvements determined by the Development Services
 Department to be consistent with the land use and development standards for this site in
 accordance with the adopted community plan, the California Environmental Quality Act

[CEQA] and the CEQA Guidelines, the City Engineer's requirements, zoning regulations, conditions of this Permit, and any other applicable regulations of the SDMC.

STANDARD REQUIREMENTS:

- 1. This Permit must be utilized within thirty-six (36) months after the date on which all rights of appeal have expired. If this permit is not utilized in accordance with Chapter 12, Article 6, Division 1 of the SDMC within the 36-month period, this permit shall be void unless an Extension of Time has been granted. Any such Extension of Time must meet all SDMC requirements and applicable guidelines in effect at the time the extension is considered by the appropriate decision maker. This permit must be utilized by January 4, 2025.
- 2. No permit for the construction, occupancy, or operation of any facility or improvement described herein shall be granted, nor shall any activity authorized by this Permit be conducted on the premises until:
 - a. The Owner/Permittee signs and returns the Permit to the Development Services Department; and
 - b. The Permit is recorded in the Office of the San Diego County Recorder.
- 3. While this Permit is in effect, the subject property shall be used only for the purposes and under the terms and conditions set forth in this Permit unless otherwise authorized by the appropriate City decision maker.
- 4. This Permit is a covenant running with the subject property and all of the requirements and conditions of this Permit and related documents shall be binding upon the Owner/Permittee and any successor(s) in interest.
- 5. The continued use of this Permit shall be subject to the regulations of this and any other applicable governmental agency.
- 6. Issuance of this Permit by the City of San Diego does not authorize the Owner/Permittee for this Permit to violate any Federal, State or City laws, ordinances, regulations or policies including, but not limited to, the Endangered Species Act of 1973 [ESA] and any amendments thereto (16 U.S.C. § 1531 et seq.).
- 7. The Owner/Permittee shall secure all necessary building permits. The Owner/Permittee is informed that to secure these permits, substantial building modifications and site improvements may be required to comply with applicable building, fire, mechanical, and plumbing codes, and State and Federal disability access laws.
- 8. Construction plans shall be in substantial conformity to Exhibit "A." Changes, modifications, or alterations to the construction plans are prohibited unless appropriate application(s) or amendment(s) to this Permit have been granted.

9. All of the conditions contained in this Permit have been considered and were determined necessary to make the findings required for approval of this Permit. The Permit holder is required to comply with each and every condition in order to maintain the entitlements that are granted by this Permit.

If any condition of this Permit, on a legal challenge by the Owner/Permittee of this Permit, is found or held by a court of competent jurisdiction to be invalid, unenforceable, or unreasonable, this Permit shall be void. However, in such an event, the Owner/Permittee shall have the right, by paying applicable processing fees, to bring a request for a new permit without the "invalid" conditions(s) back to the discretionary body which approved the Permit for a determination by that body as to whether all of the findings necessary for the issuance of the proposed permit can still be made in the absence of the "invalid" condition(s). Such hearing shall be a hearing de novo, and the discretionary body shall have the absolute right to approve, disapprove, or modify the proposed permit and the condition(s) contained therein.

10. The Owner/Permittee shall defend, indemnify, and hold harmless the City, its agents, officers, and employees from any and all claims, actions, proceedings, damages, judgments, or costs, including attorney's fees, against the City or its agents, officers, or employees, relating to the issuance of this permit including, but not limited to, any action to attack, set aside, void, challenge, or annul this development approval and any environmental document or decision. The City will promptly notify Owner/Permittee of any claim, action, or proceeding and, if the City should fail to cooperate fully in the defense, the Owner/Permittee shall not thereafter be responsible to defend, indemnify, and hold harmless the City or its agents, officers, and employees. The City may elect to conduct its own defense, participate in its own defense, or obtain independent legal counsel in defense of any claim related to this indemnification. In the event of such election, Owner/Permittee shall pay all of the costs related thereto, including without limitation reasonable attorney's fees and costs. In the event of a disagreement between the City and Owner/Permittee regarding litigation issues, the City shall have the authority to control the litigation and make litigation related decisions, including, but not limited to, settlement or other disposition of the matter. However, the Owner/Permittee shall not be required to pay or perform any settlement unless such settlement is approved by Owner/Permittee.

CLIMATE ACTION PLAN REQUIREMENTS:

11. Owner/Permittee shall comply with the Climate Action Plan (CAP) Consistency Checklist stamped as Exhibit "A." Prior to issuance of any construction permit, all CAP strategies shall be noted within the first three (3) sheets of the construction plans under the heading "Climate Action Plan Requirements" and shall be enforced and implemented to the satisfaction of the Development Services Department.

AFFORDABLE HOUSING REQUIREMENTS:

12. Prior to the issuance of any construction permits, the Owner/Permittee shall demonstrate compliance with the provisions of the Inclusionary Affordable Housing Regulations of San Diego Municipal Code Chapter 14, Article 2, Division 13 and the Inclusionary Housing Procedures Manual.

13. Prior to the issuance of any construction permits, the Owner/Permittee shall enter into a written Agreement with the San Diego Housing Commission which shall be drafted and approved by the San Diego Housing Commission, executed by the Owner/Permittee, and secured by a deed of trust which incorporates applicable affordability conditions consistent with the San Diego Municipal Code. The Agreement will specify that in exchanges for the City's approval of the Project, the Owner/Permittee shall provide 1 (one) affordable unit with prices of no more than 100% AMI.

AIRPORT REQUIREMENTS:

14. Prior to issuance of the construction permit, the Owner/Permittee shall provide a valid "Determination of No Hazard to Air Navigation" issued by the Federal Aviation Administration [FAA].

ENGINEERING REQUIREMENTS:

- 15. This Permit shall comply with the conditions of the Final Map for Clairemont Drive Vesting Tentative Map No. 2487402.
- 16. Prior to the issuance of any construction permits, the Owner/Permittee shall assure by permit and bond the dedication and improvement of an additional 4 feet of public right-of-way adjacent to the site on Clairemont Drive, satisfactory to the City Engineer.
- 17. Whenever street public rights-of-way are required to be dedicated, it is the responsibility of the Owner/Permittee to provide the right-of-way free and clear of all encumbrances and prior easements. The Owner/Permittee must secure "subordination agreements" for minor distribution facilities and/or "joint-use agreements" for major transmission facilities.
- 18. Prior to the issuance of any construction permits, the Owner/Permittee shall obtain an Encroachment Maintenance Removal Agreement (EMRA) for the landscape and irrigation located within the Clairemont Drive public right-of-way, satisfactory to the City Engineer.
- 19. Prior to the issuance of any construction permit, the Owner/Permittee shall assure by permit and bond the construction of a new 25-foot wide City standard driveway on Clairemont Drive, satisfactory to the City Engineer.
- 20. Prior to the issuance of any construction permit, the Owner/Permittee shall assure by permit and bond the removal of the existing curb, gutter, and sidewalk and replacement with new City standard curb, gutter, and sidewalk, adjacent to the site on Clairemont Drive, satisfactory to the City Engineer.

LANDSCAPE REQUIREMENTS:

21. Prior to issuance of any construction permit for grading, the Owner/Permittee shall submit complete construction documents for the revegetation and hydro-seeding of all disturbed land in accordance with the City of San Diego Landscape Standards and to the satisfaction of the Development Services Department. All plans shall be in substantial conformance to this permit

(including Environmental conditions) and Exhibit "A," on file in the Development Services Department.

- 22. Prior to issuance of any construction permit for public improvements, the Owner/Permittee shall submit complete landscape construction documents for right-of-way improvements to the Development Services Department for approval. Improvement plans shall show, label, and dimension a 40 square-foot area around each tree which is unencumbered by utilities. Driveways, utilities, drains, water and sewer laterals shall be designed so as not to prohibit the placement of street trees.
- 23. Prior to issuance of any construction permits (including shell), the Owner/Permittee shall submit complete landscape and irrigation construction documents, which are consistent with the Landscape Standards, to the Development Services Department for approval. The construction documents shall be in substantial conformance with Exhibit "A," Landscape Development Plan, on file in the Development Services Department. Construction plans shall provide a 40 square-foot area around each tree that is unencumbered by hardscape and utilities unless otherwise approved per SDMC section 142.0403(b)6.
- 24. The Owner/Permittee shall be responsible for the maintenance of all landscape improvements shown on the approved plans, including in the right-of-way, unless long-term maintenance of said landscaping will be the responsibility of another entity approved by the Development Services Department. All required landscape shall be maintained consistent with the Landscape Standards in a disease, weed, and litter free condition at all times. Severe pruning or "topping" of trees is not permitted.
- 25. If any required landscape (including existing or new plantings, hardscape, landscape features, etc.) indicated on the approved construction documents is damaged or removed, the Owner/Permittee shall repair and/or replace in kind and equivalent size per the approved documents to the satisfaction of the Development Services Department within 30 days of damage or Certificate of Occupancy.

BRUSH MANAGEMENT PROGRAM REQUIREMENTS:

- 26. The Owner/Permittee shall implement the following requirements in accordance with the Brush Management Program shown on Exhibit "A" on file in the Development Services Department.
- 27. The Brush Management Program shall be based on a standard Zone One of 35 feet in width and a Zone Two of 65 feet in width, extending out from the structures towards the native/naturalized vegetation, consistent with SDMC section 142.0412. Zone One shall range from 14 feet to 17 feet in width with a corresponding Zone Two of 10 feet to 65 feet in width.
- 28. The Owner/Permittee shall provide a radiant heat wall as shown on the Brush Management Plan at the interface of Zones One and Two as alternative compliance for the reduced Brush Management Zones. A Zone One condition shall be maintained in the yard space between the radiant heat wall and the habitable structure.

- 29. Prior to issuance of any construction permit for grading, landscape construction documents required for the engineering permit shall be submitted showing the brush management zones on the property in substantial conformance with Exhibit "A."
- 30. Prior to issuance of any construction permits, a complete Brush Management Program shall be submitted for approval to the Development Services Department and shall be in substantial conformance with Exhibit "A" on file in the Development Services Department. The Brush Management Program shall comply with the City of San Diego's Landscape Regulations and the Landscape Standards.
- 31. Within Zone One, combustible accessory structures (including, but not limited to decks, trellises, gazebos, etc.) shall not be permitted while accessory structures of non-combustible, one-hour fire-rated, and/or Type IV heavy timber construction may be approved within the designated Zone One area subject to Fire Marshal's approval.
- 32. The Brush Management Program shall be maintained at all times in accordance with the City of San Diego's Landscape Standards.

PLANNING/DESIGN REQUIREMENTS:

- 33. The automobile, motorcycle and bicycle parking spaces must be constructed in accordance with the requirements of the SDMC. All on-site parking stalls and aisle widths shall be in compliance with requirements of the City's Land Development Code and shall not be converted and/or utilized for any other purpose, unless otherwise authorized in writing authorized by the appropriate City decision maker in accordance with the SDMC.
- 34. A topographical survey conforming to the provisions of the SDMC may be required if it is determined, during construction, that there may be a conflict between the building(s) under construction and a condition of this Permit or a regulation of the underlying zone. The cost of any such survey shall be borne by the Owner/Permittee.
- 35. Prior to the issuance of any construction permits, the Owner/Permittee shall execute and record a Covenant of Easement which ensures preservation of the Environmentally Sensitive Lands that are outside the allowable development area on the premises as shown on Exhibit "A" for Sensitive Vegetation and Steep Slopes in accordance with SDMC section 143.0152. The Covenant of Easement shall include a legal description and an illustration of the premises showing the development area and the Environmentally Sensitive Lands as shown on Exhibit "A."
- 36. All signs associated with this development shall be consistent with sign criteria established by either the approved Exhibit "A" or City-wide sign regulations.
- 37. All private outdoor lighting shall be shaded and adjusted to fall on the same premises where such lights are located and in accordance with the applicable regulations in the SDMC.

GEOLOGY REQUIREMENTS

- 38. Prior to the issuance of any construction permits (either grading or building), the Owner/ Permittee shall submit a geotechnical investigation report or update letter prepared in accordance with the City's "Guidelines for Geotechnical Reports" that specifically addresses the proposed construction plans. The geotechnical investigation report or update letter shall be reviewed for adequacy by the Geology Section of the Development Services Department prior to issuance of any construction permits.
- 39. The Owner/ Permittee shall submit an as-graded geotechnical report prepared in accordance with the City's "Guidelines for Geotechnical Reports" following completion of the grading. The asgraded geotechnical report shall be reviewed for adequacy by the Geology Section of the Development Services Department prior to exoneration of the bond and grading permit close-out.

PUBLIC UTILITIES DEPARTMENT REQUIREMENTS:

- 40. Prior to the issuance of any construction permits, the Owner/Permittee shall assure, by permit and bond, the design and construction of new water and sewer service(s) outside of any driveway or drive aisle and the abandonment of any existing unused water and sewer services within the right-of-way adjacent to the project site, in a manner satisfactory to the Public Utilities Director and the City Engineer.
- 41. Owner/Permittee shall apply for a construction permit for plumbing for the installation of appropriate private back flow prevention device(s), on each water service (domestic, fire and irrigation), in a manner satisfactory to the Public Utilities Director and the City Engineer. BFPDs shall be located above ground on private property, in line with the service and immediately adjacent to the right-of-way.
- 42. All proposed private water and sewer facilities are to be designed to meet the requirements of the California Uniform Plumbing Code and will be reviewed as part of the building permit plan check.
- 43. Prior to the issuance of any construction permit, the Owner/Permittee shall assure, by permit and bond the design and construction of an 8-inch PVC public sewer on Clairemont Drive as shown on the approved Exhibit "A", in a manner satisfactory to the Public Utilities Director and the City Engineer.
- 44. No trees or shrubs exceeding three feet in height at maturity shall be installed within ten feet of any sewer facilities and five feet of any water facilities.
- 45. The Owner/Permittee shall obtain an Encroachment Maintenance Removal Agreement for the private sewer laterals encroaching into the Public Right-of-Way.

INFORMATION ONLY:

- The issuance of this discretionary permit alone does not allow the immediate commencement
 or continued operation of the proposed use on site. Any operation allowed by this
 discretionary permit may only begin or recommence after all conditions listed on this permit
 are fully completed and all required ministerial permits have been issued and received final
 inspection.
- Any party on whom fees, dedications, reservations, or other exactions have been imposed as conditions of approval of this Permit, may protest the imposition within ninety days of the approval of this development permit by filing a written protest with the City Clerk pursuant to California Government Code-section 66020.
- This development may be subject to impact fees at the time of construction permit issuance.

APPROVED by the Planning Commission of the City of San Diego on December 16, 2021.



ATTACHMENT 5

Approval: Site Development Permit No. 2487401 Neighborhood Development Permit No. 2579728 Date of Approval: December 16, 2021

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Martha Blake
Development Project Manager

NOTE: Notary acknowledgment must be attached per Civil Code section 1189 et seq.

The undersigned Owner/Permittee, by execution hereof, agrees to each and every condition of this Permit and promises to perform each and every obligation of Owner/Permittee hereunder.

3450 Clairemont LLCOwner/Permittee

By _____ NAME TITLE

NOTE: Notary acknowledgments must be attached per Civil Code section 1189 et seq.

PLANNNING COMMISSION RESOLUTION NUMBER _____

VESTING TENTATIVE MAP NO. 2487402 CLAIREMONT SDP/VTM - PROJECT NO. 677814

WHEREAS, 3450 Clairemont LLC and Warmington Residential, Subdivider, and Rick Engineering, Engineer, submitted an application to the City of San Diego for a vesting tentative map, Vesting Tentative Map No. 2487402 for the subdivision of an existing 3.28-acre parcel into a single lot for condominium purposes. The project site is located at 3450 Clairemont Drive in the RM-1-1 Zone and the Clairemont Mesa Community Planning area. The property is legally described as a portion of lot 978 of Clairemont Unit No. 6, Map No. 2865, City of San Diego, County of San Diego; and

WHEREAS, the Map proposes the Subdivision of a 3.28-acre-site into one parcel for condominium purposes; and

WHEREAS, the project complies with the requirements of a preliminary soils and/or geological reconnaissance report pursuant to Subdivision Map Act sections 66490 and 66491(b)-(f) and San Diego Municipal Code (SDMC) section 144.0220; and

WHEREAS, the subdivision is a condominium project as defined in California Civil Code section 4125 and filed pursuant to the Subdivision Map Act. The total number of condominium dwelling units is 40; and

WHEREAS, on December 16, 2021, the Planning Commission of the City of San Diego considered Vesting Tentative Map No. 2487402, and pursuant to SDMC sections 125.0440, 144.0240, and Subdivision Map Act section 66428, received for its consideration written and oral presentations, evidence having been submitted, and testimony having been heard from all

interested parties at the public hearing, and the Planning Commission having fully considered the matter and being fully advised concerning the same; NOW THEREFORE,

BE IT RESOLVED by the Planning Commission of the City of San Diego, that it adopts the following findings with respect to Vesting Tentative Map No. 2487402:

1. The proposed subdivision and its design or improvement are consistent with the policies, goals, and objectives of the applicable land use plan.

The development is consistent with the City of San Diego General Plan and the Clairemont Mesa Community Plan, which designates the area for residential. The project implements the goals and policies of these documents by creating a pedestrian-oriented development that accommodates a portion of the region's housing needs, while minimizing the environmental impacts of the development. The subdivision will retain the community character by encouraging orderly, sequential development compatible in its intensity with surrounding existing and future land development. Therefore, the proposed subdivision and its design and improvements are consistent with the policies, goals, and objectives of the applicable land use plan, including protecting open space opportunities, and providing a residential development that supports reduced vehicle miles traveled and transit ridership.

2. The proposed subdivision complies with the applicable zoning and development regulations of the Land Development Code, including any allowable deviations pursuant to the land development code.

The design and proposed improvements for the subdivision are consistent with the zoning and development regulations of the RM-1-1 Zone in that:

- The development provides the minimum frontage on a dedicated street which is open to and usable by vehicle traffic allowed under the Site Development Permit (SDP);
- The development, as a whole, meets the minimum lot area requirements of the zones;
- The development provides the required off-street vehicle parking spaces of the zones;
- All lots are designed so that required improvements result in conforming lots in respect to building area, setbacks, side yards, and rear yard regulations, except for a small portion of a retaining wall that exceeds the associated height limit through an NDP;
- All lots meet the maximum height regulations for the zones; and

Development of the site is controlled by SDP No. 2487401 and NDP No. 2579728.

The project has been designed to comply with the development regulations of the SDMC including requirements for floor area ratio, open space, grading, landscaping, etc., and all other requirements of the development criteria.

3. The site is physically suitable for the type and density of development.

The site is physically suitable for residential development and its location and scale are consistent with the City's General Plan and the Clairemont Mesa Community Plan and is consistent in types and intensity of use with surrounding developments. The scale, height, bulk, density, and coverage of development is consistent with both the land use plan and zoning designation. In addition, grading is proposed to ensure soil and slope stability will be suitable for the proposed three-story buildings. Access to the project site is provided from a new driveway to an existing public street, and the site is served by all required utilities such as electric, water, and sewer. As a result, the site is physically suitable for the design and siting of the proposed project and for the type and density of development.

4. The design of the subdivision or the proposed improvements are not likely to cause substantial environmental damage or substantially and avoidably injure fish or wildlife or their habitat.

Project specific analyses were prepared for Waste Management, Storm Water/Hydrology, Sewer, Greenhouse Gas, Noise, Air Quality, Natural Resources, and Geology. Based upon the reports and compliance with the City's development regulations and the California Environmental Quality Act, it was concluded that the project will not result in significant direct impacts, and Negative Declaration No. 677814 was prepared for the Project.

Implementation of the project design features such as controls on run-off, noise, lighting and invasive plants, construction of appropriate barriers, landscaping, and implementation of brush management techniques in accordance with the City's Land Development Code. In addition, water quality measures and storm water detention facilities are incorporated into the project's design to avoid on-site or off-site impacts to fish or wildlife or their habitats to the maximum extent feasible.

As such, with the implementation of these mitigation measures, under the Subdivision Map Act (Government Code 66474.01) and SDMC section 125.0441, the City may approve the tentative map without any substantial environmental damage or substantially unavoidable injury to fish or wildlife or their habitat by the design of the subdivision or proposed improvements.

5. The design of the subdivision or the type of improvement will not be detrimental to the public health, safety, and welfare.

The design of the subdivision and the type of improvements will not be detrimental to the public health, safety, and welfare. The project, together with the existing surrounding land development (provision of roadways, utilities, drainage infrastructure, preservation of open

space, etc.) in the Clairemont Mesa Community Plan have been designed to conform with the City of San Diego's codes, policies, and regulations whose primary focus is the protection of the public's health, safety, and welfare. The development contains conditions addressing the project compliance with the City's regulations and policies and other regional, state, and federal regulations to prevent detrimental impacts to the public health, safety, and welfare. Compliance with these regulations, along with permit conditions and implementation of project design features would result in a project which does not adversely affect the public health, safety, and welfare.

The project-level geological report demonstrates the grading proposed in connection with the development will not result in soil erosion, silting of lower slopes, slide damage, flooding, severe scarring, or any other geological instability, which would affect public health, safety, and welfare in the opinion of the City Engineer. The hydrology/drainage analysis also demonstrates no rise up or down-stream or on-site relative to flood elevations which in combination with the geological analysis show that flooding or severe scarring will not occur as a result of grading operations. Conditions included within the permit require the timely planting of all slopes to prevent erosion and to provide additional slope stability.

The project will have adequate levels of essential public services available to it (including police, fire, and medical) through conditions within the development permit. Other services, such as schools, public parks, and library resources, would be adequate for the project, as would necessary utilities such as electricity, water, and sewer. The project would pay its fair share of the cost of all of these services through impact fees, ad-hoc fees, in-kind contributions, and/or tax revenue increases.

The project, as conditioned, requires compliance with several operational constraints and development controls intended to assure the continued public health, safety, and welfare. Conditions of approval address lighting, the generation of noise, the appearance of landscaping, the placement of buildings, and Best Management Practices (BMPs) for storm water impacts. All Uniform Building, Fire, Plumbing, Electrical, Mechanical Code, and the Municipal Code regulations governing the construction and continued operation of the development apply to this site to prevent adverse effects to those persons or other properties in the vicinity. Prior to the actual construction of residential units on the subject property, City staff will review building permit plans against the Uniform Building Code to assure that structural, mechanical, electrical, plumbing, and access components of the project are designed to protect the public's health, safety, and welfare.

6. The design of the subdivision or the type of improvements will not conflict with easements acquired by the public at large for access through or use of property within the proposed subdivision.

The design of the subdivision and the type of improvements are such that they will not conflict with any easements, acquired by the public at large, for access through or use of property within the proposed subdivision. All easements granted to the City over the property have been left in place and are not affected by the proposed development.

7. The design of the proposed subdivision provides, to the extent feasible, for future passive or natural heating and cooling opportunities.

The proposed subdivision will not impede or inhibit any future passive or natural heating and cooling opportunities. The design of the subdivision implements the best use of the land to minimize grading and preserving environmentally sensitive lands. With the independent design of the proposed subdivision each structure will provide to the extent feasible, for future passive or natural heating and cooling opportunities through use of building materials, site orientation, architectural treatments, placement, and selection of plant materials that provide passive or natural heating and cooling opportunities.

The development will provide natural ventilation strategies in areas of the buildings zoned to incorporate operable windows and high-performance building materials. The architectural design incorporates these facilities into the project to minimize the visual effects of the project. The project also incorporates of drought resistant and native plant materials. Combined, these design features and the proposed improvements for the subdivision are consistent with California Government Code Section 66473.1 and SDMC section 125.0440(g) because they promote passive or natural heating and cooling opportunities.

8. The decision maker has considered the effects of the proposed subdivision on the housing needs of the region and that those needs are balanced against the needs for public services and the available fiscal and environmental resources.

The project proposes to develop 40 multi-unit residential units within the RM-1-1 Zone and consistent with the Clairemont Mesa Community Plan and the surrounding neighborhood. All appropriate public services (including fire, police, medical, schools, public parks, and libraries) as well as necessary utilities such as electricity, water, and sewer, will be available to and adequate for the project prior to occupancy. The effects of the proposed subdivision on the housing needs of the region have been considered, and those needs are balanced against the needs for public services and the available fiscal and environmental resources in conformance with the Subdivision Map Act Section 66412.3 and the SDMC section 125.0440(h).

The above findings are supported by the minutes, maps, and exhibits, all of which are herein incorporated by reference.

BE IT FURTHER RESOLVED, that based on the Findings hereinbefore adopted by the Planning Commission, Vesting Tentative Map No. 2487402, hereby granted to 3450 Clairemont LLC and Warmington Residential subject to the attached conditions which are made a part of this resolution by this reference.

Ву _____

Martha Blake Development Project Manager Development Services Department

PLANNING COMMISSIONCONDITIONS FOR VESTING TENTATIVE MAP NO. 2487402 CLAIREMONT SDP/TM - PROJECT NO. 677814 ADOPTED BY RESOLUTION NO. XXXXXXXXX ON DECEMBER 16, 2021

GENERAL

- 1. This Vesting Tentative Map will expire January 4, 2025.
- 2. Compliance with all of the following conditions shall be completed and/or assured, to the satisfaction of the City Engineer, prior to the recordation of the Final Map, unless otherwise noted.
- 3. Prior to the expiration of the Tentative Map, a Final Map to subdivide the property into forty (40) residential condominium units shall be recorded with the County Recorder's office.
- 4. Prior to the recordation of the Final Map, taxes must be paid or bonded for this property pursuant to Section 66492 of the Subdivision Map Act. A current original tax certificate, recorded in the office of the San Diego County Recorder, must be provided to satisfy this condition.

If a tax bond is required as indicated in the tax certificate, ensure that is it paid or posted at the County Clerk of the Board of Supervisors Office and supply proof prior to the recordation of the Final Map.

ENGINEERING

- 5. The Final Map shall comply with the provisions of Site Development Permit No. 2487401 and NDP No. 2579728.
- 6. The drainage system proposed for this subdivision, as shown on the approved vesting tentative map, is private and subject to approval by the City Engineer.
- 7. The Subdivider shall enter into a Maintenance Agreement for the ongoing permanent Best Management Practices (BMPs) maintenance, satisfactory to the City Engineer.
- 8. Prior to the issuance of any construction permit, the Subdivider shall submit a Technical Report that will be subject to final review and approval by the City Engineer, based on the Storm Water Standards in effect at the time of the construction permit issuance.
- 9. The Subdivider shall obtain a bonded grading permit for the grading proposed for this project. All grading shall conform to the requirements of the City of San Diego Municipal Code in a manner satisfactory to the City Engineer.
- 10. Prior to the issuance of any construction permit, the Subdivider shall incorporate any construction Best Management Practices necessary to comply with Chapter 14, Article 2, Division 1 (Grading Regulations) of the SDMC, into the construction plans or specifications.

- 11. Development of this project shall comply with all storm water construction requirements of the State Construction General Permit, Order No. 2009-0009DWQ, or subsequent order, and the Municipal Storm Water Permit, Order No. R9-2013-0001, or subsequent order. In accordance with Order No. 2009-0009DWQ, or subsequent order, a Risk Level Determination shall be calculated for the site and a Storm Water Pollution Prevention Plan (SWPPP) shall be implemented concurrently with the commencement of grading activities.
- 12. Prior to issuance of a construction permit for grading, a copy of the Notice of Intent (NOI) with a valid Waste Discharge ID number (WDID#) shall be submitted to the City of San Diego as a proof of enrollment under the Construction General Permit. When ownership of the entire site or portions of the site changes prior to filing of the Notice of Termination (NOT), a revised NOI shall be submitted electronically to the State Water Resources Board in accordance with the provisions as set forth in Section II.C of Order No. 2009-0009-DWQ and a copy shall be submitted.
- 13. The Subdivider shall ensure that all onsite utilities serving the subdivision shall be undergrounded with the appropriate permits. The subdivider shall provide written confirmation from applicable utilities that the conversion has taken place, or provide other means to assure the undergrounding, satisfactory to the City Engineer.

MAPPING

- 14. Prior to the recordation of the Final Map, all private streets and drives shall be shown with bearings and distances along the centerline and width of the streets shown on a non-title sheet on the Final Map. The street names shall be submitted to Building Development Review-Street Name Coordinator for approval and published on the Final Map.
- 15. The Final Map shall be based on field survey and all lot corners must be marked with durable survey monuments pursuant to Section 144.0311(d) of the City of San Diego Land Development Codes and Subdivision Map Act Section 66495.
 - All survey monuments shall be set prior to the recordation of the final Map, unless the setting of monuments is deemed impractical due to the proposed improvements and/or grading associated with the project, in which case, delayed monumentation may be applied on the Final Map in accordance with Section 144.0130 of the City of San Diego Land Development Code.
- 16. All subdivision maps in the City of San Diego are required to be tied to the California Coordinate System of 1983 (CCS83), Zone 6 pursuant to section 8801 through 8819 of the California Public Resources Code.
- 17. The Final Map shall:
 - a. Use the California Coordinate System for its "Basis of Bearings" and express all measured and calculated bearing values in terms of said system. The angle of grid divergence from a true meridian (theta or mapping angle) and the north point of said map shall appear on each sheet thereof. Establishment of said Basis of Bearings may be by use of existing Horizontal Control stations or astronomic observations.

b. Show two measured ties from the boundary of the map to existing Horizontal Control stations having California Coordinate values of First Order accuracy. These tie lines to the existing control shall be shown in relation to the California Coordinate System (i.e., grid bearings and grid distances). All other distances shown on the map are to be shown as ground distances. A combined factor for conversion of grid-toground shall be shown on the map.

PUBLIC UTILITIES

18. Prior to the issuance of any construction permits, the Subdivider shall assure, by permit and bond, the design and construction of new water and sewer service(s) outside of any driveway or drive aisle and the abandonment of any existing unused water and sewer services within the right-of-way adjacent to the project site, in a manner satisfactory to the Public Utilities Director and the City Engineer.

LANDSCAPE/BRUSH MANAGEMENT

19. Prior to recordation of the Final Map, the Subdivider shall identify on a separate sheet titled 'Non-title Sheet' the brush management areas in substantial conformance with Exhibit "A."

These brush management areas shall be identified with a hatch symbol with no specific dimensions or zones called out. The following note shall be provided on the 'Non-Title Sheet' to identify the hatched areas: "Indicates fire hazard zone(s) per SDMC section 142.0412 of the Land Development Code."

INFORMATION:

- The approval of this Vesting Tentative Map by the City Council of the City of San Diego does not authorize the subdivider to violate any Federal, State, or City laws, ordinances, regulations, or policies including but not limited to, the Federal Endangered Species Act of 1973 and any amendments thereto (16 USC § 1531 et seq.).
- If the Subdivider makes any request for new water and sewer facilities (including services, fire hydrants, and laterals), the Subdivider shall design and construct such facilities in accordance with established criteria in the most current editions of the City of San Diego water and sewer design guides and City regulations, standards and practices pertaining thereto. Off-site improvements may be required to provide adequate and acceptable levels of service and will be determined at final engineering.
- Subsequent applications related to this Vesting Tentative Map will be subject to fees and charges based on the rate and calculation method in effect at the time of payment.
- Any party on whom fees, dedications, reservations, or other exactions have been imposed as conditions of approval of the Vesting Tentative Map, may protest the imposition within ninety days of the approval of this Vesting Tentative Map by filing a

written protest with the San Diego City Clerk pursuant to Government Code Sections 66020 and/or 66021.

- Where in the course of development of private property, public facilities are damaged or removed, the Subdivider shall at no cost to the City, obtain the required permits for work in the public right-of-way, and repair or replace the public facility to the satisfaction of the City Engineer (SDMC section 142.0607).
- This development may be subject to impact fees, as established by the City Council, at the time of issuance of building permits.
- This development may be subject to payment of School Impact Fees at the time of issuance of building permits, as provided by Education Code Section 17620, in accordance with procedures established by the Director of Building Inspection.

Internal Order No. 24008739



RESOLUTION NUMBER R-		
ADOPTED ON December 16,	. 2021	

WHEREAS, on December 16, 2021, 3850 CLAIREMONT LLC and WARMINGTON RESIDENTIAL CALIFORNIA INC. submitted an application to Development Services Department for a SITE DEVELOPMENT PERMIT (SDP), NEIGHBORHOOD DEVELOPMENT PERMIT (NDP), and VESTING TENTATIVE MAP (VTM) for the Clairemont Drive (Project); and

WHEREAS, the matter was set for a public hearing to be conducted by the Planning Commission of the City of San Diego; and

WHEREAS, the issue was heard by the Planning Commission on December 16, 2021; and

WHEREAS, the Planning Commission considered the issues discussed in Negative Declaration No. 677814 (Declaration) prepared for this Project; NOW THEREFORE,

BE IT RESOLVED, by the Planning Commission that it has certified that the Declaration has been completed in compliance with the California Environmental Quality Act of 1970 (CEQA) (Public Resources Code Section 21000 et seq.), as amended, and the State CEQA Guidelines thereto (California Code of Regulations, Title 14, Chapter 3, Section 15000 et seq.), that the Declaration reflects the independent judgment of the City of San Diego as Lead Agency and that the information contained in said Declaration, together with any comments received during the public review process, has been reviewed and considered by the Planning Commission in connection with the approval of the Project.

BE IT FURTHER RESOLVED, that the Planning Commission finds on the basis of the entire record, including the Initial Study and any comments received, that there is no substantial evidence that the Project will have a significant effect on the environment, and therefore, that said Declaration is hereby adopted.

BE IT FURTHER RESOLVED, that the Declaration and other documents constituting the record of proceedings upon which the approval is based are available to the public at the office of the DEVELOPMENT SERVICES DEPARTMENT, 1222 FIRST AVENUE, SAN DIEGO, CA 92101.

BE IT FURTHER RESOLVED, that DEVELOPMENT SERVICES STAFF is directed to file a Notice of Determination with the Clerk of the Board of Supervisors for the County of San Diego regarding the Project.

APPROVED:	or DEVELOPMENT PROJECT MANAG	ER
By:		
DEVELOPME	NT PROJECT MANAGER	

Page 3	City of S	620 N	May 202				
SD	City of Developme	San Diego nt Services	Comn Commit	nunity Planı ee Distribu F	ning tion orm		
Project Name: Clairemont Drive Mi Community: Claire	ultifamily SDP/	ТМ	Project Numbe 677814	r:			
·	log into Op	enDSD at <u>htt</u>	ps://aca.accela.com/	nager and applicant), SANDIEGO. to access project inforn	nation.		
● Vote to Appro □ Vote to Appro □ Vote to Appro □ Vote to Deny	ve with Conditi		w endations Listed Below				
# of Members Yes	,	# of Membe	rs No	# of Members Abstain			
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Conditions or Reco		S: 					
(Please specify, e.g		formation, Split v	ote, Lack of quorum, etc)			
NAME: Kevin J. Ca	rpenter, AIA						
TITLE: Chair, Proje	ect Review Sub	commitee		DATE: November 08, 2	2021		
	Attach additio	onal pages if n	ecessary (maximum 3	attachments).			



City of San Diego Development Services 1222 First Ave., MS 302 San Diego, CA 92101 (619) 446-5000

Ownership Disclosure Statement

FORM

DS-318

October 2017

Approval Type: Check appropriate box for type of ☐ Neighborhood Development Permit ☐ Site De ☐ Tentative Map ☐ Vesting Tentative Map ☐ Ma	velopment Permit 🚨 Planned Developm	nent Permit [Conditional Use P	ent Permit ermit 🗆 Variance
Project Title: Fourth Avenue Apartments		Project No	o. For City Use Only	588751
Project Address: 2426 4th Avenue				
San Diego, CA 92101				
Specify Form of Ownership/Legal Status (plea	ACCOUNTS OF THE PROPERTY OF TH			
☑ Corporation ☐ Limited Liability -or- ☐ General	l – What State? <u>CA</u> Corporate	Identification	No. <u>82-3614461</u>	
☐ Partnership ☐ Individual				
By signing the Ownership Disclosure Statement, with the City of San Diego on the subject proper owner(s), applicant(s), and other financially interindividual, firm, co-partnership, joint venture, as with a financial interest in the application. If the individuals owning more than 10% of the shares officers. (A separate page may be attached if new ANY person serving as an officer or director of A signature is required of at least one of the pronotifying the Project Manager of any changes in ownership are to be given to the Project Manager accurate and current ownership information could	erty with the intent to record an encurn ested persons of the above referenced sociation, social club, fraternal organiza e applicant includes a corporation or pa i. If a publicly-owned corporation, inclu- cessary.) If any person is a nonprofit org f the nonprofit organization or as true roperty owners. Attach additional page in ownership during the time the applicate er at least thirty days prior to any publicate at least thirty days prior to any publicate.	nbrance again property. A stion, corpora rtnership, inde de the names ganization or stee or bene stion is being thearing on t	nst the property. F financially interester tion, estate, trust, r clude the names, tit s, titles, and addres: a trust, list the nam ficiary of the none Note: The applicar	Please list below the d party includes any eceiver or syndicate cles, addresses of all ses of the corporate es and addresses of profit organization.
Property Owner				
Name of Individual: Fourth and Laurel LP		☑ Owner	☐ Tenant/Lessee	☐ Successor Agency
Street Address: 2820 Shelter Island Dr				
City: San Diego			State: CA	Zip: 92106
Phone No.: 858-518-7372	Fax No.:	Email: Rich	ard@nextspacedev.co	m
Signature:	in Ager	Date: 10/31	/18	
Additional pages Attached:	⊠ No			
Applicant	4.00.41			
Name of Individual: Richard Simis		☑ Owner	☐ Tenant/Lessee	☐ Successor Agency
Street Address: 2820 Shelter Island Dr				
City: _San Diego			State: _CA	Zip: 92106
Phone No.: 858-518-7372	_ Fax No.:	Email: Rich	ard@nextspacedev.co	m
Signature:		Date: _10/3	1/18	
Additional pages Attached:	⊠ No			
Other Financially Interested Persons				
Name of Individual:		□ Owner	☐ Tenant/Lessee	☐ Successor Agency
Street Address:				
City:			State:	Zip:
Phone No.:		Email:		
	092250,039	ten korrektinati		
Additional pages Attached: ☐ Yes				

Printed on recycled paper. Visit our web site at www.sandiego.gov/development-services. Upon request, this information is available in alternative formats for persons with disabilities.

Fourth and Laurel LP

2820 Shelter Island Drive San Diego, CA 92106

ATTACHMENT 10

December 4, 2018

Manager

Richard Simis-PBS Real Estate Investments LLC

Investor Capital

Andrew French

Bill Foster

Brian Keel

Christopher Ross

CJ Stotts

Darren Maglidt

Dave & Cindy Osborne

Deborah N. Klein

Dennis Alviso

Frank Vretenar

Fred Register

Gary Tanner & Denise Chamblee

Harry R Bigham

Howard Kurshenbaum

Israel N Furmansky

Jay W Richen

Joel Roos

John Falconer

Joseph R John

Joseph Siemienowski

Lance Degrazier

Linda Belzberg

Lisa Gordon Arbittier

Louis E Vener

Louis Knierim

Louis M Galper

Maria Pum

Mark McKinnon

Melissa Reinard

Paul Braun

Robert F. Bernstein

Robert Yohanan

Russell Cahoon

Saul Klein

Scott A Paul

Scott Carstens

Steven Kitay

Thomas A Krause

Thomas Duran

Timothy R Penkala

Victor Laruccia

Wenkwei Lou

William W Winternitz



CLAIREMONT DRIVE

SAN DIEGO, CALIFORNIA

ktgy

ning CL,
ave, WA

PREPARED BY:
KTGY ARCHITECTURE + PLANNING

17911 VON KARMAN AVE, SUITE 20 IRVINE, CA 92614 949.851.2133

PROJECT NAME:
CLAIREMONT
WARMINGTON NDP
SHEET TITLE:
COVER

1ST SUBMITTAL: 10-23-2020
2MD SUBMITTAL: 02-01-2021
3RD SUBMITTAL: 04-08-2021
REVISION: 05-25-2021
REVISION: 07-16-2021
REVISION:
REVISION: 07-15-2021

SHEET A0.00

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A4.00 - COLOR BOARD

APN: 425-100-05 OCCUPANCY: R-3
STREET ADDRESS: 3450 CLAIREMONT DRIVE TYPE OF CONSTRUCTION: V-B
COUNTY: SAN DIEGO SPRINKLER SYSTEM: NFPA 13D
ZONING: CLAIREMONT MESA COMMUNITY PLAN; NUMBER OF STORIES: 3

 LOT AREA (GROSS):
 3.28 AC
 143,000 SF
 SETBACKS: (PER RM1-1 DEVLELOPMENT

 BUILDABLE AREA:
 1.95 AC
 84,942 SF
 FRONT
 15' MIN. / 20' STANDARD

 DENSITY (GROSS):
 1 DU/3000 SF
 48 DU MAX
 REAR
 15'

0.63 PROPOSED

NUMBER OF HOMES: 40 DWELLING UNITS
MAX. LOT COVERAGE N/A

0.75

TOTAL GROSS FLOOR AREA 89,466 SF

MAX. FAR

PROVIDED MOTORCYCLE PARKING

SPRINKLER SYSTEM: NFPA 13D

NUMBER OF STORIES: 3

BUILDING HEIGHT: 30' MAX "PER CLAIREMONT MESA HEGHT LIMIT OVERLAY

SETBACKS: (PER RM1-1 DEVLELOPMENT STANDARDS)

FRONT 15' MIN. / 20' STANDARD

REAR 15'

SIDE 5' MIN. AND ON AT LEAST 50% OF ONE OF THE INTERIOR SIDES REQUIRES A 8' SETBACK

OR 10% OF THE LOT WIDTH (WHICHEVER IS GREATER)

UNIT SUN	IMARY										
TOWNHOMES											
PLAN TYPE	DESCRIPTION		# OF UNITS	MIX	GROSS/ UNIT	TOTAL GROSS	NET/ UNIT	TOTAL NET	GARAGE	PRIVATE OPEN SPACE	TOTAL PRIVATE OPEN SPACE
PLAN 1	3 BED + DEW 2.5 B/	A	18 UNITS	45%	1,660 SF	29,880 SF	1,520 SF	27,360 SF	498 SF	170 SF	3,060 SF
PLAN 2	3 BED + DEW 2.5 B/	A	1 UNITS	3%	1,704 SF	1,704 SF	1,566 SF	1,566 SF	484 SF	298 SF	298 SF
PLAN3	3 BEDS + DEW 2.5 B	A.	7 UNITS	18%	1,725 SF	12,075 SF	1,611 SF	11,277 SF	477 SF	206 SF	1,442 SF
PLAN 4	4 BEDS/ 2.5 BA		10 UNITS	25%	1,877 SF	18,770 SF	1,746 SF	17,460 SF	461 SF	200 SF	2,000 SF
PLAN 5	3 BEDS + OPT. BED/ LOFT	+ 2.5 BA	4 UNITS	10%	1,943 SF	7,772 SF	1,790 SF	7,160 SF	467 SF	286 SF	1,144 SF
		TOTAL	40 UNITS	100%		70,201 SF		64,823 SF			7,944 SF
	*10% ACCESSIBL	EUNITS:	4 UNITS								
2	% AFFORDABLE INCOME H	OUSING.	1 UNIT								

BLDG#	DESCRIPTION	GROSS SF (LIVABLE AREAS)	NET SF	GROSS FLOOR AREA *INCLUDING GARAGES
BLDG 1	TYPE-610 (6-PLEX)	10,786 SF	10,024 SF	13,628 SF
BLDG 2	TYPE-500 (5-PLEX)	8,734 SF	8,052 SF	11,150 SF
BLDG 3	TYPE-500 (5-PLEX)	8,734 SF	8,052 SF	11,150 SF
BLDG 4	TYPE-600 (6-PLEX)	10,394 SF	9,572 SF	13,308 SF
BLDG 5	TYPE-400 (4-PLEX)	7,074 SF	6,532 SF	8,992 SF
BLDG 6	TYPE-300 (3-PLEX)	5,414 SF	5,012 SF	6,834 SF
BLDG 7	TYPE-620 (6-PLEX)	10,004 SF	9,166 SF	12,978 SF
BLDG 8	TYPE-510 (5-PLEX)	9,061 SF	8,413 SF	11,426 SF
	TOTAL	70,201 SF	64,823 SF	89,466 SF

	ACE SUMMARY		
REQUIRED OPE	NSPACE		
COMMON	25 SF PER DWELLING UNIT		*PER §131.0456 COMMON OPEN SPACE IN THE RM ZONES
	1,000 SF		
PRIVATE	60 SF PER DWELLING UNIT WITE	6' MIN DIMENSION	*PER §131.0455 PRIVATE EXTERIOR OPEN SPACE IN THE RM ZONES
	2,400 SF		
PROVIDED OPE	N SPACE		
COMMON	13,600 SF	340 SF/ UN	п
PRIVATE	7.944 SF	199 SF/UNI	Т

E SPACES)	40 UNITS	x	2.25 SPACES /DU TOTAL REQUIRED PARKING	=	90 SPACES 90 SPACES
-,			TOTAL REQUIRED PARKING	=	
-,			TOTAL REQUIRED PARKING	=	
E SPACES)	40 UNITS	x			90 SPACES
E SPACES)	40 UNITS	x			
E SPACES)	40 UNITS	×			
			2 SPACES /DU	=	80 SPACES
			SURFACE PARKING	=	10 SPACES
			TOTAL PARKING PROVIDED		90 SPACES
			*1 ADA STALL INCLUDED		
KING *PER TABLE 142-0	5C				
S)	40 UNITS	×	0.6 SPACES/ DU	=	24 SPACES
		TOT	AL REQUIRED BIKE PARKING	=	24 SPACES
KING					
S)	40 UNITS	х	0.6 SPACES/ DU	=	24 SPACES
		TOT	AL PROVIDED BIKE PARKING	=	24 SPACES
ACES WILL BE PROVIDED	WITHIN EACH GARAGE	JNIT			
	STATES BICYCLE RAC	KS ARE	NOT NEEDED FOR DWELLIN	G UNI	ITS WITH PRIVATE
EPARKING					
S)	40 UNITS	X	0.1 SPACES /DU	=	4 SPACES
	BKING IS) ACES WILL BE PROVIDED	RKING IS) 40 UNITS ACES WILL BE PROVIDED WITHIN EACH GARAGE UNITS. E PARKING	NS) 40 UNITS X TOT RKING NS) 40 UNITS X TOT, ACES WILL BE PROVIDED WITHIN EACH GARAGE UNIT TE #5 OF TABLE 142-05C STATES BICYCLE RACKS ARE INVITS. E PARKING	KING *PER TABLE 142-05C IS) 40 UNITS X 0.6 SPACES/ DU TOTAL REQUIRED BIKE PARKING BKING IS) 40 UNITS X 0.6 SPACES/ DU TOTAL PROVIDED BIKE PARKING ACES WILL BE PROVIDED WITHIN EACH GARAGE UNIT TE #5 OF TABLE 142-05C STATES BICYCLE RACKS ARE NOT NEEDED FOR DWELLINE UNITS. E PARKING	KING *PER TABLE 142-05C IS) 40 UNITS X 0.6 SPACES/ DU = TOTAL REQUIRED BIKE PARKING = RKING IS) 40 UNITS X 0.6 SPACES/ DU = TOTAL PROVIDED BIKE PARKING = ACES WILL BE PROVIDED WITHIN EACH GARAGE UNIT TE #5 OF TABLE 142-05C STATES BICYCLE RACKS ARE NOT NEEDED FOR DWELLING UNITS: UNITS. E PARKING

0.1 SPACES /DU

TOTAL PARKING PROVIDED

4 SPACES

SUSTAINABLE/ GREEN BUILDING FEATURES

THE PROJECT WILL INCLUDE "GREEN" BUILDING PRACTICES THAT MEET THE STANDARDS OF CALGREEN TO REDUCE THE IMPACT ON THE ENVIRONMENT, DECREASE ENERGY COSTS, AND CREATE HEALTHIER LIVING THROUGH IMPROVED INDOOR AIR QUALITY AND SAFER BUILDING MATERIALS.

- RESIDENTIAL GARAGES SHALL BE PRE-PLUMBED (OR PRE-WIRED) TO ACCOMMODATE ELECTRIC VEHICLE CHARGE.
- USE OF SOLAR PHOTOVOLTAICS SYSTEMS AS REQUIRED BY CODE. (THE AMOUNT OF SOLAR PANELS SHALL BE DETERMINED DURING THE BUILDING PERMIT PROCESS AND WILL BE DEPENDENT ON THE LOCATION OF REQUIRED ROOF-MOUNTED MECHANICAL AND VENTILATION EQUIPMENT).
- USE OF NATURAL LIGHTING
- LOW-E WINDOWS OR USE OF ENERGY STAR WINDOWS
- USE OF PROPERLY SIZED AND ENERGY-EFFICIENT HEATING/ COOLING SYSTEM IN CONNECTION WITH THERMALLY EFFICIENT BUILDING SHELL.
- INSTALL HIGH R-VALUE WALL AND CEILING INSULATION
- INSTALL HIGH-EFFICIENCY LIGHTING (LED, FLUORESCENT LIGHTING, ETC.)
- USE ULTRA LOW-FLUSH TOILETS, LOW-FLOW SHOWER HEAD AND OTHER CONSERVING FIXTURES AND APPLIANCES
- USE STATE-OF-THE-ART IRRIGATION CONTROLLERS AND SELF-CLOSING NOZZLES ON HOSES



Architecture + Planning 17911 Von Karman Ave, Suite 200 Irvine, CA 92614 949.851.2133 ktgy.com | PREPARED_BY:
KTGY_ARCHITECTURE + PLANNING	2ND SUBMITTAL: 10-23-2020
ADDRESS: 17971 VON KARMAN AVE, SUITE 200	IRVINE, CA 92614
949.851.2133	REVISION: 07-16-2021
REVISION: 07-1	

PROJECT SUMMARY

SHEET A0.10

JOB NUMBER: #2020-048

ATTACHMENT 11





VIEW LOOKING TOWARDS THE WEST FROM CLAIREMONT DRIVE



Architecture + Plannin 17911 Von Karman Ave Suite 200 Irvine, CA 92614 949.851.2133

REPARED BY:	1ST SUBMITTAL: 10-23-2020
TGY ARCHITECTURE + PLANNING	2ND SUBMITTAL: 02-01-2021
DDRESS:	3RD SUBMITTAL: <u>04-08-2021</u>
7911 VON KARMAN AVE, SUITE 200 RVNE . CA 92614	REVISION: 05-25-2021
49.851.2133	REVISION: <u>07-16-2021</u>
DO FOT MANE	REVISION:
ROJECT NAME: CLAIREMONT	REVISION:
VARMINGTON NDP HEET_TITLE:	ORIGINAL DATE:07-15-2021_
PERSPECTIVE RENDERING	

SHEET A1.10



VIEW LOOKING TOWARDS THE WEST INTO INTERIOR COURTYARD



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PROJECT NAME:
CLAIREMONT
WARMINGTON NDP
SHEET IIILE:
PERSPECTIVE RENDERING

ORIGINAL DATE: 07-15-2021

SHEET A1.11



FRONT PERSPECTIVE OF BUILDING TYPE 300 (3-PLEX)



REAR PERSPECTIVE OF BUILDING TYPE 300 (3-PLEX)



Architecture + Plani 17911 Von Karman A Suite 200 Irvine, CA 92614 949.851.2133 ktuv.com

PREPARED BY. KTGY ARCHITECTURE + PLANNING ADDRESS: 17911 VON KARMAN AVE, SUITE 200 IRVINE , CA 92614 949.851.2133	1ST SUBMITTAL: 10-23-2020 2ND SUBMITTAL: 02-01-2021 3RD SUBMITTAL: 04-08-2021 REVISION: 05-25-2021 REVISION: 07-16-2021
PROJECT NAME: CLAIREMONT WARMINGTON NDP SHEET JILLE: BUILDING PERSPECTIVE BUILDING TYPE 300 (3-PLEX)	REVISION: REVISION: ORIGINAL DATE: 07-15-2021
	SHEET A2.00





4 - SIDE ELEVATION



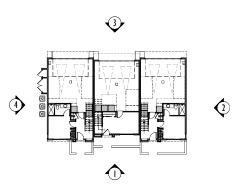
MATERIAL LEGEND

- 1 STUCCO, LIGHT SAND FINISH
- 2 FIBER CEMENT SIDING
- 3 ROOF EAVE W/ WOOD FASCIA/ BARGE
- 4 PARAPET WITH TRIM
- 5 VINYL WINDOWS
- 6 WINDOW W/ FOAM TRIM
- 7 SCREED LINE
- 8 METAL RAILING
- 9 METAL SECTIONAL GARAGE DOOR
- 10 METAL AWNING
- 11 FIBERGLASS ENTRY DOOR
- 12 DECORATIVE EXT. LIGHTING & ADDRESS SIGN
- 13 STUCCO O/ FOAM TRIM
- 14 STUCCO SILL TRIM











KEY PLAN - 1/32" = 1'-0"




PREPARED BY:	1ST SUBMITTAL:	10-23-2020
KTGY ARCHITECTURE + PLANNING	2ND SUBMITTAL:	02-01-2021
ADDRESS:	3RD SUBMITTAL:	04-08-2021
17911 VON KARMAN AVE, SUITE 200 IRVINE . CA 92614	REVISION:	05-25-2021
949.851.2133	REVISION:	07-16-2021
	REVISION:	
PROJECT NAME: CLAIREMONT	REVISION:	
WARMINGTON NDP SHEET TITLE:	ORIGINAL DATE	: _07-15-2021
BUILDING ELEVATIONS		
BUILDING TYPE 300 (3-PLEX)	CHEET	A2 01

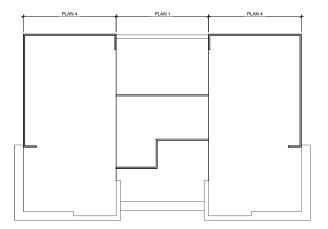


ROOF

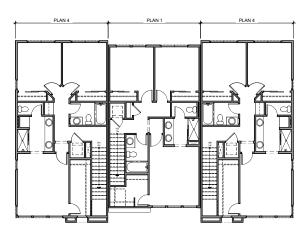


THIRD FLOOR

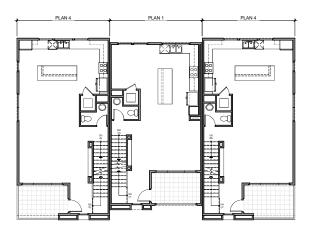

SECOND FLOOR

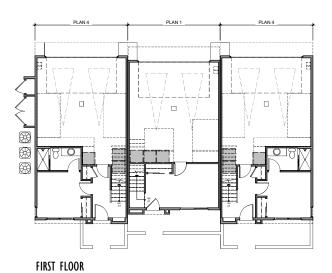

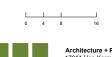

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PREPARED BY: KTGY ARCHITECTURE + PLANNING ADDRESS: 17911 VON KARMAN AVE, SUITE 200 IRVINE, CA 92614 949.851.213	1ST SUBMITTAL: 10-23-2020 2ND SUBMITTAL: 02-01-2021 3RD SUBMITTAL: 04-08-2021 REVISION: 05-25-2021 REVISION: 07-16-2021
PROJECT NAME: CLAIREMONT WARMINGTON NDP SHEET TILE: BUILDING PLANS BUILDING TYPE 300 (3-PLEX)	REVISION: REVISION: ORIGINAL DATE: 07-15-2021
	SHEET A2.02

JOB NUMBER: #2020-0487



FRONT PERSPECTIVE OF BUILDING TYPE 400 (4-PLEX)



REAR PERSPECTIVE OF BUILDING TYPE 400 (4-PLEX)



Architecture + Plann 17911 Von Karman Av Suite 200 Irvine, CA 92614 949.851.2133 ktgv.com

PREPARED BY:	1ST SUBMITTAL: 10-23-2020
KTGY ARCHITECTURE + PLANNING	2ND SUBMITTAL: 02-01-2021
ADDRESS:	3RD SUBMITTAL: 04-08-2021
17911 VON KARMAN AVE, SUITE 200 IRVINE . CA 92614	REVISION: 05-25-2021
949.851.2133	REVISION: <u>07-16-2021</u>
	REVISION:
PROJECT NAME: CLAIREMONT	REVISION:
WARMINGTON NDP	
SHEET TITLE:	ORIGINAL DATE: 07-15-2021
BUILDING PERSPECTIVE	
BUILDING TYPE 400 (4-PLEX)	SHEET A2 10
BOILDING 111 E 400 (11 EEX)	SHEET AZ. TU





4 - SIDE ELEVATION




MATERIAL LEGEND

- 1 STUCCO, LIGHT SAND FINISH
- 2 FIBER CEMENT SIDING
- ROOF EAVE W/ WOOD FASCIA/ BARGE
- 4 PARAPET WITH TRIM
- 5 VINYL WINDOWS
- 6 WINDOW W/ FOAM TRIM
- 7 SCREED LINE
- 8 METAL RAILING
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- 11 FIBERGLASS ENTRY DOOR
- 12 DECORATIVE EXT. LIGHTING & ADDRESS SIGN
- 13 STUCCO O/ FOAM TRIM
- 14 STUCCO SILL TRIM









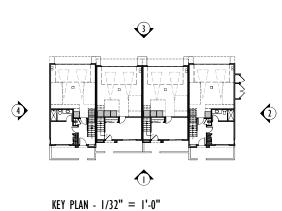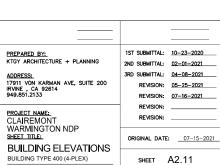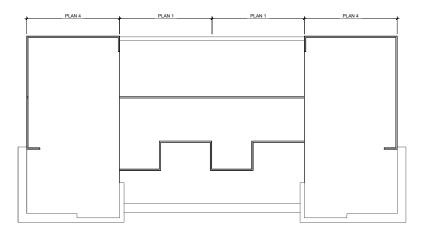










ROOF

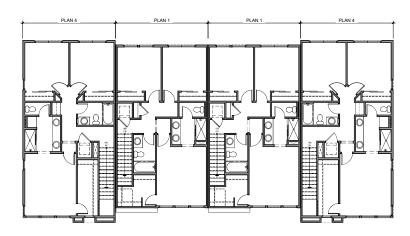

THIRD FLOOR

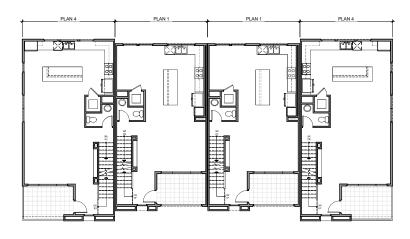

SECOND FLOOR

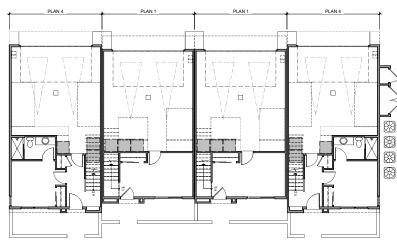

FIRST FLOOR



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PREPARED BY: KTGY ARCHITECTURE + PLANNING ADDRESS: 17911 VON KARMAN AVE, SUITE 200 IRVINE CA 92614 949.851.2133	1ST SUBMITTAL: 10-23-2020 2ND SUBMITTAL: 02-01-2021 3RD SUBMITTAL: 04-08-2021 REVISION: 05-25-2021 REVISION: 07-16-2021
PROJECT NAME: CLAIREMONT WARMINGTON NDP SHEET TITLE:	REVISION: REVISION: ORIGINAL DATE:
BUILDING PLANS BUILDING TYPE 400 (4-PLEX)	SHEET A2.12

SHEET A2.12



FRONT PERSPECTIVE OF BUILDING TYPE 500 (5-PLEX)



REAR PERSPECTIVE OF BUILDING TYPE 500 (5-PLEX)



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PREPARED BY: KTGY ARCHITECTURE + PLANNING	1ST SUBMITTAL: 10-23-2020 2ND SUBMITTAL: 02-01-2021
ADDRESS: 17911 VON KARMAN AVE, SUITE 200 IRVINE , CA 92614 949.851.2133	3RD SUBMITTAL: 04-08-2021 REVISION: 05-25-2021 REVISION: 07-16-2021
PROJECT NAME: CLAIREMONT WARMINGTON NDP SHEET TILE: BUILDING PERSPECTIVE BUILDING TYPE 500 (5-PLEX)	REVISION:
	ORIGINAL DATE: 07-15-2021
	SHEET A2.20





4 - SIDE ELEVATION


MATERIAL LEGEND

- 1 STUCCO, LIGHT SAND FINISH
- 2 FIBER CEMENT SIDING
- ROOF EAVE W/ WOOD FASCIA/ BARGE
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- 5 VINYL WINDOWS
- 6 WINDOW W/ FOAM TRIM
- 7 SCREED LINE
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- 10 METAL AWNING
- 11 FIBERGLASS ENTRY DOOR
- 12 DECORATIVE EXT. LIGHTING & ADDRESS SIGN
- 13 STUCCO O/ FOAM TRIM
- 14 STUCCO SILL TRIM





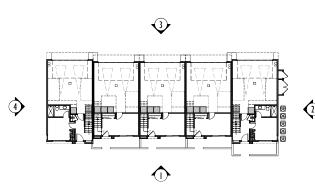2 - SIDE ELEVATION



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KTCY ARCHITECTURE + PLANNING
ADDRESS.
17911 VON KARMAN AVE, SUITE 21
IRVINE, CA 92614
949.851.2133


PROJECT NAME:
CLAIREMONT
WARMINGTON NDP
SHEET TITLE:
BUILDING ELEVATIO


| 1ST SUBMITTAL: 10-23-2020 | 2ND SUBMITTAL: 02-01-2021 | 3RD SUBMITTAL: 04-08-2021 | REVISION: 05-25-2021 | REVISION: 07-18-2021 | REVISION: REVISION: REVISION: 07-18-2021 | REVISION: 07-18-2021 | REVISION: 07-18-2021 | REVISION: 07-15-2021 | REVISION

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17911 Von Karman Ave,
Suite 200
Irvine, CA 92614
949.851.2133
ktgy.com


Architecture + Planning
17911 Von Karman Ave,
WARMINGTON
SHEET TITLE:
BUILDING E
BUILDING TYPE 50

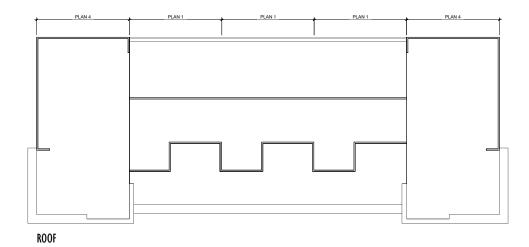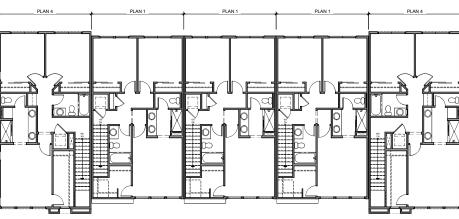
KEY PLAN - 1/32" = 1'-0"






THIRD FLOOR

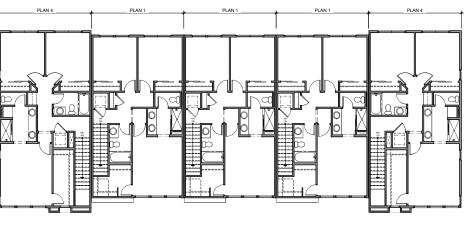


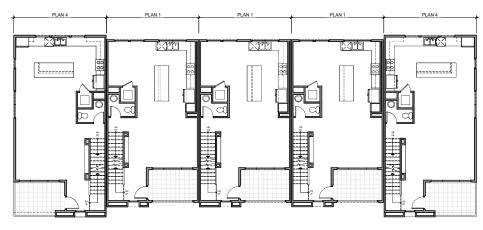

SECOND FLOOR

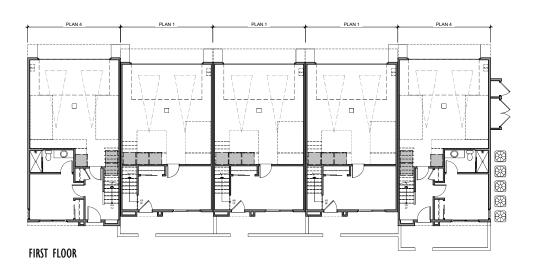



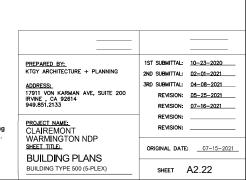



FRONT PERSPECTIVE OF BUILDING TYPE 510 (5-PLEX)



REAR PERSPECTIVE OF BUILDING TYPE 510 (5-PLEX)



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PREPARED BY:	1ST SUBMITTAL:	10-23-2020
KTGY ARCHITECTURE + PLANNING	2ND SUBMITTAL:	02-01-2021
ADDRESS:	3RD SUBMITTAL:	04-08-2021
17911 VON KARMAN AVE, SUITE 200 IRVINE . CA 92614	REVISION:	05-25-2021
949.851.2133	REVISION:	07-16-2021
	REVISION:	
PROJECT NAME: CLAIREMONT	REVISION:	
WARMINGTON NDP SHEET TITLE:	ORIGINAL DATE	: _07-15-2021
BUILDING PERSPECTIVE		
BUILDING TYPE 510 (5-PLEX)	CUEET	V 3 3 0





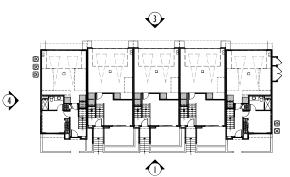
4 - SIDE ELEVATION

MATERIAL LEGEND

- 1 STUCCO, LIGHT SAND FINISH
- 2 FIBER CEMENT SIDING
- ROOF EAVE W/ WOOD FASCIA/ BARGE
- 4 PARAPET WITH TRIM
- 5 VINYL WINDOWS
- 6 WINDOW W/ FOAM TRIM
- 7 SCREED LINE
- 8 METAL RAILING
- 9 METAL SECTIONAL GARAGE DOOR
- 10 METAL AWNING
- 11 FIBERGLASS ENTRY DOOR
- 12 DECORATIVE EXT. LIGHTING & ADDRESS SIGN
- 13 STUCCO O/ FOAM TRIM
- 14 STUCCO SILL TRIM







2 - SIDE ELEVATION

KEY PLAN - 1/32" = 1'-0"

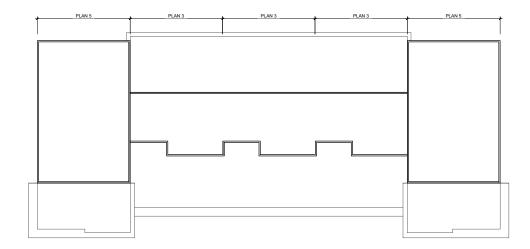


PREPARED BY:
KTGY ARCHITECTURE + PLANNING
ADDRESS:


PROJECT NAME:
CLAIREMONT
WARMINGTON NDP
SHEET TITE:
BUILDING ELEVATIONS
BUILDING TYPE 510 (5-PLEX)

1ST SUBMITTAL: 10_23_2020
2ND SUBMITTAL: 02_01_2021
3RD SUBMITAL: 04_08_2021
REVISION: 05_25_2021
REVISION: 07_16_2021
REVISION:
REVISION: 07_16_2021

SHEET A2.31




ROOF

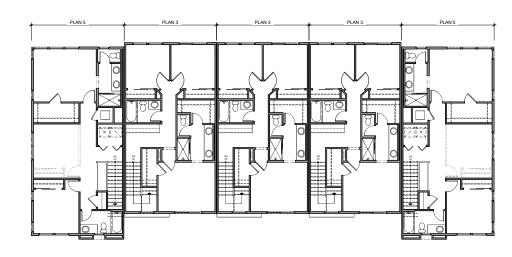

THIRD FLOOR



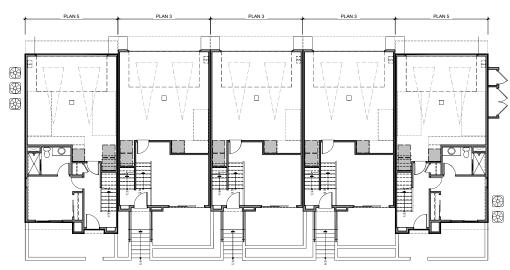SECOND FLOOR



FIRST FLOOR



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PREPARED BY: KTGY ARCHITECTURE + PLANNING	1ST SUBMITTAL: 10-23-2020 2ND SUBMITTAL: 02-01-2021
ADDRESS: 17911 VON KARMAN AVE, SUITE 200 IRVINE , CA 92614 949.851.2133	3RD SUBMITTAL: <u>04-08-2021</u> REVISION: <u>05-25-2021</u> REVISION: <u>07-16-2021</u>
PROJECT NAME: CLAIREMONT	REVISION:
WARMINGTON NDP SHEET TITLE: BUIL DING PLANS	ORIGINAL DATE:07-15-2021
BUILDING FLAINS BUILDING TYPE 510 (5-PLEX)	SHFFT A2 32



FRONT PERSPECTIVE OF BUILDING TYPE 600 (6-PLEX)



REAR PERSPECTIVE OF BUILDING TYPE 600 (6-PLEX)



PREPARED BY:	1ST SUBMITTAL: 10-23-2020
KTGY ARCHITECTURE + PLANNING	2ND SUBMITTAL: 02-01-2021
ADDRESS:	3RD SUBMITTAL: 04-08-2021
17911 VON KARMAN AVE, SUITE 200 IRVINE . CA 92614	REVISION: 05-25-2021
949.851.2133	REVISION: 07-16-2021
	REVISION:
PROJECT NAME: CLAIREMONT	REVISION:
WARMINGTON NDP	
SHEET TITLE:	ORIGINAL DATE: 07-15-2021
BUILDING PERSPECTIVE	
DUIL DINC TYPE 600 (6 DLEV)	40.40





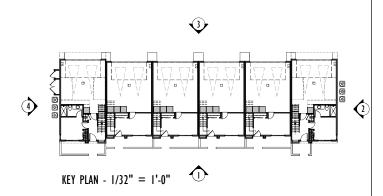
MATERIAL LEGEND

- 1 STUCCO, LIGHT SAND FINISH
- 2 FIBER CEMENT SIDING
- ROOF EAVE W/ WOOD FASCIA/ BARGE
- 4 PARAPET WITH TRIM
- 5 VINYL WINDOWS
- 6 WINDOW W/ FOAM TRIM
- 7 SCREED LINE
- 8 METAL RAILING
- 9 METAL SECTIONAL GARAGE DOOR
- 10 METAL AWNING
- 11 FIBERGLASS ENTRY DOOR
- DECORATIVE EXT. LIGHTING & ADDRESS SIGN
- 13 STUCCO O/ FOAM TRIM
- 14 STUCCO SILL TRIM













PROJECT NAME: CLAIREMONT WARMINGTON NDP SHEET TITLE:

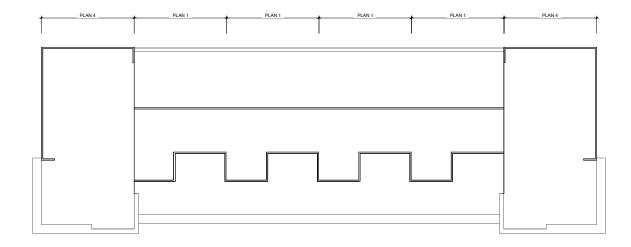
PREPARED BY: KTGY ARCHITECTURE + PLANNING 2ND SUBMITTAL: 02-01-2021 3RD SUBMITTAL: 04-08-2021 REVISION: 05-25-2021 REVISION: <u>07-16-2021</u> REVISION: REVISION: ORIGINAL DATE: ___07-15-2021__ BUILDING ELEVATIONS BUILDING TYPE 600 (6-PLEX) SHEET A2.41



ROOF

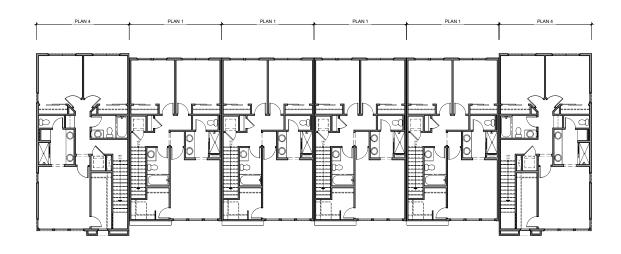

SECOND FLOOR

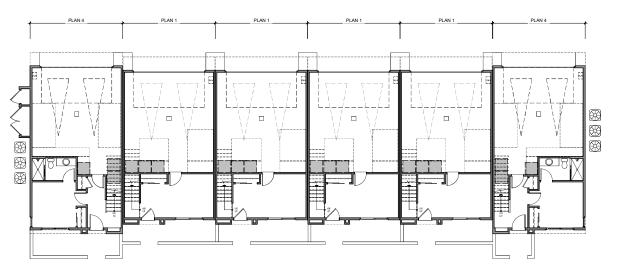

THIRD FLOOR

FIRST FLOOR



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BUILDING TYPE 600 (6-PLEX)

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SHEET A2.42



FRONT PERSPECTIVE OF BUILDING TYPE 610 (6-PLEX)



REAR PERSPECTIVE OF BUILDING TYPE 610 (6-PLEX)



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CLAIREMONT
WARMINGTON NDP
SHEET JILLE:
BUILDING PERSPECTIVE
BUILDING TYPE 610 (6-PLEX) REVISION: ORIGINAL DATE: __07-15-2021_





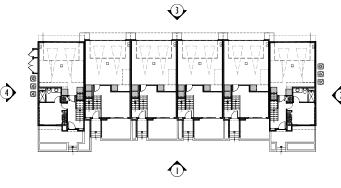
4 - SIDE ELEVATION

MATERIAL LEGEND

- 1 STUCCO, LIGHT SAND FINISH
- 2 FIBER CEMENT SIDING
- ROOF EAVE W/ WOOD FASCIA/ BARGE
- 4 PARAPET WITH TRIM
- 5 VINYL WINDOWS
- 6 WINDOW W/ FOAM TRIM
- 7 SCREED LINE
- 8 METAL RAILING
- 9 METAL SECTIONAL GARAGE DOOR
- 10 METAL AWNING
- 11 FIBERGLASS ENTRY DOOR
- 12 DECORATIVE EXT. LIGHTING & ADDRESS SIGN
- 13 STUCCO O/ FOAM TRIM
- 14 STUCCO SILL TRIM








2 - SIDE ELEVATION


KEY PLAN - 1/32" = 1'-0"




| PREPARED_BY:
KTGY ARCHITECTURE + PLANNING	2ND SUBMITTAL:	10-23-2020
ADDRESS:	3RD SUBMITTAL:	02-01-2021
3RD SUBMITTAL:	02-08-2021	
3RD		

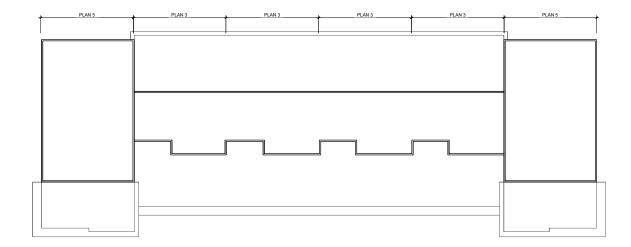


ROOF

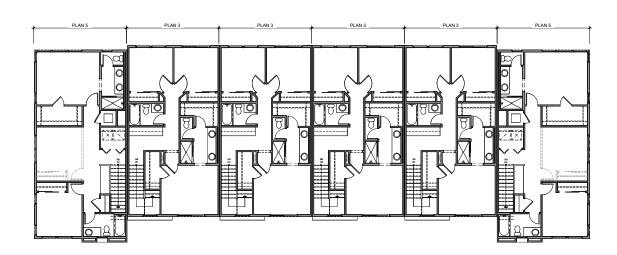

THIRD FLOOR

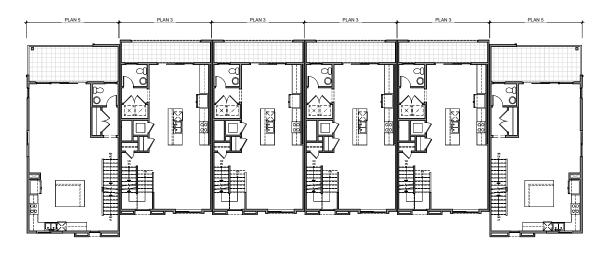

SECOND FLOOR

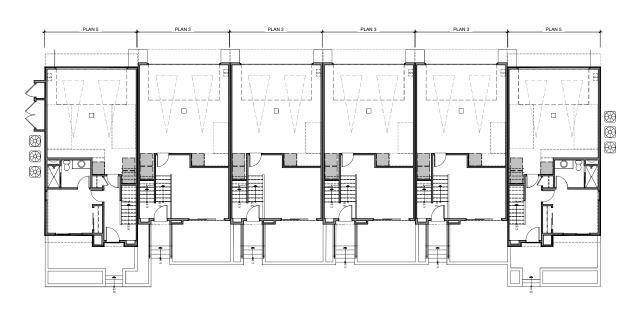

FIRST FLOOR



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PREPARED BY: KTGY ARCHITECTURE + PLANNING	1ST SUBMITTAL: 10-23-2020 2ND SUBMITTAL: 02-01-2021
ADDRESS: 17911 VON KARMAN AVE, SUITE 200 IRVINE CA 92614 949.851.2133 PROJECT NAME: CLAIREMONT WARMINGTON NDP SHEET ITLE: BUIL DING PLANS	3RD SUBMITTAL: 04-08-2021 REVISION: 05-25-2021 REVISION: 07-16-2021
	REVISION:
	ORIGINAL DATE: 07-15-2021
BUILDING TYPE 610 (6-PLEX)	sheet A2.52



FRONT PERSPECTIVE OF BUILDING TYPE 620 (6-PLEX)



REAR PERSPECTIVE OF BUILDING TYPE 620 (6-PLEX)



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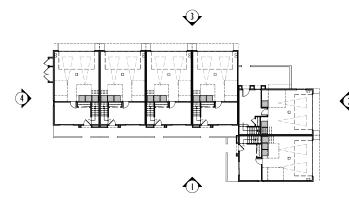
4 - SIDE ELEVATION

MATERIAL LEGEND

- 1 STUCCO, LIGHT SAND FINISH
- 2 FIBER CEMENT SIDING
- ROOF EAVE W/ WOOD FASCIA/ BARGE
- 4 PARAPET WITH TRIM
- 6 WINDOW W/ FOAM TRIM
- 7 SCREED LINE
- 8 METAL RAILING
- 9 METAL SECTIONAL GARAGE DOOR
- 10 METAL AWNING
- 11 FIBERGLASS ENTRY DOOR
- 12 DECORATIVE EXT. LIGHTING & ADDRESS SIGN
- 13 STUCCO O/ FOAM TRIM
- 14 STUCCO SILL TRIM







2 - SIDE ELEVATION

KEY PLAN - 1/32" = 1'-0"



PREPARED BY: KTGY ARCHITECTURE + PLANNING
ADDRESS: 17911 VON KARMAN AVE. SUITE :

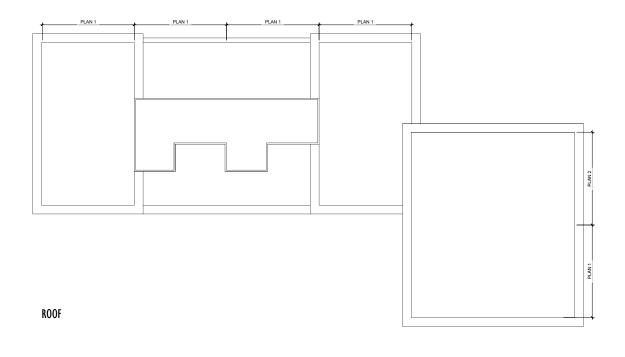
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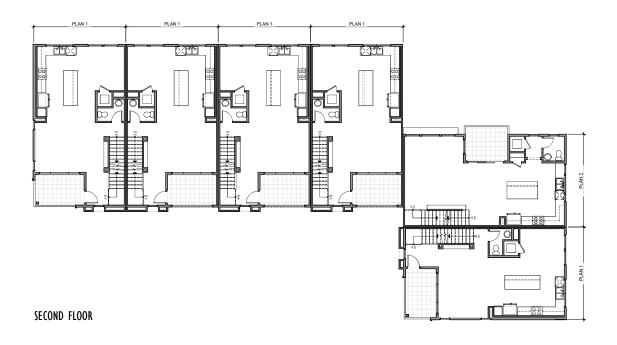
BUILDING TYPE 620 (6-PLEX)


IRVINE , CA 92614 949.851.2133 REVISION: <u>07-16-2021</u> REVISION: REVISION: ORIGINAL DATE: 07-15-2021 **BUILDING ELEVATIONS**


SHEET A2.61

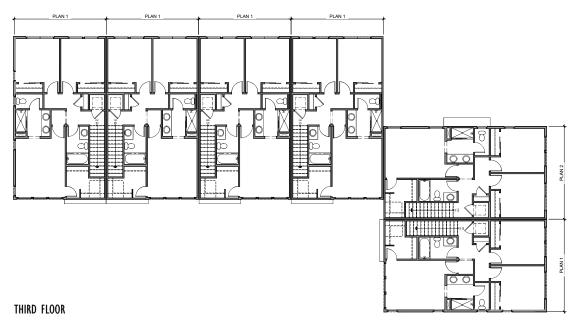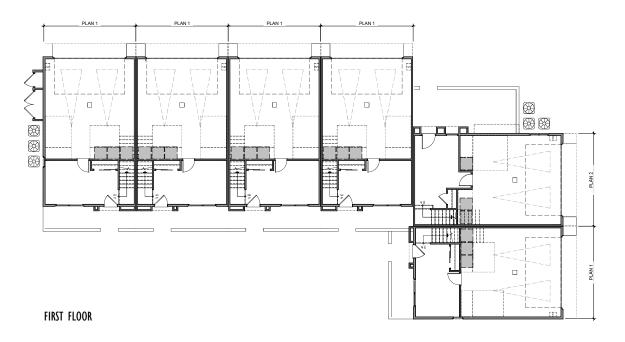2ND SUBMITTAL: 02-01-2021 3RD SUBMITTAL: 04-08-2021 REVISION: 05-25-2021













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PREPARED BY: KTGY ARCHITECTURE + PLANNING ADDRESS: 17911 VON KARMAN AVE, SUITE 200 IRVINE , CA 92614 949.851.2133	1ST SUBMITTAL: 10-23-2020 2ND SUBMITTAL: 02-01-2021 3RD SUBMITTAL: 04-08-2021 REVISION: 05-25-2021 REVISION: 07-16-2021
PROJECT NAME: CLAIREMONT WARMINGTON NDP SHEET TITLE:	REVISION: REVISION: ORIGINAL DATE: 07-15-2021
BUILDING PLANS BUILDING TYPE 620 (6-PLEX)	SHEET A2.62



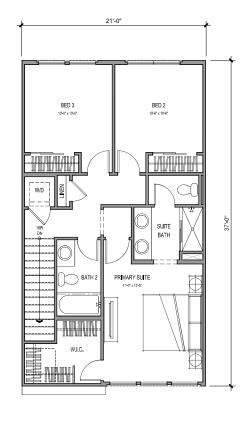

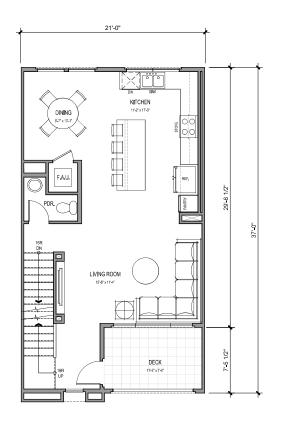— TANKLESS WATER HEATER [] GARAGE 2013* x 221-10* 116 CU FT 5'-10"L x 2'-6"D x 8'-0"1 DEN/ HOME OFFICE PAT**I**O

THIRD FLOOR SECOND FLOOR

FIRST FLOOR

3 BEDS + DEN/ 2.5 BATHS


GROSS SF		
1ST FLOOR	246 SQ. FT.	
2ND FLOOR	686 SQ. FT.	
3RD FLOOR	728 SQ. FT.	
TOTAL LIMING	1660 SQ. FT.	
GARAGE	484 SQ. FT.	
PATIO	92 SQ. FT.	
DECK	78 SQ. FT.	

NET SF		
1ST FLOOR	202 SQ. FT.	
2ND FLOOR	634 SQ. FT.	
3RD FLOOR	684 SQ. FT.	
TOTAL LIVING	1520 SQ. FT.	




PREPARED BY: KTGY ARCHITECTURE + PLANNING 2ND SUBMITTAL: 02-01-2021 3RD SUBMITTAL: <u>04-08-2021</u> REVISION: 05-25-2021 REVISION: 07-16-2021 REVISION: PROJECT NAME:
CLAIREMONT
WARMINGTON NDP
SHEET TITLE:
PLAN 1
UNIT PLANS REVISION: ORIGINAL DATE: ___07-15-2021_

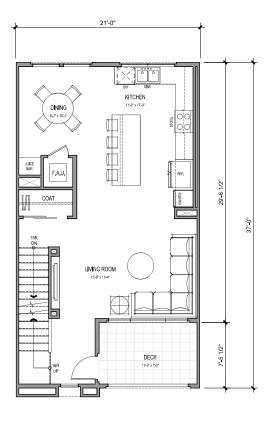SHEET A3.00



SECOND FLOOR

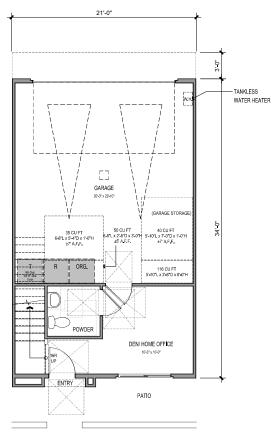

FIRST FLOOR

3 BEDS + DEN/ 2.5 BATHS

GROSS SF		
1ST FLOOR	246 SQ. FT.	
2ND FLOOR	686 SQ. FT.	
3RD FLOOR	728 SQ. FT.	
TOTAL LIVING	1660 SQ. FT.	
GARAGE	484 SQ. FT.	
PATIO	92 SQ. FT.	
DECK	78 SQ. FT.	


	NET SF	
Γ.	1ST FLOOR	202 SQ. FT.
Γ.	2ND FLOOR	634 SQ. FT.
Γ.	3RD FLOOR	684 SQ. FT.
т.	TOTAL LIVING	1520 SQ. FT.
Γ.		





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PREPARED BY: KTGY ARCHITECTURE + PLANNING 2ND SUBMITTAL: 02-01-2021 3RD SUBMITTAL: 04-08-2021 REVISION: 05-25-2021 REVISION: <u>07-16-2021</u> REVISION: PROJECT NAME:
CLAIREMONT
WARMINGTON NDP
SHEET JILLE:
PLAN 1 - ACCESSIBLE
UNIT PLANS REVISION: ORIGINAL DATE: ___07-15-2021_

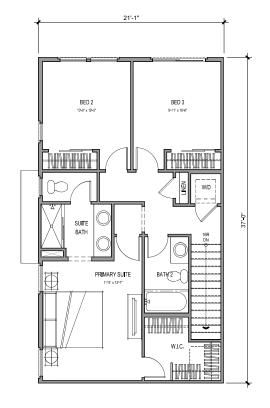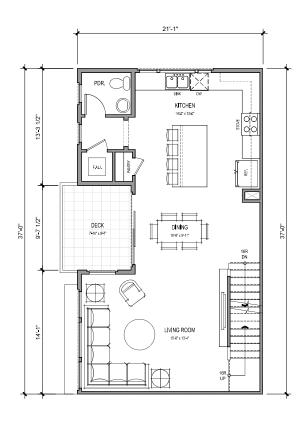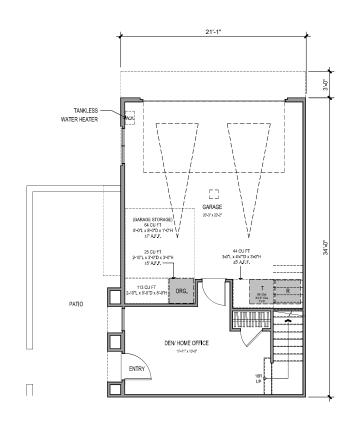SHEET A3.01







THIRD FLOOR SECOND FLOOR FIRST FLOOR


3 BEDS + DEN/ 2.5 BATHS

GROSS SF	
1ST FLOOR	248 SQ. FT.
2ND FLOOR	718 SQ. FT.
3RD FLOOR	738 SQ. FT.
TOTAL L M NG	1704 SQ. FT.
GARAGE	484 SQ. FT.
PAT I O	223 SQ. FT.
DECK	75 SQ. FT.


•			
	NET SF		
	1ST FLOOR	209 SQ. FT.	
	2ND FLOOR	667 SQ. FT.	
	3RD FLOOR	691 SQ. FT.	
	TOTAL LIVING	1566 SQ. FT.	




PREPARED BY:	1ST SUBMITTAL:	10-23-2020
KTGY ARCHITECTURE + PLANNING	2ND SUBMITTAL:	02-01-2021
ADDRESS:	3RD SUBMITTAL:	04-08-2021
17911 VON KARMAN AVE, SUITE	200 REVISION:	05-25-2021
949.851.2133	REVISION:	07-16-2021
	REVISION:	
PROJECT NAME: CLAIREMONT	REVISION:	
WARMINGTON NDP		
SHEET TITLE:	ORIGINAL DATE	: 07-15-2021
PLAN 2		
UNIT PLANS	SHEET	A3.10

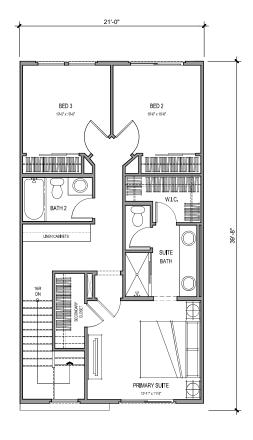

THIRD FLOOR

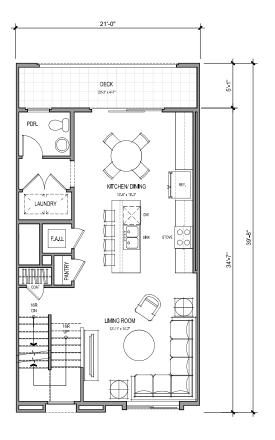

SECOND FLOOR

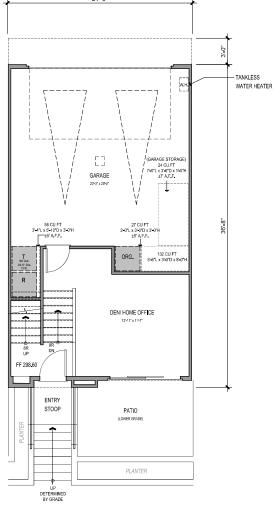


NET SF 1ST FLOOR 251 SQ. FT. 2ND FLOOR 658 SQ. FT. 3RD FLOOR 702 SQ. FT. TOTAL LIVING 1611 SQ. FT.

FIRST FLOOR


3 BEDS + DEN/ 2.5 BATHS


GROSS SF		
275 SQ. FT.		
704 SQ. FT.		
745 SQ. FT.		
1725 SQ. FT.		
477 SQ. FT. 112 SQ. FT.		
94 SQ. FT.		



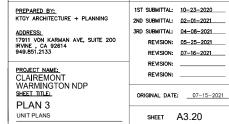

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TANKLESS WATER HEATER

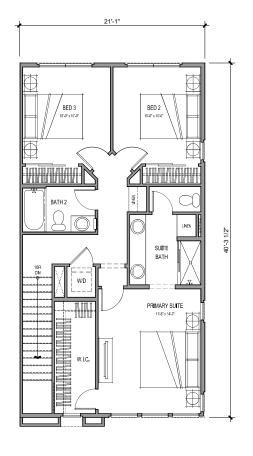SOUTH STANK WATER HEATER

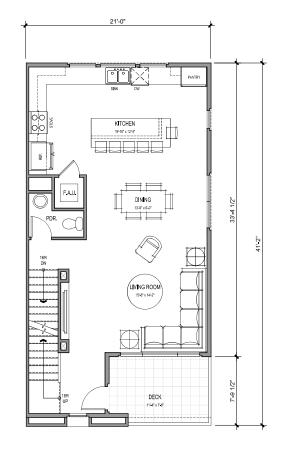AND SOUTH STANK WATER HEATER

BED 4

SOUTH STANK WATER HEATER

BED 4

SOUTH STANK WATER HEATER

PATIO

PATIO

THIRD FLOOR SECOND FLOOR

FIRST FLOOR

4 BEDS/ 2.5 BATHS

GROSS SF		
1ST FLOOR	322 SQ. FT.	
2ND FLOOR	766 SQ. FT.	
3RD FLOOR	788 SQ. FT.	
TOTAL LIMING	1877 SQ. FT.	
GARAGE	461 SQ. FT.	
PATIO	110 SQ. FT.	
DECK	90 SQ. FT.	


NET SF		
295 SQ. FT.		
717 SQ. FT.		
733 SQ. FT.		
1746 SQ. FT.		





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ADDRESS: 17911 VON KARMAN AVE, SUITE 200 IRVINE , CA 92614 949.851.2133	3RD SUBMITTAL: 04-08-2021 REVISION: 05-25-2021 REVISION: 07-16-2021
PROJECT NAME:_ CLAIREMONT WARMINGTON NDP	REVISION:
SHEET TITLE: PLAN 4	ORIGINAL DATE: 07-15-2021
UNIT PLANS	SHEET A3.30

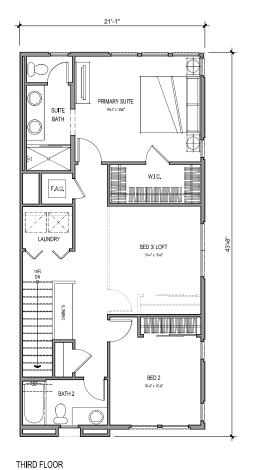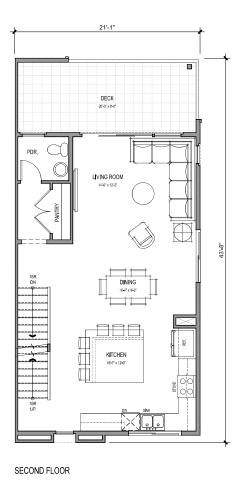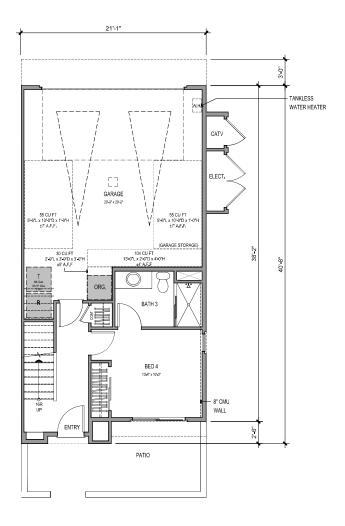JOB NUMBER: #2020-0487







FIRST FLOOR

3 BEDS + OPT. BED/ LOFT + 2.5 BATHS

GROSS SF		
1ST FLOOR	359 SQ. FT.	
2ND FLOOR	723 SQ. FT.	
3RD FLOOR	861 SQ. FT.	
TOTAL LIV I NG	1943 SQ. FT.	
GARAGE	467 SQ. FT.	
PATIO	123 SQ. FT.	
DECK	162 SQ. FT.	

NET SF	
1ST FLOOR	313 SQ. FT.
2ND FLOOR	674 SQ. FT.
3RD FLOOR	802 SQ. FT.
TOTAL LIVING	1790 SQ. FT.



PREPARED BY: KTGY ARCHITECTURE + PLANNING 2ND SUBMITTAL: 02-01-2021 3RD SUBMITTAL: 04-08-2021 REVISION: 05-25-2021 REVISION: 07-16-2021 REVISION: PROJECT NAME:
CLAIREMONT
WARMINGTON NDP
SHEET TITLE:
PLAN 5
UNIT PLANS REVISION: ORIGINAL DATE: 07-15-2021

SHEET A3.40




FRONT ELEVATION - B500 - 5-PLEX

ALL STUCCO TO BE 16/20 FINISH ALL PAINT TO BE SHERWIN WILLIAMS



Architecture + Planning 17911 Von Karman Ave, Suite 200 Irvine, CA 92614 949.851.2133 | PREPARED_BY. | ST SUBMITTAL: 10-23-2020. | ST SUBMITTAL: 10-201-2021. | ST SUBMITTAL: 10-2021. | ST SUBMITTAL: 10-2021. | ST SUBMITTAL: 10-2021. | ST SUBMITTAL

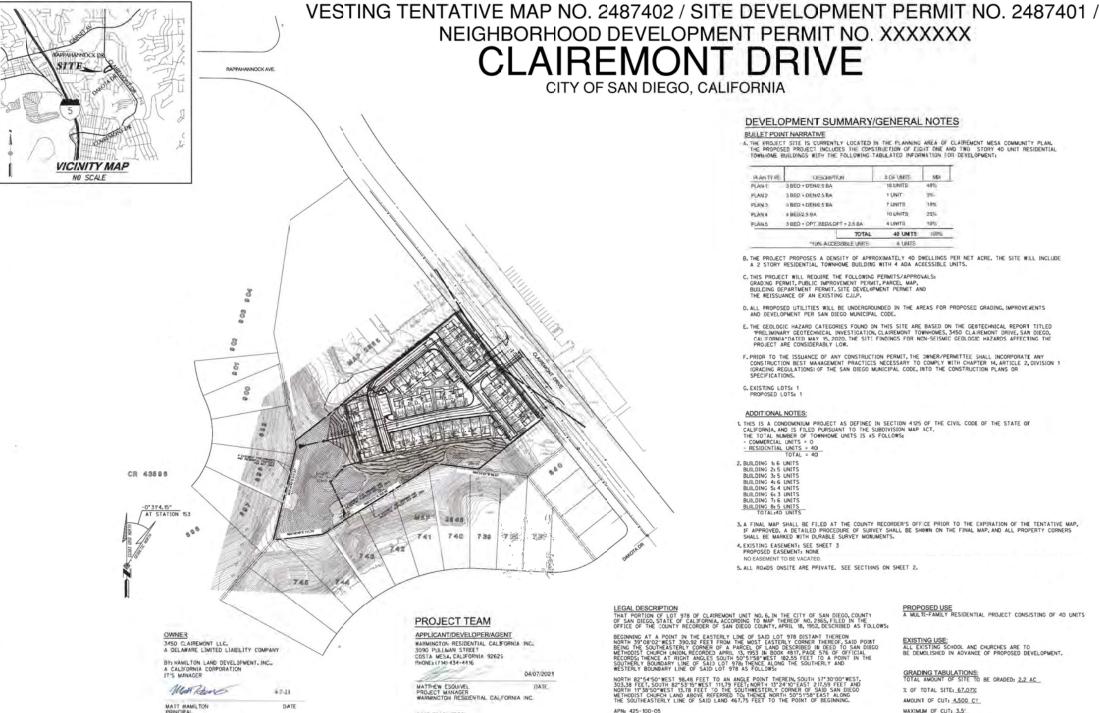SHEET A4.00



PHONE : (619) 291-0707

PHONE: (619) 284-3815

PHONE: (858) 292-8030

SHEET INDEX

GEOTECHNICAL ENGINEER

G. GRADING & DRAINAGE PLAN 7. SITE UTILITIES 8. SITE CROSS SECTIONS

9. ACCESSIBILITY PLAN 10. FIRE ACCESS PLAN

SHEET INDEX

1. TITLE SHEET FOR TENTATIVE MAP/SITE PLAN

2. DETAILS AND SECTIONS

3. TOPOGRAPHIC AND MAPPING CONSTRAINTS MAP

4. SLOPE ANALYSIS EXHIBIT

5. SITE PLAN/TENTATIVE MAP

5. DEDINGE BLAN

DENMARE BLAN

1. DENMARE BLAN

ABBREVIATIONS
HT HEIGHT
FF FINISH FLOOR
FS FINISH SURFACE
FL FLOW LINE
100 IRREVOCABLE OFFER OF DEDICATION
1E. INVERT ELEVATION
FE PAD ELEVATION
PM PM FLOOR OFFER OF DEDICATION
PM PM FLOOR OF THE PROPERTY O

PRIVATE TOP OF GRADE TOP OF PIPE

ENVIRONMENTAL CONSULTANT

DEVELOPMENT SUMMARY/GENERAL NOTES

A THE PROJECT SITE IS CURRENTLY LOCATED IN THE PLANNING AREA OF CLAIREMENT MESA COMMUNITY PLAN. THE PROPOSED PROJECT INCLUDES THE CONSTRUCTION OF EIGHT DNE AND TWO STORY 40 UNIT RESIDENTIAL TOWNSOME BUILDINGS WITH THE FOLLOWING TABLACTED INFORMATION FOR DEVELOPMENT:

MANTINE	DESCRIPTION		A DE UMIS	1/01
PLAN-T	3 BEO + DENIES BA		18 UNITS	45%
PLAN2	1 BEO + DENG 5 BA		1 UNIT	3%
PLAN 3	A BED + DENG 5 BA		7 UNITS	18%
PLAN4	4 BED/2 5 BA		10 UNITS	25%
PLANÓ	3 BED + OPT BED/LOFT +	2.5 BA	4 UNITS	10%
		TOTAL	40 UMTS	100%
	"ADM ACTIFICIEN	DEVINES:	A UNITS	

- B. THE PROJECT PROPOSES A DENSITY OF APPROXIMATELY 40 DWELLINGS PER NET ACRE. THE SITE WILL INCLUDE A 2 STORY RESIDENTIAL TOWNHOME BUILDING WITH 4 ADA ACCESSIBLE UNITS.
- C. THIS PROJECT WILL REQUIRE THE FOLLOWING PERMITS/APPROVALS: GRADNO PERMIT, PUBLIC IMPROVEMENT PERMIT, PARCEL MAP, BUILCING DEPARTMENT FERMIT, SITE DEVELOPMENT PERMIT AND THE REISSUANCE OF AN EXISTING CLUP.
- D. ALL PROPOSED UTILITIES WILL BE UNDERGROUNDED IN THE AREAS FOR PROPOSED GRADING, IMPROVEMENTS AND DEVELOPMENT PER SAN DIEGO MUNICIPAL CODE.
- E. THE CEOLOGIC HAZARD CATEGORIES FOUND ON THIS SITE ARE BASED ON THE GEOTECHNICAL REPORT TITLED PRELIMINARY GEOTECHNICAL INVESTIGATION, CLAIREMONT TOWNHOMES, 3450 CLAIREMONT DRIVE, SAN DIEGO, CALFORNIA-DATED MAY 18, 2020. THE SIT! FINDINGS FOR NON-SEISMIC GEOLOGIC HAZARDS AFFECTING THE PROJECT ARE CONSIDERABLY LOW.
- F. PRIOR TO THE ISSUANCE OF ANY CONSTRUCTION PERMIT, THE DWNER/PERMITTEE SHALL INCORPORATE ANY CONSTRUCTION BEST MANAGEMENT PRACTICES NECESSARY TO COMPLY WITH CHAPTER 14, ARTICLE 2, DIVISION 1 (GRACING REGULATIONS) OF THE SAN DIEGO MUNICIPAL CODE, INTO THE CONSTRUCTION PLANS OR SPECIFICATIONS.

1. THIS IS A CONDOMINIUM PROJECT AS DEFINED IN SECTION 4125 OF THE CIVIL CODE OF THE STATE OF CALIFORNIA, AND IS FILED PURSUANT TO THE SUBDIVISION MAD LCT, THE TOTAL NUMBER OF TOWNHOME UNITS IS AS FOLLOWS:

- COMMERCIAL UNITS = 0 - RESIDENTIAL UNITS = 40 TOTAL = 40

3. A FINAL MAP SHALL BE FILED AT THE COUNTY RECORDER'S OFFICE PRIOR TO THE EXPIRATION OF THE TENTATIVE MAP, IF APPROVED, A DETAILED PROCEDURE OF SURVEY SHALL BE SHOWN ON THE FINAL MAP, AND ALL PROPERTY CORNERS SHALL BE MARKED WITH DURABLE SURVEY MURILWENTS.

4. EXISTING EASEMENT: SEE SHEET 3
PROPOSED EASEMENT: NONE

5. ALL ROADS ONSITE ARE PRIVATE. SEE SECTIONS ON SHEET 2.

BASIS OF BEARINGS
THE BASIS OF BEARINGS AND COORDINATES FOR THIS SURVEY IS THE CALIFORNIA COORDINATE SYSTEM OF 1885 CCC5833, ZONE 6, EPOCH 1991.35, BASED UPON THE GRID BEARING BETWEEN GPS STATIONS 163 AND 207, AND IS DETERMINED BY GPS MEASUREMENTS TAKEN ON SEPTEMBER 14, 2020, BOTH STATIONS HAYING & COORDINATE VALUE OF FIRST ORDER ACCURACY OR BETTER PER RECORD OF SURVEY 14492.

I.E. GPS STATIOM 153 TO 207: S 36"22"45" W

STATION 153
FD STD. STREET SURVEY MONUMENT (NO STAMPING) ON CENTERLINE MT. ALAMAGOSA PL. AT ADDRESS NO. 3721
N: 18750-14.6
E: 6272/28.19
ELEVY.291.51 CGF: 9999874 CONVERGENCE: -0*31'4.15"

STATION 20T
FD 2"CDOT BRASS DISK IN CONC. BRIDGE "5-22.31 1992" ON CENTER MEDIAN OF
CLAIREMONT DR. BRIDGE OVER 1-5
Nº 1868806.54
F6.267.34.7
BASIS OF ELEVATIONS
THE BASIS OF ELEVATIONS FOR THIS SURVEY IS THE NATIONAL GEODETIC VERTICAL
DATUM OF 1929 MOVED-9, BASED 16 CALLY UPON THE WARD CLAIREMONT DR. &
APPAMANMONCK AVE., PER CITY OF SAM DIEGO VERTICAL CONTROL BOOK BATED OCTOBER 4, 2011.

ASSESSORS PARCEL NUMBER

TYPE OF CONSTRUCTION

OCCUPANCY CLASSIFICATION

EXISTING USE:
ALL EXISTING SCHOOL AND CHURCHES ARE TO
BE DEMOLISHED IN ADVANCE OF PROPOSED DEVELOPMENT

GRADING TABULATIONS: TOTAL AMOUNT OF SITE TO BE GRADED: 2.2 AC

AMOUNT OF CUT: 4,500 CY MAXIMUM OF CUT: 3.5' AMOUNT OF FILL: 8,000 CY MAXIMUM DEPTH OF FILL: 8.5' SLOPE RATIO: 2:1 MAXIMUM HT. OF CUT SLOPES: 14 SLOPE RATIO: 2:1 AMOUNT OF IMPORT SOIL: 3,500 CY RETAINING WALLS: •LENGTH: 900' •MAXIMUM HEIGHT: 12'

% OF TOTAL SITE: 67.07%

PROJECT GROSS SITE AREA GROSS LAND AREA: 3.28 AC. NET LAND AREA: 1.95 AC.

COMMUNITY PLAN AREA
CLAIREMONT MESA COMMUNITY PLAN

ZONING DESIGNATION EXISTING ZONING RM-1-1

SETBACK REQUIREMENTS



04/08/2021

PIET TITE:
VESTING TENTAIVE MAP/
SITE PLAN/ NEIGHBORHOOD
DEVELOFMENT PERMIT

LEGEND

ITEM	SYMBOL
PROPOSED IMPROVEMENTS *	
LOT LINE/ROW	
0"/4"/6" CONCRETE CURB/BERM & GUTTER (PVT)	
SIDEWALK	
ASPHALT PAWING	LESK WOOD NEW
CONCRETE	
PAD ELEVATION	PE=487.2
FINISH FLOOR ELEVATION	FF=492.5
DIRECTION OF FLOW	1.0%
DAYLIGHT LIME/GRADING LIMIT	
PROPOSED MAJOR CONTOUR	420
PROPOSED MINOR CONTOUR	
2:1 SLOPE (MAX)	
BROW DITCH	$\Rightarrow \Rightarrow$
SWALE	\rightarrow \rightarrow
ADA PATH OF TRAVEL	********
RETAINING WALL	
STORM DRAIN18" UNLESS OTHERWISE NOTED	—— SD———
CATCH BASIN	
TYPE A-4 CLEAN OUT	
CURB INLET	[3
STORM DRAIM HEADWALL	
RIPRAP	20
SEWER MANHOLE	0
SEWER B" UNLESS OTHERWISE NOTED	—— s ——
WATER 8" UNLESS OTHERWISE NOTED	— w ——
WATER METER W/BACKFLOW (PUBLIC)	
FIRE SERVICE 8" UNLESS CTHERWISE NOTED	FS
FIRE SERVICE W/BACKFLOW	
FIRE HYDRANI	DO4
STREET LIGHT	0-0

EXISTING IMPROVEMENTS

EXISTING	PROPERTY LINE	
EXISTING	LOT LINE/ROW	
EXISTING	CENTERLINE	
EXISTING	MAJOR CONTOUR	420
EXISTING	MINOR CONTOUR	
EXISTING	RO4D	
EXISTING	TREE OR BUSH	3 %
EXISTING	BUILDING OR MANMADE STRUCTURE	4
EXISTING	LICHT FIXTURE	*
EXISTING	SIGN	.a.
EXISTING	FENCE	- н н
EXISTING	PARKING SPACES	1111
EXISTING	WATER MAIN	w
EXISTING	SEWER MAIN	s
EXISTING	GAS LINE	G
EXISTING	DRY UTILITIES	· 0 0 0
EXISTING	SURVEY MONUMENT, AS NOTED	△ • ■

LAMBERT CCORDINATES: 232-1707 PTS: 0677814 NAD83: 1872-6267 1.0.: 24008739 PREPARED BY: RICK ENGINEERING COMPAN' REVISION 2: ADDRESS: 5620 FRIARS ROAD SAN DIEGO, CA. 92110 (619) 291-9707 REVISION 4: REVISION 5: REVISION 6: PROJECT NAME: CLAIREMONT REVISION 7: DRIVE

ORIGINAL DATE: 06/16/2021

SHEET 1 OF 10 JOB NUMBER: 19254

ARCHITECTURE & PLANNING

PHONE: 1949) 851-2133

PHONE: (951) 737-1124

SURVEYOR:

LANDSCAPE ARCHITECT

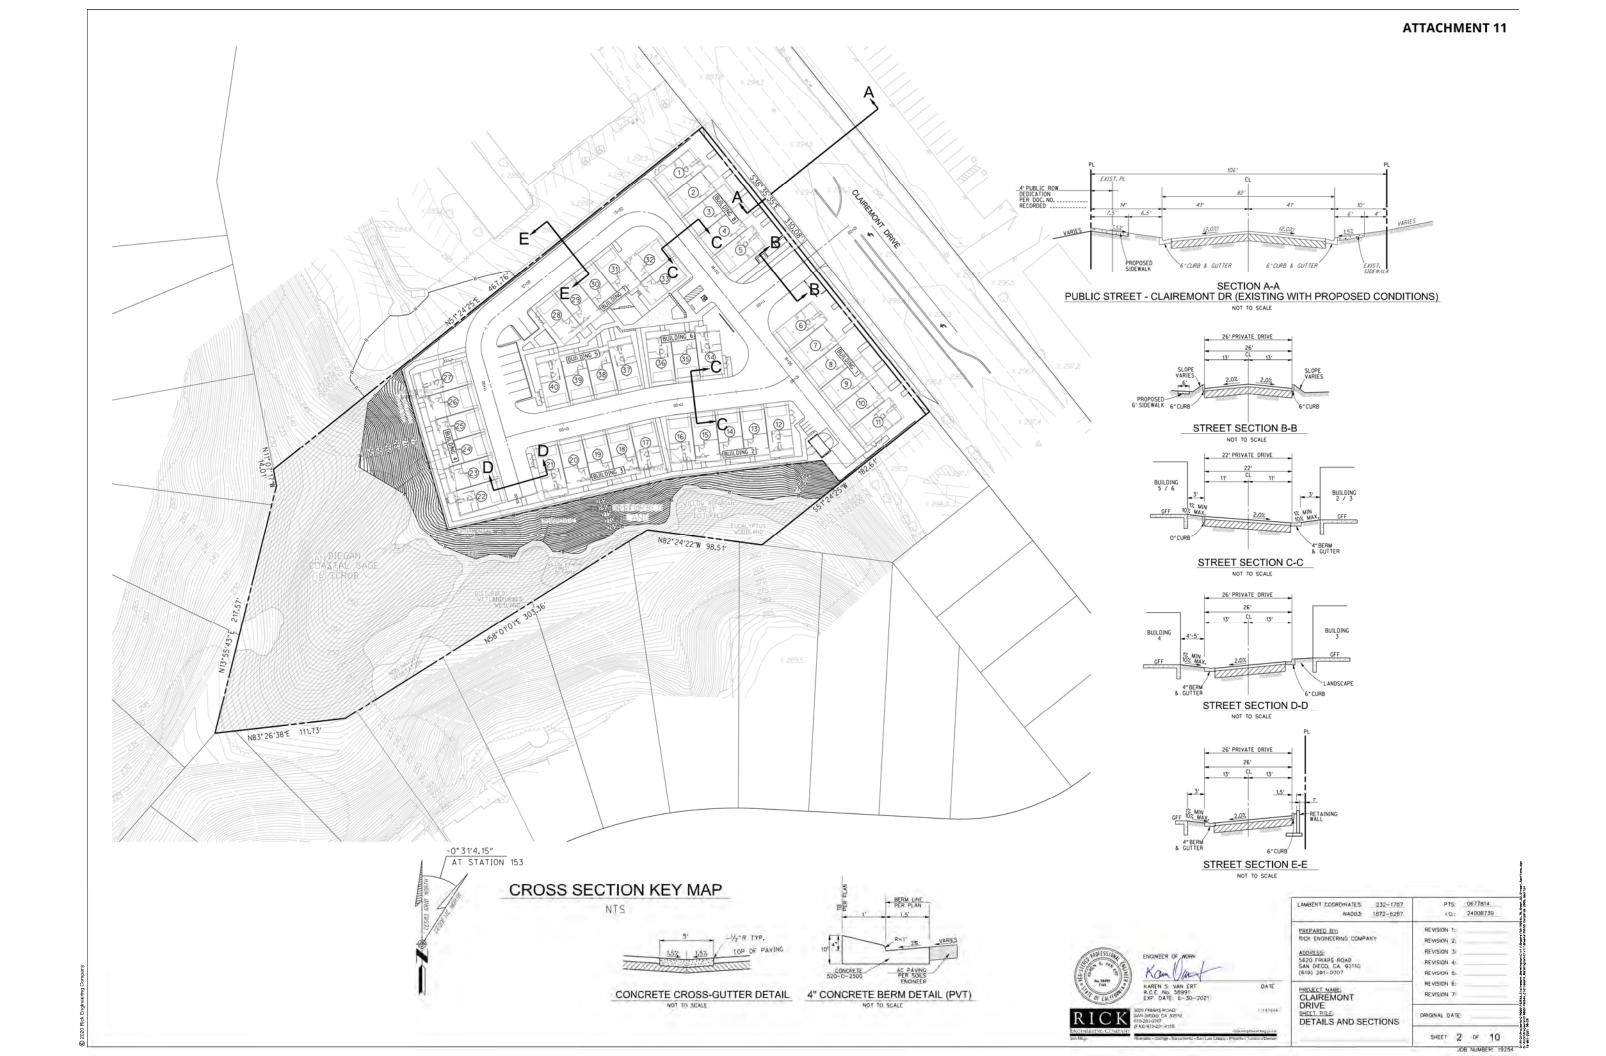
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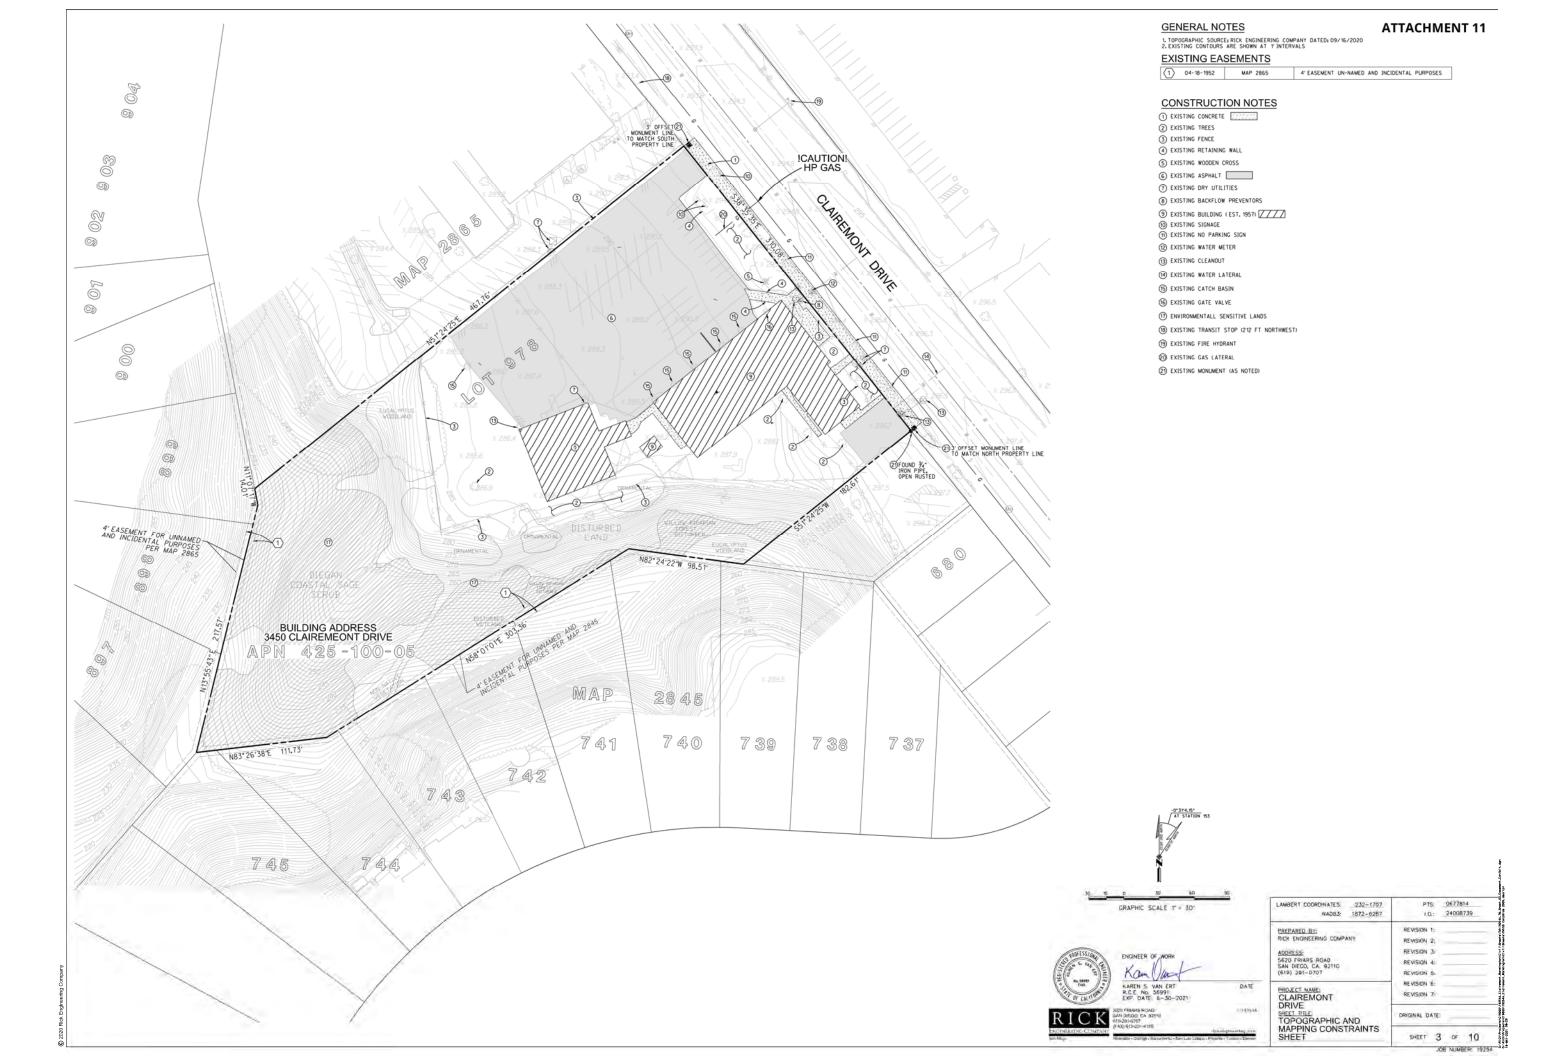
PATRICK A. McMICHAEL L.S. 61817 EXP. DATE: 3/31/2022

BMLA LANDSCAPE ARCHITECTURE 310 N. JOY STREET CORONA, CALIFORNIA 92879

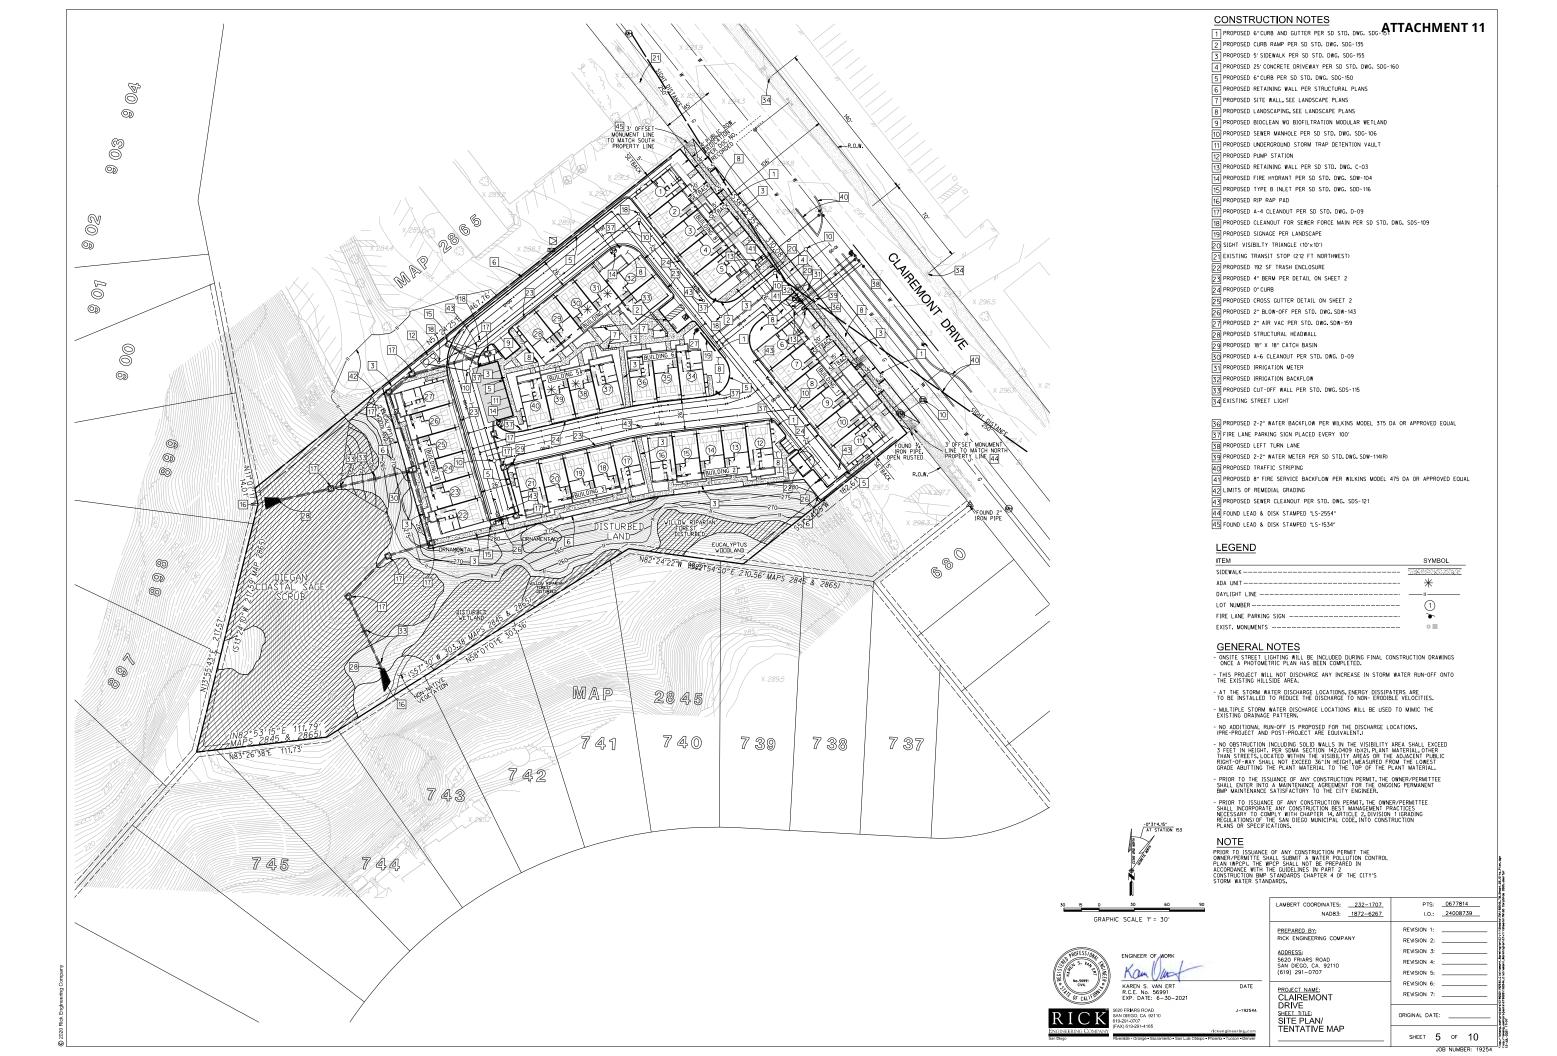
INFERENT DECLARE THAT I AM THE LAND SURVEYOR OF WORK FOR THIS PROJECT AND THAT I HAVE EXERCISED RESPONSIBLE CHARGE OVER THE LAND SURVEYING WORK FOR THIS PROJECT AS DEFINED IN SECTION 8703 OF THE BUSINESS AND PROFESSIONS CODE

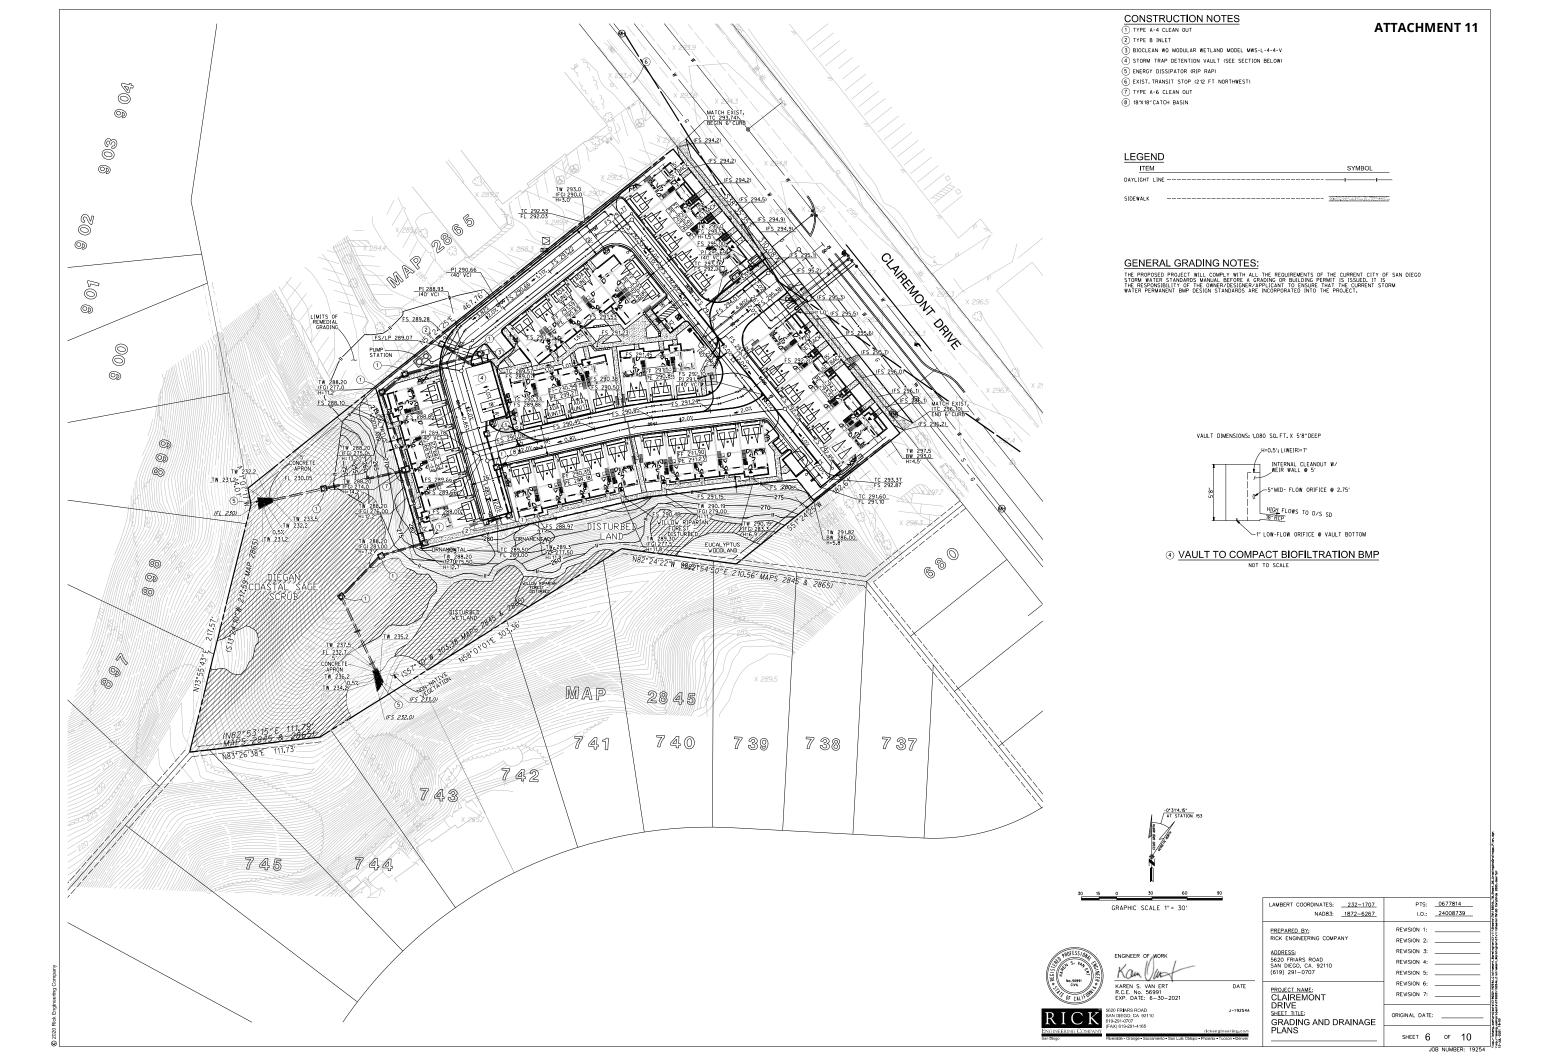
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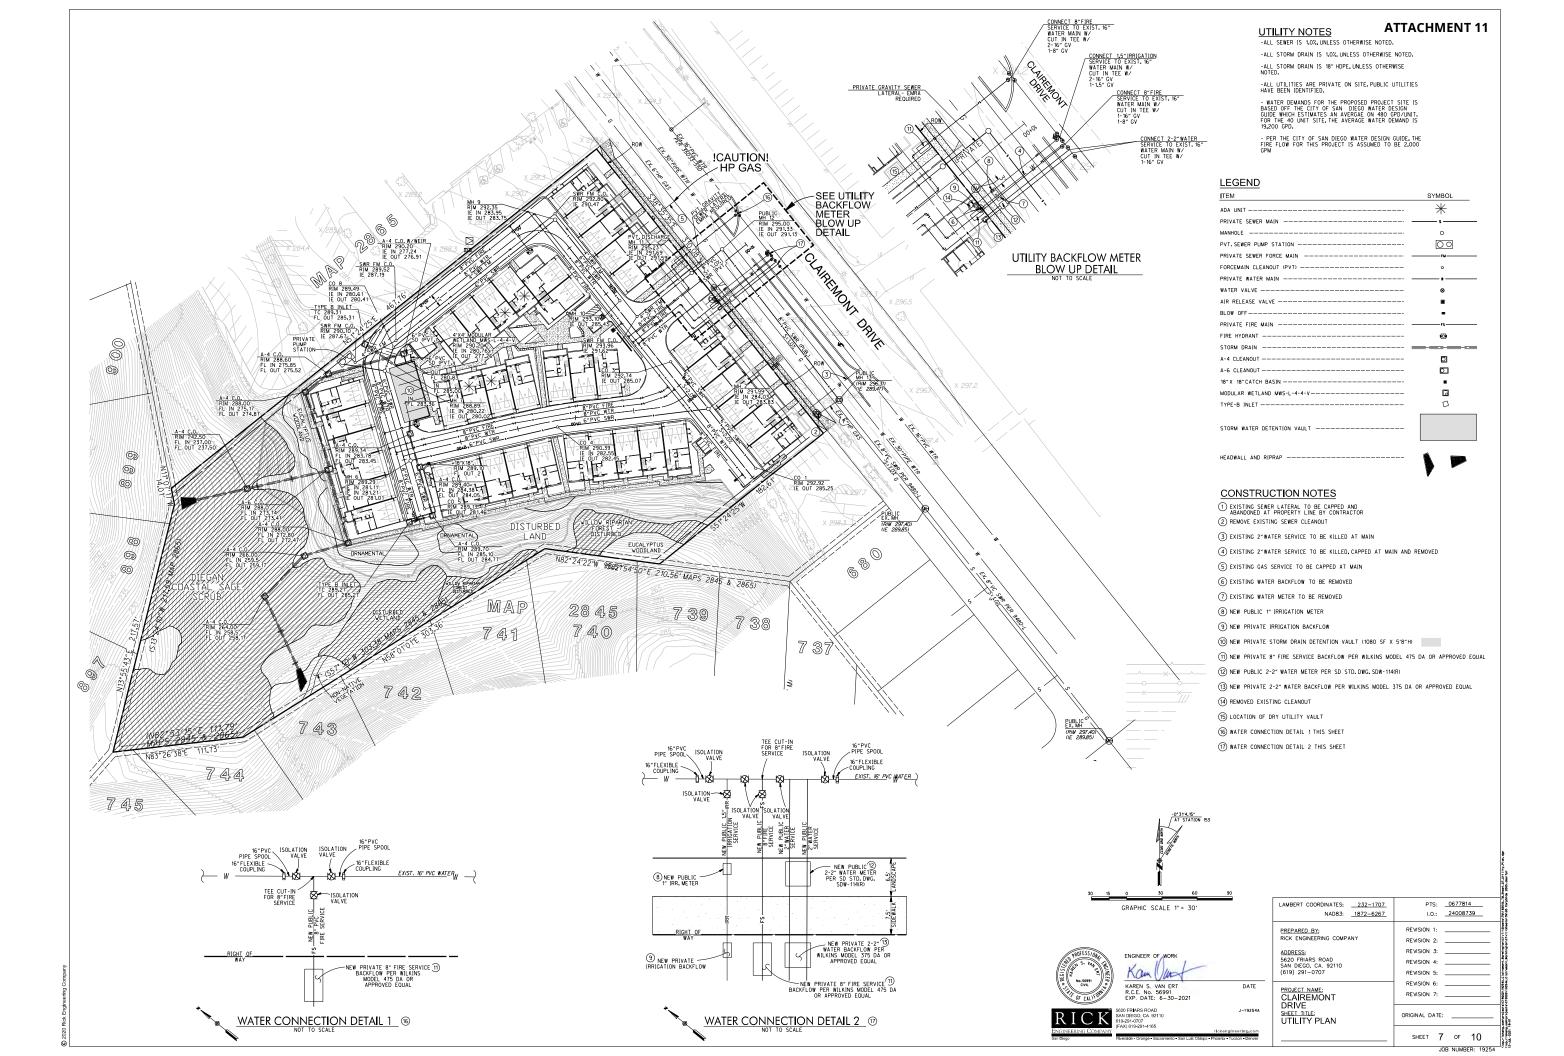


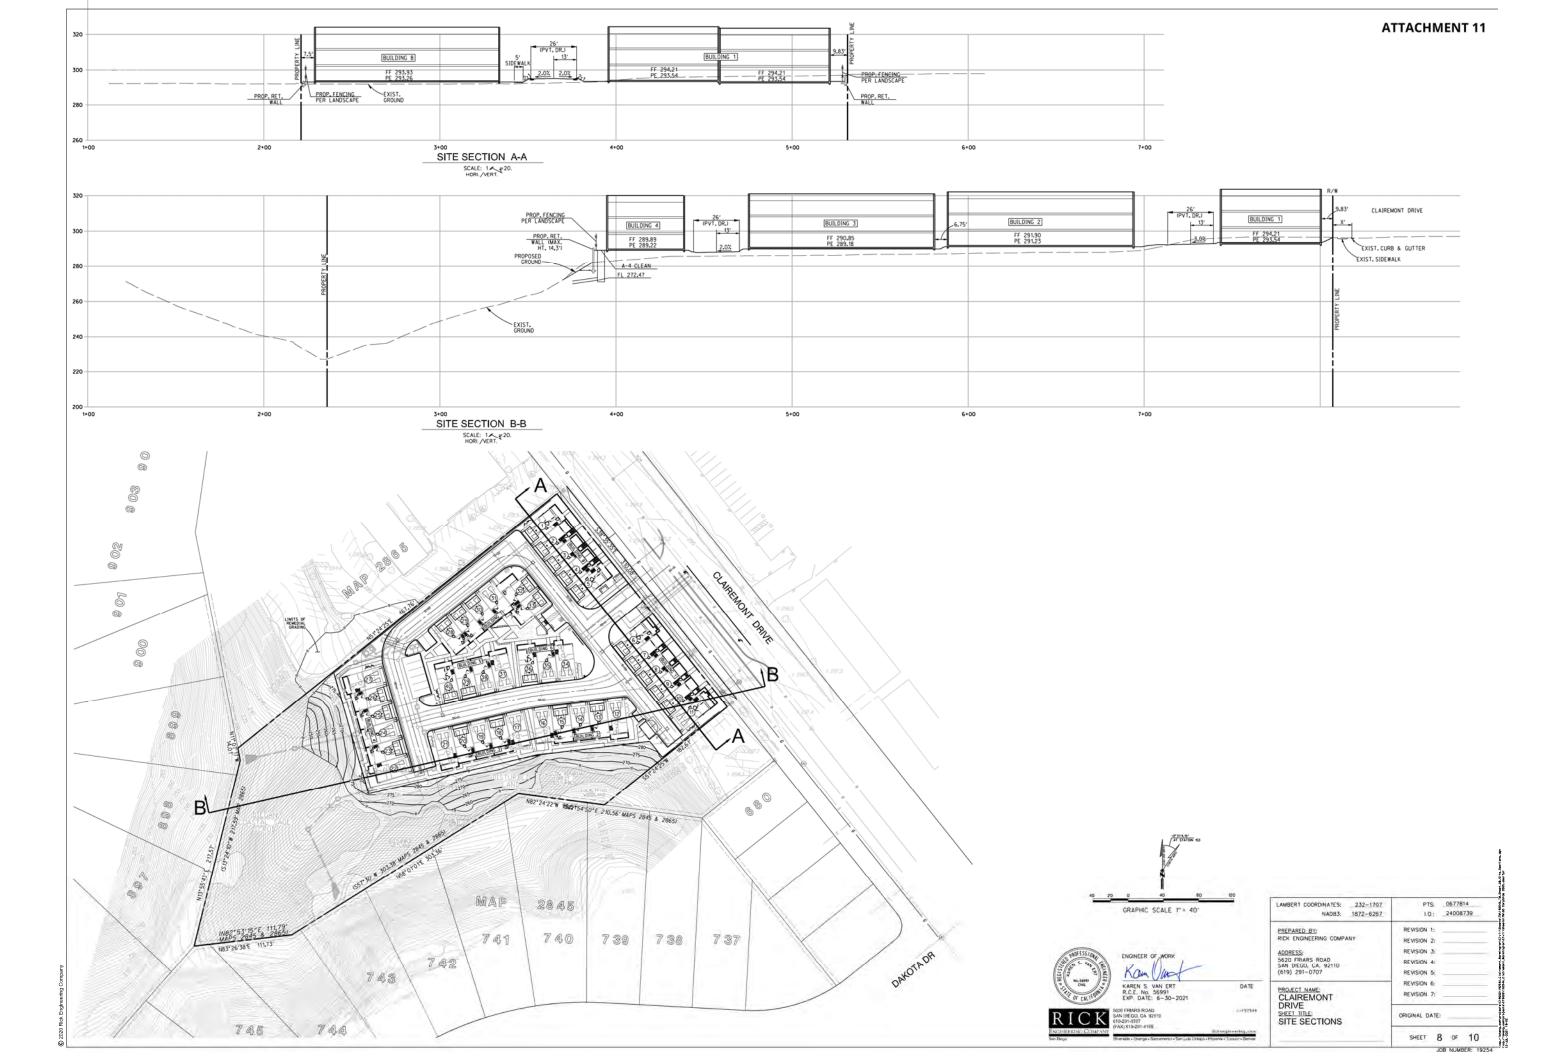
















Sheet List Table				
Sheet Number	Sheet Tit l e			
L-1	OVERALL LANDSCAPE PLAN			
L-2	CENTRAL COURTYARD ENLARGEMENT			
L-3	LANDSCAPE CALCULATIONS			
L-4	BRUSH MANAGEMENT PLAN			
L-5	WATER CONSERVATION PLAN			
L-6	CONCEPTUAL WALL AND FENCE PLAN			

PROPOSED STREET TREE CALCULATION

1 QTY, 24" BOX CANOPY TREE PER 30 LINEAR FEET OF STREET FRONTAGE, EXCLUDING CURB CUTS.

LINEAR FEET OF STREET FRONTAGE: 284 LF REQUIRED STREET TREES: 10 PROVIDED STREET TREES: 10

CONCEPT STATEMENT

LANDSCAPE CONCEPT:
This landscape will consist of climate adaptive and appropriate, low water use planting categories as described by the WUCOLS system. Plant material has been chosen to provide site wide coverage, parkway shade, and to accentuate the entry into the site. A mixture of Califfornia natives and drought-tolerant plant species have been selected to compliment the architecture and provide assentic interest. Maintenance and longevity of the plant material has been taken into consideration. Root panels and barriers will be provided on all trees necessary, consistent with all standards and specifications. A 3" layer of bark mulch will be used in all landscape areas. All landscape areas will conform to current City of San Diego landscape guidelines.

IRRIGATION CONCEPT:

IRRICATION CONCEPT:

The irrigation design will incorporate the latest in smart irrigation technologies. All new planter areas will include drip line. All planters will use drip line with an irrigation efficiency of .81. A smart irrigation controller with a rain shut off device will also be incorporated. Bark mulch will be used to retain moisture and reduce evaporation and an irrigation schedules will be provided to program the controller. Two irrigation schedules shall be prepared, one for plant establishment and one for after plant establishment. All new irrigation systems will compty with all current City of San Diego guidelines.

EXISTING TREES TO BE REMOVED

EXISTING PINE (2 QTY.) - SIZE: 15" - SIZE: 24"

EXISTING TREE SP. (3 QTY.)
- SIZE: 8"
- SIZE: 12"
- SIZE: 36"

TREE NOTES:

1. ALL TREES PLANTED A MINIMUM OF 4' FROM BUILDING.

2. A MINIMUM ROOT ZONE OF 40 SF IN AREA SHALL BE PROVIDED FOR ALL TREES.
THE MINIMUM DIMENSION FOR THIS AREA SHALL BE 5 FEET, PER SDMC 142,0403(B)(5).

3. MINIMUM TREE SEPARATION DISTANCE:
TRAFFIC SIGNALS / STOP SIGNS - 20 FT
UNDERGROUND UTILITY LINES - 5 FT (10 FT FOR SEWER)
ABOVE GROUND UTILITY STRUCTURES - 10 FT
DRIVEWAY (ENTRIES) - 10 FT
INTERSECTIONS (INTERSECTING CURB LINES OF TWO STREETS - 25 FT

IRRIGATION NOTES:

1. AN AUTOMATIC, ELECTRICALLY CONTROLLED IRRIGATION SYSTEM SHALL BE PROVIDED AS REQUIRED BY LDC 142,0403(C) FOR PROPER IRRIGATION, DEVELOPMENT, AND MAINTENANCE OF THE VEGETATION IN A HEALTHY, DISEASE-RESISTANT CONDITION, THE DESIGN OF THE SYSTEM SHALL PROVIDE ADEQUATE SUPPORT FOR THE VEGETATION SELECTED.

2. ALL LANDSCAPE AND IRRIGATION SHALL CONFORM TO THE STANDARDS OF THE CITY-WIDE LANDSCAPE REGULATIONS AND THE CITY OF SAN DIEGO LAND DEVELOPMENT MANUAL LANDSCAPE STANDARDS, AND ALL OTHER LANDSCAPE RELATED CITY AND REGIONAL STANDARDS.

SEE SHEET L-4

MAINTENANCE NOTE:

1. ALL REQUIRED LANDSCAPE AREAS SHALL BE MAINTAINED BY MASTER HOA. LANDSCAPE AND IRRIGATION AREAS IN THE PUBLIC RIGHT-OF-WAY SHALL BE MAINTAINED BY MASTER HOA. THE LANDSCAPE AREAS SHALL BE MAINTAINED FREE OF DEBRIS AND LITTER, AND ALL PLANT MATERIAL SHALL BE MAINTAINED IN A HEALTHY GROWING CONDITION. DISEASED OR DEAD PLANT MATERIAL SHALL BE SATISFACTORILY TREATED OR REPLACED PER THE CONDITIONS OF THE PERMIT.

VICINITY MAP SITE



LAMBERT COORDINATES: 232-1707 NAD83: 1872-6267	PTS: <u>0677814</u> I,O.: <u>24008739</u>
PREPARED BY; RICK EMGINEERING COMPANY ADDRESS; 5820 FRIJARS ROAD SAN DIEGO, CA. 92110 (619) 291-0707	REVISION 1: REVISION 2: REVISION 3: REVISION 4: REVISION 5:
PROJECT NAME: CLAIREMONT DRIVE	REVISION 7:
SHEET TITLE:	DATE:7/13/2021
OVERALL LANDSCAPE PLAN	янеет 1 оғ 6

L A N D S C A P E 310 NORTH JOY STREET | CORONA, CA 92879

T: 951.737.1124 | F: 951.737.6551

JOB NUMBER: 19254

ATTACHMENT 11

TREES	BOTANICAL / COMMON NAME	SIZE	MATURE	WUCOLS	QTY	FORM / FUNCTION
•	CALLISTEMON VIMINALIS 'RED CASCADE' RED CASCADE WEEPING BOTTLEBRUSH CERCIS OCCIDENTALIS WESTERN REDBUD	24"BOX	20°H X 15°W	L	14	SMALL ACCENT TREE
No.	CERCIDIUM X 'DESERT MUSEUM' THORNLESS PALO VERDE MULTI-TRUNK SOPHORA SECUNDIFICORA TEXAS MOUNTAIN LAUREL	36"BOX	25°H X 25°W	L	17	FLOWERING SPECIMEN TREE
	DRACAENA DRACO DRAGON TREE ACACIA BAILEYANA FERNLEAF ACACIA	24"BOX	20°H X 15°W	L	5	SMALL ACCENT TREE
	PYRUS CALLERYANA 'CHANTICLEER' CHANTICLEER CALLERY PEAR RHAPHOLEPIS I, "MAJESTIC BEAUTY' MAJESTIC BEAUTY HAWTHORN STANDARD	24"BOX	20°H X 10°W	М	10	NARROW ACCENT TREE
0	QUERCUS AGRIFOLIA COAST LIVE OAK CEDRUS DEODAR DEODAR CEDAR	24"BOX	30`-50`H X 25`-50`W	L	5	EVERGREEN ANCHOR TREE
STREET TREE	BOTANICAL / COMMON NAME	SIZE	MATURE	WUCOLS	QTY	FORM / FUNCTION
	JACARANDA MIMOSIFOLIA BLUE JACARANDA	24"BOX	30.H X 30.M	М	10	BROAD CANOPY PARKWAY TREE
JPRIGHT ACCENT	BOTANICAL / COMMON NAME	SIZE	MATURE	WUCOLS	QTY	FORM / FUNCTION
•	CUPRESSUS SEMPERVIRENS 'MONSHEL' TINY TOWER ITALIAN CYPRESS	15 GAL	25°H X 3°W	L	38	COLUMNAR ACCENT
©	DODONAEA VISCOSA 'PURPUREA' PURPLE LEAFED HOPSEED BUSH	15 GAL	12'H X 6'W	L	38	COLUMNAR ACCENT
•	LAURUS NOBILIS SWEET BAY	15 GAL	12'H X 12'W	L	54	COLUMNAR ACCENT

NOTE: ALL TREES PLANTED A MINIMUM OF 4' FROM BUILDING,

SHRUBS	BOTANICAL / COMMON NAME	SIZE	MATURE	WUCOLS	FORM / FUNCTION
	AGAVE ATTENUATA 'KARA'S STRIPES' KARA'S STRIPES FOXTAIL AGAVE	15 GAL	3`H X 4`W	L	SCULPTURAL ACCENT
	AGAVE X 'BLUE GLOW' BLUE GLOW AGAVE	5 GAL	2`H X 3`W	L	SCULPTURAL ACCENT
	ALOE STRIATA CORAL ALOE	5 GAL	2` - 3`H X 2`W	L	LOW MIDGROUND SHRUE
	CALLISTEMON VIMINALIS 'LITTLE JOHN' LITTLE JOHN WEEPING BOTTLEBRUSH	5 GAL	3'H X 5'W	L	MIDGROUND SHRUB
	OLEA EUROPAEA 'LITTLE OLLIE' TM LITTLE OLLIE OLIVE	5 GAL	4°H X 4°W	L	FOUNDATION SHRUB
	ROSMARINUS OFFICINALIS 'TUSCAN BLUE' TUSCAN BLUE ROSEMARY	5 GAL	6°H X 4°W	L	FOUNDATION SHRUB
	LANTANA X 'NEW GOLD' NEW GOLD LANTANA	5 GAL @ 36" O.C.	1.5°H X 4°W	L	LOW MIDGROUND SHRUE
	SALVIA X 'BEE'S BLISS' BEE'S BLISS SAGE	1 GAL @ 18" O.C.	1`-3`H X 5`W	L	FOREGROUND
	SENECIO MANDRALISCAE BLUE FINGERS	1 GAL @ 24" O.C.	2°H X 3°W	L	GROUNDCOVER
GROUND COVERS	BOTANICAL / COMMON NAME	SIZE	1	WUCOLS	FORM / FUNCTION

PARKWAY UNDERSTORY PLANTING					
SHRUBS	BOTANICAL / COMMON NAME	SIZE	MATURE	WUCOLS	FORM / FUNCTION
	LANTANA X `NEW GOLD` NEW GOLD LANTANA	5 GAL @ 36" O.C.	1.5`H X 4`W	L	LOW MIDGROUND SHRUB
	SALVIA X 'BEE'S BLISS' BEE'S BLISS SAGE	1 GAL @ 18" O.C.	1'-3'H X 5'W	L	FOREGROUND


NOTE: PLANT MATERIAL, OTHER THAN TREES, LOCATED WITHIN VISIBILITY AREAS OR THE ADJACENT PUBLIC RIGHT-OF-WAY SHALL NOT EXCEED 36" IN HEIGHT.

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NORTH	0'	10'	20'	30 ¹


LAMBERT COORDINATES: 232-1 <u>707</u> NAD83: 18 <u>72-6267</u>	PTS: <u>0677814</u> I.O.: <u>24008739</u>
PREPARED BY. RICK ENGINEERING COMPANY ADDRESS: 5620 FRIARS ROAD SAN DIEGO, CA, 92110 (619) 291-0707	REVISION 1: REVISION 2: REVISION 3: REVISION 4: REVISION 5:
PROJECT NAME: CLAIREMONT DRIVE	REVISION 6:
SHEET TITLE: CENTRAL COURTYARD	DATE: <u>7/13/2021</u>
ENLARGEMENT	SHEET 2 OF 6


CENTRAL COURTYARD ENLARGEMENT LEGEND 1. TURF 2. CMU SEAT WALLS 3. TABLES - 2 TOTAL, 1 ADA ACCESSIBLE
4. BBQ AREA 5. PARKING LOT - 10 SPACES TOTAL, 1 ADA ACCESSIBLE 6. ENTRY MONUMENT

NATIVE CONTAINER STOCK	SIZE	WUCOLS	QTY
ARTEMISIA CALIFORNICA CALIFORNIA SAGEBRUSH	1 GAL	L	50
ERIOGONUM FASCICULATUM COMMON BUCKWHEAT	1 GAL	L	50
STIPA LEPIDA FOOTHILL NEEDLEGRASS	1 GAL	L	50
NATIVE MIX	SIZE	WUCOLS	LBS/ ACRE
ACMISPON GLABER DEERWEED	HYDROSEED	L	2
ARTEMISIA CALIFORNICA CALIFORNIA SAGEBRUSH	HYDROSEED	L	5
DEINANDRA FASCICULATA FASCICLED TARWEED	HYDROSEED	L	3
ENCELIA CALIFORNICA CALIFORNIA ENCELIA	HYDROSEED	L	3
ERIOGONUM FASCICULATUM COMMON BUCKWHEAT	HYDROSEED	L	5
ERIOPHYLLUM CONFERTIFLORUM GOLDEN YARROW	HYDROSEED	L	3
GNAPHALIUM CALIFORNICUM PEARLY EVERLASTING	HYDROSEED	L	3
LASTHENIA CALIFORNICA CALIFORNIA GOLDFIELDS	HYDROSEED	L	2
PLANTAGO ERECTA DOTSEED PLANTA I N	HYDROSEED	L	3
SALVIA APIANA WHITE SAGE	HYDROSEED	L	3
STIPA LEPIDA FOOTHILL NEEDLEGRASS	HYDROSEED	L	6

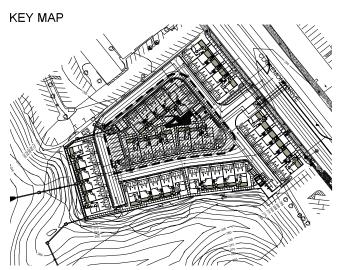

A N D S C A P E 310 NORTH JOY STREET | CORONA, CA 92879 R C H I T E C T U R E T: 951.737.1124 | F: 951.737.6551

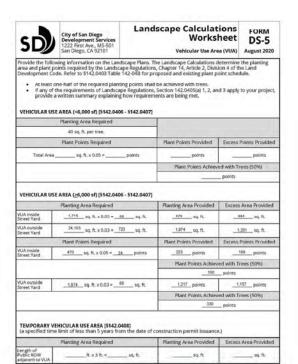

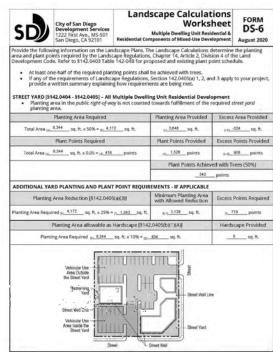


Planting Area Required	Planting Area Provided	Excess Area Provided
Total Area 15,838 sq. ft. x 20% = 3,168 sq. ft.	sq. ft.	sq. ft.
Plant Points Required	Plant Points Provided	Excess Points Provided
Total Area 15,638 sq. ft. x 0.05 = 792 sq. ft.	points	163 points
	Plant Points Arbityed with Trees (50%)	
	415	points
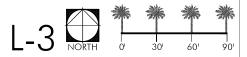
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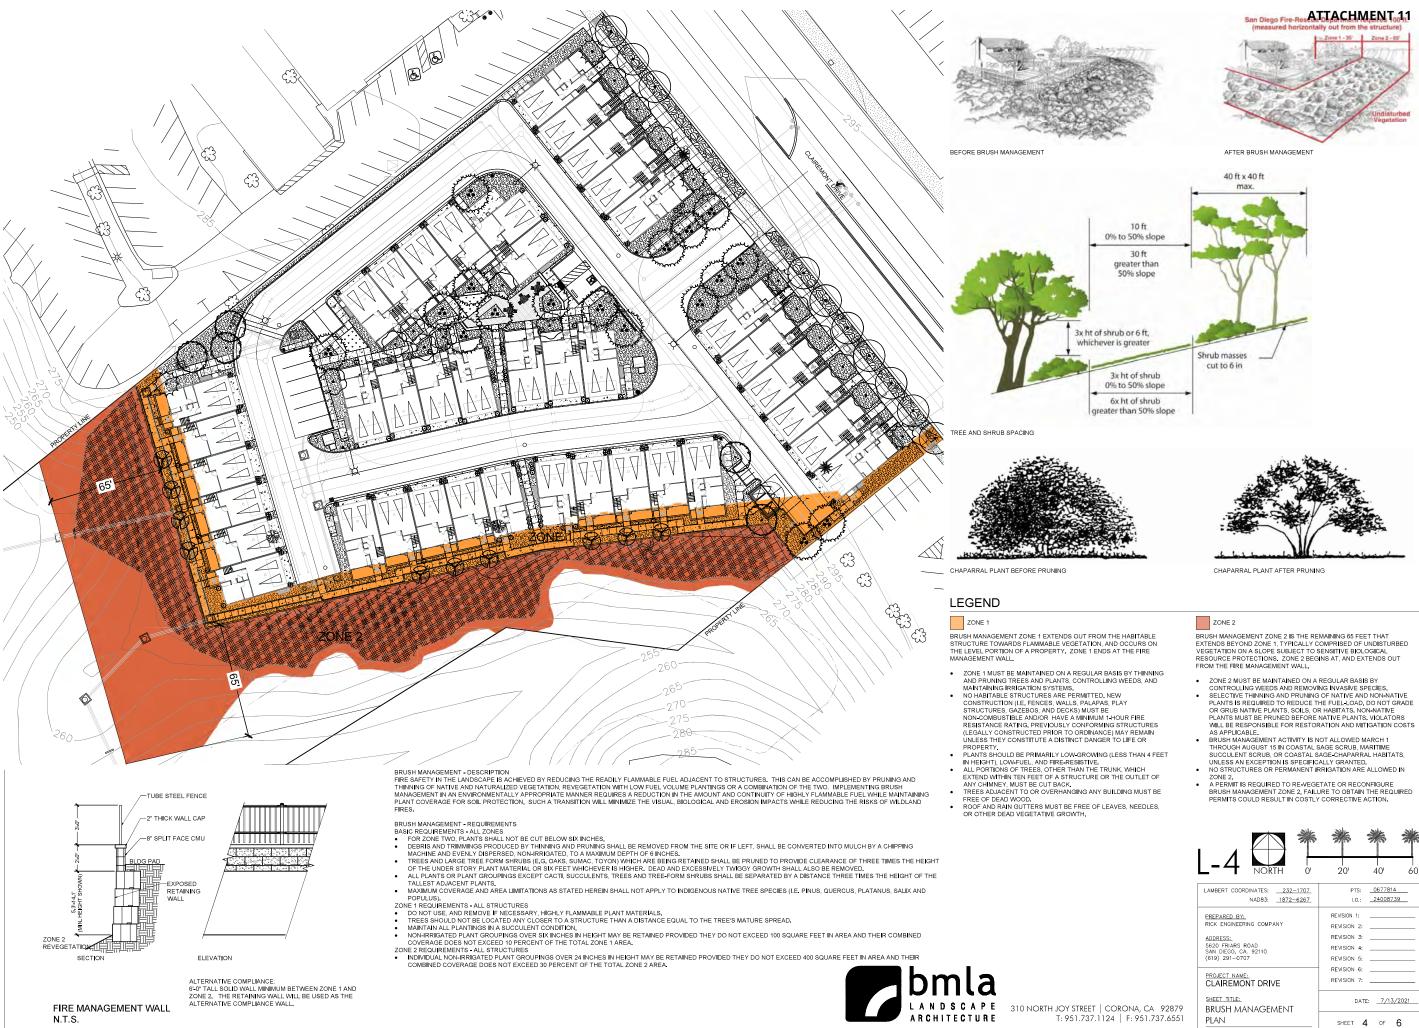










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LAMBERT COORDINATES: <u>232-1707</u> NAD83: <u>1872-6267</u>	PTS: <u>0677814</u> LO:: <u>24008739</u>
PREPARED BY: RICK ENGINEERING COMPANY ADDRESS: 5620 FRIARS ROAD SAN DIEGO, CA. 92110 (619) 291–0707	REVISION 1:
PROJECT NAME: CLAIREMONT DRIVE	REVISION 6:
SHEET TITLE:	DATE: _7/13/2021
OVERALL LANDSCAPE PLAN	SHEET 3 OF 6
	JOB NUMBER: 19254



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LAMBERT COORDINATES: <u>232-1707</u> NAD83: <u>1872-6267</u> PTS: <u>0677814</u> I.O.: <u>24008739</u> REVISION 1: REVISION 2: REVISION 3: REVISION 4: REVISION 5: REVISION 6: ___ PROJECT NAME: CLAIREMONT DRIVE REVISION 7: ____ SHEET TITLE: WATER CONSERVATION PLAN



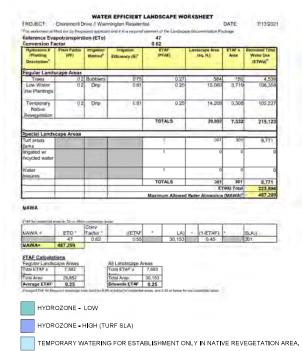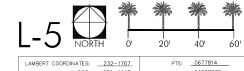