TORREY PINES SCIENCE PARK, LOT 12 COASTAL DEVELOPMENT PERMIT / SITE DEVELOPMENT PERMIT SUBMITTAL PACKAGE

PROJECT DIRECTORY

OWNER:

ARE - SD REG(ON NO. 17, (LC 9820 WILOW CREEK ROAD, SUITE 440 SAN DEGO, CA 92131 PHONE: (858) 530-8190 - FAX: (858) 530-8791

ARCHITECT.

MoFARLANE ARCHITECTS 4350 EXECUTIVE DRIVE, SUITE 315 SAN D/EGO, CA 92121 PHONE: (858) 453-1150 FAX: (858) 453-1911

CIVIL ENGINEER:

RBF CONSULTING 9755 CLAIRMONT MESA BOUREVARD, SUME TOO SAN DIEGO, CA 92/24 PHONE: (858) 614-5000 FAX: (858) 614-5001

LANDSCAPE ARCHITECT:

NOWE: # ASSOCIATES 4010 COLDFINCH STREET SAN DIEGO, CA 92103 PHONE: (619) 325-1990 FAX: (679) 325 1997

CONTACT: JEFF RYAN, VICE PRESIDENT VICE PRESIDENT.

CONTACT: NEAL MOFARLANE, AIA FRESIDENT

CONTACT: BRIAN OLIVER, 9. VICE PRESIDENT

CONTACT: GREG NOWFLL, ASLA

FRINCIPAL.

CODE ANALYSIS

APPLICABLE CODES: 2001 CALIFORNIA BUILDING CODE (C.B.C.)

- 2. 2001 CAUFORNIA MECHANICAL CODE (C.M.C) 2001 CALIFORNIA PLUMBING CODE (C.P.C)
- 2001 CAGEORNIA FIRE CODE (C.P.C) 5. 2001 CALIFORNIA ELECTRICAL CODE (C.E.C)

EXISTING TWO STORY R&D BUILDING	
TYPE OF CONSTRUCTION PER C.B.C.: OCCUPANCY PER C.B.C.:	TYPE V-N FULLY SPRINKLERED 'B'
NUMBER OF STORIES:	TWO STORIES ABOVE GRADE ONLY
TABLE 3-B REQUIRED SEPARATION IN	BUILDINGS OF MIXED OCCUPA
OCCUPANCIES TO BE SEPARATED: NONE	FIRE RESISTIVE REQUIREMENT: NONE
TABLE 5-A EXTERIOR WALL AND OPEN	NING PROTECTION:
EXTERIOR WALLS-BEARING:	T HR LEBS (HAN 20' NR ELSEWRERE
EXTERIOR WALLS-NON BEARING:	SAME AS BEARING
OPENINGS: TABLE 4 A TYPE V A: CODE DESISTING (E. C.	NOT PERMITTED LESS THAN 5 FL. PROTECTED LESS THAN TO FT.
TABLE 6-A, TYPE V - N, FIRE RESISTIVE (BUILDING ELEMENT	
2. BEARING WALLS EXTERIOR 2. BEARING WALLS INTERIOR	FIRE RESISTIVE REQUIREMENT NR NR
OLANNO WALLS - INTERIOR NON-BEARING WALLS - EXTERIOR STRUCTURAL FRAME	NR NR
5. PARTITIONS - PERMANENT 6. SHAFT ENGLOSURES	NR L MR
 BLOOR - FLOOR / CEILING5 ROOF - ROOF / CEILING5 	NR NR
9. EXTERIOR DOORS AND WINDOWS 10. STAIRWAY CONSTRUCTION	PER SECTION GOGLE, SEE TABLE S-A PER SECTION GOGLE, SEE TABLE S-A
NEW TWO STORY R&D BUILDING	
TYPE OF CONSTRUCTION PER C.B.C.:	TYPE V-N 2001 SPRINKLERED
OCCUPANCY PER C.B.C.:	"D" (TWO STOR:ES ABOVE GRADE)
NUMBER OF STORIES:	"5-3" (ONE STORY BELOW GRADE)
	TWO STORIES ABOVE GRADE TWO STORY BELOW GRADE
TABLE 3-B REQUIRED SEPARATION IN	······
OCCUPANCIES TO BE SEPARATED: B : 3-3	FIRE RESISTIVE REQUIREMENT: 1 HR
TABLE 5-A EXTERIOR WALL AND OPE EXTERIOR WALLS BEARING:	I HR LESS THAN 20 FEET NR ELSEWHERE
EXTERIOR WALLS: NON BEARING: OPEN:NGG:	SAME AS BEARING NOT PERMITTED (ESS THAN 5 (***.
	PROTECTED LESS THAN TO PT,
TABLE 5-A EXTERIOR WALL AND OPE	
EXTERIOR WALLS-BEARING: EXTERIOR WALLS-NON BEARING:	L HR LESS THAN 20' NR ELSEWHERE SAME AG BEARING
OPEN(NGS)	NOT PERMITIED LESS THAN 5 PT. PROTECTED LESS THAN NO FT.
TABLE 6-A, TYPE V - N, FIRE RESISTIVE C	
BUILDING ELEMENT	FIRE RESISTIVE REQUIREMENT
BEARING WALLS - EXTERIOR 2. BEARING WALLS - INTERIOR	NR NR
 NON-BEARING WALLS - EXTERIOR STRUCTURAL FRAME 	NR NR
5. PARTITIONS - PERMANENT S. SHAFT ENCLOSURES	NR I HR
7. FLOOR - FLOOR / CEILINGS 8. ROOF - ROOF / CEILINGS	NR NR
 EXTERIOR DOORS AND WINDOWS STAIRWAY CONSTRUCTION 	PER SECTION GOGLE, SEE TABLE 5-A PER SECTION GOGLE, SEE TABLE 5-A
NEW PARKING DECK	
TYPE OF CONSTRUCTION PER C.B.C.:	TYPE V-N FULLY SPRINKLERED
OCCUPANCY PER C.B.C.:	19-31 (ONE STORY BELOW GRADE)
NUMBER OF STORIES:	ONE STORY AT GRADE ONE STORY BELOW GRADE
TABLE 5-A EXTERIOR WALL AND OPEN	NING PROTECTION: B OCCUPAN
EXTERIOR WALLS-BEARING/	T MR LESS THAN 20 FEFT NR ELSEWHERE
XTERIOR WALLS NON BEARING:	SAME AS BEARING
DPENINGS:	NOT PERMITTED LEGS (BAN 5 FT. PROTECTED LESS THAN FO FC.
TABLE 5-A EXTERIOR WALL AND OPEN	NING PROTECTION: S-3 OCCUPA
XTERIOR WALLS-BEARING:	/ HR LESS THAN 20 NR ELSEWHERE
XTERIOR WALLS NON BEARING:	SAME AS BEARING
OPENINGS:	NOT PERMITTED LESS THAN 5 FT. PROTECTED LESS THAN TO HT.
TABLE 6-A, TYPE V - N, FIRE RESISTIVE C	
BUILDING ELEMENT	FIRE RESISTIVE REQUIREMENT
. BEARING WALLS - EXTÉRIOR 2. BEARING WALLS - INTERIOR	NR NR
 NON-BEARING WALLS - EXTERIOR STRUCTURAL FRAME 	NR NR
	-

ALLOWABLE FLOOR AREA CALCULATION PER C.B.C SEC. 503.3, BUILDINGS ON GAME PROPERTY MAY BE COUNTED AS ONE BUILDING PER EXCEPTION. SEC, 504.1. TABLE 5 & BASIC ALLOWABLE AREA: 8,000 S.F. SEC. 505.2, UNLIMITED AREA - WHEN BUILDING IS LIMITED TO 2 STORIES, & OCCUPANCY WITH GO

EXTERIOR DOORS AND WINDOWS

8. ROOF - ROOF / CEUINGS

10. STAIRWAY CONSTRUCTION

ILLY SPRINKLERED

ES ABOVE GRADE ONLY OF MIXED OCCUPANCY WE REQUIREMENT: NONE <u>CTIO</u>N

ULY SPRINKLERED

OF MIXED OCCUPANCY

IVE REQUIREMENT: 1 HR. CTION: B OCCUPANCY

LESS CHANTO PT, CTION: S-3 OCCUPANCY

ELY SPRINKLERED

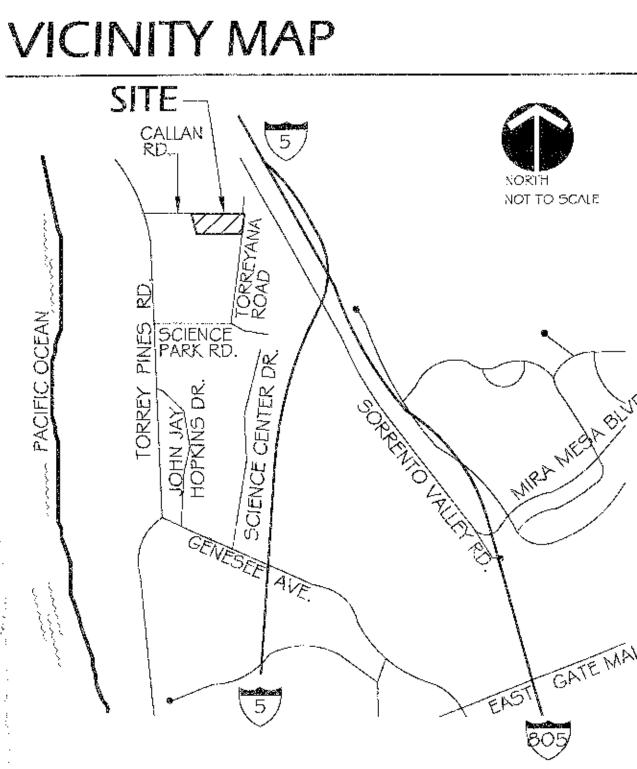
BELOW GRADE CTION: 8 OCCUPANCY

TED LEGS (HAN 5 IFT. LESS THAN FOR POLI-CTION: S-3 OCCUPANCY

HAN 20 ARING

PER SECTION GOG.3, SEE TABLE S-A PER SECTION GOGLA, SEE TABLE 5-A

SIDEYARDS ON ALL SIDES (SEE BUILDING CODE ANALYSIS SHEET AT, T)



PROJECT ASSESSMENT LETTER

THE CITY OF SAN DIEGO

Jone (J. 2003

Mt. Neal McFathors Arciaitects Delawie Wilkes Rodrigues Burks 2265 India 34.

San Diego, CA 92101 Deer Mr., McFerland; Subject: - Amandmoni, of Project Assessment Latter: Torrey Pines Science Park (Lot 32) -

(10996 Torreyana Rd - Coastal/Size Development Fermits (CPIOZ 122 & APZ 2) No. 424136, PTS No. 5844. This fetter is to anexil my fabrice 13, 2003, assessment latter to address issues that serfaced as a stank of the April 3, 2003, letter from Ellen Larley of the State Coastal Commission. The letter

states that state Closest Development Permit 198513 approving analisit and Sature development on Torney Pines Science Park, Lot 12, is valid. According to Table 3 on Page 166 of the University Community Plan, development intensity in "Torrey Pines Science Park is determined by "existing or approved development," In the case of Portey Pines Science Park, Lo. 12, State Coastal Development Permit No. F8513 approved a. total of 142,569 square feet of gress fluor area. The existing building is 87,140 square-feet. The remaining allocation for the "influe building" accommodated by the State CDP No. 18513 lot is 55,429 square-sect.

It the proposed development is consistent with the State Coastal Development Permit No. 16543. and State Coastal Commission letter of April 3, 2003, Development Services can review the project for Sobstanria) Conformance with the state permit. If the proposed development is not consistent with either the state permit or the Coastel Coardission letter, then we would continue the CDP/SDF oncess, with the new subare-fact allocation established by the state Cosstal Development Permit.

> Development Services 1887 Frei Werten, WS 50, im Sublingin, CA 92(19) 415 march 100 august solon

Tourey Pines Science Park

Sec.

June 11, 2003 Also attached is the commont letter from the MCAS Miramar. When resubmitting, please

include an additional deposit of at least \$8,600 to ensure continued processing If you wish to discuss these issues, if you have any questions or, or if you wish to arrange a meeting to discuss the Development Services Department's assessment of your request, please contact me, Juan Baligad, at (619) 446-5276, I am your project manager,

Thatepark. (Jeth) Juan Baligad

Development Project Manager Attachment: Letter from the Coastal Commission

Letter from USMC Miraman -cc: Joe Ecclosine, Engineering Review Tracy Elliot-Yawn, Planning Review Chris Kluth, Metropolitan Transit Development Board Will Kwan, Landscaping Roview Rudy Jauregui, Transportation Development Etten Liney, California Coastal Commission Paul Schlitt, Environmental Analysis Section

George Lattimer, University Community Plancing Group Chairperson Cecilia Williams, Long-Range Planning

DEVELOPMENT SUMMARY

PROJECT DESCRIPTION

LEGAL DESCRIPTION

SITE ADDRESS:

ASSESSOR'S PARCEL N EXISTING CONDITION **EXISTING PERMITS:**

PROPOSED USES:

REQUIRED PERMITS

LAND USE INFORMAT

SITE AREA:

DEVELOPMENT REQU FLOOR AREA RATIOS:

SETBACKS:

FRONT YARD EXTERIOR SIDE YARD IN ERIOR SIDE YARD. REAR YARD

MAXIMUM BUILDING COAS (AL HEIGHT OVERLAY ZO ACTUAL BUILDING HEIGHT OF (SET SCIEET A JUS FOR GRAPH

ALLOWABLE GROSS F SED PAGE 166 OF UNIVERSIT DEVELOPMENT, SEE LEPPER : ALLOWABLE GROSS FLOOR AL

GROSS FLOOR AREA EXISTING BUILDING'S GROSS FIRST LEVEL ECOND LEVEL UBCOTAL

PROPOSED 2 STORY BUILDING FIRST LEVEL SECOND (EVEL) SUBTOTAL:

GROSS FLOOR AREA OF EXIST FIRST (EVE), BASEMENT OF PR SECOND (2VEL BASEMENT OF SUBTOTAL **** TOTAL ABOVE AND BELOW GI

BASEMENT LEVEL ONE OF PRO BASEMENT LEVEL TWO OF PRI GRADE LEVEL OF PROPOSED TOTAL ABOVE AND BELOW G

CROSS FLOOR AREA OF BELC GROSS FLOOR AREA OF ABOY CROSS FLOOR AREA I AS

** MECHANICAL SPACE IS E COMMUNITY PLAN ITTE BASEMENT LEVEL G CALCULATION PER MUNI

**** THESE TOTALS ARP FOR BY THE MUNICIPAL CODE PARKING INFORMATIC

MINIMUM PARKING ST STANDARD STALLS: DISABLED PERSON STALLS:

PARKING RATIOS PER J MINIMUM FARKING RATIO: MAXIMUM PARKING RATIO: CARPOOL MINIMUM : BICYCLE PARKING MINIMUM:

BICYCLE PARKING MINIMUM: MOTORCYCLE PÁRKING MIN.: PARKING TABULATION ON SITE PARKING (INCLUDING BASEMENT LEVEL ONE PARKIN

BASEMENT LEVEL TWO PARKIN UPPER LEVEL OF BASEMENT PA LOWER REVEL OF BASEMENT TOTAL PARKING PARKING RATIO PER 1,000 S.I CARPOOL PARKING PROVIDED:

BICYCLE PARKING W/O LOCKERS PROVIDED: BICYCLE PARKING WITH LOCKERS PROVIDED: MOTORCYCLE PARKING PROVIDED:

<u>'N:</u>	 DEMOLITION OF 5X TOWER, LANDSCAF TO REMAIN. CONSTRUCTION O OVER 1 STORY BE ASSOCIATED SHE SYSTEM, LANDSCA CONSTRUCTION O GRADE, ONE LEVES 	PING, DRAINAGE, E F A NEW 2 STORY LOW GRADE BASE IMPROVEMENTS IN IMPRO, HARDSCAPE F A TWO LEVEL PAR	TC.), EXISTING TWO RESEARCH & DEVE MENT PARKING STR ICLUDING SIME UTH I AND GRADING.	D STORY BUILDING LOPMENT BUILDING SUCTURE: LITIES, DRAINAGE	
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	BUILDING PERMIT, PLA COASTAL DEVELOPME GRADING WORK ORDE	NT PERMIT, 58573	5, 1979	, A≌R. 16, 1980	
	RESEARCH & DEVELOF RESEARCH & DEVELOF				
	SITE DEVELOPIMENT PL COASTAL DEVELOPIME PT5 NO. 5844 JOB NO. 42-1136				
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	GROSS SITE AREA: (A LANDSCAPE AREA: MARDSCAPE AREA: BUILDING COVERAGE: BUILDING COVERAGE:		6.222 ACRES 1.647 ACRES 2.448 ACRES 1.662 ACRES (72.423 SF/27 L)	71,766 S.F. 106,642 S.P. 66,723 S.F.	
JIREM	ENTS:				
	MAXIMUM ALLOWED F ACTUAL FLOOR AREA			1.00 .53	
	<u>NEW BUIL</u>	DING	PARKING S	BTRUCIURE	
		·	REQUIRED	PROPOSED	
	25' 20' 15' 25'	405-10' 78'-5' 69-3" 134'-6'	25' 20' 35 25'	25'-0' 20' 0 60'-) 0" 536'-8"	
HEIG	HT ALLOWED:	0'1'0	20	556.9	
- propo Higal d F <u>LOO</u> !	ROPOSITION D) PER ZO DSED BUILDING PER BUI ETAL: SHOWING CONFO R AREA PER UNIVI MUNITY PLAN: 1 ABLE 3.	LDING KEWBLETTPI RMANCE) E RSITY PLAN:	₹52142-2:	= 30'-0' 30'-0'	
FROM C	CITY OF SAN DIEGO DAT	770 JUNE 11, 2003		42,569 S.F.*	
	1 71-14	DCCDPANO		20110	
	AREA:	38.731 S.F.* 43,164 5.F.*	MECHANICA). 1,521 S.F.** 3,724 S.F.** 5,245 S.F.**	107AL9 40,252 3.F.*** 46.888 5.F.*** 87.140 5.F.****	
G5 GR	055 FLOOR AREA.	OCCUPANO B 30,971 5.F.* 29,703 5.F.* 60,674 5.F.*	MECHANICAL 1,200 S.F.** 1,870 S.F.**	31,573 S.F.***	
5T)NG 4	PROPOSED BUILDINGS:	-		150,884 S.F.***	
PROP	ED BUILDING OSFD BUILDING			36,862 5.F.*** 39,800 5.F.*** 76,662 5.F.	
CPO3E	QUARE FOOTAGE OF PI	ROPOSED BUILDING	5:	24,430 5.F.***	
PARKIN	D PARKING DECK. IG DECK QUARE FOOTAGE:			24,430 5.F.*** 24,430 5.F.*** 73,290 9.F.****	
DVE AND	ADE PARKING, BOTH ST DELOW GRADE, PROP	DSED & EXISTING S	TRUCTURES:	213,696 5.F.*** 364,580 5.F.***	
EXEMPT	RED BY THE MUNICIPAL IN THE CALCULATION (Dri GROGS PLOOR :			
ICIPAL C	FLOOR AREA IS EXEMPT CODE SECTION #13.02 MATION ONLY. THEY A	34,A.2.5			
ON: TALL (
INEL I	REQUIREMENTS: 8'-0' WIDE X 18'-0' LC 9'-0' WIDE X 18'-0' LC 9-0'' WIDE X 18'-0'' LC ACCESS AISLE AT VAN	ING WHERE ADJECE ING WITH S'-O' ACC			
MUNI	2.5 SPACES PER 1,00 4.0 SPACES PER 1,00	LE 142-05F: 00 3.F. 00 3.F.	AT 142.50 AT 142.50	999.F.≃ 570	
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PARKIN	G STRUCTURE UNDER I			<u></u>	
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SHEET INDEX

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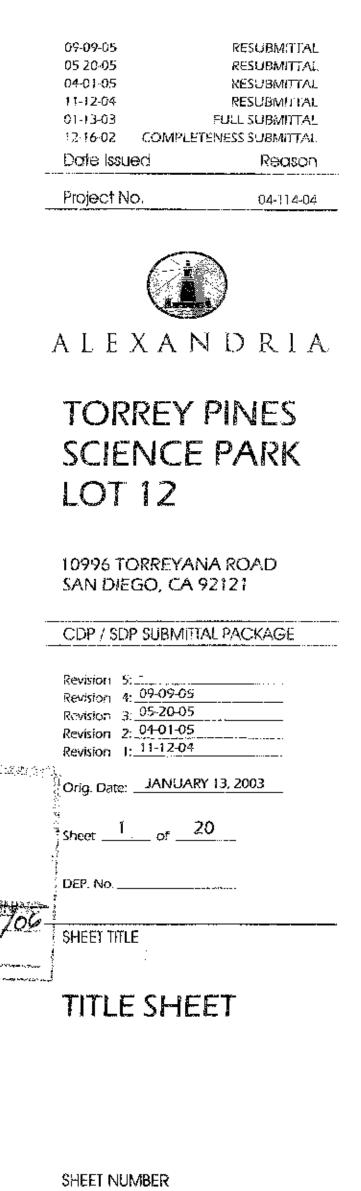
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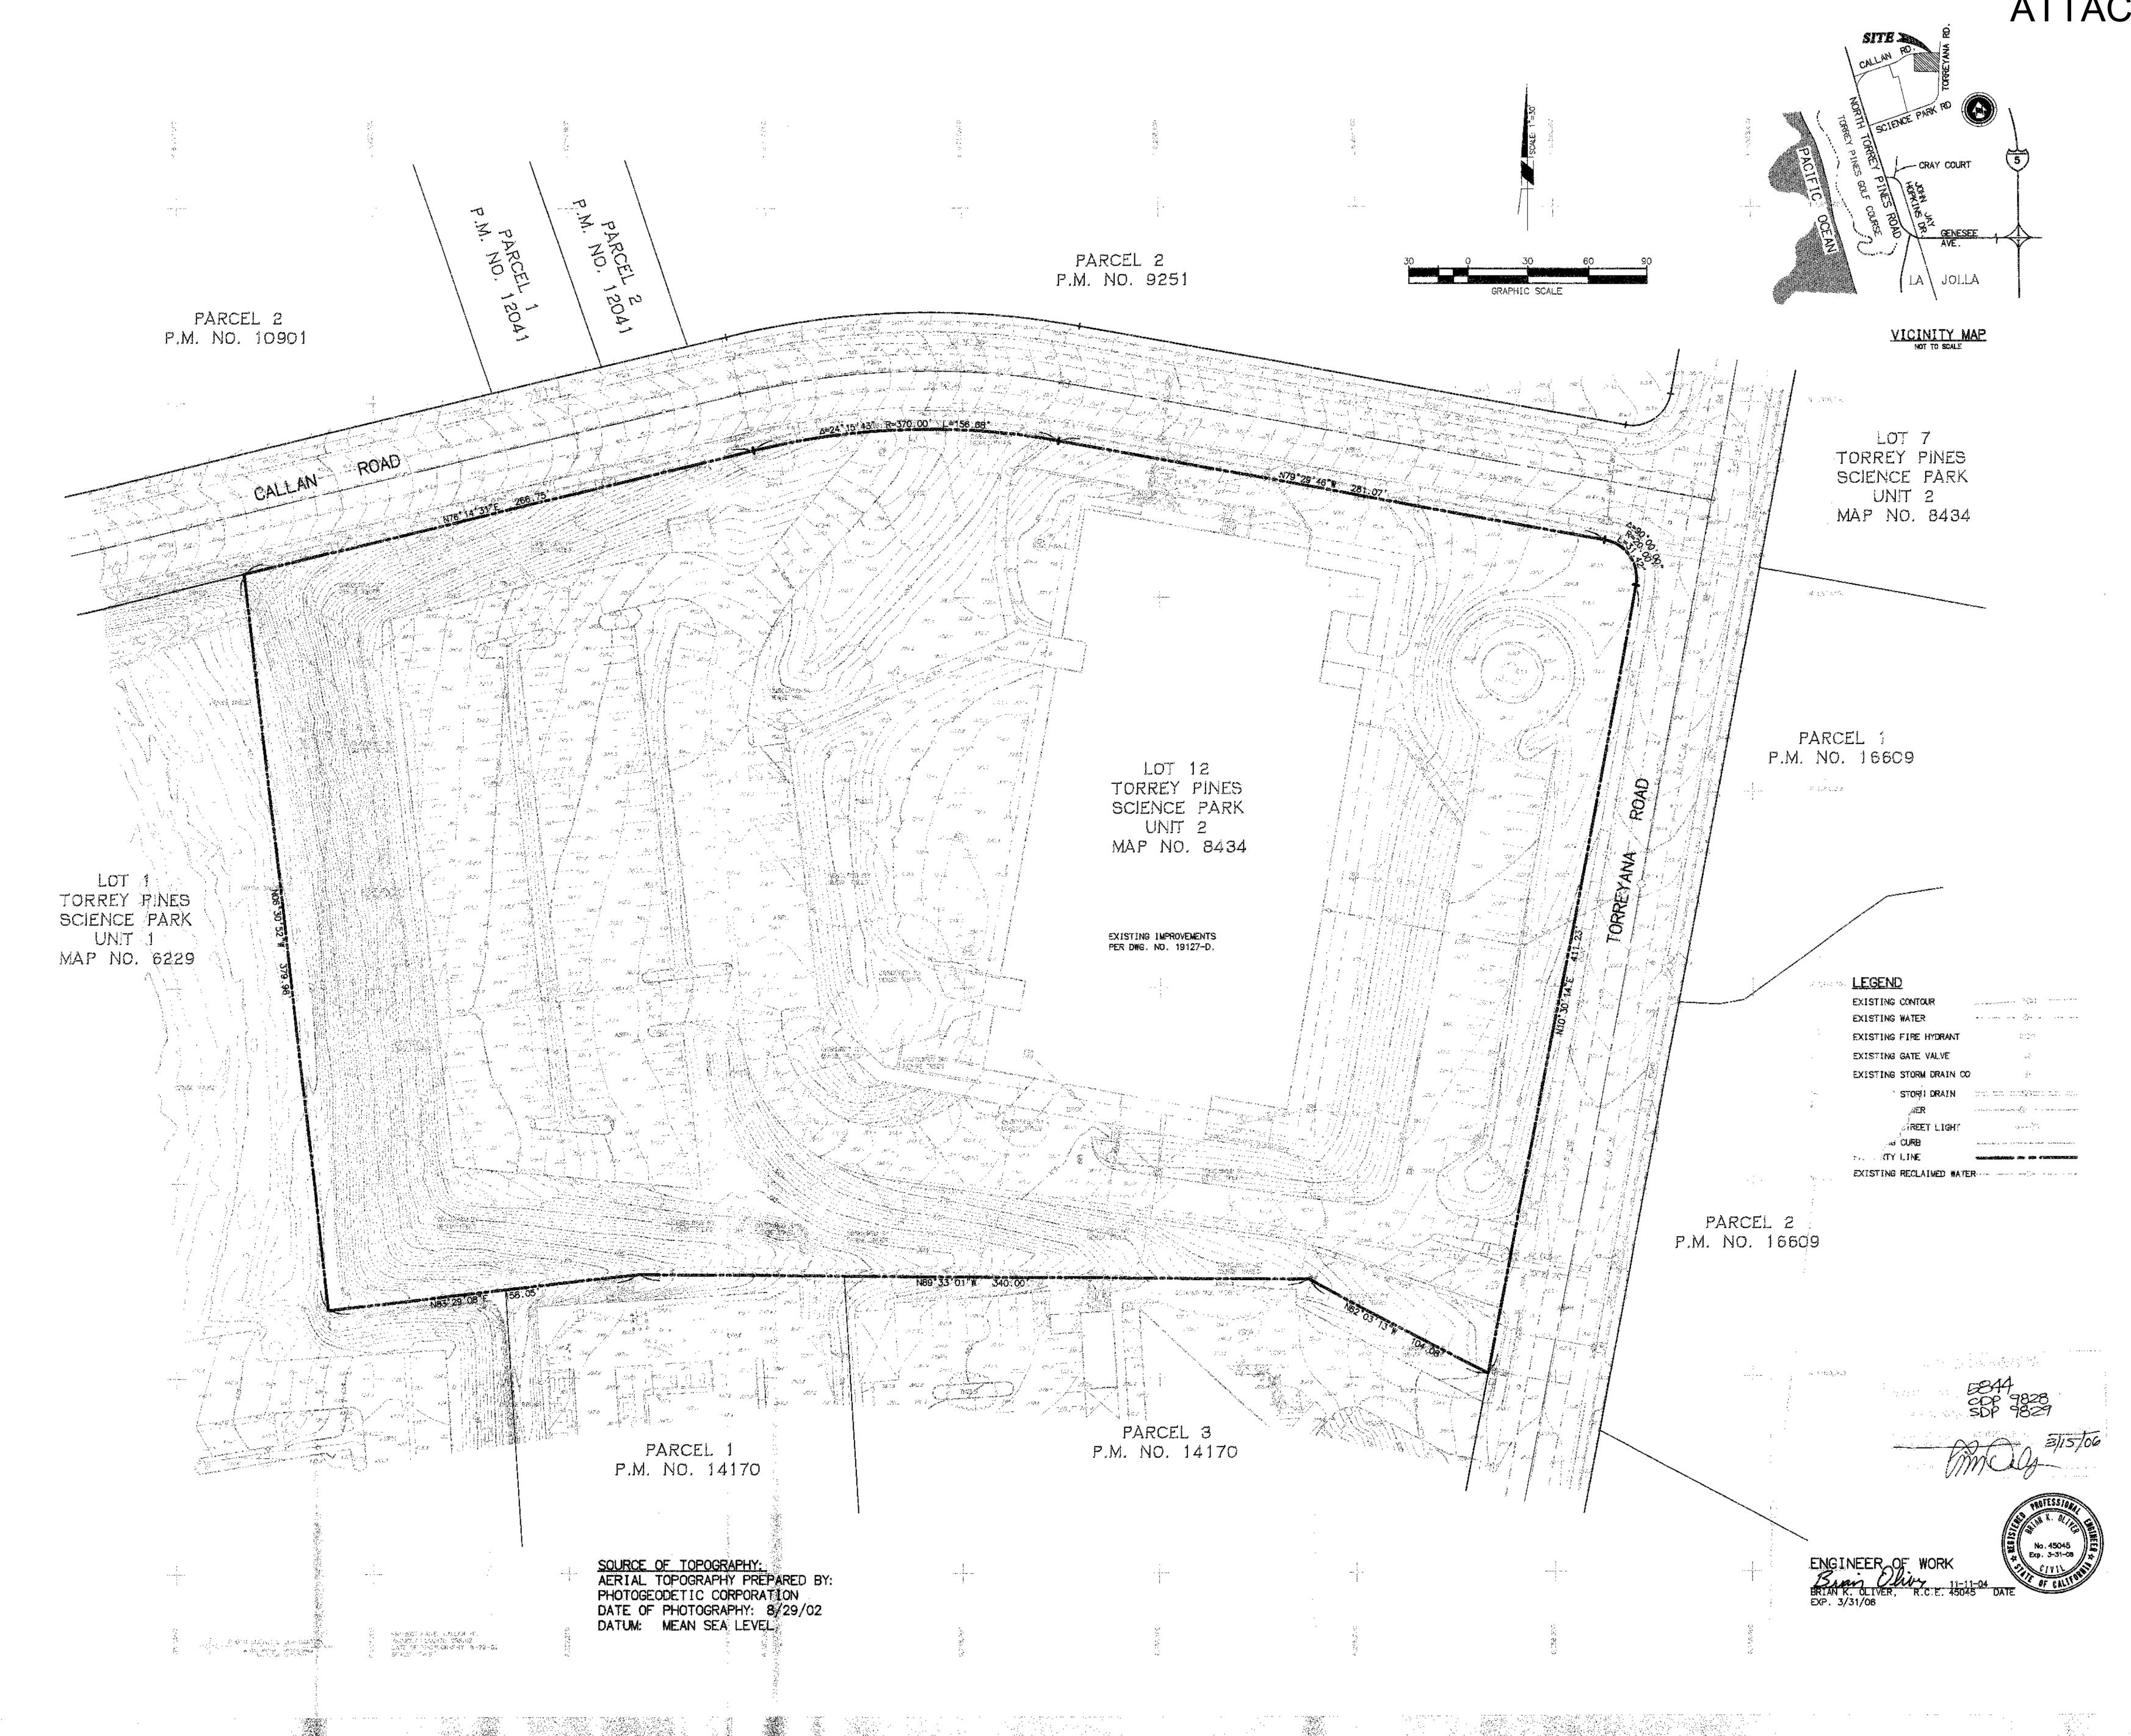
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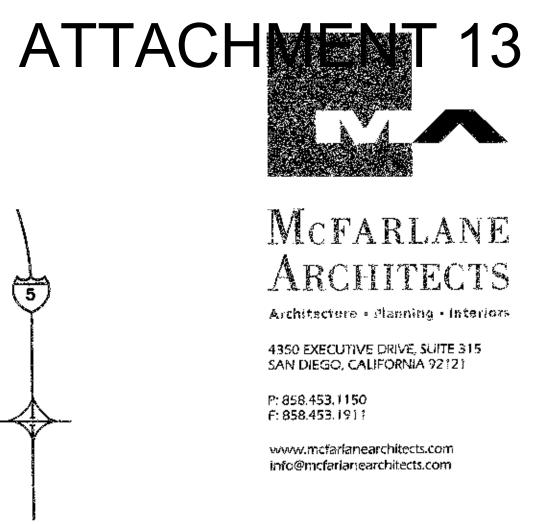






aline Charles







09-09-05 RESUBMITTA 05-20-05 RESUBMITTAL RESUBMITTAL 04-01-05 11-12-04 RESUBMITTAL 01-13-03 FULL SUBMITTAL LETENESS SUBMITTA 12-16-02 Date Issued Reason Project No. 04-114-04

TORREY PINES SCIENCE PARK LOT 12

10996 TORREYANA ROAD SAN DIEGO, CA 92121

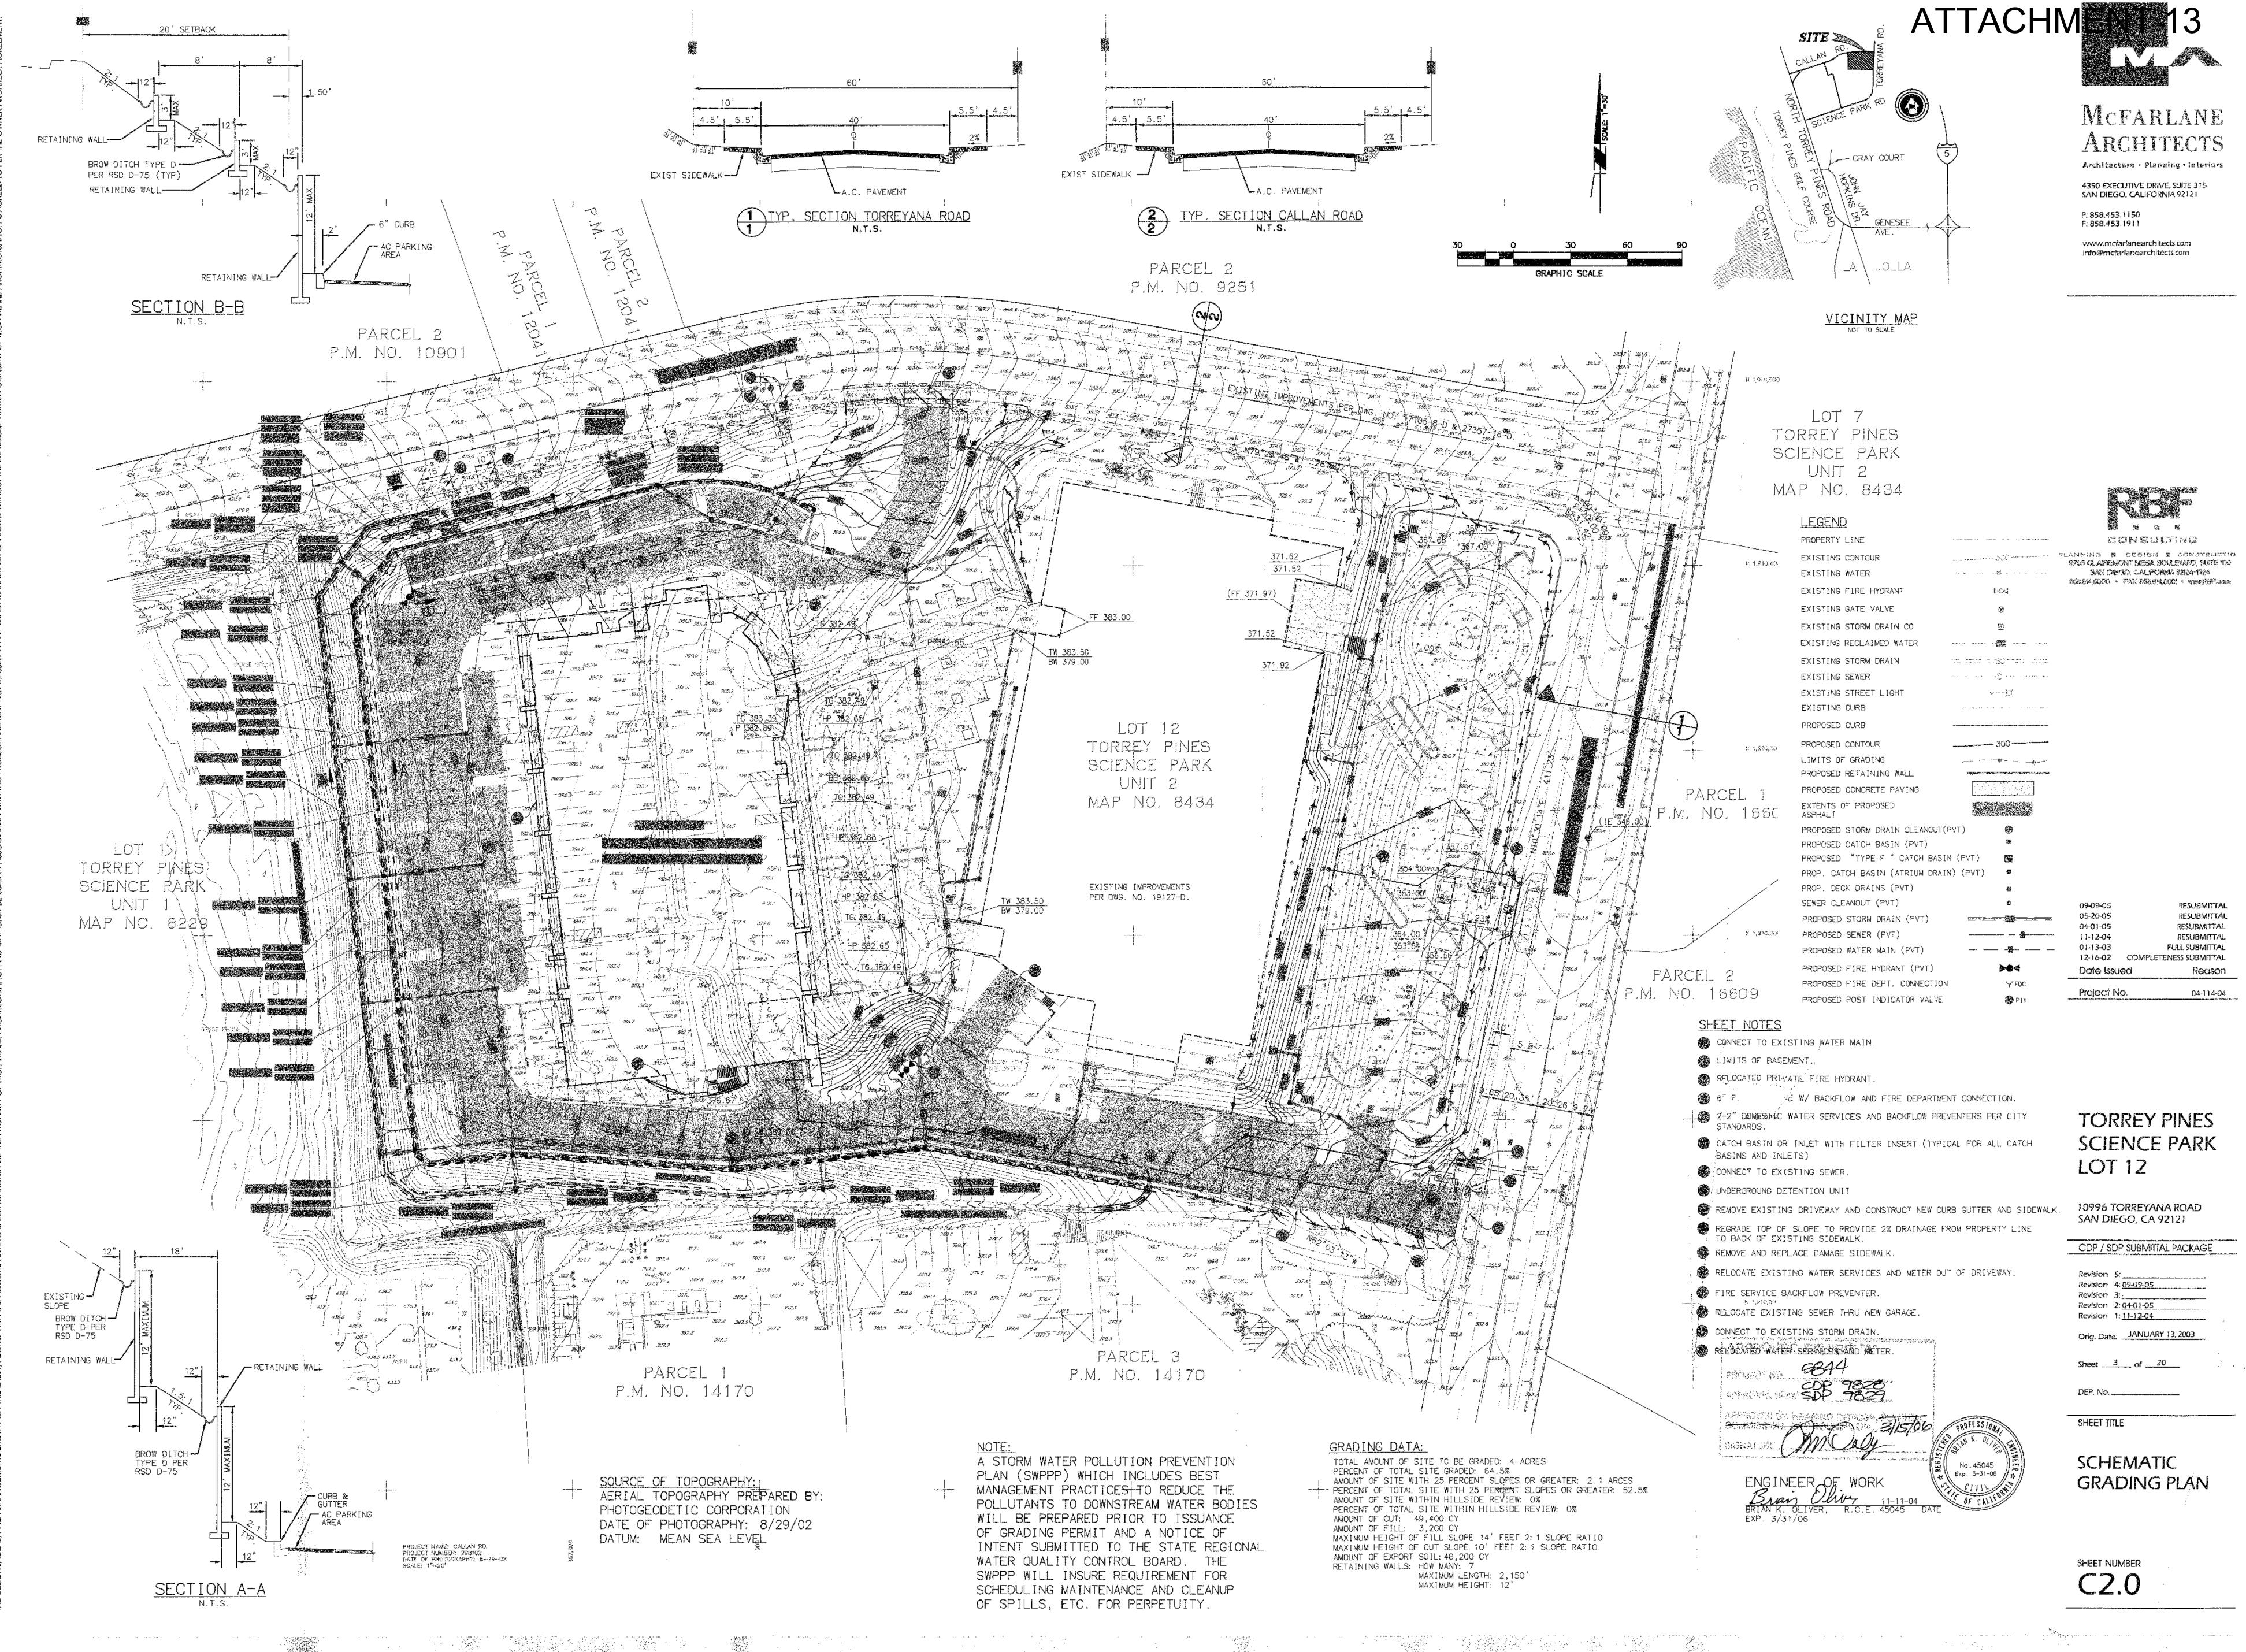
CDP / SDP SUBMITTAL PACKAGE

Revision 5:
Revision 4:
Revision 3:
Revision 2: <u>04-01-05</u>
Revision 1: <u>11-12-04</u>
Orig. Date: JANUARY 13, 2003
Sheet of20
DEP. No.

SHEET TITLE

EXISITING conditions/ TOPOGRAPHIC MAP

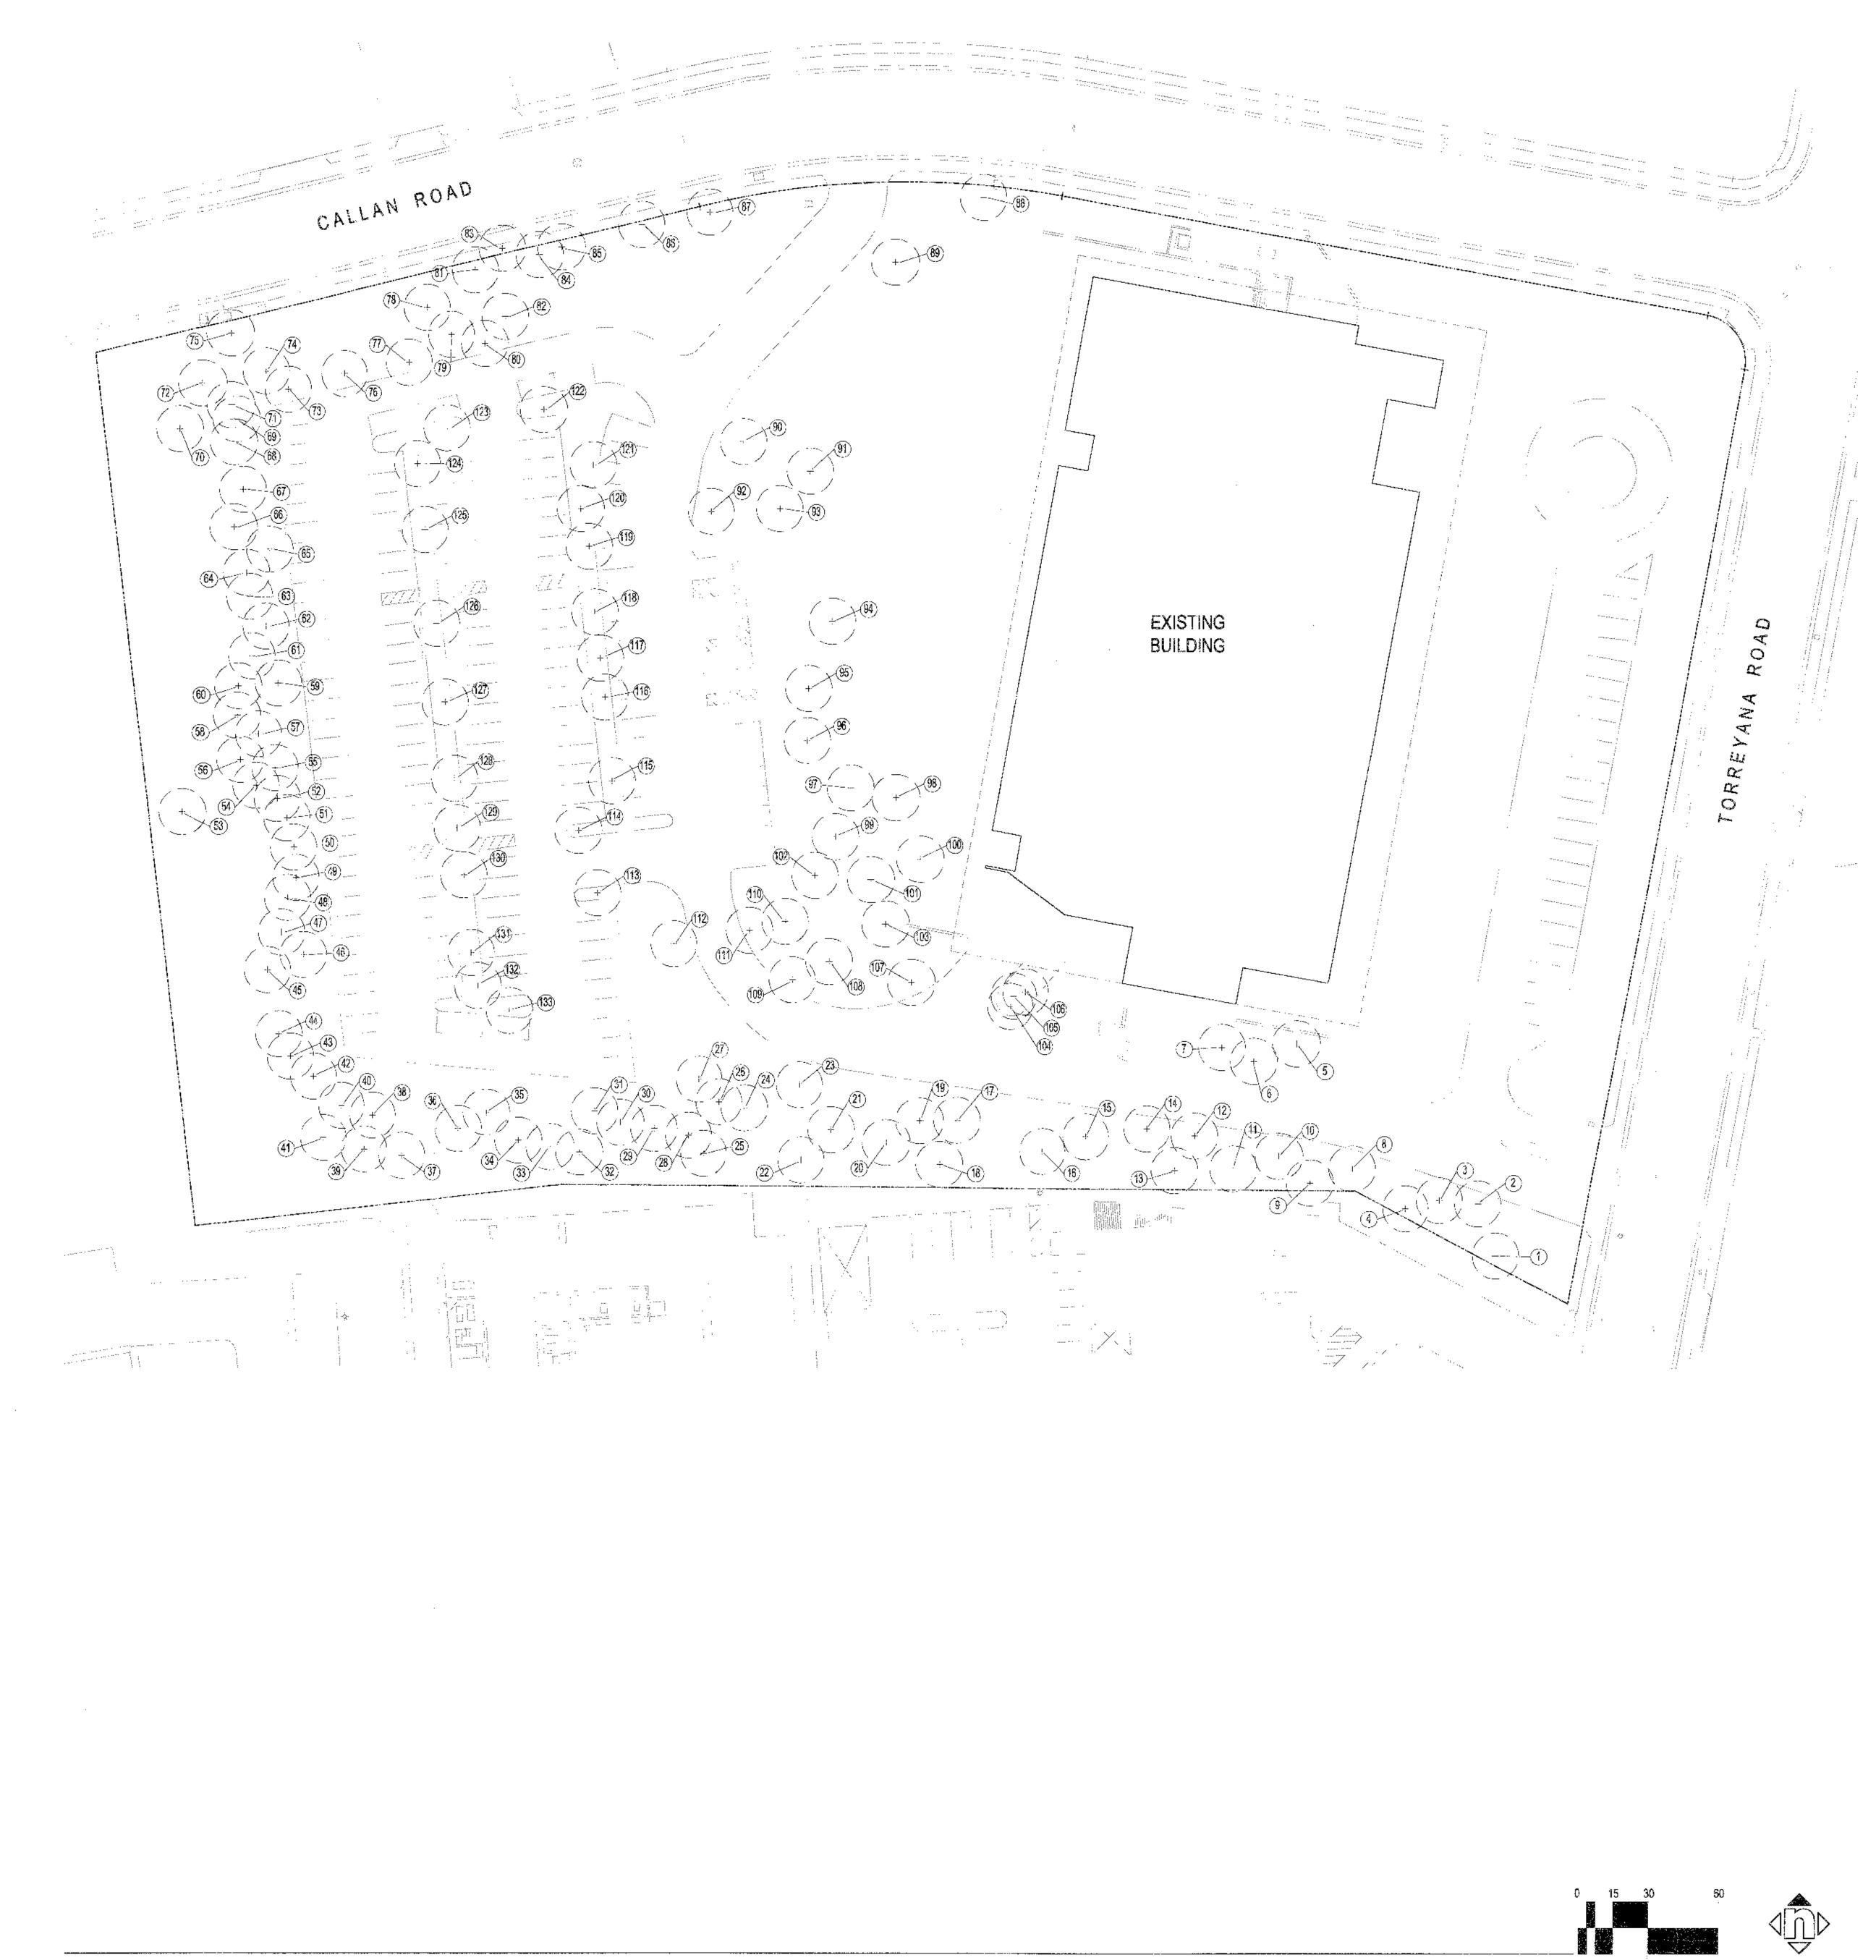
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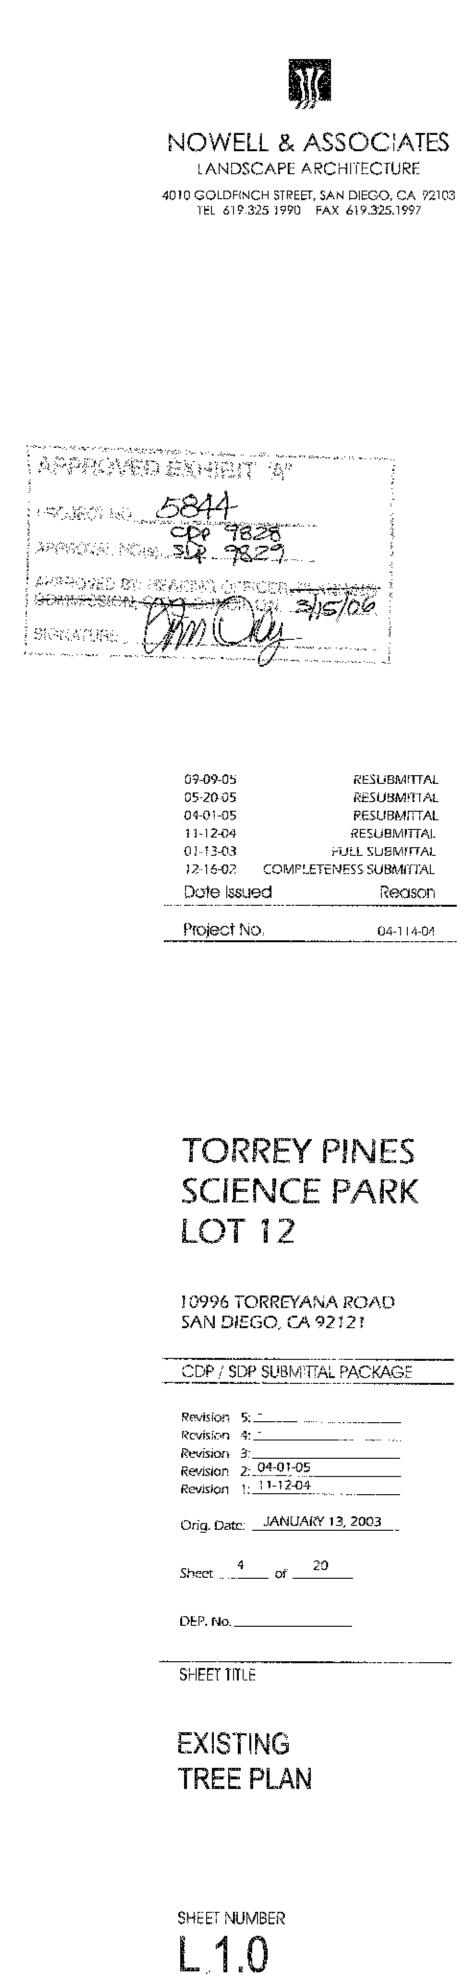
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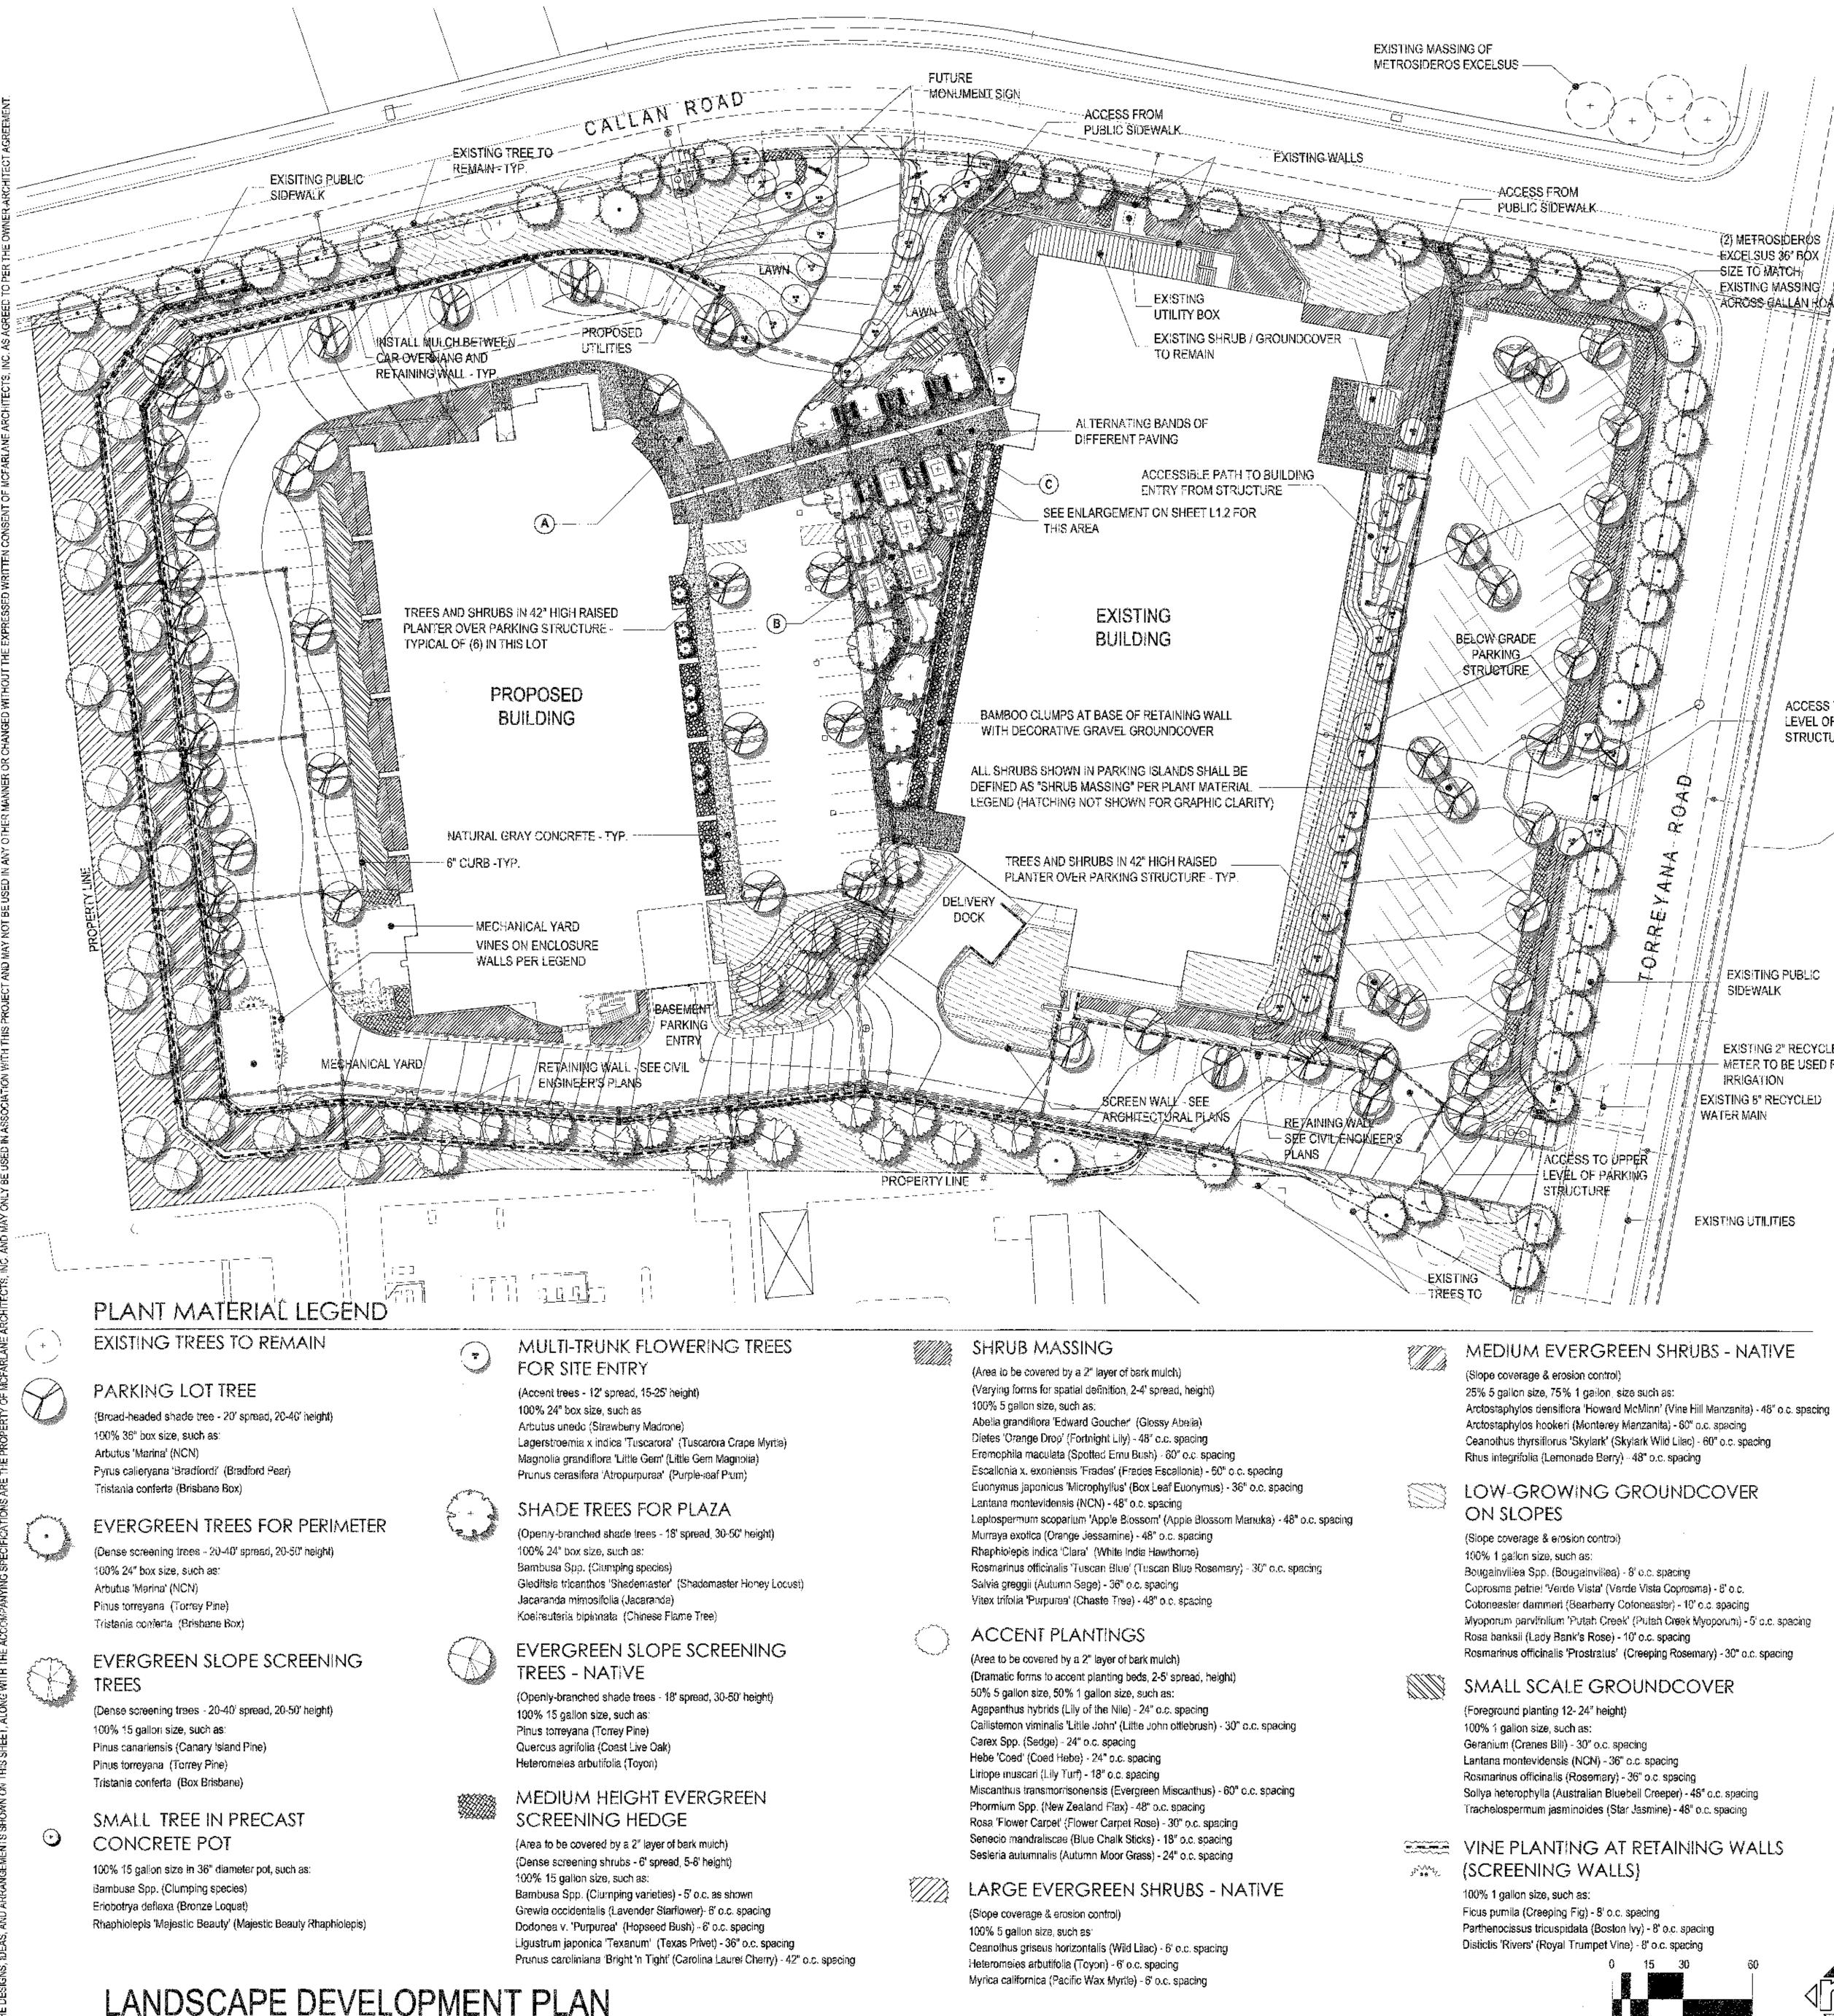
EXISTING TREE INVENTORY

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8 ALUS RUBAN 8' 2' REMOVE 2 PRUS MULEPENSIS 4' 10' REMOVE 2 PRUS MULEPENSIS 5' 16' REMOVE 3 PRUS MULEPENSIS 5' 15' REMOVE 3 PRUS MULEPENSIS 1'' 2'' REMOVE 3 PRUS MULEPENSIS 1'' 2'' REMOVE 3 PRUS MULEPENSIS 1'' 2'' REMOVE 3 PRUS MULEPENSIS 1'' 1'' REMOVE 3 PRUS MULEPENSIS 7'' 1''' REMOVE 4 PRUS MULEPENSIS 7'' 1''' REMOVE 4 PRUS MULEPENSIS 7'' 1'''<'''	24	j · · · · · · · · · · · · · · · · · · ·	12ª	i i	
18 PAUS, INTEGERPEUN 4' 10' RELEVANCE 10 PAUS, MALEPENNS 5' 16' RELEVANCE 11 PAUS, MALEPENNS 5' 15' RELEVANCE 12 PAUS, MALEPENNS 14' 3'' RELEVANCE 13 PAUS, STALEPENNS 14'' 3'' RELEVANCE 14 PAUS, STALEPENNS 12'' 2''' RELEVANCE 15 PAUS, STALEPENNS 1''' 2''' RELEVANCE 16 PAUS, STALEPENNS 7''' 16''' RELEVANCE 17 PAUS, STALEPENNS 7'''' 16'''' RELEVANCE 18 PAUS, MALEPENNS 7''''''''''''''''''''''''''''''''''''	26	ALNUS RUBRA	8"	25'	REMOVE
80 PHUS HALPENSS 9' 16' PROVOG 21 PHUS HALPENSS 12' 27' RENOVE 31 PHUS HALPENSS 12' 27' RENOVE 34 PHUS HALPENSS 12' 27' RENOVE 35 PHUS HALPENSS 12' 27' RENOVE 36 PHUS HALPENSS 12' 27' RENOVE 36 PHUS HALPENSS 12' 27' RENOVE 36 PHUS HALPENSS 7' 10' RENOVE 37 PHUS HALPENSS 7' 12' RENOVE 36 PHUS HALPENSS 7' 12' RENOVE 47 PHUS HALPENSS 7' 10' RENOVE 48 PHUS HALPENSS 7' 10' RENOVE 44 PHUS HALPENSS 7' 10' RENOVE 45 PHUS HALPENSS 7' 10' RENOVE 46 PHUS HALPENSS 7' 10' RENOVE	28	RHUS INTEGRIFOLIA	∢"	12	REMOVE
12 PPUS HAI PEPNSS 14' 30' PRUMOVE 14 PPUS HAI PEPNSS 12' 20' RRMOVE 15 PRUS HALEPENSS 10' 12' 20' RRMOVE 16 PRUS HALEPENSS 10' 10' RRMOVE 17 PAUS HALEPENSS 10' 20' RRMOVE 10 PAUS HALEPENSS 1'' 20' RRMOVE 10 PAUS HALEPENSS 1'' 20'' RRMOVE 10 PAUS HALEPENSS 1'' 22'' RRMOVE 14'' PAUS HALEPENSS 1'' 20''' RRMOVE 14'' PAUS HALEPENSS 1''' 20'''' RRMOVE 14'' PAUS HALEPENSS 1'''' 20'''''' RRMOVE 14''' PAUS HALEPENSS 1''''''''''''''''''''''''''''''''''''	30	PINUS HALEPENSIS	9	18'	RÉMOVE
94 PHUS 940 EPNSS 92 PE PELIDA 95 PHUS 940 EPNSS 97 22 REMOVE 96 PHUS 940 EPNSS 97 22 REMOVE 97 PAUS 940 EPNSS 97 22 REMOVE 98 PAUS 940 EPNSS 97 22 REMOVE 91 PAUS 940 EPNSS 97 15 REMOVE 91 PAUS 940 EPNSS 97 17 REMOVE 91 PAUS 940 EPNSS 97 19 REMOVE 91 PAUS 940 EPNSS 97 19 REMOVE 91 PAUS 940 EPNSS 97 16 REMOVE 91 PAUS 940 EPNSS 97 16 REMOVE 91 PAUS 940 EPNSS 97 16 REMOVE <t< td=""><td>32</td><td>PINUS HALEPENSIS</td><td>14'</td><td>30'</td><td>REMOVE</td></t<>	32	PINUS HALEPENSIS	14'	30'	REMOVE
98 9400 9	34	FINUS HALEPENSIS	12	20'	REMOVE
39 PARS HULEPISSIS 7' 16' PUROUPE 40 PURO HULEPISSIS 8' 20' REMOVE 41 PURO HULEPISSIS 9' 22' REMOVE 42 PURO HULEPISSIS 9' 22' REMOVE 44 PURO HULEPISSIS 7' 15' REMOVE 45 PURO HULEPISSIS 7' 15' REMOVE 46 PURO HULEPISSIS 7' 16' REMOVE 47 PURO HULEPISSIS 7' 16'' REMOVE 48 PURO HULEPISSIS 7' 16'' REMOVE 49 PURO HULEPISSIS 7' 16'' REMOVE 40 PURO HULEPISSIS 7' 16'' REMOVE 41 PURO HULEPISSIS 7' 16'' REMOVE 42 PURO HULEPISSIS 7' 16'' REMOVE 44 PURO HULEPISSIS 7'' 16'' REMOVE 5 PURO HULEPISSIS 7'' 16'' R	36	PINUS HALEPENSIS	10"	22	REMOVE
40 PNUS HALEPENSIS 57 27 REMOVE 42 PNUS HALEPENSIS 67 267 PERMOVE 43 PNUS HALEPENSIS 75 157 PERMOVE 44 PNUS HALEPENSIS 75 157 PERMOVE 45 PNUS HALEPENSIS 75 227 REMOVE 46 PNUS HALEPENSIS 75 227 REMOVE 47 PAUS HALEPENSIS 76 45 REMOVE 48 PAUS HALEPENSIS 77 167 REMOVE 49 PAUS HALEPENSIS 77 167 REMOVE 50 PAUS HALEPENSIS 71 167 REMOVE 51 PAUS HALEPENSIS 71 167 REMOVE 52 ANUS NALEPENSIS 71 167 REMOVE 53 ANUS NALEPENSIS 71 167 REMOVE 54 PAUS HALEPENSIS 71 167 REMOVE 55 PNUS HALEPENSIS 71 167 REMOVE <td>38</td> <td>PINUS HALEPENSIS</td> <td>7"</td> <td>16'</td> <td>REMOVE</td>	38	PINUS HALEPENSIS	7"	16'	REMOVE
22 PMINS NALEPDASS 0" 2" PL PL 24 PAUS HALEPDASS 7" 15" PROVIS 25 PAUS HALEPDASS 7" 15" PROVIS 26 PAUS HALEPDASS 7" 15" PROVIS 27 PRUS HALEPDASS 7" 22 PROVIS 28 PAUS HALEPDASS 7" 22 PRUS HALEPDASS 29 PAUS HALEPDASS 7" 18 REMOVE 29 PAUS HALEPDASS 7" 18" REMOVE	40	PINUS HALEPENSIS	8	20'	REMOVE
44 PNUS HALEPPANS 7 19 9 PNUS HALEPPANS 45 PNUS HALEPPANS 6' 12' REMOVE 45 PNUS HALEPPANS 5' 22' REMOVE 45 PNUS HALEPPANS 5' 22' REMOVE 45 PNUS HALEPPANS 1'' 22' REMOVE 50 PNUS HALEPPANS 1'' 22' REMOVE 51 PNUS HALEPPANS 7'' 16'' REMOVE 52 PNUS HALEPPANS 7'' 16'' REMOVE 53 PNUS HALEPANS 7'' 16'' REMOVE 54 PNUS HALEPANS 7'' 16'' REMOVE 55 PNUS HALEPANS 7'' 16'' REMOVE 56 PNUS HALEPANS 7'' 16'' REMOVE 57 PNUS HALEPANS 7'' 16'' REMOVE 58 PNUS HALEPANS 7'' 16'' REMOVE 59 PNUS HALEPANS 7''' 16''' <td>42</td> <td>PINUS HALEPENSIS</td> <td>8"</td> <td>26'</td> <td>REMOVE</td>	42	PINUS HALEPENSIS	8"	26'	REMOVE
14 PNILE PALEPENSIS 5" 22 PREADURE 10 PALE PALEPENSIS 10" 22 PREADURE 11 PALE PALEPENSIS 10" 22 PREADURE 12 PALE PALEPENSIS 10" 22 PREADURE 13 ALARE RESIS 10" 22 PREADURE 14 PREADURE 11" RESOURCE PREADURE 15 PRUS MALEPENSIS 11" RESOURCE 16 PRUS MALEPENSIS 11" RESOURCE 17 PRUS MALEPENSIS 11" RESOURCE 16 PRUS MALEPENSIS 11" RESOURCE 17 PRUS MALEPENSIS 11" RESOURCE 18 PRUS MALEPENSIS 11" RESOURCE 19 PRUS MALEPENSIS 11" RESOURCE 10 PRUS MALEPENSIS 11" RESOURCE 11 PRUS MALEPENSIS 11" RESOURCE 12 PRUS MALEPENSIS 11" RESOURCE 13 </td <td>44</td> <td>PINUS HALEPENSIS</td> <td>7"</td> <td>15'</td> <td>REMOVE</td>	44	PINUS HALEPENSIS	7"	15'	REMOVE
43 9 PAUS PALEPRASIS 5" 22 PERVAYE 50 PAUS PALEPRASIS 10" 22 PERVAYE 50 PAUS PALEPRASIS 10" 22 PERVAYE 51 PAUS PALEPRASIS 7" 16" REMOVE 52 PAUS PALEPRASIS 7" 16" REMOVE 53 ALNAS RUGRA 7" 14" REMOVE 54 PAUS PALEPRASIS 7" 18" REMOVE 55 PRUS PALEPRASIS 7" 18" REMOVE 56 PRUS PALEPRASIS 7" 18" REMOVE 57 PRUS PALEPRASIS 7" 18" REMOVE 58 PRUS PALEPRASIS 7" 19" REMOVE 59 PRUS PALEPRASIS 9" 19" REMOVE 50 PRUS PALEPRASIS 9" 19" REMOVE 50 PRUS PALEPRASIS 9" 19" REMOVE 50 PRUS PALEPRASIS 9" 19" REMOVE	46	PINUS HALEPENSIS	8 ‴	22	REMOVE
50 PINUS ANLEPENSIS 00° 22 PELOY 51 PALUS IVALEPENSIS 9° 14° PELOYE 52 PAULS IVALEPENSIS 9° 14° PELOYE 53 ALMUS RUBRA 9° 14° PELOYE 54 PINUS IVALEPENSIS 9° 14° PELOYE 55 PINUS IVALEPENSIS 9° 16° REMOVE 56 PINUS IVALEPENSIS 9° 16° REMOVE 57 PAUS IVALEPENSIS 9° 16° REMOVE 58 PINUS IVALEPENSIS 9° 16° REMOVE 59 PINUS IVALEPENSIS 9° 16° REMOVE 50 PINUS IVALEPENSIS 9° 16° REMOVE 50 PINUS IVALEPENSIS 9° 16° REMOVE 50 PINUS IVALEPENSIS 9° 16° REMOVE 51 PINUS IVALEPENSIS 7° 16° REMOVE 52 PINUS IVALEPENSIS 7° 16°	48	PINUS HALEPENSIS	87	22'	REMOVE
12 PAULS FALEPENSIS 9' 14' PELOVE 33 ALMS RUPA 9' 14' PELOVE 55 PAULS HALEPENSIS 8' 14' PELOVE 55 PAULS HALEPENSIS 9' 14' REMOVE 57 PAULS HALEPENSIS 9' 16' REMOVE 58 PAULS HALEPENSIS 9' 16' REMOVE 59 PAULS HALEPENSIS 6' 16' REMOVE 50 PAULS HALEPENSIS 6' 16' REMOVE 50 PAULS HALEPENSIS 9' 16' REMOVE 51 PAULS HALEPENSIS 9' 16' REMOVE 52 PAULS HALEPENSIS 9' 16' REMOVE 54 PAULS HALEPENSIS 9' 16' REMOVE 56 PAULS HALEPENSIS 7' 16' REMOVE 57 PAULS HALEPENSIS 7' 16' REMOVE 58 PAULS HALEPENSIS 7' 16' REM	50	PINUS HALEPENSIS	10"	22'	REMOVE
14 PINUS NALEPENSIS 0 16' PELOVICE 55 PINUS MALEPENSIS 3'' 16'' REMOVE 77 PIRUS MALEPENSIS 3'' 16'' REMOVE 78 PIRUS MALEPENSIS 3'' 16'' REMOVE 79 PIRUS MALEPENSIS 6'' 16'' REMOVE 70 PIRUS MALEPENSIS 6'' 16'' REMOVE 71 PARS MALEPENSIS 8'' 16'' REMOVE 72 PIRUS MALEPENSIS 9'' 16'' REMOVE 74 PIRUS MALEPENSIS 9'' 16'' REMOVE 75 PIRUS MALEPENSIS 7'' 15'' REMOVE 76 PIRUS MALEPENSIS 7'' 16'' REMOVE 70 PIRUS MALEPENSIS 7'' 16'' REMOVE 71 PIRUS MALEPENSIS 7'' 16'' REMOVE 71 PIRUS MALEPENSIS 7'' 16'' REMOVE 71 PIRUS MALEPENSIS 7''	52	PINUS HALEPENSIS	8"	18	REMOVE
65 PAULS FALLEPENSIS 3" 16" REMOVE 57 PRUS HALEPENSIS 3" 16" REMOVE 59 PRUS HALEPENSIS 3" 16" REMOVE 50 PRUS HALEPENSIS 6" 16" REMOVE 50 PRUS HALEPENSIS 6" 16" REMOVE 51 PRUS HALEPENSIS 9" 16" REMOVE 52 PNIS HALEPENSIS 9" 16" REMOVE 54 PNIS HALEPENSIS 9" 16" REMOVE 56 PNIS HALEPENSIS 9" 16" REMOVE 57 PNIS HALEPENSIS 7" 12" REMOVE 58 PNIS HALEPENSIS 16" 12" REMOVE 59 PNIS HALEPENSIS 6" 12" REMOVE 50 PNIS HALEPENSIS 6" 12" REMOVE 50 PNIS HALEPENSIS 6" 12" REMOVE 51 PNIS HALEPENSIS 6" 12" REMOVE </td <td>54</td> <td>PINUS HALEPENSIS</td> <td>8.</td> <td>18</td> <td>REMOVE</td>	54	PINUS HALEPENSIS	8.	18	REMOVE
58 PNUS HALEPENSS 7' 22' PELVOVE 59 PNUS HALEPENSS 6' 16' REVOVE 50 PNUS HALEPENSS 6' 16' REVOVE 51 PNUS HALEPENSS 6' 16' REVOVE 52 PNUS HALEPENSS 6' 16' REVOVE 54 PNUS HALEPENSS 9' 16' REVOVE 55 PNUS HALEPENSS 9' 16' REVOVE 56 PNUS HALEPENSS 9' 16' REVOVE 57 PNUS HALEPENSS 7' 15' REVOVE 50 PNUS HALEPENSS 7' 16' REVOVE 51 PNUS HALEPENSS 7' 16' REVOVE 52 PNUS HALEPENSS 7' 16' REVOVE	50	PINUS HALEPENSIS	3"	16'	REMOVE
90 PNUS HALEPONSIS 9" 16" PREVOYE 61 PNUS HALEPONSIS 9" 14" REMOVE 62 PNUS HALEPONSIS 9" 14" REMOVE 63 PNUS HALEPONSIS 9" 14" REMOVE 64 PNUS HALEPONSIS 9" 14" REMOVE 65 PNUS HALEPONSIS 7" 15" REMOVE 66 PNUS HALEPONSIS 7" 15" REMOVE 67 PNUS HALEPONSIS 7" 15" REMOVE 68 PNUS HALEPONSIS 7" 16" REMOVE 70 PNUS HALEPONSIS 6" 22" REMOVE 70 PNUS HALEPONSIS 6" 12" REMOVE 70 PNUS HALEPONSIS 7" 16" REMOVE <td>58</td> <td>PINUS HALEPENSIS</td> <td>7"</td> <td>22'</td> <td>REMOVE</td>	58	PINUS HALEPENSIS	7"	22'	REMOVE
83 PNUS HALEPENSIS 9' 19' REMOVE 84 PNUS HALEPENSIS 9' 18' REMOVE 85 PNUS HALEPENSIS 9' 16' REMOVE 86 PNUS HALEPENSIS 9' 16' REMOVE 87 PNUS HALEPENSIS 7' 15' REMOVE 88 PNUS HALEPENSIS 7' 16' REMOVE 70 PAUS HALEPENSIS 3' 18' REMOVE 71 PAUS HALEPENSIS 7' 16' REMOVE 72 PNUS HALEPENSIS 7' 16' REMOVE 73 PNUS HALEPENSIS 7' 16' REMOVE 74 PNUS HALEPENSIS 7' 16' REMOVE 75 PNUS HALEPENSIS 7' 16' REMOVE 76 PNUS HALEPENSIS 7' 16' REMOVE 77 PNUS HALEPENSIS 7' 16' REMOVE 78 PNUS HALEPENSIS 7' 16' REMOVE 79 PNUS HALEPENSIS 7' 16' REMOVE	50	PINUS HALEPENSIS	6"	18'	REMOVE
64 PNUS HALEPENSIS 10" 22 REMOVE 65 PNUS HALEPENSIS 9" 18" REMOVE 67 PNUS HALEPENSIS 9" 18" PRMOVE 67 PNUS HALEPENSIS 9" 18" REMOVE 68 PNUS HALEPENSIS 7" 18" REMOVE 70 PNUS HALEPENSIS 7" 18" REMOVE 71 PAUS HALEPENSIS 6" 22" REMOVE 70 PAUS HALEPENSIS 6" 22" REMOVE 71 PAUS HALEPENSIS 6" 22" REMOVE 70 PAUS HALEPENSIS 6" 12" REMOVE	62	PINUS HALEPENSIS	6"	15'	REMOVE
66 FINUS HALEPENSIS 9' 17 20' REMOVE 67 FINUS HALEPENSIS 7' 18' REMOVE 68 FINUS HALEPENSIS 7' 18' REMOVE 69 FINUS HALEPENSIS 7' 18' REMOVE 70 PINUS HALEPENSIS 7' 18' REMOVE 71 PINUS HALEPENSIS 7' 18' REMOVE 72 PINUS HALEPENSIS 7' 16' REMOVE 73 PINUS HALEPENSIS 7' 16' REMOVE 74 PINUS HALEPENSIS 7' 16' REMOVE 75 PINUS HALEPENSIS 7' 16' REMOVE 76 PINUS HALEPENSIS 7' 16' REMOVE 77 PINUS HALEPENSIS 7' 16' REMOVE 78 PINUS HALEPENSIS 7' 16' REMOVE 79 PINUS HALEPENSIS 7' 16' REMOVE 70 PINUS HALEPENSIS 7' <		· · · · · · · · · · · · · · · · · · ·	1	5	
88 PINUS HALEPENSIS 7* 15 REMOVE 99 PINUS HALEPENSIS 7* 18 REMOVE 71 PINUS HALEPENSIS 3* 18* REMOVE 71 PINUS HALEPENSIS 5* 18* REMOVE 72 PINUS HALEPENSIS 6* 12* REMOVE 73 PINUS HALEPENSIS 6* 12* REMOVE 74 PINUS HALEPENSIS 6* 12* REMOVE 75 PINUS HALEPENSIS 6* 12* REMOVE 76 PINUS HALEPENSIS 6* 12* REMOVE 79 PINUS HALEPENSIS 6* 12* REMOVE 79 PINUS HALEPENSIS 6* 12* REMOVE 80 PINUS HALEPENSIS 6* 12* REMOVE 81 PINUS HALEPENSIS 6* 12* REMOVE 84 ALINUS RUBRA 18* 40* REMOVE 85 PINUS HALEPENSIS 7* REDVE <td< td=""><td></td><td></td><td>-</td><td>1</td><td></td></td<>			-	1	
70 PAUS HALEPENSIS 8' 19' REMOVE 71 PAUS HALEPENSIS 10' 19' REMOVE 72 PAUS HALEPENSIS 7' 20' REMOVE 73 PINUS HALEPENSIS 7' 20' REMOVE 74 PINUS HALEPENSIS 7' 10' REMOVE 75 PINUS HALEPENSIS 7' 16' REMOVE 76 PINUS HALEPENSIS 6' 12' REMOVE 79 PINUS HALEPENSIS 6' 12' REMOVE 70 PINUS HALEPENSIS 6' 12' REMOVE 71 PINUS HALEPENSIS 6' 12' REMOVE 70 PINUS HALEPENSIS 7' 16' REMOVE 71 PINUS HALEPENSIS 7' 12' KEEP 70 SCHINUS MOLE 7'' KEEP REMOVE 71 SCHINUS MOLE 7''' KEEP REMOVE 72 ALUS RUBRA 10''' REMOVE REM	1		1		
72 PINUS HALEPENSIS 6' 22 REMOVE 73 PINUS HALEPENSIS 7' 20' REMOVE 74 PINUS HALEPENSIS 7' 16' 28' REMOVE 75 PINUS HALEPENSIS 7' 16' REMOVE 76 PINUS HALEPENSIS 6' 12' REMOVE 78 PINUS HALEPENSIS 6' 12' REMOVE 79 PINUS HALEPENSIS 6' 12' REMOVE 79 PINUS HALEPENSIS 6' 12' REMOVE 80 PINUS HALEPENSIS 6' 12' REMOVE 81 PINUS HALEPENSIS 7' 16' REMOVE 82 PINUS HALEPENSIS 6' 2'' KEEP 84 ALUS NUBRA 10' REMOVE REMOVE 84 ALUS RUBRA 10' REMOVE REMOVE 84 ALUS RUBRA 10' REMOVE REMOVE 84 ALUS RUBRA 12' S''	1		2	1	(I
74 PINUS HALEPENSIS 6° 10° REMOVE 75 PINUS HALEPENSIS 16° 20° REMOVE 77 PINUS HALEPENSIS 7° 16° REMOVE 78 PINUS HALEPENSIS 17° 16° REMOVE 79 PINUS HALEPENSIS 6° 12° REMOVE 80 PINUS HALEPENSIS 6° 12° REMOVE 81 PINUS HALEPENSIS 6° 12° REMOVE 82 PINUS HALEPENSIS 7° 16° REMOVE 83 PINUS HALEPENSIS 7° 16° REMOVE 84 PINUS HALEPENSIS 7° KEEP REMOVE 85 PINUS HALEPENSIS 7° KEEP REMOVE 86 ALNUS RUBRA 18° 40° REMOVE 87 ALNUS RUBRA 12° S° REMOVE 84 ALNUS RUBRA 12° S° REMOVE 84 ALNUS RUBRA 12° S° REMOVE	1	ζ · · · · · · · · · · · · · · · · · · ·		1	<u>r</u>
76 PINUS HALEPENSIS 7° 16° REMOVE 77 PINUS HALEPENSIS 6° 12° REMOVE 78 PINUS HALEPENSIS 6° 12° REMOVE 79 PINUS HALEPENSIS 6° 12° REMOVE 80 PINUS HALEPENSIS 6° 12° REMOVE 81 PINUS HALEPENSIS 6° 12° REEP 82 PINUS HALEPENSIS 6° 12° KEEP 83 PINUS HALEPENSIS 6° 12° KEEP 84 PINUS HALEPENSIS 6° 10° REMOVE 85 ALNUS RUBRA 16° 40° REMOVE 86 ALNUS RUBRA 16° 40° REMOVE 80 ALNUS RUBRA 12° 30° REMOVE 84 ALNUS RUBRA 12° 30° REMOVE 84 ALNUS RUBRA 12° 30° REMOVE 84 ALNUS RUBRA 12° 32° REMOVE 84 ALNUS RUBRA 12° 32° REMOVE 8	1			t	!
77 PINUS HALEPENSIS 5° 12' REMOVE 78 PINUS HALEPENSIS 6° 12' REMOVE 80 PINUS HALEPENSIS 6° 12' REMOVE 81 PINUS HALEPENSIS 6° 12' REMOVE 81 PINUS HALEPENSIS 6° 12' REMOVE 82 PINUS HALEPENSIS 6° 12' KEEP 84 PINUS HALEPENSIS 6° 12' KEEP 84 PINUS HALEPENSIS 6° 12' KEEP 86 ALNUS RUBRA 16' 10' REMOVE 87 SCHINUS MOLLE 5'' REMOVE REMOVE 84 ALNUS RUBRA 16'' 30'' REMOVE 84 ALNUS RUBRA 12'' 20'' REMOVE 84 ALNUS RUBRA 12'' 30'' REMOVE 84 ALNUS RUBRA 12'' 30'' REMOVE 84 ALNUS RUBRA 12''' REMOVE REMOVE		· · · · · · · · · · · · · · · · · · ·		i	
80 PINLS HALEPENSIS 9" 12 REMOVE 81 PAUS HALEPENSIS 9" 12 KEEP 82 PINLS HALEPENSIS 9" 12 KEEP 83 PINLS HALEPENSIS 9" 12 KEEP 84 PINLS HALEPENSIS 9" 12 KEEP 85 PINLS HALEPENSIS 9" KEEP REMOVE 86 PINLS RUBRA 10" REMOVE REMOVE 81 ALNUS RUBRA 14" 30" REMOVE 91 ALNUS RUBRA 14" 30" REMOVE 94 ALNUS RUBRA 12" 30" REMOVE 94 ALNUS RUBRA 14" 36" REMOVE <td< td=""><td>5</td><td></td><td>1 ·</td><td>1</td><td></td></td<>	5		1 ·	1	
81 PINUS HALEPENSIS 8' 22 KEEP 82 PINUS HALEPENSIS 7' 16' REMOVE 83 PINUS HALEPENSIS 8' 12' KEEP 84 PINUS HALEPENSIS 8' 4'' KEEP 85 PINUS HALEPENSIS 6'' KEEP 86 PINUS HALEPENSIS 6'' KEEP 87 SCHINUS MUBRA 18'' 40' REMOVE 89 ALNUS RUBRA 18'' 40' REMOVE 91 ALNUS RUBRA 12'' 25' REMOVE 92 ALNUS RUBRA 12'' 30' REMOVE 93 ALNUS RUBRA 12'' 30' REMOVE 94 ALNUS RUBRA 12'' 32'' REMOVE 95 ALNUS RUBRA 12'' 32'' REMOVE 94 ALNUS RUBRA 16'' 32'' REMOVE 95 ALNUS RUBRA 16'' 32''' REMOVE 96 ALNU	i i			12	
83 PINUS HALEPENSIS 8" 12" KEEP 84 PINUS HALEPENSIS 8" """ KEEP 85 PINUS HALEPENSIS 1"" KEEP 86 PINUS HALEPENSIS 1"" KEEP 87 SCHINUS MOLLE 10" REMOVE 88 ALINUS RUBRA 16" 40" REMOVE 80 ALINUS RUBRA 12" 25" REMOVE 81 ALINUS RUBRA 12" 30" REMOVE 82 ALINUS RUBRA 12" 30" REMOVE 84 ALINUS RUBRA 12" 30" REMOVE 84 ALINUS RUBRA 14" 36" REMOVE 94 ALINUS RUBRA 16" 32" REMOVE 95 ALINUS RUBRA 16" 32" REMOVE 96 ALINUS RUBRA 10" 30" REMOVE 97 ALINUS RUBRA 10" 32" REMOVE 98 ALINUS RUBRA 10"<	81		8"	22	KEEP
86 PINUS HALEPENSIS 6' KEEP 86 PINUS HALEPENSIS KEEP 87 SCHINUS MOLE KEEP 88 ALNUS RUBRA JO' REMOVE 89 ALNUS RUBRA 10' REMOVE 90 ALNUS RUBRA 12'' 25'' REMOVE 91 ALNUS RUBRA 12'' 30'' REMOVE 92 ALNUS RUBRA 12'' 30'' REMOVE 93 ALNUS RUBRA 12'' 32'' REMOVE 94 ALNUS RUBRA 12'' 32'' REMOVE 95 ALNUS RUBRA 16''' 35''' REMOVE 96 ALNUS RUBRA 16''''''''''''''''''''''''''''''''''''			· ·	12	KEEP
30 OCALINUS RUBRA 30' REMOVE 88 ALNUS RUBRA 16" 40' REMOVE 89 ALNUS RUBRA 14" 30' REMOVE 90 ALNUS RUBRA 14" 30' REMOVE 91 ALNUS RUBRA 12" 25' REMOVE 92 ALNUS RUBRA 12" 30' REMOVE 93 ALNUS RUBRA 14" 36' REMOVE 94 ALNUS RUBRA 14" 36' REMOVE 95 ALNUS RUBRA 16" 32' REMOVE 96 ALNUS RUBRA 16" 32' REMOVE 97 ALNUS RUBRA 16" 32' REMOVE 98 ALNUS RUBRA 16" 32' REMOVE 100 ALNUS RUBRA 10" 30' REMOVE 101 ALNUS RUBRA 10" 30' REMOVE 102 ALNUS RUBRA 10" 30' REMOVE 103 ALNUS RUBRA 10" 30' REMOVE 104 ALNUS RUBRA <		1	4	· · · · · · · · · · · · · · · · · · ·	1 1
89 ALNUS RUBRA 18" 40" REMOVE 90 ALNUS RUBRA 12" 30" REMOVE 91 ALNUS RUBRA 12" 30" REMOVE 92 ALNUS RUBRA 12" 30" REMOVE 93 ALAUS RUBRA 12" 30" REMOVE 94 ALNUS RUBRA 14" 36" REMOVE 95 ALNUS RUBRA 14" 36" REMOVE 96 ALNUS RUBRA 16" 36" REMOVE 97 ALNUS RUBRA 16" 36" REMOVE 98 ALNUS RUBRA 16" 36" REMOVE 99 ALNUS RUBRA 16" 36" REMOVE 100 ALNUS RUBRA 10" 30" REMOVE 101 ALNUS RUBRA 10" 30" REMOVE 102 ALNUS RUBRA 10" 30" REMOVE 103 ALNUS RUBRA 10" 30" REMOVE 104	87	i de la constancia de la c	14 T	۰، ۵۲	REMOVE
91 ALNUS RUBRA 12" 25" REMOVE 92 ALNUS RUBRA 12" 30" REMOVE 93 ALNUS RUBRA 14" 36" REMOVE 94 ALNUS RUBRA 12" 30" REMOVE 95 ALNUS RUBRA 12" 30" REMOVE 96 ALNUS RUBRA 12" 30" REMOVE 97 ALNUS RUBRA 12" 30" REMOVE 98 ALNUS RUBRA 16" 32" REMOVE 99 ALNUS RUBRA 16" 32" REMOVE 90 ALNUS RUBRA 10" 30" REMOVE 101 ALNUS RUBRA 10" 32" REMOVE 102 ALNUS RUBRA 10" 32" REMOVE 103 ALNUS RUBRA 10" 30" REMOVE 104 FICUS BENJAMINA 5" 20" REMOVE 105 FICUS BENJAMINA 5" 20" REMOVE 106 FICUS BENJAMINA 5" 20" REMOVE 108 <	-89	ALNUS RUBRA		40'	REMOVE
33ALNUS RUBRA14"36"REMOVE34ALNUS RUBRA12"32"REMOVE36ALNUS RUBRA18"40"REMOVE36ALNUS RUBRA14"35"REMOVE37ALNUS RUBRA14"35"REMOVE38ALNUS RUBRA16"32"REMOVE39ALNUS RUBRA16"32"REMOVE300ALNUS RUBRA16"36"REMOVE301ALNUS RUBRA10"30"REMOVE302ALNUS RUBRA10"32"REMOVE303ALNUS RUBRA10"32"REMOVE304ALNUS RUBRA10"32"REMOVE305ALNUS RUBRA10"30"REMOVE306FICUS BENJAMINA6"20'REMOVE306FICUS BENJAMINA6"20'REMOVE306FICUS BENJAMINA6"20'REMOVE306ALNUS RUBRA10"30"REMOVE306ALNUS RUBRA10"30"REMOVE306ALNUS RUBRA10"30"REMOVE307ALNUS RUBRA10"30"REMOVE308ALNUS RUBRA10"30"REMOVE309ALNUS RUBRA10"30"REMOVE301ALJUS RUBRA10"26"REMOVE303ALNUS RUBRA10"26"REMOVE304ALNUS RUBRA10"26"REMOVE305ALNUS RUBRA	91	ALNUS RUBRA	12"	25'	REMOVE
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	131	MELALEUCA NESOPHILA	6"	6'	REMOVE
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LANDSCAPE NOTES

GENERAL

A thorough soil analysis by a qualified agronomist will influence final plant selection, soil amendment, impation system design and use, and future maintenance practices.

All landscape maintenance shall be provided by the owner. The initial maintenance period will be sufficient in duration to insure that all specifications are met. This includes removal of noxious weeds, resolding or plant replacement where necessary, insect and disease control, and continued fertilization as recommended by the agronomist.

Ail landscape and irrigation shall conform to the standards of the City-wide Landscape Regulations & Land Development Manual Landscape Standards, precise plan, and other applicable city and regional standards.

Plant materials have been selected that are suitable for the climate, and that integrate with the architectural theme.

Landscape drains shall be installed in planting areas as needed to prevent drainage across walkways and patio surfaces.

Tree root barriers shall be installed where trees are placed within 5 feet of public improvements.

IRRIGATION

All landscaped areas will be watered with a permanent below-grade, fully automatic irrigation system. This system will be controlled by a dual program electronic time clock and remote control valves. Pop-up type heads will be used adjacent to walkways and roadways. Bubbler heads will be used for landscaped areas less than 6' wide. The system will be installed as soon as possible after construction and prior to placement of plant materials.

The entire site will be irrigated with recycled water.

MAINTENANCE

All required landscape areas shall be maintained by the owner. The landscape areas shall be maintained in a free of debris and litter and all plant material shall be maintained in a healthy growing condition. Diseased or dead plant material shall be satisfactorily treated or replaced per the conditions of the plant.

USE AREAS: FORMS AND FUNCTIONS

(A) ± 40'x80' arrival plaza area with large planting area and (3) benches. Benches shall be cast-in-place concrete, precast concrete, or powder coated steel. Paving shall be integral color concrete, concrete or brick pavers.

(B) ± 40'x50' Informal garden seating area with (5) benches. Benches shall be cast-in-place concrete, precast concrete, or powder coated steel. Alternating bands of iawn and decomposed granite. Decomposed granite shall be New California Gold, or Coyote Gold, or Apache Brown.

(C) ± 85'x30' arrival plaza with (6) benches. Benches shall be as described above in 'A' and 'B'. Paving shall be as described above in 'A'

LANDSCAPE CALCULATIONS

STREET YARD AREA: 107,872 s.f.

Planting area required: 26,968 s.f. / Provided: 53,133 s.f. / Excess area provided: 26,165 s.f. Planting points required: 5,394 / Provided: 5,560 / Excess points provided: 166 Points achieved through trees: 5,560

VEHICULAR USE AREA (OUTSIDE STREETYARD)

Total Area: 35,524 s.f. Planting area required: 1,066 s.f. / Provided: 1,360 s.f. / Excess area provided: ,294 s.f. Planting points required: 1,066 / Provided: 1,262 / Excess points provided: 196 Points achieved through trees: 1,100

VEHICULAR USE AREA (INSIDE STREETYARD)

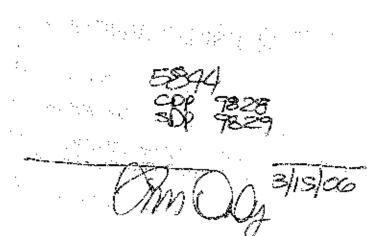
Total Area: 42,778 s.f. Pianting area required: 2,139 s.f. / Provided: 3,498 s.f. / Excess area provided: 🥙 Planting points required: 2,139 / Provided: 2,280 / Excess points provided: 141 Points achieved through trees: 1,500

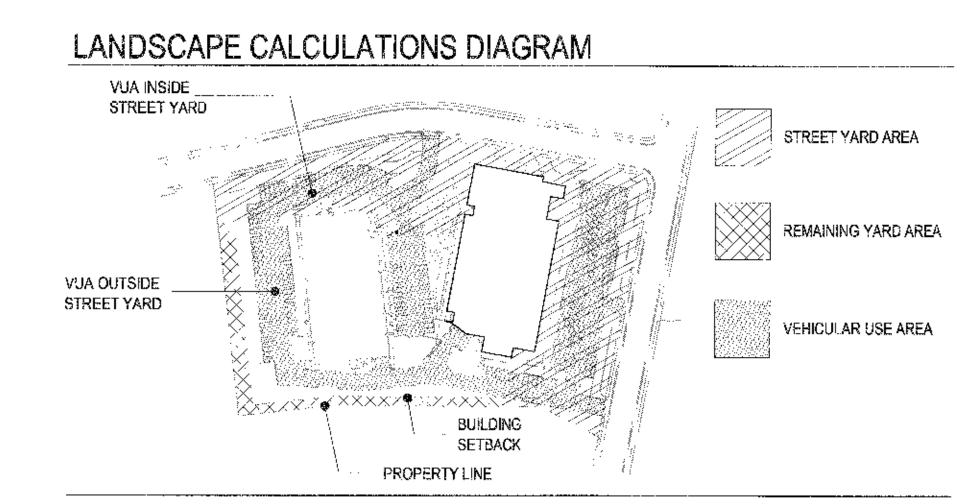
REMAINING YARD AREA: 13,775 s.f.

Planting area required: 4,133 s.f. / Provided: 13,775 s.f. / Excess area provided: 9,642 s.f. Pianting points required: 688 / Provided: 876 / Excess points provided: 188 Points achieved through trees: 600

STREET TREES IN PUBLIC RIGHT OF WAY: Length of street property lines: 1,148'

Street trees required: 38 Street irees provided: 40 (1 existing)





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721 METROSIDEROS - -EXCELSUS 36" BOX SIZE TO MATCH XISTING MASSING FORS GALLAN ROAL

> ACCESS TO LOWER LEVEL OF PARKING STRUCTURE

EXISITING PUBLIC SIDEWALK

EXISTING 2" RECYCLED WATER METER TO BE USED FOR IRRIGATION EXISTING 8" RECYCLED WATER MAIN

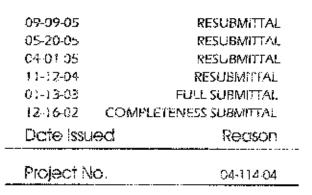
EXISTING UTILITIES





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NOWELL & ASSOCIATES LANDSCAPE ARCHITECTURE 4010 GOLDFINCH STREET, SAN DIEGO, CA. 92103 TEL 619.325.1990 FAX 619.325.1997



TORREY PINES SCIENCE PARK LOT 12

10996 TORREYANA ROAD SAN DIEGO, CA 92121

CDP / SDP SUBMITTAL PACKAGE

Revision 5:.... Revision 1: _____ ičevision <u>3:</u> Revision <u>2: 04-01-05</u> Revision 1: 11-12-04 Orig. Date: JANUARY 13, 2003

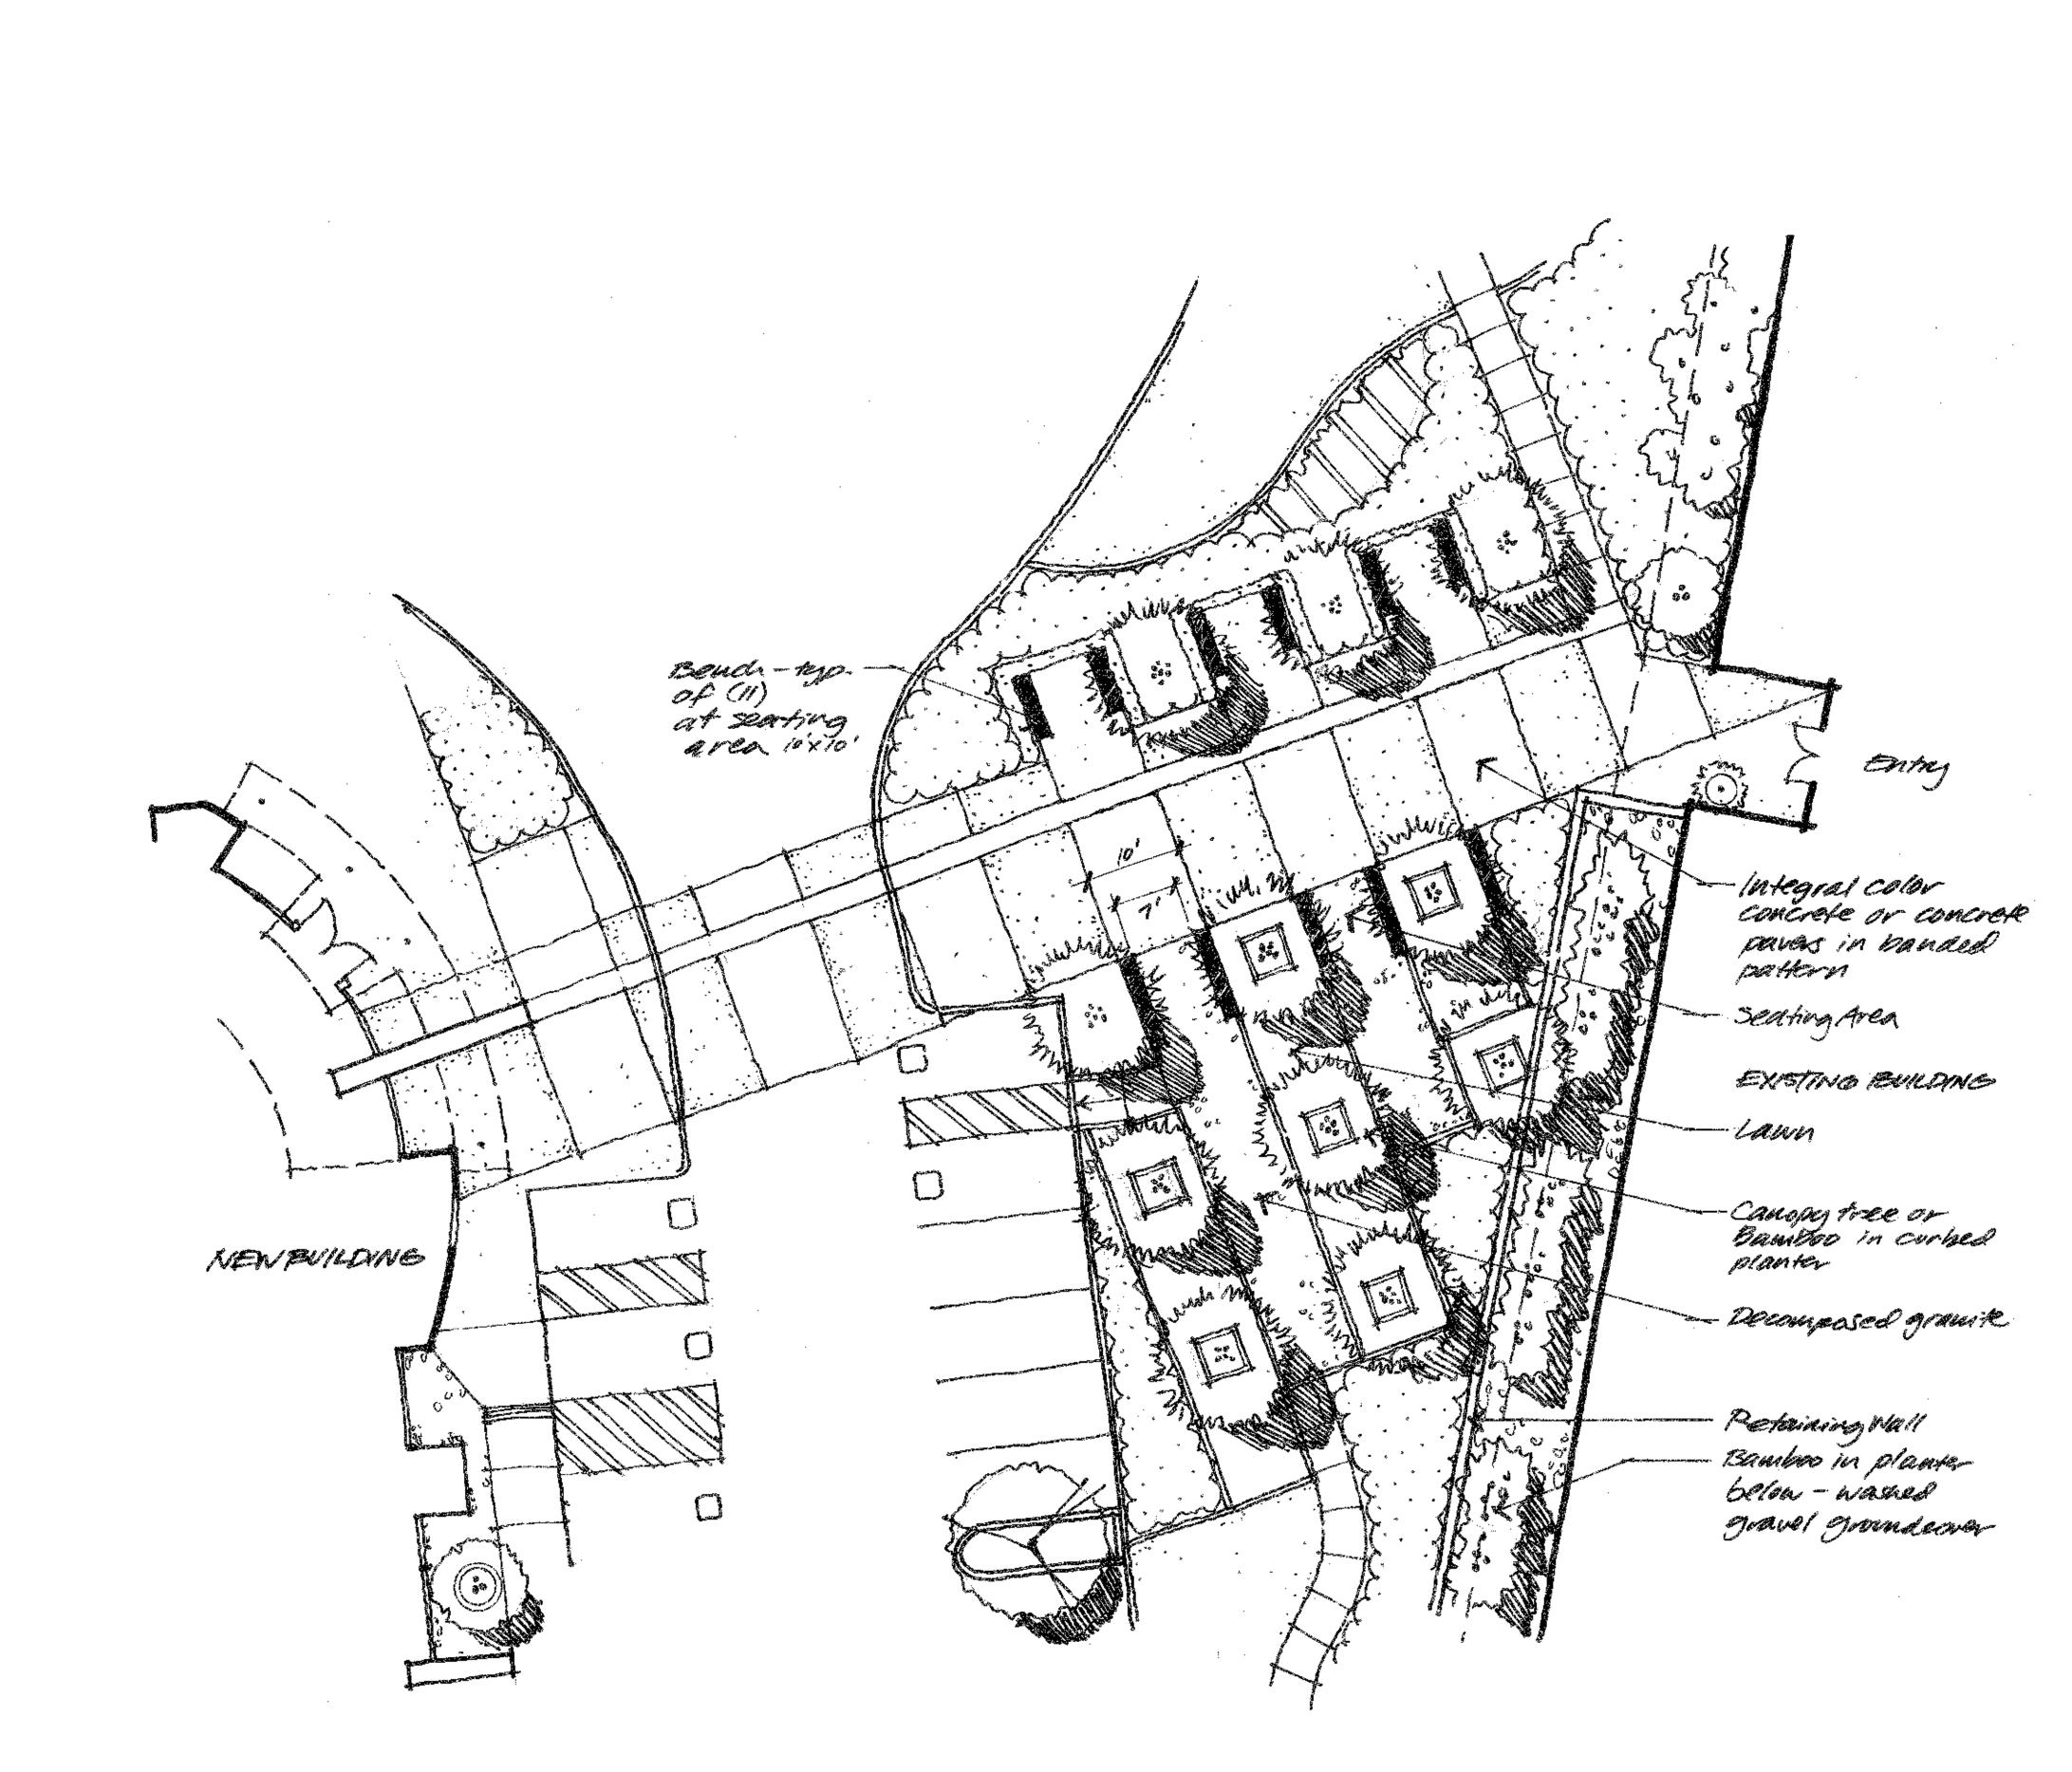
Sheet ______ of _____ DEP. No.

SHEET TITLE

SHEET NUMBER

L 1.1

LANDSCAPE DEVELOPMENT PLAN



GARDEN PLAZA ENLARGEMENT



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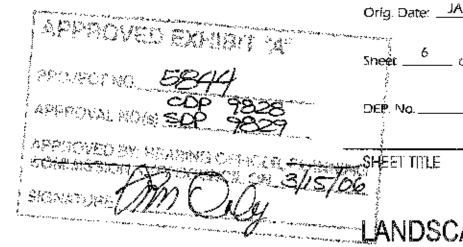
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DESIGN STATEMENT

The project is located at southwest corner of the intersection of Callan Road and Torreyana Road in the Torrey Pines Science Park. As suggested by the Design Guidelines for the Torrey Pines Sub-Area of the University Community Plan, the project is designed to blend into the surrounding andscape. We are proposing the use of Torrey Pines spaced informally along both Callan and Torreyana Roads to match the design of the surrounding properties on the East side of Torreyana Road and the north side of Callan Road. Between the existing building and Torreyana Road a new two level parking structure will be constructed. This will be screened from the street on the north and east sides by a combination of a large evergreen hedge and shrub masses along the street edge. Raised planters on the roof deck will provide landscape areas for shrubs and canopy trees to reduce heat in the parking area.

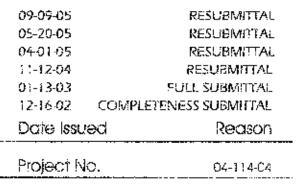
On both the south and west sides of the project are slopes that rise to meet the adjacent properties. These slopes will be planted with spreading evergreen groundcovers and a mixture of Torrey Pines and Brisbane Box. These trees along with Cresping Fig and Boston Ivy will help to screen the newly constructed retaining walls. The lowest retaining wall west of the new building will receive additional screening by a dense planting of trees along its base adjacent to the parking lot.

As one enters the site down the main driveway from Calian Road, bands of alternating colors of paving visually link the entrances of the new and existing buildings together. Between the buildings lies a large garden plaza that is intended to provide a series of smaller shaded garden room seating areas for employees or guests. The garden pattern is achieved by the use of alternating bands of stabilized decomposed granite paving and lawn that reinforce the informal garden nature of the spaces, while benches placed opposite one another offer conversational opportunities. Large clumps of Bamboo or lacy canopy trees will provide dappled shade and cover.









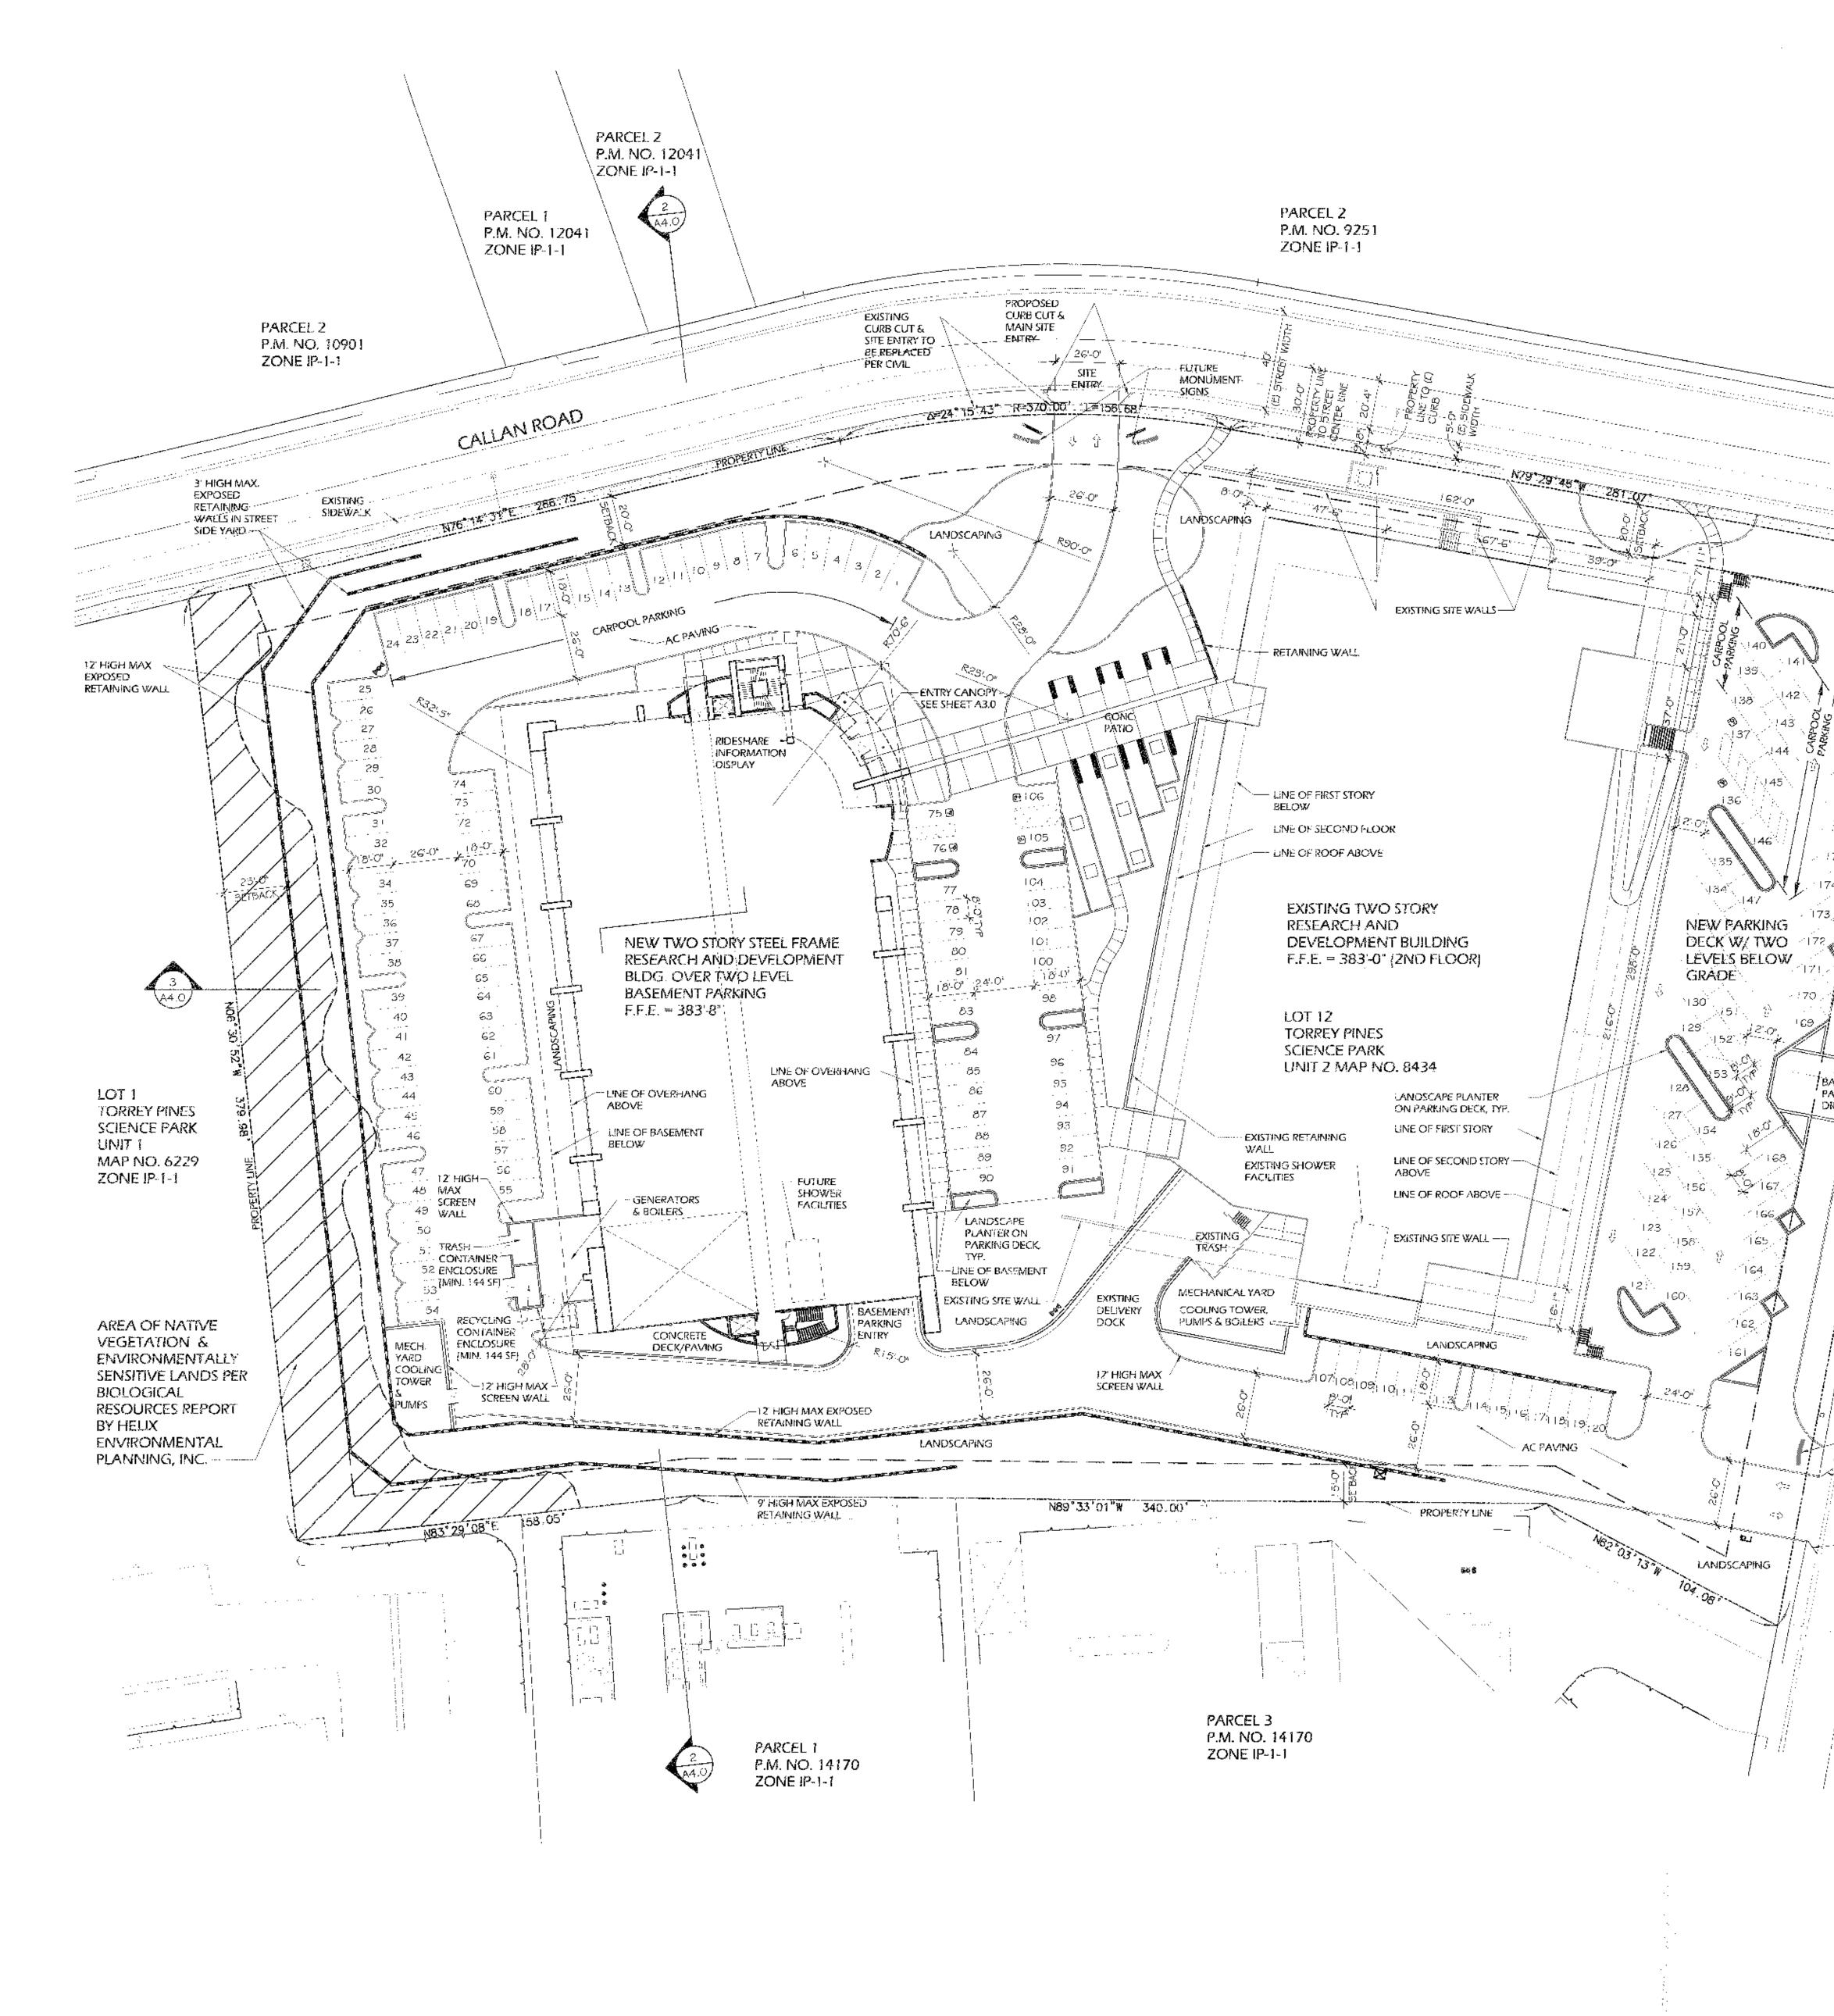
TORREY PINES SCIENCE PARK LOT 12

10996 TORREYANA ROAD SAN DIEGO, CA 92121 CDP / SDP SUBMITTAL PACKAGE

Revision Revision Revision	5: 4: 3: - 2: 04-01 05 1: 11-12-04
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DEP. No	

LANDSCAPE ENLARGEMENT PLAN





SITE PLAN SCALE: 1" = 30'-0"

COASTAL HEIGATTACHMENT 13 REQUIREMENT NOTES

 SEE SHEET A 1.3 FOR GRADE ELEVATIONS, BUILDING ELEVATIONS, HIGH POINT OF GRADE, LOW POINT OF GRADE, # SECTION DRAWINGS THAT DEMONSTRATE COMPLIANCE.

ENGINEERING NOTES

- 1. NO EXISTING EASEMENTS.
- 2. SEE SHEET CR.O FOR EXISTING & PROPOSED UT/LITIES.
- 3. SEE SHEET A4.0 FOR SITE SECTIONS.
- 4. SEE C2.0 FOR TOP OF WALL AND BOTTOM OF WALL ELEVATIONS FOR SITE RETAINING WALLS.

SITE LIGHTING NOTES

 STREET LIGHTING TO CONFORM TO CITY OF SAN DIEGO STREET DESIGN MANUAL, DOCUMENT # 769844, FILED JANUARY 12, 2001.

2. SITE UGHTING TO BE DIRECTED OR SHIELDED TO PREVENT LIGHT FROM SHINING OFFITHE PREVISES.

- ENVIRONMENTAL NOTES 1. SEE BIOLOGY REPORT BY HELIX EAVIRONMENTAL
- 2. NO "STEEP HILLSIDES" EXISTION THE PROPERTY, AS DEFINED BY MUNICIPAL CODE, THE PROPERTY WAS PREVIOULY DEVELOPED AND GRADED PER WORK ORDER NO. / 17237 # 63395
- (3) THE SITE IS CLEAR OF ALL MHPA BOUNDARIES BY 500 FEET OK MORE, SEE BIOLOGICAL RESOURCES REPORT PREPARED BY HELX EXVIRONMENTAL PLANNING INC. THAT HAS BEEN SUBMITTED TO THE CITY OF SAM DIEGO, THIS REPORT DOCUMENTS THE LG PLANT SPECIES THAT EXIST ON THE SIDE, NONE OF WHICH ARE SENSITIVE, STORYWATER RUNOFF WILL BE CONTROLLED PER THE CIVID DRAWING CR.O WITH THE REQUIRED SWPPP WHICH INCLUDES BEST MANAGEMENT PRACTICES AND THE NOTICE OF INTENT TO THE STATE REGIONAL WATER QUALITY CONTROL BOARD.

DISABLED ACCESS NOTES

PARCEL 7

UNIT 2

PARCEL

4 3 (A4.0)

- EXISTING DRIVEWAY

---- PROPOSED CURB CUT

AND PARKING

FUTURE MONUMENT

P.M. NO. 16609

-- PROPOSED CURB CUT &

SIGN

PARCEL 2

SITE ENTRY

ZONE IP-1-1

STRUCTURE ENTRY

--- EXISTING SITE UTILITIES, TYP

P.M. NO. 16609

ZONE IP-1-1

4040 I CO STREET WIDTH X

STRee

20-5

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KATONI (E) SIDELWALKI WIDTII

PROPERTY LINE

:77

175

BASEMENT / _

PARKING I

DRIVEWAY/

VV . 174 .

173

171

-170 /

169 2

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9/167

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162

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TORREY PINES

SCIENCE PARK

MAP NO. 8434

ZONE IP-1-1

- . SEE SHEET AT 4 FOR DISABLED ACCESS PLAN TRANSPORTATION NOTES
- . SEE AT 4 FOR CLOSEST PUBLIC TRANSPORTATION STOP, NO STOPS EXISY ON CALLAN ROAD OR TORREYANA ROAD.

MCAS MIRAMAR CLUP REQUIREMENTS

- 1. NO SUBSTANCES WILL BE RELEASED INTO THE AIR, NOR ELECTROMAGNETIC EMISSIONS, OR LIGHT EMISSIONS THAT WID, AFFECT AIRCRAFT OR GROUND INSTRUMENTATION.
- 2. THE CONSTRUCTION ASSEMBLIES OF THE SHELL BUILDING SHALL BE SUCH THAT THE INDOOR VOISE. LEVELS ATTRIBUTABLE TO THE AIRPORT OPERATIONS OF MOAS MIRAMAR SHALL NOT EXCEED THE LEVEL INDICATED IN THE COMPREMENSIVE LAND USE PLAN.

FIRE DEPARTMENT NOTES

SE2 SU227 AT .2 FOR FIRE DEPARTMENT REQUIREMENTS.

PARKIN	<u>iG</u>	INFC	DRN	IATI	<u>ON:</u>	
MINIMUM PAR	RKING	STALL RE	EQUIRE	MENT(S)		
S 'ANDARD	<i>δ-</i> (O" WIDE X	18-0°	LONG		
STALLS:	9'-0	D' WIDE X	: 8'-0'	LONG V	VEERE	

57A(L5)	9'-0' WIDE X +8'-0 Adjecent to A w	
DISABLED PERSON STALLS:		8407 WIDE ACCESS
MINIMUM		CODE TABLE 142 OSF: AT 142,569 S.F.=356
MAXIMUM PARKING RATYO:	4.0 SPACES PER 1,000 S.F.	AT + 42,569 S.F.=570
CARPOOL MINIMUM:	0.3 SPACES PER 1,000 S.F.	AT 142.569 5.F.+ 43
BICYCLE PARRING MINIMUMI	0.03 SPACES PFR 1,000 S.F. (W/O LOCKERS)	AT 142,569 5.F.≃ 4
BIGYCLE PARK:NG MINIMUM:	0.03 SPACES PER 1,000 S F. (WITH LOCKERS)	A1 142,569 S.F.= 4
MOTORCYCLE PARKING MIN.:	270 OF MIN. AUTOMOBILE Parking	ALIBSG SPACES = 7

PARKING TABULATION:	
UPPER LEVEL BASEMENT PARKING (INCLUDING DISABLED PERSON STALLS):	ξ
LOWER LEVEL BASEMENT PARKING:	Ę
5JBTOTAL:	I
ON-SITE PARKING (INCLUDING D. P. STALLS):	18
BASEMENT LEVEL ONE PARKING AT PARKING DECK:	ŗ
BASEMENT LEVEL TWO PARKING AT PARKING DECK:	Ę
TOTAL SITE PARKING COUNT:	4
PARKING RATION PER 1,000 S.F.	3.3

LEPHCHEN SXMBIT 4 1990,0007 NO. 5844 1999,00041, NO.16) 500 9828



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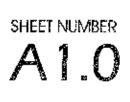
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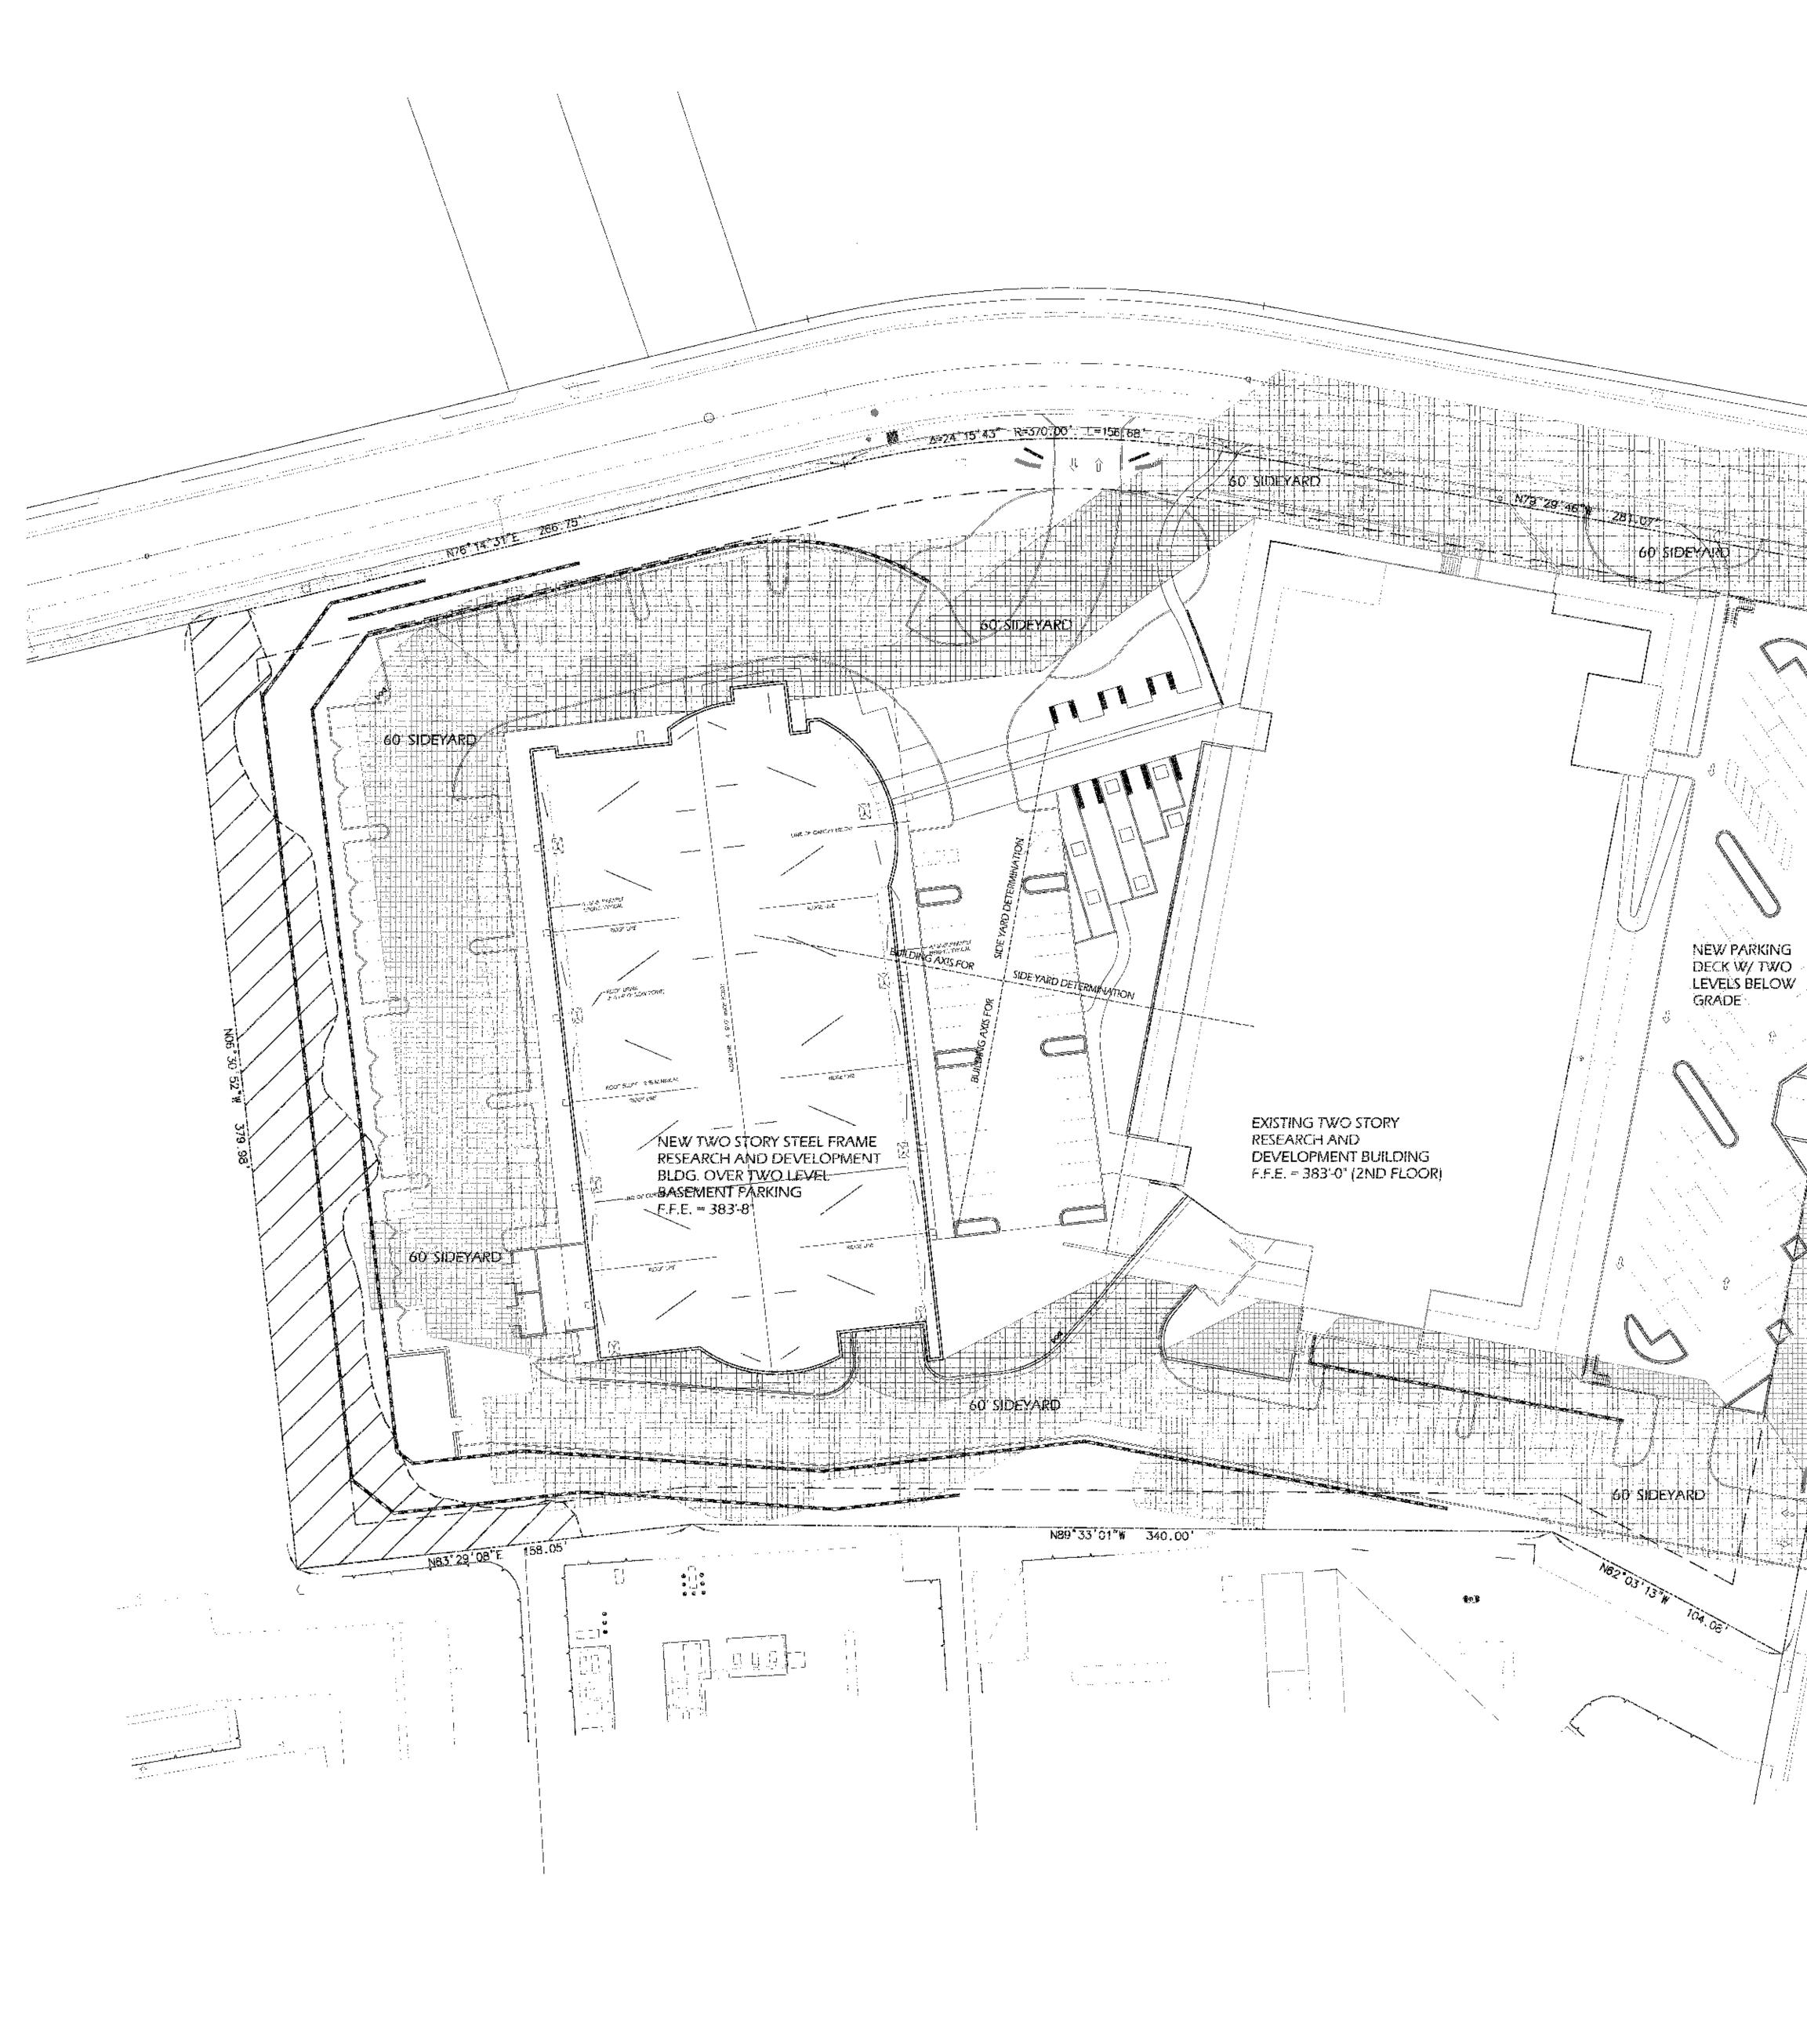
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SITE PLAN





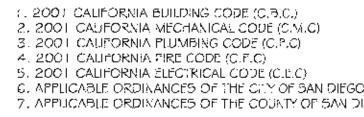
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BUILDING CODE ANALYSIS PLAN SCALE: 1" = 30'-0"

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CODE ANALYSIS

APPLICABLE CODES:



TYPE OF CONSTRUCTION FER C.B.C.:	
OCCUPANCY PER C.B.C.:	TYPE V-N FULLY SPRINKLERED
NUMBER OF STORIES:	TWO STORIES ABOVE GRADE ONLY
TABLE 3-B REQUIRED SEPARATION	IN BUILDINGS OF MIXED OCCUPANCY
OCCUPANCIES TO BE SEPARATED: NONE	FIRE RESISTIVE REQUIREMENT: NONE
TABLE 5-A EXTERIOR WALL AND OPE	NING PROTECTION:
EXTERIOR WALLS-BEARING:	I HR LESS THAN 20 FEE (
EXTERIOR WALLS-NON BEARING:	NR ELSZWHERE SAME AS BEARING
OPENINGS:	NOT PERMITTED LESS THAN 5 MT. PROTECTI LESS THAN TO FF.
TABLE G-A, TYPE V - N, FIRE RESISTI	VE CONSTRUCTION
BUILDING ELEMENT 1. BEARING WALLO - EXTERIOR	FIRE RESISTIVE REQUIREMENT
 BEARING WALLS - EXTERIOR BEARING WALLS - INTERIOR 	NR. NR
3. NON-BEARING WALLS - EXTERIOR	NR
 STRUCTURAL FRAME PARTITIONS - PERMANENT 	VR NR

PARTITIONS - PERMANENT

- SMAFT ENCLOSURES FLOOR - FLOOR / CEILINGS
- B. ROOF ROOF / CEILINGS

- 9. EXTERIOR DOORS AND WINDOWS 10. STAIRWAY CONSTRUCTION

NEW TWO STORY R&D BUILDING

TYPE OF CONSTRUCTION PER C.B.C.: TYPE V-N FULLY SPRINKLERED OCCUPANCY PER C.B.C.:

"9" (TWO STORIES ABOVE GRADE) "S13" (TWO STORIES BELOW GRADE) NUMBER OF STORIES: TWO STORIES ABOVE GRADE TWO STORIES BELOW GRADE

2 HR

TABLE 3-B REQUIRED SEPARATION IN BUILDINGS OF MIXED OCCUPANCY OCCUPANCIES TO BE SEPARATED: B : 5-3 FIRE REGISTIVE REQUIREMENT: IT HR

TABLE 5-A EXTERIOR WALL AND OPENING PROTECTION: B OCCUPANCY EXTERIOR WALLS (BEARING: T HR (256 TEAN 20 FEET, NR ELSEWHERE SAME AS BEARING

OPENINGS:

NOT PERMITTED LESS THAN 5 FT. PROTECTED LESS THAN TO FT.

NOT PERMITTED (LESS THAN 5 FT. PROTECTED LESS THAN TO MI.

FIRE REDISTIVE REQUIREMENT

PER SECTION GOGLE, SEE TABLE 5-A PER SECTION GOGLE, SEE TABLE 5-A

TABLE 5-A EXTERIOR WALL AND OPENING PROTECTION: S-3 OCCUPANCY EXTERIOR WALLS-BEARING: T HR LESS THAN 20 FEET, NR ELSEWHERE SAME AS BEARING EXTERIOR WALLS-NON BEARING:

TABLE G-A, TYPE V - N, FIRE RESISTIVE CONSTRUCTION

BUILDING ELEMENT

- BEARING WALLS INTERIOR NON-BEARING WALLS - EXTERIOR STRUCTURAL FRAME PARTITIONS - PERMANENT SHAFT ENCLOSURES FLOOR - FLOOR / CEILINGS
- ROOF ROOF / CFILINGS EXTERIOR DOORS AND WINDOWS -10. STAIRWAY CONSTRUCTION

NEW PARKING DECK

TYPE OF CONSTRUCTION PER C.B.C.: TYPE V-A FULLY SPRINKLERED OCCUPANCY PER C.B.C.:

NUMBER OF STORIES:

TABLE 5-A EXTERIOR WALL AND OPENING PROTECTION: B OCCUPANCY EXTERIOR WALLS-BEARING: U HR LESS THAN 20 FEEL, NR ELSEWHERE

EXTERIOR WALLS-NON BEARING:

OPENING5:

TABLE 5-A EXTERIOR WALL AND OPENING PROTECTION: S-3 OCCUPANCY L HR (ESS THAN 20 FEF). NR BISEW()ERF EXTERIOR WALLS-BEARING: EXTERIOR WALLS-NON BEARING:

OPENINGS:

TABLE G-A, TYPE V - N, FIRE RESISTIVE CONSTRUCTION

- BUILDING ELEMENT BEARING WALLS - INTERIOR
- NON-BEARING WALLS EXTERIOR STRUCTURAL FRAME
- PARTITIONS PERMANENT SHAFT ENCLOSURES
- FLOOR FLOOR / CEILINGS ROOF - ROOF / CEILINGS
- EXTERIOR DOORS AND WINDOWS 10. STAIRWAY CONSTRUCTION
- ALLOWABLE FLOOR AREA CALCULATION PER C.B.C.

SEC. 503.3, BUILDINGS ON SAME PROPERTY MAY BE COUNTED AS ONE BUILDING PER EXCEPTION. SEC. 504.1, TABLE 5 & BASIC ALLOWABLE AREA: 8,000 S.F. SEC. 505.2, UNLIMITED AREA - WHEN BUILDING IS LIMITED TO 2 STORIES, B OCCUPANCY WITH 60' SIDEMARDS ON ALL SIDES (SEE BUILDING CODE ANALYSIS SHEET AT LT)

> SPPROVED EXHEN '4' PROJECTINO. ഹം APPROVAL NOW SDA 982

PAROVED BY: HEARING OFFICE



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PER SECTION GOG. 4, SEE TABLE 5 A

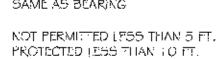
"">" (ONE STORY AT GRADE) "S-3" (ONE STORY BELOW GRADE) ONE STORY AT GRADE ONE STORY BELOW GRADE

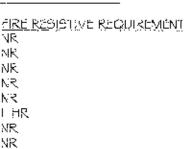
PER SECTION 60613, SEE TABLE 5-A

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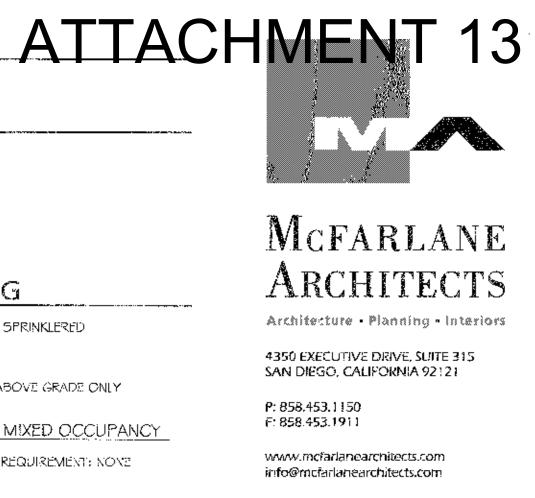










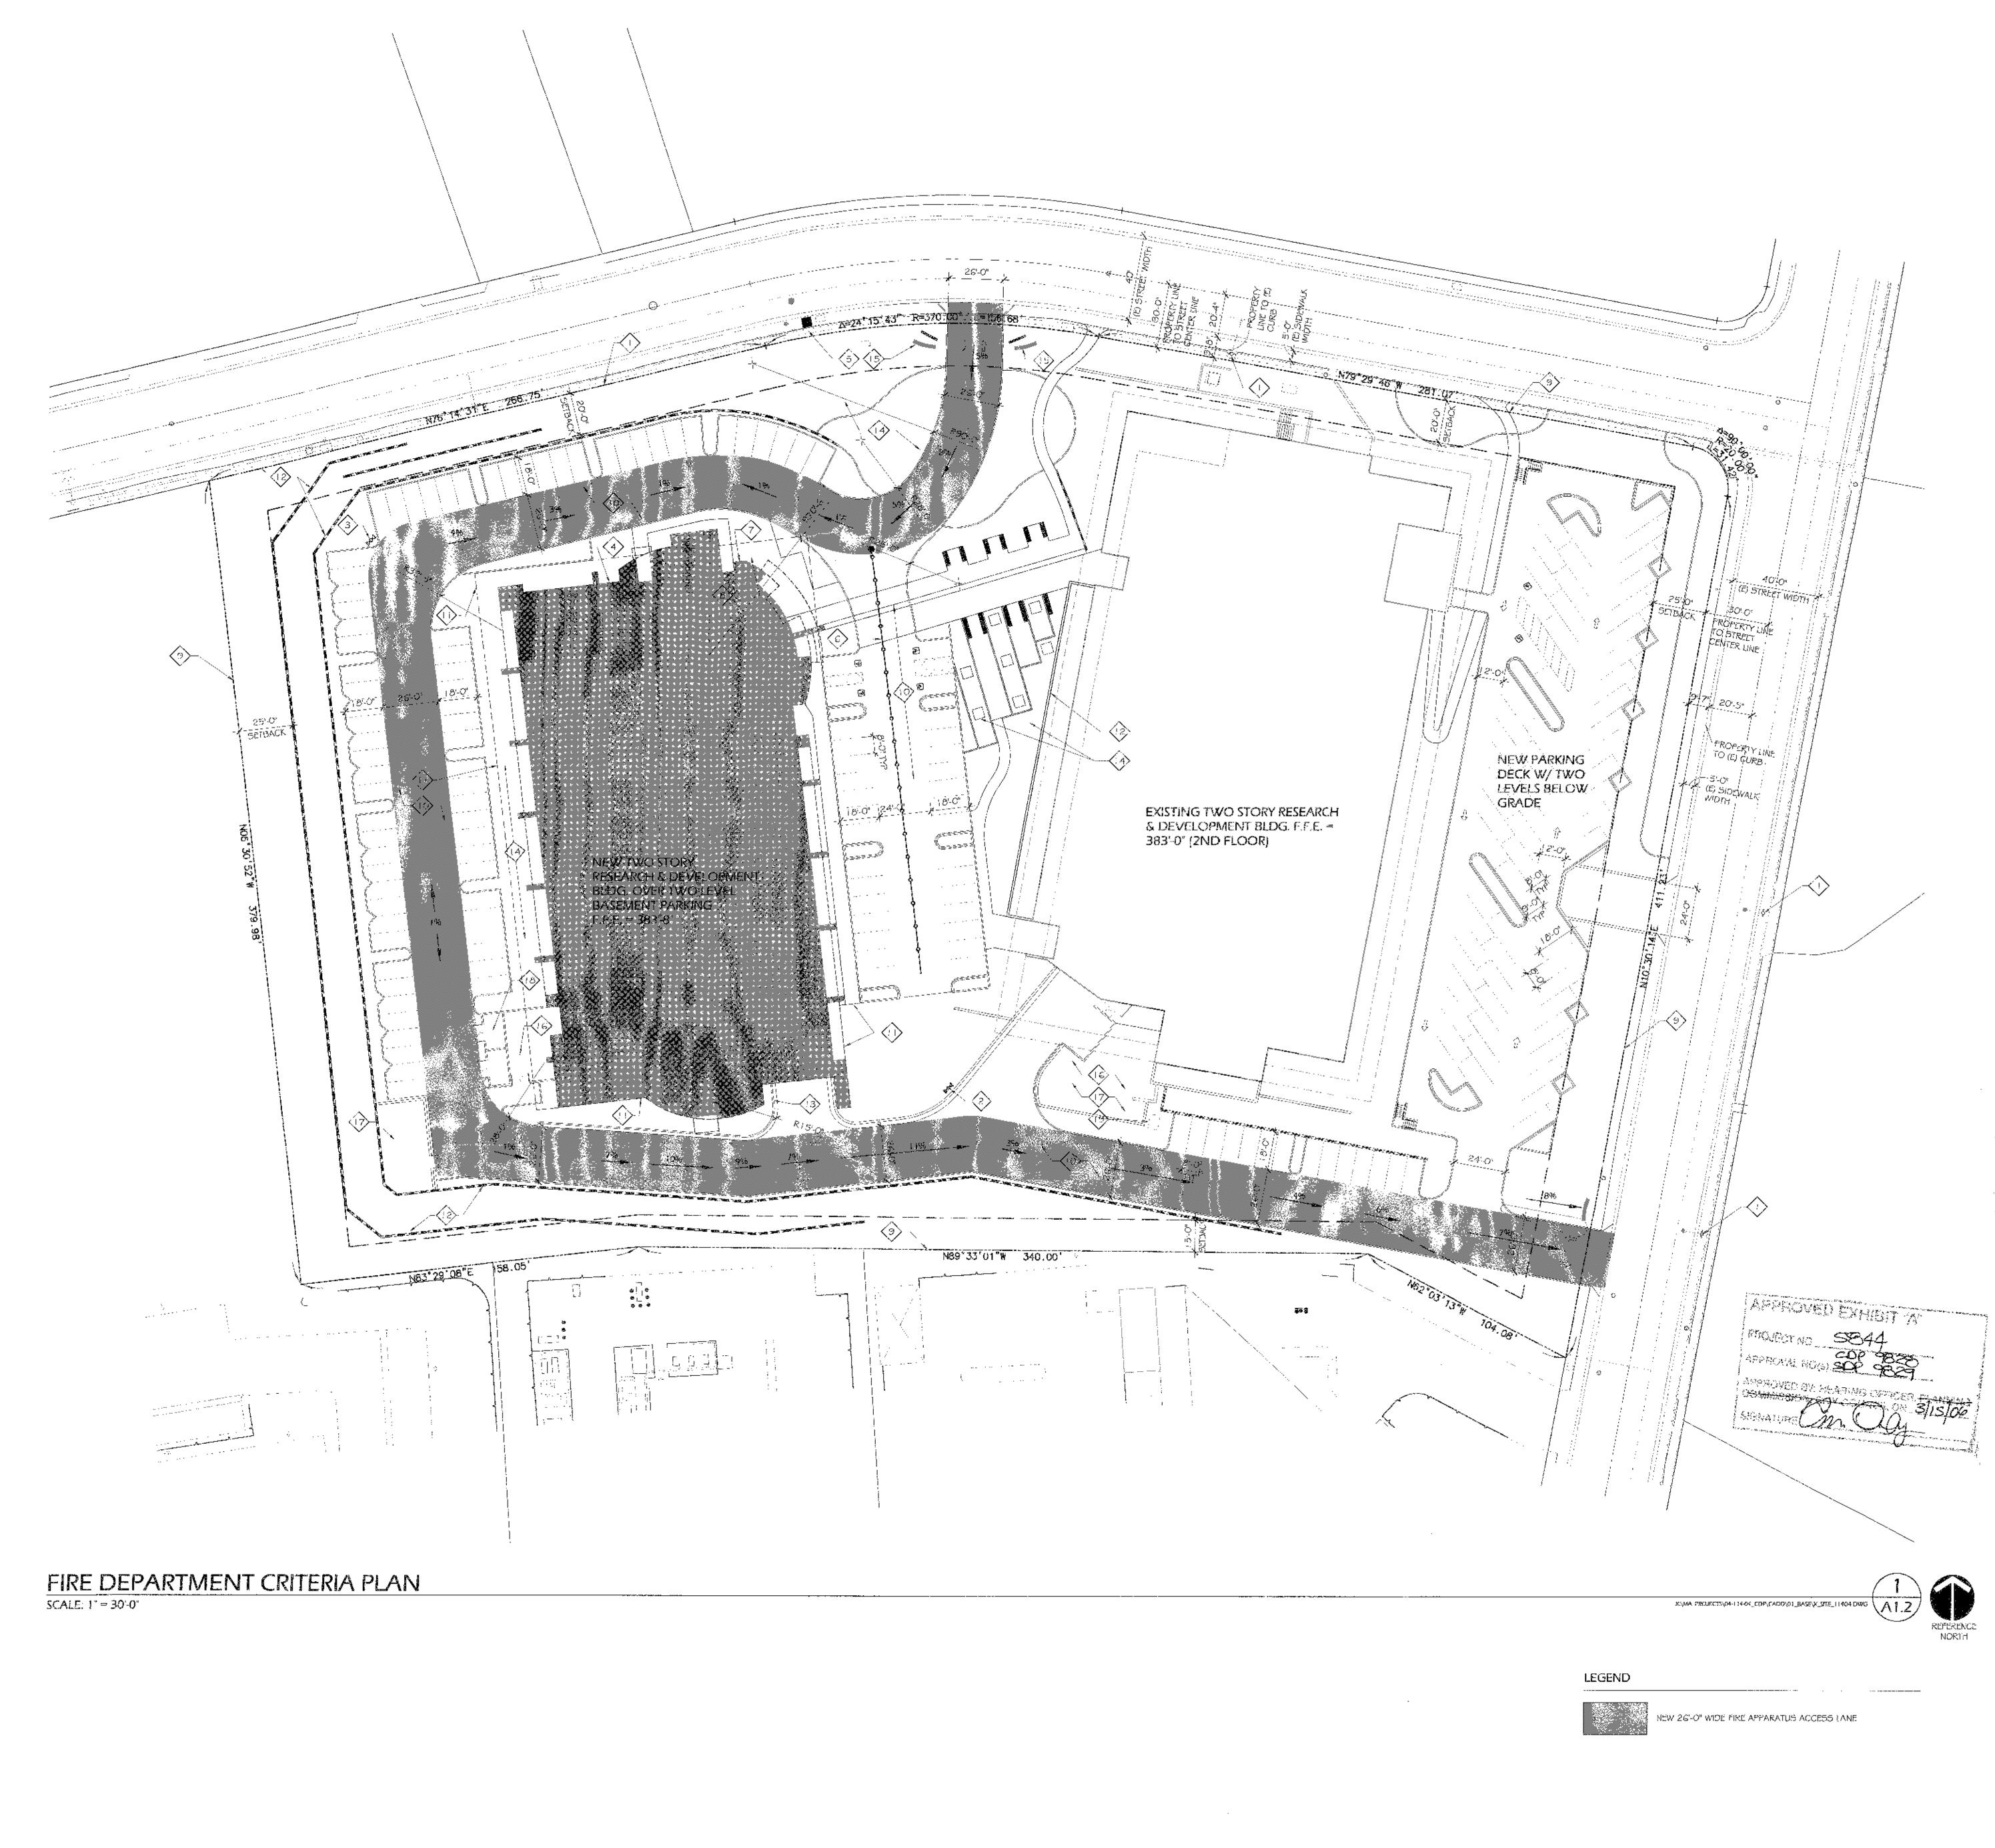


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Revision 5: Revision 4: Revision 3: Revision 2: 04-01-05 Revision 1: 11-12-04	
Orig. Date:JANUARY	13, 2003
Sheet <u>8</u> of <u>20</u>	<u> </u>
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GENERAL NOTEATTAC

- 1. FIRE APPARATUS ACCESS AND HYDRANT LOCATIONS WERE PREVIOUSLY APPROVED BY BOB MEDAN ON 12/11/00.
- 2. FIRE ACCESS JANE TO HAVE FIRE LANE SIGNAGE FER CITY OF SAM DIEGO FIRE DEPARTMENT POLICY NO. A-95-1.
- 3 VERTICAL DISTANCE FROM FINISH GRADE TO TOP OF PARAPET RANGE FROM 16'0' TO 34'0',
- 4. BUILDING OCCUPANT SHALL SECURE PERMITS REQUIRED BY THE FIRE DEPARTMENT FROM THE FIRE PREVENTION BUREAU PRIOR TO OCCUPYING THIS BUILDING.
- 5. FIRE PROTECTION, INCLUDING FIRE APPARATUS ACCESS. ROADS AND WATER SUPPLIES FOR FIRE PROTECTION. SHALL BE INSTALLED AND MADE SERVICEABLE PRIOR TO AND DURING TIME OF CONSTRUCTION. C.F.C. 9013,8704.2, 8704.3
- 6. ADDRESS SHALL BE PROVIDED FOR ALL NEW AND EXISTING BUILDINGS IN A POSITION AS TO BE PLAINLY. VISIB\% AND LEGIBL® FROM THE STREET OR ROAD PRONTING THE PROPERTY. C.F.C. 901.4.4
- 7. BUILDING NUMBERS SHALL BE EASILY VISIBLE AND LEGIBLE FROM THE STREET OR ROAD FRONTING THE PROPERTY (C.F.C. SEC. 901.4.4, C.B.C. 5EC, 502)
- 8. BUILDINGS UNDERGOING CONSTRUCTION, ALTERATION OR DEMOLITION SHALL BE IN ACCORDANCE WITH CFC. ARIICLE 87 (CFC 8701)
- 9. POST INDICATOR VALVES, FIRE DEPARTMENT CONNECTIONS, AND ALARM BELL ARE TO BE LOCATED O THE ADDRESS/ACCESS SIDE OF THE STRUCTURE, CPC 2001-4
- 0. DECORATIVE MATERIALS SHALL BE MAINTAINED IN A FLAME RETARDANT CONDITION (C.C.R., 1-19, SEC. 1.14, 3,08, 3.21 AND C.F.C. SEC. 1103.3, 2501.5, SEC. 250!.G).
- 11. DRIVEWAY OR PARKING AREAS OVER BASEMENT SHALL BE DESIGNED TO SUPPORT A MINIMUM 95,000 (B, FIRE APPARATUS PER CITY OF SAN DIEGO FIRE DEPARTMENT POUCY NO. A-96-1.

FIRE EXTINGUISHERS

- 12. AT LEAST ONE FIRE EXTINGUISHER WITH A MINIMOM RATING OF 4-A-20BIC SHALL BE PROVIDED OUTSIDE OF EACH MECHANICAL, ELECTRICAL, OR BOILER ROOM. C.F.C. 1002, UFC STANDARD (10-1, C.C.R. T-19, 3.29.
- 4.3. AT LEAST ONE FIRE EXTINGUISHER WITH A MINIMUM RATING OF 2-A-7 OBIC SHALL BE PROVIDED WITHIN 75 FEET MAXIMUM TRAVEL DISTANCE FOR EACH 6,000 SQUARE FEET OR PORTION THEREOF ON EACH FLOOR. (CFC 1002, UFC STANDARD 10-1, C.C.R., TITLE 19, 3.29)
- 14. A SODIUM BICARBONATE OR POTASSIUM BICARBONATE DRY-CHEMICAL-TYPE PORTABLE FIRE EXTINGUISHER HAVING A MINIMUM RATING OF 40-B SHALL BE INSTALLED WITHIN 30 FEET OF COMMERCIAL POOD HEAT-PROCESSING EQUIPMENT. (CPC TOOG.2,7)

FIRE HYDRANTS

- 15. FIRE HYDRANT SHALL COMPLY WITH FIRE DEPARTMENT REQUIREMENTS FOR ON SITE FIRE MYDRANTS, FIRE AND UFF SAFETY, F.P.B., POLICY F-SG-OT AND C.P.C. SEC. 903.4.
- U.S. FIRE HYDRANT LOCATIONS SHALL BE IDENTIFIED BY THE INSTAULTION OF REFLECTIVE MARKERS. C.F.C. 901.4.3.
- 17. ON SIDE FIRE HYDRANTS SHALL COMPAY WITH FIRE DEPARTMENT REQUIREMENTS AND CLEUCISEC, 203.4.

FIRE ALARM / EXTINGUISHING SYSTEMS

- 18. STANDPIPE SYSTEMS SHALL COMPLY WITH THE REQUIREMENTS OF C.B.C. SEC. 904,5 AND UBC STANDARD 9-2. (C.F.C. SEC. 904,5.1, C.F.C. 53C. 1004.1.2)
- 19. INSTAULTION OF AUTOMATIC FIRE SPRINKLER SYSTEM SHALL COMPLY WITH C.B.C. STANDARD NO. 3-1 # 9-2 AND N.F.P.A. 13.
- 20, ALL FIRE ALARM SYSTEMS SHALL BE INSTALLED IN COMPLIANCE WITH CODES AS FOLLOWS: C.B.C. ARTICLE 37760 AND C.F.C. ARTICLE 140, C.F.C. 1007
- 21, COMPLETE PLANS AND SPECIFICATIONS FOR FIRE ALARM. SYSTEMS: FIRE-EXTINGUISHING SYSTEMS, INCLUDING AUTOMATIC SPRINKLERS AND WET AND DRY STANDPIPES: BALON SYSTEMS AND OTHER SPECIAL TYPES OF FIRE-EXTINGUISHING SYSTEMS - BASEMENT PIPE INLETS: AND OTHER FIRE-PROTECTION SYSTEMS AND APPURIENANCES THERETO SHALL BE SUBMITTED TO FIRE AND UPE SAFETY FOR REVIEW AND APPROVAL PRIOR TO INSTALLATION: C.S.C. LOOT.3
- 22. AU, VALVES CONTROLLING THE WATER SUPPLY FOR AUTOMATIC SPRINKLER SYSTEMS AND WATER-PLOW SWITCHES ON ALL SPRINKLER SYSTEMS SHALL BE ELECTRICALLY MONITORED WHERE THE NUMBER OF SPRINKLER IS LOG OR MORE, C.5 C. 904.3.1, C.F.C. 1003.371
- 23. AN APPROVED AUDIBLE SPRINKLER FLOW ALARM SHALL BE PROVIDED ON THE EXTERIOR OF THE BUILDING IN AN APPROVED LOCATION, AN APPROVED AUDIBLE SPRINKLER FLOW ALARM TO ALERT THE OCCUPANTS A NORMALLY OCCUPIED FORATION CIRCLED A BAR A LEXANDRIA AND RIA. A NORMALLY OCCUPIED EDCATION. C.B.C. 904.3.2, U.B.C. STANDARD 3-1
- 24. INSTALLATION OF FIRE ALARM SYSTEMS SHALL BE IN ACCORDANCE WITH CLEUCT 1007
- 25. APPROVED AUTOMATIC FIRE-EXTINGUISHING SYSTEMS SPALL BE PROVIDED FOR THE PROTECTION OF COMMERCIAL TYPE COOKING EQUIPMENT. SEPARATE COMPLETE PLANS FOR THESE SYSTEMS SHALL BE SUBMITTED TO FIRE PLAN CHECK FOR REVIEW AND APPROVAL PRIOR TO INSTALLATION. (CFC 1006.2.1)

KEYNOTES

\mathbf{i}	PXISTING FIRE HYDRANIL SEE CIVIL DRAWINGS
\geq	RELOCATED FIRE HYDRANT PER CAVIL DRAWINGS
	NEW FIRE HYDRANT PER CIVIL DRAWINGS
	NEW FIRE DEPARTMENT CONNECTION PER CAVIL DRAWINGS
\geq	BACKFLOW PREVENTERS PER CIVIL DRAWINGS
\geq	200-0' HOSE REACH LIMITATION
\geq	BUILDING ADDRESS PER CALIFORNIA FIRE CODE 901.4.4
\rightarrow	KNOX BOX LOCATION
\rightarrow	PROPERTY LINE
	CONCRETE OR A.C. PAVING PER CIVIL DRAWINGS
	LINE OF BASEMENT BELOW
\geq	RETAINING WALL
3	SCREEN WALL
4	LANDSCAPING
\$	MONUMENT SIGN
\geq	MPCHANICAL YARD
\rightarrow	COOLING TOWER
3	TRASH ENCLOSURE

B EXISTING FIRE DEPARTMENT CONNECTION

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Date Issued

Project No.

TORREY PINES SCIENCE PARK LOT 12 10996 TORREYANA ROAD SAN DIEGO, CA 92121

12-16-02 COMPLETENESS SUBMITTAL

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RESCOMMENTAL

Reason

04-114-04

FULL SUBMITTAL

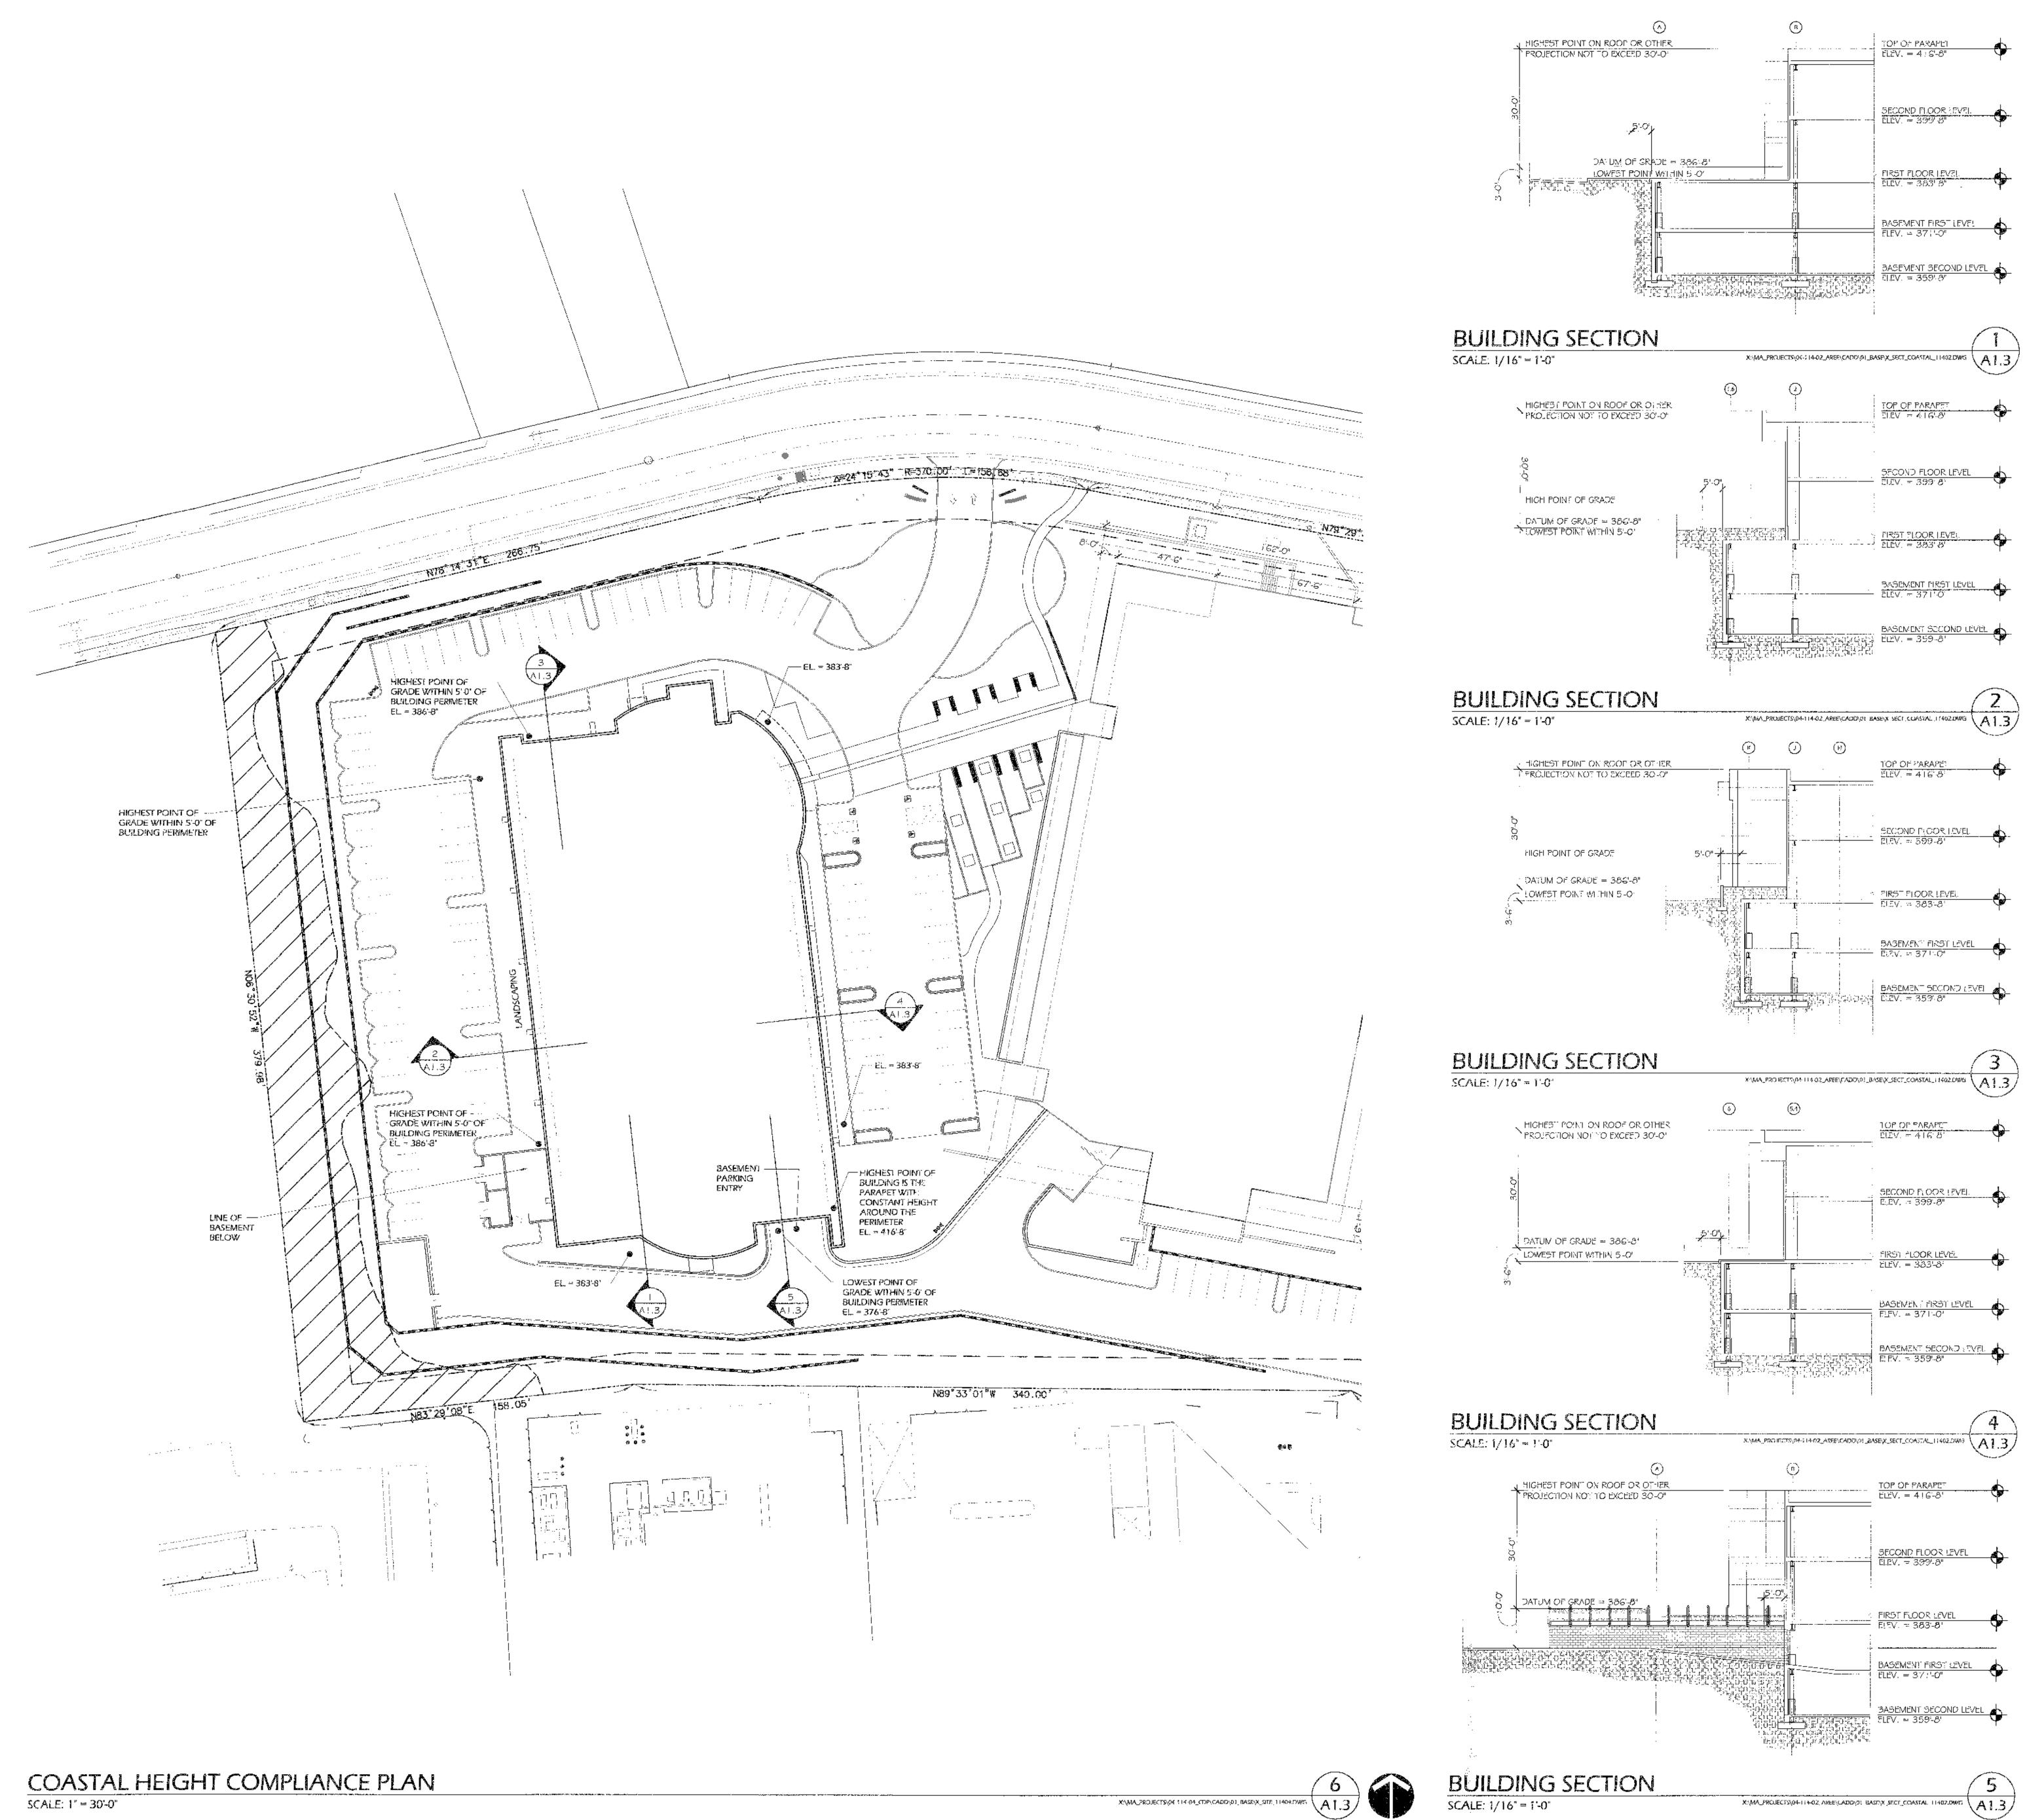
CDP / SDP SUBMITTAL PACKAGE Revision 5:_____

Revision 4: _____ Revision 3:_____ Revision 2:_____ Revision 1: 11-12-04 Orig. Date: JANUARY 13, 2003 Sheet ______ of _____

SHEET TITLE FIRE DEPARTMENT CRITERIA PLAN

DEP. No.

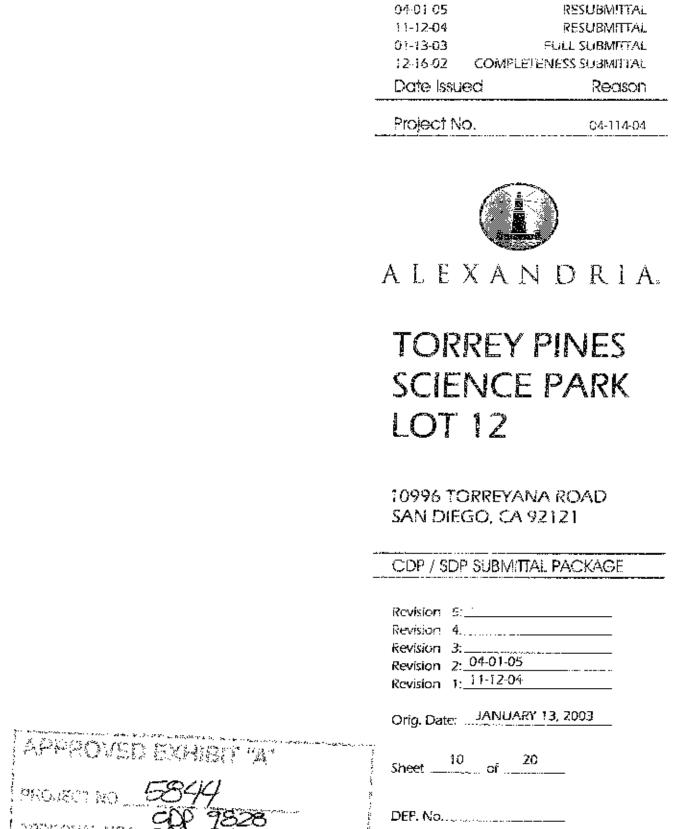
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- THE BIGHEST POINT OF THE BUILDING IS THE ROOF PARAPET (SL. 41 G-8') INCLUDING ANY EQUIPMENT, VENTS, PIPES, ANTENNAE OR OTHER PROJECTIONS.
- 2. GRADE HAS BEEN DEFINED PER CRY OF SAN DIEGO. BUILDING NEWSLETTERS 2-1 AND 2-2.
- 3. DATUM OF GRADE FOR THE DECERMINATION OF PROPOSITION DICOMPLIANCE IS 386-8%



info@mcfarlanearchitects.com



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RESUBMITTAL

09-09-05

05-20-05

COASTAL HEIGHT COMPLIANCE PLAN

SHEET NUMBER A1.3

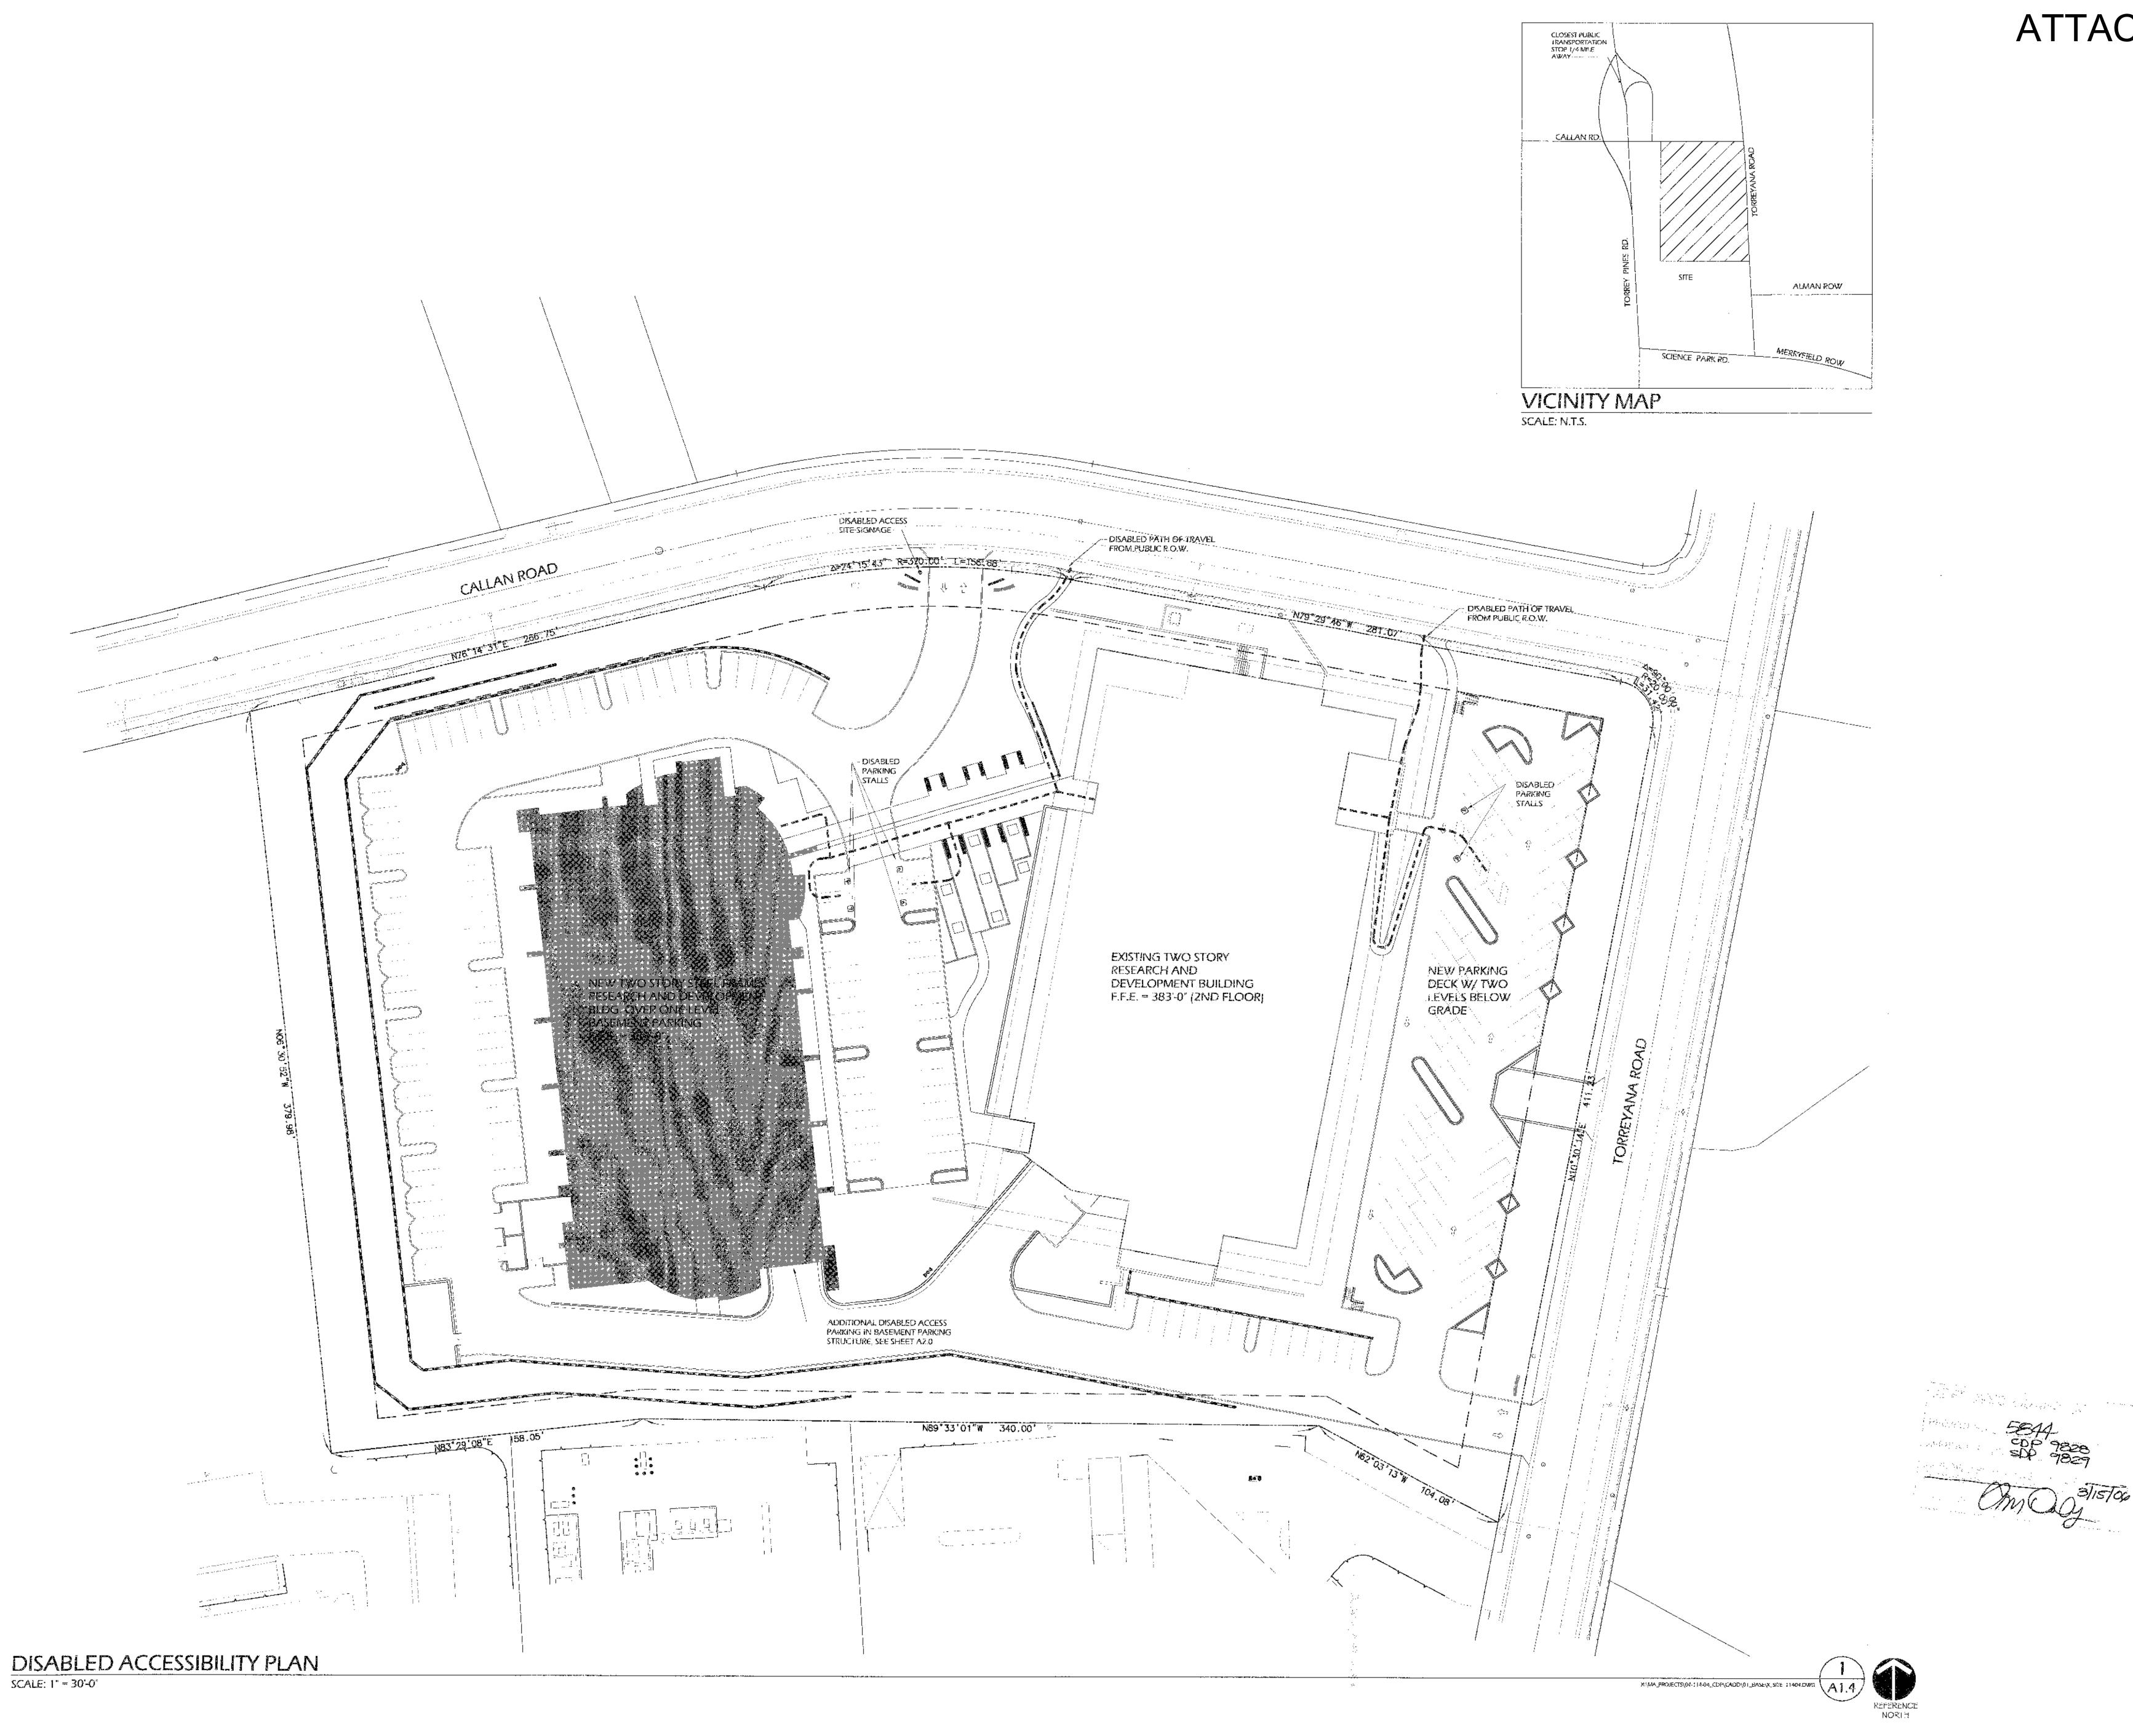
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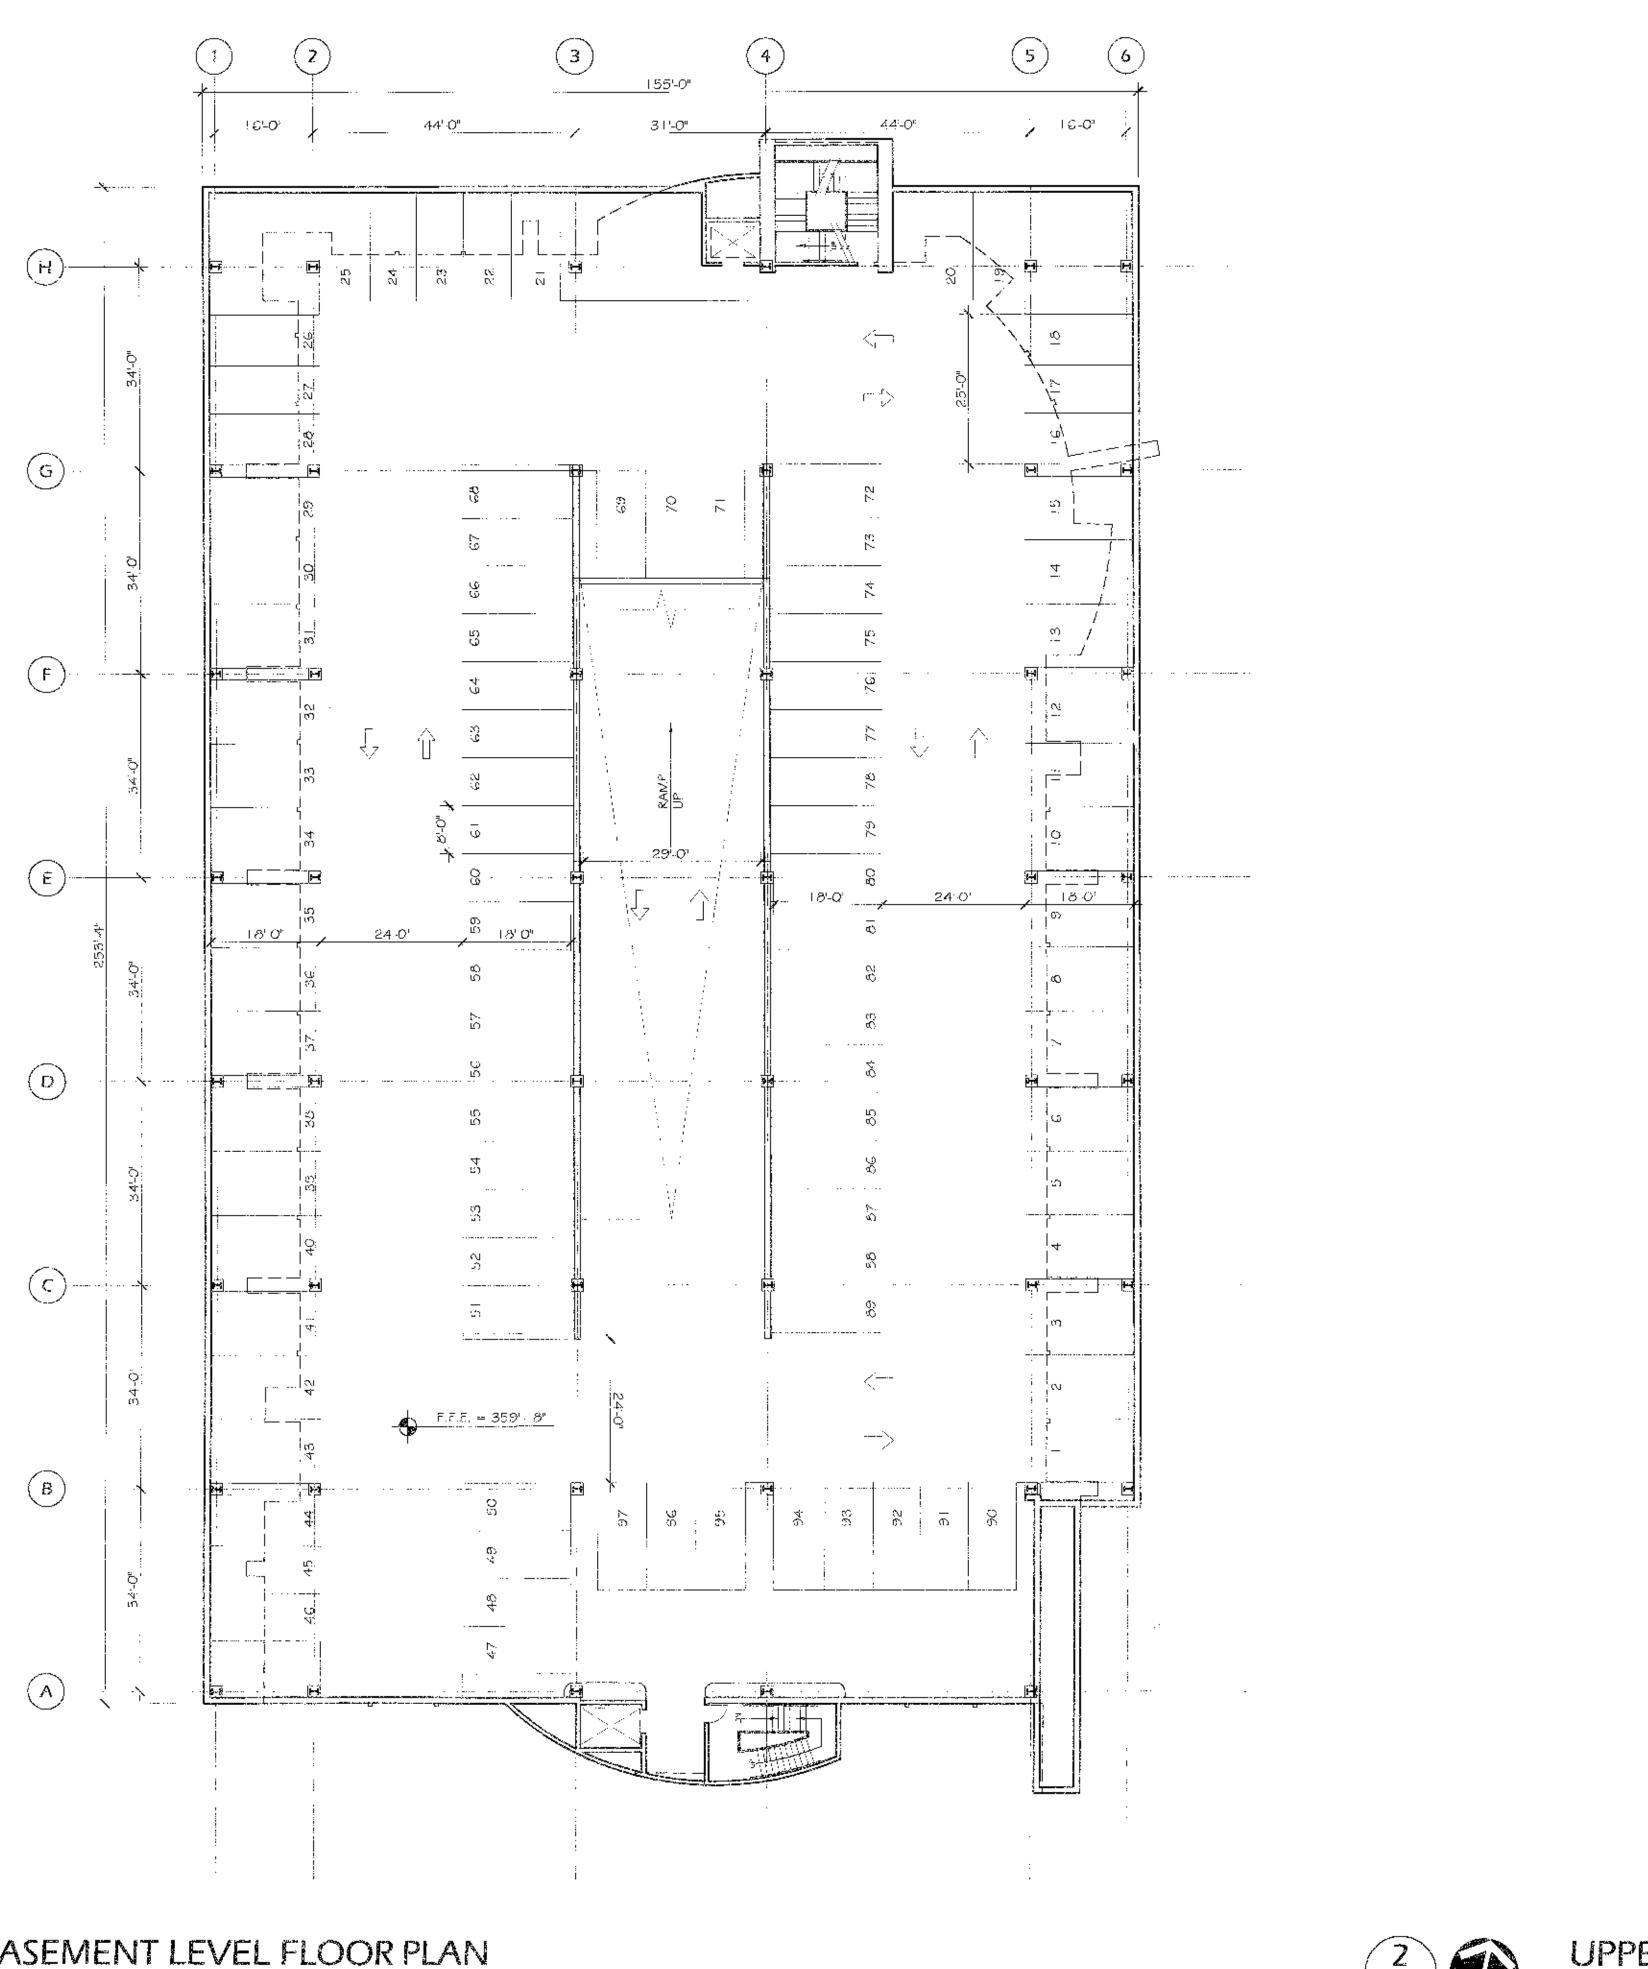
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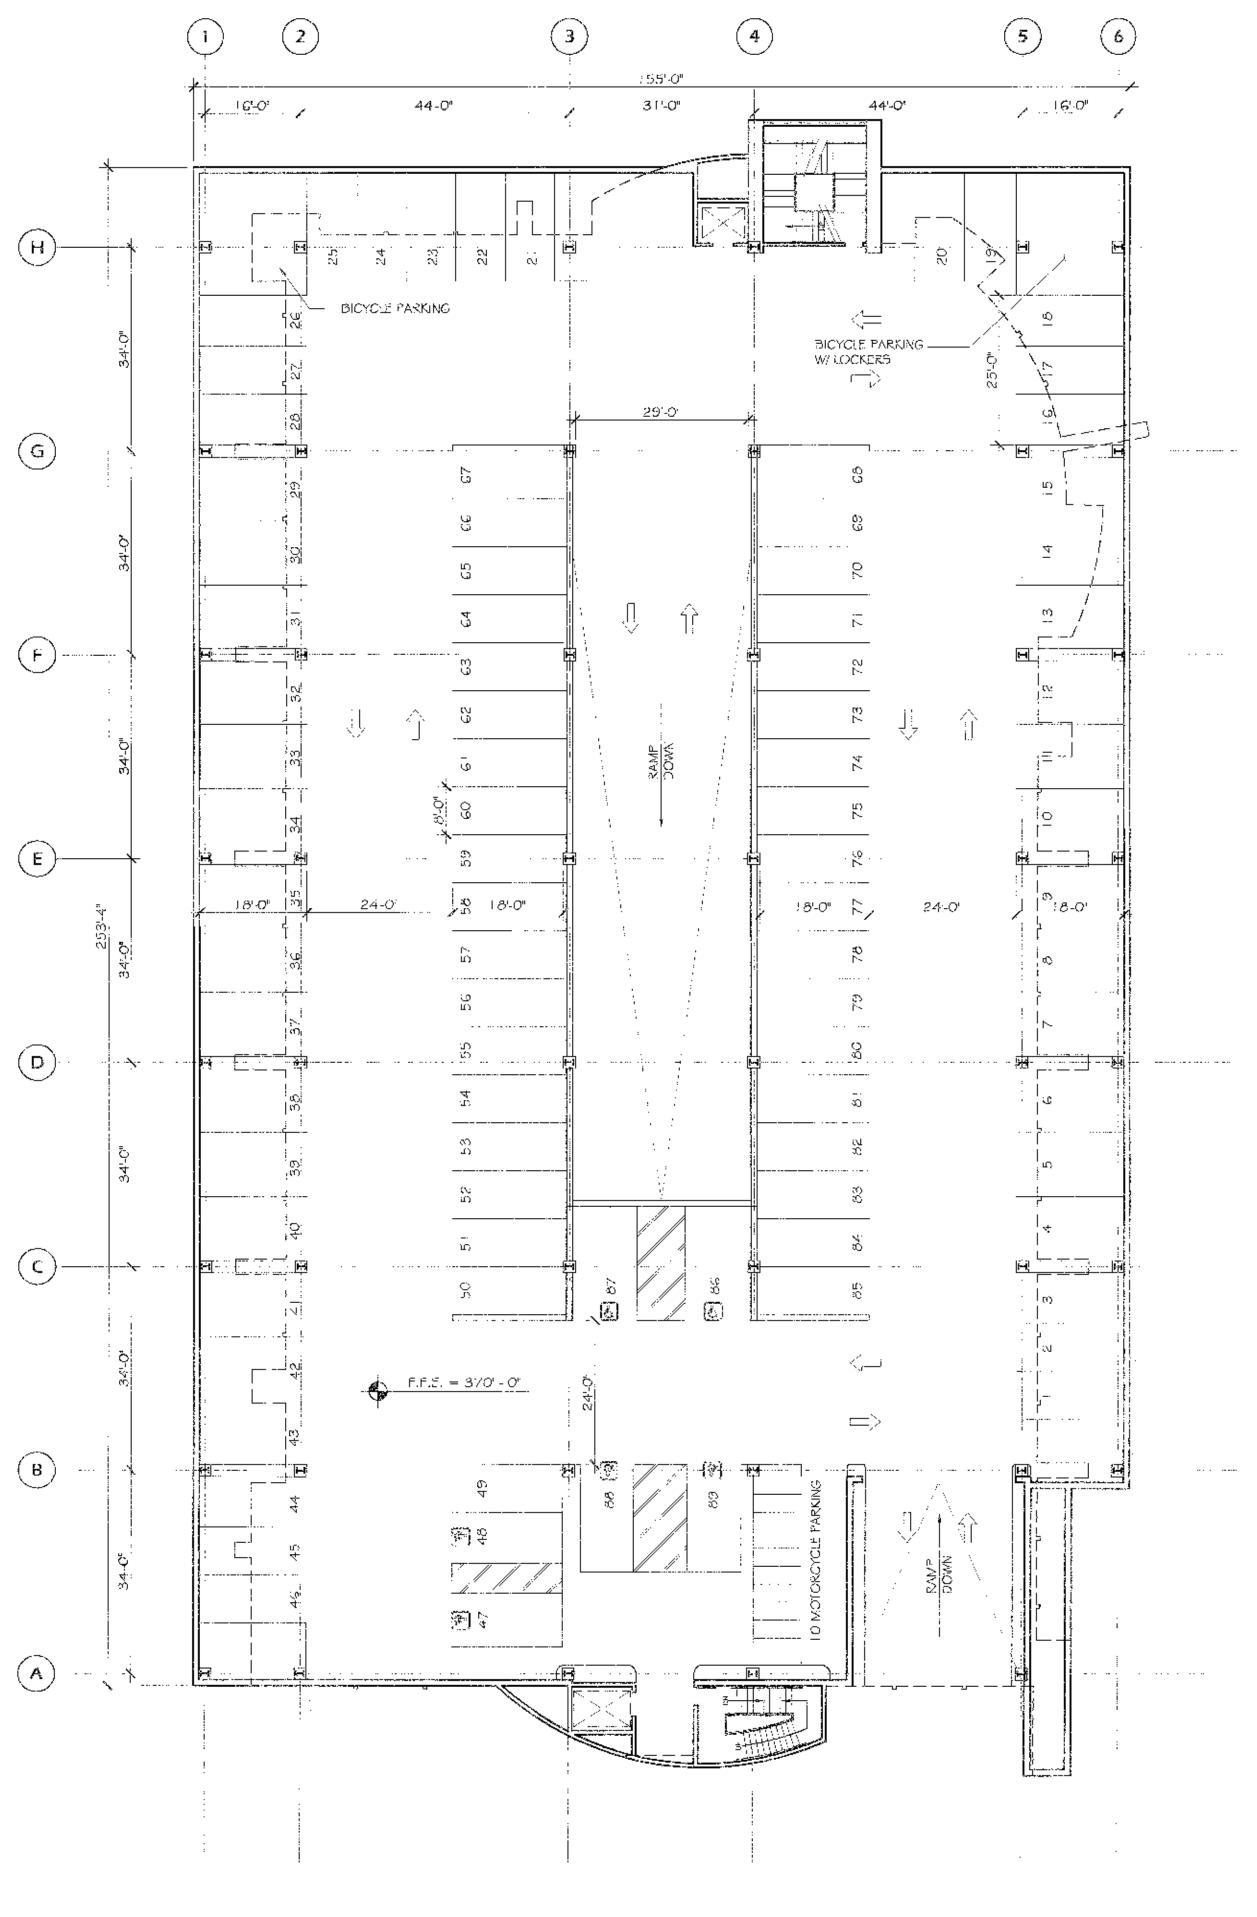


09-09-05 RESUBMITTAL 05 20 05 RESUBMITTAL 04-01-05 RESUBMITTAL 10-12-04 RESUBINITTAL 01-13-03 FULL SUBMITTAL 12-16-02 COMPLETENESS SUBMITTAL Date issued Reason Project No. 04-114-04 L. ALEXANDRIA. TORREY PINES SCIENCE PARK LOT 12 10996 TORREYANA ROAD SAN DIEGO, CA 92121 CDP / SDP SUBMITTAL PACKAGE Revision 5: _____ Revision 1:.... Revision 3;_ Revision 2: 04:01:05 Revision 1: 11-12-04 Orig. Date: JANUARY 13, 2003 Sheet 11 of 20 SHEET TITLE DISABLED ACCESSIBILITY PLAN

SHEET NUMBER A1.4



LOWER BASEMENT LEVEL FLOOR PLAN SCALE: 1/16" = 1'-0"





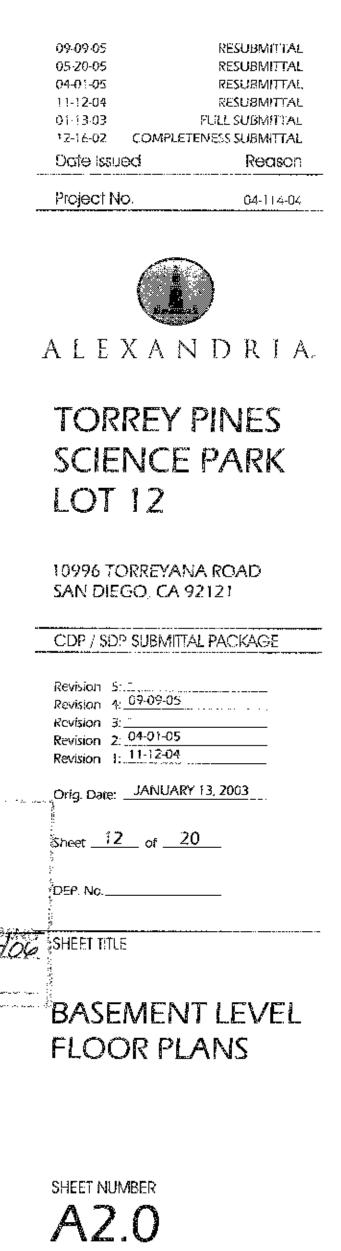
UPPER BASEMENT LEVEL FLOOR PLAN SCALE: 1/16" = 1'-0"

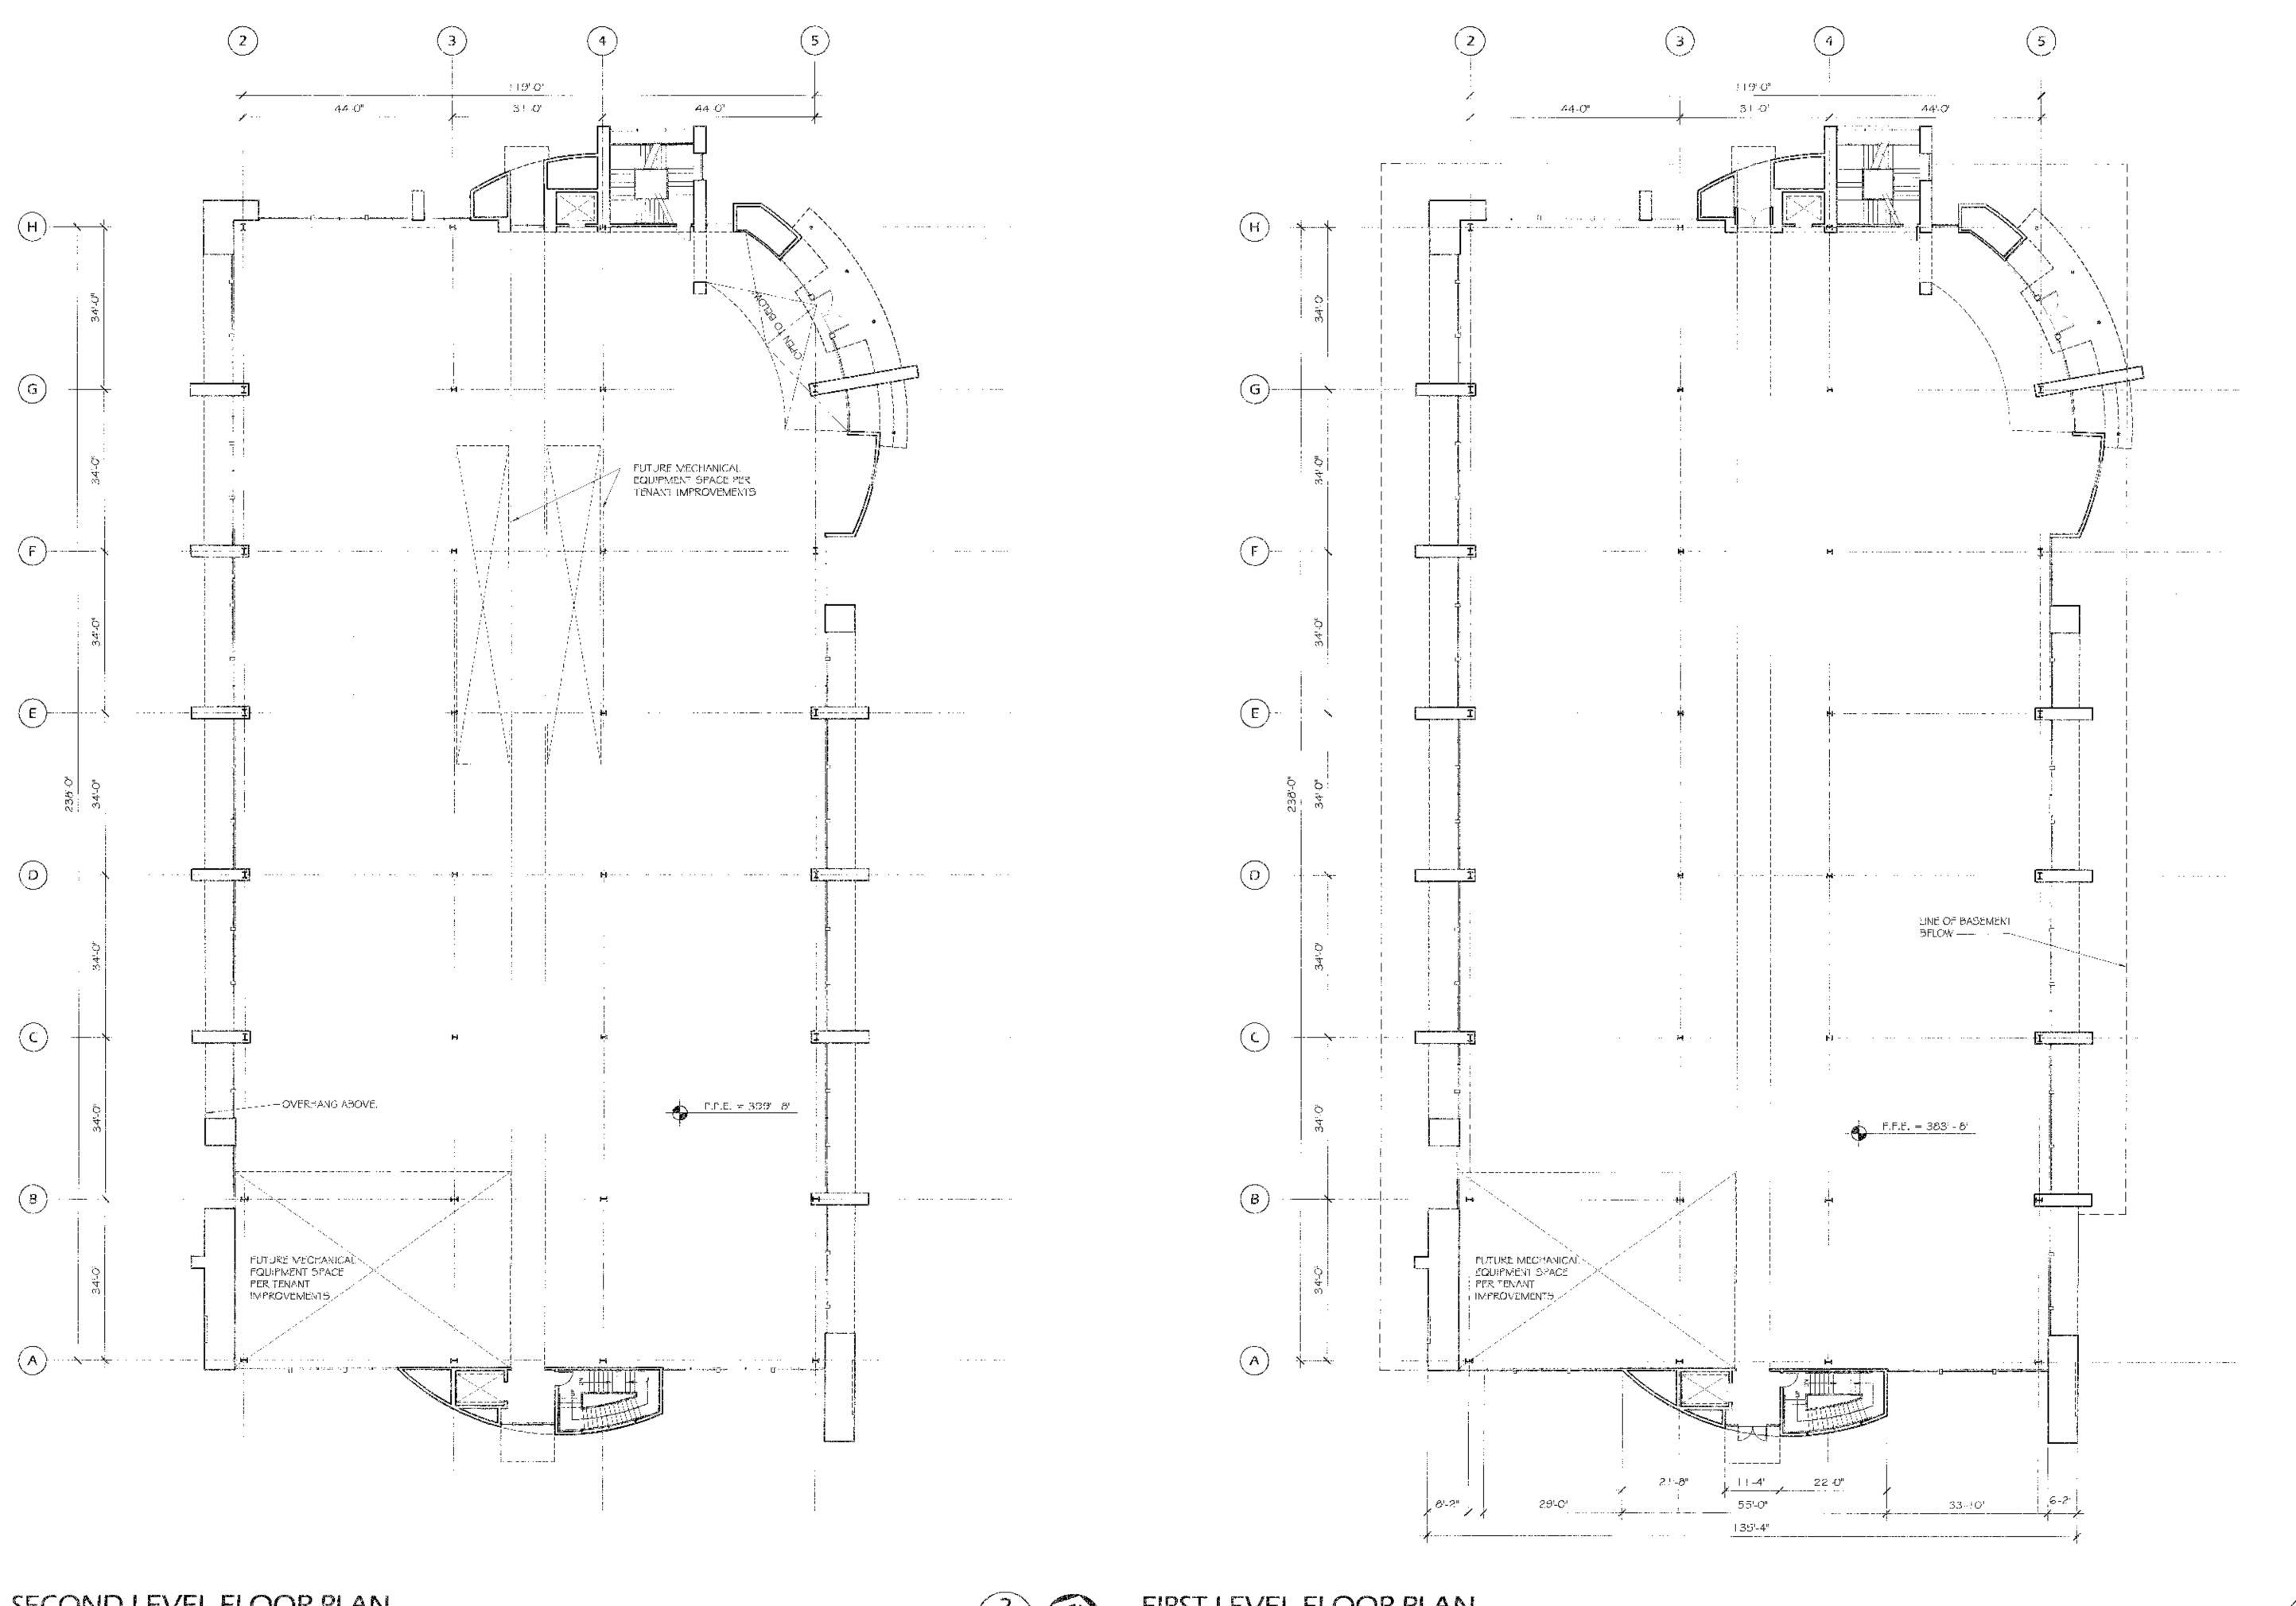
APPROVED EXHIBIT 'A' PTOLECT NO. 6844 APPHONAL NOISE SDP 9828 APPROVED BY NEAPING OF ALLS 3715706 SHEET TILE

REFERENCE NORTH

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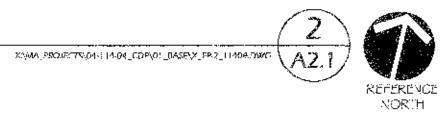




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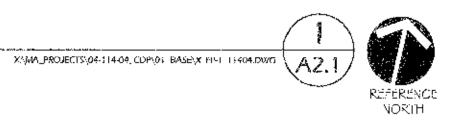
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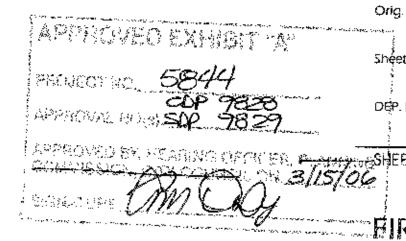
FIRST LEVEL FLOOR PLAN SCALE: 1/16" = 1'-0"

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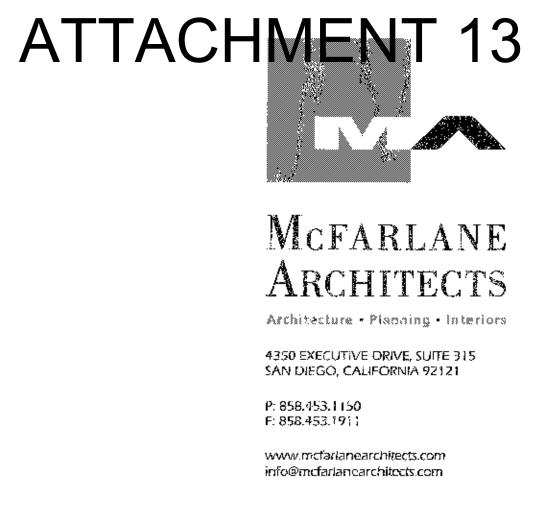
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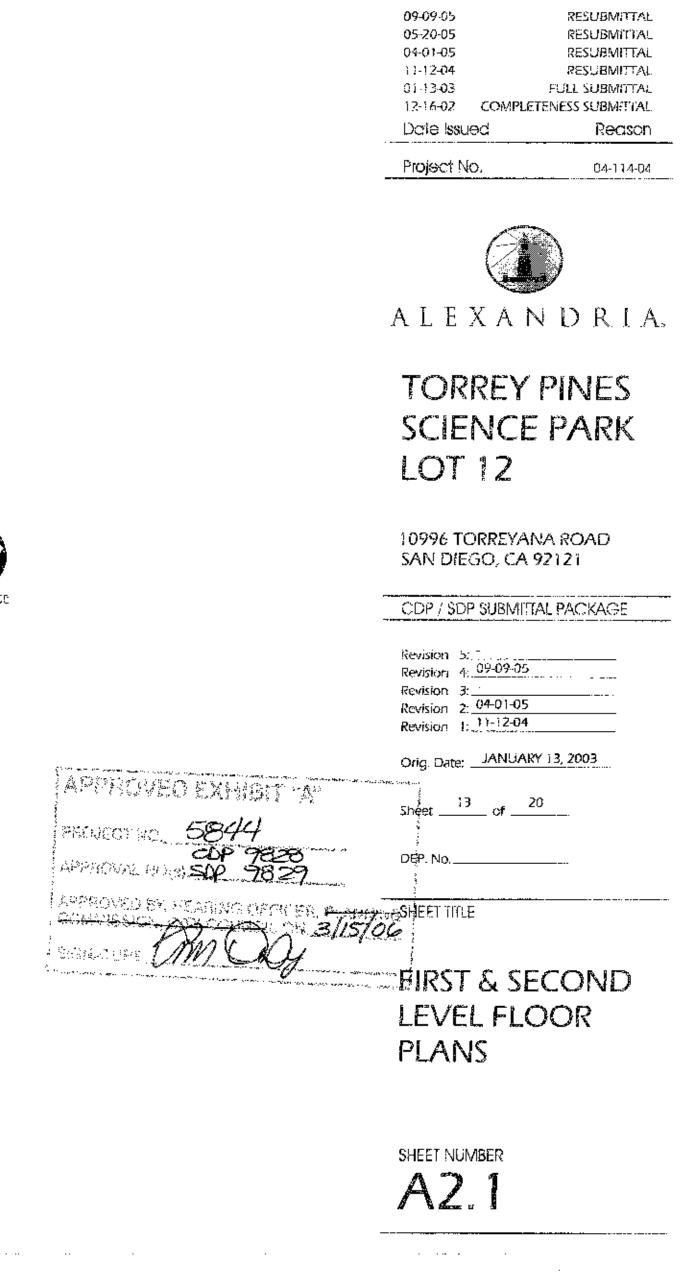


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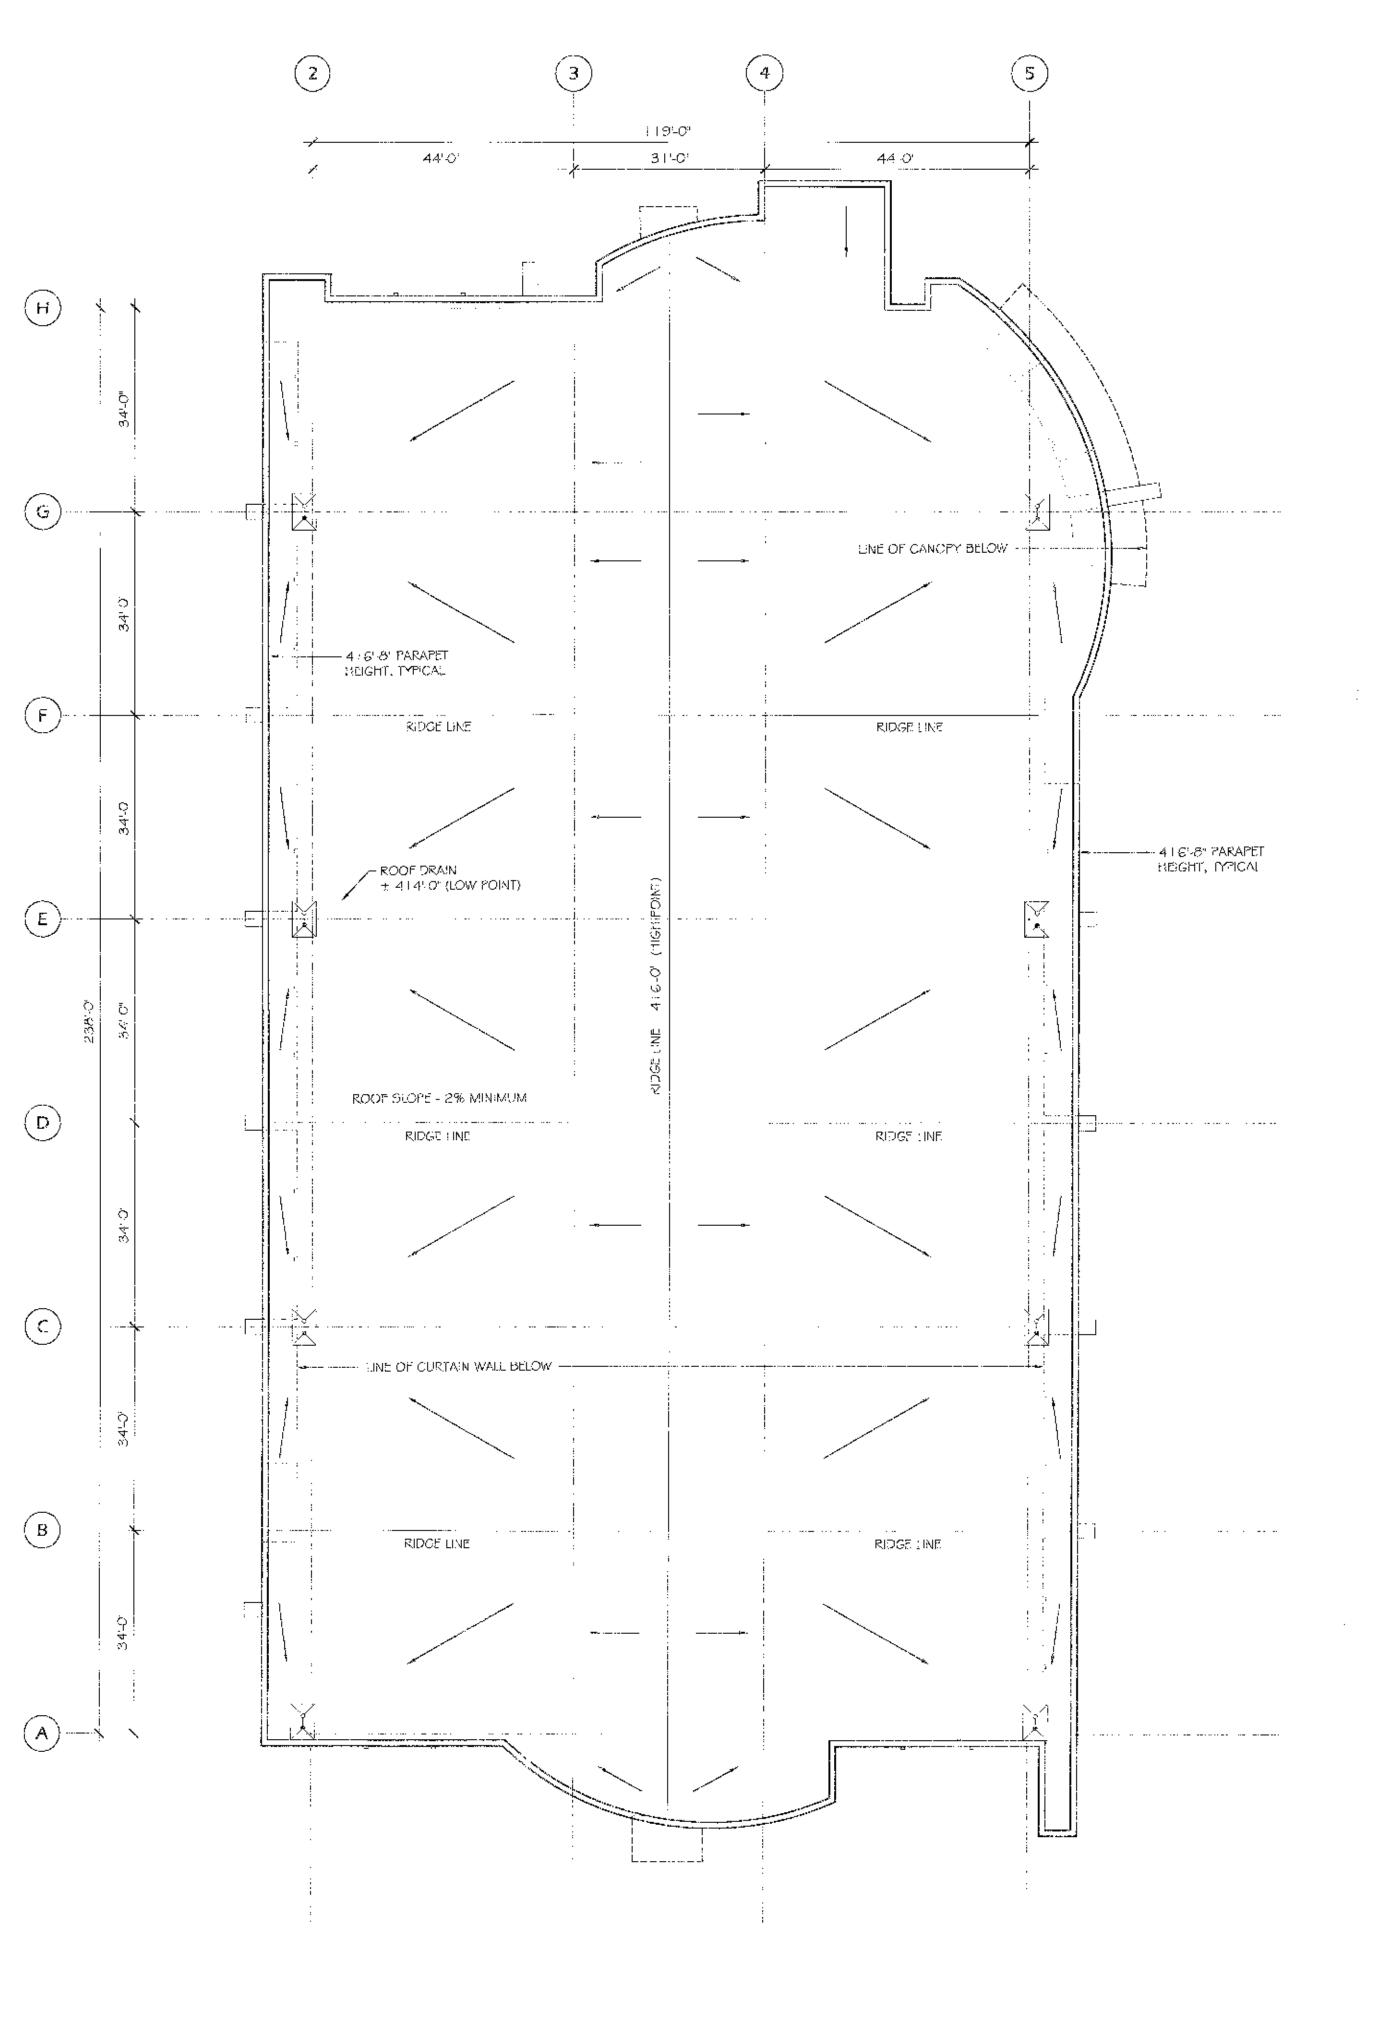


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ROOF PLAN SCALE: 1/16" = 1'-0"

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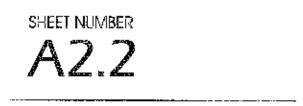
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APPROVED EXHIBIT A APTINEMAL NOVO 5844 SIGNATURE

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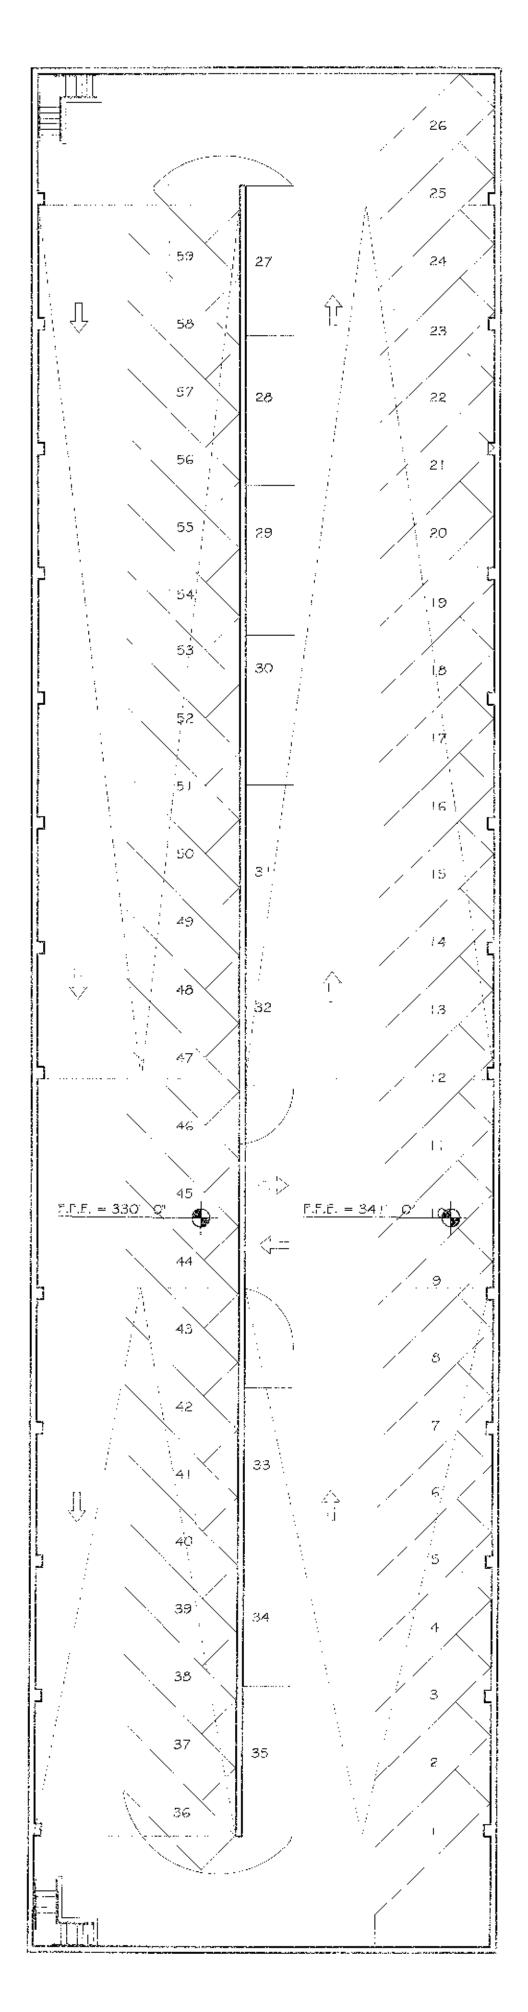
09:09:05 05-20:05 04:01:05 11:12:04 01:13:03 32:16:02 COMPLETE Oale Issued	RESUBMITTAL RESUBMITTAL RESUBMITTAL RESUBMITTAL FULL SUBMITTAL INESS SUBMITTAL RECISON
Project No.	04-114-04
ALEXAN	DRIA.
TORREY I SCIENCE LOT 12	
10996 TORREYAN/ SAN DIEGO, CA 92 COP / SDP SUBMITTA	2121
Revision 5: Revision 4 Revision 3: Revision 2: 04-01-05 Revision 1: 11-12-04 Orig. Date:IANUARY	······
Sheet <u>14</u> of <u>20</u> DEP. No.	<u> </u>
SHEET TITLE	
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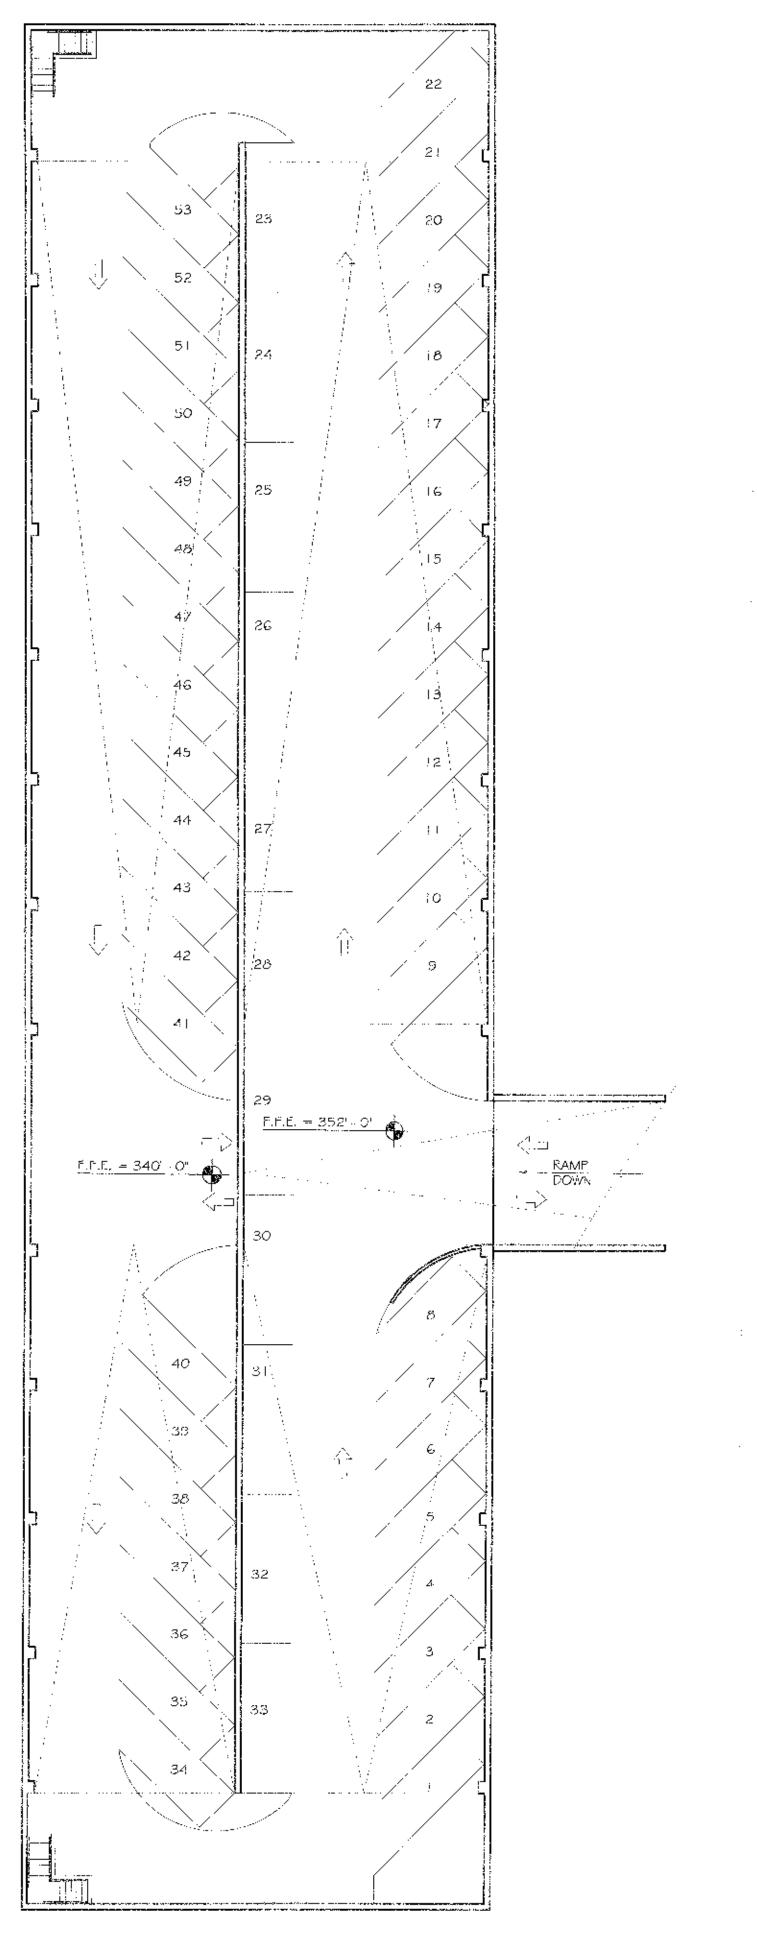
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SCALE: 1/16" = 1'-0"







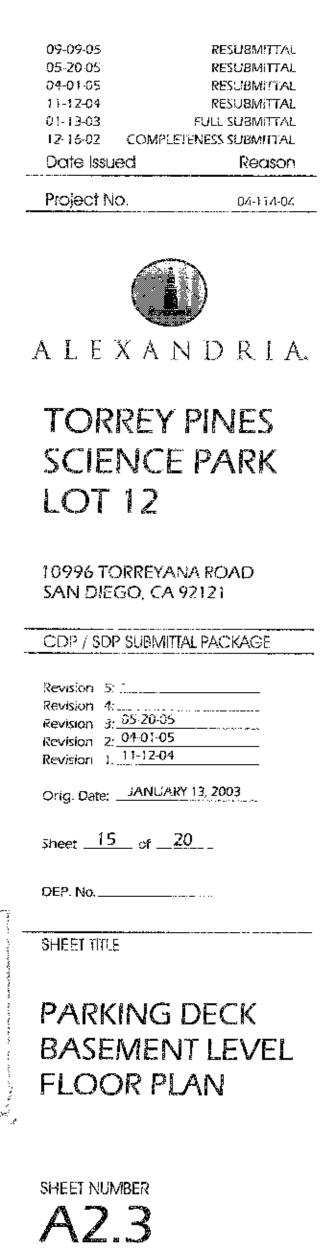


PARKING DECK BASEMENT LEVEL ONE FLOOR PLAN SCALE: 1/16" = 1'-0"



APPROVED EXHIBIT 'A' PROJECT NO. 58444 CDP 7828 APPAOVAL NOND SDP 7829 APPENENCE SIGHEARING OFFICER, HANNING COMPRESSION AND AN 3/15/06 SHOWATURE AM AU





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		EAST ELI SCALE: 1/16" = 1	

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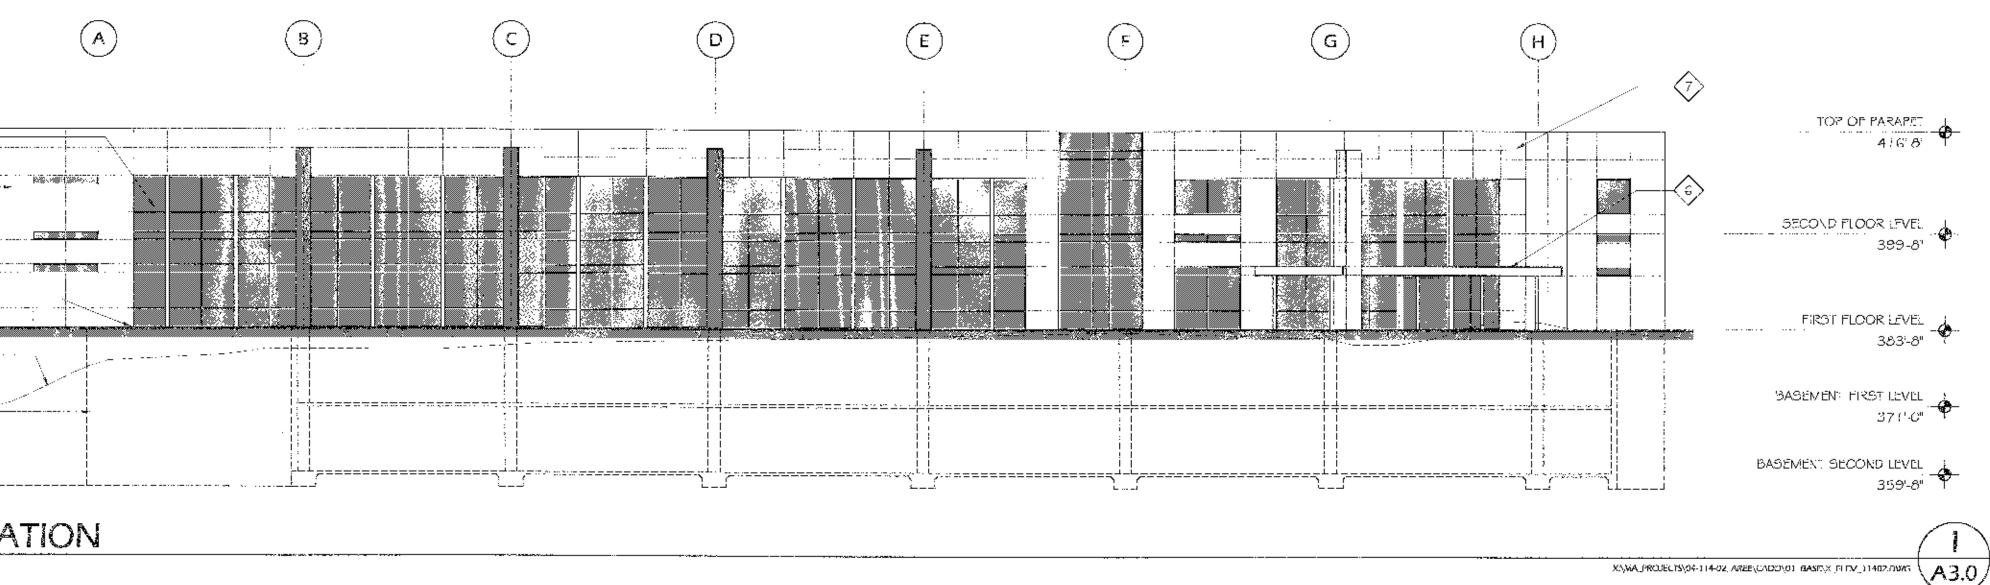
SCALE:	1/10	5" = 1	'-0"

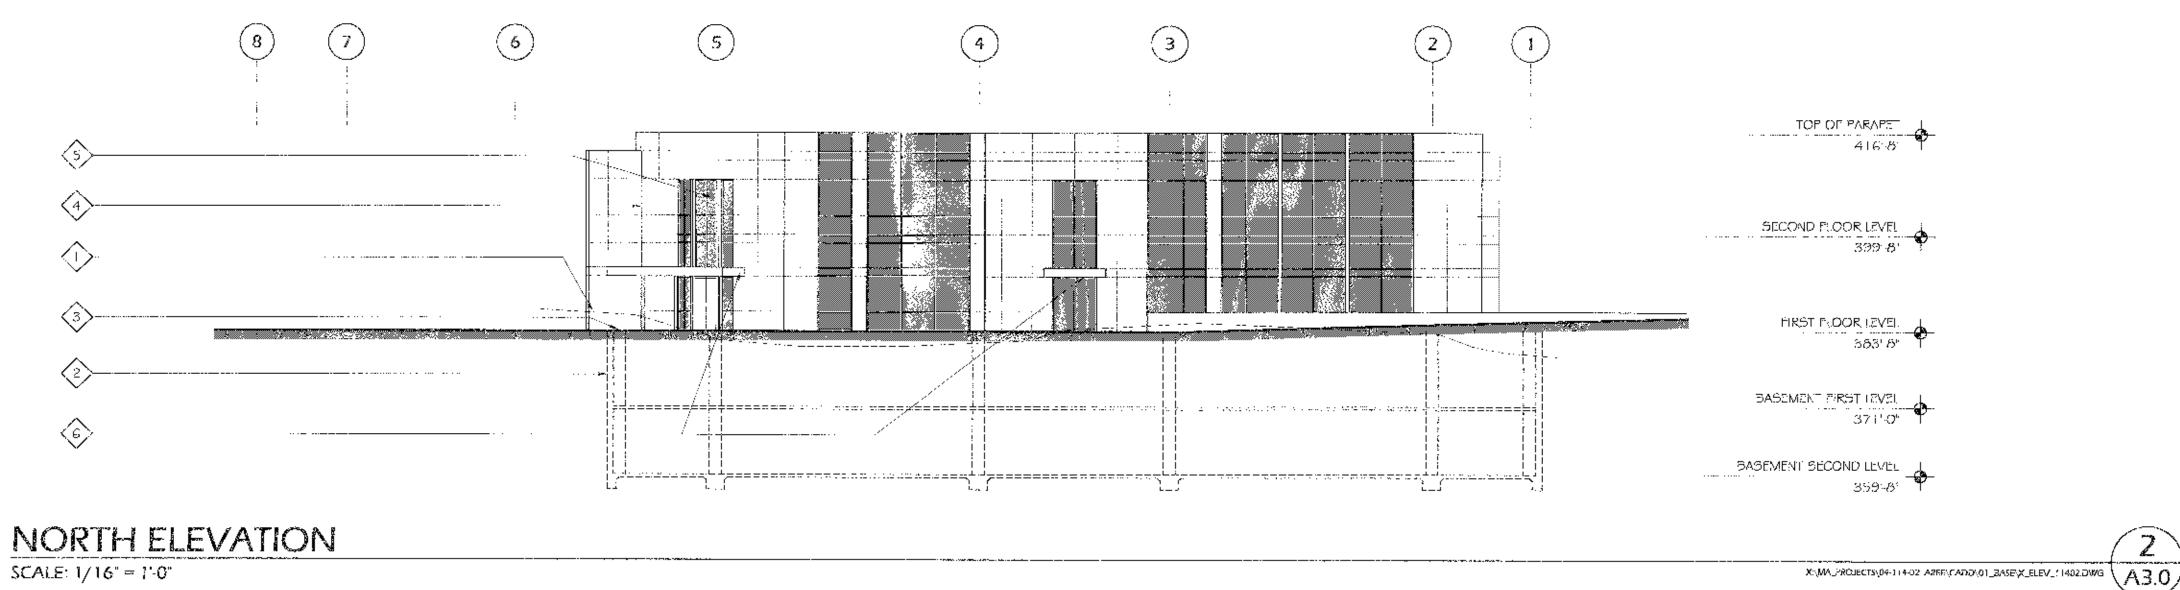
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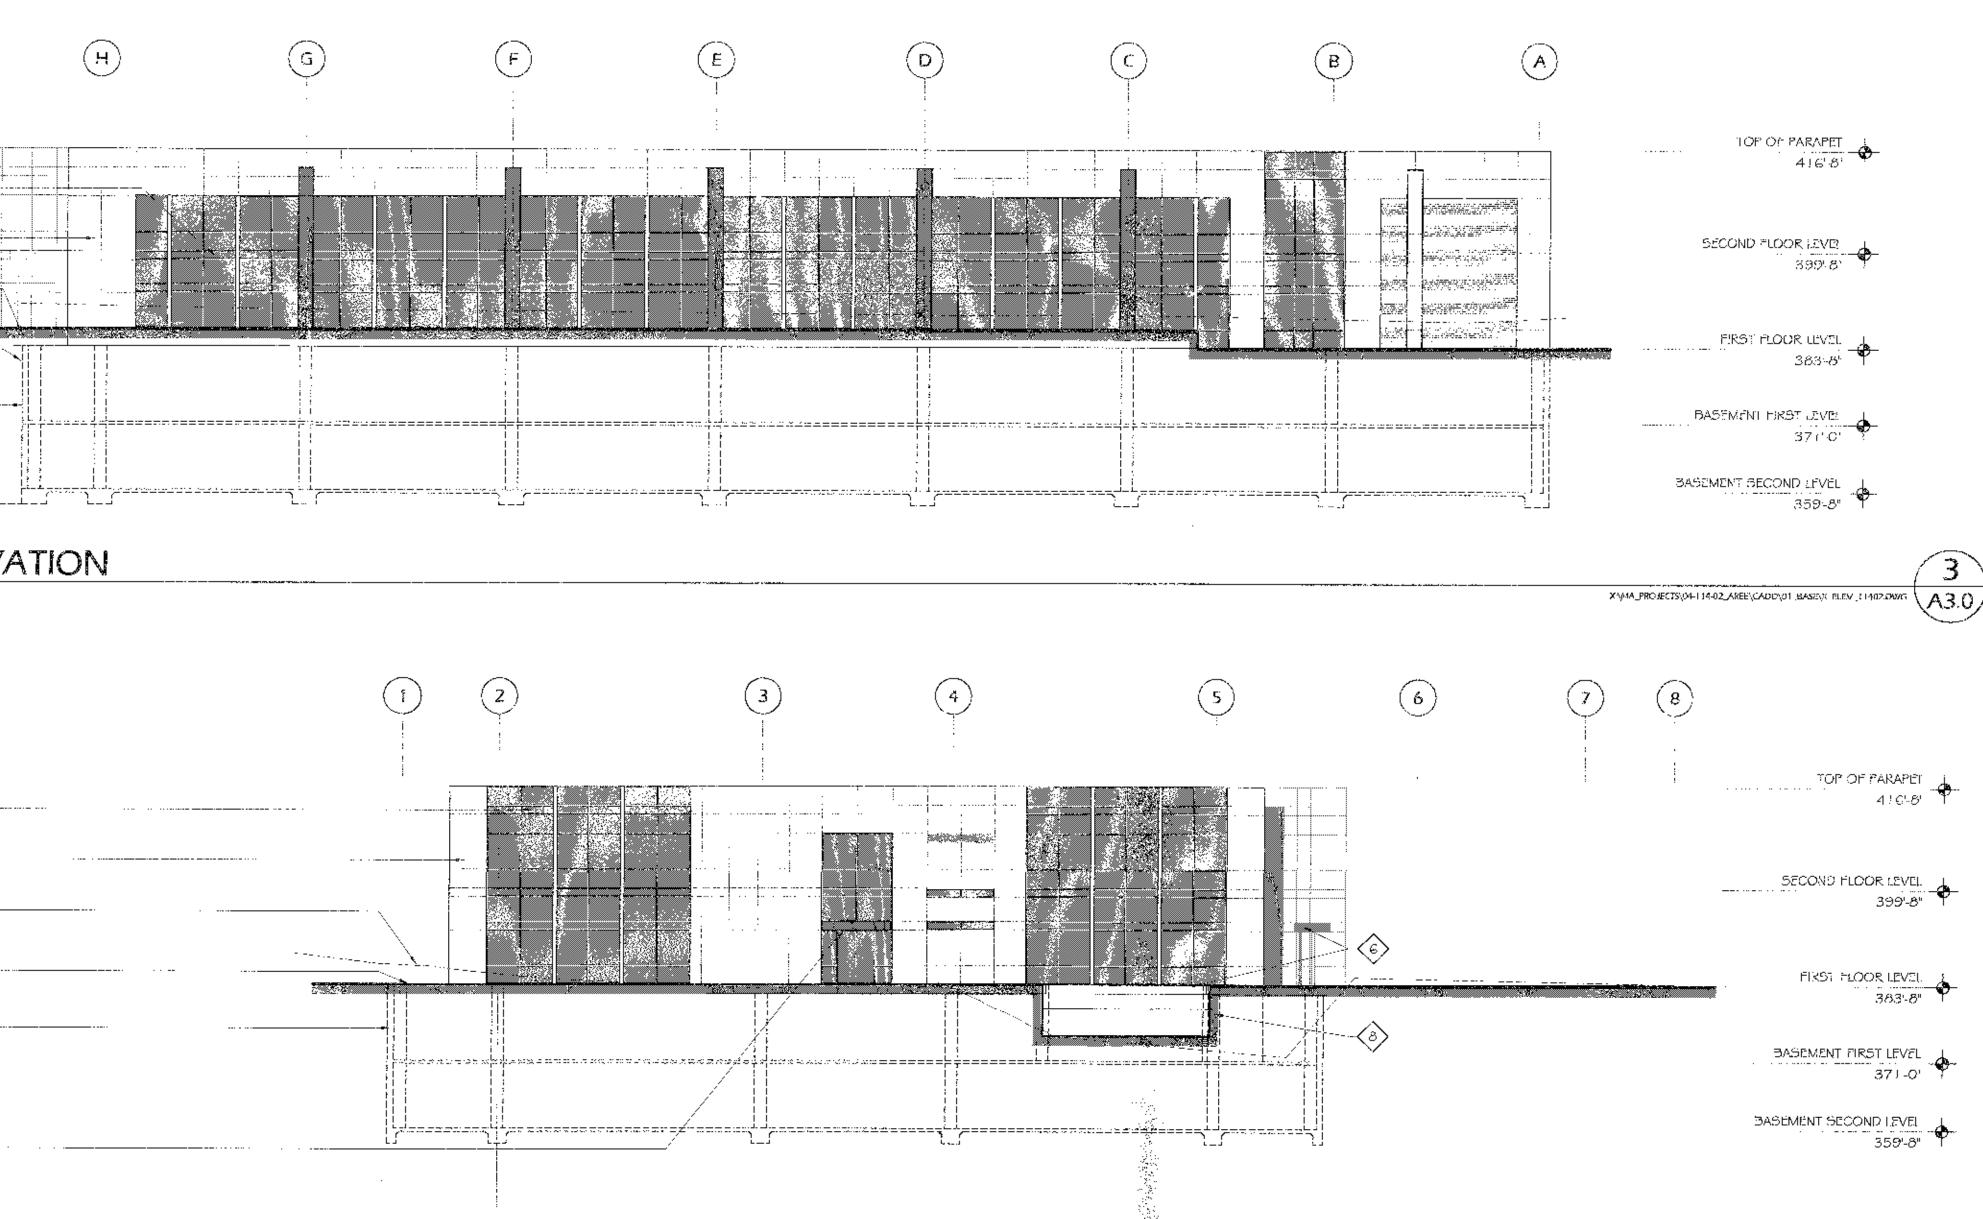
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SCALE: 1/16	o" ≕ †′	0"

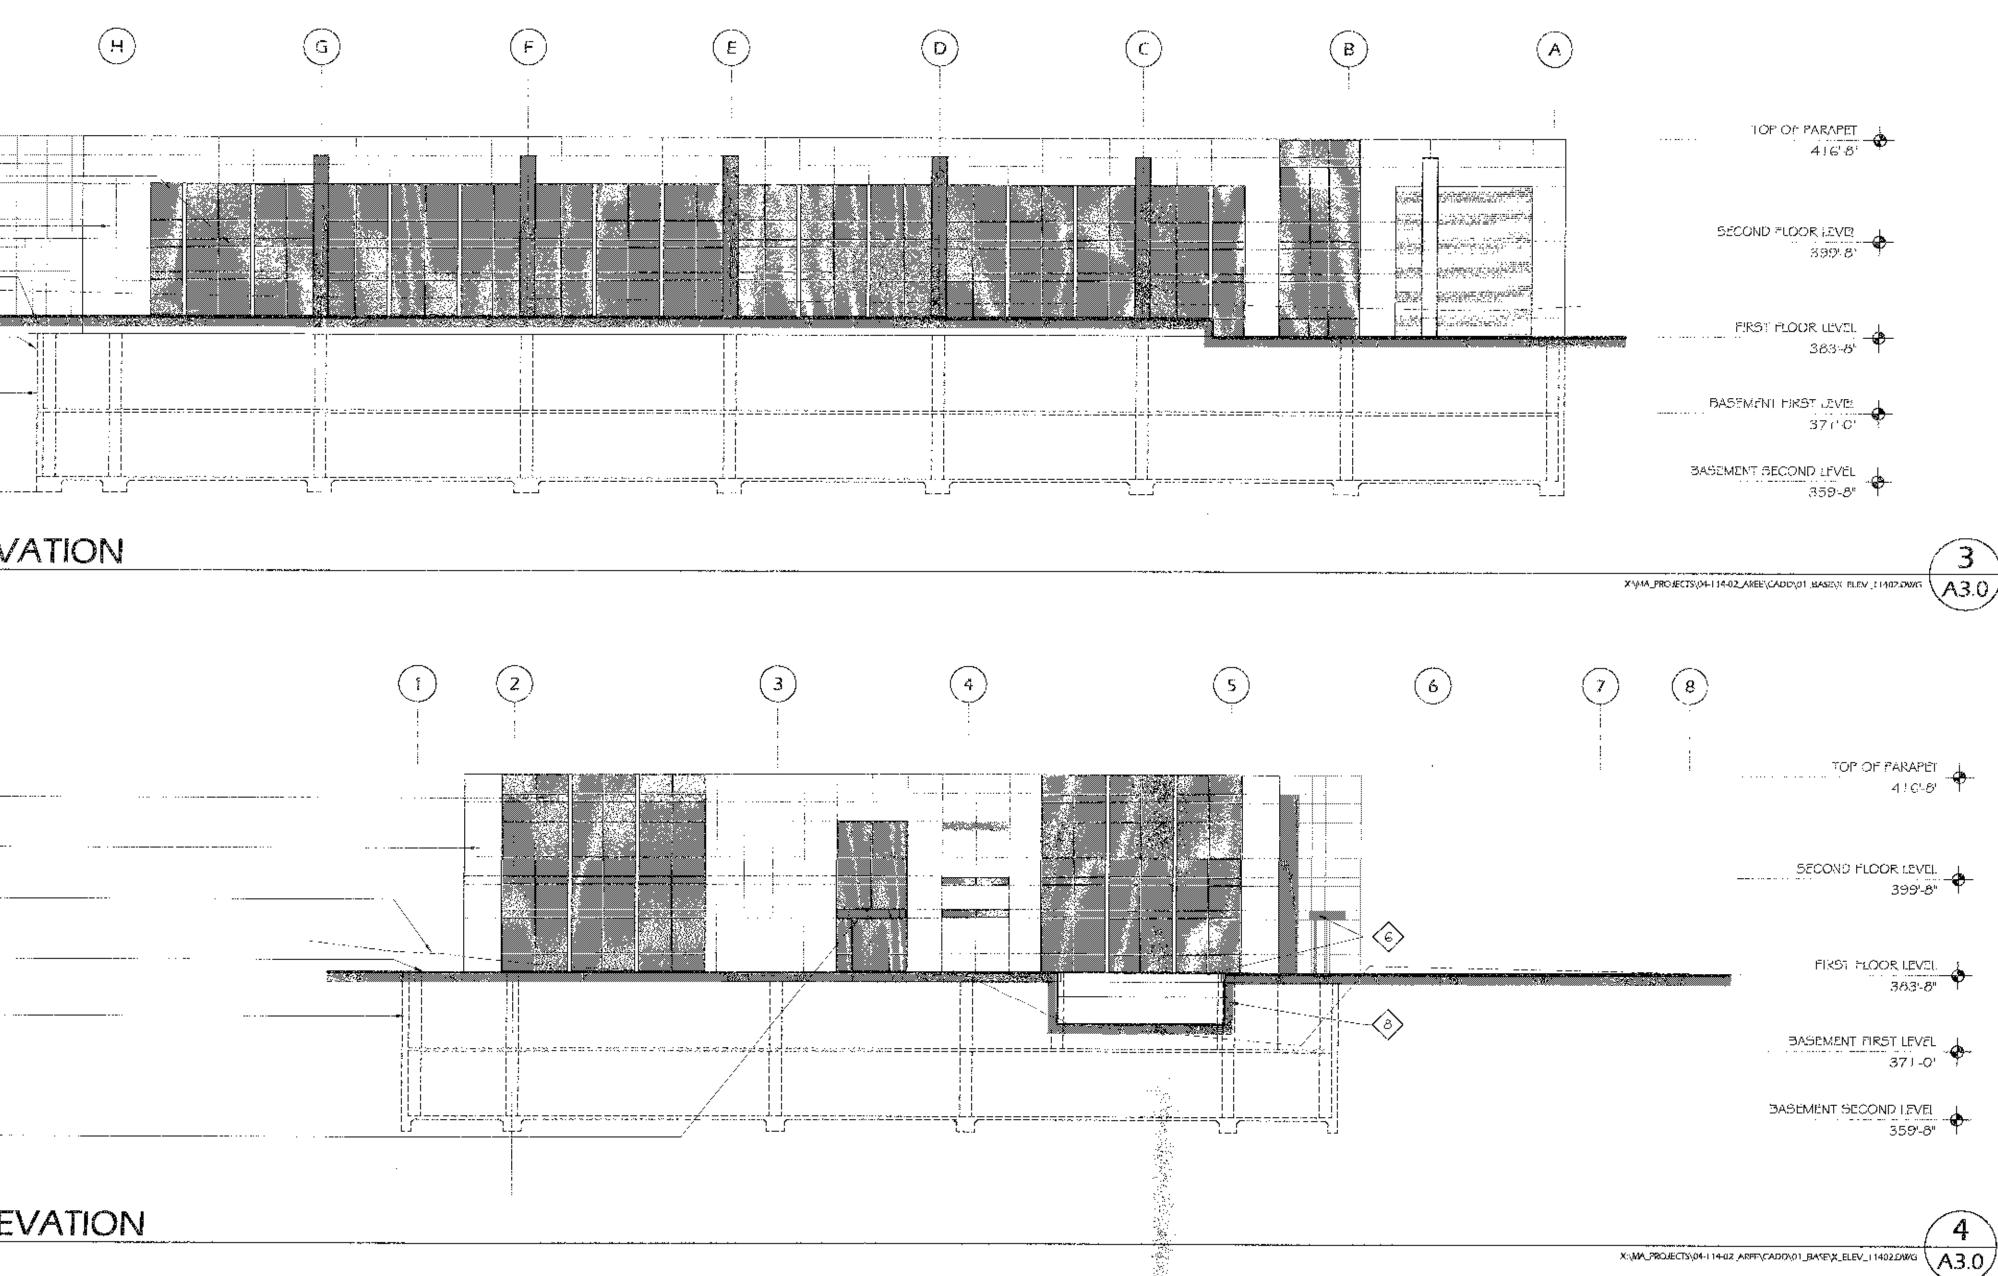
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SOUTH ELEVATION SCALE: 1/16" = 1'-0"









GENERAL NOTE ATTACHMEN

- BUILDING SIGNAGE TO CONFORM TO THE REQUIREMENTS OF THE MUNICIPAL CODE.
- 2. SEP SHEET AT 2 FOR COASTAL REGATELIMITATION COMPLIANCE TO PROPOSITION D.
- 3. MECHANICAL YARD SCREEN WALLS HAVE BEEN OMITTED FOR CLARITY OF BUILDING ELEVATIONS.
- 4. BUILDING COLOR PALETTE WILL CONSIST EARTH TONES AND SOFT GRAYS. GLAZING WILL BE TINTED, GRAY OR BLUZ, NOT MIRRORED.

KEYNOTES

- $\langle \cdot
 angle$ APPROXIMATE LIVE OF EXISTING GRADE .
- (2) LINE OF BASEMENT BELOW GRADE
- (3) APPROXIMATE LINE OF NEW GRADE
- 4 GLASS FIBER REINFORCED CONCRETE (GFRC) OR EXTERIOR CEMENT PLASTER OR SCONE TILE OR METAL PANELS. 5 GLAZING

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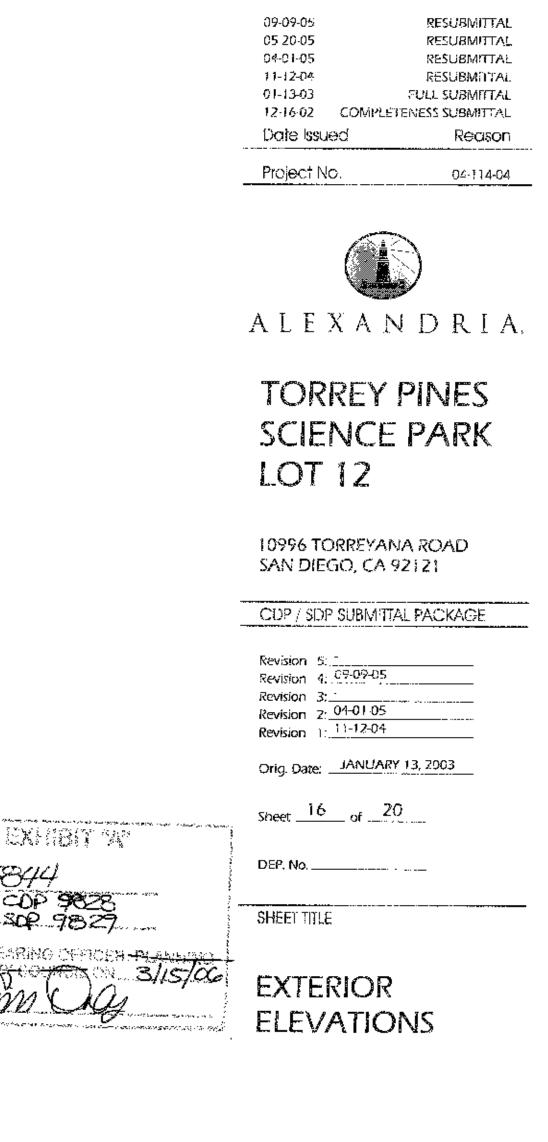
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- (G) CANOPY (50% SOLID SURFACE)
- 7 BUILDING SIGNAGE (100 S.F. MAXIMUM PER CHAPTER 14. SAN DIEGO, MUNICIPAL CODE) COLOR TO BE SELECTED BY ARCHITECT 8 RETAINING WALL

APPROVED EXHIBIT OF
PROJECT NO. 5844
COP 9028
APPROVED BY HEARING OFFICER PLANE COMMISSION, JAY CONTRACT, CN. 3/15
STONATURE CAM QQ





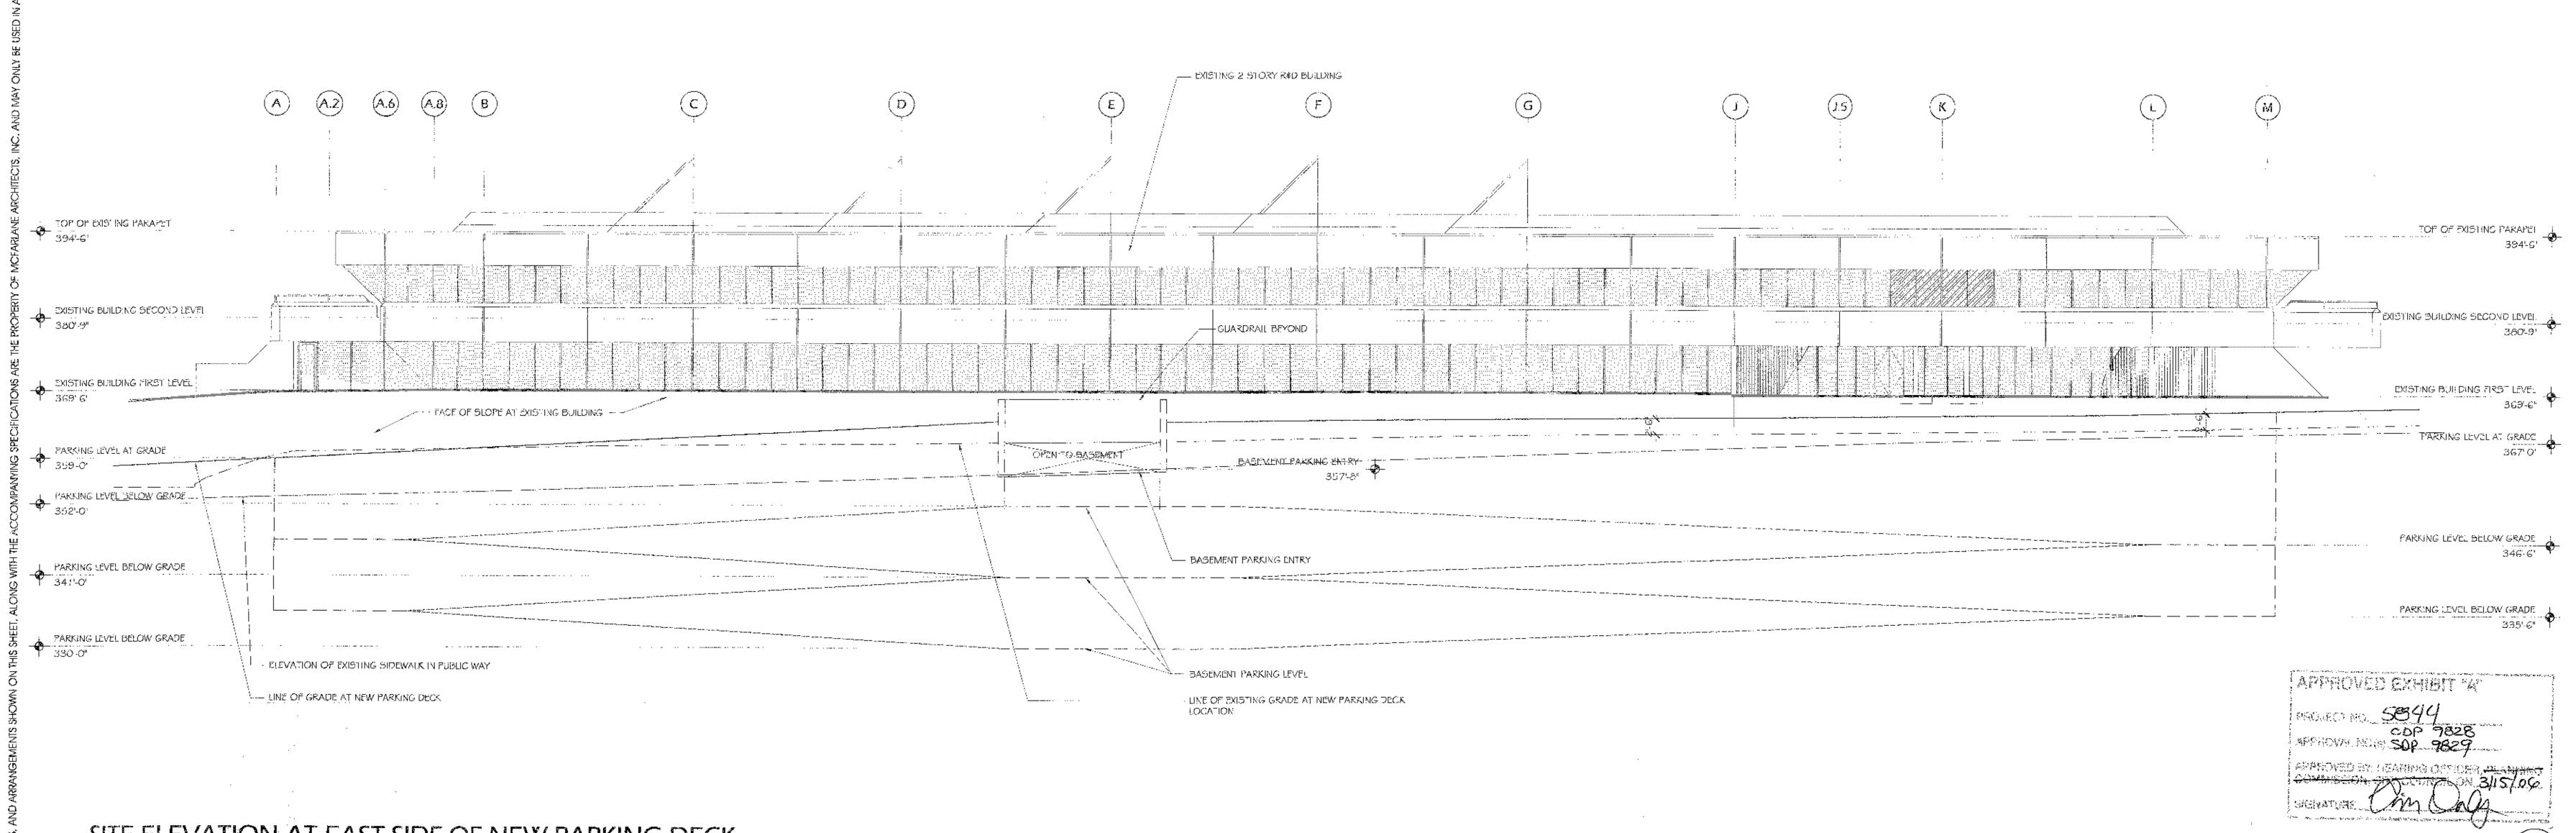




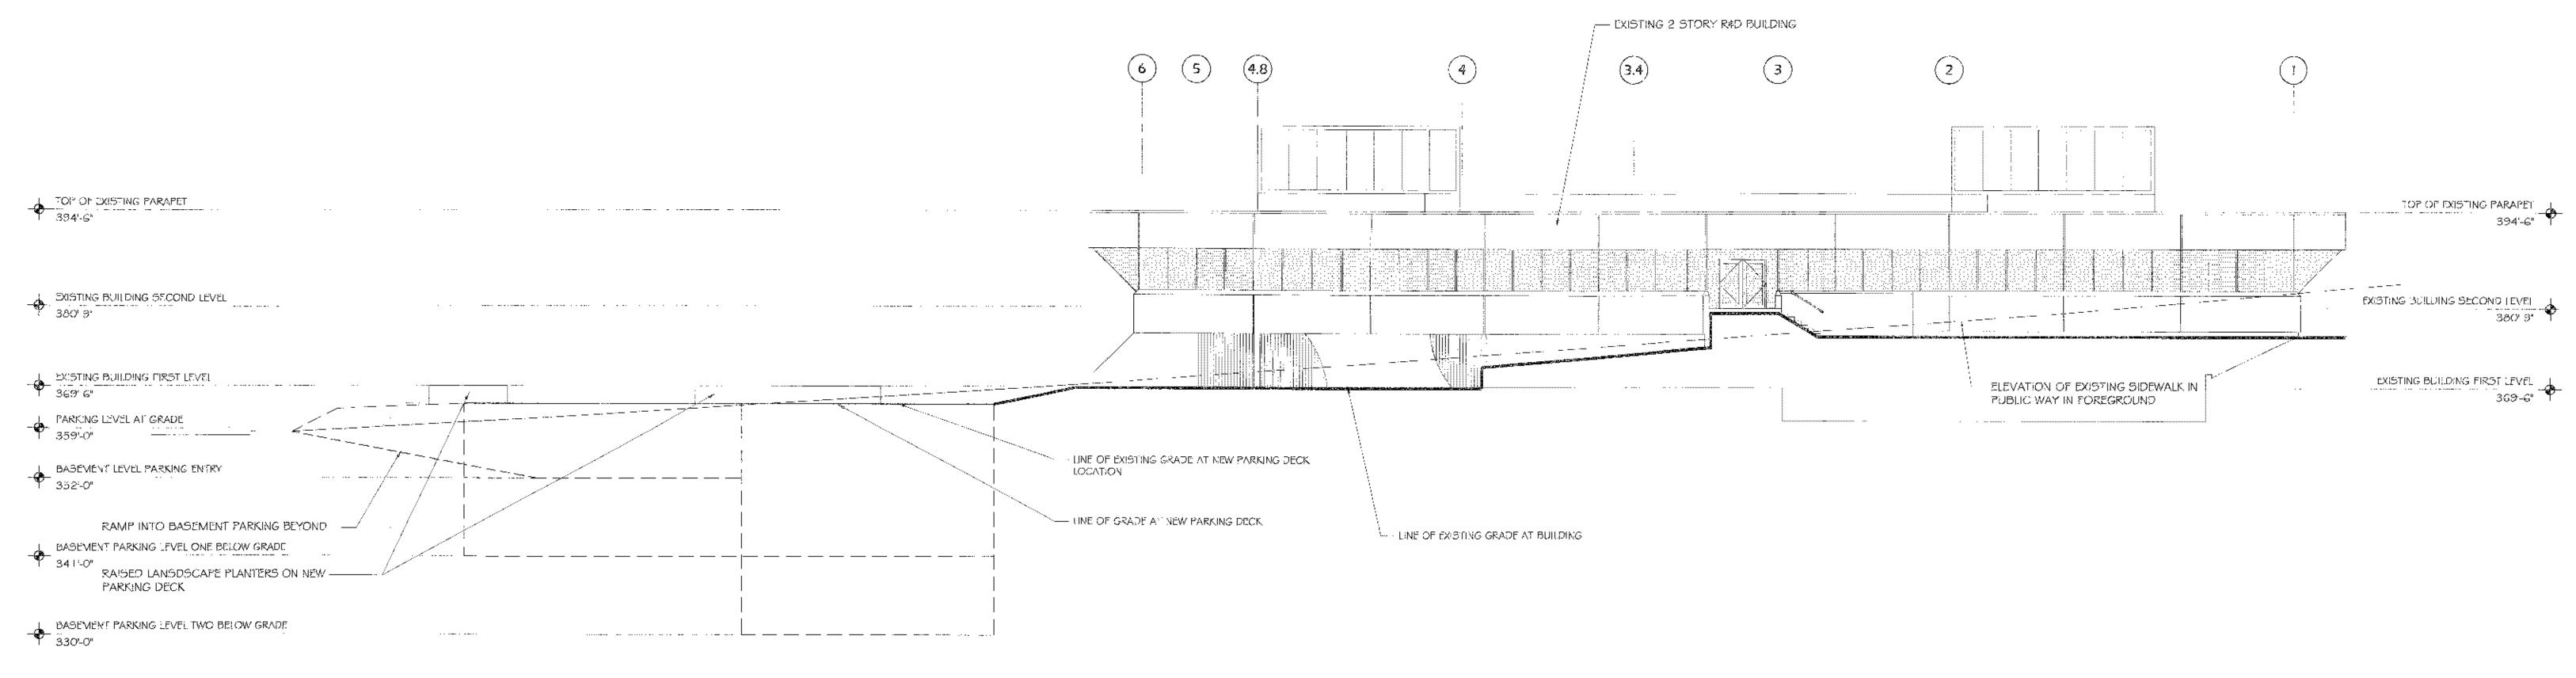
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SITE ELEVATION AT NORTH END OF NEW PARKING DECK SCALE: 3/32" = 1'-0"



X:\VA_PROJECTS\04-114-02_AKEE\CADD\01_BASIE\X_FLEY_AREE EXISTING-NORTH-WITH NEW TOPOLDWG AB. 1



09-09-05 RESUBMITTAL 05-20 05 RESUBMITTAL 04-01-05 RESUBMITIAL 11-12-04 RESUBMITTAL 01-13-03 FULL SUBMITTAL 1Z-16-02 COMPLETENESS SUBMITTAL Date Issued Reason _____ Project No. 04-114-04 _____ ALEXANDRIA. TORREY PINES SCIENCE PARK LOT 12 10996 TORREYANA ROAD SAN DIEGO, CA 92121 CDP / SDP SUBMITTAL PACKAGE Revision St. 7..... Revision 4: ___ kevision 4:_____ Kevision 3:<u>05-20-05</u>____ Revision 2: 04-01-05 11-12-04 Revision 1: Orig. Date: JANUARY 13, 2003 Sheet <u>17</u> of <u>20</u> DEP No. _____ SHEET TITLE GRADE ELEVATION / SECTIONS AT PARKING DECK SHEET NUMBER A3.1

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XI/MA_PROJECTS\04 T14-02_AREE\CADO\01, BASE\X I2.EV_AREF-FKISTING-FASTAUTH NEW FOPO DWG A3.1

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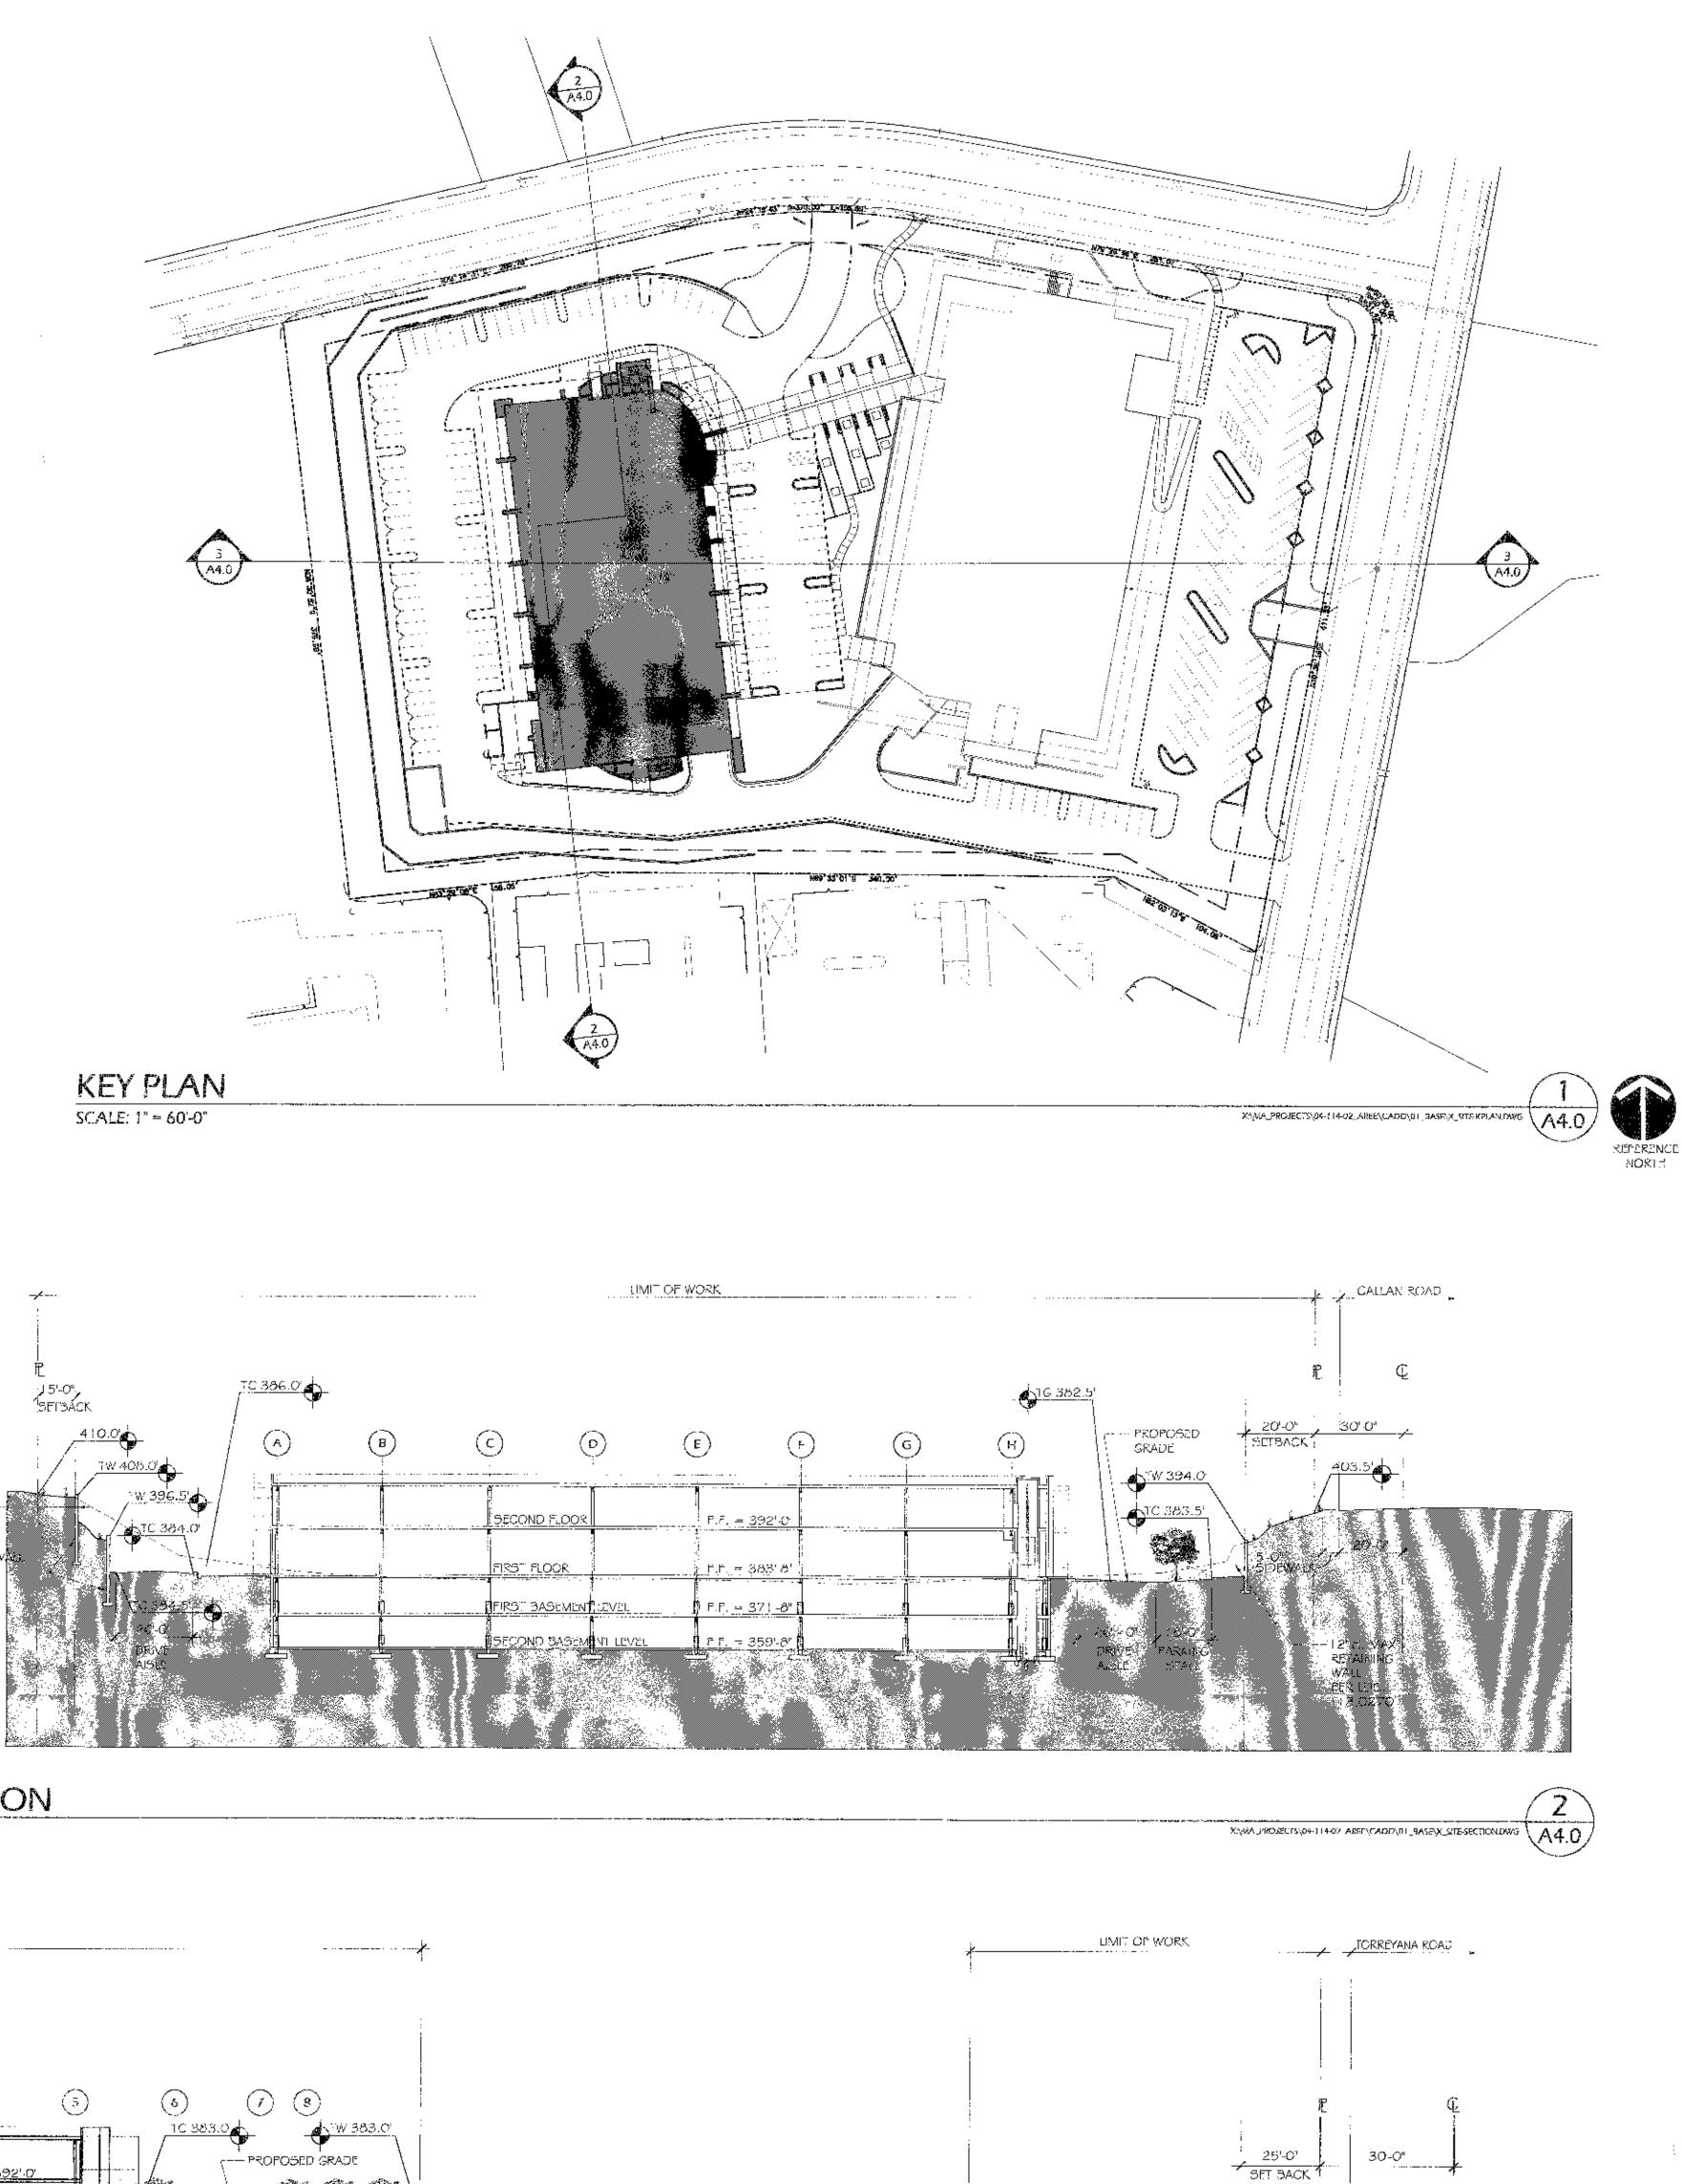
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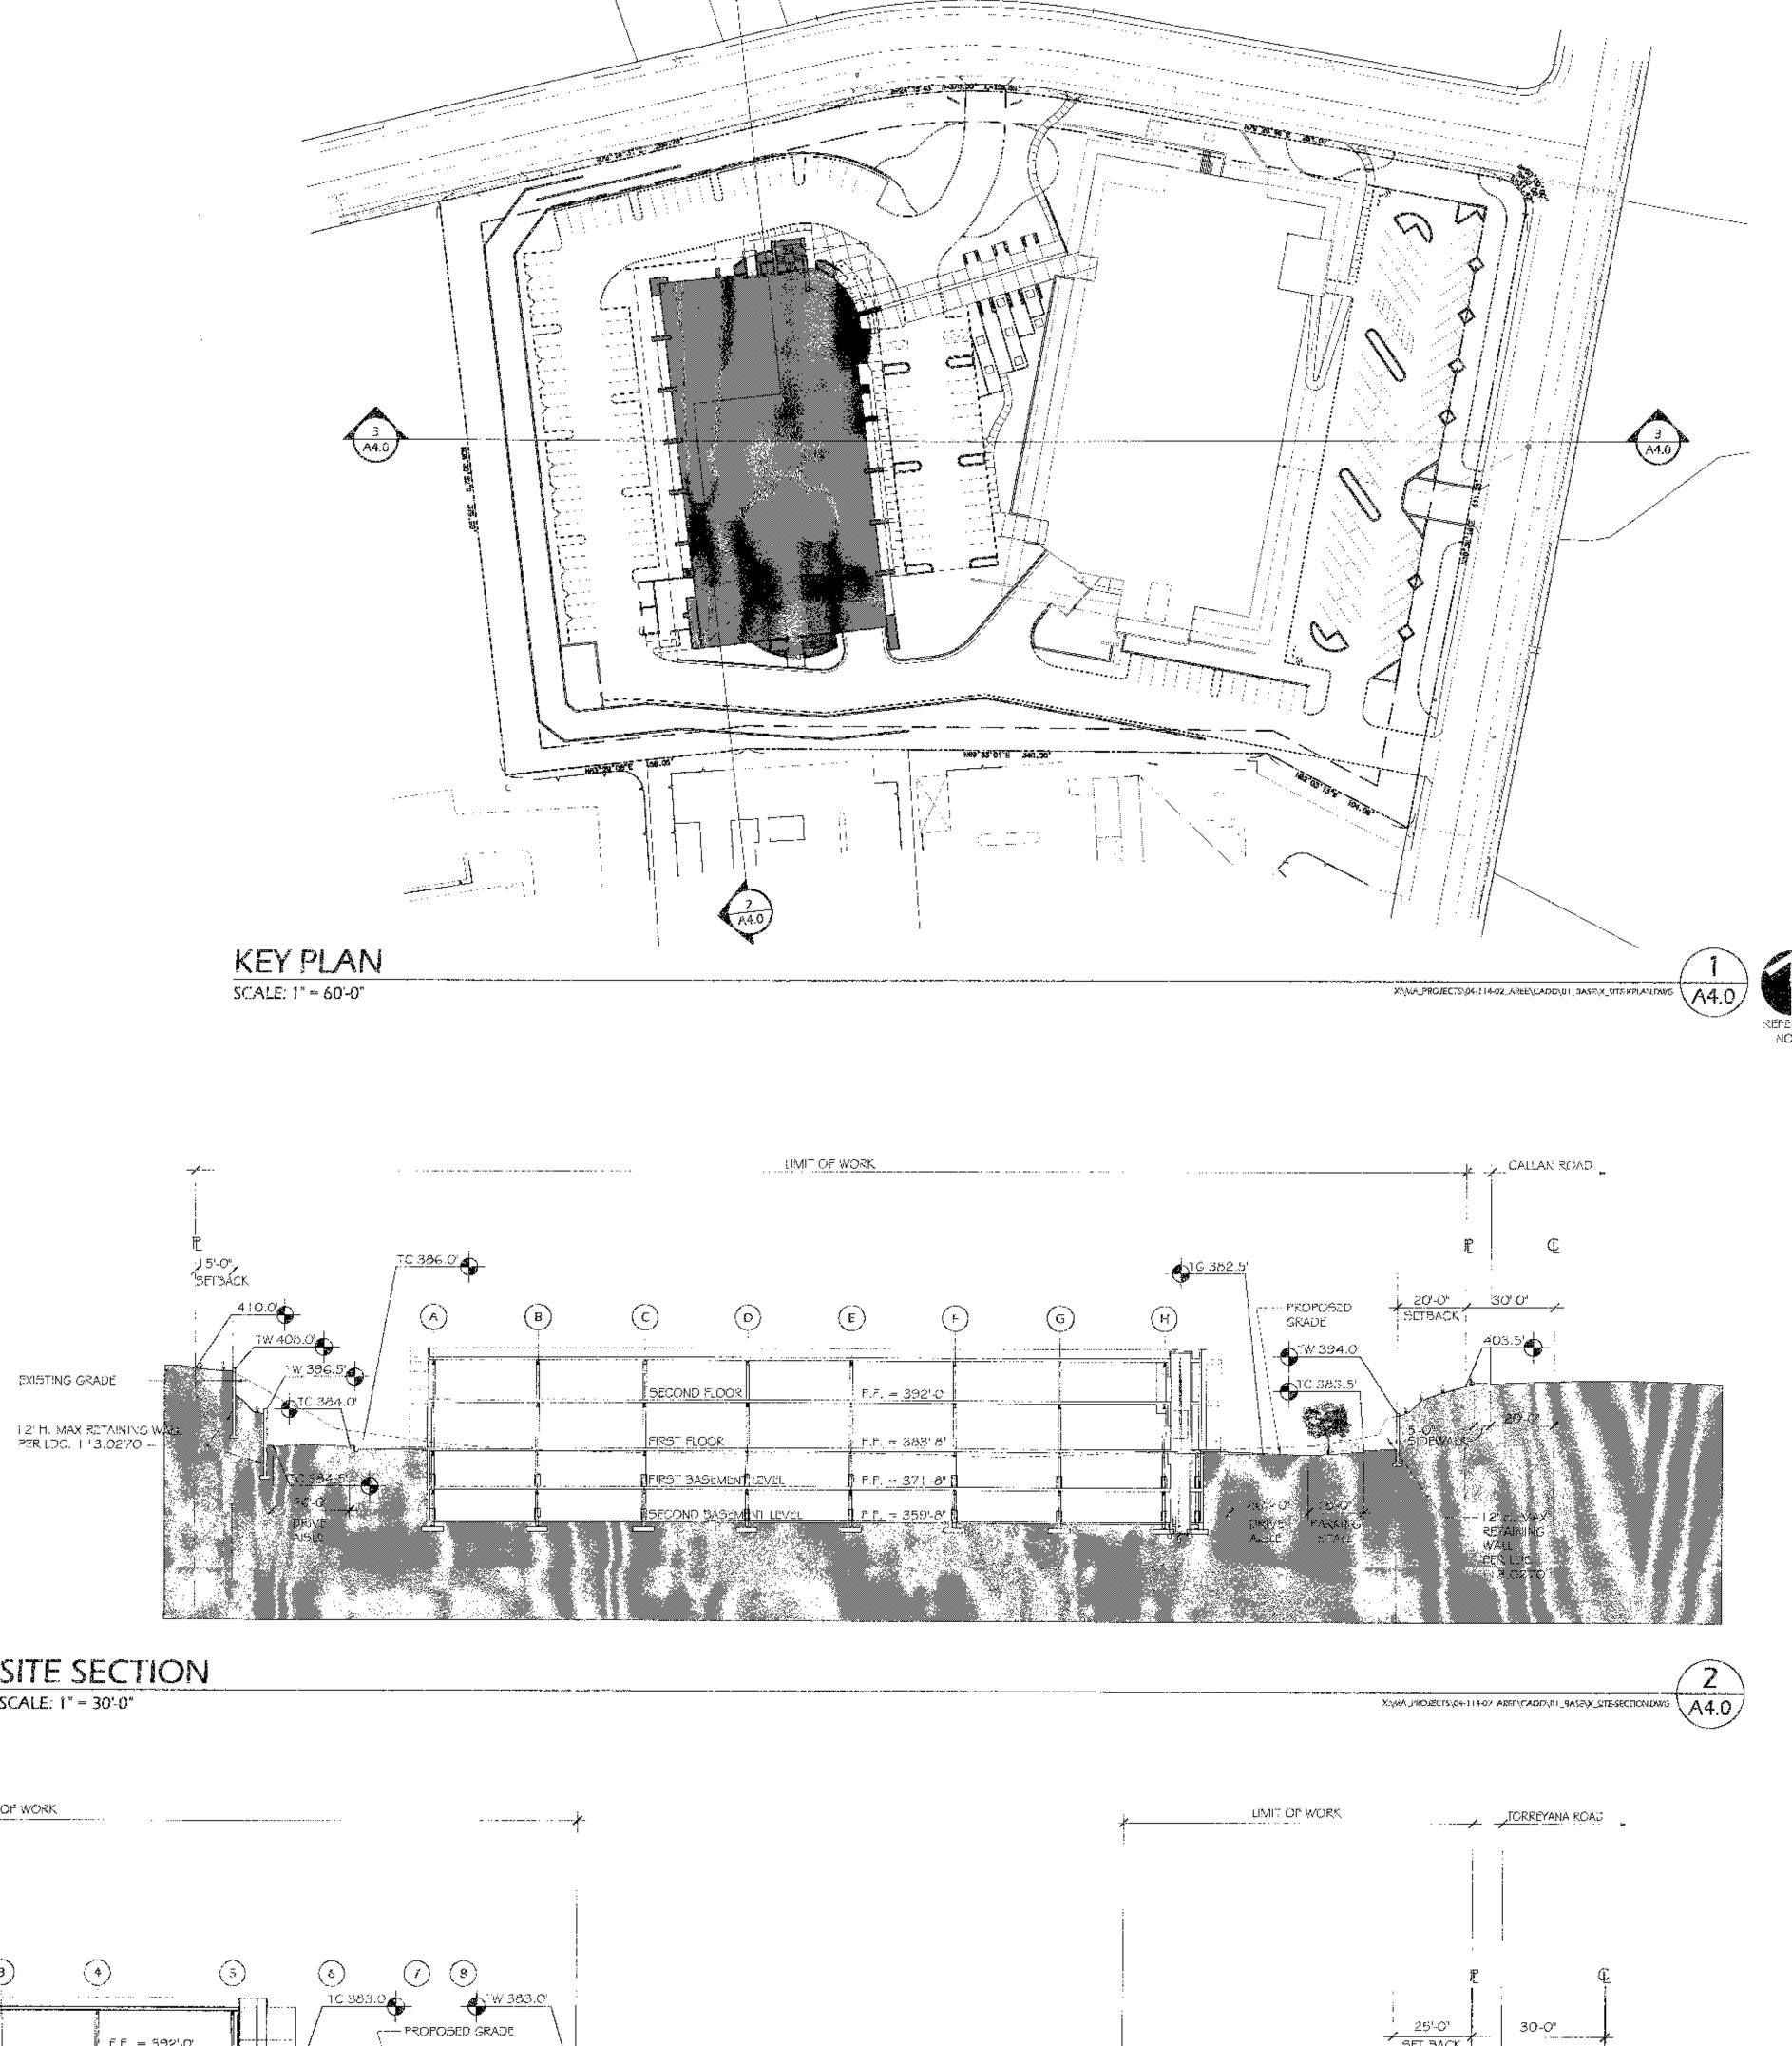
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_____ ······ 1W-423.0 25'-0" 1 SET BACK ,----EXISTING GRADE H 213, MAX RETAINING WALL PER LOC: 173,0270 TW 402.5 388.5

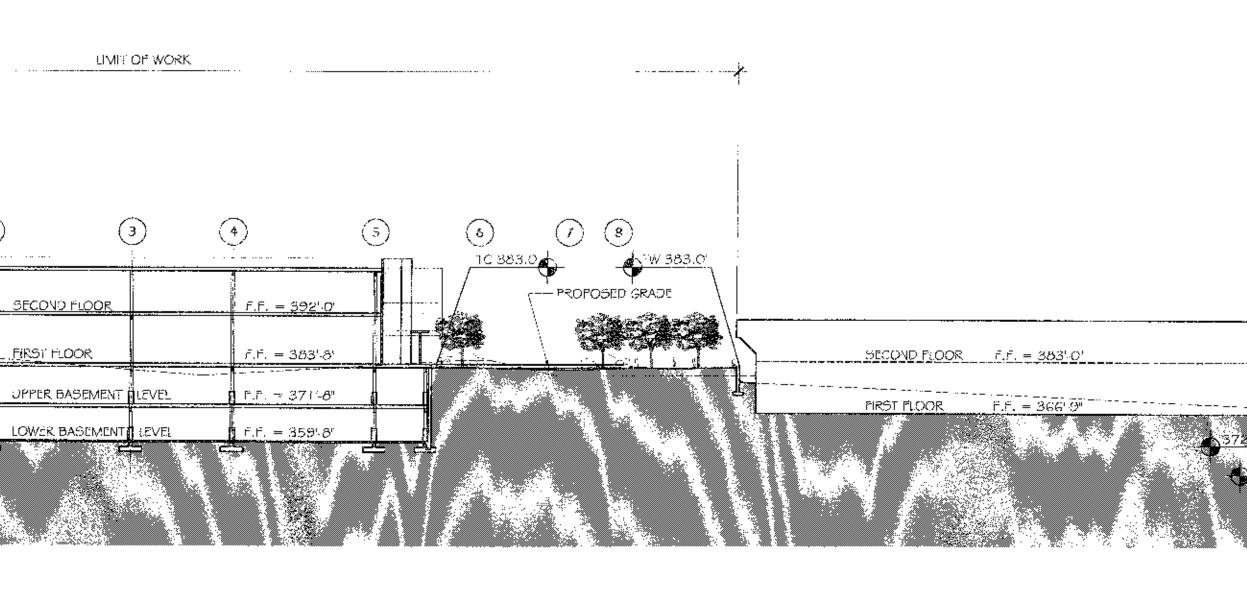
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SITE SECTION SCALE: 1" = 30'-0"





SITE SECTION SCALE: 1" = 30'-0"



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6844 600 9828 APPROVAL INCRUS 500 7829 APPROVED BY ASABURU DEFICER DUALTHES COLORISSION OF COULCE ON 3115706 SIGNATURE MALLAG era meranda 📢 ar ber andara a juene je za era والمجاجعة والمتعادية والمراجع والمراكل

5'-0" SIDEWALK;

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BASEMENT LEVEL - EL VARIES

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XIMA PROJECTS(04-114-02_AREE\CADD\02_BASE\X_SITE-SECTION/DWG A4.0/

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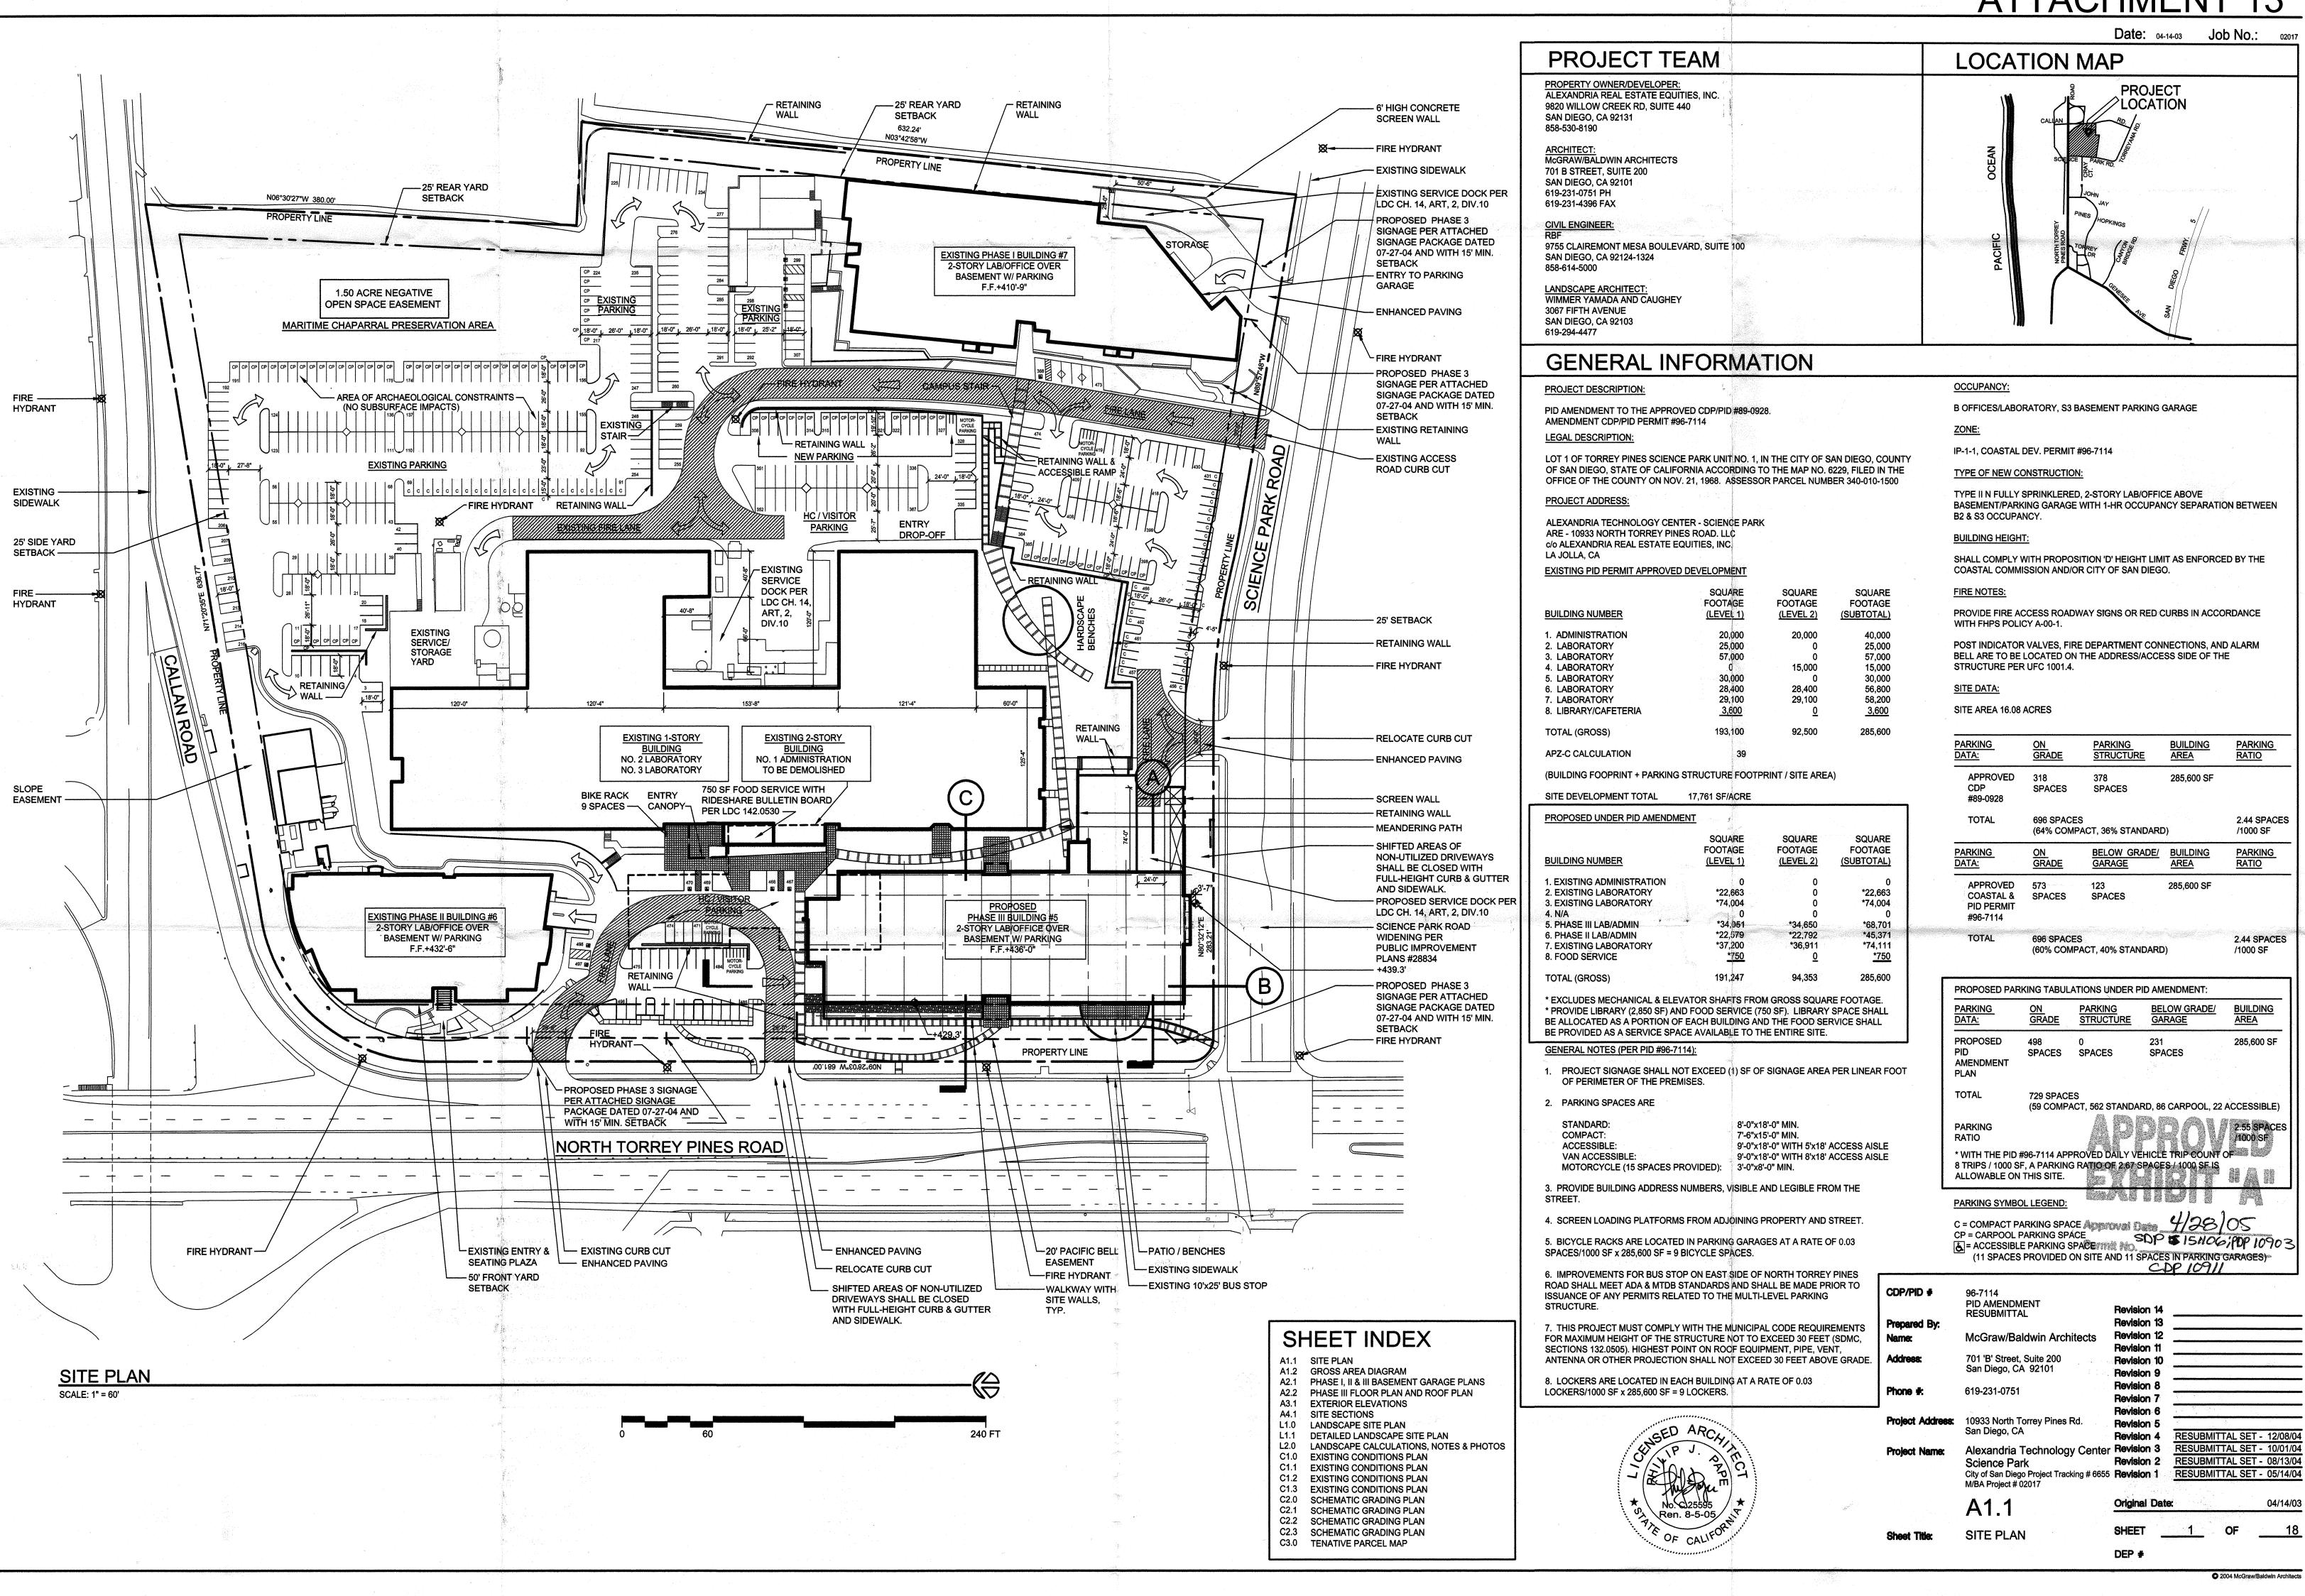
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09-09-05	RESUBMITTAL			
05-20-05	RESUBMITTAL			
04-01-05	RESUBMITTAL			
11-12-04	RESUBMITTAL			
01-13-03	FULL SUBMICIAL			
12-16-02 COMP	LETENESS SUBMITTAL			
Date Issued	Reason			
Project No.	04-114-04			
ALEAA	N D R I A.			
TORREY	' PINES			
SCIENC	CDADV			
JCHE!VC				
LOT 12				
Hanna "Angel" - M. Kinger				
10996 TORREY/	ANA ROAD			
SAN DIEGO, CA	192121			
CDP / SDP SUBMI	HAL PACKAGE			
Revision 5:				
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Revision 2: 04-01-0	5			
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Orig. Date:JANU/	ARY 13, 2003			
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SHEET TITLE	••••••••••••••••••••••••••••••••••••••			
Sheet 18 of DEP. No SHEET TITLE PROJECT				
PROJECT	CROSS			
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	ing gal			

SHEET NUMBER A4.0



ATTACHMENT 13

SQUARE FOOTAGE (LEVEL 1)	SQUARE FOOTAGE (LEVEL 2)	SQUARE FOOTAGE (SUBTOTAL)
20,000	20,000	40,000
25,000	0	25,000
57,000	0	57,000
ď	15.000	15,000
30.000	0	30,000
	28,400	56,800
		58,200
3,600	<u>0</u>	3,600
193,100	92,500	285,600
	FOOTAGE (LEVEL 1) 20,000 25,000 57,000 0 30,000 28,400 29,100 <u>3,600</u>	FOOTAGE (LEVEL 1) FOOTAGE (LEVEL 2) 20,000 20,000 25,000 0 57,000 0 0 15,000 30,000 0 28,400 28,400 29,100 3,600 0

INDER PID AMENDME	<u>INT</u>			
MBER	SQUARE FOOTAGE <u>(LEVEL 1)</u>	SQUARE FOOTAGE <u>(LEVEL 2)</u>	SQUARE FOOTAGE (SUBTOTAL)	
DMINISTRATION	0	0	0	
ABORATORY	*22,663	0	*22,663	
ABORATORY	*74,004	0	*74,004	
경험이 있는 것은 동물을 받았다.	0	0	0	
AB/ADMIN	* *34,051	*34.650	*68,701	
AB/ADMIN	*22,579	*22,792	*45,371	
ABORATORY	*37,200	*36,911	*74,111	
VICE	<u>*750</u>	<u>0</u>	*750	
26)	101 947	04 353	285 600	

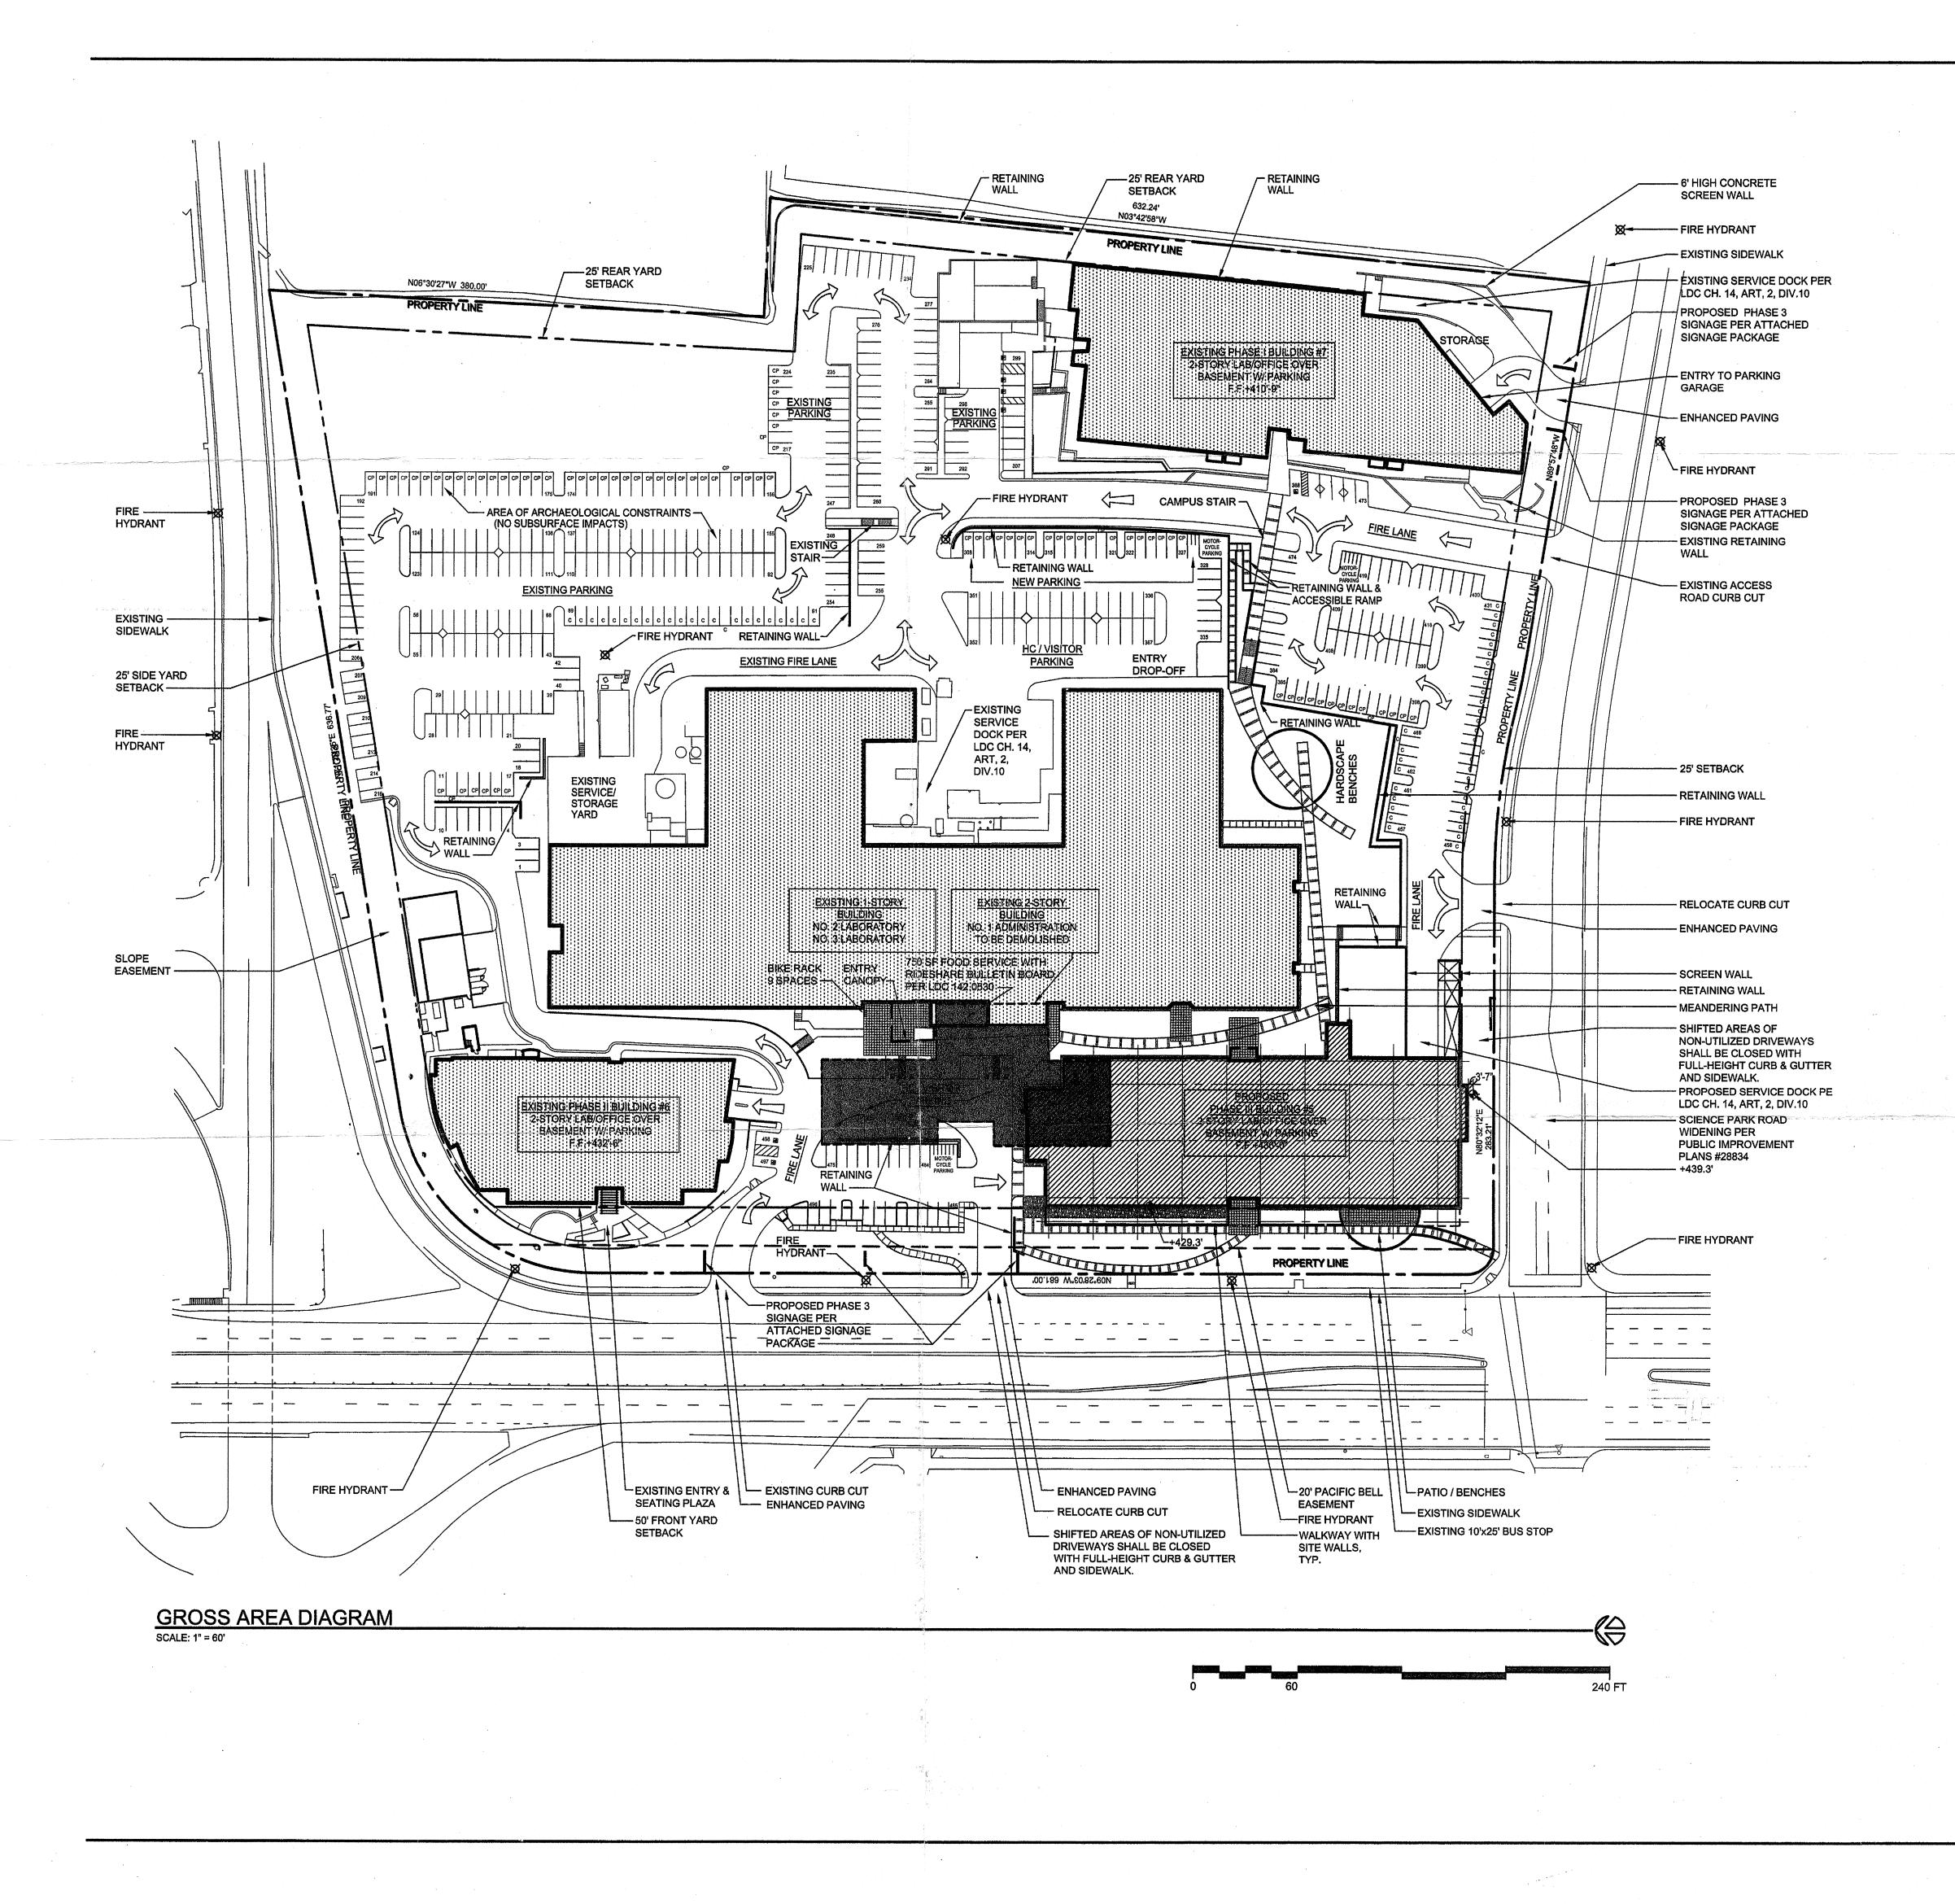
SPACE	S	ARE	

RD:	8'-0"x18'-0" MIN.
T:	7'-6"x15'-0" MIN.
BLE:	9'-0"x18'-0" WITH 5'x18' ACCESS AISLE
ESSIBLE:	9'-0"x18'-0" WITH 8'x18' ACCESS AISLE
YCLE (15 SPACES PROVIDED):	3'-0"x8'-0" MIN.

			· · ·	
PARKING DATA:	ON GRADE	PARKING STRUCTURE	BUILDING AREA	PARKING RATIO
APPROVED CDP #89-0928	318 SPACES	378 SPACES	285,600 SF	· · · · · · · · · · · · · · · · · · ·
TOTAL	696 SPACES (64% COMPAC	CT, 36% STANDARD))))))))))))))))))))))))))))))))))))))	2.44 SPACES /1000 SF
PARKING DATA:	ON GRADE	BELOW GRADE/ GARAGE	BUILDING AREA	PARKING RATIO
APPROVED COASTAL & PID PERMIT #96-7114	573 SPACES	123 SPACES	285,600 SF	
TOTAL	696 SPACES (60% COMPAC	CT, 40% STANDARD))	2.44 SPACES /1000 SF

PROPOSED PAR	KING TABUL	ATIONS UNDER	PID AMENDMENT:	
PARKING DATA:	ON GRADE	PARKING STRUCTURE	BELOW GRADE/ GARAGE	BUILDING AREA
PROPOSED PID AMENDMENT PLAN	498 SPACES	0 SPACES	231 SPACES	285,600 SF
TOTAL	729 SPACE (59 COMPA		ARD, 86 CARPOOL, 2	22 ACCESSIBLE)
PARKING RATIO			PROI	2:55 SPACES /1000 SF
	F, A PARKING		'EHICLE TRIP COUN SPACES / 1000 SF IS	
PARKING SYMBO	DL LEGEND:			6-1
C = COMPACT P CP = CARPOOL F C = ACCESSIBL (11 SPACES	PARKING SP/ E PARKING S	ACE SPACE		
96-7114 PID AMENDM RESUBMITTA McGraw/Ba	NL.	itects Revis	sion 14 sion 13 sion 12	
701 'B' Street, San Diego, C/		Revis	sion 11 sion 10 sion 9	
619-231-0751			sion 8	
: 10933 North T San Diego, C/		Rd. Revis	sion 6 sion 5 sion 4 RESUBMI	TTAL SET - 12/08/0

and Alexandra



ATTACHMENT 13

Date: 04-14-03 Job No.: 02017

GROSS AREA DIAGRAM LEGEND

EXISTING BUILDING

AREA OF BUILDING DEMOLITION

PROPOSED PHASE III BUILDING

EXISTING PID PERMIT APPROVED	DEVELOPMENT		
BUILDING NUMBER	SQUARE FOOTAGE (LEVEL 1)	SQUARE FOOTAGE (LEVEL 2)	SQUARE FOOTAGE <u>(SUBTOTAL)</u>
 1. ADMINISTRATION 2. LABORATORY 3. LABORATORY 4. LABORATORY 5. LABORATORY 6. LABORATORY 7. LABORATORY 8. LIBRARY/CAFETERIA 	20,000 25,000 57,000 0 30,000 28,400 29,100 <u>3,600</u>	20,000 0 15,000 0 28,400 29,100 <u>0</u>	40,000 25,000 57,000 15,000 30,000 56,800 58,200 <u>3,600</u>
TOTAL (GROSS) APZ-C CALCULATION	193,100	92,500	285,600
(BUILDING FOOPRINT + PARKIN	% IG STRUCTURE FOOT	PRINT / SITE A	REA)
SITE DEVELOPMENT TOTAL	17,761 SF/ACRE		

PROPOSED UNDER PID AMENDM	ENT		
BUILDING NUMBER	SQUARE FOOTAGE (LEVEL 1)	SQUARE FOOTAGE (LEVEL 2)	SQUARE FOOTAGE (SUBTOTAL)
1. EXISTING ADMINISTRATION 2. EXISTING LABORATORY 3. EXISTING LABORATORY 4. N/A 5. PHASE III LAB/ADMIN 6. PHASE II LAB/ADMIN 7. EXISTING LABORATORY 8. FOOD SERVICE	0 *22,663 *74,004 0 *34,051 *22,579 *37,200 <u>*750</u>	0 0 *34,650 *22,792 *36,911 <u>0</u>	0 *22,663 *74,004 0 *68,701 *45,371 *74,111 <u>*750</u>
TOTAL (GROSS)	191,247	94,353	285,600

* EXCLUDES MECHANICAL & ELEVATOR SHAFTS FROM GROSS SQUARE FOOTAGE. * PROVIDE LIBRARY (2,850 SF) AND FOOD SERVICE (750 SF). LIBRARY SPACE SHALL BE ALLOCATED AS A PORTION OF EACH BUILDING AND THE FOOD SERVICE SHALL BE PROVIDED AS A SERVICE SPACE AVAILABLE TO THE ENTIRE SITE.

PARKING DATA:	<u>ON</u> GRADE	PARKING STRUCTURE	BELOW GRADE/ GARAGE	BUILDING AREA
PROPOSED PID AMENDMENT PLAN	498 SPACES	0 SPACES	231 SPACES	285,600 SF
TOTAL	729 SPACE (60% COM	ES PACT, 40% STANI	DARD)	
PARKING RATIO				2.55 SPACES /1000 SF
RATIO * WITH THE PID	F, A PARKING		HICLE TRIP COUNT (PACES / 1000 SF IS	/1000 SF

		EXH	 B T "/	
		Approval Da	110 4/28/05	non-particular contraction of
CDP/PID #	PID AMENDMENT	St Permit No Revision 14	CDP 15/106; PDF	2 10903
Prepared By: Name:	RESUBMITTAL McGraw/Baldwin Architects	Revision 13 Revision 12		
Address:	701 'B' Street, Suite 200	Revision 11 Revision 10		desenantes set sets
Phone #:	San Diego, CA 92101 619-231-0751	Revision 9 Revision 8		
		Revision 7 Revision 6		addite the first sector a
Project Address:	10933 North Torrey Pines Rd. San Diego, CA	Revision 5 Revision 4	-	
Project Name:	Alexandria Technology Center Science Park City of San Diego Project Tracking # 6655	Revision 2	RESUBMITTAL SET - 10 RESUBMITTAL SET - 08 RESUBMITTAL SET - 05	3/13/04
	M/BA Project # 02017			
	A1.2	Original Date		4/14/03
Sheet Title:	GROSS AREA	SHEET	OF	18

DEP #

APPRC

DIAGRAM

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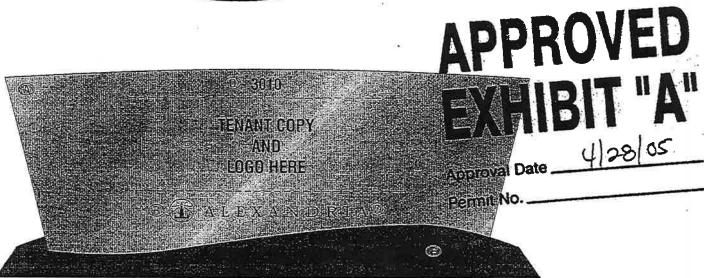
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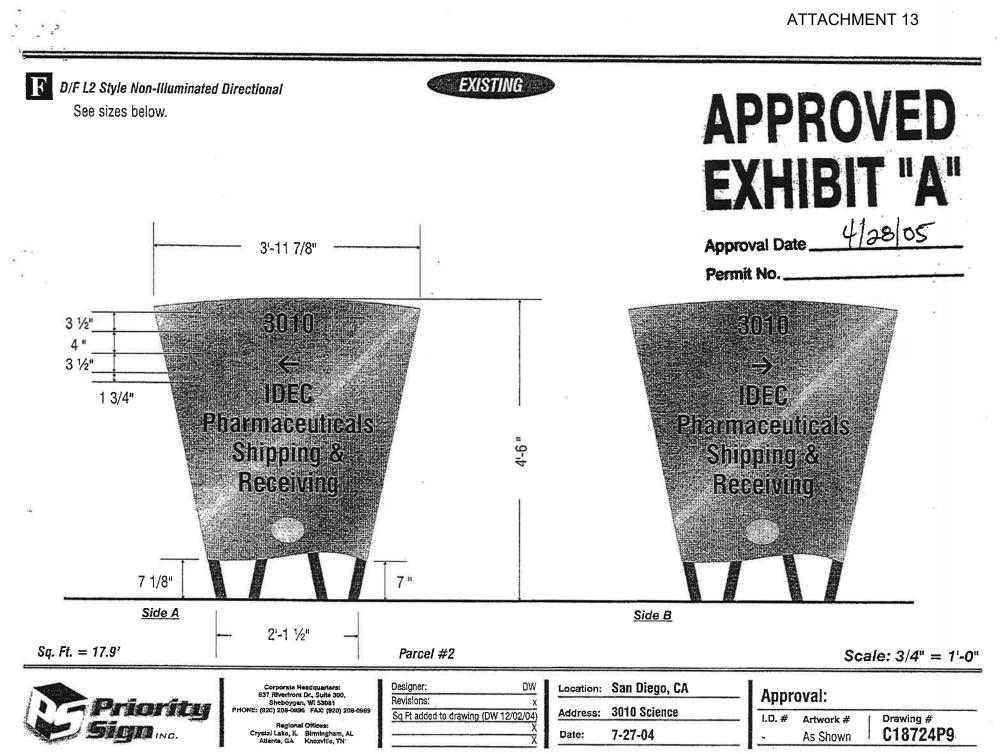
D/F B2-d Style Illuminated Monument See detail specs below.



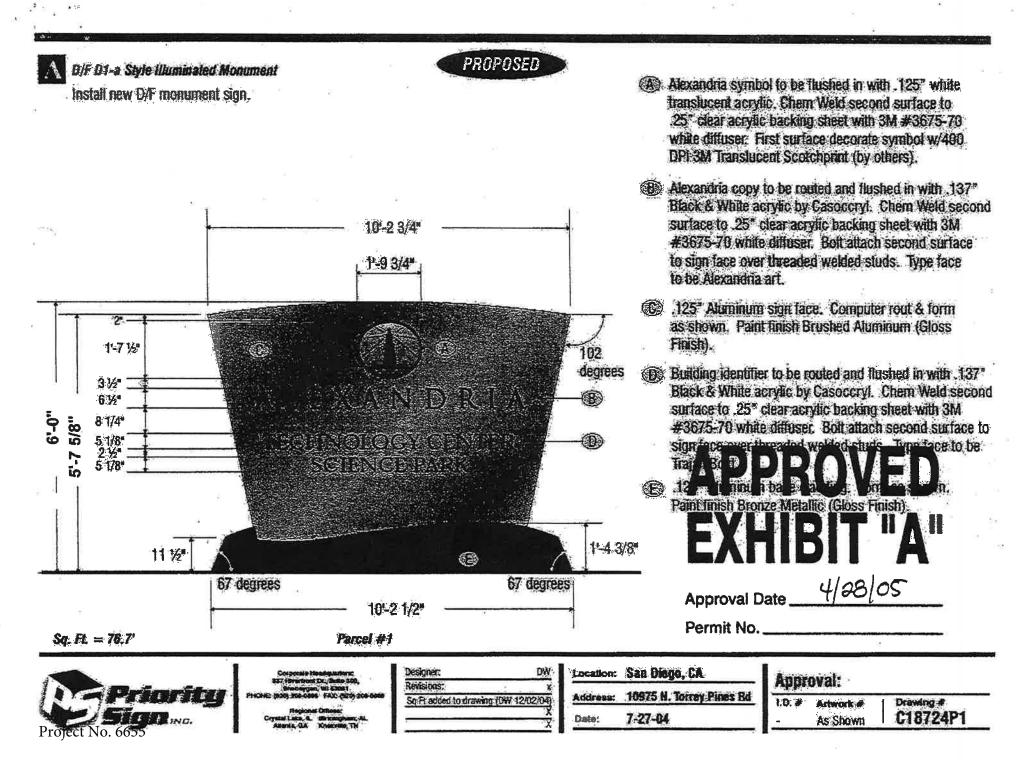


- 125" Aluminum sign face. Computer rout & form as shown. Paint finish Brushed Aluminum (Gloss Finish).
 - Alexandria symbol to be flushed in with .125" white translucent acrylic. Chem Weld second surface to .25" clear acrylic backing sheet with 3M #3675-70 white diffuser. First surface decorate symbol w/400 DPI 3M Translucent Scotchprint (by others).
- Alexandria copy to be routed and flushed in with .137" Black & White acrylic by Casoccryl. Chem Weld second surface to .25" clear acrylic backing sheet with 3M #3675-70 white diffuser. Bolt attach second surface to sign face over threaded welded studs. Type face to be Alexandria art.
 Sg. Ft. = 54.9' Parcel #2
- Address copy to be routed and flushed in with .137" Black & White acrylic by Casocryl. Chem Weld second surface to .25" clear acrylic backing sheet with 3M #3675-70 white diffuser. Bolt attach second surface to sign face over threaded welded studs. Type face Helvetica Condensed.
- First surface decorative tenant "signature & logo" with 3M film(s) as req'd. Signature to be full color. Use artwork supplied by 'tenant' and approved by designer. Graphic area should not exceed area shown.
- .125" Aluminum base cladding. Form as shown. Paint finish Bronze Metallic (Gloss Finish).
 - Scale: 1/2" = 1'-0"

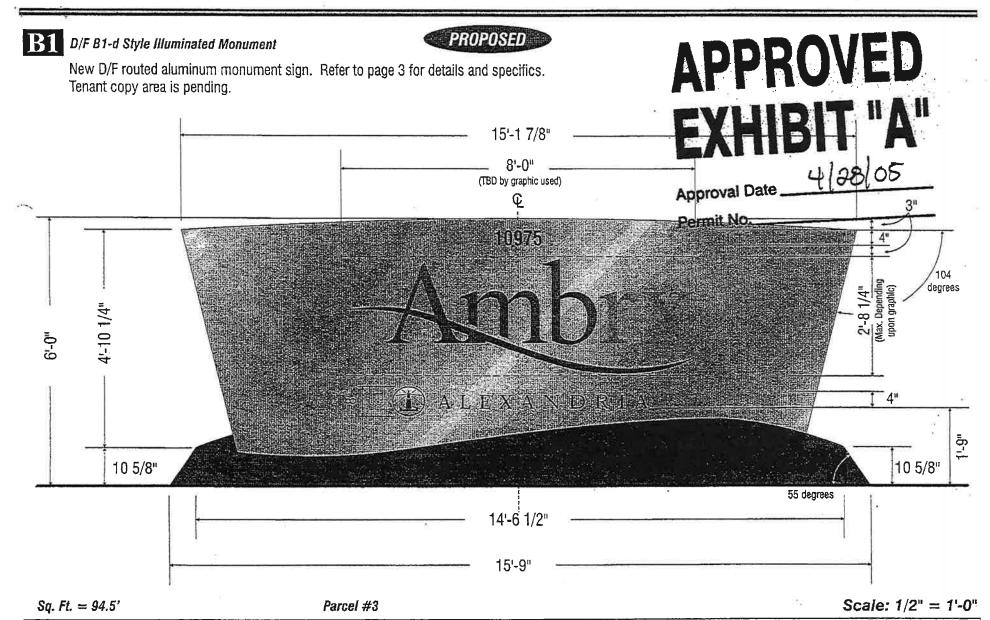
	Corporate Headquarters: 837 Riverhont D., Suite 300, Sheboygan, Wi 53081	Designer: DW Revisions: x	Location:		Аррі	roval:	
Priority	PHONE; (920) 208-0896 FAX: (920) 208-0969	Sq Ft added to drawing (DW 12/02/04)	Address:	3010 Science	I.D. #	Artwork #	Drawing #
Signing.	Regional Offices: Crystal Lake, IL Birmingham, AL Atlanta, GA Knoxville, TN	<u> </u>	Date:	7-27-04		As Shown	C18724P8
Project No. 6655					2 n		



Project No. 6655

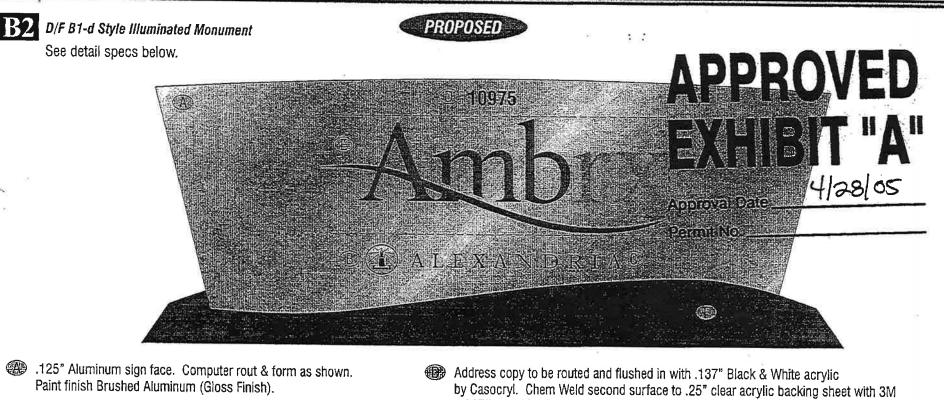


ATTACHMENT 13



	. Corporate Headquartera: 837 Rivertront Dr., Suite 300, Sheboygan, Wi 53061	Designer: DW Revisions: x	Location: San Diego, CA	Approval:
Prioricy	PHONE: (920) 208-0896 FAX: (920) 208-0969	Ambrx artwork inserted (DW 11/15/04)	Address: 10975 N. Torrey Pines Rd	I.D. # Artwork # Drawing #
Signine.	Regional Offices: Crystaf Lake, IL Birmingham, AL Atlanta, GA Knoxville, TN	Sq Ft added to drawing (DW 12/02/04) X	Date: 7-27-04	- As Shown C18724P2

Project No. 6655

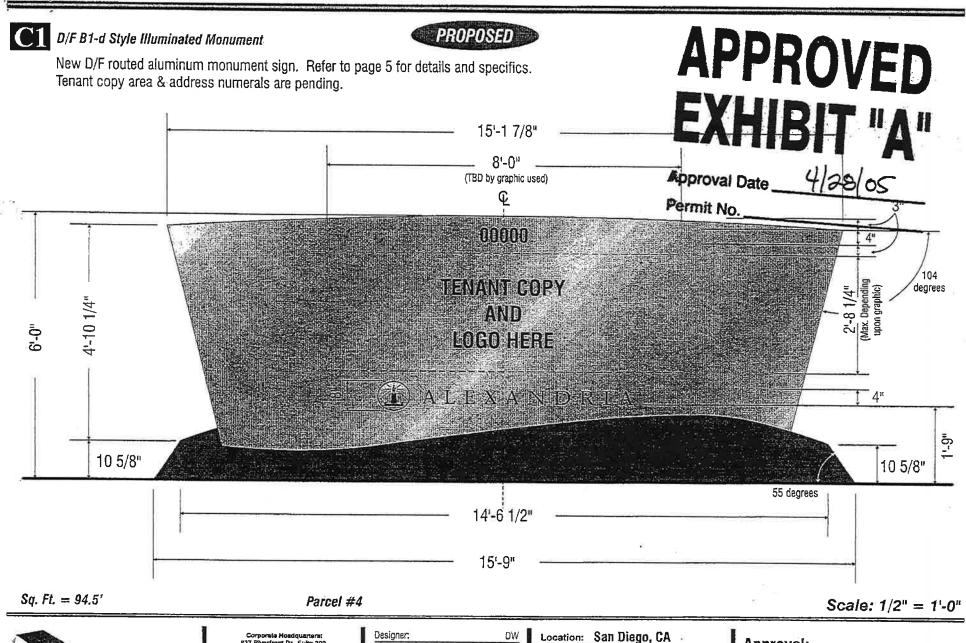


- Alexandria symbol to be flushed in with .125" white translucent acrylic. Chem Weld second surface to .25" clear acrylic backing sheet with 3M #3675-70 white diffuser. First surface decorate symbol w/400 DPI 3M Translucent Scotchprint (by others).
- Alexandria copy to be routed and flushed in with .137" Black & White acrylic by Casoccryl. Chem Weld second surface to .25" clear acrylic backing sheet with 3M #3675-70 white diffuser. Bolt attach second surface to sign face over threaded welded studs. Type face to be Alexandria art.
 Sq. Ft. = 94.5'
- Address copy to be routed and flushed in with .137" Black & White acrylic by Casocryl. Chem Weld second surface to .25" clear acrylic backing sheet with 3M #3675-70 white diffuser. Bolt attach second surface to sign face over threaded welded studs. Type face Helvetica Condensed.
- First surface decorative tenant "signature & logo" with 3M film(s) as req'd. Signature to be full color. Use artwork supplied by 'tenant' and approved by designer. Graphic area should not exceed area shown. Colors to match corporate specs.
- .125" Aluminum base cladding. Form as shown. Paint finish Bronze Metallic (Gloss Finish).

Scale:	1/2"	=	1'-0"
--------	------	---	-------

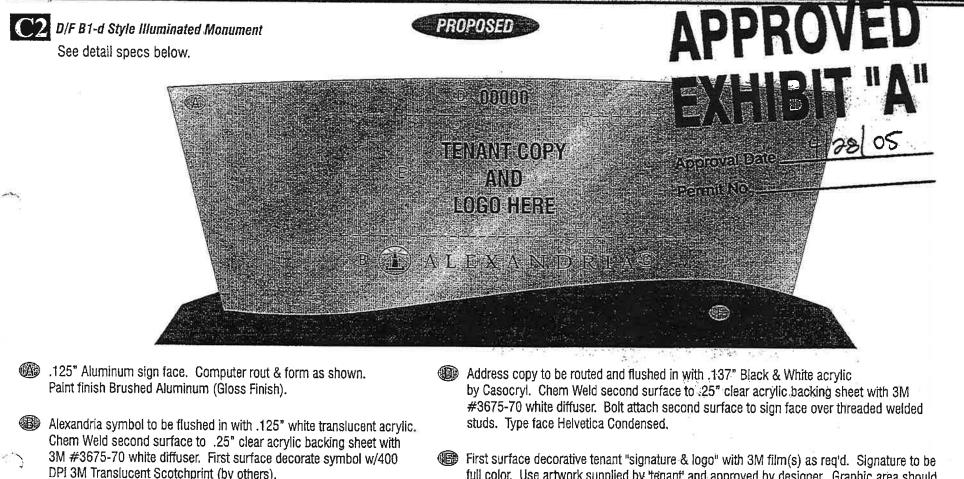
Priority	Corporate Headquarters: 637 Riverfront Dr., Suite 300, Sheboygan, WI S3081 PHONE: (320) 203-086 FAX: [320) 208-0969	Designer; DW Revisions: x		San Diego, CA	Appr	oval:	24. 0 24. 1
E Signine.	Regional Offices: Crystal Lake, IL Birningham, AL Atlanta, GA Knoxville, TN	Ambrx artwork inserted (DW 11/15/04) Sq Ft added to drawing (DW 12/02/04) X	Address: Date:	10975 N. Torrey Pines Rd 7-27-04	1.D. # -	Artwork # As Shown	Drawing # C18724P3

Project No. 6655



Prinritu	Corporate Hosdquarters; 837 Riverfront Dr., Suite 300, Sheboygan, WI 53081 PHONE: (320) 203-0395 FAX: (820) 208-0369	Designer: DW Revisions: x	Location: San Diego, CA	Approval:		
Signine.	Regional Offices: Crystal Lake, IL Birmingham, AL Atlanta, GA Knoxville, TN	Sq Ft added to drawing (DW 12/02/04) X X X	Address: 10975 N. Torrey Pines Rd Date: 7-27-04	I.D. # Artwork # Drawing # - As Shown C18724P4		

Project No. 6655



- Alexandria copy to be routed and flushed in with .137" Black & White acrylic by Casoccryl. Chem Weld second surface to .25" clear acrylic backing sheet with 3M #3675-70 white diffuser. Bolt attach second surface to sign face over threaded welded studs. Type face to be Alexandria art.
- Sq. Ft. = 94.5'

Parcel #4

- full color. Use artwork supplied by 'tenant' and approved by designer. Graphic area should not exceed area shown.
- .125" Aluminum base cladding. Form as shown. Paint finish Bronze Metallic (Gloss Finish).

Priority	Corporate Headquarters: 837 Riverfront Dr., Suite 300, Sheboygan, Wi 53081	Designer: DW Revisions: x	Location: San Diego, CA	Approval:
	PHONE: (\$20) 208-0695 FAX: (\$20) 208-0969 Regional Offices:	Sq Ft added to drawing (DW 12/02/04)	Address: 10975 N. Torrey Pines Rd	I.D. # Artwork # Drawing #
Signing.	Crystal Lake, IL Burningham, AL Atlanta, GA Knoxville, TN	xX	Date: 7-27-04	- As Shown G18724P5

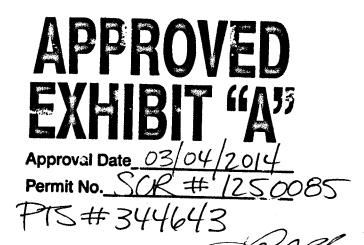
Project No. 6655



Torreyana / Sunrise

SUBSTANTIAL CONFORMANCE REVIEW 02/21/2014





Sustainable Buildings Expedite program

> AUTHORIZED BY **COUNCIL POLICY 900-14**

Malback

Version 5 (Project Manager) പ്പ

				• • • • •
DING OWNER:	ALEXANDRIA REAL ESTATE EQUITIES 4660 LA JOLLA VILLAGE DRIVE - SUITE 725 - SAN DIE CONTACT: BRIAN SMITH	GO, CA 92122		
	TELEPHONE: 858.638.2800 EMAIL: BSMITH@ARE.COM			
IECT:	GENSLER			
201.	225 BROADWAY - SUITE 1600 - SAN DIEGO, CA 92101 CONTACT: NATHAN OUREN			
	TELEPHONE: 619.557.2512 FAX: 619.557.2520 EMAIL: NATHAN_OUREN@GENSLEF	R.COM		
ENGINEER	RBF CONSULTING 9755 CLAIREMONT MESA BLVD - SUITE 100 - SAN DIE CONTACT: BRIAN OLIVER	GO, CA 92129		
	TELEPHONE: 858.614.6000 FAX: 858.614.5001 EMAIL: BKOLIVER@GENSLER.COM			
SCAPE ARCHITECT:	MCCULLOUGH LANDSCAPE ARCHITECTURE, INC. 363 5TH AVENUE, SUITE 201 - SAN DIEGO, CA 92101 CONTACT: DAVID MCCULLOUGH			
	TELEPHONE:619.296.3150EMAIL:DAVID@MLASD.COM			
DJECT TEAN 2" = 1'-0"				
				and a second
P 9829 / CDP 9828 : TORREY				
GAL DESCRIPTION:	LOT 12 UNIT # 2 TORREY PINES. IN THE CITY OF S DIEGO, STATE OF CALIFORNIA. ACCORDING TO M THE OFFICE OF THE COUNTY RECORDER OF SAM	AP THEREOF 8434 ON FILE IN		
E ADDRESS:	10996 TORREYANA ROAD, SAN DIEGO, CA, 92121	(EXISTING STRUCTURE)		
SESSOR'S PARCEL NO.:	340-010-34-00			
D USE INFORMATION:	INDUSTRIAL PARK ZONE (IP-1-1) COASTAL OVERLAY ZONE (NON-APPEALABLE AR	FA 1)		
	COASTAL HEIGHT LIMIT OVERLAY ZONE (PROPO COMMUNITY PLAN IMPLEMENTATION OVERLAY Z	SITION D)		
	UNIVERSITY COMMUNITY PLAN PARKING IMPACT OVERLAY ZONE (CAMPUS AND RESIDENTIAL TANDEM PARKING OVERLY ZONE	BEACH IMPACT AREAS)		
	PRIME INDUSTRIAL LAND (GENERAL PLAN) AIRPORT LAND USE COMPATIBILITY OVERLAY ZO AIRPORT ENVIRONS OVERLAY ZONE. 60 CNPL	NE: MCAS MIRAMAR		
	AIRPORT INFLUENCE AREA (REVIEW AREA 1) OVERFLIGHT NOTIFICATION AREA: MCAS MIRAM			
AREA:	······································	222 ACRES 271,040 SF		
	HARDSCAPE AREA: BUILDING COVERAGE:	2.899 ACRES 125,862 SF 2.258 ACRES 98,387 SF 2.009 ACRES 43,953 SF	PREVIOUSLY APPROVED	JEVELOPMENI
BACKS:	BUILDING COVERAGE %: (43,953 SF/271,040 SF) = 16%	PER SDP 151106 / PDP 109	03 / CDP 10911
	STREET SIDE YARD:	25' 20' 15'	SUNRISE	
	REAR YARD:	25'	2. EXISTING LAB 3. EXISTING LAB	22,663 SF 74,004 SF
OGIC HAZARD CATEGOR			5. PHASE III LAB/ADMIN. 6. PHASE II LAB/ADMIN.	68,701 SF 45,371 SF
L DESCRIPTION:	LOTS 1 THROUGH 4 INCLUSIVE AND LOT "A" OF A CENTER, IN THE CITY OF SAN DIEGO, COUNTY O	F SAN DIEGO, STATE OF	7. EXISTING LAB	74,111 SF
	CALIFORNIA, ACCORDING TO MAP THEREOF NO. THE COUNTY RECORDER OF SAN DIEGO COUNT FILE NO. 0666754.	15437, FILED IN THE OFFICE OF	8. FOOD SERVICE TOTAL	750 SF 285,600 S
ADDRESS:	109331 N.TORREY PINES RD, 3010 SCIENCE PARI	(RD., 10975 N. TORREY PINES RD.,		200,000 3
ESSOR'S PARCEL NO.:	VACANT LAND, OPEN SPACE PARCEL 340-012-0100, 340-012-0200, 340-012-0300, 340-012	-0400, 340-012-0500	PER SDP 9829 / CDP 9828:	TORREYANA
			EXISTING 2-STORY R&D BUILDING	81,895 SF
ID USE INFORMATION:	INDUSTRIAL PARK ZONE (IP-1-1) COASTAL OVERLAY ZONE (NON-APPEALABLE AF	EA 1)	PROPOSED 2-STORY R&D BUILDING	60,674 SF
	COASTAL HEIGHT LIMIT OVERLAY ZONE (PROPO COMMUNITY PLAN IMPLEMENTATION OVERLAY Z	SITION D)	TOTAL	142,569 S
	UNIVERSITY COMMUNITY PLAN PARKING IMPACT OVERLAY ZONE (CAMPUS AND RESIDENTIAL TANDEM PARKING OVERLY ZONE	BEACH IMPACT AREAS)	COMBINED PREVIOUSLY	APPROVED
	PRIME INDUSTRIAL LAND (GENERAL PLAN) AIRPORT LAND USE COMPATIBILITY OVERLAY ZO AIRPORT ENVIRONS OVERLAY ZONE. 60 CNPL	DNE: MCAS MIRAMAR	DEVELOPMENT:	
	AIRPORT ENVIRONS OVERLAT ZONE: 60 CITE AIRPORT INFLUENCE AREA (REVIEW AREA 1) OVERFLIGHT NOTIFICATION AREA: MCAS MIRAM ACCIDENT POTENTIAL ZONE: MCAS MIRAMAR ZO			428,169 S
E AREA:		DNE 2 16.08 ACRES 700,445 SF		л
TBACKS:		50'	DEVELOPMENT DA	IA
	STREET SIDE YARD	25' 25'		
OLOGIC HAZARD CATEGOR	<u>RY:</u> 51 & 52			
			REQUIRED PARKING PER	
CUPANCY	BUILDING ABBUILDING BBBUILDING CB		TABLE 142-05G PARKING RATIOS: RES	
	BUILDING D B, A2, A3		MIN: 2.5 R&D 428,169 SF 1.070 ST	
			*ACCESSIBLE PARKING STALLS SHALL BE PROV PLUS 1 FOR EACH OF 100 OR FRACTION THERE	IDED AT THE RATE OF 20
PE OF NEW CONSTRUCTIO	N REMODELED BUILDING D TYPE III-	B, SPRINKLERED	DESIGNATED PARKING SPACES FOR	R CARPOOL VEHICLES
		Br-U., WIVI	AND ZERO EMISSIONS VEHICLES PE	R 142.0530(d)(1)(B)(viii
P. PARKING DIMENSIONS	PREVIOUSLY CONFORMING COMPACT 7'-6" X 1 ACCESSIBLE 9'-0" X 1	8'-0" WITH 5'X18' ACCESS AISLE		MAX
an a		B'-0" WITH 8'X18' ACCESS AISLE	8% OF TOTAL SPACES 86 STAL MOTORCYCLE PARKING PER 142.053	
IILDING HEIGHT	BUILDING HEIGHTS SHALL COMPLY WITH PROPO HEIGHT LIMIT AS ENFORCED BY THE OASTAL CO			ORCYCLE SPACES
	AND/OR CITY OF SAN DIEGO		BICYCLE PARKING PER 142.0530(e)(1	l)(A) & 142.0530(e)(2)(A
RE NOTES:	PROVIDE BUILDING ADDRESS NUMBERS, VISIBL FROM THE STREET ROAD FRONTING THE PROP POLICY P-00-6 (UFC 901.4.4)		5% OF PARKING MIN. 54 BICY	CLE SPACES
	PROVIDE "NO PARKING - FIRE LANE" SIGNAGE A			
	CURBS THAT OUTLINE ACCESS ROADWAYS RED WHITE LETTERING READING "NO PARKING - FIRI ACCORDANCE WITH FHPS POLICY A-08-1			
RKING SYMBOL LEGEND	C COMPACT (PREVIOUSLY CONFORMING)			
	cp CAR POOL			
ROJECT DAT	ΓΔ			
E: 12" = 1'-0"			PARKING DATA	

H:\55.7106.000\BIM\Building Model_User Model Files\Daniel Robinson_55.7106.000_Torreyana CENTRAL_A13.rvt

TOTAL TORREYANA / SUNRISE ENTITLEMENT:

10% MAX. ACCESSORY:

LEVEL 1:
FITNESS
B-BALL INSTRUCTIONAL STUD OPEN FITNESS POOL LOCKER ROOMS

RECEPTION TOTAL:

LEVEL 1 TOTAL ACCESSORY

LEVEL 2:

LOUNGE / DINING BIKE FACILITY

BIOCOM SUITE SPACE

TOTAL:

LEVEL 2 TOTAL ACCESSORY

ENTITLEMENT

TOTAL SITE AREA

(E) BUILDING 81,895 SF OF R&D @ 300 SF/PERSON (PER SDMC TABLE 142-15F REMAINING R&D ENTITLEMENT 60,674 SF OF R&D @ 300 SF/PERSON (PER SDMC TABLE 142-15F)

TOTAL SDP 9829 SITE DENSITY PEOPLE / ACRE = 475 PEOPLE / 6.222 ACRES

TOTAL SITE AREA

(E) BUILDING A 45,371 SF OF R&D @ 300 SF/PERSON (PER SDMC TABLE 142-15F)

(E) BUILDING B 122,000 SF OF R&D @ 300 SF/PERSON (PER SDMC TABLE 142-15F)

(E) BUILDING C 74,111 SF OF R&D @ 300 SF/PERSON (PER SDMC TABLE 142-15F) REMAINING R&D ENTITLEMENT 43,368 SF OF R&D @ 300 SF/PERSON 750 SF OF FOOD SERVICE (ACCESSORY)

TOTAL SDP 151106 SITE DENSITY PEOPLE / ACRE = 950 PEOPLE / 16.08 ACRES

(PER SDMC TABLE 142-15F)

TOTAL SITE AREA

COMBINED SDP 9829 & SDP 151106 SITE DENSITY PEOPLE / ACRE = 1425 PEOPLE / 22.302 ACRES

TOTAL ENTITLED BUILDING AREA 10% ACCESSORY SF EXEMPTION PER

SDMC 132.1515(c)(2)(E)(iii)

(E) BUILDING A 45,371 SF OF R&D @ 300 SF/PERSON (PER SDMC TABLE 142-15F) (E) BUILDING B 97,417 SF OF R&D @ 300 SF/PERSON (PER SDMC TABLE 142-15F) (E) BUILDING C 74,111 SF OF R&D @ 300 SF/PERSON (PER SDMC TABLE 142-15F) BUILDING D: REMODELED 10996 TORREYANA RD. ASSEMBLY: 26,186 SF INSTRUCTIONAL STUDIOS: 2,734 SF EATING ESTABLISHMENTS: 3,000 SF BIOCOM 27,259 SF SUPPORT SPACES (RESTROOMS, STORAGE, LOCKER ROOMS, ETC.) REMAINING 16,362 SF OF BIOCOM @ 215 SF/PERSON (27,259 SF - 10,897 SF EXEMPT = 16,362 SF) PER SDMC TABLE 142-15F)

REMAINING "SUNRISE" ENTITLEMENT 68,701 SF OF R&D @ 300 SF/PERSON (PER SDMC TABLE 142-15F) REMAINING "TORREYANA" ENTITLEMENT 64,303 SF OF R&D @ 300 SF/PERSON (PER SDMC TABLE 142-15F)

TOTAL SITE DENSITY FOR PROPOSED DEVELOPMENT PEOPLE / ACRE = 1242 PEOPLE / 22.302 ACRES

APZ PPL / ACRE CALCULATIONS SCALE: 12" = 1'-0"

45.371 SF BUILDING A: (E) 2 STORY BUILDING B: (E) 1 STORY 122,000 SF BUILDING C: (E) 2 STORY 74,111 SF REMAINING UNBUILT ENTITLEMENTS 44,118 SF 285,600 SF TOTAL 151106 / PDP 10903 / CDP 10911 SDP 9829 BUILDING D: (E) 2-STORY 81,895 SF 22,663 SF REMAINING UNBUILT ENTITLEMENTS 60,674 SF 74,004 SF 142,569 SF TOTAL 68,701 SF 45,371 SF **COMBINED ENTITLEMENTS:** 428,169 SF 74,111 SF 285,600 SF **PROPOSED DEVELOPMENT** 45,371 SF BUILDING A: (E) 2 STORY 122,000 SF BUILDING B: (E) 1 STORY 81,895 SF BUILDING C: (E) 2 STORY 74.111 SF 60,674 SF 78,266 SF REMODELED BUILDING D WITH 142,569 SF (N) SOCCER FIELD TOTAL PROPOSED DEVELOPMENT 319,748 SF 108,421 SF REMAINING UNBUILT ENTITLEMENTS 428,169 SF TOTAL ENTITLEMENT:

EXISTING DEVELOPMENT

SDP 15116

OPMENT DATA

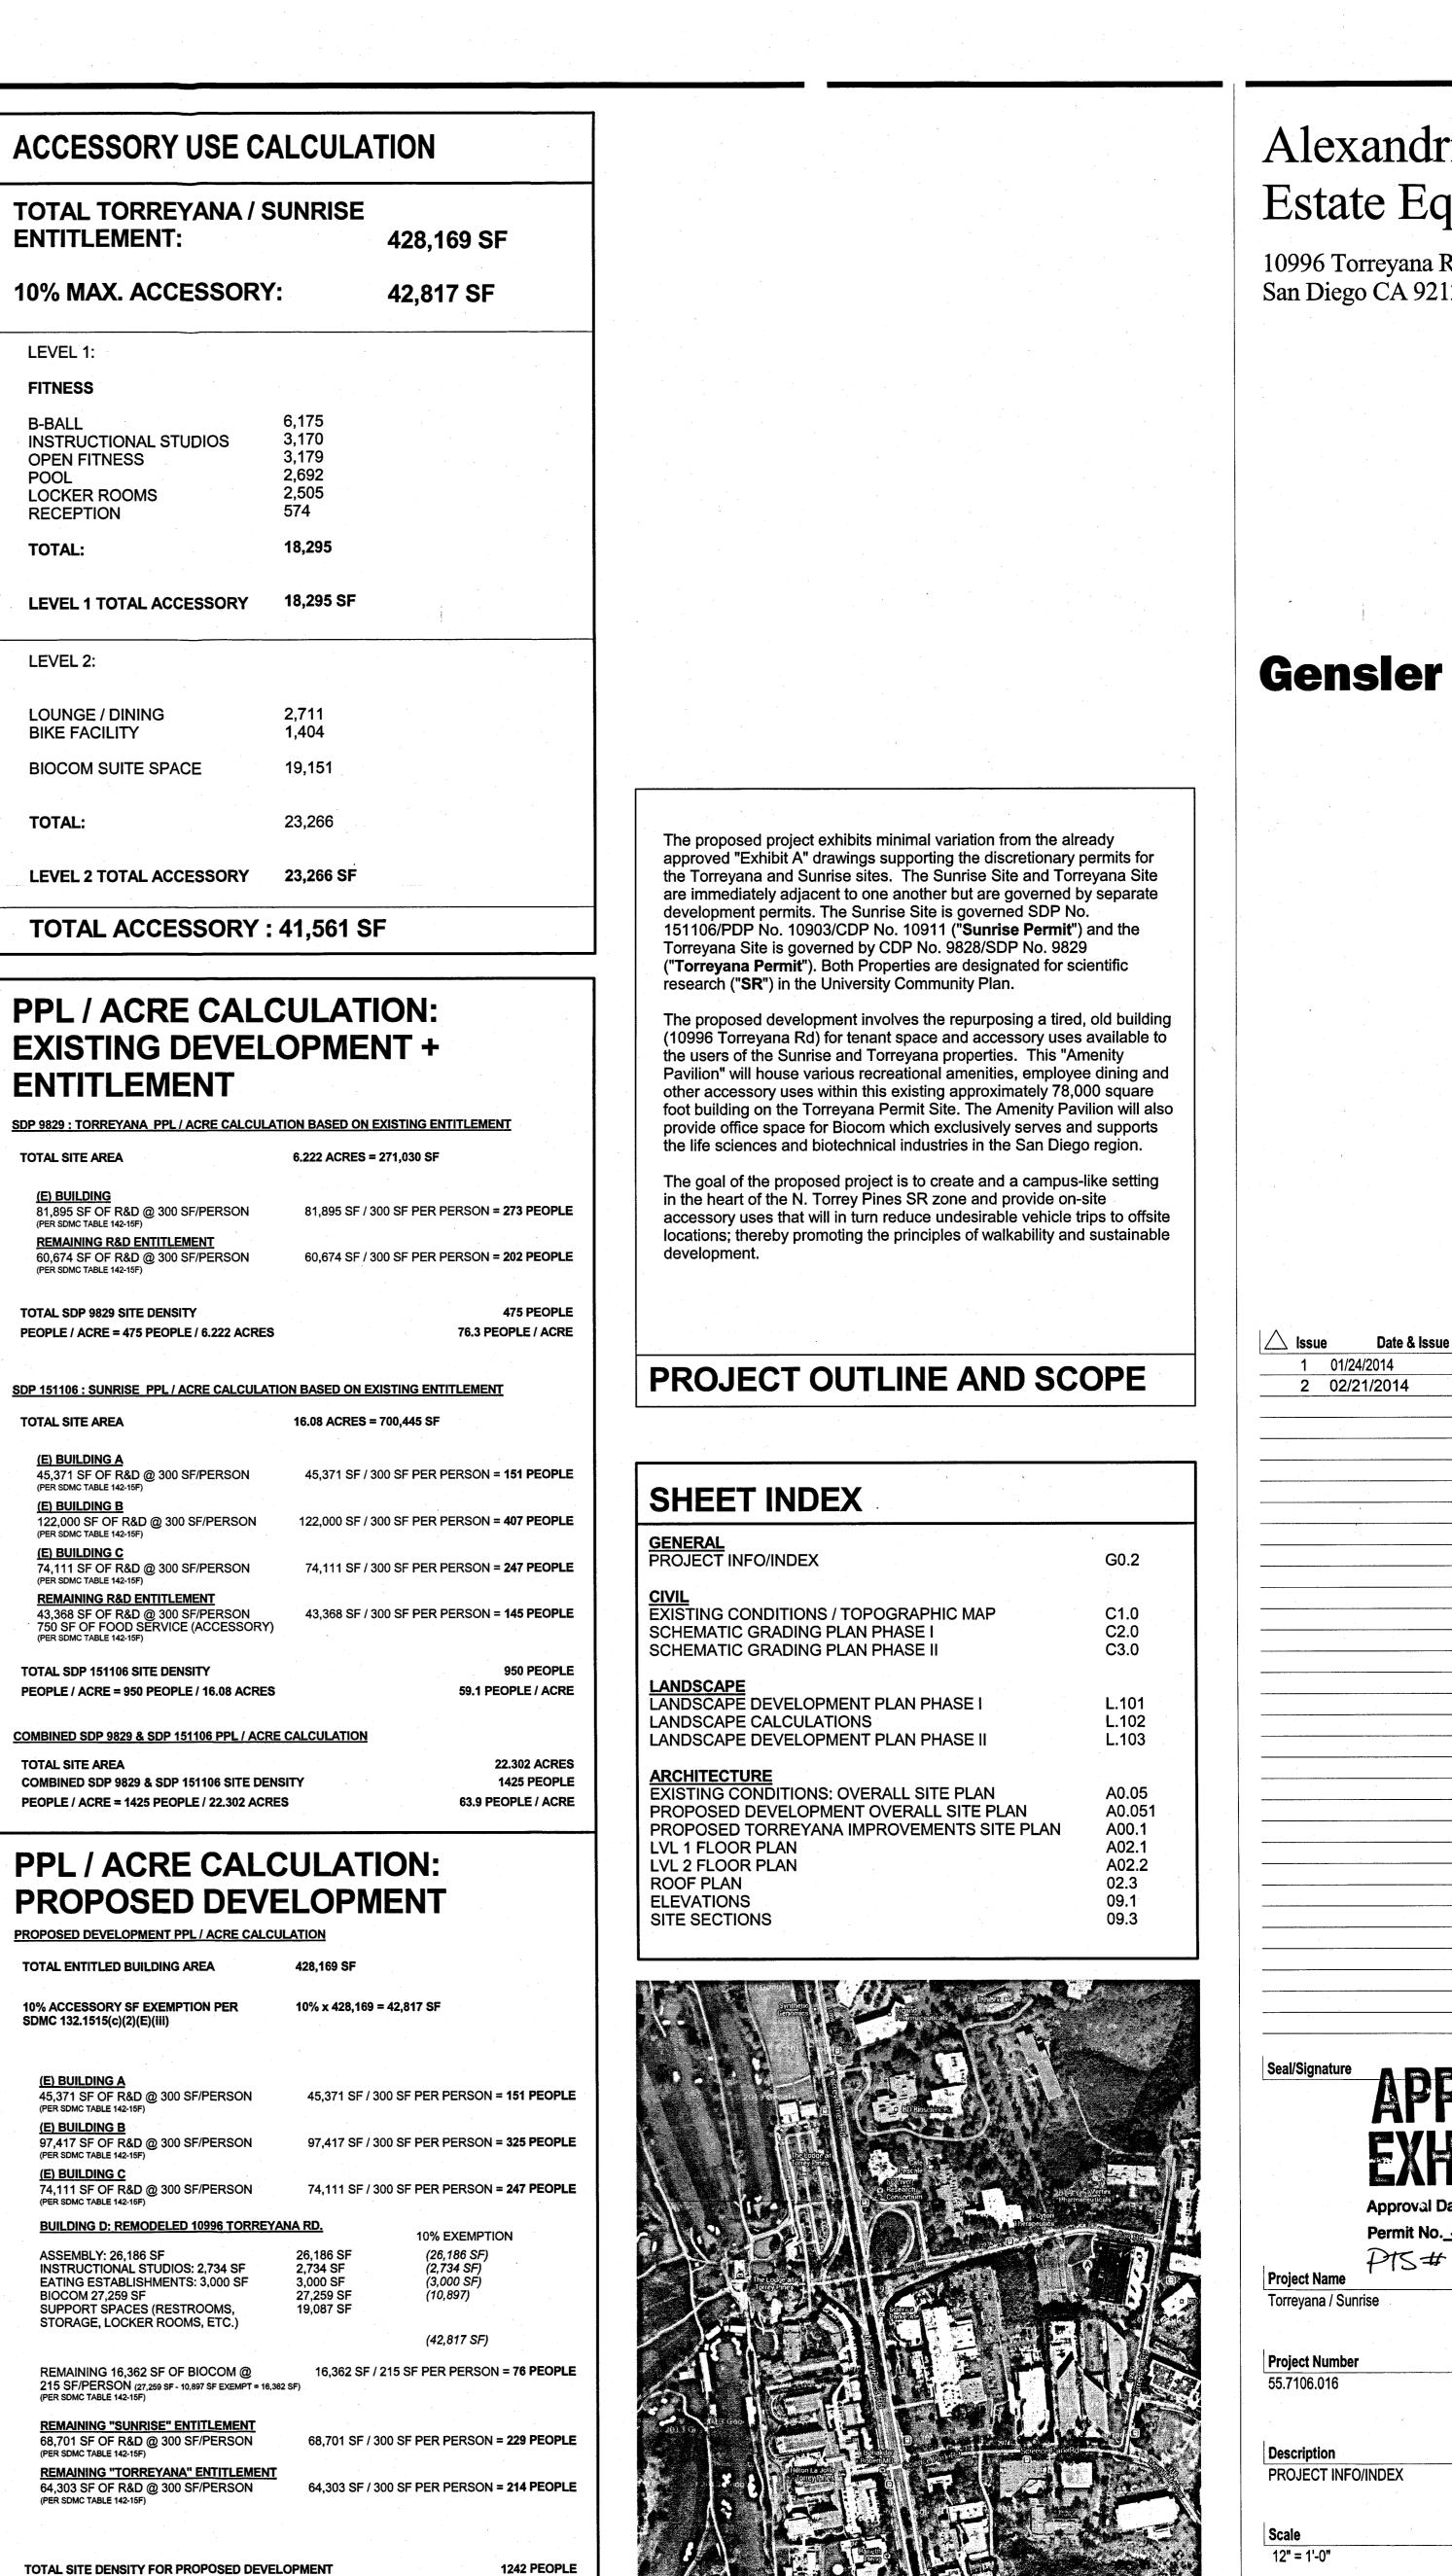
· · ·		
	IG PER SDM	IC 142.0530
G PARKING RA	TIOS: RESEARCH	& DEVELOPMENT
	MIN: 2.5/1000	MAX: 4.0/1000
9 SF	1,070 STALLS*	1,712 STALLS*
	ALL BE PROVIDED AT 1 TION THEREOF OVER	
	ACES FOR CARP HICLES PER 142.0	
	MIN	MAX
AL SPACES	86 STALLS	137 STALLS
LE PARKING P	ER 142.0530(g)	
KING MIN.	21 MOTORCYC	LE SPACES
RKING PER 14	2.0530(e)(1)(A) & 1	142.0530(e)(2)(A)
KING MIN.	54 BICYCLE SP	ACES

EXISTING PARKING			
SDP 15116 - "SUNRI	SE"		-
	STANDARD	ACCESSIBL	E
ON GRADE	480	15	-
BLDG. A SUBTERANEAN	50	3	
BLDG. C SUBTERANEAN	79	4	
TOTAL	609	22	= 631
	· ·		
SDP 9829 - "TORRE"	YANA"		
	STANDARD	ACCESSIBL	E
	450	-	
ON GRADE	159	6	
PARKING STRUCTURE	165	<u>6</u> 4	
			= 334
PARKING STRUCTURE	165 324	4	= 334
PARKING STRUCTURE	165 324	4	
PARKING STRUCTURE	165 324	4 10	
PARKING STRUCTURE TOTAL PROPOSED PARKIN	165 324 IG STANDARD	4 10 ACCESSIBL	
PARKING STRUCTURE TOTAL PROPOSED PARKIN ON GRADE	165 324 IG STANDARD 581	4 10 ACCESSIBL 15	
PARKING STRUCTURE TOTAL PROPOSED PARKIN ON GRADE BLDG. A SUBTERANEAN	165 324 IG STANDARD 581 50	4 10 ACCESSIBL 15 3	

IG DATA

428,169 SF

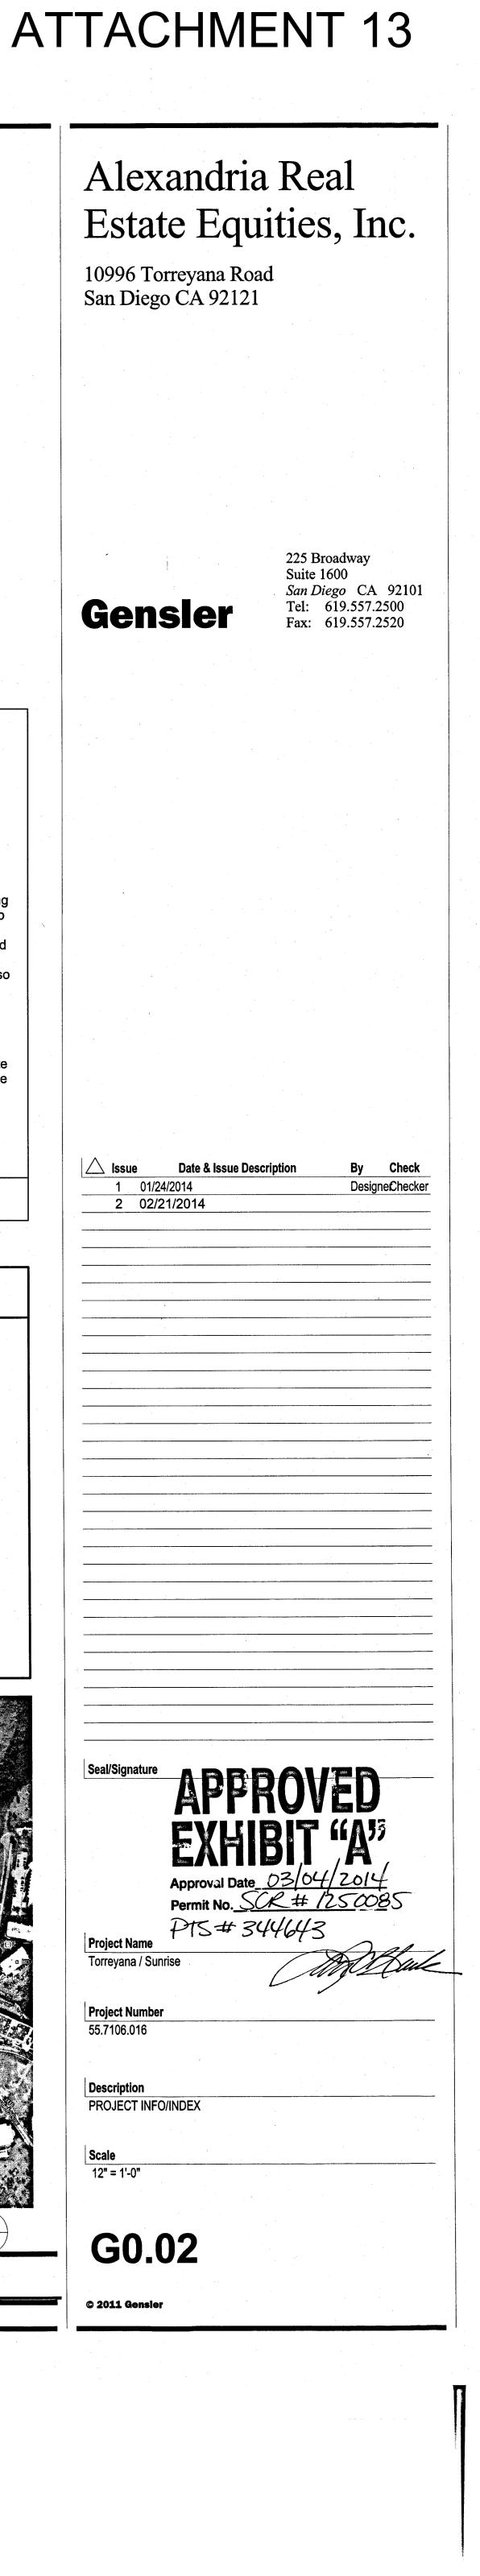
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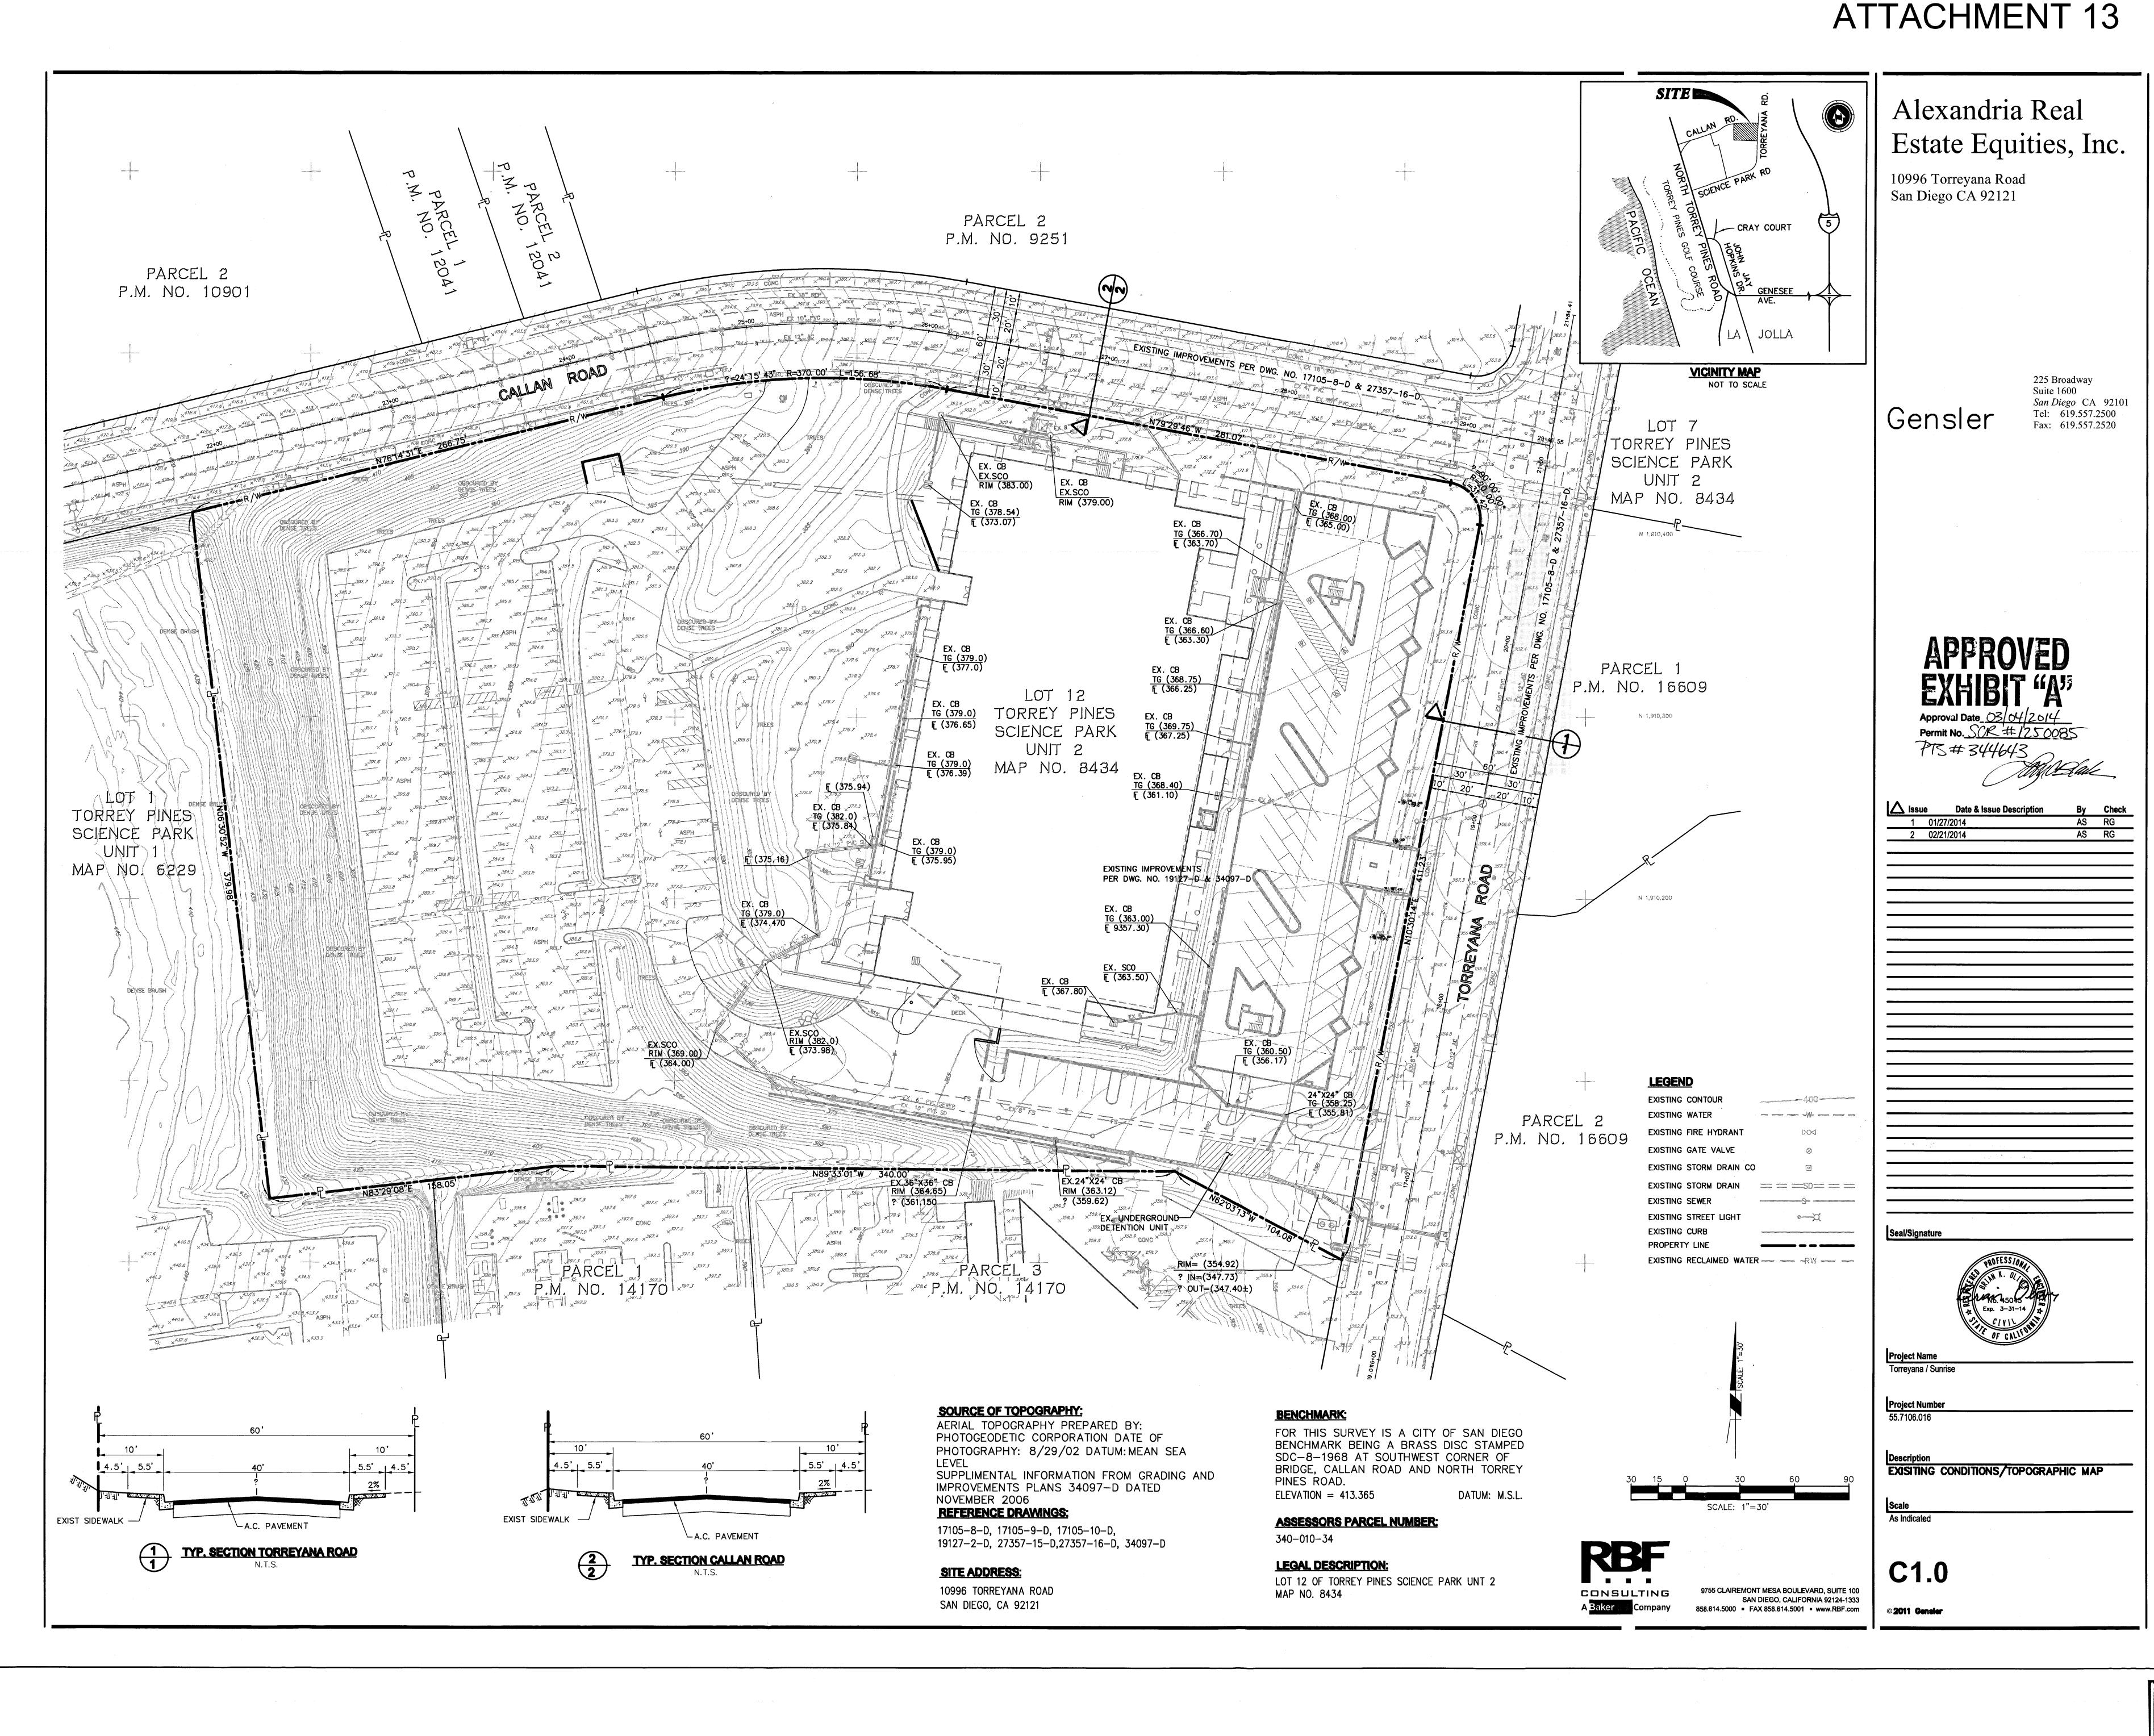


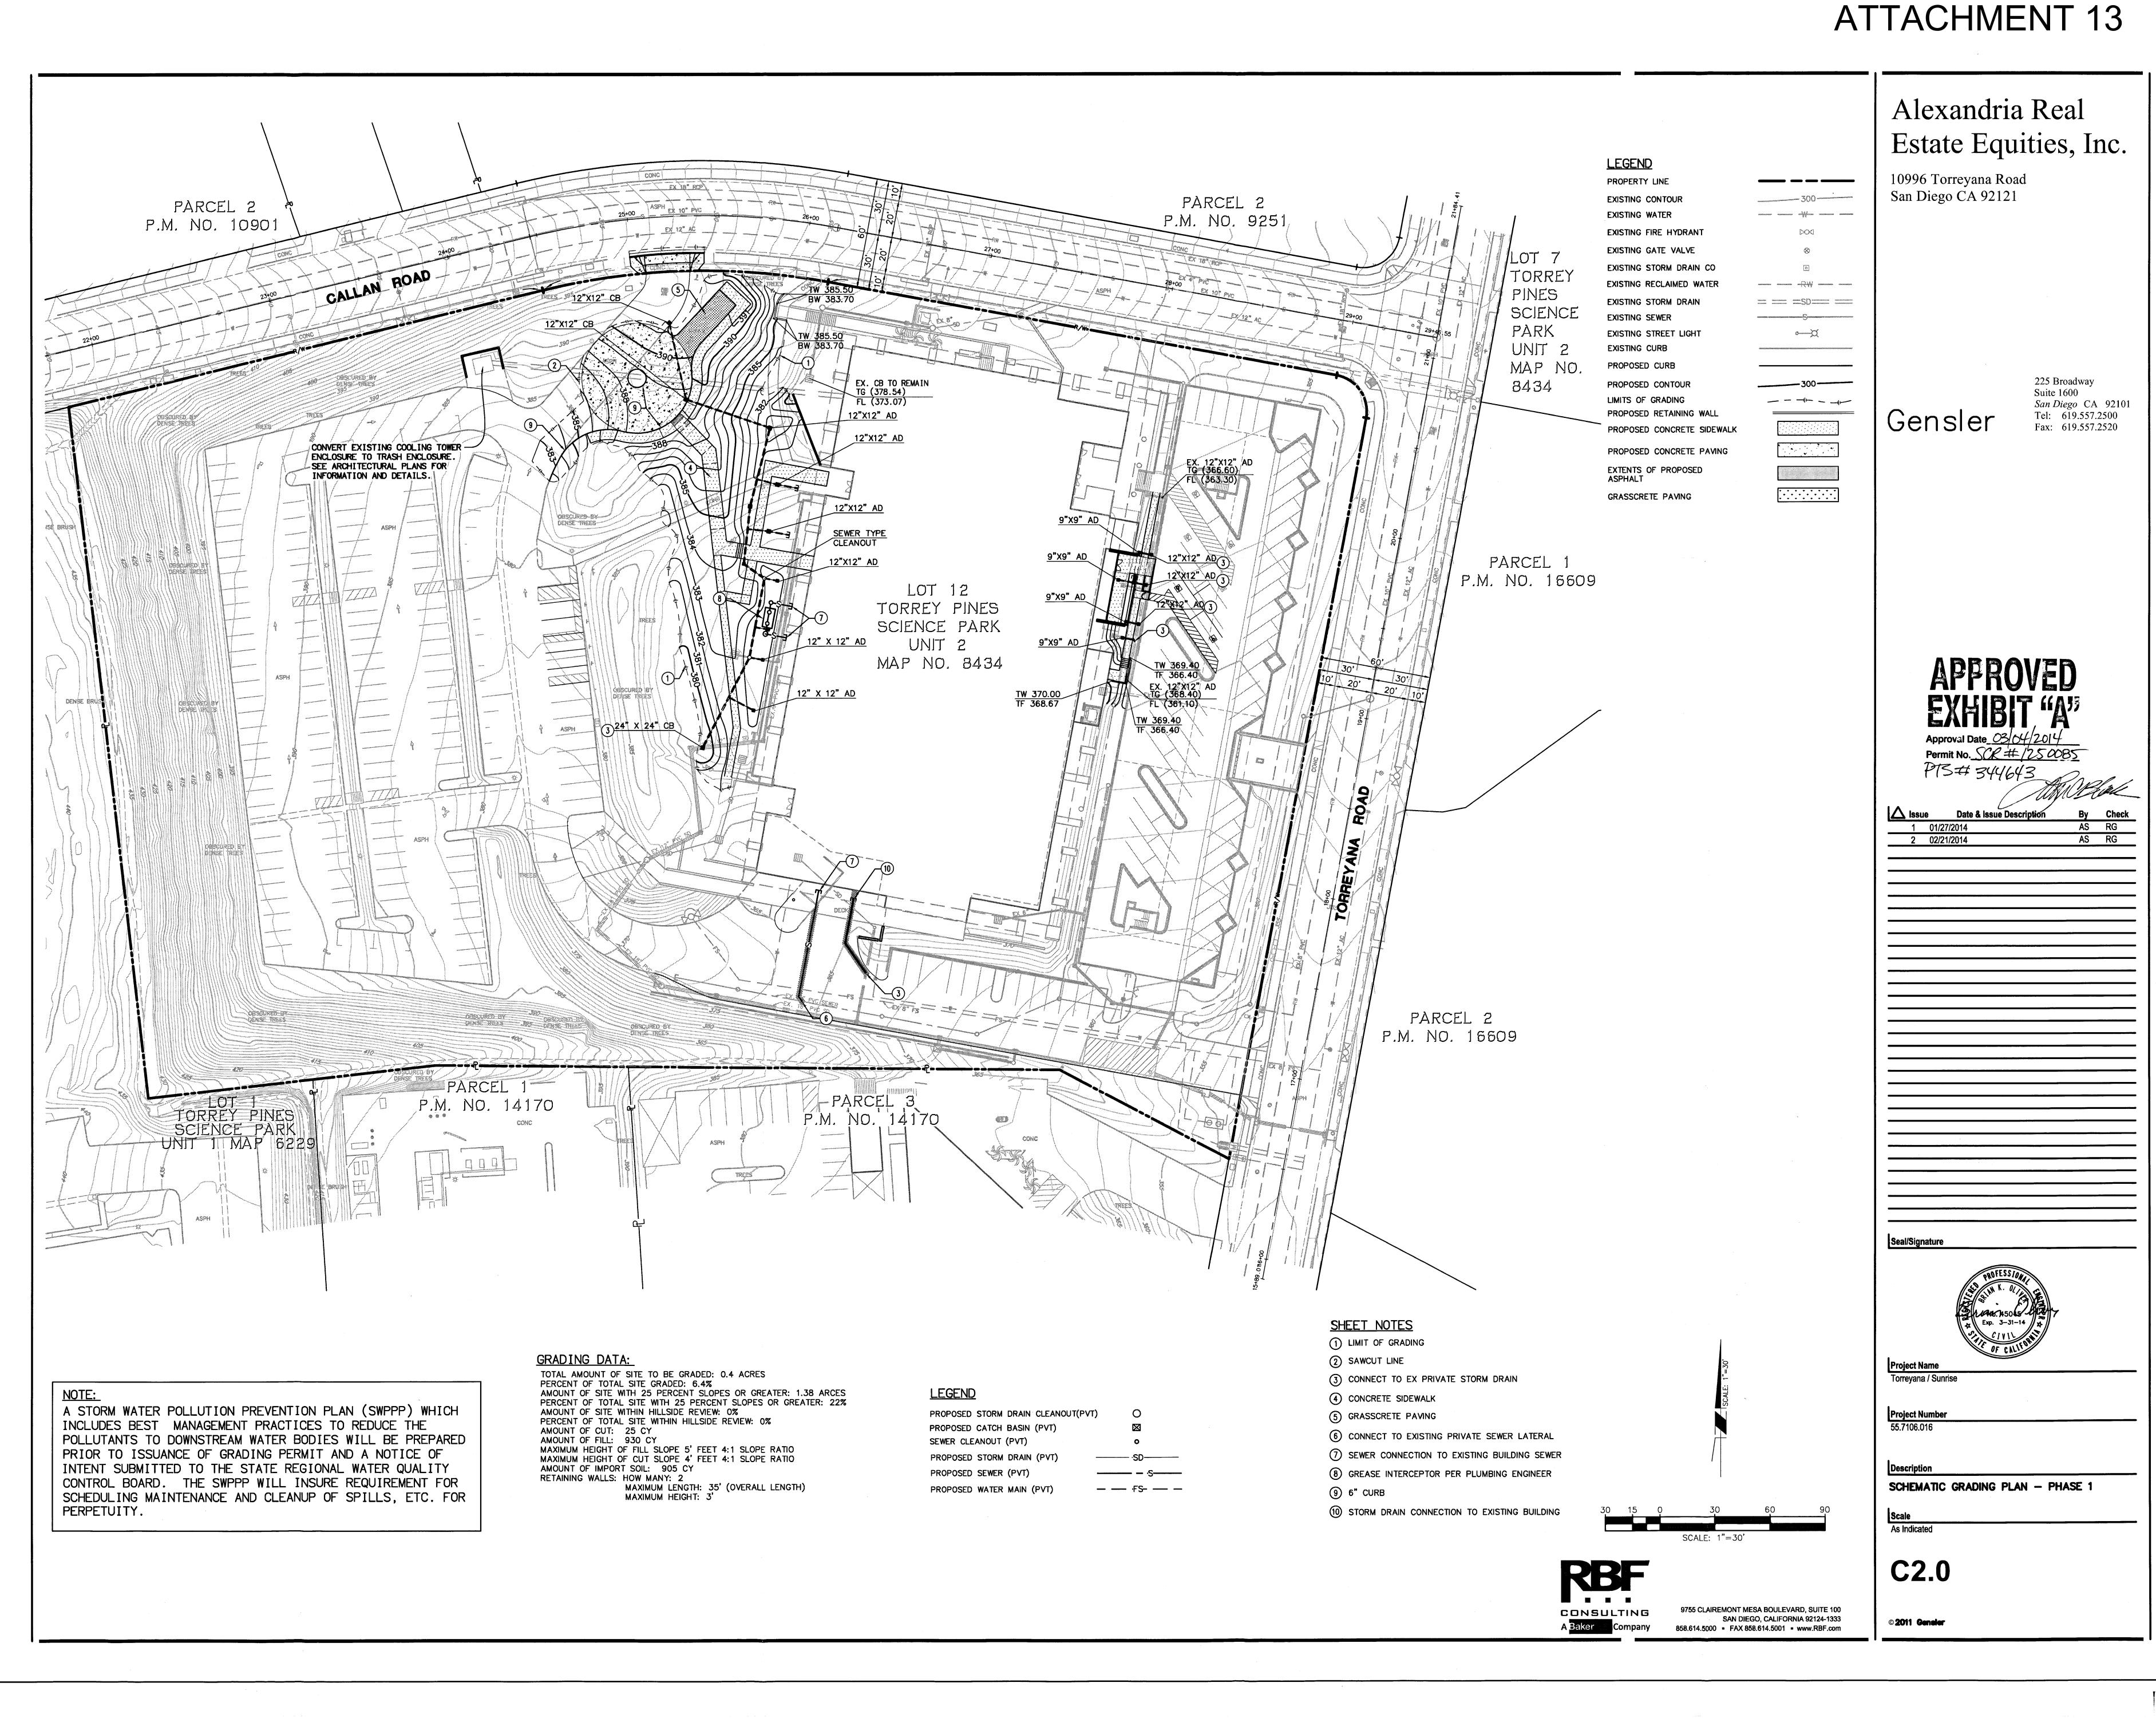
55.7 PEOPLE / ACRE

Copy of VICINITY MAP SCALE: 12" = 1'-0"

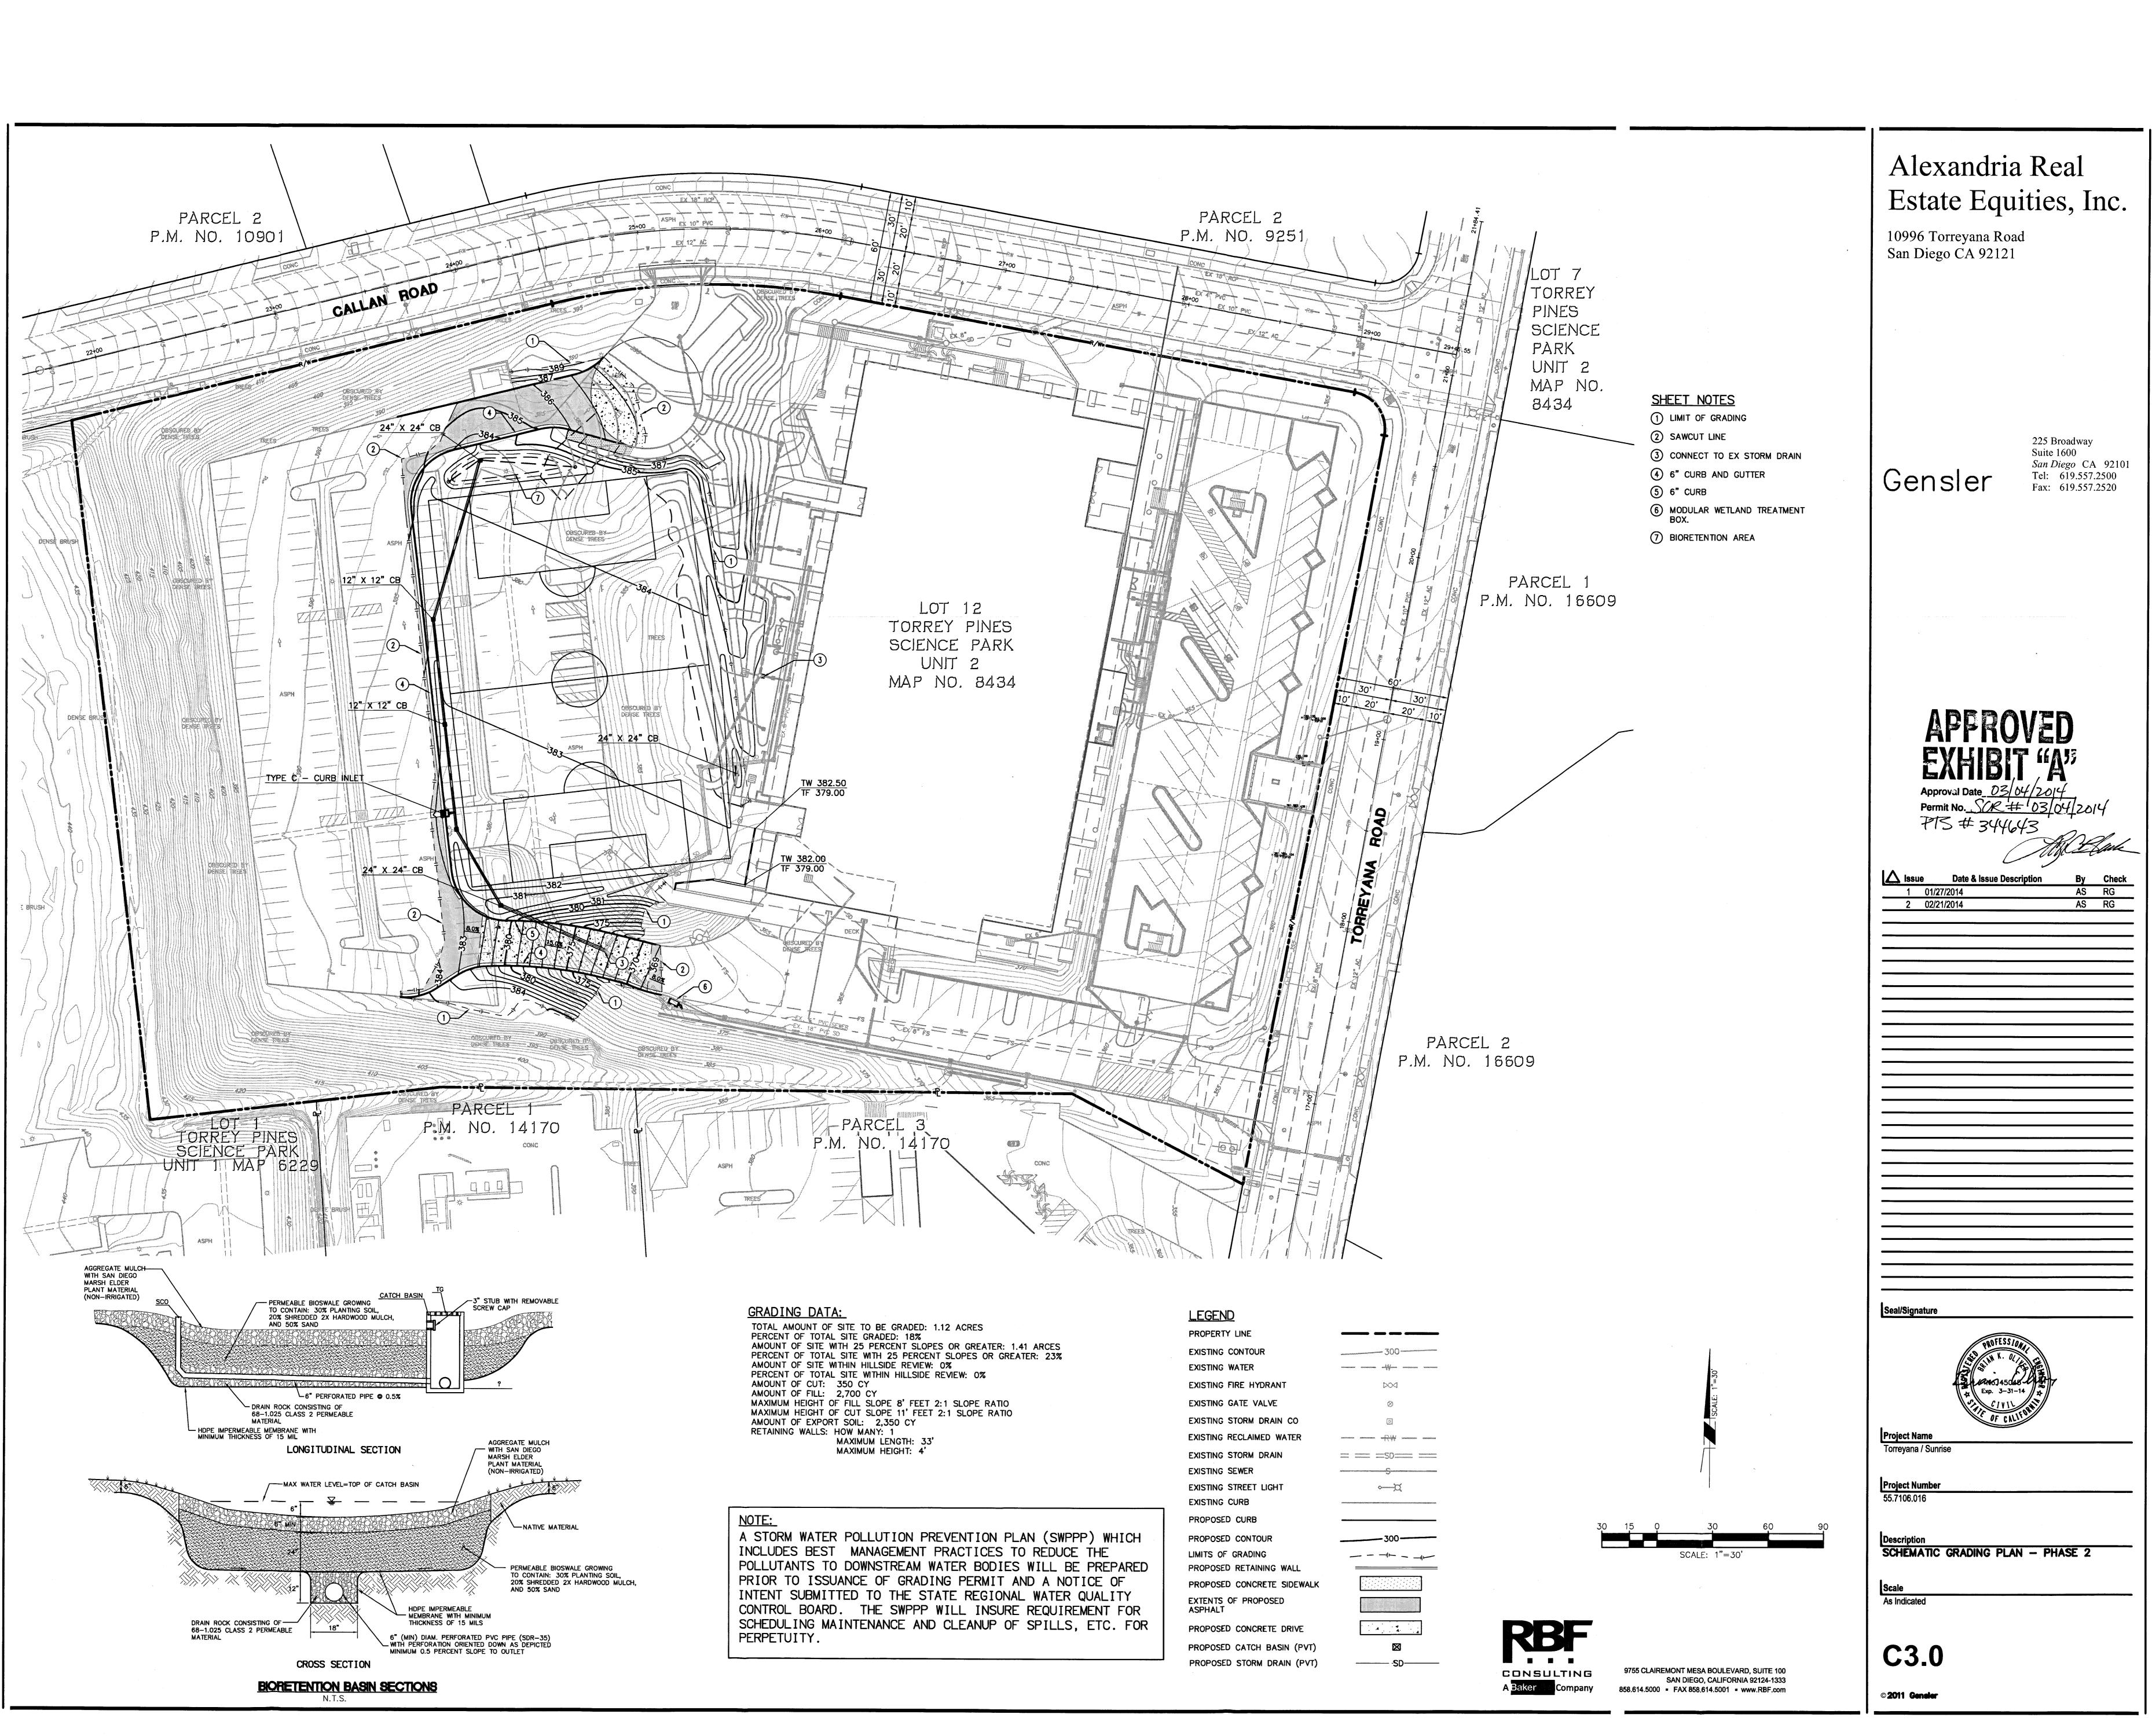
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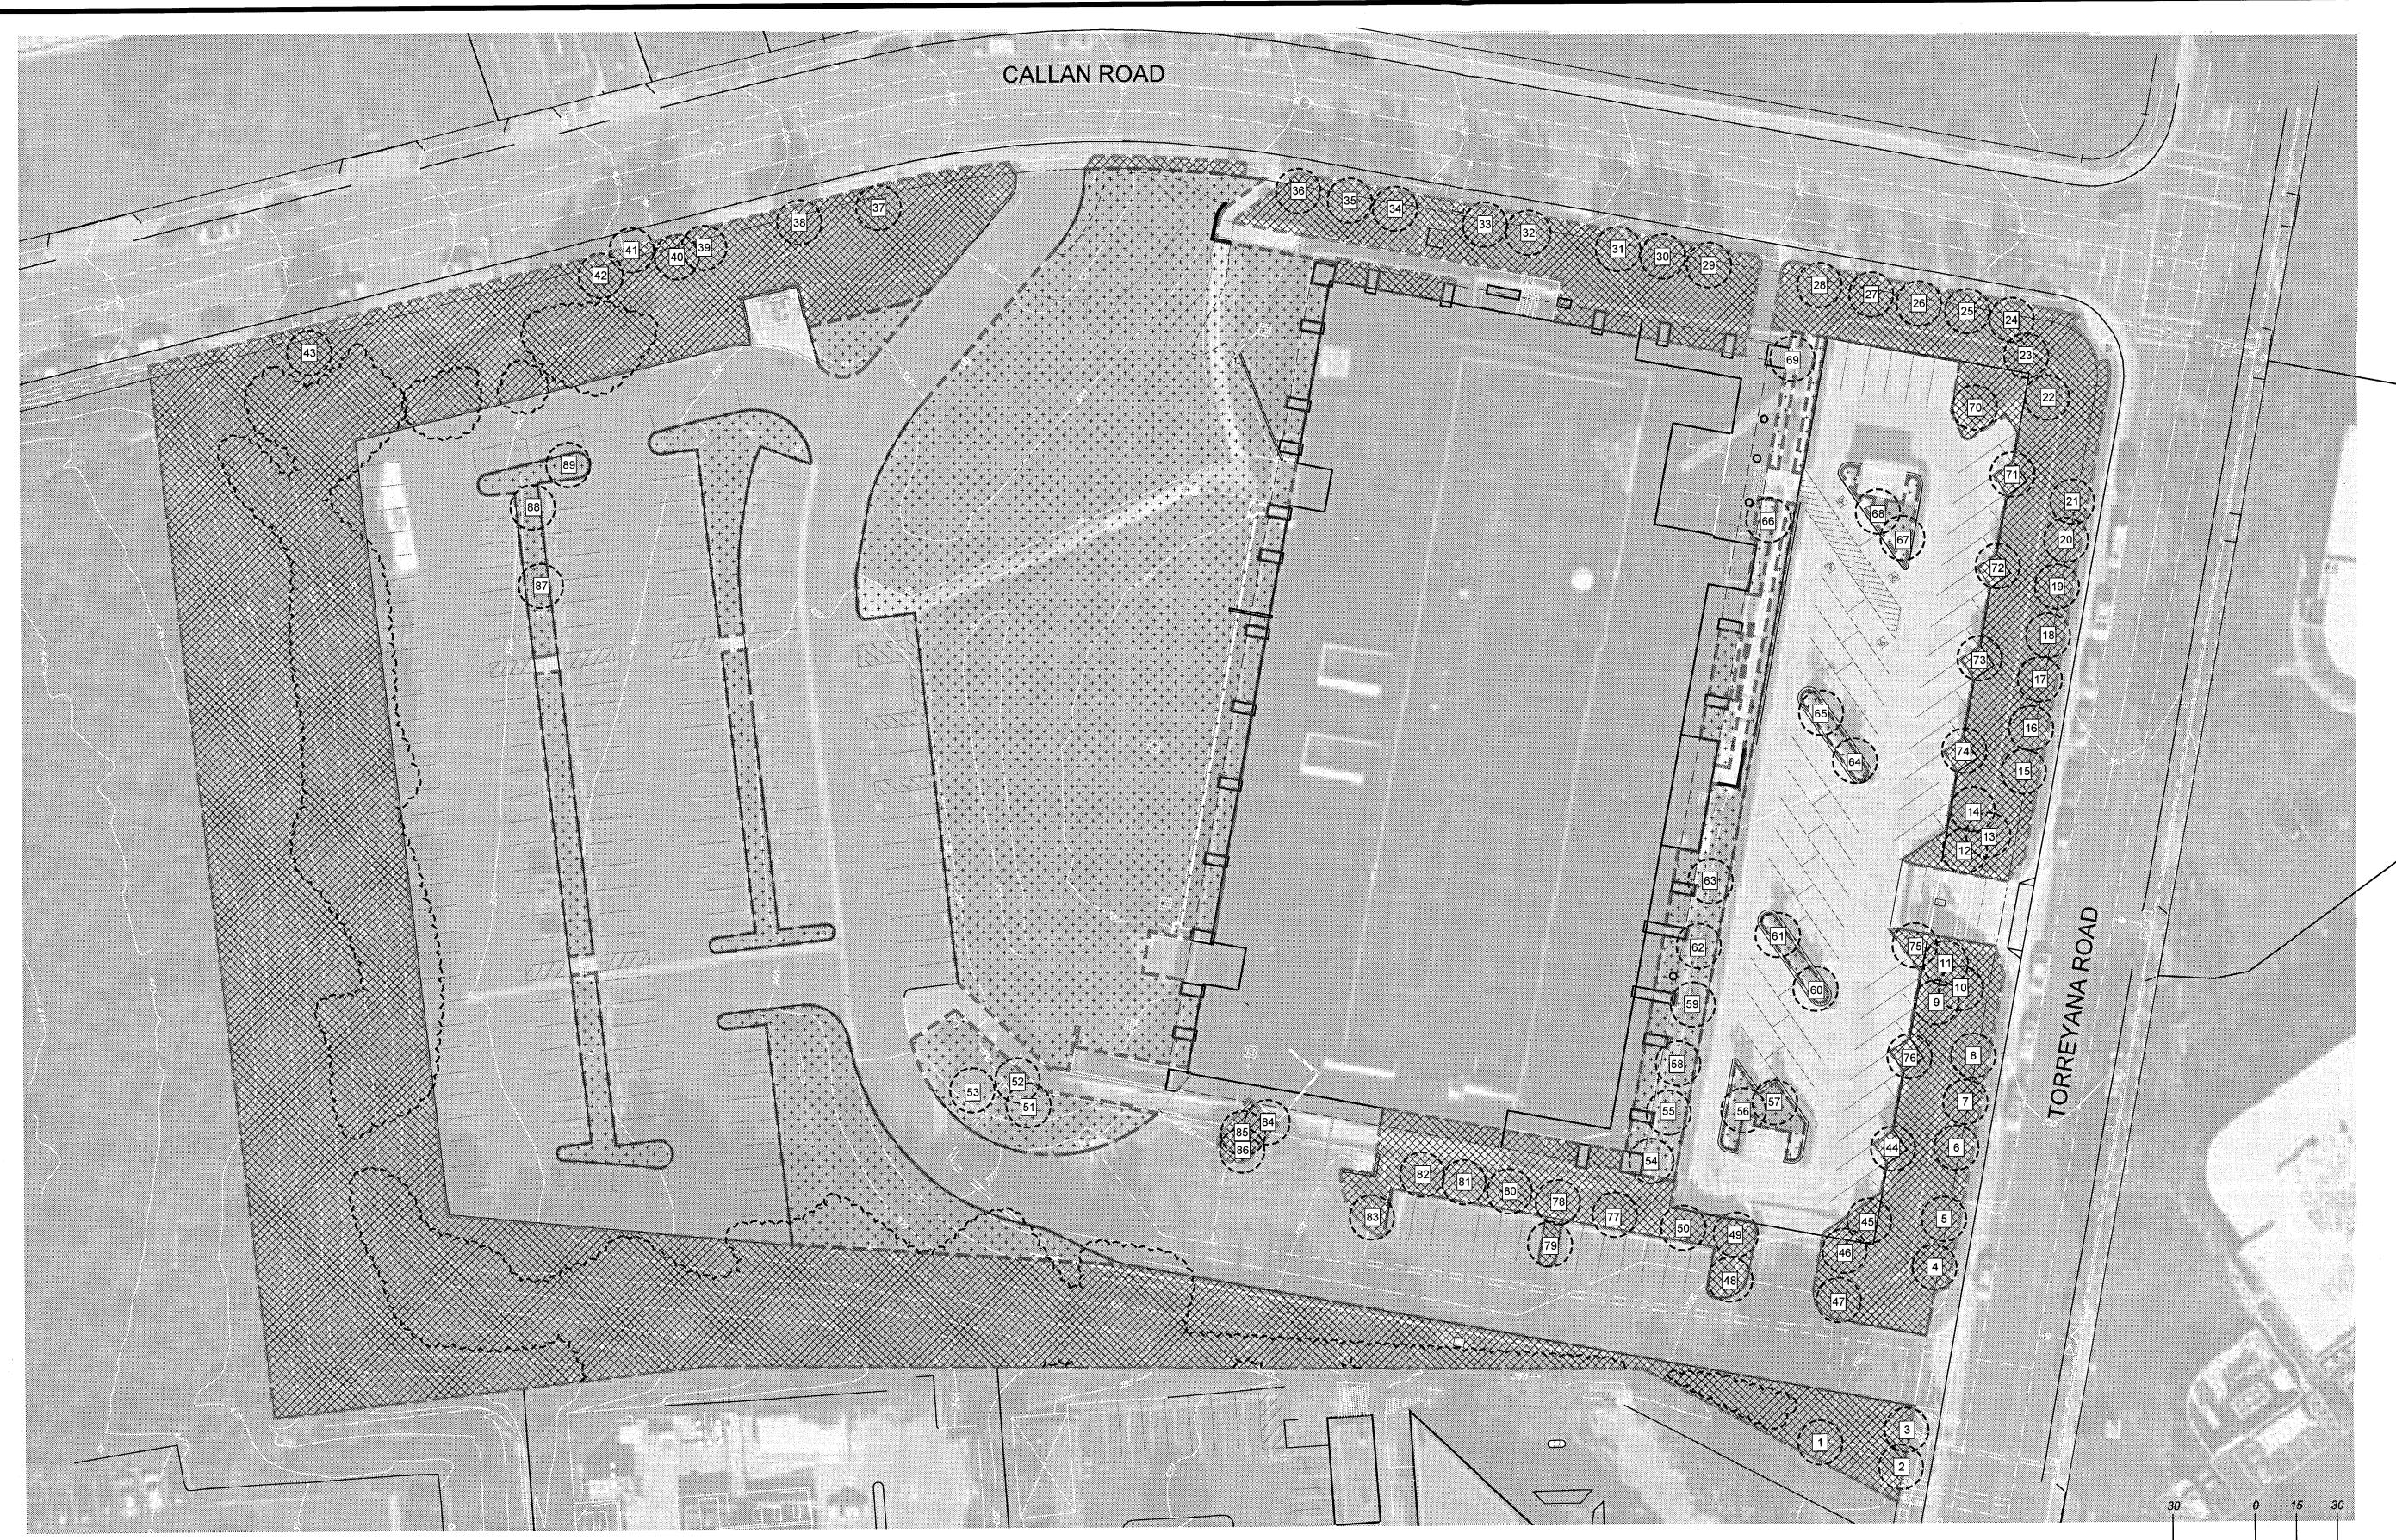




PROPOSED STORM DRAIN CLEANOUT(P	O (TV
PROPOSED CATCH BASIN (PVT)	\mathbf{X}
SEWER CLEANOUT (PVT)	0
PROPOSED STORM DRAIN (PVT)	
PROPOSED SEWER (PVT)	·S
PROPOSED WATER MAIN (PVT)	— — FS- — ·



ATTACHMENT 13



EXISTING TREE LEGEND

SYMBOL	BOTANICAL NAME	COMMON NAME	CALIPER SIZE	HEIGHT	SPREAD	REMARKS
1	PINUS HALEPENSIS	ALEPPO PINE	7"	30'	30'	TO REMAIN, PROTECT IN PLACE
2	PINUS TORREYANA	TORREY PINE	6"	12'	15'	TO REMAIN, PROTECT IN PLACE
3	PINUS TORREYANA	TORREY PINE	6"	12'	15'	TO REMAIN, PROTECT IN PLACE
4	PINUS TORREYANA	TORREY PINE	6"	10'	12'	TO REMAIN, PROTECT IN PLACE
5	PINUS TORREYANA	TORREY PINE	6"	12'	15'	TO REMAIN, PROTECT IN PLACE
6	PINUS TORREYANA	TORREY PINE	6"	12'	15'	TO REMAIN, PROTECT IN PLACE
7	PINUS TORREYANA	TORREY PINE	6"	12'	15'	TO REMAIN, PROTECT IN PLACE
8	PINUS TORREYANA	TORREY PINE	6"	12'	15'	TO REMAIN, PROTECT IN PLACE
9	LAGERSTROEMIA INDICA	CRAPE MYRTLE	4"	12'	15'	TO REMAIN, PROTECT IN PLACE
10	LAGERSTROEMIA INDICA	CRAPE MYRTLE	4"	10'	8'	TO REMAIN, PROTECT IN PLACE
11	LAGERSTROEMIA INDICA	CRAPE MYRTLE	4"	10'	8'	TO REMAIN, PROTECT IN PLACE
12	LAGERSTROEMIA INDICA	CRAPE MYRTLE	4"	12'	15'	TO REMAIN, PROTECT IN PLACE
13	LAGERSTROEMIA INDICA	CRAPE MYRTLE	4"	10'	8'	TO REMAIN, PROTECT IN PLACE
14	LAGERSTROEMIA INDICA	CRAPE MYRTLE	4"	10'	8'	TO REMAIN, PROTECT IN PLACE
15	PINUS TORREYANA	TORREY PINE	6"	12'	15'	TO REMAIN, PROTECT IN PLACE
16	PINUS TORREYANA	TORREY PINE	6"	12'	15'	TO REMAIN, PROTECT IN PLACE
17	PINUS TORREYANA	TORREY PINE	6"	12'	15'	TO REMAIN, PROTECT IN PLACE
18	PINUS TORREYANA	TORREY PINE	6"	12'	15'	TO REMAIN, PROTECT IN PLACE
19	PINUS TORREYANA	TORREY PINE	6"	12'	15'	TO REMAIN, PROTECT IN PLACE
20	PINUS TORREYANA	TORREY PINE	6"	12'	15'	TO REMAIN, PROTECT IN PLACE
21	PINUS TORREYANA	TORREY PINE	6"	12'	15'	TO REMAIN, PROTECT IN PLACE
22	METROSIDEROS EXCELSA	NEW ZEALAND CHRISTMAS TREE	12"	8'	15'	TO REMAIN, PROTECT IN PLACE
23	METROSIDEROS EXCELSA	NEW ZEALAND CHRISTMAS TREE	8"	6'	6'	TO REMAIN, PROTECT IN PLACE
24	PINUS TORREYANA	TORREY PINE	8"	18'	15'	TO REMAIN, PROTECT IN PLACE
25	PINUS TORREYANA	TORREY PINE	6"	18'	15'	TO REMAIN, PROTECT IN PLACE
26	PINUS TORREYANA	TORREY PINE	6"	18'	15'	TO REMAIN, PROTECT IN PLACE
27	PINUS TORREYANA	TORREY PINE	6"	18'	15'	TO REMAIN, PROTECT IN PLACE
28	PINUS TORREYANA	TORREY PINE	8"	18'	15'	TO REMAIN, PROTECT IN PLACE
29	PINUS TORREYANA	TORREY PINE	8"	18'	15'	TO REMAIN, PROTECT IN PLACE
30	PINUS TORREYANA	TORREY PINE	8"	18'	15'	TO REMAIN, PROTECT IN PLACE

LANDSCAPE DEVELOPMENT PLAN - PHASE 1

1/30" = 1'

BOTANICAL NAME PINUS TORREYANA PINUS TORREYANA PINUS TORREYANA PINUS TORREYANA PINUS TORREYANA PINUS TORREYANA PINUS HALEPENSIS ARBUTUS MARINA RHUS LANCEA PITTOSPORUM SPP. PITTOSPORUM SPP. ARBUTUS MARINA ARBUTUS MARINA ARBUTUS MARINA ARBUTUS MARINA ARBUTUS MARINA ARBUTUS MARINA ARBUTUS MARINA

SYMBOL

53

60

COMMON NAME TORREY PINE TORREY PINE TORREY PINE TORREY PINE TORREY PINE TORREY PINE ALEPPO PINE STRAWBERRY TREE AFRICAN SUMAC PITTOSPORUM PITTOSPORUM STRAWBERRY TREE STRAWBERRY TREE STRAWBERRY TREE STRAWBERRY TREE STRAWBERRY TREE STRAWBERRY TREE STRAWBERRY TREE

CAL SIZI	LIPER E	HEIGHT
8"		18'
8"		18'
8"		18'
10"		18'
10"		18'
10"		18'
8"		22'
8"		22'
8"		22'
10"		24'
10"		24'
10"		24'
10"		24'
4"		7'
5"		8'
5"		8'
5"		8'
4"		6'
4"		6'
4"		7'
6" N	NULTI	12'
6" N	NULTI	15'
6" N	MULTI	15'
3"		5'
3"		5'
4"		6'
4 "		6'
3"		5'
3"		5'
3"		5'

18'

20'

20'

REMARKS SPREAD

REMARKS
TO REMAIN, PROTECT IN PLACE
TO BE REMOVED

SYMBOL

78

79

82

83

87

88

89

BOTANICAL NAME ARBUTUS MARINA FICUS BENJAMINA FICUS BENJAMINA FICUS BENJAMINA MELALEUCA NESOPHILA PINK MELALEUCA MELALEUCA NESOPHILA PINK MELALEUCA MELALEUCA NESOPHILA PINK MELALEUCA

COMMON NAME STRAWBER STRAWBER STRAWBERI STRAWBER STRAWBEF STRAWBER STRAWBER STRAWBER STRAWBER STRAWBER WEEPING F WEEPING F WEEPING F

Gensler

1 12/18/2013 2 01/27/2014 3 02/20/2014

 -

Seal/Signature

Project Name

Project Number 55.7106.016

Description

Scale As Indicated

L.101 © 2011 Gensler

NAME	CALIPER SIZE	HEIGHT	SPREAD	REMARKS
RRY TREE	3"	5'	4'	TO BE REM
RRY TREE	4"	6'	5'	TO BE REM
RRY TREE	4"	6'	5'	TO BE REM
RRY TREE	4 "	6'	5'	TO BE REM
RRY TREE	4 "	6'	5'	TO BE REM
RRY TREE	4"	6'	5'	TO BE REM
RRY TREE	4"	6'	5'	TO BE REM
RRY TREE	4"	6'	5'	TO BE REM
RRY TREE	4"	6'	5'	TO BE REM
RRY TREE	4"	6'	4'	TO REMAIN
RRY TREE	4"	7'	5'	TO REMAIN
RRY TREE	4 "	7'	5'	TO REMAIN
RRY TREE	4"	7'	5'	TO REMAIN
RRY TREE	4"	7'	5'	TO REMAIN
RRY TREE	4 "	7'	5'	TO REMAIN
RRY TREE	4"	7'	5'	TO REMAIN
RRY TREE	4"	6'	7'	TO REMAIN
RRY TREE	4"	6'	7'	TO REMAIN
RRY TREE	4 "	6'	7'	TO REMAIN
RRY TREE	4"	6'	7'	TO REMAIN
RRY TREE	4 ["]	6'	7'	TO REMAIN
RRY TREE	4"	6'	7'	TO REMAIN
RRY TREE	4"	6'	7'	TO REMAI
FIG	6"	20'	20'	TO REMAIN
FIG	6"	20'	20'	TO REMAI
FIG	6"	20'	20'	TO REMAII
ALEUCA	6"	5'	5'	TO REMAII

5'

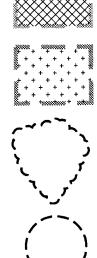
5'

6"

5'

5'

TO BE REMOVED TO REMAIN, PROTECT IN PLACE SYMBOL



DESCRIPTION

EXISTING SHRUBS, GROUND COVERS TO REMAIN, PROTECT IN PLACE EXISTING IRRIGATION TO BE MODIFIED, PROTECT IN PLACE

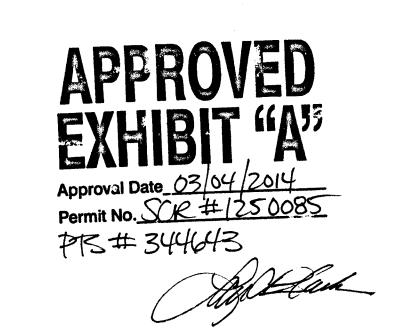
120

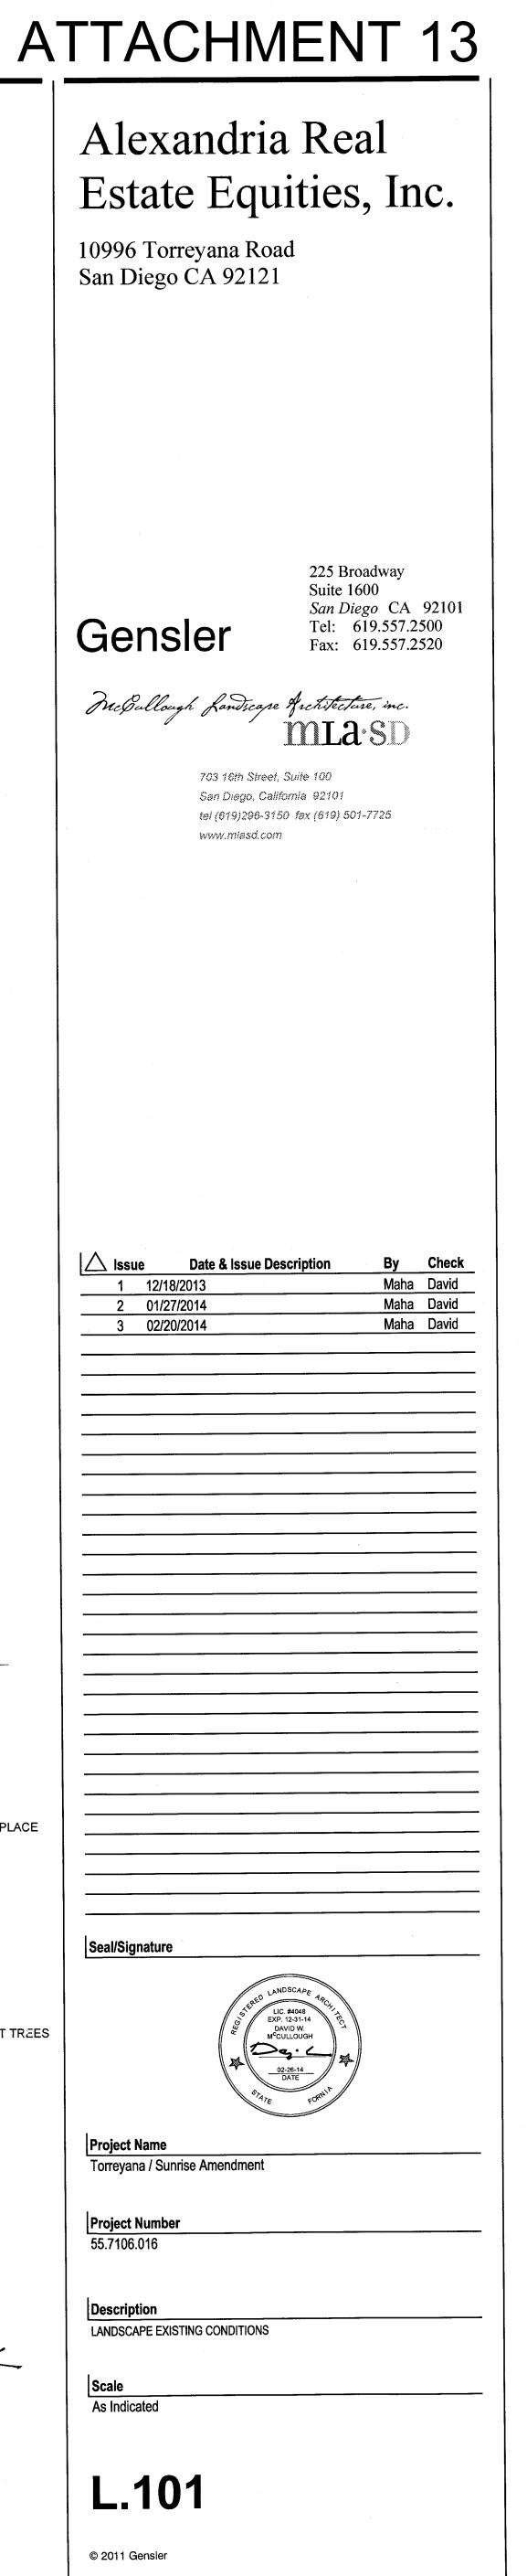
EXISTING SHRUBS AND GROUND COVERS AND IRRIGATION TO BE REMOVED

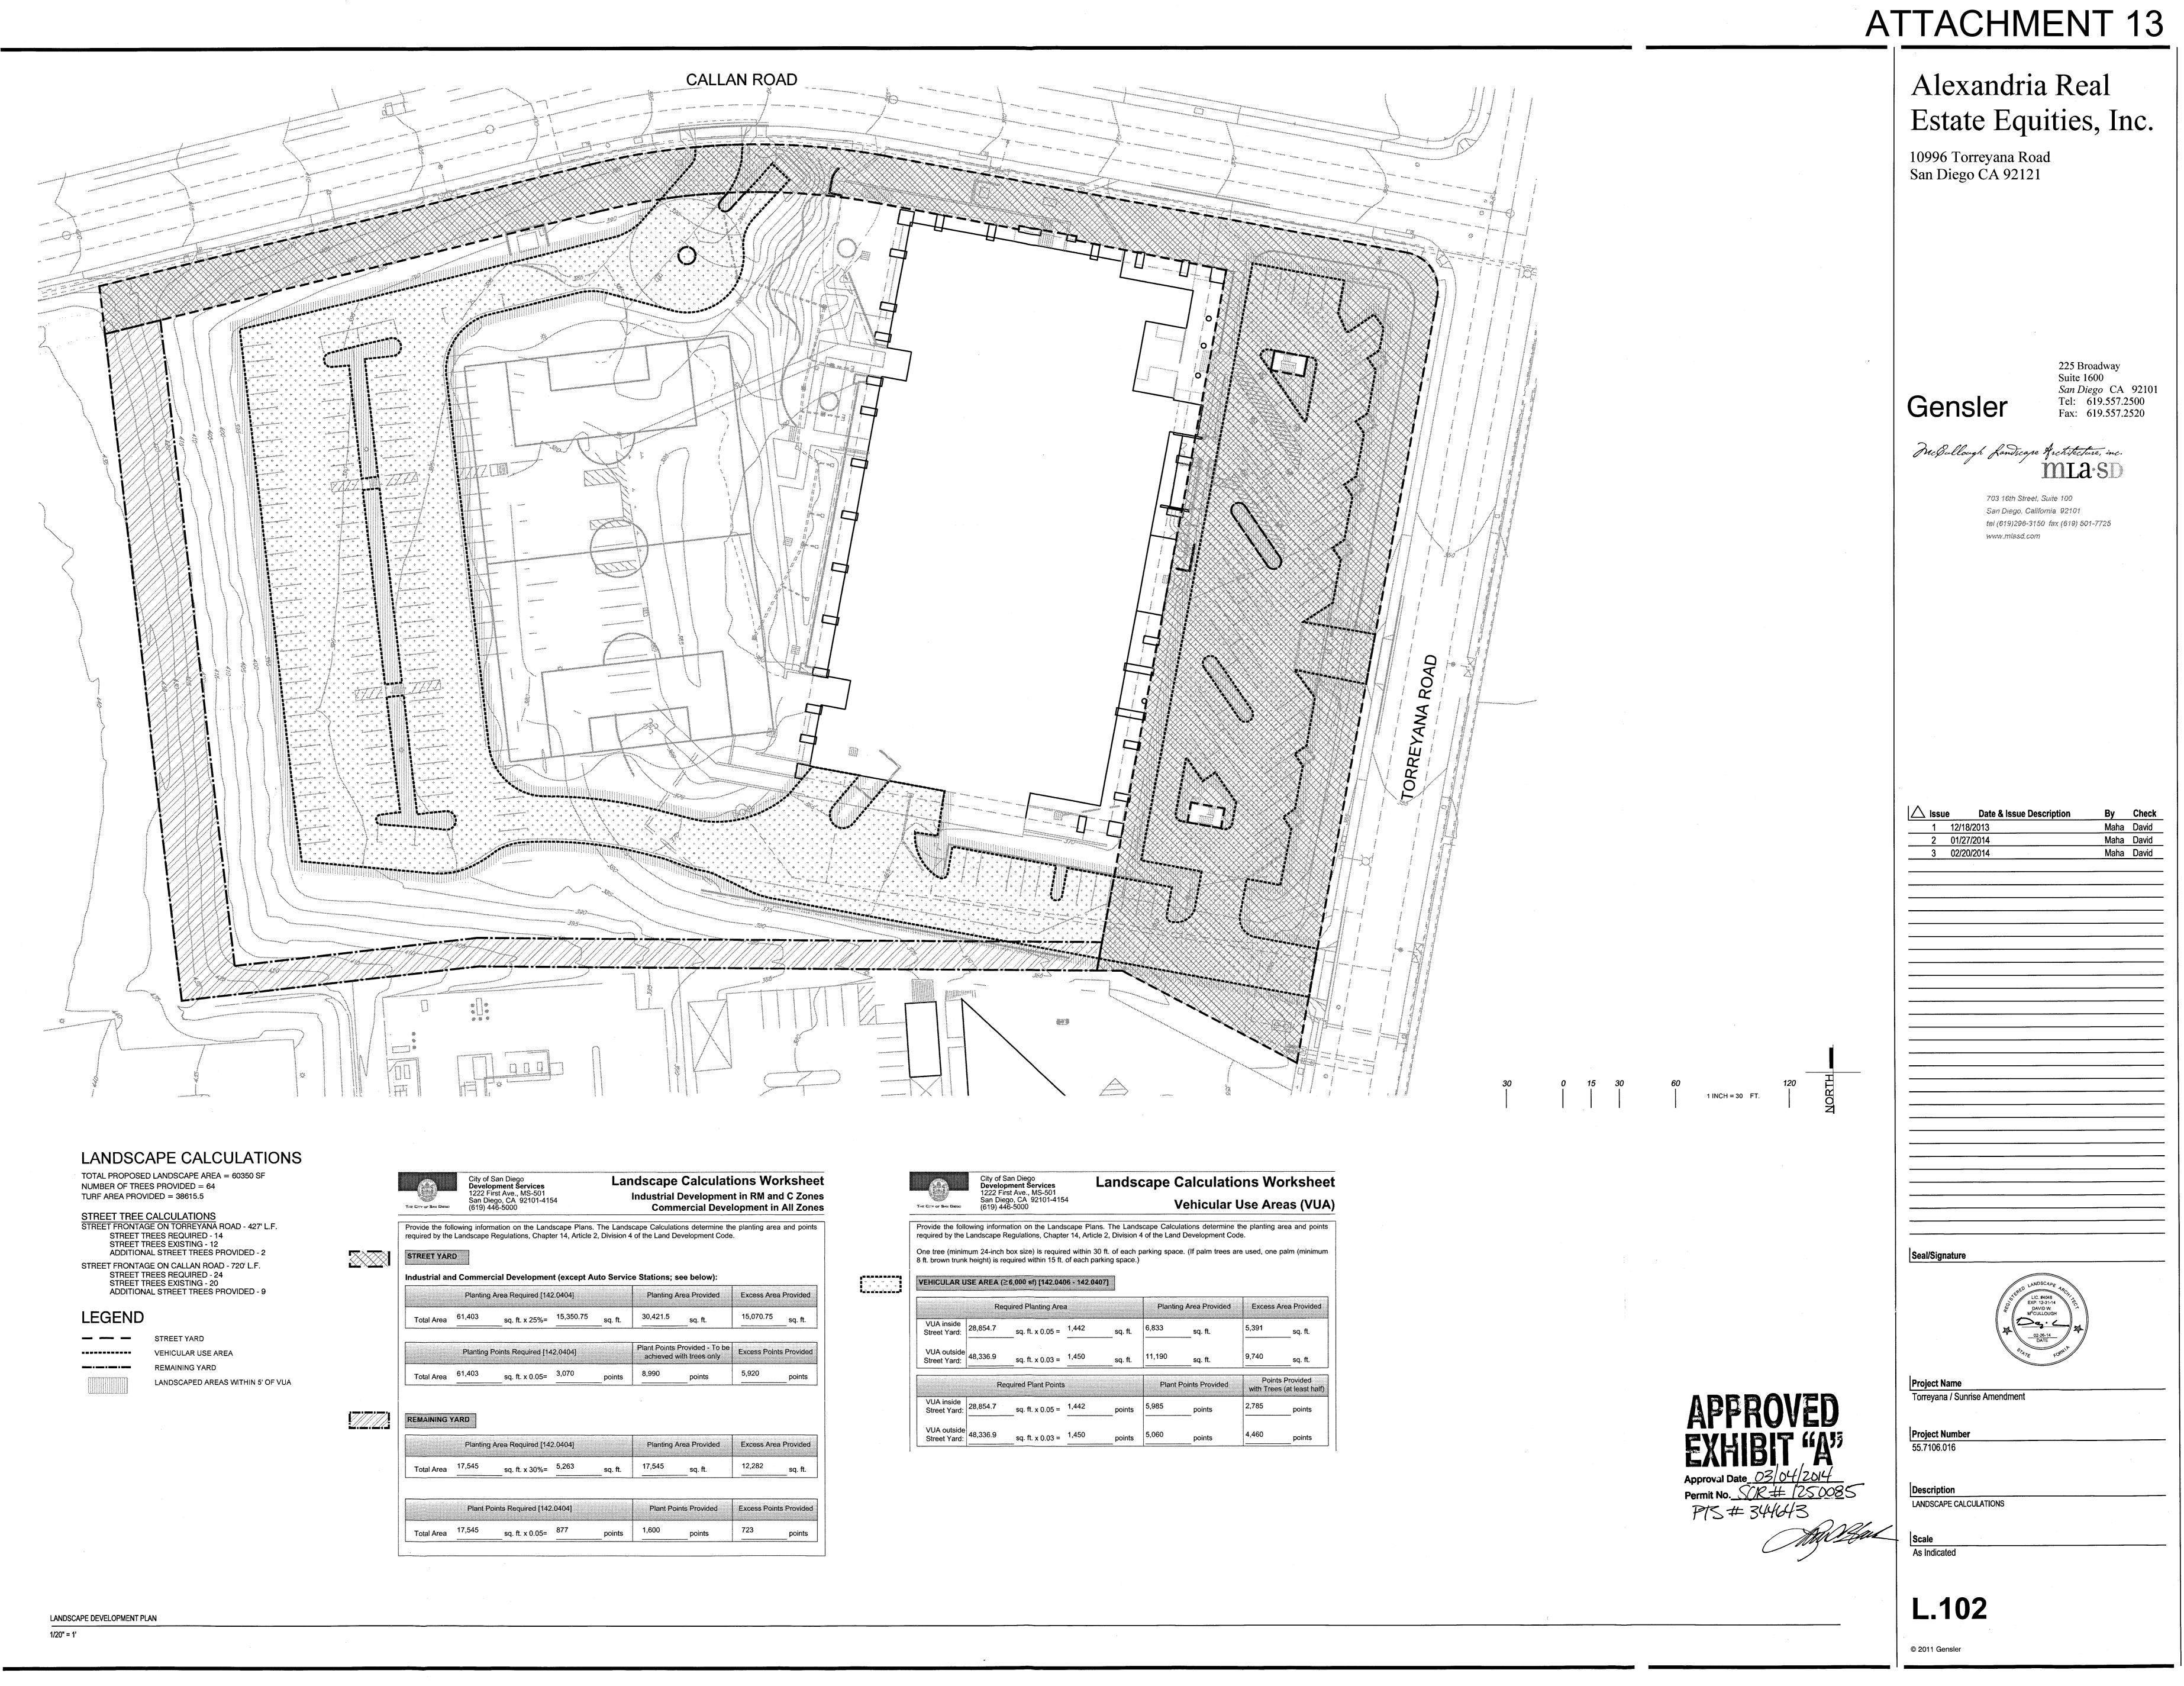
1 INCH = 30 FT.

EXISTING DENSE TREES OUTSIDE LIMIT OF WORK TO REMAIN, PROTECT IN PLACE

EXISTING TREES WITHIN LIMIT OF WORK AND STREET TREES SEE EXISTING TREE LEGEND FOR SPECIES

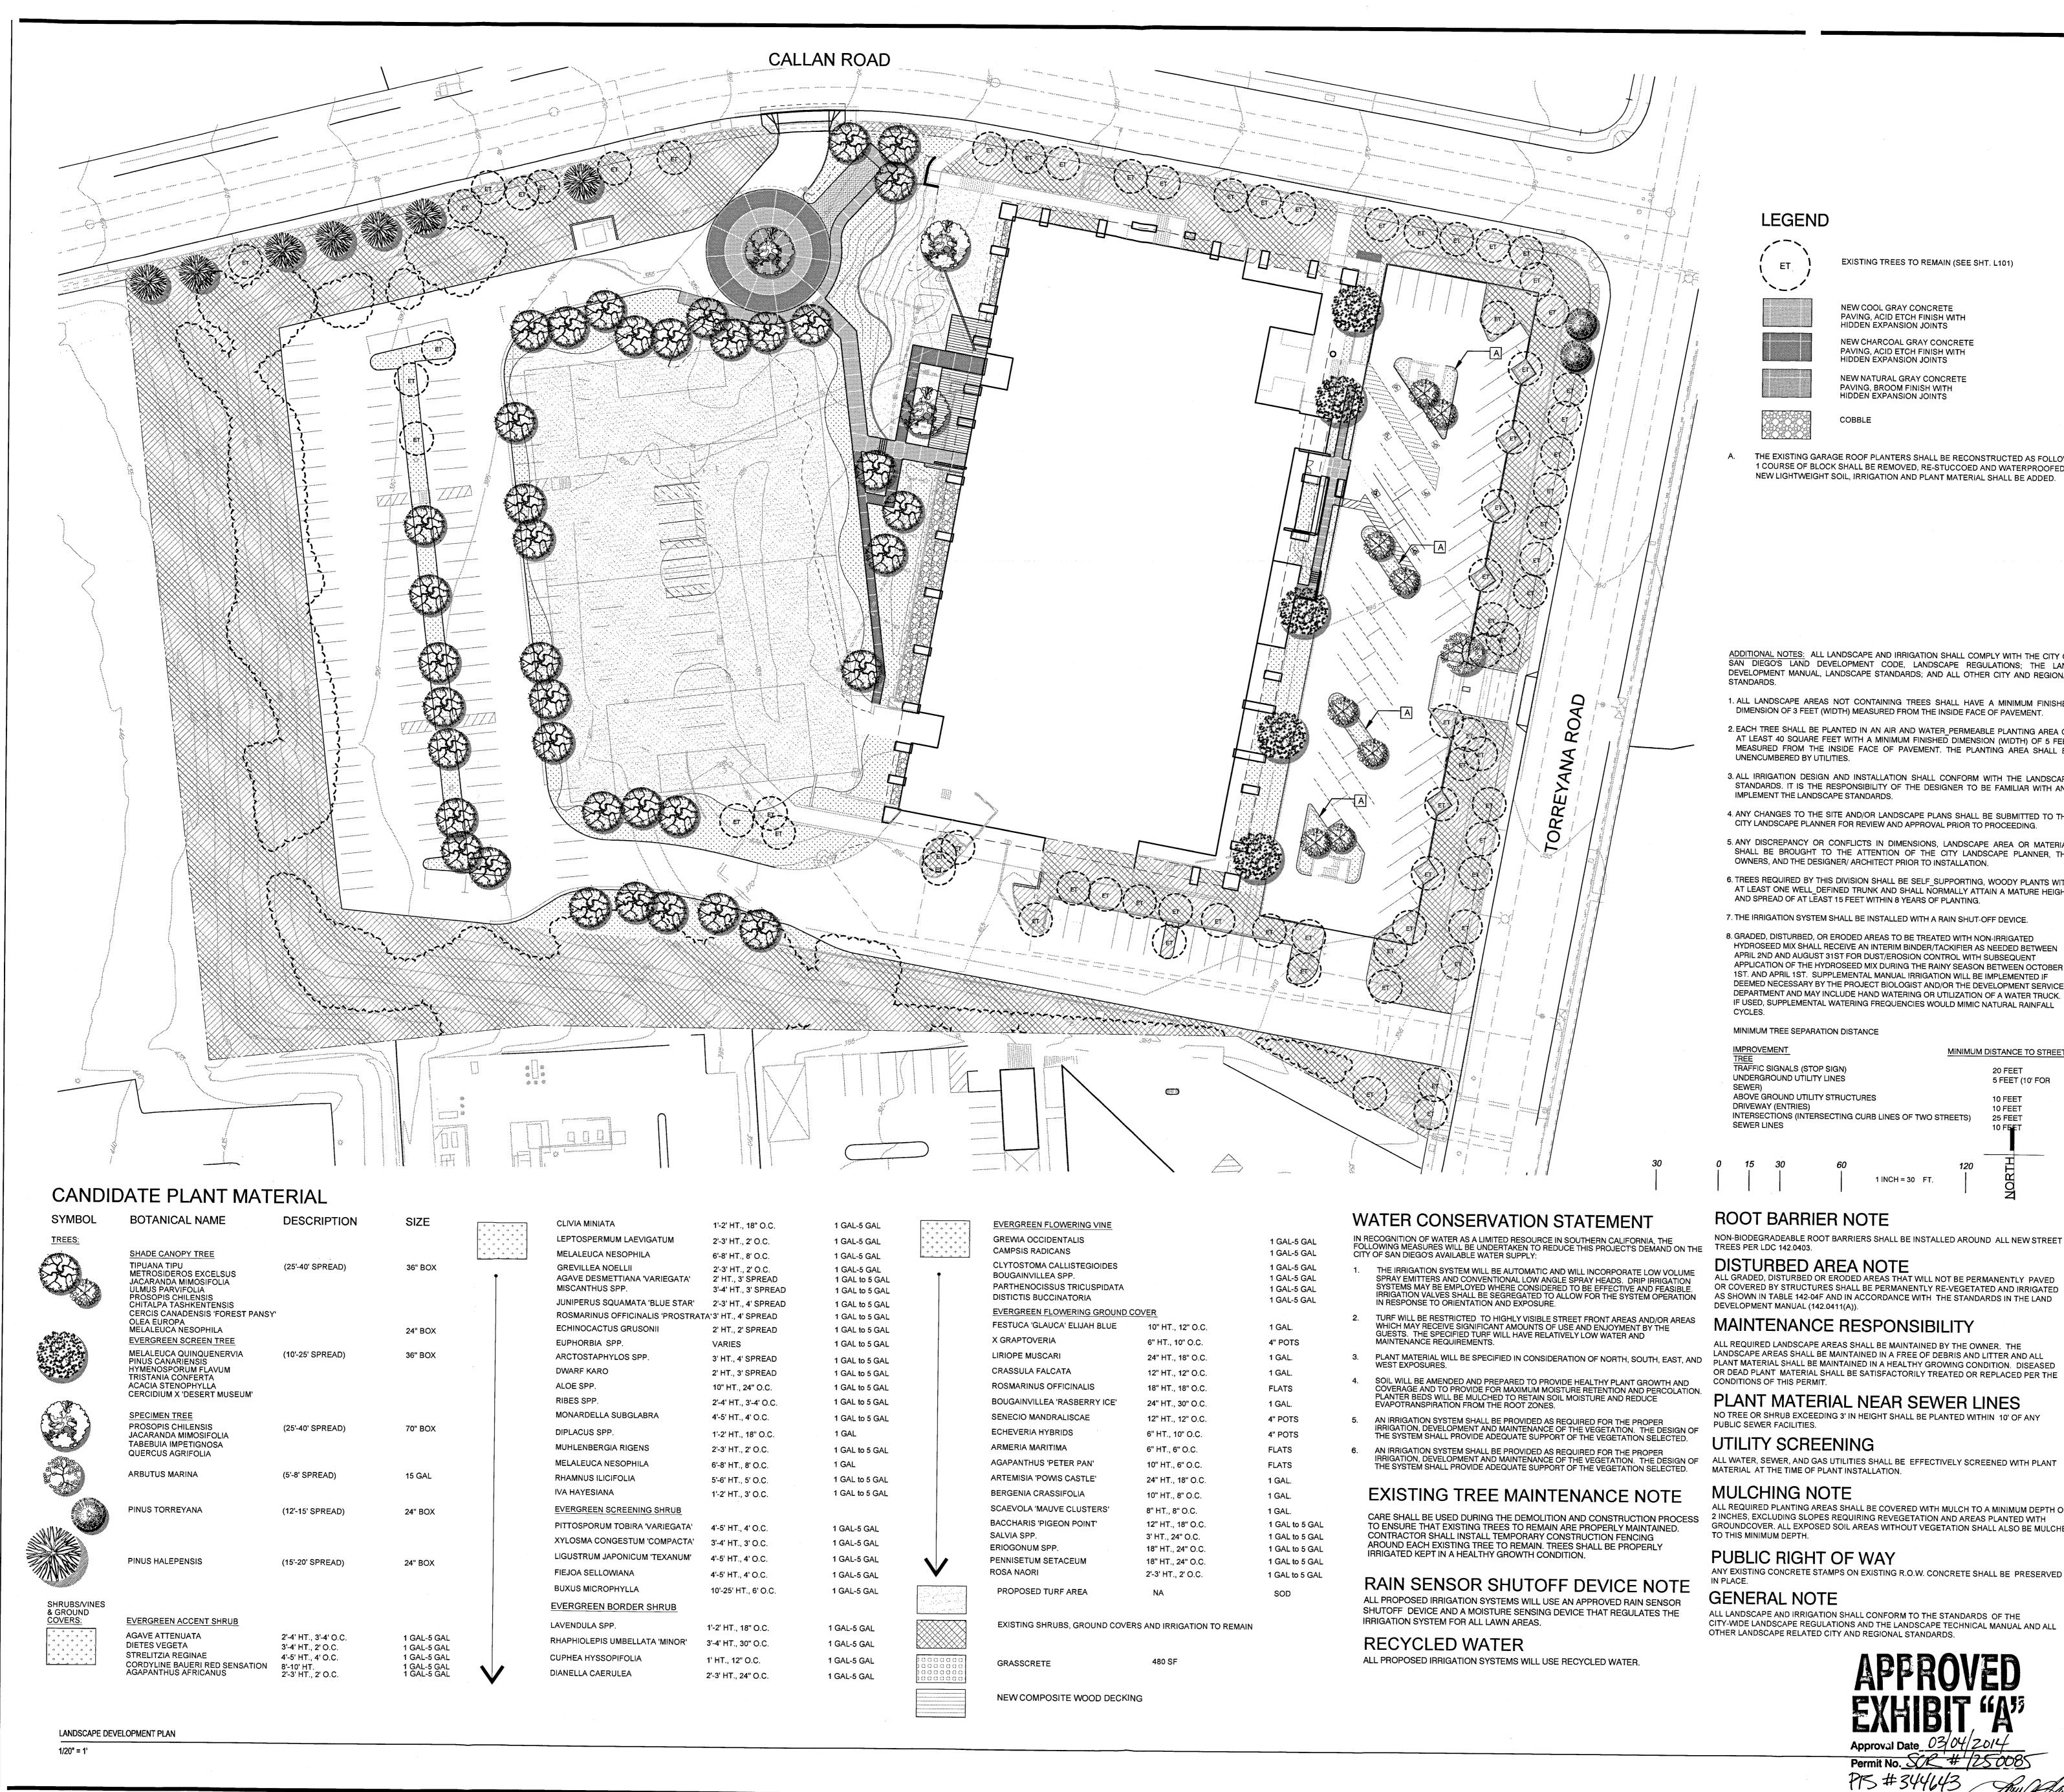






andscape Plans. The napter 14, Article 2, Div					All Zone
.,		of the Land Dev	elopment Code		and points
nent (except Auto : [142.0404]	Servic	e Stations; se	-	Excess Area	Provided
%= <u>15,350.75</u> s	q. ft.	30,421.5	sq. ft.	15,070.75	sq. ft.
1 [142.0404]		Plant Points Pr achieved wit		Excess Points	Provided
5= ^{3,070} po	oints	8,990	points	5,920	points
[142.0404]		Planting Are	a Provided	Excess Area	Provided
%= <u>5,263</u> so	q. ft <i>.</i>	17,545	_sq. ft.	12,282	sq. ft.
142.0404]		Plant Point	s Provided	Excess Points	Provided
5= ⁸⁷⁷ p	oints	1,600	_points	723	points

8	Develo 1222 Fi	San Diego p ment Services rst Ave., MS-501		Landso	cape (Calculatio	on
HE DOY OF SAN ENDEDC	San Die (619) 44	ego, CA 92101-415 46-5000	54		١	/ehicular	Us
equired by the L One tree (minimi ft. brown trunk	andscape f um 24-inch height) is re	nation on the Land Regulations, Chapt box size) is requir equired within 15 ft.	er 14, Articl ed within 30 of each pa	e 2, Division 4 0 ft. of each p rking space.)	l of the Land	d Development Co	de.
VEHICULAR US		≥ 6,000 st) [142.04 quired Planting Are		07]	Plantir	ig Area Provided	
VUA inside , Street Yard:	28,854.7	sq. ft. x 0.05 =	1,442	sq. ft.	6,833	sq <i>.</i> ft.	5,3
VUA outside Street Yard:	48,336.9	sq. ft. x 0.03 =	1,450	sq. ft.	11,190	sq. ft.	9,7
	Re	quired Plant Points	3		Plant	Points Provided	N
VUA inside Street Yard:	28,854.7	sq. ft. x 0.05 =	1,442	points	5,985	points	2,7



ATTACHMENT 13

LEGEND

EXISTING TREES TO REMAIN (SEE SHT, L101)

COBBLE

NEW COOL GRAY CONCRETE PAVING, ACID ETCH FINISH WITH HIDDEN EXPANSION JOINTS NEW CHARCOAL GRAY CONCRETE PAVING, ACID ETCH FINISH WITH HIDDEN EXPANSION JOINTS NEW NATURAL GRAY CONCRETE PAVING, BROOM FINISH WITH HIDDEN EXPANSION JOINTS

THE EXISTING GARAGE ROOF PLANTERS SHALL BE RECONSTRUCTED AS FOLLOWS : 1 COURSE OF BLOCK SHALL BE REMOVED, RE-STUCCOED AND WATERPROOFED. NEW LIGHTWEIGHT SOIL, IRRIGATION AND PLANT MATERIAL SHALL BE ADDED.

ADDITIONAL NOTES: ALL LANDSCAPE AND IRRIGATION SHALL COMPLY WITH THE CITY OF SAN DIEGO'S LAND DEVELOPMENT CODE, LANDSCAPE REGULATIONS; THE LAND DEVELOPMENT MANUAL, LANDSCAPE STANDARDS; AND ALL OTHER CITY AND REGIONAL STANDARDS. 1. ALL LANDSCAPE AREAS NOT CONTAINING TREES SHALL HAVE A MINIMUM FINISHED DIMENSION OF 3 FEET (WIDTH) MEASURED FROM THE INSIDE FACE OF PAVEMENT.

- 2. EACH TREE SHALL BE PLANTED IN AN AIR AND WATER_PERMEABLE PLANTING AREA OF AT LEAST 40 SQUARE FEET WITH A MINIMUM FINISHED DIMENSION (WIDTH) OF 5 FEET MEASURED FROM THE INSIDE FACE OF PAVEMENT. THE PLANTING AREA SHALL BE UNENCUMBERED BY UTILITIES. 3. ALL IRRIGATION DESIGN AND INSTALLATION SHALL CONFORM WITH THE LANDSCAPE
- STANDARDS. IT IS THE RESPONSIBILITY OF THE DESIGNER TO BE FAMILIAR WITH AND IMPLEMENT THE LANDSCAPE STANDARDS. 4. ANY CHANGES TO THE SITE AND/OR LANDSCAPE PLANS SHALL BE SUBMITTED TO THE
- CITY LANDSCAPE PLANNER FOR REVIEW AND APPROVAL PRIOR TO PROCEEDING. 5. ANY DISCREPANCY OR CONFLICTS IN DIMENSIONS, LANDSCAPE AREA OR MATERIAL SHALL BE BROUGHT TO THE ATTENTION OF THE CITY LANDSCAPE PLANNER, THE OWNERS, AND THE DESIGNER/ ARCHITECT PRIOR TO INSTALLATION.
- 6. TREES REQUIRED BY THIS DIVISION SHALL BE SELF_SUPPORTING, WOODY PLANTS WITH AT LEAST ONE WELL_DEFINED TRUNK AND SHALL NORMALLY ATTAIN A MATURE HEIGHT AND SPREAD OF AT LEAST 15 FEET WITHIN 8 YEARS OF PLANTING.
- 7. THE IRRIGATION SYSTEM SHALL BE INSTALLED WITH A RAIN SHUT-OFF DEVICE. 8. GRADED, DISTURBED, OR ERODED AREAS TO BE TREATED WITH NON-IRRIGATED HYDROSEED MIX SHALL RECEIVE AN INTERIM BINDER/TACKIFIER AS NEEDED BETWEEN APRIL 2ND AND AUGUST 31ST FOR DUST/EROSION CONTROL WITH SUBSEQUENT APPLICATION OF THE HYDROSEED MIX DURING THE RAINY SEASON BETWEEN OCTOBER 1ST. AND APRIL 1ST. SUPPLEMENTAL MANUAL IRRIGATION WILL BE IMPLEMENTED IF DEEMED NECESSARY BY THE PROJECT BIOLOGIST AND/OR THE DEVELOPMENT SERVICES DEPARTMENT AND MAY INCLUDE HAND WATERING OR UTILIZATION OF A WATER TRUCK. IF USED, SUPPLEMENTAL WATERING FREQUENCIES WOULD MIMIC NATURAL RAINFALL CYCLES.

MINIMUM TREE SEPARATION DISTANCE MPROVEMENT TRAFFIC SIGNALS (STOP SIGN) UNDERGROUND UTILITY LINES SEWER) ABOVE GROUND UTILITY STRUCTURES

DRIVEWAY (ENTRIES)

SEWER LINES

20 FEET 5 FEET (10' FOR 10 FEET 10 FEET INTERSECTIONS (INTERSECTING CURB LINES OF TWO STREETS) 25 FEET

10 FFF

MINIMUM DISTANCE TO STREET

ROOT BARRIER NOTE

NON-BIODEGRADEABLE ROOT BARRIERS SHALL BE INSTALLED AROUND ALL NEW STREET TREES PER LDC 142.0403. DISTURBED AREA NOTE ALL GRADED, DISTURBED OR ERODED AREAS THAT WILL NOT BE PERMANENTLY PAVED OR COVERED BY STRUCTURES SHALL BE PERMANENTLY RE-VEGETATED AND IRRIGATED AS SHOWN IN TABLE 142-04F AND IN ACCORDANCE WITH THE STANDARDS IN THE LAND DEVELOPMENT MANUAL (142.0411(A)). MAINTENANCE RESPONSIBILITY

1 INCH = 30 FT.

ALL REQUIRED LANDSCAPE AREAS SHALL BE MAINTAINED BY THE OWNER. THE LANDSCAPE AREAS SHALL BE MAINTAINED IN A FREE OF DEBRIS AND LITTER AND ALL OR DEAD PLANT MATERIAL SHALL BE SATISFACTORILY TREATED OR REPLACED PER THE CONDITIONS OF THIS PERMIT.

PLANT MATERIAL NEAR SEWER LINES NO TREE OR SHRUB EXCEEDING 3' IN HEIGHT SHALL BE PLANTED WITHIN 10' OF ANY PUBLIC SEWER FACILITIES.

UTILITY SCREENING MULCHING NOTE

ALL REQUIRED PLANTING AREAS SHALL BE COVERED WITH MULCH TO A MINIMUM DEPTH OF 2 INCHES, EXCLUDING SLOPES REQUIRING REVEGETATION AND AREAS PLANTED WITH GROUNDCOVER. ALL EXPOSED SOIL AREAS WITHOUT VEGETATION SHALL ALSO BE MULCHED TO THIS MINIMUM DEPTH.

PUBLIC RIGHT OF WAY ANY EXISTING CONCRETE STAMPS ON EXISTING R.O.W. CONCRETE SHALL BE PRESERVED IN PLACE.

GENERAL NOTE ALL LANDSCAPE AND IRRIGATION SHALL CONFORM TO THE STANDARDS OF THE CITY-WIDE LANDSCAPE REGULATIONS AND THE LANDSCAPE TECHNICAL MANUAL AND ALL OTHER LANDSCAPE RELATED CITY AND REGIONAL STANDARDS.



PTS #344643

1 12/18/2013 <u>2 01/27/2014</u> 3 02/20/2014

 Seal/Signa	tur

Project Name

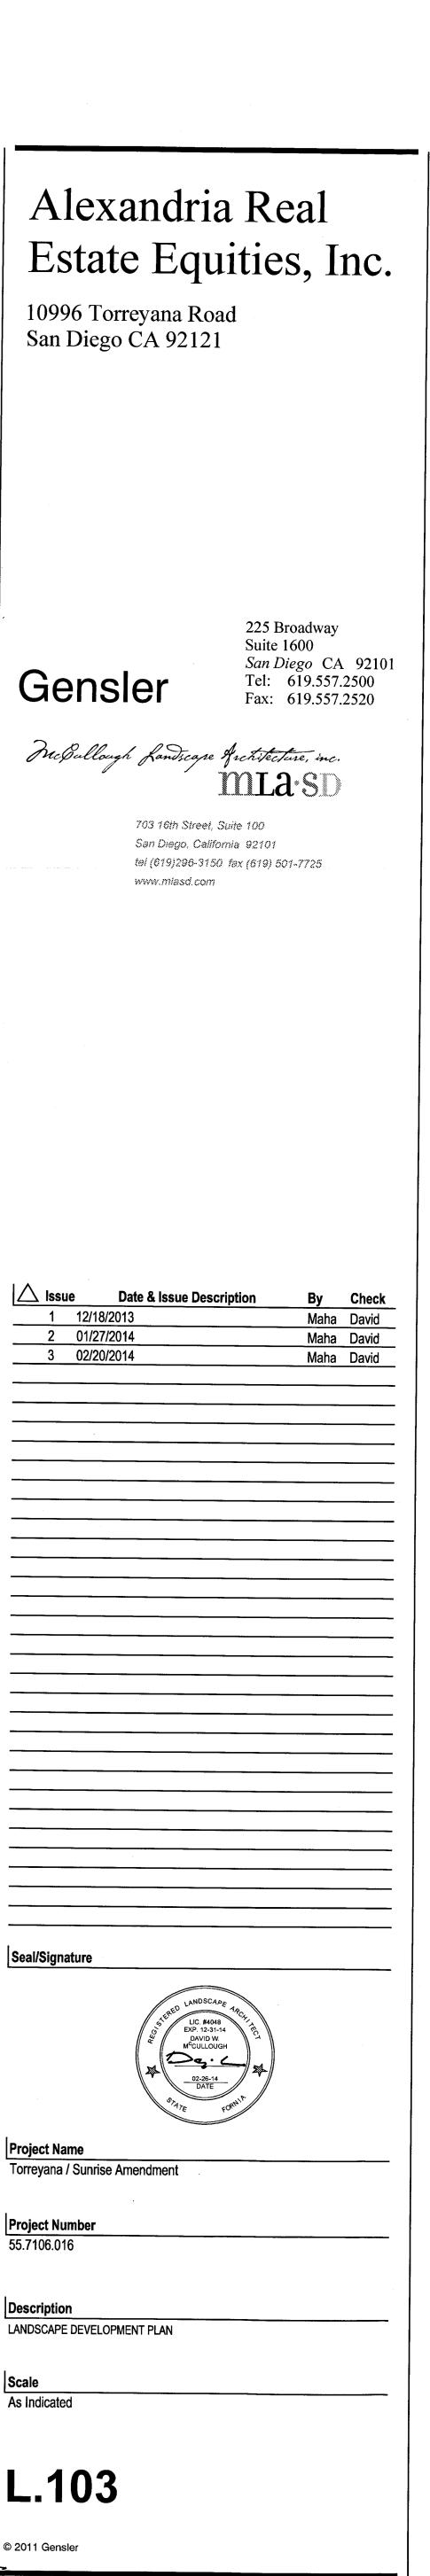
Project Number

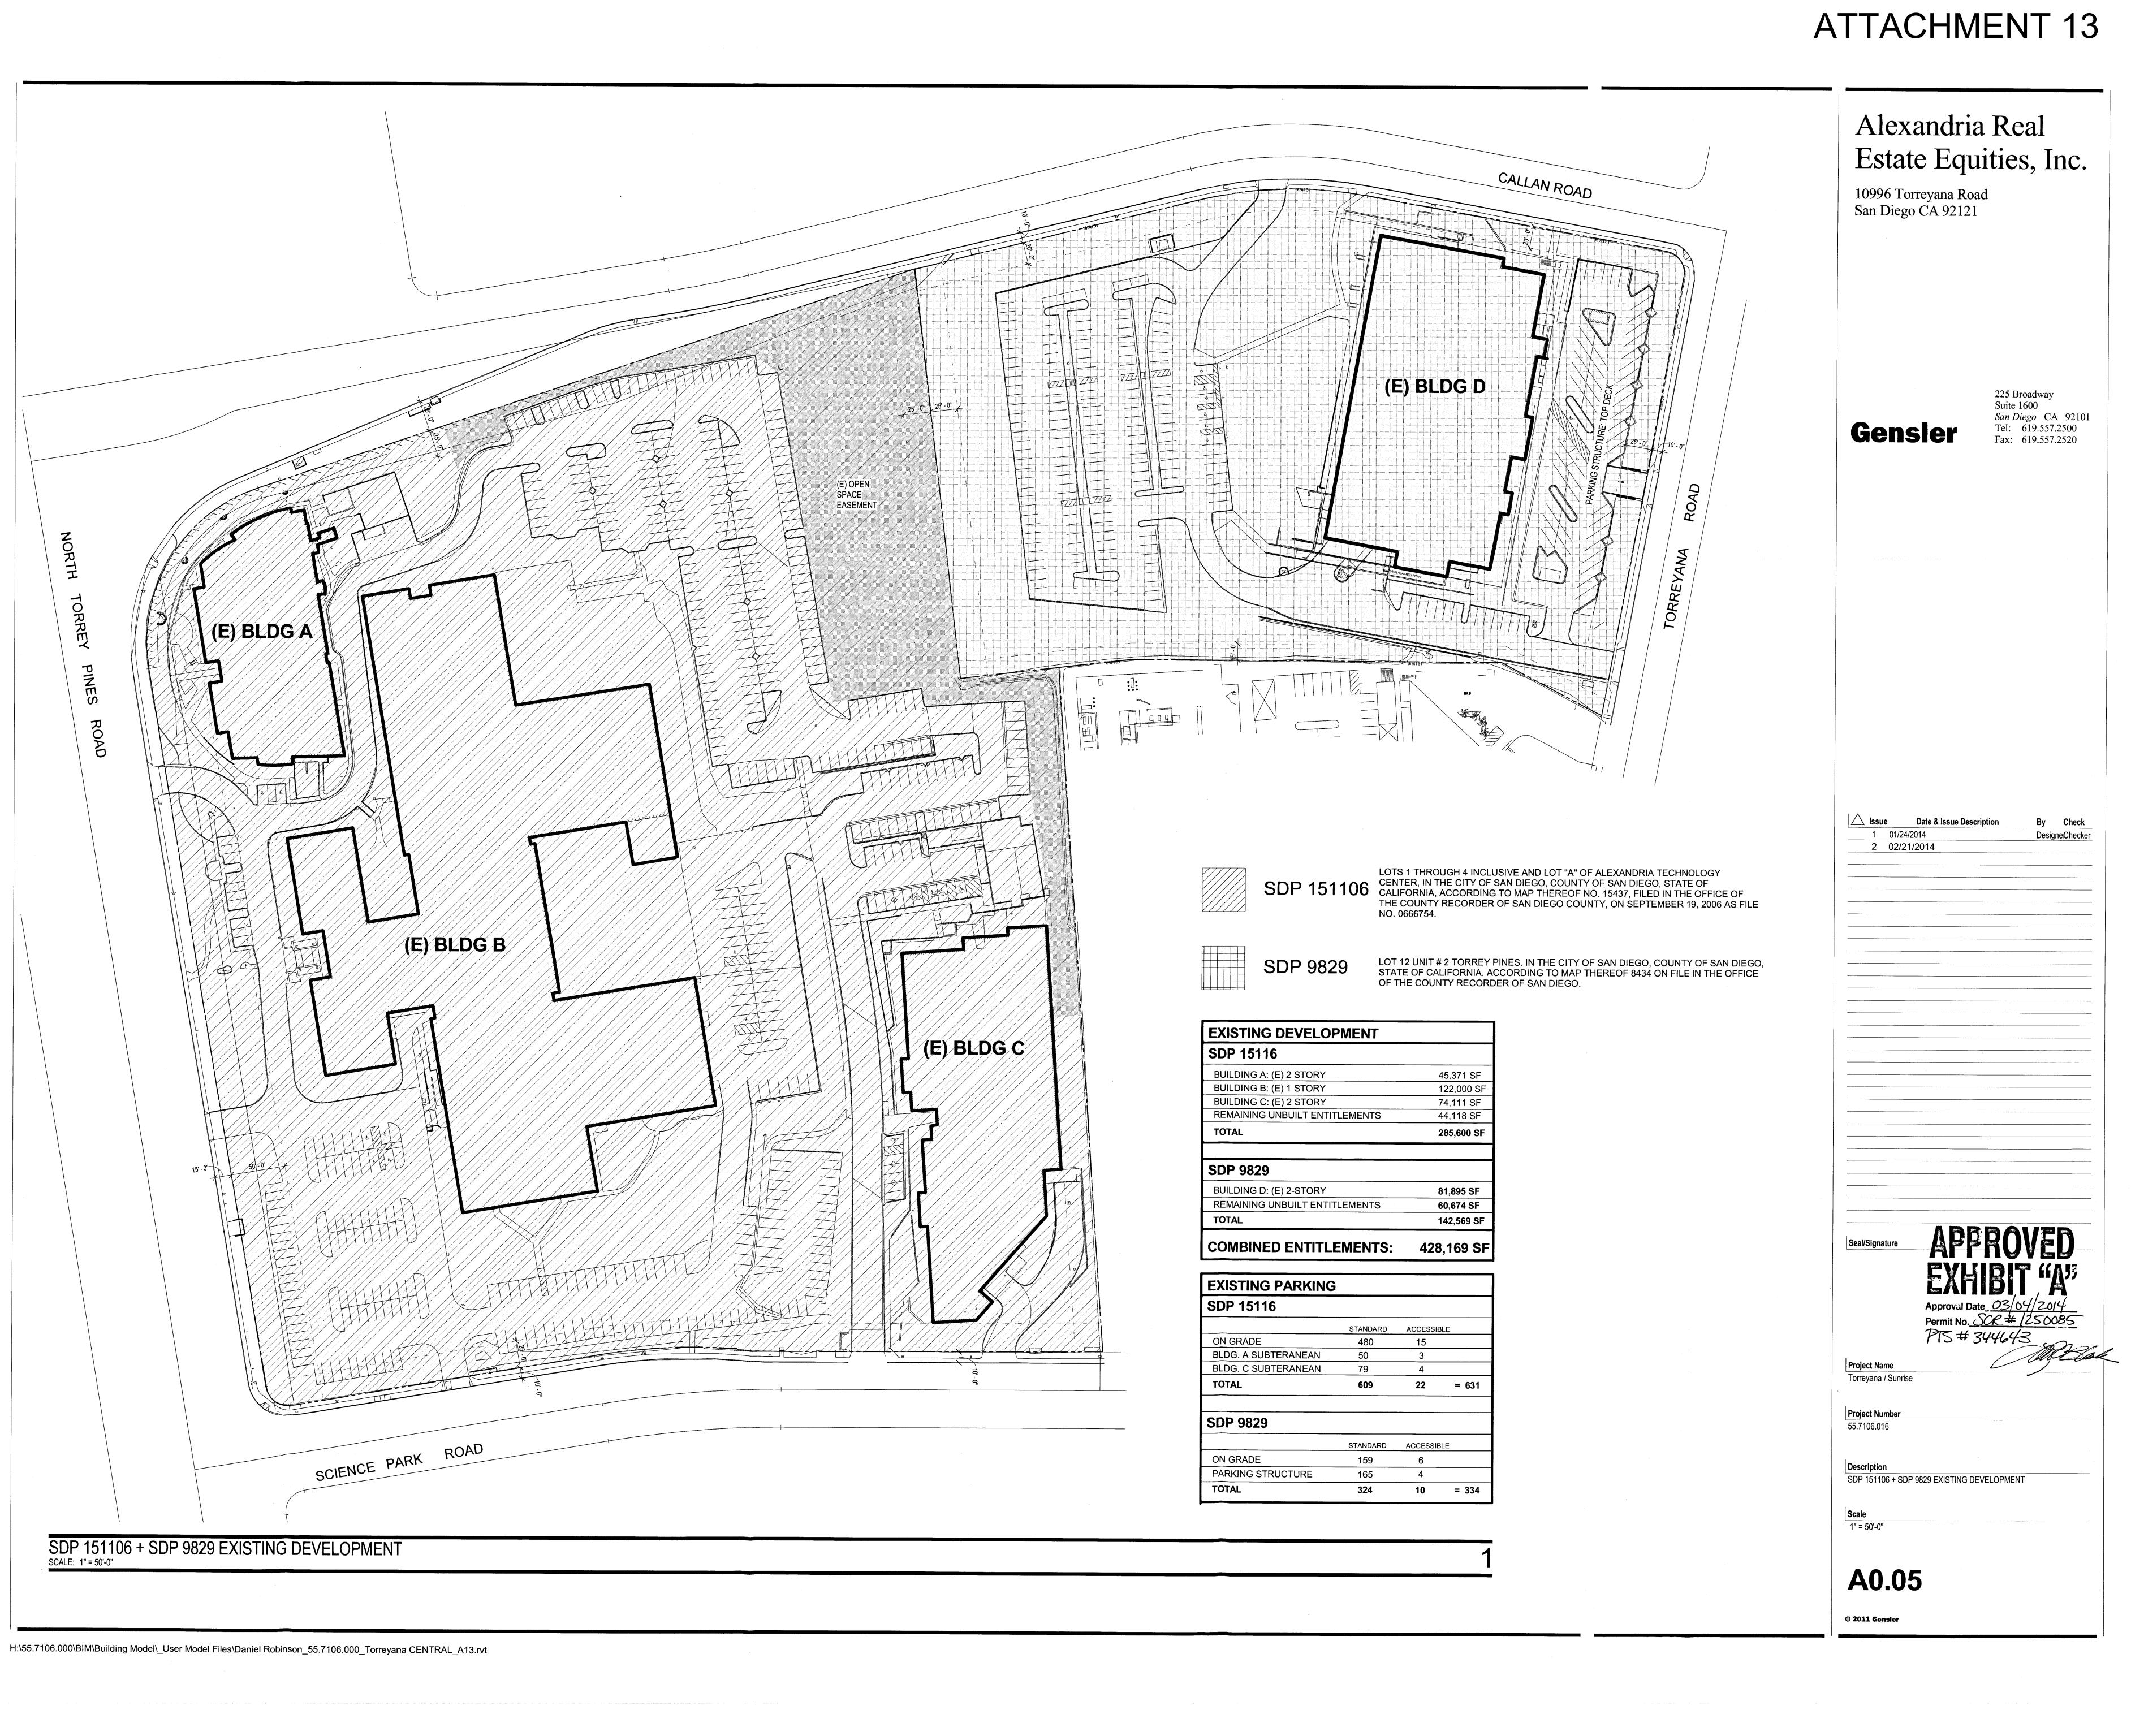
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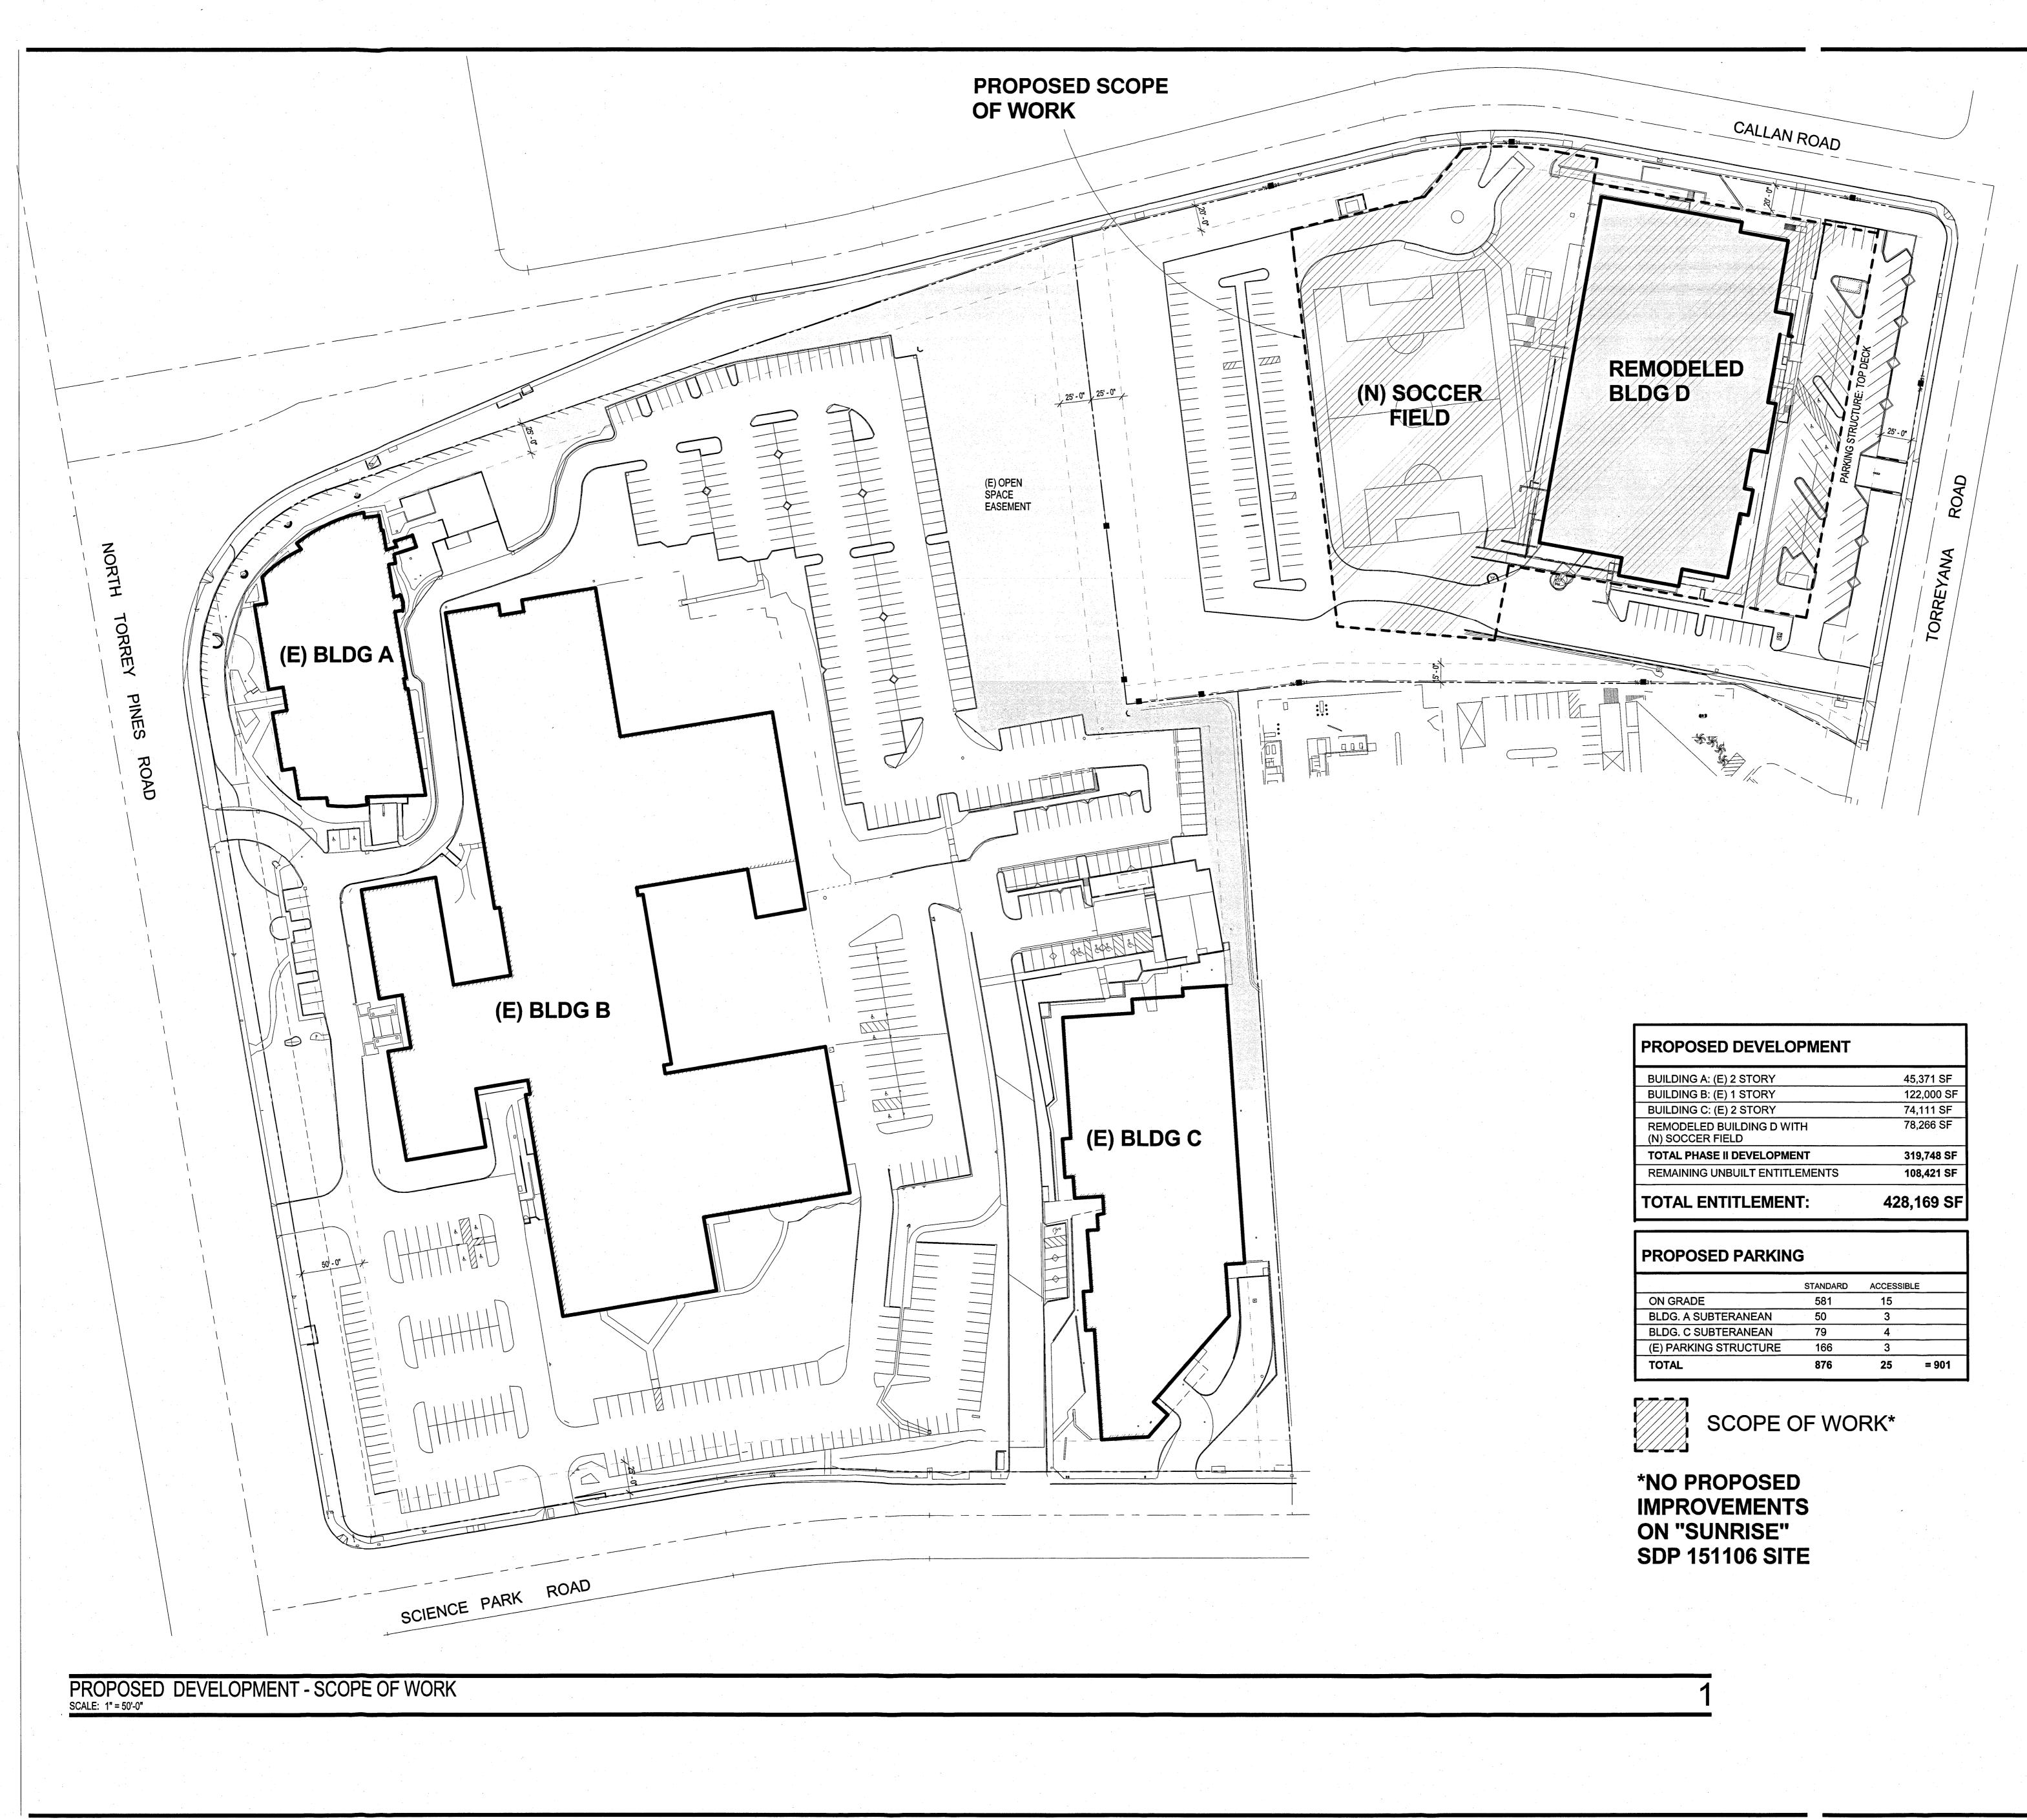
Description

Scale As Indicated

L.103 © 2011 Gensler



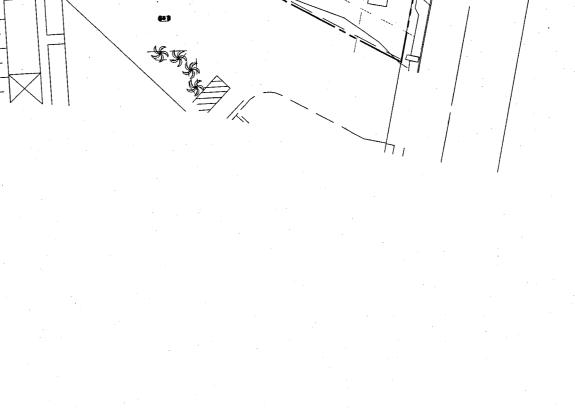


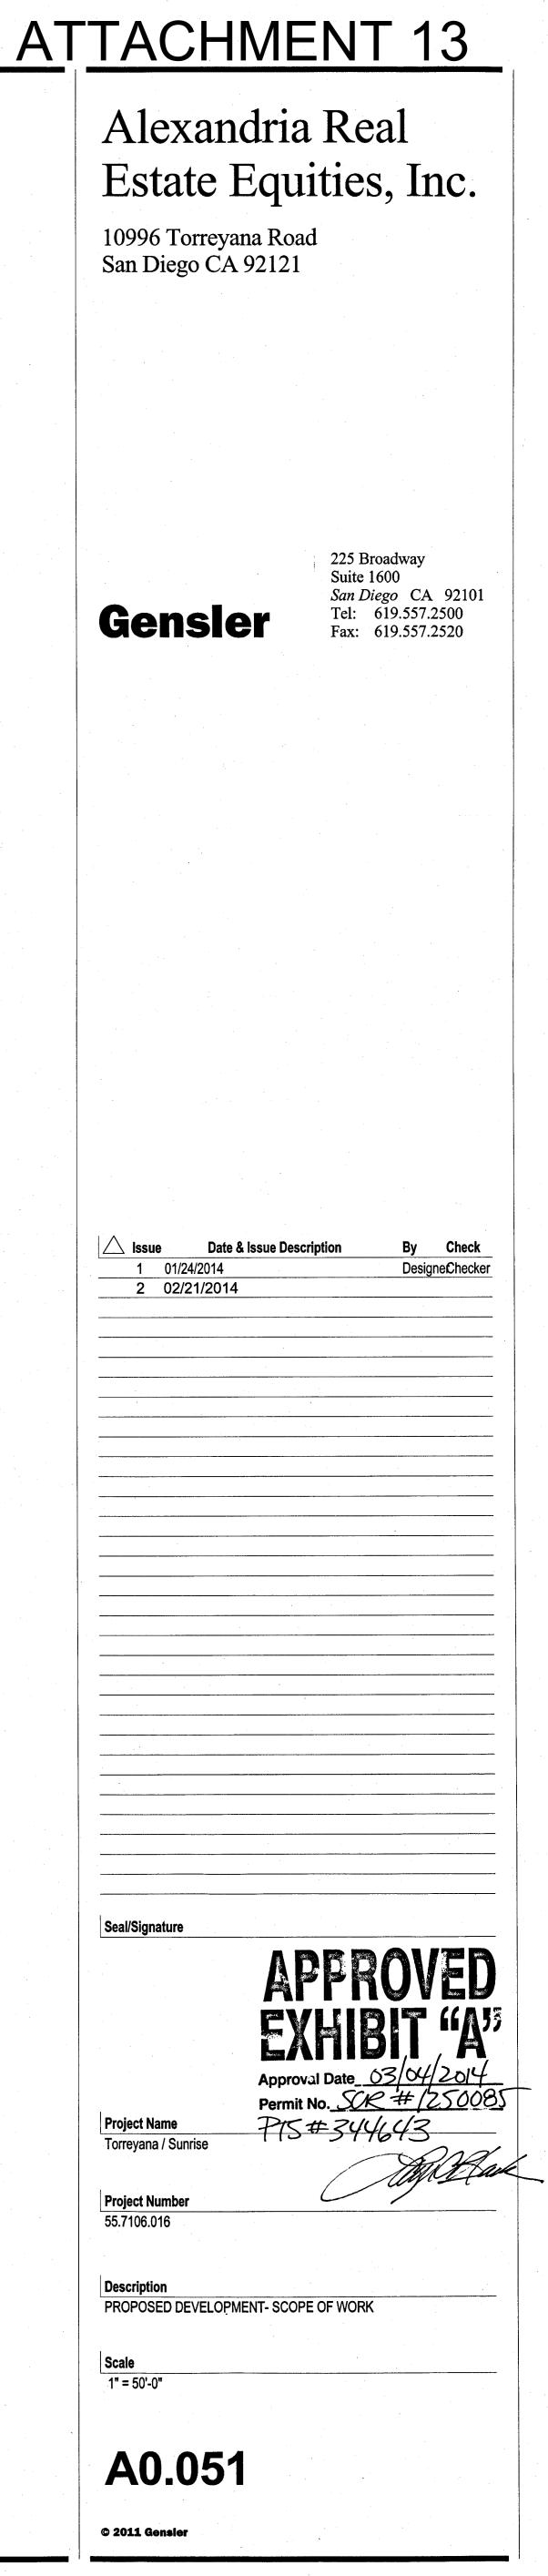




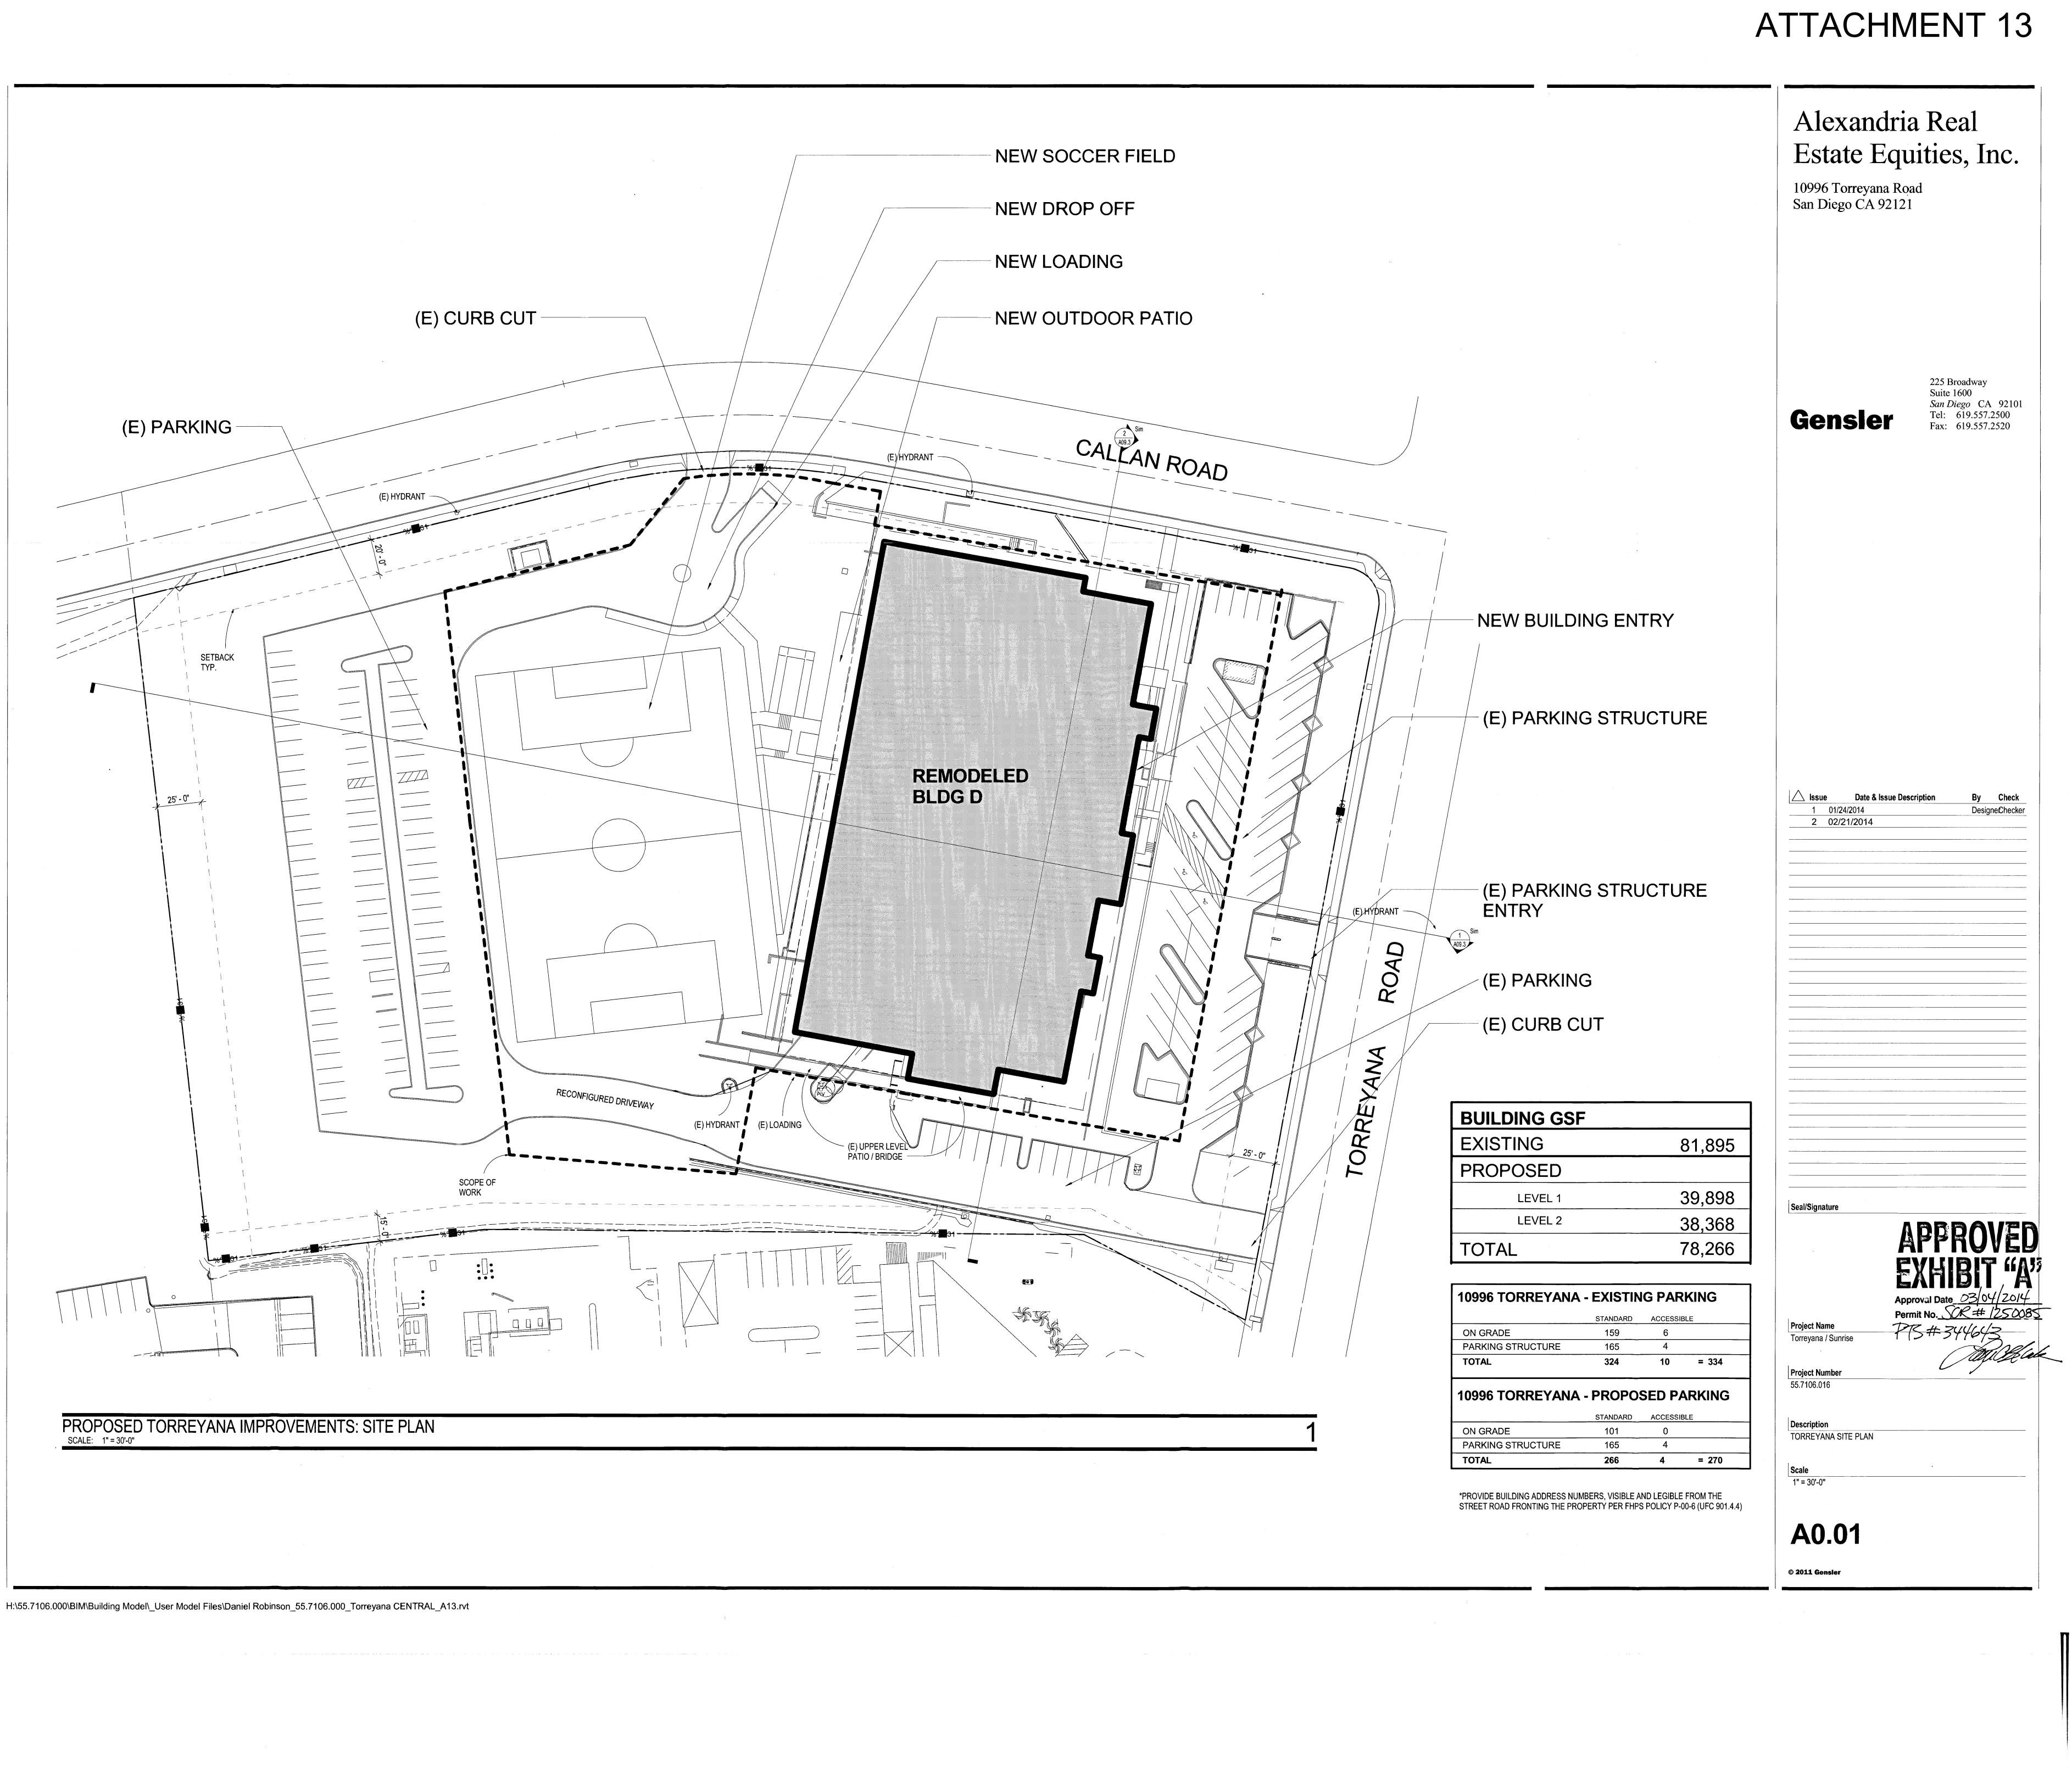
PROPOSED PARKING				
	STANDARD	ACCESSIBLE		
ON GRADE	581	15		
BLDG. A SUBTERANEAN	50	3		
BLDG. C SUBTERANEAN	79	4		
(E) PARKING STRUCTURE	166	3		
TOTAL	876	25	= 901	

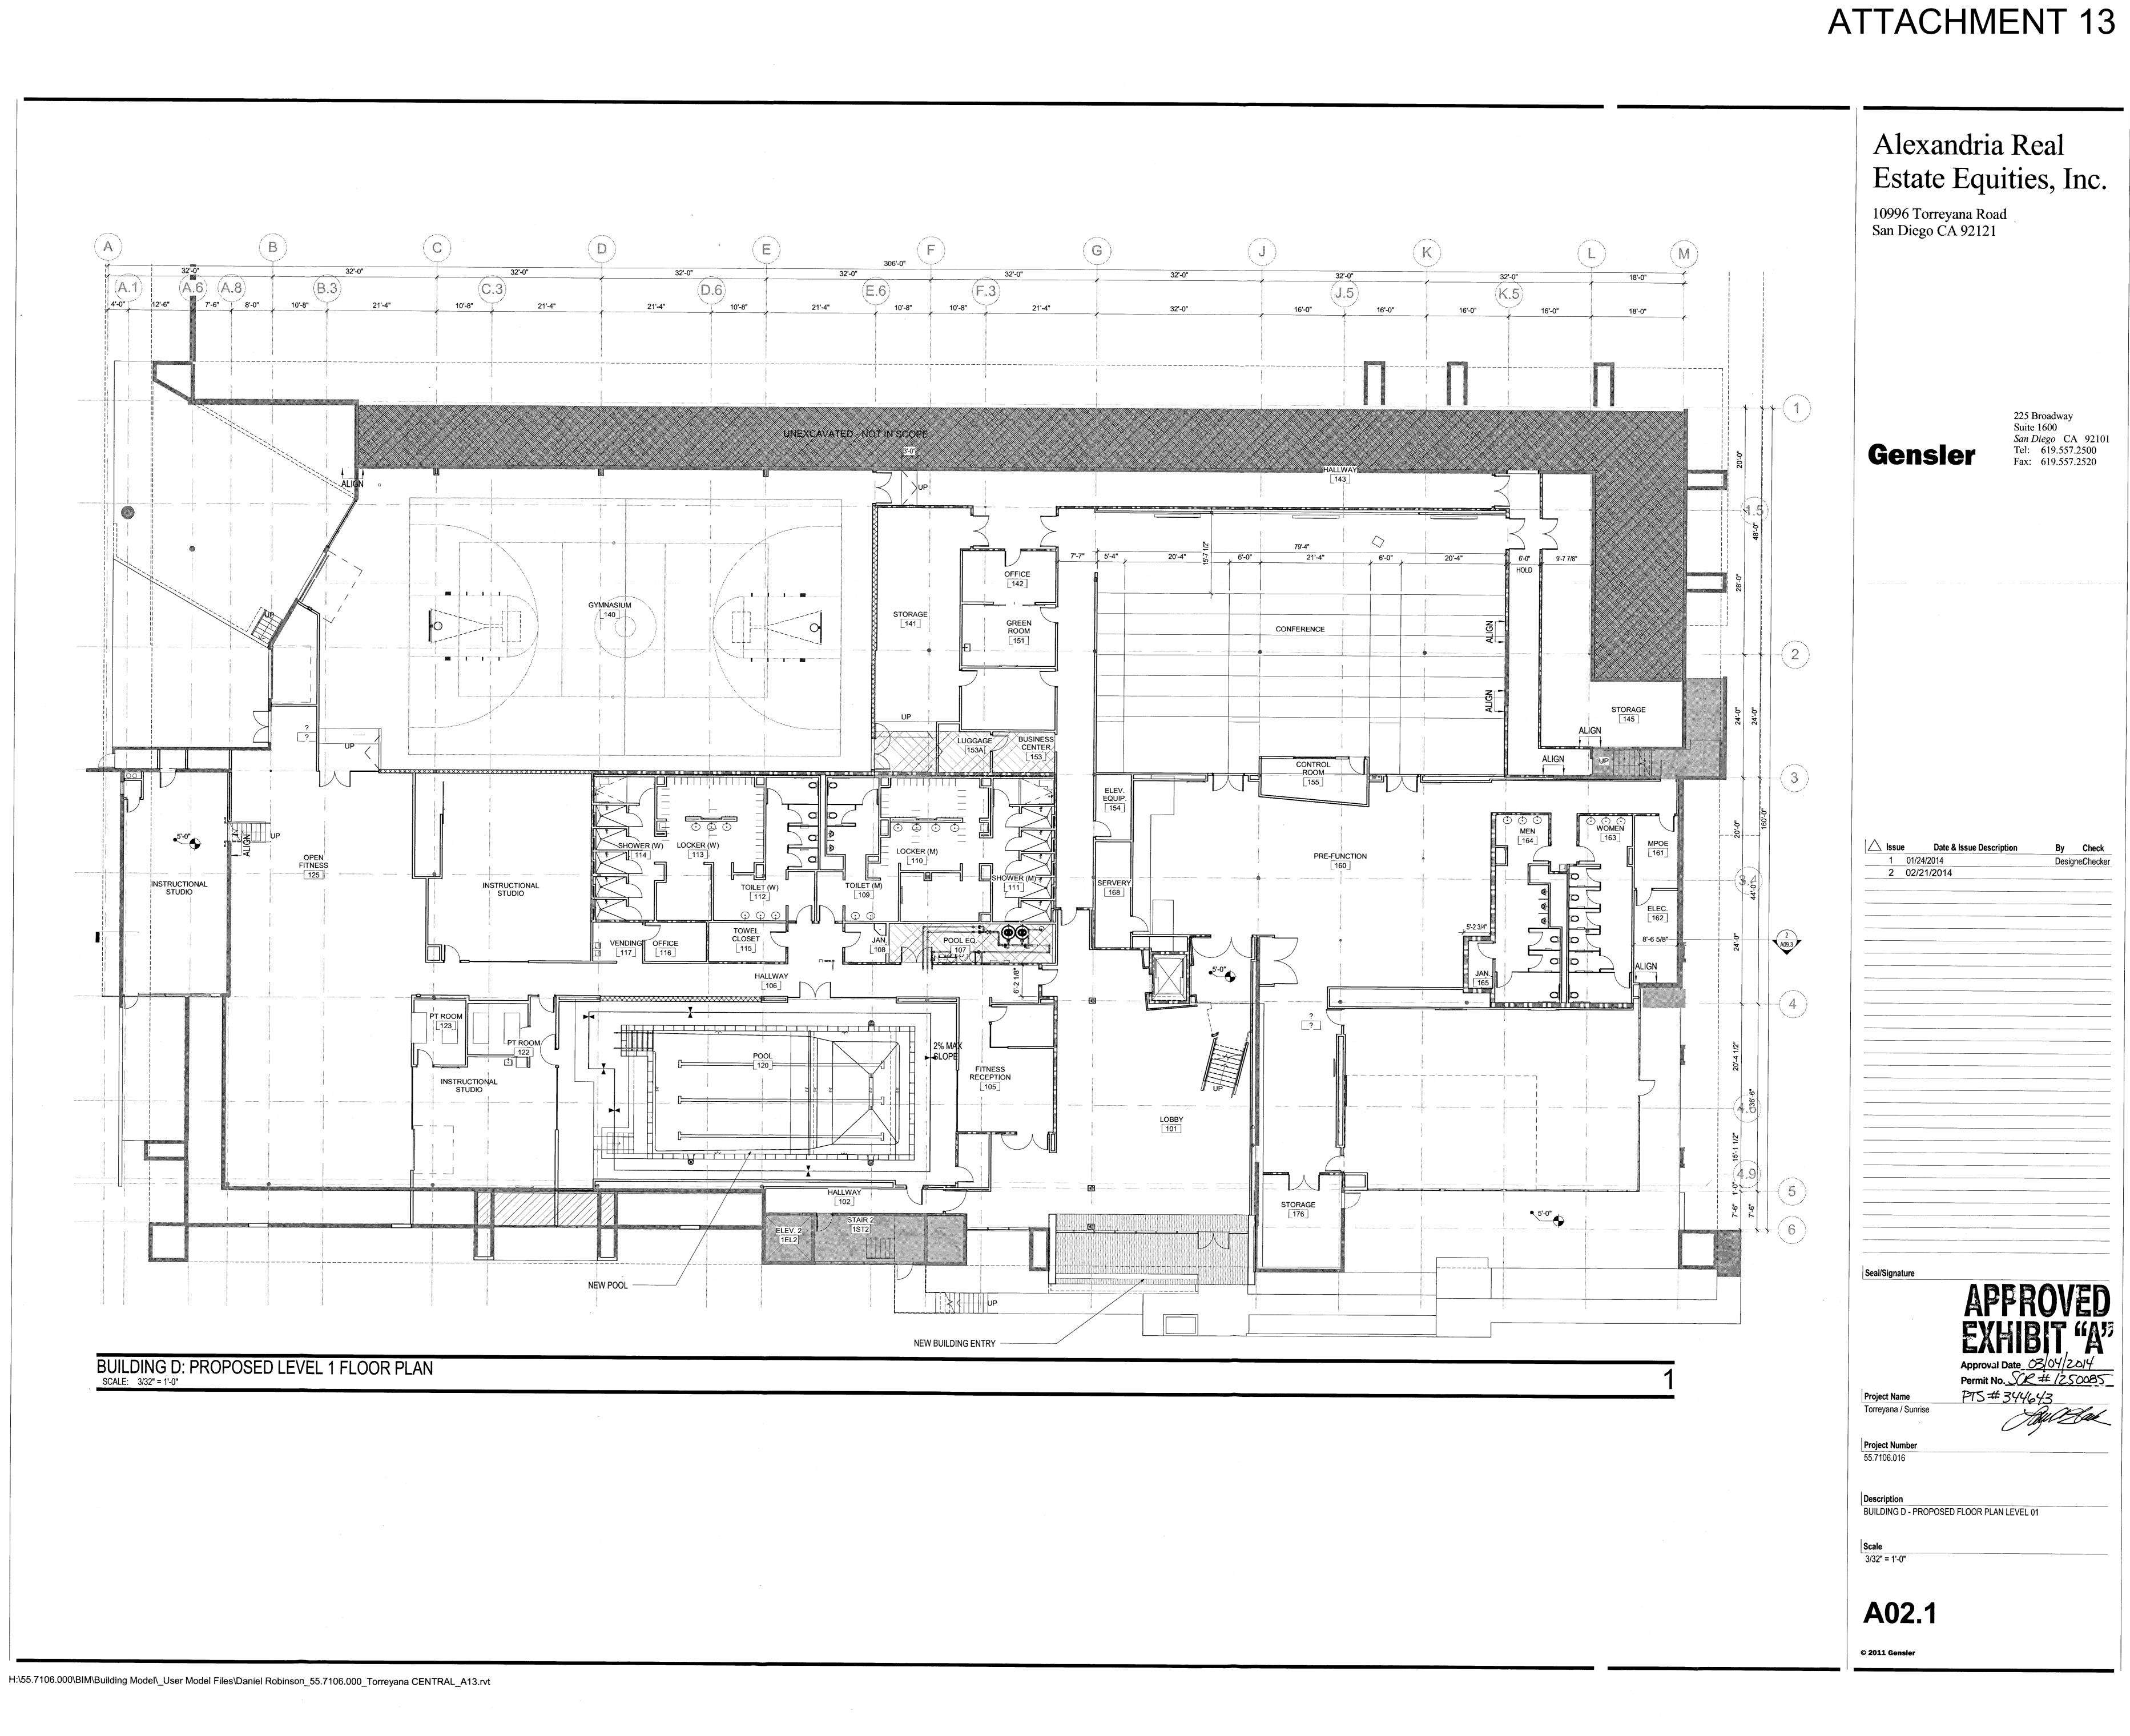
TOTAL ENTITLEMENT:	428,169 SF
REMAINING UNBUILT ENTITLEMENTS	108,421 SF
TOTAL PHASE II DEVELOPMENT	319,748 SF
REMODELED BUILDING D WITH (N) SOCCER FIELD	78,266 SF
BUILDING C: (E) 2 STORY	74,111 SF

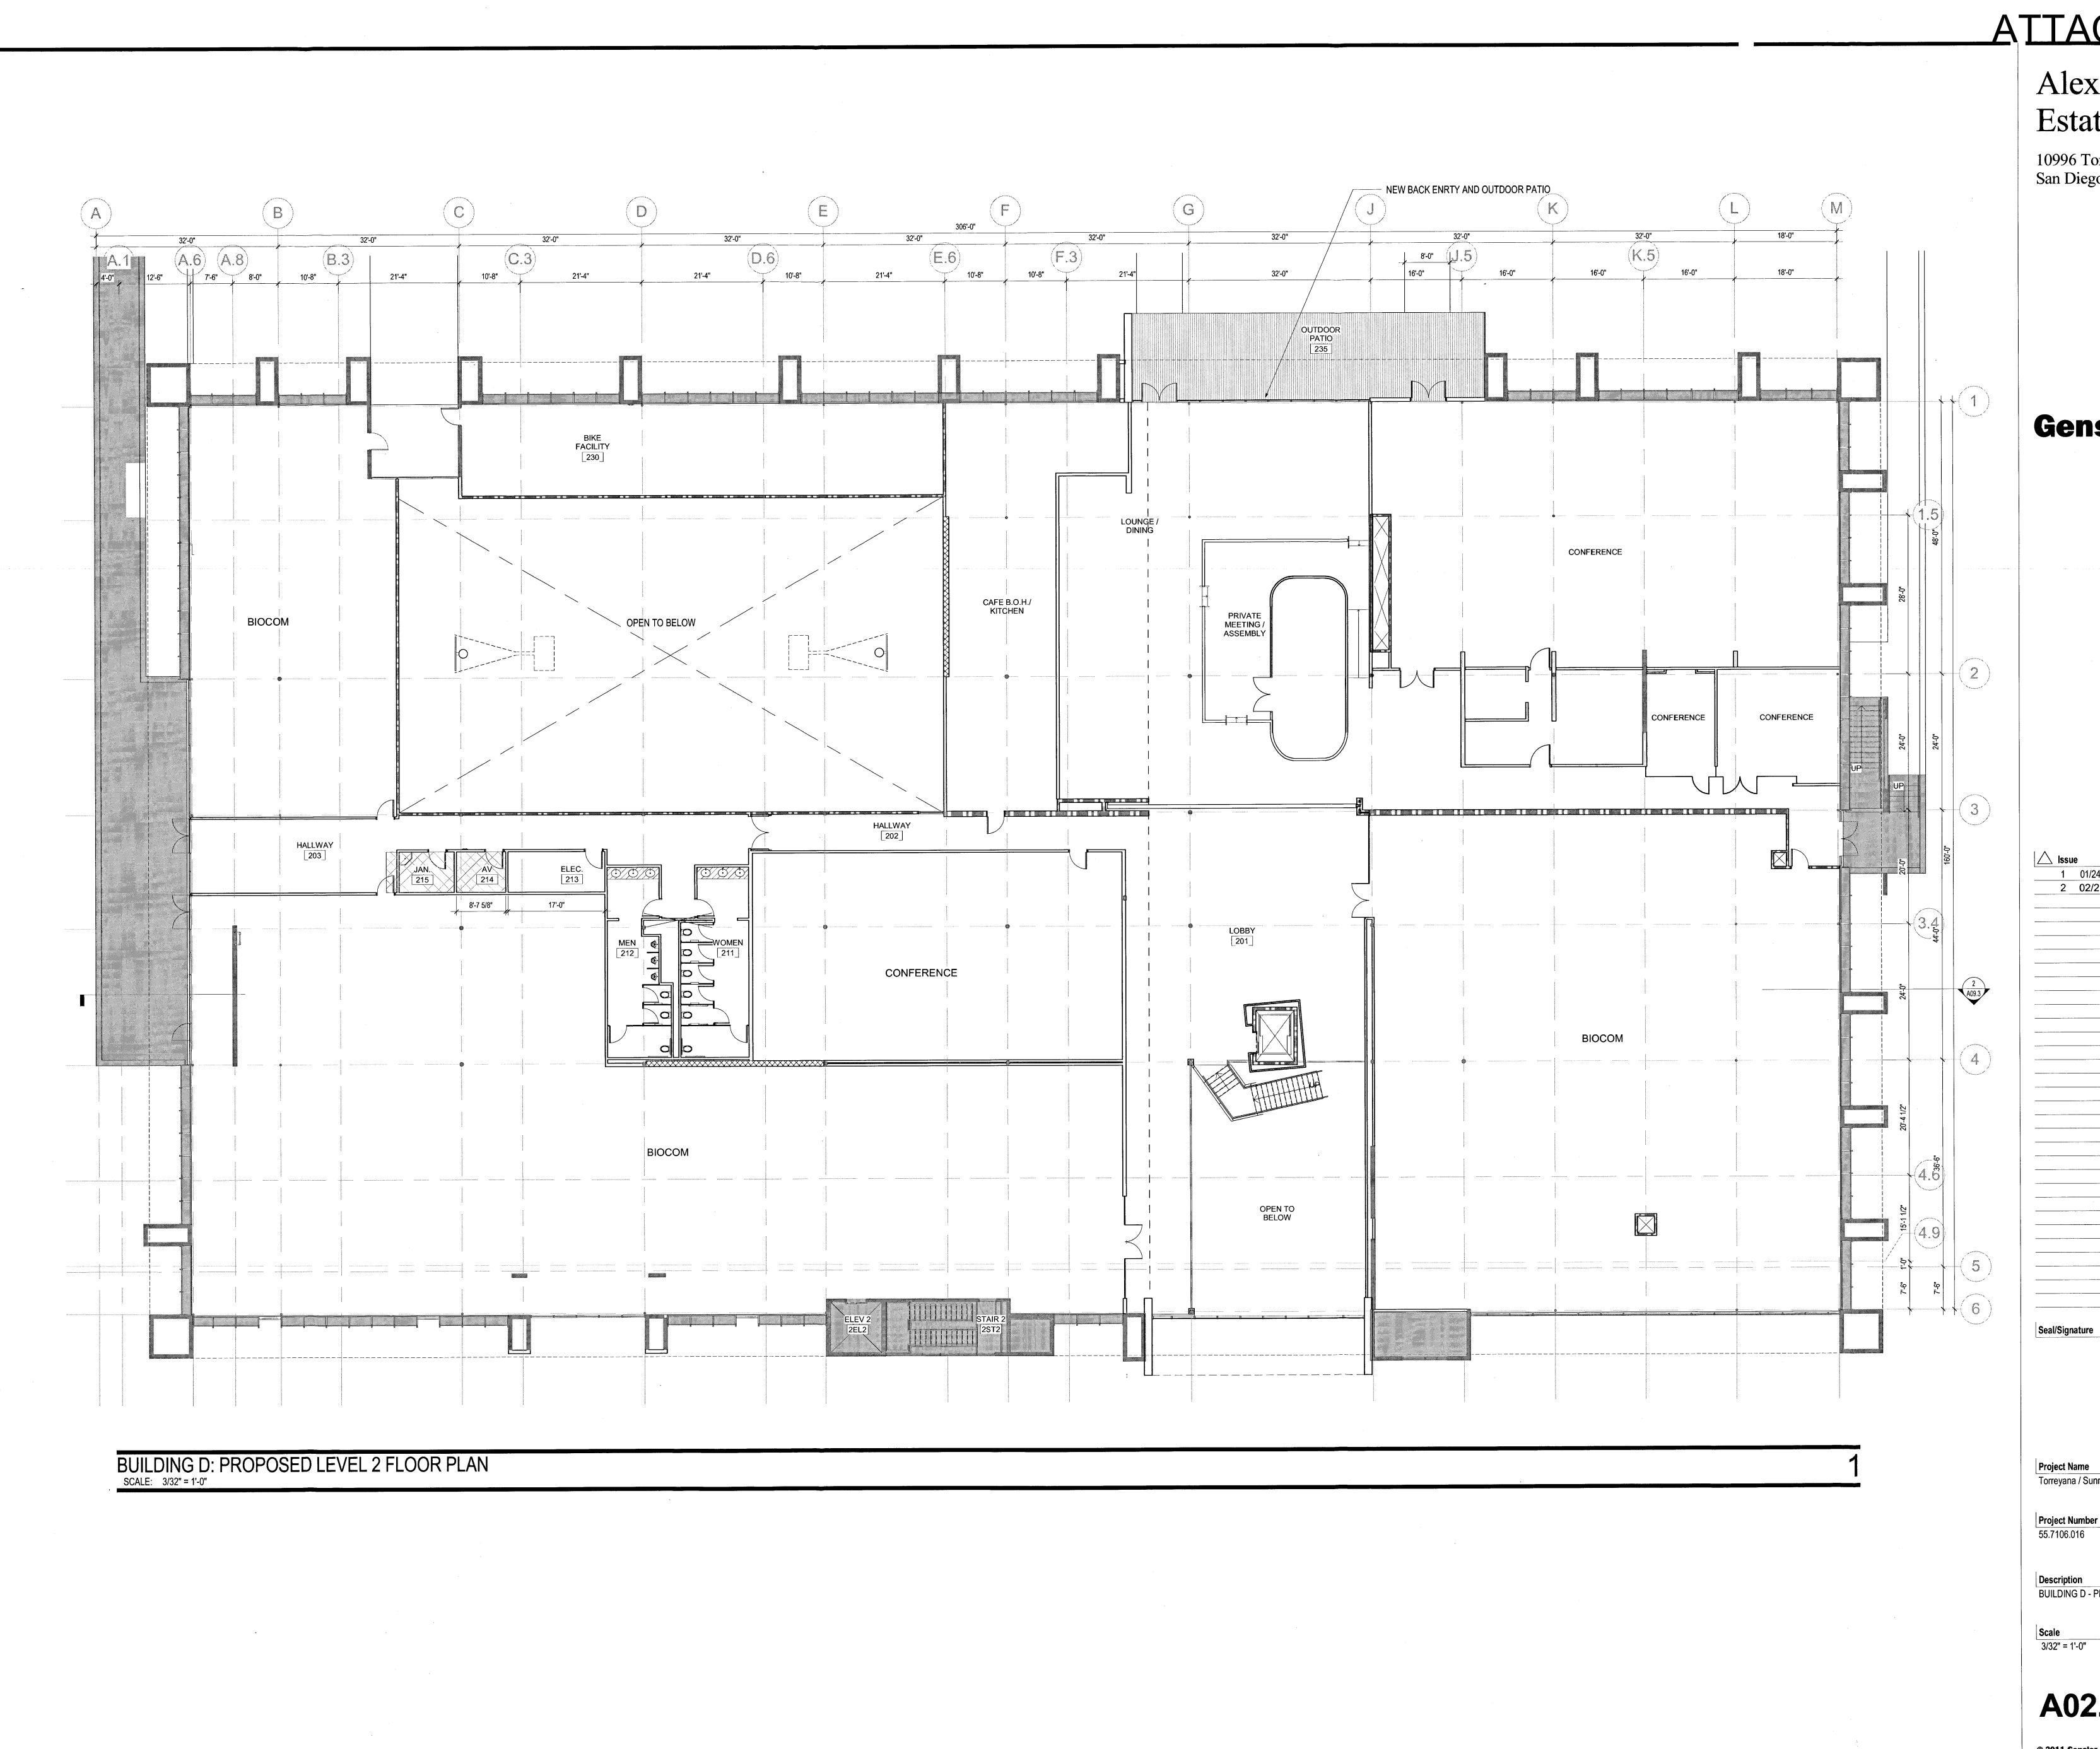




Seal/Signature

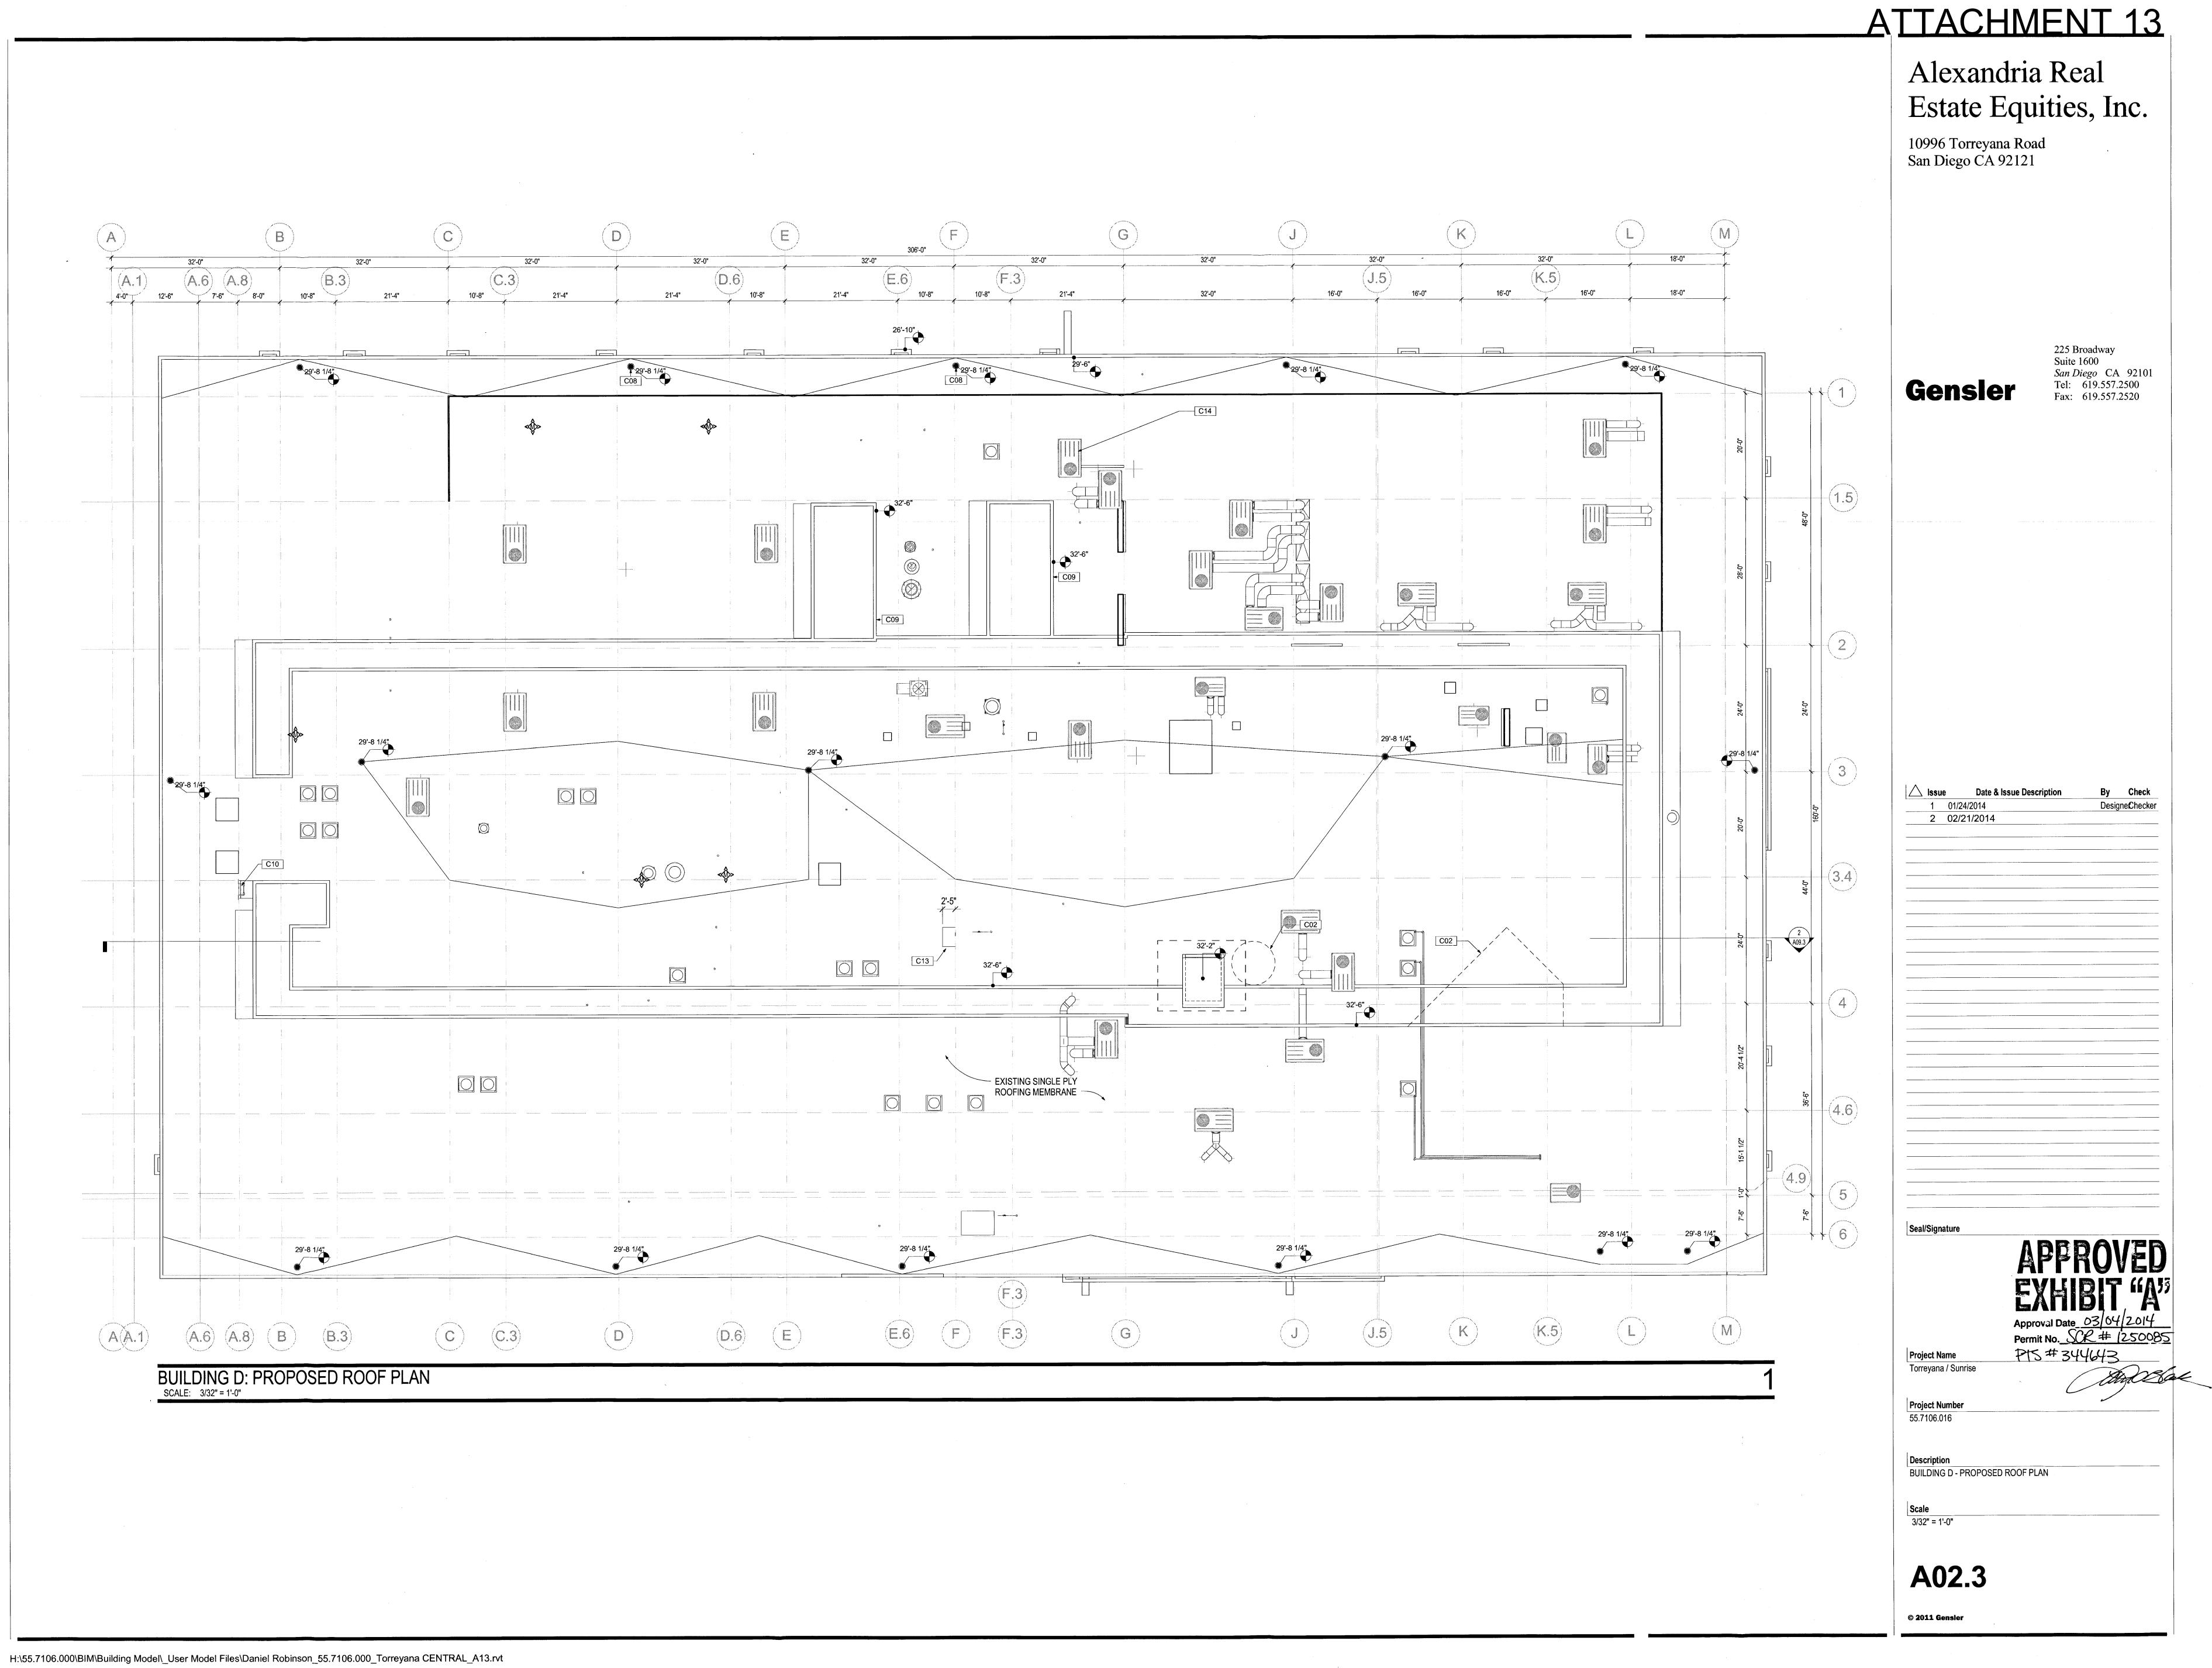


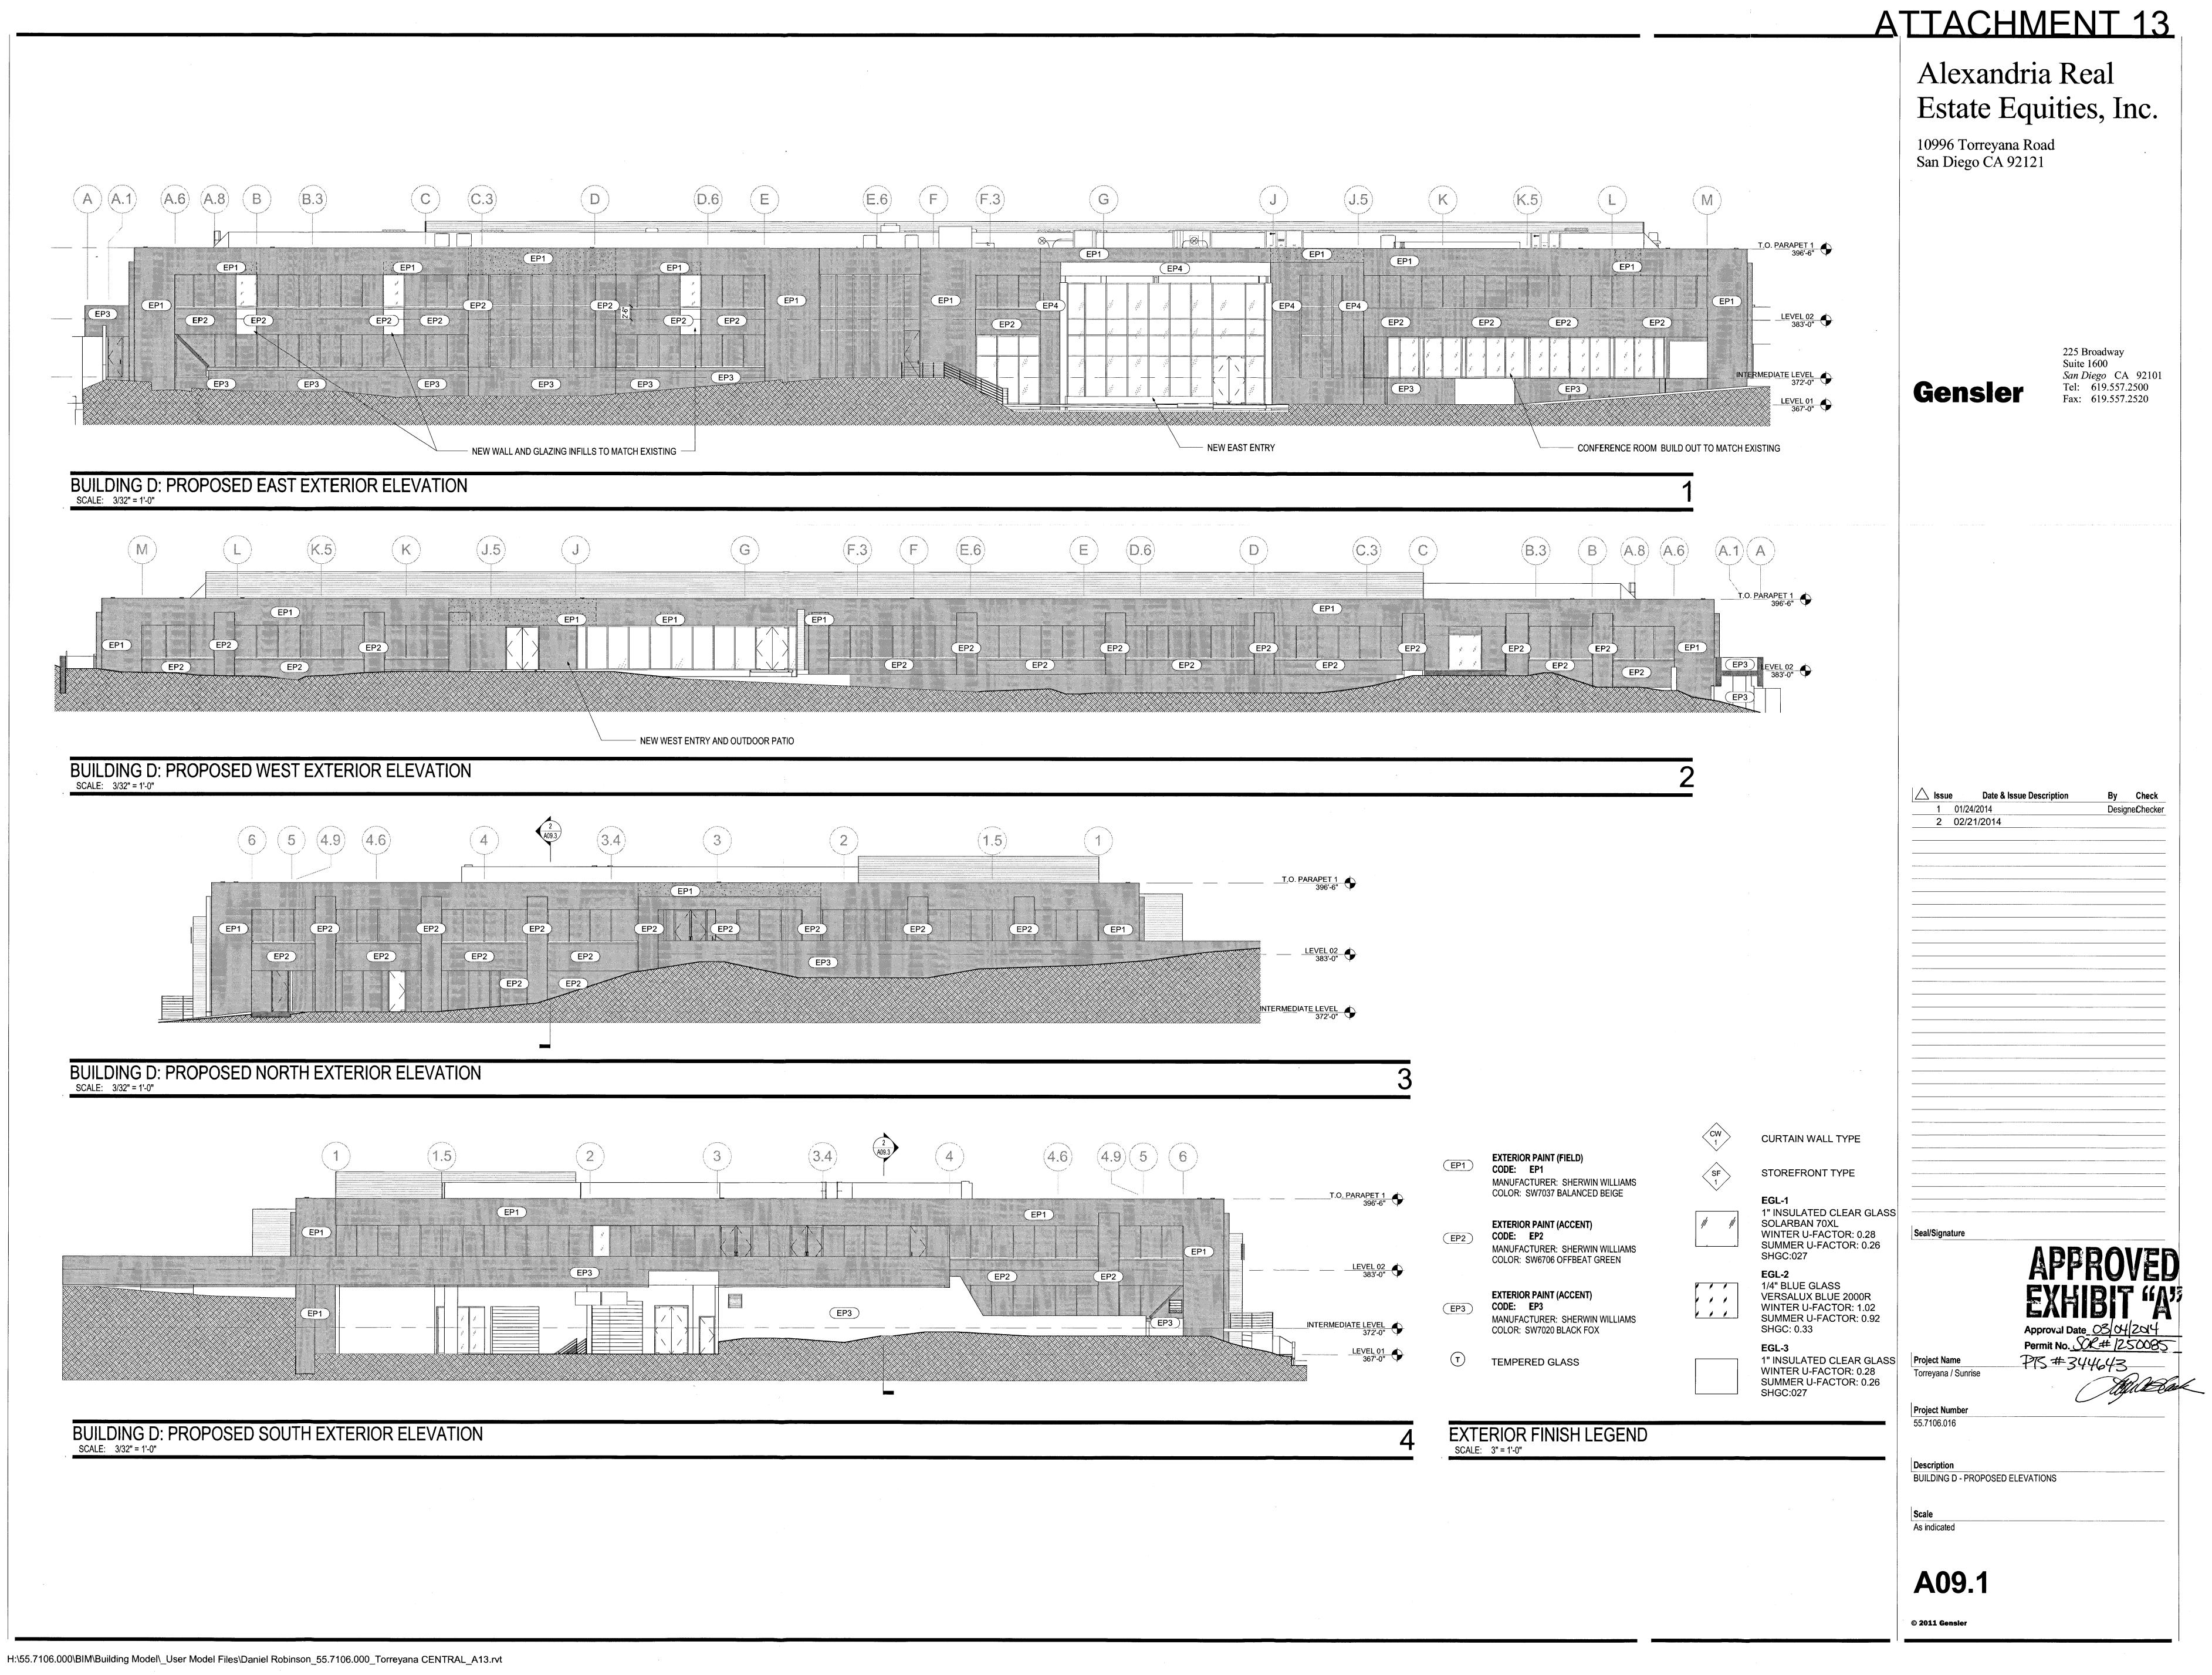


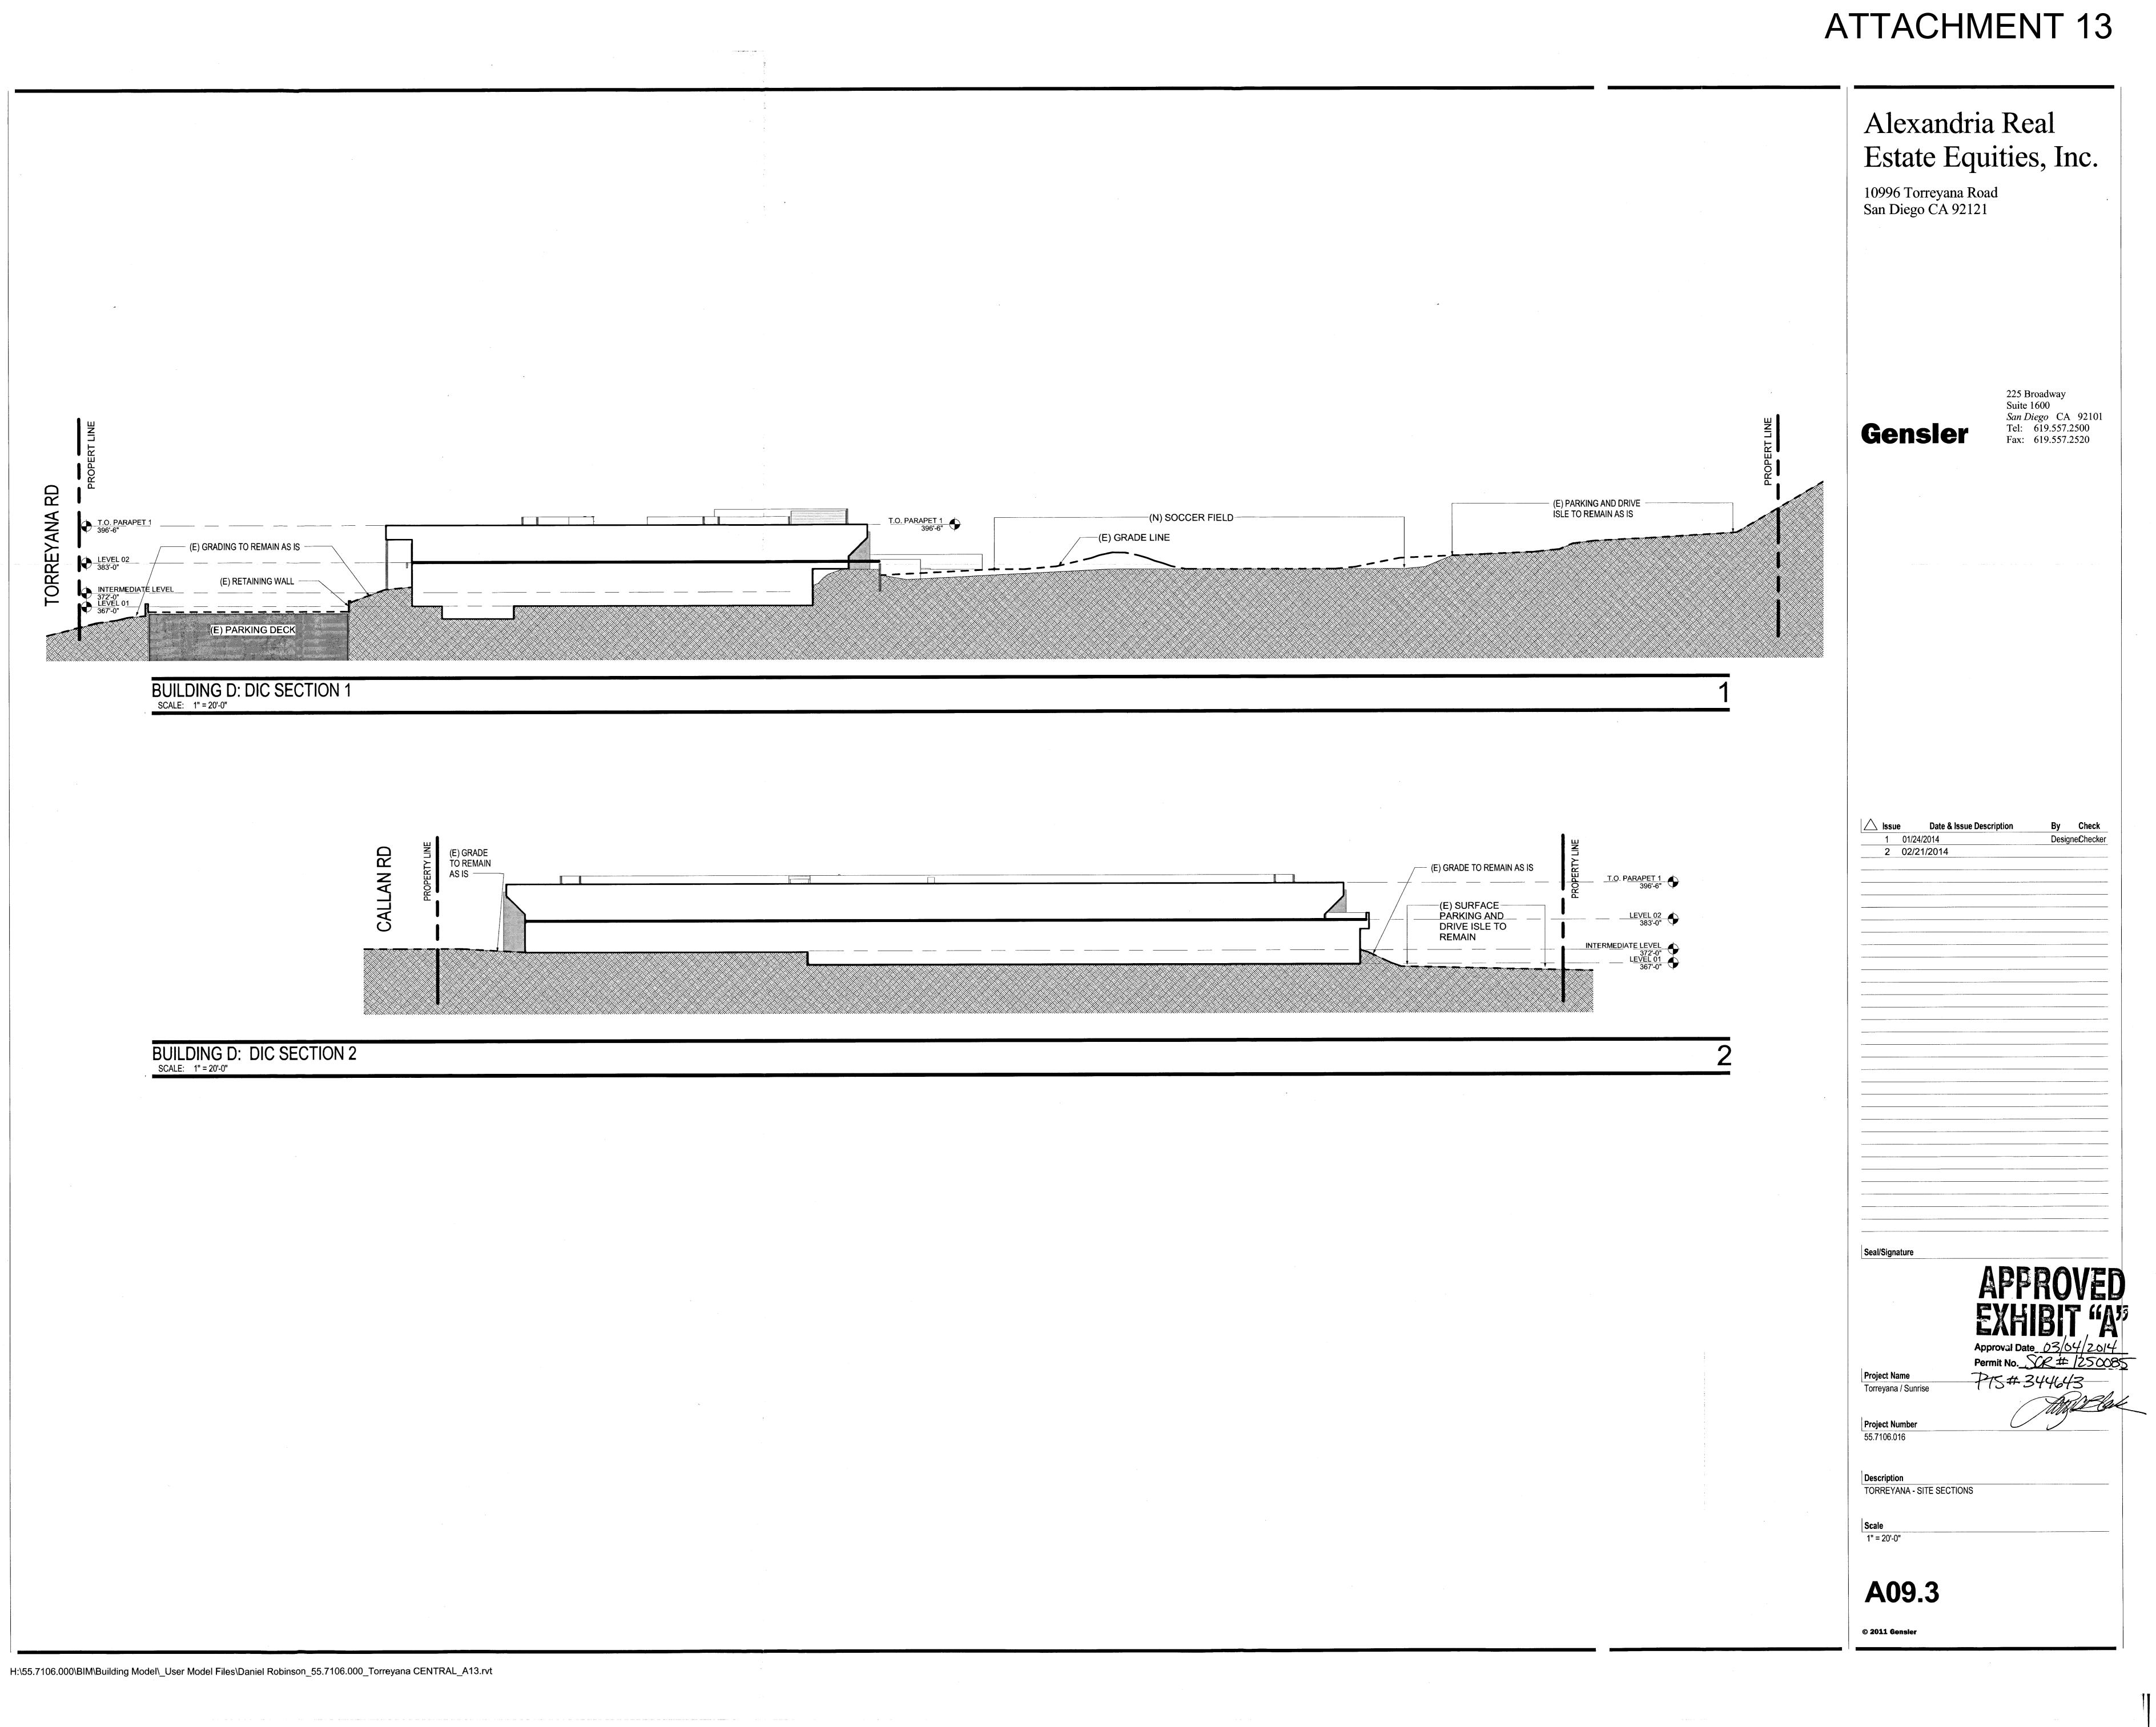


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kandria Real te Equities, Inc. orreyana Road go CA 92121
225 Broadway Suite 1600 <i>San Diego</i> CA 92101 Tel: 619.557.2500 Fax: 619.557.2520
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Permit No. <u>SAC+7230005</u> PTS # 344643 unrise
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