

Report to the Planning Commission

DATE ISSUED: June 1, 2023 REPORT NO. PC-23-020

HEARING DATE: June 8, 2023

SUBJECT: CROWN CASTLE T-MOBILE DEL MAR MESA, Process Four Decision

PROJECT NUMBER: 1053192

OWNER/APPLICANT: DEAN AND IRENE VAYSER, Owner, and T-MOBILE WIRELESS/CROWN CASTLE,

Permittees

SUMMARY

<u>Issue</u>: Should the Planning Commission approve a Conditional Use Permit (CUP) and a Planned Development Permit (PDP) for a Wireless Communication Facility (WCF) located at 5005 Del Mar Mesa Road in the Del Mar Mesa Community Plan Area?

Staff Recommendations:

- 1. **Approve** CUP No. 3146501; and
- 2. **Approve** PDP No. 3209210.

<u>Community Planning Group Recommendation</u>: On November 10, 2022, the Del Mar Mesa Community Planning Group voted 8-0-0 to recommend approval of the project with the condition that a staging area for T-Mobile service vehicles is provided. An area adjacent to the right-of-way on the east side of the private drive was chosen, as shown on the plans (Attachment 9).

Environmental Review:

This project was determined to be categorically exempt from the California Environmental Quality Act (CEQA) pursuant to CEQA Guidelines section 15301 (Existing Facilities). The project is not pending an appeal of the environmental determination. The environmental exemption determination for this project was made on February 6, 2023, and the opportunity to appeal that determination ended February 20, 2023 (Attachment 7).

<u>Fiscal Impact Statement</u>: All costs associated with the processing of this project are paid by the applicant.

Code Enforcement Impact: None.

<u>Housing Impact Statement</u>: This project application is for a wireless communication facility and is not associated with residential development.

BACKGROUND

The T-Mobile Del Mar Mesa (Project) proposes the continued use and upgrade of a T-Mobile Wireless Communication Facility (WCF). The project consists of an existing 18-foot, 2-inch faux elm tree (monoelm) located at 5005 Del Mar Mesa Road within the AR-1-1 of the Del Mar Mesa Community Plan. The previous approval for a Planned Development Permit No. 691812, Conditional Use Permit No. 533126, Coastal Development Permit No. 691813, and Site Development Permit No. 700522 expired on February 25, 2020, with a 10-year term.

DISCUSSION

Project Description:

The WCF consists of six (6) panel antennas and two (2) Remote Radio Units (RRUs) mounted on an existing monoelm. The project proposes to replace two antennas, add two Remote Radio Units (RRUs), and to remove two Tower Mounted Amplifiers (TMAs). The project also consists of modifications to the auxiliary equipment associated with the facility. The equipment will continue to be located in an existing 168-square foot CMU block enclosure. The WCF is on the northeastern part of the parcel in the setback, which allows the WCF to be located away from the existing residential use on site (Figures 1 and 2). Land use surrounding the site is designated as Estate Residential with single family residential developments (Attachments 1,2,3). The project complies with the Wireless Communication Facility Guidelines as a Faux Natural Elements monoelm.



Figure 1 View of WCF monoelm from Del Mar Mesa Road



Figure 2: View of WCF monoelm from Del Mar Mesa Road

WCFs are permitted in all zones Citywide with the appropriate permit process. Council Policy 600-43 assigns preference levels to WCFs proposed on different land uses, with Preference 1 being the highest and Preference 4 the lowest. The most preferred locations being Preference 1 which are generally non-residential uses/zones and are permitted ministerially and the least preferred locations are residential uses in residential zones and are Preference 4, requiring a Process Four, CUP. This Project is located in an agriculture zone which is a Preference 3 according to the Council Policy.

This WCF has been in T-Mobile's network since 1997. The permits for this WCF expired on February 25, 2020. The purpose and intent of an expiration date is to allow the City to analyze the WCF design with the current surrounding development in addition to upgrading the WCFs to address any advancements in designs and innovations. To continue use of the WCF, this new application was created on March 14, 2022. The Project's permit will include a 10-year expiration date. In reviewing the aerial maps provided with the application, it is evident that the area is a mix of residential uses at low elevations and this Preference 3 location is the most viable option in the area (Attachment 1).

Pursuant to San Diego Municipal Code (SDMC) 143.0401, the Project as designed requires a Process Four PDP, Planning Commission decision as the Project requires a deviation to the front and side setbacks. Additionally, pursuant to SDMC Section 141.0420(e)(3), the Project requires a CUP when a WCF is located in an agriculture zone with antennas located less than 100 feet from the property line of a premises with a dwelling unit, childcare center, or school with children enrolled in any grade. The site is located in the City of San Diego's jurisdiction for the Coastal Overlay zone.; however, this project is exempt from needing a Coastal Development Permit pursuant to SDMC section 126.0704(a), improvements to existing structures. The project is proposing to replace two antennas, add two RRUs, and to remove two TMAs. The project also consists of modifications to the auxiliary equipment associated with the facility. The previous permit required a Site Development Permit as the Del Mar Mesa Community Planning Group requested that a split rail fence be placed in the public right-of-way along Del Mar Mesa Road. The fence is not being permitted as part of this entitlement and the project does not require a Site Development Permit.

The Telecommunication Act of 1996 preempts local governments from regulating the "placement,

construction and modification of wireless communication facilities on the basis of the environmental effects of Radio Frequency (RF) emissions to the extent that such facilities comply with the Federal Communication Commission's (FCC) standards for such emissions." An RFE-EME Compliance Report dated February 15, 2022 from SiteSafe was submitted to the City verifying that the proposed project meets or exceeds the requirements of the FCC. The report will be stamped as Exhibit "A" and provided within the project file.

Community Plan Analysis:

The <u>Del Mar Mesa Plan</u> does not address communication antennas as a specific land use. However, the City of San Diego's General Plan (<u>UD-A.15</u>) requires that the visual impact of wireless facilities be minimized by concealing them inside existing structures or using screening techniques to hide or blend them into the surrounding area. The plan also calls for these facilities to be designed to be aesthetically pleasing and respectful of the neighborhood context. Furthermore, the plan states that equipment associated with wireless facilities shall be concealed from view. Pursuant to the San Diego Land Development Code, communication antennas are permitted in all zones citywide with the appropriate permit process. Wireless communication facilities are separately regulated uses, which have limitations or require compliance with conditions in order to minimize potential impacts. The intent of the regulations is, among other things, to camouflage facilities from public view.

In this case, the antennas are mounted near the top of the tree. The WCF is integrated and screened by mature trees that surround the WCF (Attachment 11). Any branches that are discolored or damaged will be replaced with new branches. Branches will project 24-inches past the antenna and the antenna socks. Antenna socks are designed to help conceal the antennas within the leaves. The design of the WCF is respectful of the neighborhood context and does not adversely affect the applicable land use plans.

Project-Related Issues:

<u>Deviation</u>- An applicant may request deviations from the applicable development regulations with a Planned Development Permit decided in accordance with Process Four, provided that the findings in <u>SDMC Section 126.0605</u> are made. The following Table 1 is a matrix of the proposed deviation, which is followed by the justifications for the deviations:

DEVIATIONS SUMMARY Table 1										
Deviation Description	Deviation from SDMC	Allowed/Required	Proposed							
Front Setbacks	SDMC Section 131.0530 and Table 131-05D	25-feet	Encroaching 4 feet into the setbacks; 21 feet remaining							

DEVIATIONS SUMMARY Table 1									
Deviation Description	Deviation from SDMC	Allowed/Required	Proposed						
Side Setbacks	SDMC Section 131.0530 and Table 131-05D	20-feet	Encroaching entirely into the setbacks; 0 feet remaining						

Justification- The facility has been existing on the site since 1997 and was designed as an 18-foot monopole in the same location. In 2010, it was redesigned to conform to the newest WCF guidelines and associated codes. The Project was designed as an 18-foot 2-inch monoelm that integrates into the surrounding mature trees. The location in the setbacks allows the WCF to be further away from the residences on site.

The existing WCF provides critical voice and data service throughout the surrounding area. Continued operation of this site is necessary to maintain the existing levels of service to the area for T-Mobile. The site is an integral part of telecommunication networks, as the site's operation is closely coordinated with other sites in the area. Coverage maps demonstrate the existing coverage provided on the property and the predicted loss of coverage without the continuing of the WCF (Attachment 6). A degradation of the existing service could have a significant impact on customers and essential emergency communication services. The above deviation has been analyzed by staff and determined to be consistent with the goals and recommendations of the City of San Diego's General Plan (UD-A.15), Del Mar Mesa Community Plan, and the purpose and intent of the Wireless Communication Facility Ordinance. The Project has been designed to integrate into the surrounding community and would not adversely impact the public's health or safety.

Conclusion:

The Project's design effectively integrates with the architecture of the surrounding community, meeting the purpose and intent of the Wireless Communication Ordinance (<u>SDMC 141.0420</u>), the <u>Wireless Design Guidelines</u> and <u>Council Policy 600-43</u>. City staff has prepared draft findings in the affirmative to approve the Project and recommends approval of CUP No. 3146501 and PDP No. 3209210 (Attachment 6).

ALTERNATIVES

- 1. Approve CUP No. 3146501 and PDP No. 3209210, with modifications; or
- 2. Deny CUP No. 3146501 and PDP No. 3209210, if the Planning Commission makes written findings based on substantial evidence that the approval is not authorized by state or local zoning law.

Respectfully submitted,

Simon Tse

Supervising Development Project Manager Development Services Department San Heacox

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Development Project Manager Development Services Department

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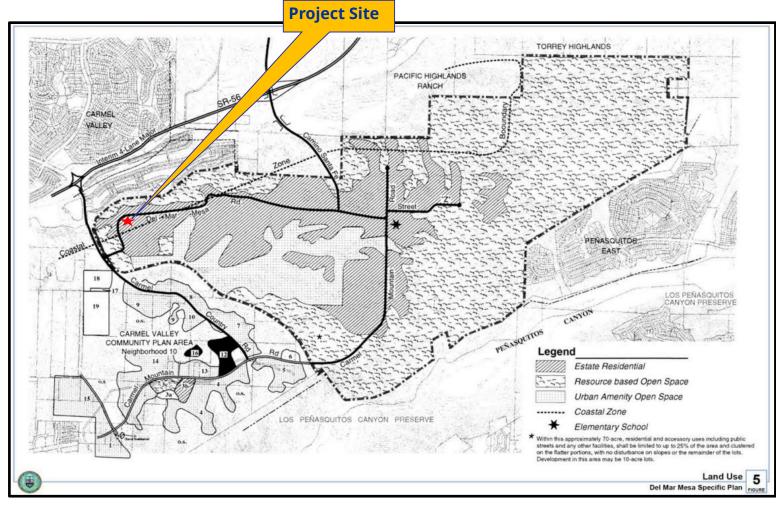
Attachments:

- 1. Aerial Photographs
- 2. Community Plan Land Use Map
- 3. Project Location Map
- 4. Draft Permit Resolution with Findings
- 5. Draft Permit with Conditions
- 6. Coverage Maps
- 7. Environmental Exemption
- 8. Ownership Disclosure Form
- 9. Community Planning Group Recommendation
- 10. Photo Survey
- 11. Photo Simulations
- 12. Project Plans



Aerial Photograph

<u>T-Mobile Del Mar Mesa Project No. 1053192</u> 5005 Del Mar Mesa Road






Del Mar Mesa Land Use Map

T-Mobile Del Mar Mesa Project No. 1053192 5005 Del Mar Mesa Road



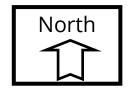

PLANNING COMMISSION RESOLUTION NO. XXX CONDITIONAL USE PERMIT NO. 3146501 PLANNED DEVELOPMENT PERMIT NO. 3209210 T-MOBILE DEL MAR MESA PROJECT NO. 1053192

WHEREAS, DEAN AND IRENE VAYSER, Owner, and T-MOBILE WIRELESS OR CROWN CASTLE, Permittee, filed an application with the City of San Diego for a permit for a Wireless Communication Facility (as described in and by reference to the approved Exhibits "A" and corresponding conditions of approval for the associated Permit No. 3146501 and 3209210);

WHEREAS, the project site is located at 5005 Del Mar Mesa Road within the AR-1-1 of the Del Mar Mesa Community Plan area;

WHEREAS, the project site is legally described as Parcel 1 of Parcel Map No. 20448, in the City of San Diego, County of San Diego, State of California, recorded in the Office of the County Recorder of said County on March 7, 2008;

WHEREAS, on February 6, 2023, the City of San Diego, as Lead Agency, through the Development Services Department, made and issued an Environmental Determination that the project is exempt from the California Environmental Quality Act (CEQA) (Public Resources Code Section 21000 et seq.) under CEQA Guideline Section 15301 (Existing Facilities) and there was no appeal of the Environmental Determination filed within the time period provided by San Diego Municipal Code Section 112.0520;

WHEREAS, on June 8, 2023, the Planning Commission of the City of San Diego considered Conditional Use Permit (CUP) No. 3146501 and Planned Development Permit (PDP) No. 3209210 pursuant to the Land Development Code of the City of San Diego;

BE IT RESOLVED by the Planning Commission of the City of San Diego, that it adopts the following findings with respect to CUP No. 3146501 and PDP No. 3209210:

A. CONDITIONAL USE PERMIT [SDMC Section 126.0305]

1. <u>Findings for all Conditional Use Permits:</u>

a. The proposed development will not adversely affect the applicable land use plan.

The T-Mobile Del Mar Mesa (Project) proposes the continued use and upgrade of a T-Mobile Wireless Communication Facilities (WCF). The existing WCF consists of an existing 18-foot, 2-inch faux elm tree (monoelm) with six (6) panel antennas and two (2) Remote Radio Units (RRUs). The project proposes to replace two antennas, add two Remote Radio Units (RRUs), and to remove two Tower Mounted Amplifiers (TMAs). The associated equipment will continue to be located in an existing 168-square foot CMU block enclosure.

The Del Mar Mesa Plan does not address communication antennas as a specific land use. However, the City of San Diego's General Plan (UD-A.15) requires that the visual impact of wireless facilities be minimized by concealing them inside existing structures or using screening techniques to hide or blend them into the surrounding area. The plan also calls for these facilities to be designed to be aesthetically pleasing and respectful of the neighborhood context. Furthermore, the plan states that equipment associated with wireless facilities shall be concealed from view. Pursuant to the San Diego Land Development Code, communication antennas are permitted in all zones citywide with the appropriate permit process. Wireless communication facilities are separately regulated uses, which have limitations or require compliance with conditions in order to minimize potential impacts. The intent of the regulations is, in part, to camouflage facilities from public view.

In this case, the antennas are mounted near the top of the tree. The WCF is integrated and screened by mature trees that surround the WCF (Attachment 11). Any branches that are discolored or damaged will be replaced with new branches. Branches will project 24-inches past the antenna and the antenna socks. Antenna socks are designed to help conceal the antennas within the leaves. The design of the WCF is respectful of the neighborhood context and does not adversely affect the applicable land use plans. As designed, the Project complies with the WCF regulations, by integrating the Project into the surrounding community, thereby reducing any potential visual impacts. Therefore, the proposed development will not adversely affect the applicable land use plan.

b. The proposed development will not be detrimental to the public health, safety, and welfare.

The Project is determined to be exempt from CEQA pursuant to Section 15301 (Existing Facilities). The conditions of approval for the Project will require compliance with several operational constraints and development controls intended to assure the continued public health, safety, and welfare. These include, but not limited to concealment requirements and electromagnetic fields controls. All proposed improvement plans associated with the Project will be reviewed prior to issuance of

construction permits and inspected during construction to assure the Project will meet or exceed all relevant and applicable building, electrical, mechanical, plumbing and fire codes.

This existing WCF has been active on this site since 1997. The WCF provides critical voice and data service throughout the surrounding area. Continued operation of this site is necessary to maintain the existing levels of service to the area for T-Mobile. The site is an integral part of telecommunication networks, as the site's operation is closely coordinated with other sites in the area. Coverage maps demonstrate the existing coverage provided on the property and the predicted loss of coverage without the continuation of the WCF. A degradation of the existing service could have a significant impact on customers and essential emergency communication services.

The Telecommunication Act of 1996 preempts local governments from regulating the "placement, construction and modification of wireless communication facilities on the basis of the environmental effects of Radio Frequency (RF) emissions to the extent that such facilities comply with the Federal Communication Commission's (FCC) standards for such emissions." An RFE-EME Compliance Report (Report) dated February 15, 2022 from SiteSafe was submitted to the City verifying that the proposed Project meets or exceeds the requirements of the FCC. The Report will be stamped as Exhibit "A" and provided within the Project file. Therefore, the proposed development will not be detrimental to the public health, safety, and welfare.

c. The proposed development will comply with the regulations of the Land Development Code including any allowable deviations pursuant to the Land Development Code.

The Project requires a setback deviation from the zone regulations under Land Development Code. The 18-foot, 2-inch stealth tower is located on a single-family residence premise in the AR-1-1 Zone. The maximum front setback is 25 feet and the side setback is 20 feet. The project extends four feet in the front setback with 21 feet remaining and encroaches entirely in the side setback near the property line. The WCF does not encroach into the driveway or public right-of-way. The location in the setbacks allows the WCF to be further away from the residences on site. The WCF is also located around large mature trees that will help integrate the WCF in the surrounding area.

WCFs are permitted in all zones citywide with the appropriate permit process. Council Policy 600-43 assigns preference levels to WCFs proposed on different land uses, with Preference 1 being the highest and Preference 4 the lowest. The most preferred locations being Preference 1 which are generally non-residential uses/zones and are permitted ministerially and the least preferred locations are residential uses in residential zones and are Preference 4, requiring a Process Four, CUP. This Project is located in an agricultural zone which is a Preference 3 according

to the Council Policy. The monoelm implements the intent of the WCF ordinance which is to integrate and camouflage WCFs within the existing environment. Based on these considerations, this Project complies with the permit and design requirements for WCF's as identified in the SDMC. Therefore, the proposed development will comply with the regulations of the Land Development Code with the approval of the front and side setback deviation.

d. The proposed use is appropriate at the proposed location.

The existing T-Mobile WCF was previously approved on February 25, 2010 with a 10year term and contained a total of two (2) panel antennas. The project proposes to replace two antennas, add two Remote Radio Units (RRUs), and to remove two Tower Mounted Amplifiers (TMAs). The project also consists of modifications to the auxiliary equipment associated with the facility. The City of San Diego encourages wireless carriers to locate on non-residential properties but does allow locations on residential properties as set forth in the Council policy. The existing WCF provides critical voice and data service throughout the surrounding area. Continued operation of this site is necessary to maintain the existing levels of service to the area for T-Mobile. The site is an integral part of telecommunication networks, as the site's operation is closely coordinated with other sites in the area. Coverage maps demonstrate the existing coverage provided on the property and the predicted loss of coverage without the project. A degradation of the existing service could have a significant impact on customers and essential emergency communication services. The location is preferred because it allows the existing tree and equipment to remain in the same location and will not need to construct another WCF on a different parcel to maintain service. In the site's setbacks, the WCF will reduce impacts to the property site by being located as far from the residences as possible and being located near the existing mature trees in the surrounding area.

The surrounding properties in all directions are agricultural estate which includes single family residences and barns. There are some non-residential properties to the east. However, in order to make up for the loss service, a WCF at one of these locations would require a new standalone tower, whose height would far exceed the height of any existing structures in the area. This would result in a facility that is less integrated in the overall aesthetics of the community. In addition, the relocation of an existing WCF could have negative impacts on the overall performance of the network in the area, resulting in possible coverage gaps between sites. For these reasons, the existing site is preferred, and no other properties are suitable candidates. Therefore, the proposed use is appropriate at the proposed location.

B. PLANNED DEVELOPMENT PERMIT [SDMC Section 126.0605]

- 1. Findings for all Planned Development Permits:
 - a. The proposed development will not adversely affect the applicable land use plan.

As outlined in CUP Finding No. A.1.a. listed above, the proposed development will not adversely affect the applicable land use plan.

b. The proposed development will not be detrimental to the public health, safety, and welfare.

As outlined in CUP Finding No. A.1.b. listed above, the proposed development will not adversely affect the applicable land use plan.

C. The proposed development will comply with the applicable regulations of the Land Development Code including any allowable deviations pursuant to the Land Development Code.

As outlined in CUP Finding No. A.1.c. listed above, the proposed development will not adversely affect the applicable land use plan.

The above findings are supported by the minutes, maps, and exhibits, all of which are incorporated herein by this reference.

BE IT FURTHER RESOLVED that, based on the findings hereinbefore adopted by the Planning Commission, CUP No. 3146501 and PDP No. 3209210 is hereby GRANTED by the Planning Commission to the referenced Owner/Permittee, in the form, exhibits, terms and conditions as set forth in Permit Nos. 3146501 and 3209210, a copy of which is attached hereto and made a part hereof.

lan Heacox	
Development Project Manager	

Development Services

Adopted on: June 8, 2023

IO#: 11003679



RECORDING REQUESTED BY

CITY OF SAN DIEGO DEVELOPMENT SERVICES PERMIT INTAKE, MAIL STATION 501

WHEN RECORDED MAIL TO PROJECT MANAGEMENT PERMIT CLERK MAIL STATION 501

INTERNAL ORDER NUMBER: 11003679

SPACE ABOVE THIS LINE FOR RECORDER'S USE

CONDITIONAL USE PERMIT NO. 3146501 PLANNED DEVELOPMENT PERMIT NO. 3209210 CROWN CASTLE **T-MOBILE DEL MAR MESA PROJECT NO. 1053192**PLANNING COMMISSION

This Conditional Use Permit (CUP) No. 3146501 and Planned Development Permit (PDP) No. 3209210 is granted by the Planning Commission of the City of San Diego to DEAN AND IRENE VAYSER, Owner, and CROWN CASTLE and T-MOBILE, Permittees, pursuant to San Diego Municipal Code [SDMC] sections 126.0302, 131.0302, 141.0420 and 143.0402. The site is located at 5005 Del Mar Mesa Road within the AR-1-1 of the Del Mar Mesa Community Plan area. The project site is legally described as Parcel 1 of Parcel Map No. 20448, in the City of San Diego, County of San Diego, State of California, recorded in the Office of the County Recorder of said County on March 7, 2008;

Subject to the terms and conditions set forth in this Permit, permission is granted to Owner and Permittees for a Wireless Communication Facility (WCF) described and identified by size, dimension, quantity, type, and location on the approved exhibits [Exhibit "A"] dated March 2, 2023, on file in the Development Services Department.

The project shall include:

- a. A WCF consisting of an 18'-2'' tall existing faux elm tree (monoelm) supporting six (6) panel antennas measuring 59.25" x 12.87" x 8.66" and 39" x 30" x 14" with antenna socks installed; and
- b. Associated 168-square-foot equipment enclosure with four (4) cabinets; and
- c. Public and private accessory improvements determined by the Development Services Department to be consistent with the land use and development standards for this site in accordance with the adopted community plan, the California Environmental Quality Act [CEQA] and the CEQA Guidelines, the City Engineer's requirements, zoning regulations, conditions of this Permit, and any other applicable regulations of the SDMC.

STANDARD REQUIREMENTS:

- 1. This Permit must be utilized within thirty-six (36) months after the date on which all rights of appeal have expired. If this permit is not utilized in accordance with Chapter 12, Article 6, Division 1 of the SDMC within the 36-month period, this permit shall be void unless an Extension of Time has been granted. Any such Extension of Time must meet all SDMC requirements and applicable guidelines in effect at the time the extension is considered by the appropriate decision maker. This permit must be utilized by June 22, 2026.
- 2. No later than ninety (90) days prior to the expiration of this approval, the Permittees may submit a new application to the Development Services Department for consideration with review and a decision by the appropriate decision maker at that time. Failure to submit prior to the deadline will be cause for enforcement for noncompliance, which may include penalties and fines.
- 3. This Conditional Use Permit and corresponding use of this site shall expire on **June 22, 2033**. Upon expiration of this Permit, the facilities and improvements described herein shall be removed from this site and the property shall be restored to its original condition preceding approval of this Permit.
- 4. Under no circumstances, does approval of this permit authorize the Owner/Permittees to utilize this site for WCF purposes beyond the permit expiration date. Use of this permit approval beyond the expiration date of this permit is prohibited.
- 5. No permit for the construction, occupancy, or operation of any facility or improvement described herein shall be granted, nor shall any activity authorized by this Permit be conducted on the premises until:
 - a. The Owner/Permittees signs and returns the Permit to the Development Services Department; and
 - b. The Permit is recorded in the Office of the San Diego County Recorder.
- 6. While this Permit is in effect, the subject property shall be used only for the purposes and under the terms and conditions set forth in this Permit unless otherwise authorized by the appropriate City decision maker.
- 7. This Permit is a covenant running with the subject property and all of the requirements and conditions of this Permit and related documents shall be binding upon the Owner/Permittees and any successor(s) in interest.
- 8. The continued use of this Permit shall be subject to the regulations of this and any other applicable governmental agency.

- 9. Issuance of this Permit by the City of San Diego does not authorize the Owner/Permittees for this Permit to violate any Federal, State or City laws, ordinances, regulations or policies including, but not limited to, the Endangered Species Act of 1973 [ESA] and any amendments thereto (16 U.S.C. § 1531 et seq.).
- 10. The Owner/Permittees shall secure all necessary building permits. The Owner/Permittees is informed that to secure these permits, substantial building modifications and site improvements may be required to comply with applicable building, fire, mechanical, and plumbing codes, and State and Federal disability access laws.
- 11. Construction plans shall be in substantial conformity to Exhibit "A." Changes, modifications, or alterations to the construction plans are prohibited unless appropriate application(s) or amendment(s) to this Permit have been granted.
- 12. All of the conditions contained in this Permit have been considered and were determined necessary to make the findings required for approval of this Permit. The Permit holder is required to comply with each and every condition in order to maintain the entitlements that are granted by this Permit.

If any condition of this Permit, on a legal challenge by the Owner/Permittees of this Permit, is found or held by a court of competent jurisdiction to be invalid, unenforceable, or unreasonable, this Permit shall be void. However, in such an event, the Owner/Permittees shall have the right, by paying applicable processing fees, to bring a request for a new permit without the "invalid" conditions(s) back to the discretionary body which approved the Permit for a determination by that body as to whether all of the findings necessary for the issuance of the proposed permit can still be made in the absence of the "invalid" condition(s). Such hearing shall be a hearing de novo, and the discretionary body shall have the absolute right to approve, disapprove, or modify the proposed permit and the condition(s) contained therein.

The Owner/Permittees shall defend, indemnify, and hold harmless the City, its agents, officers, and employees from any and all claims, actions, proceedings, damages, judgments, or costs, including attorney's fees, against the City or its agents, officers, or employees, relating to the issuance of this permit including, but not limited to, any action to attack, set aside, void, challenge, or annul this development approval and any environmental document or decision. The City will promptly notify the Owner/Permittees of any claim, action, or proceeding and, if the City should fail to cooperate fully in the defense, the Owner/Permittees shall not thereafter be responsible to defend, indemnify, and hold harmless the City or its agents, officers, and employees. The City may elect to conduct its own defense, participate in its own defense, or obtain independent legal counsel in defense of any claim related to this indemnification. In the event of such election, Owner/Permittees shall pay all of the costs related thereto, including without limitation reasonable attorney's fees and costs. In the event of a disagreement between the City and Owner/Permittees regarding litigation issues, the City shall have the authority to control the litigation and make litigation related decisions, including, but not limited to, settlement or other disposition of the matter. However, the Owner/Permittees shall not be required to pay or perform any settlement unless such settlement is approved by the Owner/Permittee.

ENGINEERING REQUIREMENTS:

14. Prior to the issuance of any construction permit the Owner/Permittees shall submit a Water Pollution Control Plan (WPCP). The WPCP shall be prepared in accordance with the guidelines in Part 2 Construction BMP Standards Chapter 4 of the City's Storm Water Standards.

LANDSCAPE REQUIREMENTS:

- 15. The Owner/Permittees shall be responsible for the maintenance of all landscape improvements shown on the approved plans, including in the right-of-way, unless long-term maintenance of said landscaping will be the responsibility of another entity approved by the Development Services Department. All required landscape shall be maintained consistent with the Landscape Standards in a disease, weed, and litter free condition at all times. Severe pruning or "topping" of trees is not permitted.
- 16. If any required landscape (including existing or new plantings, hardscape, landscape features, etc.) indicated on the approved construction documents is damaged or removed, the Owner/Permittees shall repair and/or replace in kind and equivalent size per the approved documents to the satisfaction of the Development Services Department within 30 days of damage or Certificate of Occupancy.

COMMUNITY PLANNING GROUP:

17. A staging area for T-Mobile service vehicles shall be provided at an area adjacent to the ROW on the east side of the private drive, as shown on the plans.

WCF-TELECOM REQUIREMENTS:

- 18. Every aspect of this project is considered an element of concealment including but not limited to the dimensions, bulk and scale, color, materials, and texture. Any future modifications to this permit must not defeat concealment.
- 19. No overhead cabling is permitted.
- 20. The WCF shall conform to the approved construction plans.
- 21. Photo simulations shall be printed in color on the construction plans.
- 22. The City may require the Owner/Permittees to provide a topographical survey conforming to the provisions of the SDMC may be required if the City determines during construction, that there may be a conflict between the building(s) under construction and a condition of this Permit or a regulation of the underlying zone. The cost of any such survey shall be borne by the Owner/Permittees.

- 23. The Owner/Permittees shall install and maintain appropriate warning signage and barriers on the WCF as required by State and Federal regulations. The Owner/Permittees shall be responsible for complying with all State and Federal regulations.
- 24. Antennas and associated components, such as, but not limited to, remote radio units (RRUs), surge suppressors, etc., shall be concealed by branches at all times and shall not negatively affect the appearance of the tree.
- 25. The accuracy and validity of the RF Compliance Report, submitted by the Permittees, shall be assured while the WCF is in operation. If requested by the City, the Owner/Permittees shall provide an updated RF Compliance Report to address any issues associated with the emitting components of the WCF.
- 26. All equipment, including transformers, emergency generators and air conditioners belonging to the Owner/Permittees shall be designed and operated consistent with the City noise ordinance. Ventilation openings shall be baffled and directed away from residential areas. Vibration resonance of operating equipment in the equipment enclosures shall be eliminated.
- 27. All facilities and related equipment shall be maintained in good working order. Any damaged equipment shall be repaired or replaced within thirty (30) calendar days of notification by the City of San Diego.
- 28. The Owner/Permittees shall notify the City within 30 days of the sale or transfer of this site to any other provider or if the site is no longer operational, in which case, the removal and the restoration of this site to its original condition is required.
- 29. All proposed hand-holes shall be covered with bark material to match the mono-palm trunk to the satisfaction of the Development Services Department.
- 30. All coaxial conduits shall be routed up through the caisson and into the tree to the satisfaction of the Development Services Department. "Doghouse" cable housings are not permitted.
- 31. All branches at the antenna level shall extend a minimum of 24-inches beyond the entire vertical face of each antenna to the satisfaction of the Development Services Department.
- 32. Starting branch height shall be 8-feet, as illustrated on the stamped, approved Exhibit "A".
- 33. All exposed cables, brackets and supports shall be painted to match the faux tree foliage to the satisfaction of the Development Services Department.
- 34. Antenna socks fully covering the front and back of the antennas (and any other components) shall be used.
- 35. All private outdoor lighting shall be shaded and adjusted to fall on the same premises where such lights are located and in accordance with the applicable regulations in the SDMC.

INFORMATION ONLY:

- Please note that a Telecom Planning Inspection Issue will be placed on the project prior to
 Final Clearance from the City's Building Inspector to ensure compliance with the approved
 plans and associated conditions. Prior to calling for your Final Inspection from your building
 inspection official, please contact the Development Services Department Wireless
 Communication Facilities staff listed on City webpage,
 https://www.sandiego.gov/development-services/codes-regulations/wireless-communication-facilities, to schedule an inspection of the completed facility. Please schedule this
 administrative inspection at least five working days ahead of the requested Final Inspection
 date.
- The issuance of this development permit alone does not allow the immediate commencement
 or continued operation of the proposed use on site. The operation allowed by this
 discretionary permit may only begin or recommence after all conditions listed on this permit
 are fully completed and all required ministerial permits have been issued and received final
 inspection.
- Any party on whom fees, dedications, reservations, or other exactions have been imposed as conditions of approval of this permit, may protest the imposition within ninety days of the approval of this development permit by filing a written protest with the City Clerk pursuant to California Government Code-section 66020.
- This development may be subject to impact fees at the time of construction permit issuance.

APPROVED by the Planning Commission of the City of San Diego on June 8, 2023.

AUTHENTICATED BY THE CITY OF SAN DIEGO DEVELOPMENT SERVICES DEPARTMENT


lan Heacox	
Development Project Manager	
NOTE: Notary acknowledgment must be attached per Civil Code	
section 1189 et seq.	
-	es, by execution hereof, agrees to each and every condition of n each and every obligation of Owner/Permittees hereunder.
	DEAN AND IRENE VAYSER
	Owner
	Ву
	NAME:
	TITLE:


NOTE: Notary acknowledgments must be attached per Civil Code section 1189 et seq.







Coverage without SD06217A

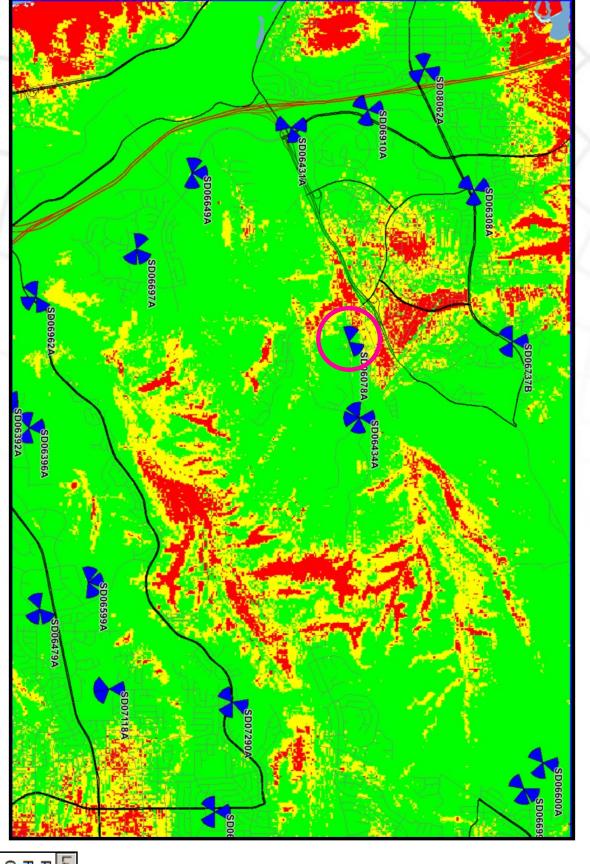

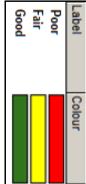

Coverage with SD06217A

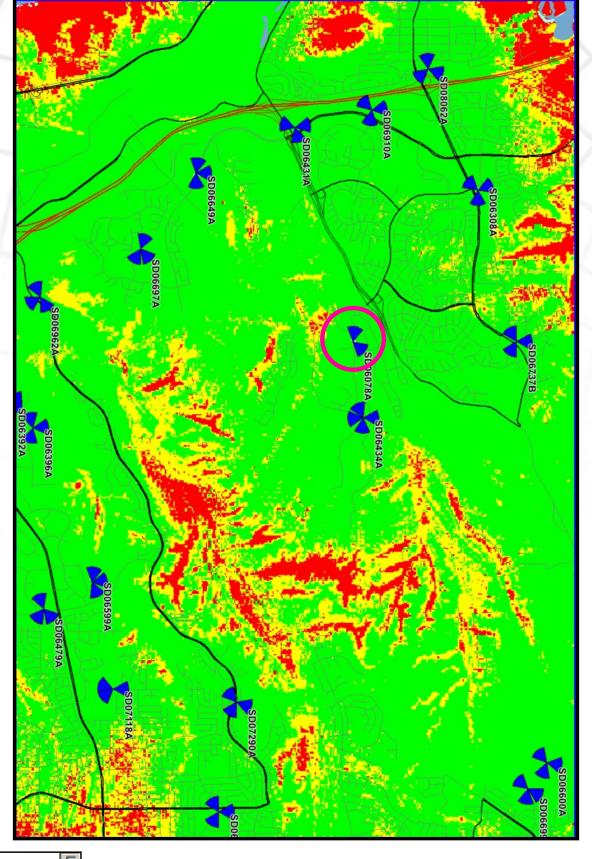

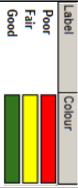

NOTICE OF EXEMPTION

(Check c	ne or l	both)		
TO:	X	RECORDER/COUNTY CLERK P.O. Box 1750, MS A-33 1600 PACIFIC HWY, ROOM 260 SAN DIEGO, CA 92101-2422	FROM:	CITY OF SAN DIEGO DEVELOPMENT SERVICES DEPARTMENT 1222 FIRST AVENUE, MS 501 SAN DIEGO, CA 92101
		OFFICE OF PLANNING AND RESEARCH 1400 TENTH STREET, ROOM 121 SACRAMENTO, CA 95814		

Project No.: 1053192 Project Title: 5005 Del Mar Mesa Road

PROJECT LOCATION-SPECIFIC: The project is located at 5005 Del Mar Mesa Road, San Diego 92130

PROJECT LOCATION-CITY/COUNTY: San Diego/San Diego

<u>DESCRIPTION OF NATURE AND PURPOSE OF THE PROJECT:</u> Conditional Use Permit (CUP) to continue the operation of an existing wireless communication facility (WCF). The WCF includes antennas on an existing 18-foot tall monotree pole, two antennas would be replaced with 2 new panel antennas. The equipment is located inside an existing equipment enclosure. The WCF in unmanned and is not for human habitation.

NAME OF PERSON OR AGENCY CARRYING OUT PROJECT: Plancom, Shelly Kilbourn- 302 State Place, Escondido CA 92029 619 208-4685

EXEMPT STATUS: (CHECK ONE)

- () MINISTERIAL (SEC. 21080(b)(1); 15268);
- () DECLARED EMERGENCY (Sec. 21080(b)(3); 15269(a));
- () EMERGENCY PROJECT (Sec. 21080(b)(4); 15269 (b)(c)...
- (X) CATEGORICAL EXEMPTION: 15301 (Existing Facilities)
- () STATUTORY EXEMPTION:

REASONS WHY PROJECT IS EXEMPT: The City of San Diego conducted an environmental review and determined that the project would qualify to be categorically exempt from CEQA pursuant to Section 15301 (Existing Facilities). Section 15301 allows for the operation, repair, maintenance, permitting, leasing, licensing, or minor alteration of existing facilities (public or private), involving negligible or no expansion of use beyond that existing at the time of the determination. Since the project would only permit the continual operation of an existing WCF and would not expand the use the exemption was deemed appropriate. The project is located on a developed site and no environmental impacts would occur and none of the exceptions described in CEQA Guidelines Section 15300.2 apply.

ı						
ı				DV	V DDI	ICANT:
ı	11	ΗII	ヒヒレ	DТ	APPL	ILANI.

- 1. ATTACH CERTIFIED DOCUMENT OF EXEMPTION FINDING.
- 2. HAS A NOTICE OF EXEMPTION BEEN FILED BY THE PUBLIC AGENCY APPROVING THE PROJECT?

() YES () No

IT IS HEREBY CERTIFIED THAT THE CITY OF SAN DIEGO HAS DETERMINED THE ABOVE ACTIVITY TO BE EXEMPT FROM CEQA

Jeff Szymanski /SENIOR PLANNER

MARCH 15, 2023

DATE

CHECK ONE:

(X) SIGNED BY LEAD AGENCY

DATE RECEIVED FOR FILING WITH COUNTY

CLERK OR OPR:



City of San Diego Development Services 1222 First Ave., MS 302 San Diego, CA 92101 (619) 446-5000

Ownership Disclosure Statement

FORM

DS-318

October 2017

Approval Type: Check appropriate box for type of ap □ Neighborhood Development Permit □ Site Deve □ Tentative Map □ Vesting Tentative Map □ Map	elopment Permit 🛭 Planned Developm	ent Permit	Conditional Use Po	
Project Title: _BU 823674 Crown Sharf		Project No	. For City Use Only	:
5005 Project Address: 5109 Del Mar Mesa Road				
5				
Specify Form of Ownership/Legal Status (please ☐ Corporation ☐ Limited Liability -or- ☐ General		Identification	n No.	
□ Partnership □ Individual				
By signing the Ownership Disclosure Statement, the with the City of San Diego on the subject proper owner(s), applicant(s), and other financially interested individual, firm, co-partnership, joint venture, assowith a financial interest in the application. If the individuals owning more than 10% of the shares. Officers. (A separate page may be attached if neces and person serving as an officer or director of a signature is required of at least one of the proposition of the project Manager of any changes in the project Manager of any changes in the project Manager accurate and current ownership information could be one of the project Manager of any changer accurate and current ownership information could be one of the project Manager of any changer accurate and current ownership information could be one of the project Manager of any changer accurate and current ownership information could be one of the project Manager of any changer accurate and current ownership information could be one of the project Manager of any changer of	ty with the intent to record an encum sted persons of the above referenced pociation, social club, fraternal organizat applicant includes a corporation or pall if a publicly-owned corporation, includes sessary.) If any person is a nonprofit organization or as trust perty owners. Attach additional page ownership during the time the applicated at least thirty days prior to any public	brance again property. A fiction, corpora rtnership, include the names anization or stee or bene is if needed. tion is being hearing on t	nst the property. Prinancially interested tion, estate, trust, relude the names, tit s, titles, and address a trust, list the name ficiary of the nonpose. Note: The applicars processed or cons	lease list below the diparty includes any eceiver or syndicate les, addresses of all ses of the corporate es and addresses of profit organization. It is responsible for idered. Changes in
Property Owner	, , ,			
Name of Individual: Dean and Irene Vayser		■ Owner	☐ Tenant/Lessee	☐ Successor Agency
Street Address: 5005 Del Mar Mesa Road				
City: _San Diego			State: CA	Zip: 92130
Phone No.:		Date:		
Additional pages Attached:				
Applicant				
Name of Individual: Crown Castle - Jim Lee		☐ Owner	■ Tenant/Lessee	☐ Successor Agency
Street Address: 200 Spectrum Center Drive, Suite 1700				
City: Irvine			State: _CA	Zip: _92618
Phone No.: 949-930-4360	Fax No.:	Email: jim.	lee@crowncastle.com	
Signature:				
Additional pages Attached:	□No			
Other Financially Interested Persons				
Name of Individual:		☐ Owner	☐ Tenant/Lessee	☐ Successor Agency
Street Address:				
City:			State:	Zip:
Phone No.:	Fax No.:	Email:		
Signature:				
Additional pages Attached:	□ No			

Page 3

City of San Diego · Information Bulletin 620

August 2018



City of San Diego Development Services 1222 First Ave., MS-302 San Diego, CA 92101

Community Planning Committee Distribution Form

Project Name:	-11.0%-	Project Numbe	r:							
T-Mobile Del Mar Mesa Ce	ell Site	PRJ-1053192								
Community: Del Mar Mes	sa .									
log	scope and contact inform g into OpenDSD at https://news.nico.org	//aca.accela.com/	'SANDIE	<u>GO</u> .						
☐ Vote to Approve	□ Vote to Approve Date of Vote:									
• •	n Conditions Listed Below	ı								
□ Vote to Approve with Conditions Listed Below November 10, 2022										
□ Vote to Deny										
# of Members Yes	# of Me	Members Abstain								
8		0								
Conditions or Recomment Provide a staging area for property. An area adjace attached graphic was cho	ndations: or T-Mobile service vehicle nt to the ROW on the eas osen and is also depicted	s in one of three I t side of the privat on the Crown Cas	ocations e drive a stle/T-Ma	s shown on the facilities as depicted on the obile Plan set submitted						
	further information, Split vote,	Lack of quorum, etc.)							
NAME: Paul Metcalf										
TITLE: Chair			DATE:	January 16, 2023						
Attac	ch additional pages if nece	ssary (maximum 3	3 attachr	ments).						

PHOTO STUDY & KEY MAP

PROPOSAL TO MODIFY AND OPERATE AN EXISTING COMMUNICATIONS FACILITY

Crown Castle - T-Mobile "Del Mar Ridge"

5109 Shaw Ridge Road/5109 Del Mar Mesa Road San Diego, CA 92130

Prepared for:

City of San Diego Development Services Department

1222 First Avenue San Diego, CA 92101

Prepared by:

PlanCom, Inc. *Contractor Representatives for*

Crown Castle

302 State Place Escondido, CA 92029 Contact: Shelly Kilbourn, Planning Consultant (619) 223-1357

October 26, 2020



North Elevation



South Elevation



East Elevation



West Elevation



View North




View South



View East



View West

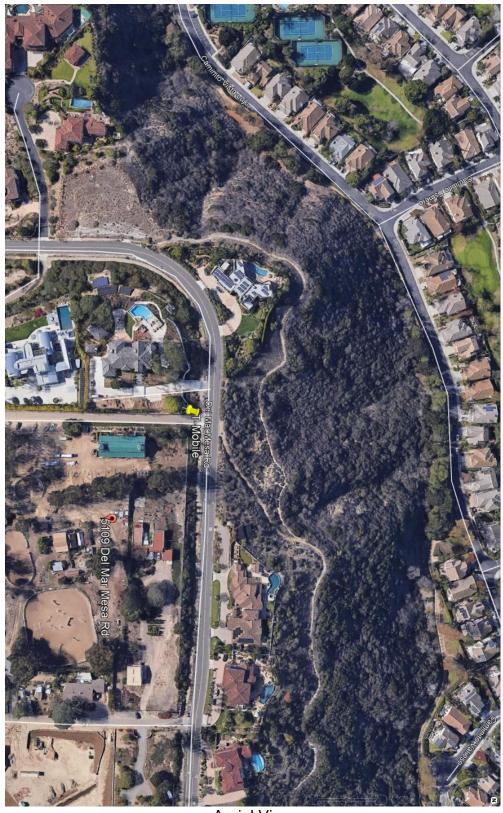

Aerial View

Attachment 11 SD06078A

Del Mar Ridge

SCOS Del Mar Mesa Road
San Diego, CA 92130

r'r'CROWN v-cASTLE





SD06078A
Del Mar Ridge
SOOS Del Mar Mesa Road
San Diego, CA 92130

r'r'CROWN v-cASTLE





SD06078A
Del Mar Ridge
SOOS Del Mar Mesa Road
San Diego, CA 92130
r'r'CROWN
v-cASTLE







CUP RENEWAL PROJECT:

SITE CASCADE: SD06078A

SITE NAME: **DEL MAR RIDGE**

CCI SITE ID: 823674

ADDRESS: MESA RD

SAN DIEGO, CA 92130

LATITUDE: 32°56' 30.07" N 117° 12' 30.53" W LONGITUDE:

SITE TYPE: **MONOELM**

SITE INFORMATION

PROPERTY OWNER

VAYSER, DEAN & IRENE 5005 DEL MAR MESA RD SAN DIEGO, CA92137 CONTACT:

APPLICANT: ADDRESS: 10509 VISTA SORRENTO PARKWAY, SUITE 206 SAN DIEGO, CA 92121

NAD-83 LAT/LONG TYPE LATITUDE: 32 56 30.07 N LONGITUDE: 117 12 30.530 w ZONING JURISDICTION:

ZONING CLASSIFICATION: 7 AR-1-1

UNMANNED TELECOMMUNICATIONS FACILITY CURRENT USE:

ASSESSOR'S PARCEL NO .: 307-660-13-00 PROPOSED USE:

UNMANNED TELECOMMUNICATIONS FACILITY

TYPE OF CONSTRUCTION: V-8 OCCUPANCY GROUP:

PROJECT TEAM

CLIENT REPRESENTATIVE: CROWN CASTLE

COUNT CASTLE
200 SPECTRUM CENTER DR., STE. 1700,
IRVINE, CA 92618
CONTACT: JIM LEE
JIM.LEE@CROWNCASTLE.COM SAN CLEMENTE, CA 92673 CONTACT: MICHAEL MONTELLO PHONE: (949) 391-6824

DEPRATTI INC CONTACT: DEPRATTI INC 13948 CALLE BUENO GANAR JAMUL, CA 91935 DEBRA D GARDNER

T-MOBILE CONTACT: T-MOBILE 1-MOBILE 10509 VISTA SORRENTO PARIGNAY SUITE 206 SAN DIEGO, CA 92121

VICINITY MAP

DRIVING DIRECTIONS

DIRECTIONS FROM SAN DIEGO INTERNATIONAL AIRPORT:

- 1. HEAD EAST ON N HARBOR DR
- 2. TURN LEFT ONTO W LAUREL ST
- 3. TURN LEFT ONTO INDIA ST.
- 4. TAKE THE RAMP ONTO 15 N
- 6. KEEP RIGHT AT THE FORK TO CONTINUE ON 15. FOLLOW SIGNS FOR CA-56 E
- 7. KEEP RIGHT TO CONTINUE ON CA-56 E
- 8. TAKE EXIT 2 FOR CARMEL COUNTRY RD
- TURN RIGHT ONTO CARMEL COUNTRY RD 10. TURN LEFT ONTO DEL MAR MESA RD

DESTINATION IS ON THE RIGHT IN 0.5 MI

PROJECT DESCRIPTION

T-MOBILE PROPOSES TO RENEW THE LAND USE PERMIT FORAN EXISTING WIRELESS INSTALLATION. THE SCOPE WILL CONSIST OF THE FOLLOWING:

REMOVE REMOVE

L
DEGITING ANTENNAS
DEGITING TIMAS
DEGITING TIMAS
PROPOSED ERICSSON AIR 6449 B#1 ANTENNAS
PROPOSED ERICSSON RADIO 4415 B25
PROPOSED 6X12 HCS 6AWG HYBRID CABLES
DEGITING EQUIPMENT CABINET
PROPOSED ENCLOSURE 6160
PROPOSEDB160BATTERYCABINET

'ALL ANTENNAS, CABLING, AND POLES ARE TO BE PAINTED GREEN
'EXISTING LANDSCAPING TO REMAIN AND BE MAINTAINED THRU THE DURATION OF THE PERMIT.

GENERAL NOTES

THE FACILITY IS UNMANNED AND NOT FOR HUMAN HABITATION. HANDICAPPED ACCESS REQUIREMENTS ARE NOT REQUIRED IN ACCORDANCE WITH THE 2019 CALIFORNIA BUILDING CODE. A TECHNICAN WILL VISIT THE SITE AS REQUIRED FOR ROUTINE MAINTENANCE. THE PROJECT WILL NOT RESULT IN ANY SIGNIFICANT DISTURBANCE OR EFFECT ON DRAINAGE; NO SANITARY SEVER SERVICE, POTABLE WATER, OR TRASH DISPOSAL IS REQUIRED AND NO COMMERCIAL SIGNAGE IS NEW.

ENGINEERING

ALL WORK AND MATERIALS SHALL BE PERFORMED AND INSTALLED IN ACCORDANCE WITH THE CURRENT EDITIONS OF THE FOLLOWING CODES AS ADOPTED BY THE LOCAL GOVERNING AUTHORITIES.

- 2019 CALIFORNIA BUILDING CODE
- 2019 CALIFORNIA BUILDING CODE
 CITY/COUNTY ORDINANCES
 BUILDING OFFICIALS & CODE ADMINISTRATORS (BOCA)
 2019 MECHANICAL CODE
 2019 FIRE CODE
 2019 FLUMBING CODE
 2019 LECTRICAL CODE

- LOCAL BUILDING CODE

DO NOT SCALE **DRAWINGS**

SUBCONTRACTOR SHALL VERIFY ALL PLANS, EXISTING DIMENSIONS & FIELD CONDITIONS ON THE JOB SITE & SHALL IMMEDIATELY NOTIFY THE ENGINEER N WRITING OF ANY DISCREPANCIES BEFORE PROCEEDING WITH THE WORK OR BE RESPONSIBLE FOR SAME.



ZONING DRAWINGS

DRAWING INDEX SHEET TITLE SHEET NO: T.1 TITLE SHEET LANDSCAPE PLAN SITE PLAN AND ENLARGED SITE PLAN A-1 A-2 EQUIPMENT LAYOUT A-3 ANTENNA LAYOUT A-4 ELEVATION MONOELM STRUCTURAL ELEVATION VIEW AND PLAN VIEW- SCI RF-1 RF-2 MONOELM BRANCH LAYOUT AND EPA VALUES- SCI

APPROVALS

THE FOLLOWING PARTIES HEREBY APPROVE AND ACCEPT THESE DOCUMENTS & AUTHORIZE THE SUBCONTRACTOR TO PROCEED WITH THE CONSTRUCTION DESCRIBED HEREIN. ALL DOCUMENTS ARE SUBJECT TO REVIEW BY THE LOCAL BUILDING DEPARTMENT & MAY IMPOSE CHANGES OR MODIFICATIONS.

T-MOBILE RF ENGINEER:	DATE:
T-MOBILE OPERATIONS:	DATE:
SITE ACQUISITION:	DATE:
CONSTRUCTION MANAGER:	DATE:
PROPERTY OWNER:	DATE:
ZONING:	DATE:
PROJECT MANAGER:	DATE:

tF ·· Mobile · · ·

10509 VISTA SORRENTO PARKWAY, SUITE 206 SAN DIEGO, CA 92121



200 SPECTRUM CENTER DR., STE. 1700, IRVINE. CA 92618



DRAWN BY: CHECKED BY:

H		
4	02/17/2023	100% ZD'S REV L'SCAPING
3	12/08/2022	100% ZD'S REV CLIENT
&	06/14/2022	100% ZD'S REVISED: JX
1	04/20/2021	100% ZD'S FOR SUBMITTAL
0	03/11/2020	90% ZD'S FOR REVIEW
REV	DATE	DESCRIPTION

THIS DOCUMENT IS FOR ZONING **PURPOSES AND IS** NOTFOR CONSTRUCTION

IT B A VICLATION OF LAW FOR ANY PERSON, UNLESS PEY ARE ACTING UNDER THE DIRECTION OF A LICENST PROPESSIONAL ENGINEER, TO ALTER THIS DOCUMENT.


DEL MAR RIDGE SD06078A BU# 823674 5005 DEL MAR MESA RD SAN DIEGO, CA 92130 MONOELM

SHEET TITLE

TITLE SHEET

SHEET NUMBER

T-1

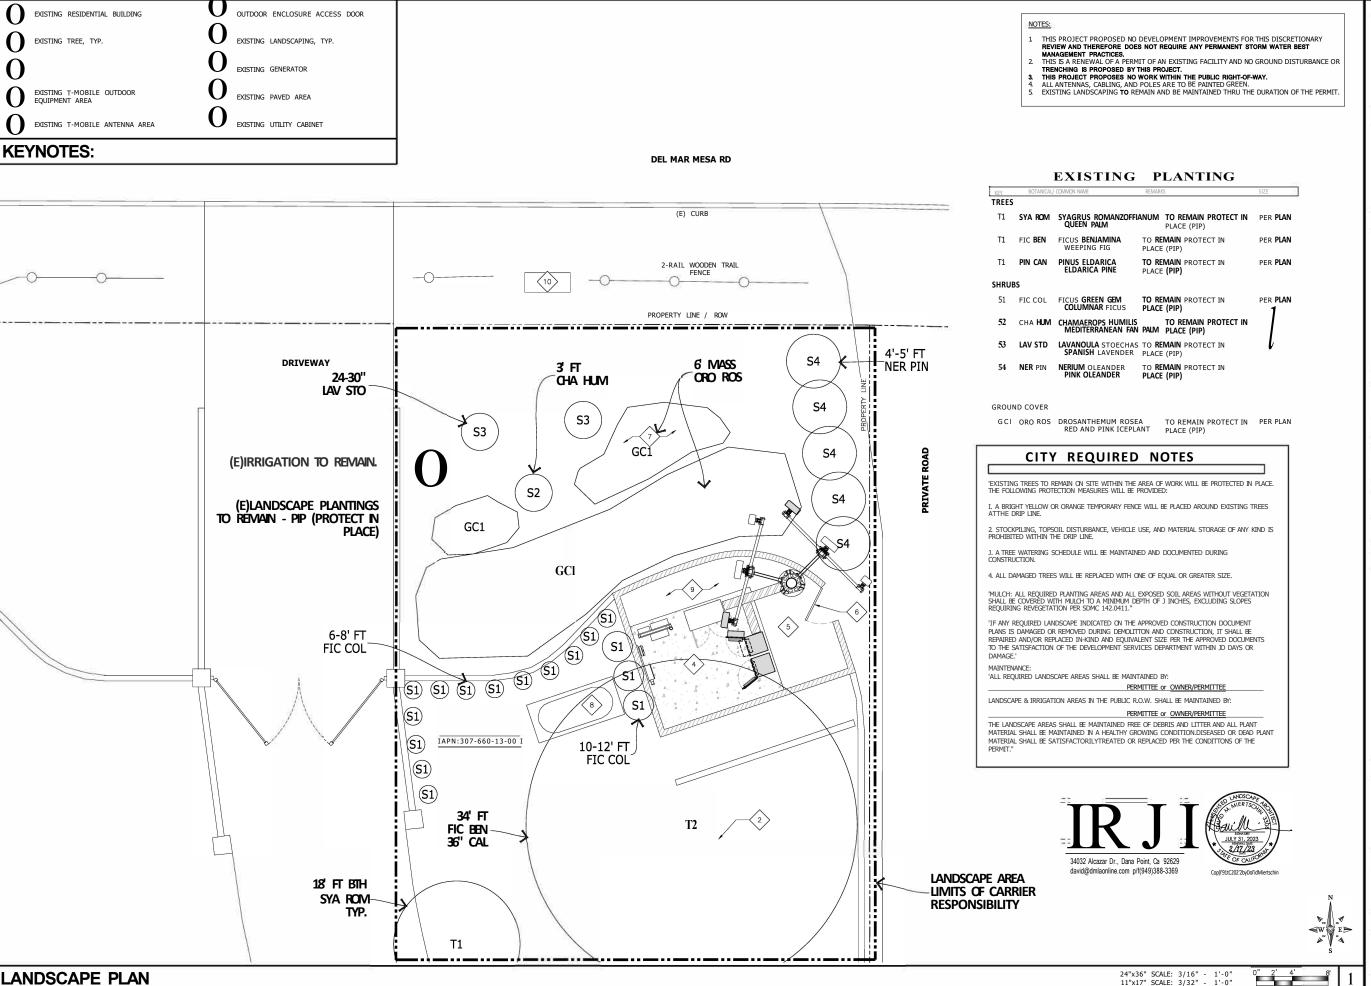

t.F.·Mobile···

10509 VISTA SORRENTO PARKWAY, SUITE 206 SAN DIEGO, CA 92121


rrcROWN V'-'CASTLE

200 SPECTRUM CENTER DR., STE. 1700, IRVINE, CA 92618

M SQUARI: • J.,

1317 CALLE AVANZADO 9/N CLEMENIE CA 926/3 (1148)381/61124

DRAWN BY: MI
CHECKED BY: MA

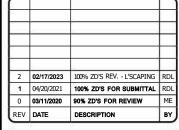

JI 5 A VIOLATION OF LAW FOR ANY PERSON, UNLESS THEY ARE ACTING UNDER THE DIRECTION OF A LICENSE PROFESSIONAL ENGINEER, TO ALTER THIS DOCUMENT.

DEL MAR RIDGE SD06078A BU# 823674 5109 SHAW RIDGE RD/ 5109 DEL MAR MESA RD SAN DIEGO, CA 92130


SAN DIEGO, CA 92130 MONOELM


SHEET TITLE

LANDSCAPE PLAN

SHEET NUMBER

1 -1

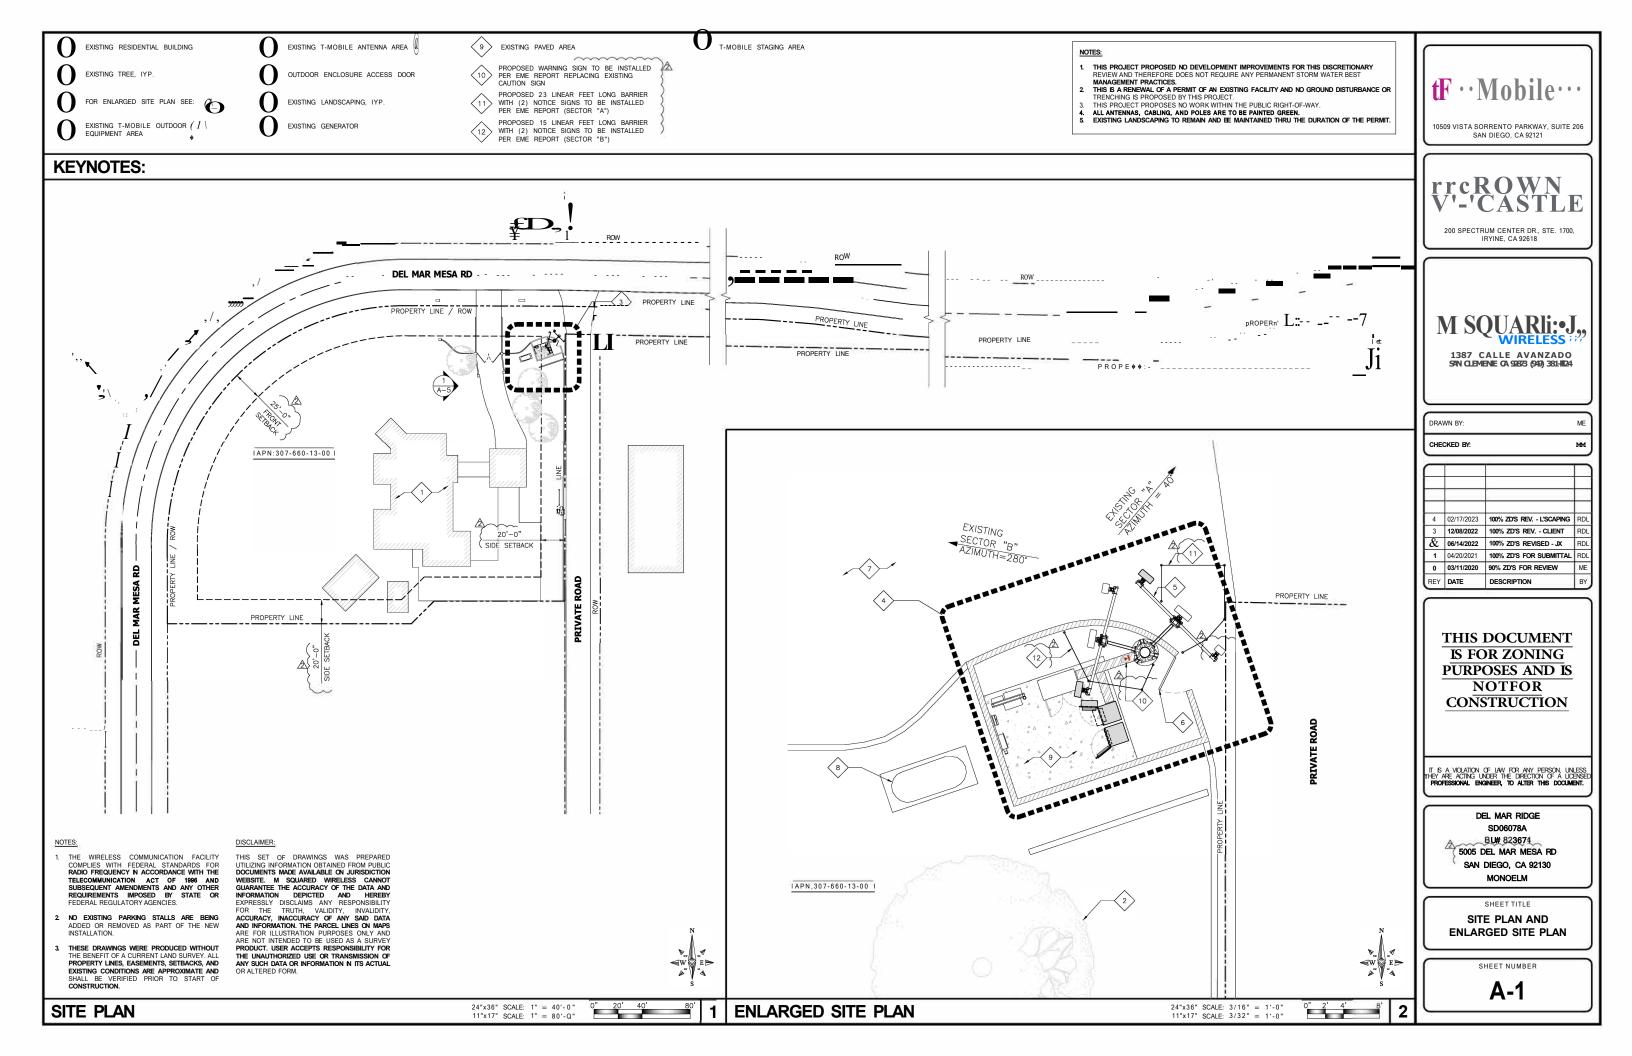

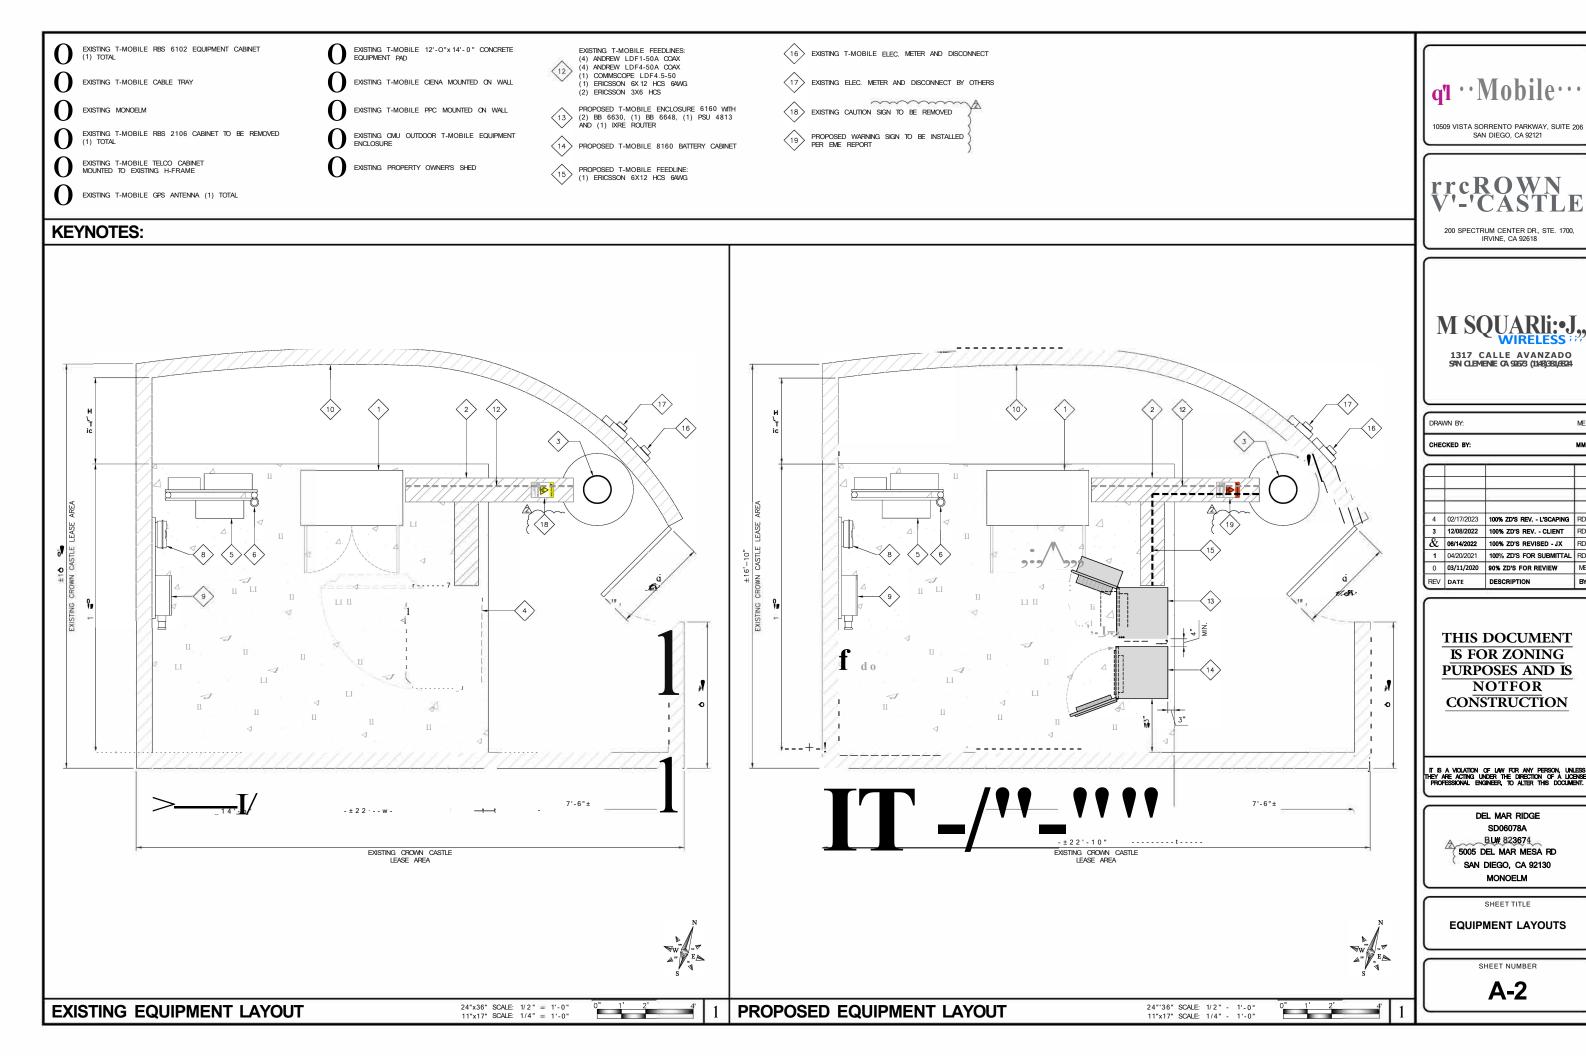

FINAL EQUIPMENT SCHEDULE (VERIFY WITH CURRENT RFDS)

ALPHA																		
		ANTENNA			RADIO		DIP LEXER			TMA		SURGE PROTECTION		CABLES				
POSITION	TECH.	STATUS/MANUFACTURER MODEL	AZIMUTH	RAD CENTER	QTY.	STATUS/MODEL	LOCATION	QTY.	STATUS	LOCATION	QTY.	STATUS	QTY.	STATUS/MODEL	QTY.	STATUS/TYPE	SIZE	LENGTH
Al	L2500 N2500	NEW ERICSSON AIR6449 B41	40-	13'-o"	-	<u>(24</u>)	201	-	2	<u>u</u> :	įΈ.	32-	ST.	<u>~</u>	1	NEW 6X12 HCS 6AWG	-	30'-o"
	L600 L700				1	EXISTING ERICSSON RADIO 4449 B71 + B85	TOWER	٦						4	EXISTING COAX	_	_	
A2	L1900 UI 900	EXISTING RFS/CELWAVE APXVMRRI 8_43-U-NA20	##*	13'-Q"		NEW ERICSSON	TOMER	-		3		16	-	\E	4	EXISTING COAX	_	-
	N600				1.5	RADIO 4415 825	MIL.	_					_		1	EXISTING COAX	J)F4.5-5C	30'-0"
	L1900	EXISTING ERICSSON	40	401.01											1	EXISTING 6X12 HCS 6AWG	is a	30'-o"
A3	L2100 GI 900	AIR 32 B2A/B66A	40-	13'-Q"	=	<u> </u>	55.5	372	35	-54	8 77	<u> </u>	2 	*5	2	EXISTING 3X6	:53	30'-Q"
BETA			·															0
81	L2500 N2500	NEW ERICSSON AIR6449 B41	280"	13'-Q"	=	¥	¥3	-	=	¥5	<u> </u>	82	:=	92	-	=	=	=
	L600 L700	EXISTING RFS/CELWAVE			1	EXISTING ERICSSON RADIO 4449 B71 + B85	TOWER		=1	41		.==			121	121		
B2	L1900 UI 900 N600	APXVMRRI 8_43-U-NA20	280"	13'-0"	1	NEW ERICSSON RADIO 4415 B25	TOWER	-		-	-		12	-				
В3	LISOO L2100 GI 900	EXISTING ERICSSON AIR 32 82A/B66A	280"	13'-o"	77	2	20	<u> </u>	.	3 25	:52	\$ 5	\$E	æ	15	ą	2	2
					_		1	_	I	1	_		_	1	1			

- CONTRACTOR IS TO REFER TO T-MOBILE'S MOST CURRENT RADIO FREQUENCY DATA SHEET (RFD\$) PRIOR TO CONSTRUCTION
 CABLE LENGTHS WERE DETERMINED BASED ON VISUAL INSPECTION DURING STE-WALK.
 CONTRACTOR TO VERIFY ACTUAL LENGTH DURING PRE-CONSTRUCTION WALK
 CONTRACTOR TO VERIFY PORTS HAVE SUFFICIENT ROOM

EXISTING STANDOFF ARM, (2 TOTAL)

- OTE:
 ISTING ANTENNA AZIMUTHS ARE ESTIMATED
 AND ARE TO BE VERIFIED BY RF.
 EXISTING MONOELM FRONDS AND BRANCHES NOT
 SHOWN FOR CLARITY IN THIS VIEW
 ALL ANTENNAS, CABLING, AND POLES ARE TO BE
 PAINTED GREEN.
 EXISTING LANDSCAPING TO REMAIN AND BE
 MAINTAINED THRU THE DURATION OF THE PERMIT.

tF ·· Mobile · · ·

10509 VISTA SORRENTO PARKWAY, SUITE 206 SAN DIEGO, CA 92121

200 SPECTRUM CENTER DR., STE. 1700, IRVINE, CA 92618



1387 CALLE AVANZADO 9/N CLEMENIE (A 928/3 (949) 381-1124

CHECKED BY:

4 02/17/2023 100% ZD'S REV. - L'SCAPING 3 12/08/2022 100% ZD'S REV. - CLIENT & 06/14/2022 100% ZD'S REVISED - JX 1 04/20/2021 100% ZD'S FOR SUBMITTAL 0 03/11/2020 90% ZD'S FOR REVIEW REV DATE DESCRIPTION

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IT IS A VIOLATION OF LAW FOR ANY PERSON, UNLESS THEY ARE ACTING UNDER THE DIRECTION OF A LICENSE PROFESSIONAL ENGINEER, TO ALTER THIS DOCUMENT.

DEL MAR RIDGE SD06078A BU# 823674 5005 DEL MAR MESA RD SAN DIEGO, CA 92130 MONOELM

SHEET TITLE

ANTENNA PLANS

SHEET NUMBER

A-3

EXISTING T-MOBILE 12'-6" LONG HORIZONTAL PIPE

KEYNOTES

EXISTING MONOELM

EXISTING T-MOBILE AIR 32 82A/866A ANTENNAS, MOUNTED TO EXISTING PIPE

EXISTING T-MOBILE RADIO 4449 B71 +B85, MOUNTED TO EXISTING PIPE

EXISTING T-MOBILE RFS-APXVMRR18 ANTENNAS, MOUNTED TO EXISTING PIPE

EXISTING T-MOBILE AIR 21 82A/84P ANTENNAS, MOUNTED TO EXISTING PIPE, TO BE REMOVED (2 TOTAL, 1 PER SECTOR)

EXISTING T-MOBILE TMA, MOUNTED TO EXISTING PIPE TO BE REMOVED


PROPOSED T-MOBILE AIR6449 841 ANTENNAS, MOUNTED TO EXISTING PIPE


24"x36" SCALE: 1/2" = 1'-0" II"x17" SCALE: 1/4" = 1'-0"

PROPOSED T-MOBILE RADIO 4415 825, MOUNTED TO EXISTING PIPE (2 TOTAL, 1 PER SECTOR)


ANTENNA & EQUIPMENT SCHEDULE


EXISTING ANTENNA PLAN

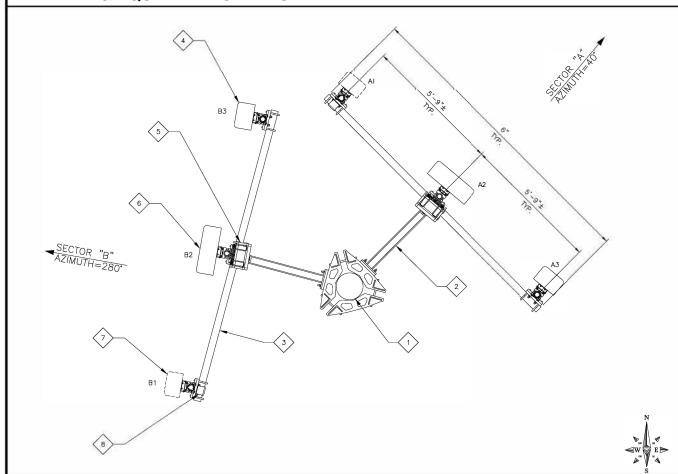


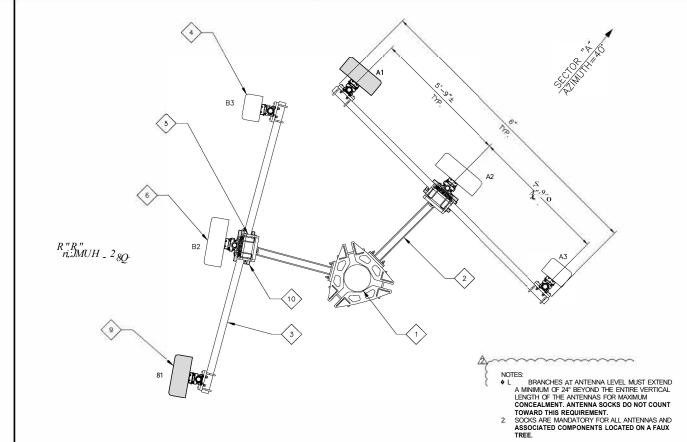

PROPOSED ANTENNA PLAN

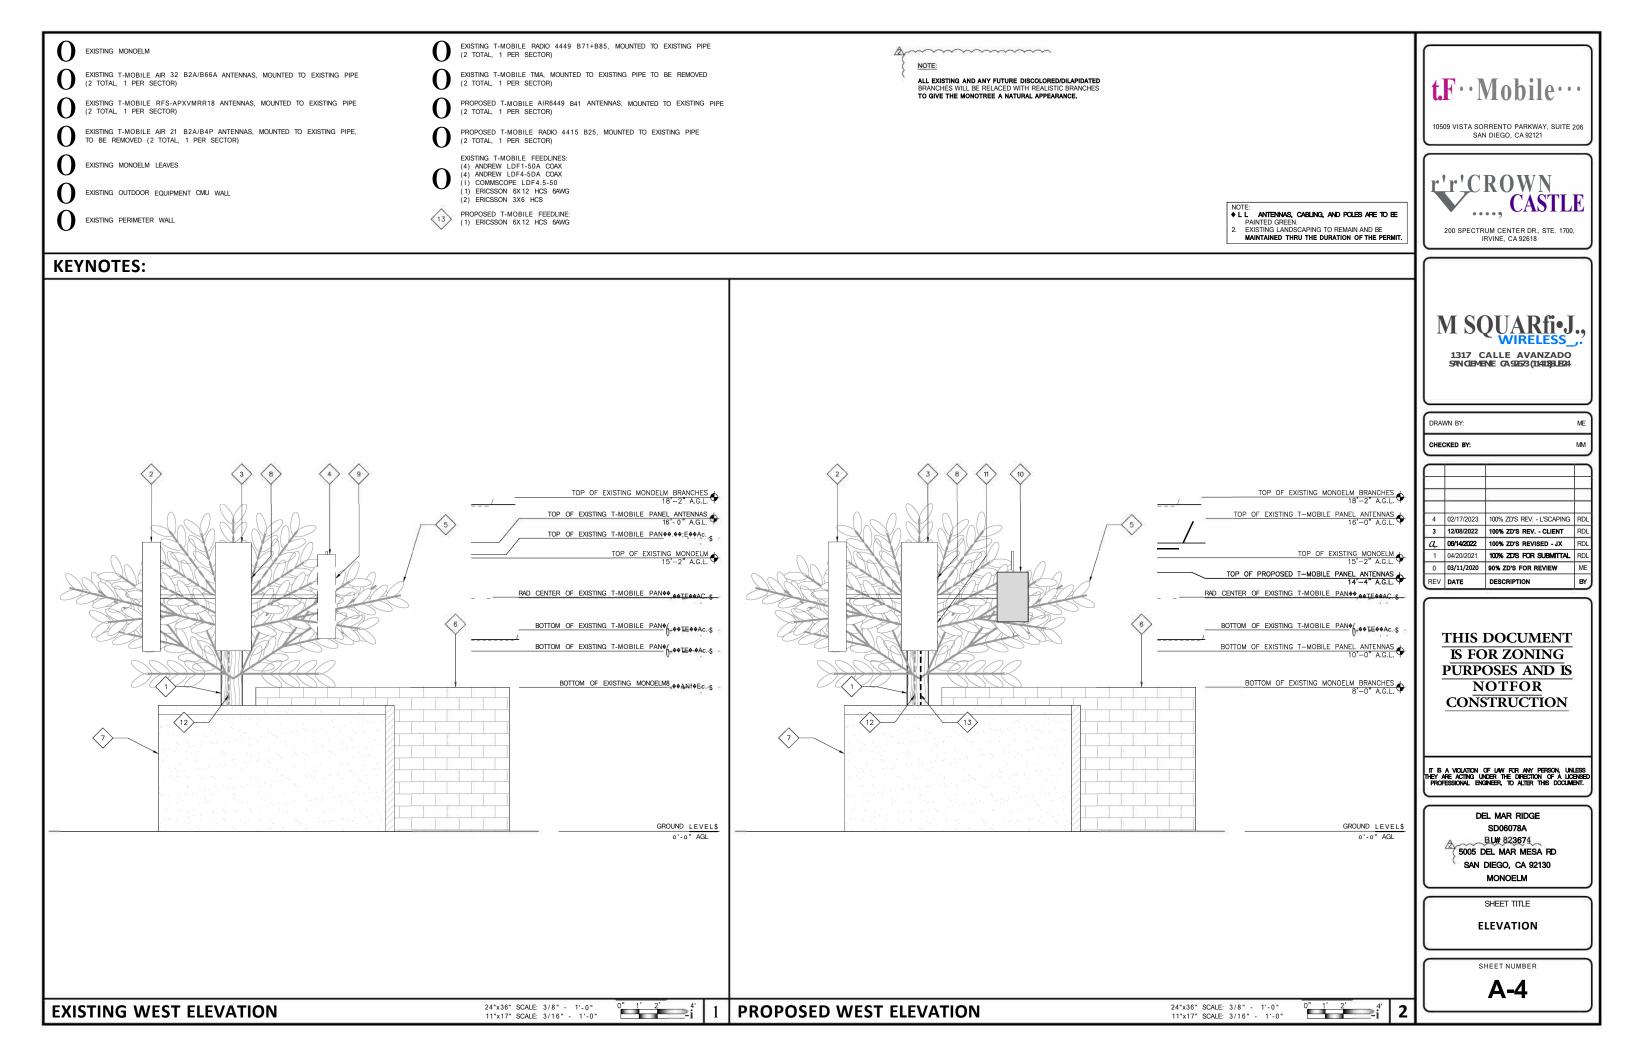

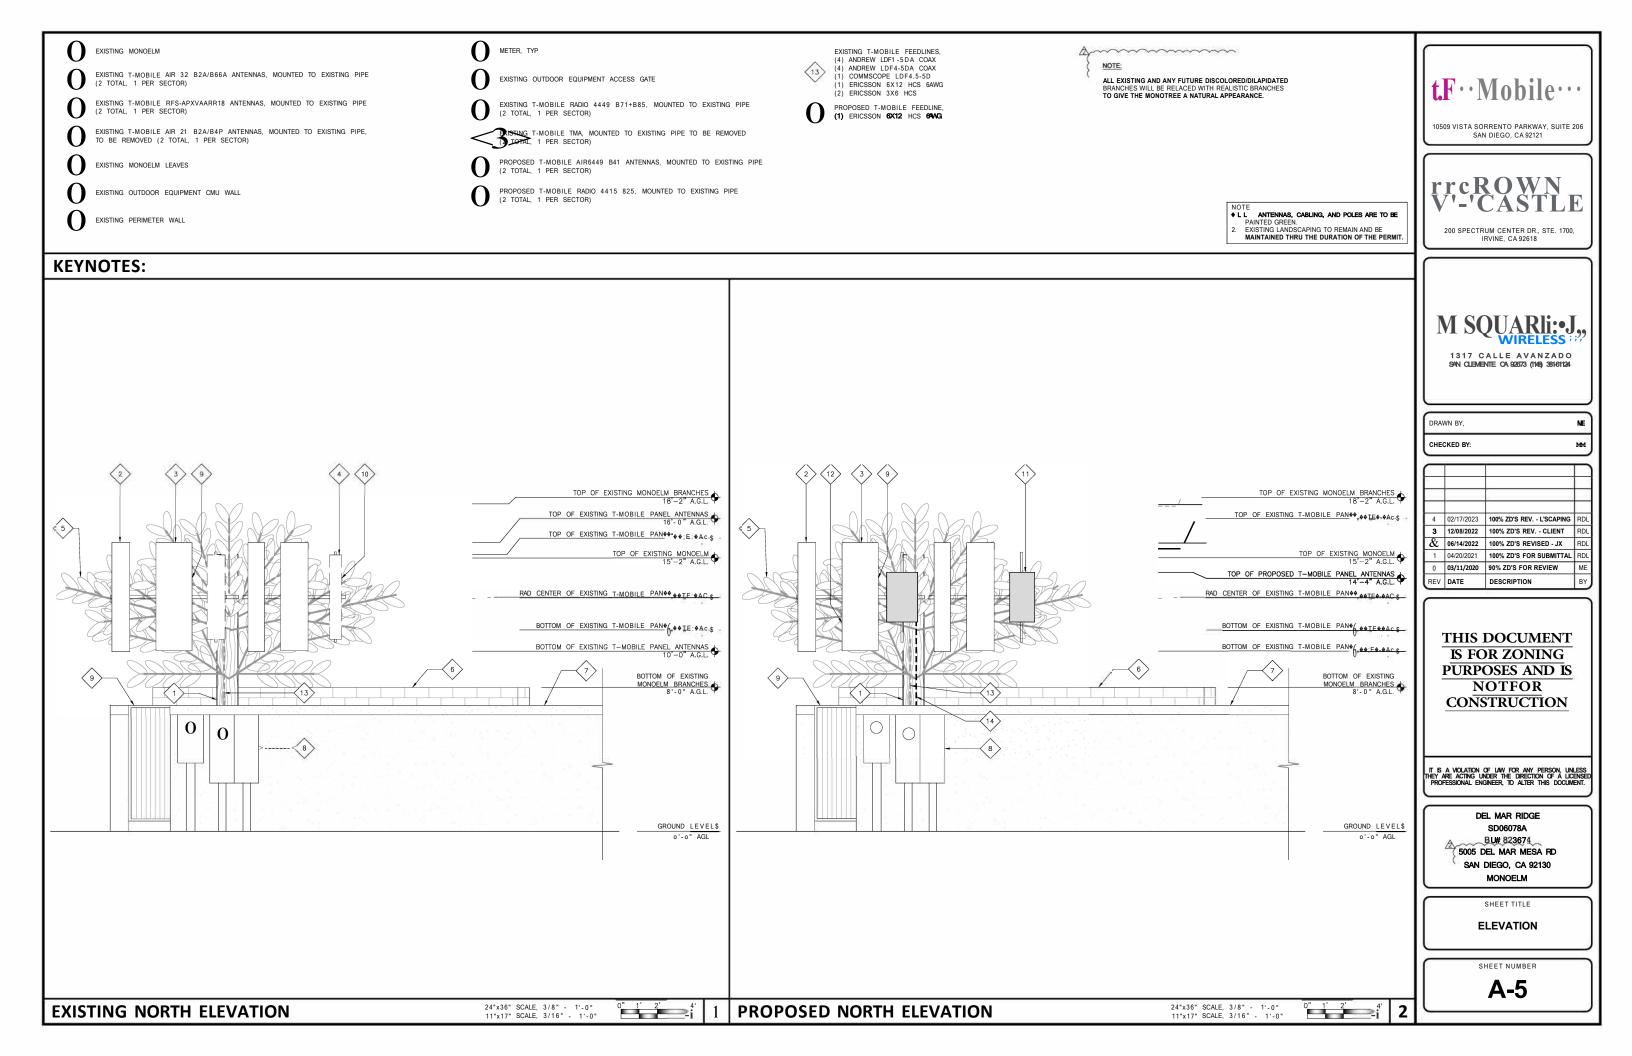

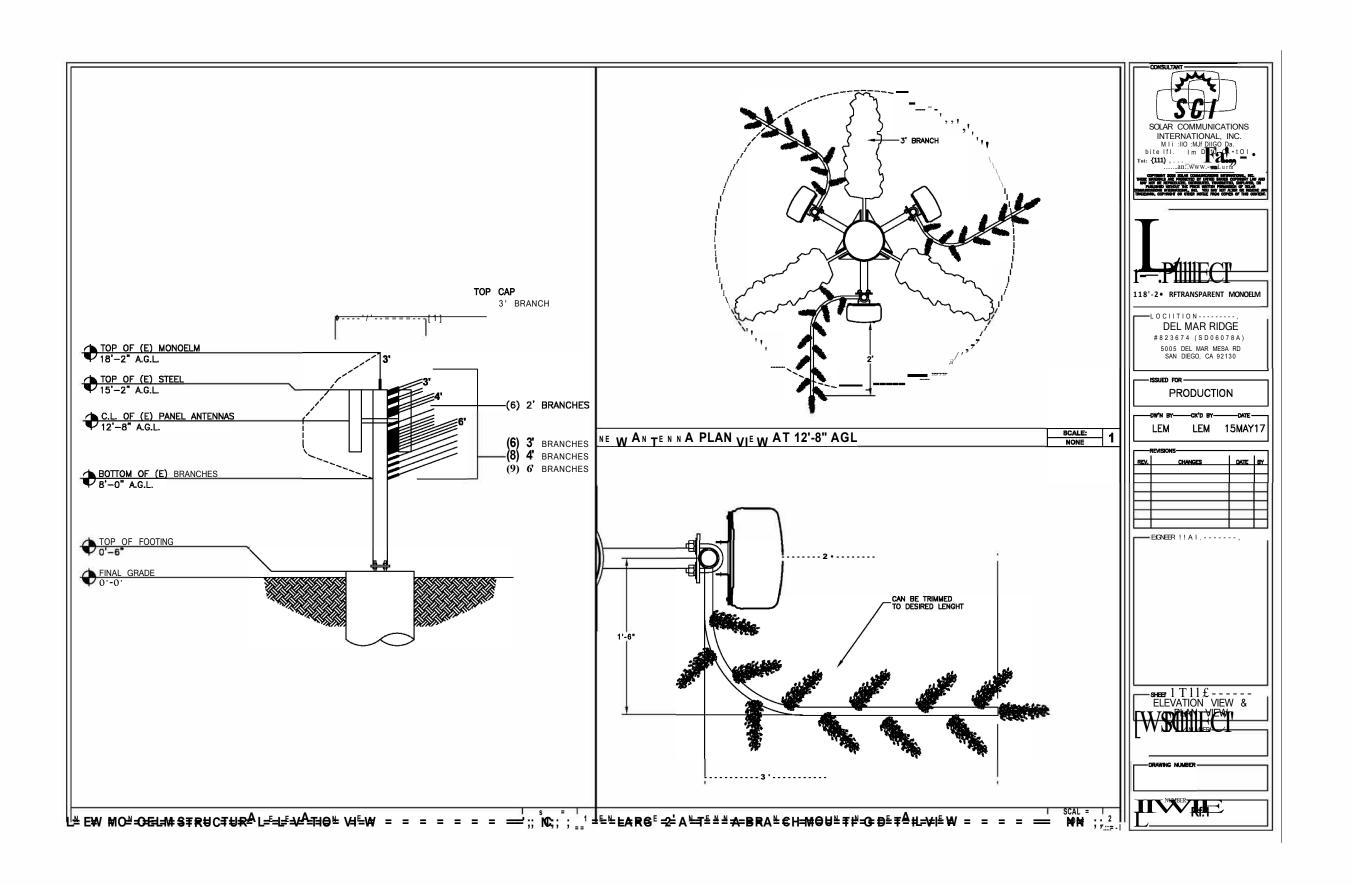

t.F · · Mobile · ·

10509 VISTA SORRENTO PARKWAY, SUITE 206 SAN DIEGO, CA 92121

200 SPECTRUM CENTER DR, STE. 1700, IRVINE, CA 92618

M SQUARI: • J.,

1 3 1 7 C A L L E A V A N Z A D O SAN CLEMENIE CA 92673 (1148) 381-61124

CHECKED BY:

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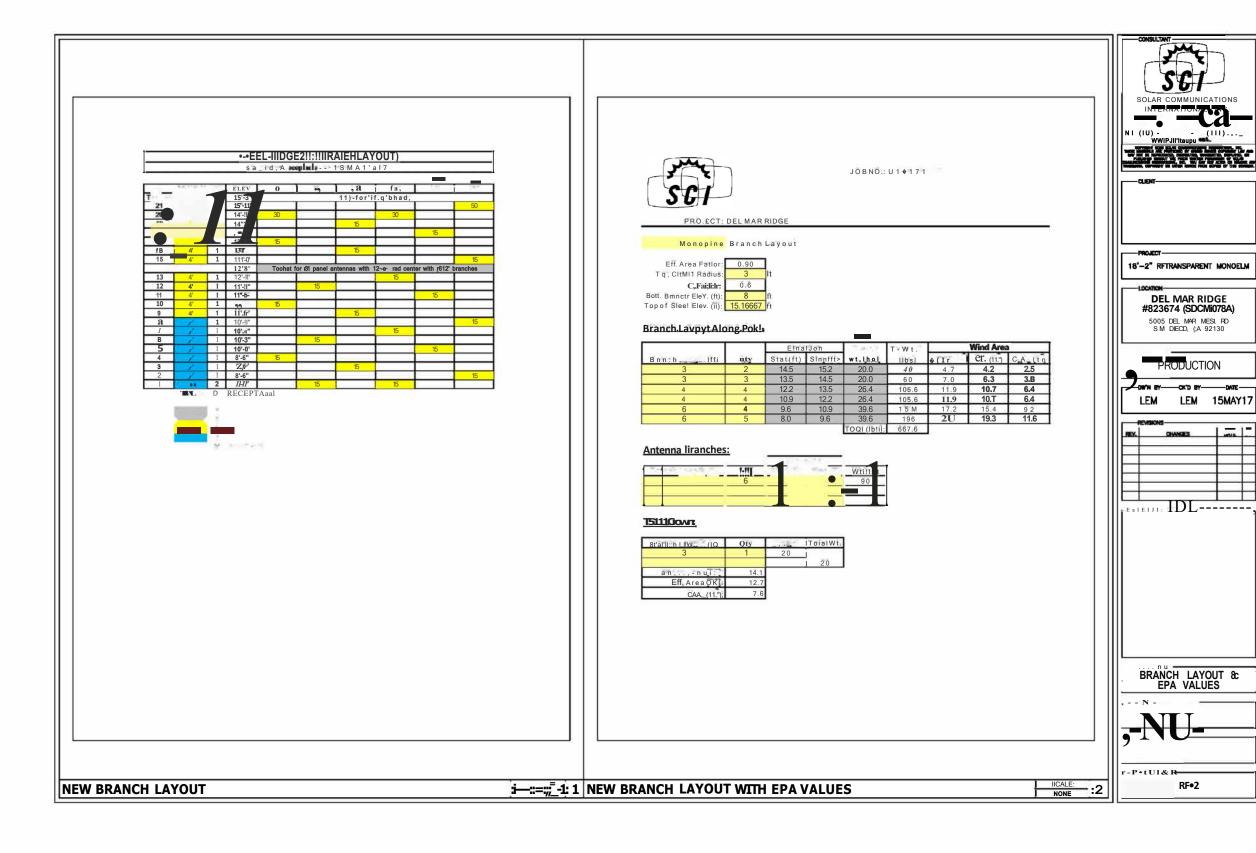
DEL MAR RIDGE SD06078A BU# 823674 5005 DEL MAR MESA RD SAN DIEGO, CA 92130 MONOELM

SHEET TITLE
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M SQUARI:•J.,

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